

Providing Outstanding Service Since 1963

**Board of Directors** 

Janna Orkney, Chair Susan Pan, Vice Chair Leon Shapiro, Director Raymond Tjulander, Director James Wall, Director

November 25, 2019

Board of Directors Triunfo Water & Sanitation District Ventura County, California

# AT&T REQUEST FOR EQUIPMENT MODIFICATIONS AT THE KILBURN SITE

The Triunfo Sanitation District (TSD) Board entered into a site lease agreement (TSD No. T93-14) with AT&T Wireless Services of California, LLC, on January 28, 1994, for placement of a cell tower facility at the Kilburn water reservoir site. The terms of the agreement included a provision that allows AT&T Wireless to make minor modifications to its equipment as part of ongoing routine operations and maintenance. AT&T Wireless has requested to replace and improve the antennas and certain components of the transmitting equipment to expand broadband connectivity and system capacity (upgrade to 5G). These changes involve no change of the physical dimensions of the antennas array pattern or the tower height and will not further impair the District's ability to operate its facilities at this site. AT&T Wireless requests a Letter of Authorization from TWSD (as the landlord) to present with their upgrade CUP request to the County of Ventura Planning Department as part of the permitting process for these modifications. Staff is recommending that the Board approve the General Manager to sign the Letter of Authorization and approve the requested modifications.

Please contact me at (805) 658-4621 or marknorris@vrsd.com if you have any questions.


# Recommendation

It is recommended that the Board approve the General Manager to sign the Letter of Authorization and provide AT&T Wireless Services of California, LLC, with the approval to move this process forward to County Planning.

**REVIEWED AND APPROVED** 

Mark Norris - General Manager

Attachments: LOA request with Proposed Plans

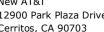

T: 562-468-6164 F: 562-403-1830 www.att.com



October 9, 2019

Mark Norris Triunfo Water & Sanitation District 1001 Partridge Drive STE 150 Ventura, CA 93003

### REQUEST FOR CONSENT

RE: AT&T Mobility Site #: SBOV22

Property Address: 4997 Kilburn Court Oak Park, CA 91377

LEASE BETWEEN THE NEW CINGULAR WIRELESS PCS, LLC, SUCCESSOR TO AB CELLULAR WIRELESS LLC, DOING BUSINESS AS AT&T MOBILITY ("THE NEW CINGULAR") AND THE TRIUNFO WATER & SANITATION DISTRICT, HAVING A MAILING ADDRESS OF 1001 PARTRIDGE DRIVE STE 150 VENTURA, CA 93003. ("LANDLORD")

### To Whom It May Concern:

This letter is to inform you that AT&T Mobility is in the process of performing necessary maintenance of its wireless communications facility at the above-referenced Property. The property's APN is 685-0-010-175 & 685-0-207-535.

Consistent with the Lease Agreement, documented consent is hereby requested in order to proceed with the following maintenance, which is scheduled to begin in the next few months:

- Swap 3 existing antennas with 3 new antennas
- Replace existing Radome with a new Radome
- Installation of 9 new Radio Remote Units (RRU's)
- Installation of 6 new single TMA
- Removal of 3 existing DUS-41 and installation of new 1-XMU on existing rack
- Installation of 3 new twin diplexers and 3 new twin triplexers at equipment area

Please note that this work may occur in two separate stages, depending on equipment availability at the time of the first stage of work. AT&T is forecasting construction 3/9 - 4/8 2020. Please indicate your consent by signing the enclosed "Confirmation of Consent".

Bechtel Corporation is authorized by AT&T Mobility to perform the required work. If you have any questions or require additional information, please contact Jessica Grevin at Coastal Business Group. Thank you for your prompt response and attention to this matter. AT&T Mobility and Bechtel Corporation appreciate your assistance.

Sincerely,

Jessica Grevin LTE Project Manager 949-336-1550 jborders@coastalbusinessgroup.net



T: 562-468-6164 ve F: 562-403-1830 www.att.com



#### **Confirmation of Consent**

To: AT&T Mobility c/o Coastal Business Group, Inc. 24310 Moulton Pkwy Suite O#1009

Via email to:jborders@coastalbusinessgroup.net

Laguna Hills, CA 92637 Attn: Jessica Grevin

RE: AT&T Mobility SITE NO: SBOV22 / North Ranch

SITE ADDRESS: 4997 Kilburn Court Oak Park, CA 91377

APN: 685-0-010-175 & 685-0-207-535

By: \_\_\_\_\_

To Whom It May Concern: Consent is hereby granted for AT&T Mobility to proceed with the following: Swap 3 existing antennas with 3 new antennas, Replace existing Radome with a new Radome, Installation of 9 new Radio Remote Units (RRU's), Installation of 6 new single TMA. Removal of 3 existing DUS-41 and installation of new 1-XMU on existing rack, Installation of 3 new twin diplexers and 3 new twin triplexers at equipment area

\*Please execute below, initial each page of the attached drawings, and return.

TRIUNFO WATER & SANITATION DISTRICT, HAVING A MAILING ADDRESS OF 1001 PARTRIDGE DRIVE STE 150 VENTURA, CA 93003.

	Authorized Signature	
Name:	Please print name	
Title: _		
Date: _		_
Phone:	•	_
Comm	ents:	







A notary public or other officer completing this certificate verifies only the identity of the individual who signed the document to which this certificate is attached, and not the truthfulness, accuracy, or validity of that document.

# LANDLORD ACKNOWLEDGEMENT

STATE OF CALIFORNIA )	
COUNTY OF)	
	_ before me,,
who proved to me on the basis of satisfactorised to the within instrument and achis/her/their authorized capacity(ies), and	ctory evidence to be the person(s) whose name(s) is/are eknowledged to me that he/she/they executed the same in that by his/her/their signature(s) on the instrument the ch the person(s) acted, executed the instrument.
I certify under PENALTY OF PERJURY uparagraph is true and correct.	under the laws of the State of California that the foregoing
WITNESS my hand and official seal.	
Signature	
Name	
(typed or printed)	(Seal)



NORTH RANCH 4997 KILBURN COURT OAK PARK, CA 91377 SBOV22/LTE 5C (850)/6C (AWS-3) 7C (700-B14)

SITE NO.: SBOV22 PACE NO.: MRLOS038125 PACE NO.: MRLOS040831 PACE NO.: MRLOS040859 PTN NO.: 3551A0AGV1 PTN NO.: 3551A0BYL3

PTN NO.: 3551A0BXBS

FA LOCATION CODE: 10086936


#### **GENERAL NOTES**

- THE CONTRACTOR SHALL GIVE ALL NOTICES & COMPLY WITH ALL LAWS, ORDINANCES, RULES, REGULATIONS & LAWFUL ORDERS OF ANY PUBLIC AUTHORITY, MUNICIPAL & UTILITY COMPANY SPECIFICATIONS, & LOCAL & STATE JURISDICTIONAL CODES BEARING ON THE PERFORMANCE OF THE WORK THE WORK PERFORMED ON THE PROJECT & THE MATERIALS INSTALLED SHALL BE IN STRICT ACCORDANCE WITH ALL APPLICABLE CODES, REGULATIONS, & ORDINANCES.
- 2. THE ARCHITECT/ENGINEER HAVE MADE EVERY EFFORT TO SET FORTH IN THE CONSTRUCTION & CONTRACT DOCUMENTS THE COMPLETE SCOPE OF WORK. THE CONTRACTOR BIDDING THE JOB IS NEVERTHELESS CAUTIONED THAT MINOR OMISSIONS OR ERRORS IN THE DRAWINGS & OR SPECIFICATIONS SHALL NOT EXCUSE SAID CONTRACTOR FROM COMPLETING THE PROJECT & IMPROVEMENTS IN ACCORDANCE WITH THE INTENT OF THESE DOCUMENTS
- THE CONTRACTOR OR BIDDER SHALL BEAR THE RESPONSIBILITY OF NOTIFYING (IN WRITING) THE PROJECT OWNER'S REPRESENTATIVE OF ANY CONFLICTS, ERRORS, OR OMISSIONS PRIOR TO THE SUBMISSION OF CONTRACTOR'S PROPOSAL OR PERFORMANCE OF WORK. IN THE EVENT OF DISCREPANCIES THE CONTRACTOR SHALL PRICE THE MORE COSTLY OR EXTENSIVE WORK, UNLESS DIRECTED IN WRITING
- 4. THE SCOPE OF WORK SHALL INCLUDE FURNISHING ALL MATERIALS, EQUIPMENT, LABOR & ALL OTHER MATERIALS & LABOR DEEMED NECESSARY TO COMPLETE THE WORK/PROJECT AS DESCRIBED HEREIN.
- THE CONTRACTOR SHALL VISIT THE JOB SITE PRIOR TO THE SUBMISSION OF BIDS OR PERFORMING WORK TO FAMILIARIZE HIMSELF WITH THE FIELD CONDITIONS & TO VERIFY THAT THE PROJECT CAN BE CONSTRUCTED IN ACCORDANCE WITH THE CONTRACT DOCUMENTS.
- THE CONTRACTOR SHALL OBTAIN AUTHORIZATION FROM THE PROJECT OWNER'S REPRESENTATIVE TO PROCEED WITH CONSTRUCTION PRIOR TO STARTING WORK ON ANY ITEM NOT CLEARLY DEFINED BY THE CONSTRUCTION DRAWINGS / CONTRACT DOCUMENTS.
- THE CONTRACTOR SHALL INSTALL ALL EQUIPMENT & MATERIALS ACCORDING TO THE MANUFACTURER'S / VENDOR'S SPECIFICATIONS UNLESS NOTED OTHERWISE OR WHERE LOCAL CODES OR ORDINANCES TAKE
- 8. THE CONTRACTOR SHALL PROVIDE A FULL SET OF CONSTRUCTION DOCUMENTS AT THE SITE UPDATED WITH THE LATEST REVISIONS & ADDENDUMS OR CLARIFICATIONS AVAILABLE FOR THE USE BY ALL PERSONNEL INVOLVED WITH THE PROJECT.
- 9. THE CONTRACTOR SHALL SUPERVISE & DIRECT THE PROJECT DESCRIBED HEREIN. THE CONTRACTOR SHALL BE SOLELY RESPONSIBLE FOR ALL CONSTRUCTION MEANS, METHODS, TECHNIQUES, SEQUENCES & PROCEDURES & FOR COORDINATING ALL PORTIONS OF THE WORK UNDER THE CONTRACT.
- 10. THE CONTRACTOR SHALL BE RESPONSIBLE FOR PROVIDING ALL NECESSARY CONSTRUCTION CONTROL SURVEYS, ESTABLISHING & MAINTAINING ALL LINES & GRADES REQUIRED TO CONSTRUCT ALL IMPROVEMENTS AS SHOWN HEREIN.
- 11. THE CONTRACTOR SHALL BE RESPONSIBLE FOR OBTAINING ALL PERMITS & INSPECTIONS WHICH MAY BE REQUIRED FOR THE WORK BY THE ARCHITECT/ENGINEER, THE STATE, COUNTY OR LOCAL GOVERNMENT
- 12. THE CONTRACTOR SHALL MAKE NECESSARY PROVISIONS TO PROTECT EXISTING IMPROVEMENTS, EASEMENTS, PAVING, CURBING, ETC. DURING CONSTRUCTION. UPON COMPLETION OF WORK, THE CONTRACTOR SHALL REPAIR ANY DAMAGE THAT MAY HAVE OCCURRED DUE TO CONSTRUCTION ON OR ABOUT THE PROPERTY.
- 13. THE CONTRACTOR SHALL KEEP THE GENERAL WORK AREA CLEAN & HAZARD FREE DURING CONSTRUCTION & DISPOSE OF ALL DIRT, DEBRIS, RUBBISH & REMOVE EQUIPMENT NOT SPECIFIED AS REMAINING ON THE PROPERTY. PREMISES SHALL BE LEFT IN CLEAN CONDITION & FREE FROM PAINT SPOTS, DUST, OR SMUDGES OF ANY NATURE.
- 14. THE CONTRACTOR SHALL COMPLY WITH ALL OSHA REQUIREMENTS AS THEY APPLY TO THIS PROJECT.
- 15. THE CONTRACTOR SHALL NOTIFY THE PROJECT OWNER'S REPRESENTATIVE WHERE A CONFLICT OCCURS ON ANY OF THE CONTRACT DOCUMENTS. THE CONTRACTOR IS NOT TO ORDER MATERIAL OR CONSTRUCT ANY PORTION OF THE WORK THAT IS IN CONFLICT UNTIL CONFLICT IS RESOLVED BY THE LESSEE/LICENSEE
- 16. THE CONTRACTOR SHALL VERIFY ALL DIMENSIONS, ELEVATIONS, PROPERTY LINES, ETC. ON THE JOB.
- 17. ALL UNDERGROUND UTILITY INFORMATION WAS DETERMINED FROM SURFACE INVESTIGATIONS & EXISTING PLANS OF RECORD. THE CONTRACTOR SHALL LOCATE ALL UNDERGROUND UTILITIES IN THE FIELD PRIOR TO ANY SITE WORK. CALL THE FOLLOWING FOR ALL PRE-CONSTRUCTION NOTIFICATION 72-HOURS PRIOR TO ANY EXCAVATION ACTIVITY, CALL BEFORE YOU DIG (800) 227-2600 OR 811 WWW.USANORTH.ORG.
- 18. PER FCC MANDATE, ENHANCED EMERGENCY (E911) SERVICE IS REQUIRED TO MEET NATIONWIDE STANDARDS FOR WIRELESS COMMUNICATIONS SYSTEMS. PROJECT OWNER IMPLEMENTATION REQUIRES DEPLOYMENT OF EQUIPMENT & ANTENNAS GENERALLY DEPICTED ON THIS PLAN, ATTACHED TO OR MOUNTED IN CLOSE PROXIMITY TO THE BTS RADIO CABINET. THE PROJECT OWNER RESERVES THE IGHT TO MAKE REASONABLE MODIFICATIONS TO E911 EQUIPMENT & LOCATION AS TECHNOLOGY EVOLVES TO MEET REQUIRED
- 19. A STRUCTURAL ANALYSIS OF THE EXISTING STRUCTURE SHALL BE COMPLETED BY THE CARRIER DEMONSTRATING ADEQUATE CAPACITY FOR THE ADDITIONAL LOADS PRIOR TO CONSTRUCTION START.



Know what's below. Call before you dig. (800) 227-2600 or 811 WWW.USANORTH.ORG

48 HOURS PRIOR TO DIGGING, CONTRACTOR SHALL NOTIFY ALL UTILITY COMPANIES TO LOCATE ALL UNDERGROUND UTILITIES.

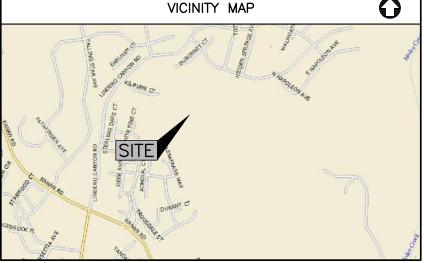

#### SCOPE OF WORK

AT&T PROPOSES THE MODIFICATION OF AN EXISTING UNMANNED WIRELESS TELECOMMUNICATIONS FACILITY:

AT ANTENNAS (3 SECTOR SITE):

REMOVE (3) EXISTING ANTENNAS AT ALPHA, BETA & GAMMA SECTOR POSITION 1 (TYP OF 1 PER SECTOR, TOTAL OF 3).

2. INSTALL (3) NEW ANTENNAS AT ALPHA, BETA & GAMMA SECTOR POSITION 1(TYP. OF 1 PER SECTOR

TOTAL OF 3).
INSTALL RETS AS NEEDED.

AT EQUIPMENT CABINETS:

4. REMOVE (6) EXISTING TMA AT BASE OF SLIMLINE NONOPOLE (TYP. OF 2 PER SECTOR, TOTAL OF 6).

REMOVE (1) DUS41 WITHIN EXISTING 19" EQUIPMENT RACK.

6. REMOVE (1) EXISTING RXAINT RACK.

REMOVE (1) 2206 CABINET.

8. INSTALL (6) TMAS AT BASE OF SLIMLINE MONOPOLE (TYP. OF 2 PER SECTOR, TOTAL OF 6. INSTALL (1) BASE BAND 5216 AND (1) XMU. FINAL BASEBAND COUNT: 1X5216 & 2X XMU.

10. INSTALL (3) RRUS-B66 MOUNTED ON PROPOSED PIPE (TYP. OF 1 PER SECTOR, TOTAL OF 3).

11. INSTALL (3) RRUS-B5 MOUNTED ON PROPOSED PIPE (TYP. OF 1 PER SECTOR, TOTAL OF 3).

12. INSTALL (3) RRUS-B14 MOUNTED ON PROPOSED PIPE (TYP. OF 1 PER SECTOR, TOTAL OF 3).

13. INSTALL (3) TRIPLEXERS MOUNTED TO EXISTING O/H CABLE LADDER (TYP. OF 1 PER SECTOR, TOTAL OF 3).

14. INSTALL (3) DIPLEXERS MOUNTED TO EXISTING O/H CABLE LADDER (TYP. OF 1 PER SECTOR, TOTAL OF

3).15. CONFIGURE RETS AS NEEDED.

16. UTILIZE (E) SURGE SUPPRESSION.
17. INSTALL (2) NEW DC-DC CONVERTERS WITHIN (E) RACK.

#### CODE COMPLIANCE

ALL WORK AND MATERIALS SHALL BE PERFORMED AND INSTALLED IN ACCORDANCE WITH THE CURRENT EDITIONS OF THE FOLLOWING CODES AS ADOPTED BY THE LOCAL GOVERNING AUTHORITIES. NOTHING IN THESE PLANS IS TO BE CONSTRUED TO PERMIT WORK NOT CONFORMING TO THE LOCAL CODES:

- 2016 CALIFORNIA ADMINISTRATIVE CODE
- 2016 CALIFORNIA ENERGY CODE (CEC)
- 2016 CALIFORNIA BUILDING CODE (CBC)
- 2016 CALIFORNIA ELECTRIC CODE (CEC)
  2016 CALIFORNIA MECHANICAL CODE (CMC)
- 2016 CALIFORNIA PLUMBING CODE (CPC)
  2016 CALIFORNIA FIRE CODE
- ANSI/EIA-TIA-222-G APPLICABLE LOCAL & STATE LAWS AND REGULATIONS

THIS FACILITY IS UNMANNED & NOT FOR HUMAN HABITATION: DISABLED ACCESS & REOS. ARE NOT REQUIRED.

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l	S-2	STRUCTURAL DETAILS 1					
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SHEET INDEX

# PROJECT INFORMATION

SITE NAME: NORTH RANCH

SITE NUMBER: SBOV22/LTE 5C (850)/6C (AWS-3) 7C (700-B14)

SITE ADDRESS: 4997 KILBURN COURT OAK PARK, CA 91377

LATITUDE: 34° 11' 22.59" N (NAD 83) LONGITUDE: 118° 46' 49.09" W (NAD 83)

**GROUND ELEVATION:** 1,404'± AMSL

TRIUNFO SANITATION DISTRICT PROPERTY OWNER:

346 NEW KANAN ROAD, SUITE 203 OAK PARK, CA 91301 CONTACT: TOM HUGHES

PHONE: 88.879.8321

PARCEL ID: 685-0-010-175 & 685-0-207-535

JURISDICTION: COUNTY OF VENTURA

ZONING DISTRICT: N/A CONSTRUCTION TYPE: U-2

OCCUPANCY TYPE: U (UNMANNED)

POWER COMPANY: PG&E TELEPHONE COMPANY: AT&T

APPLICANT: AT&T MATTHEW YOON - (562) 412-9826

1452 EDINGER AVE., TUSTIN, CA 92780

SITE ACQUISITION: JACQUELINE ZIRBES 818-859-4119 3703 LONG BEACH BOULEVARD, SUITE 421, 2ND FLOOR

LONG BEACH, CA 90807

APPLICANT:



1452 EDINGER AVE. TUSTIN, CA 92780

PREPARED BY:



3703 Long Beach Blvd I Suite 421 I 2nd Floor Long Beach, CA 90807 (781) 273-2500 | www.ebiconsulting.com



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#### **SUBMITTALS**

	NO.	DATE	DESCRIPTION	BY
	Α	01/15/18	90% CONSTRUCTION	SH
	В	02/22/18	REVISED PER COMMENTS	SM
	0	06/19/18	100% FOR CONSTRUCTION	SH

EBI JOB NO:

8117000509

SITE INFO:

NORTH RANCH 4997 KILBURN COURT OAK PARK, CA 91377 SBOV22/LTE 5C (850)/6C (AWS-3) 7C (700-B14)


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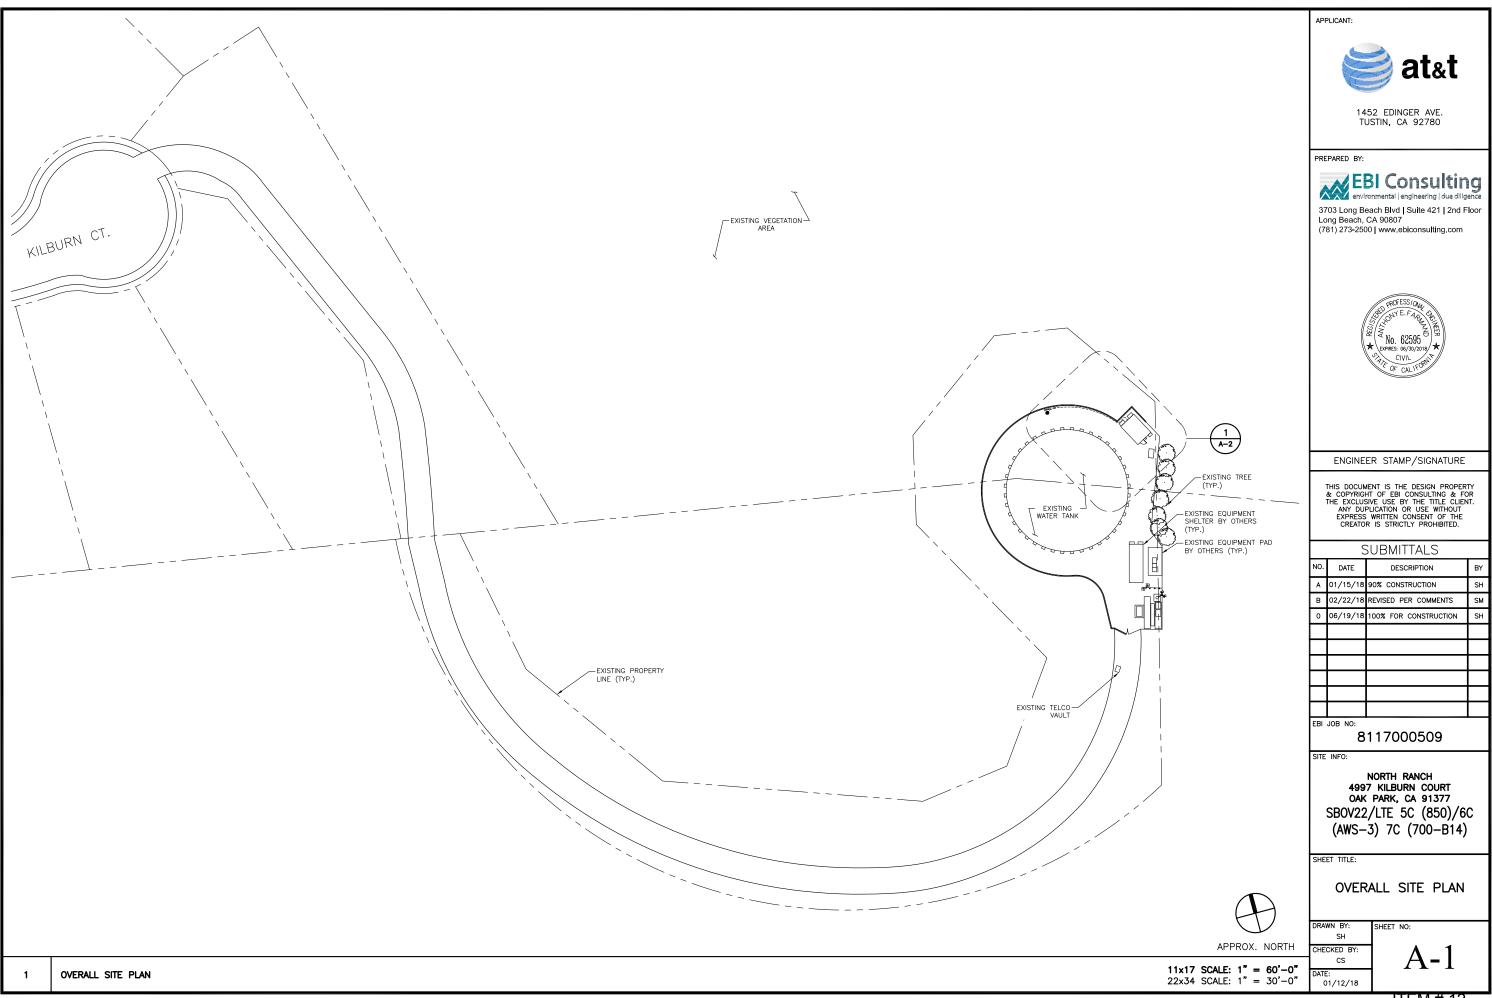
TITLE SHEET

SHEET NO: SH CHECKED BY

CS 01/12/18

ITEM # 12



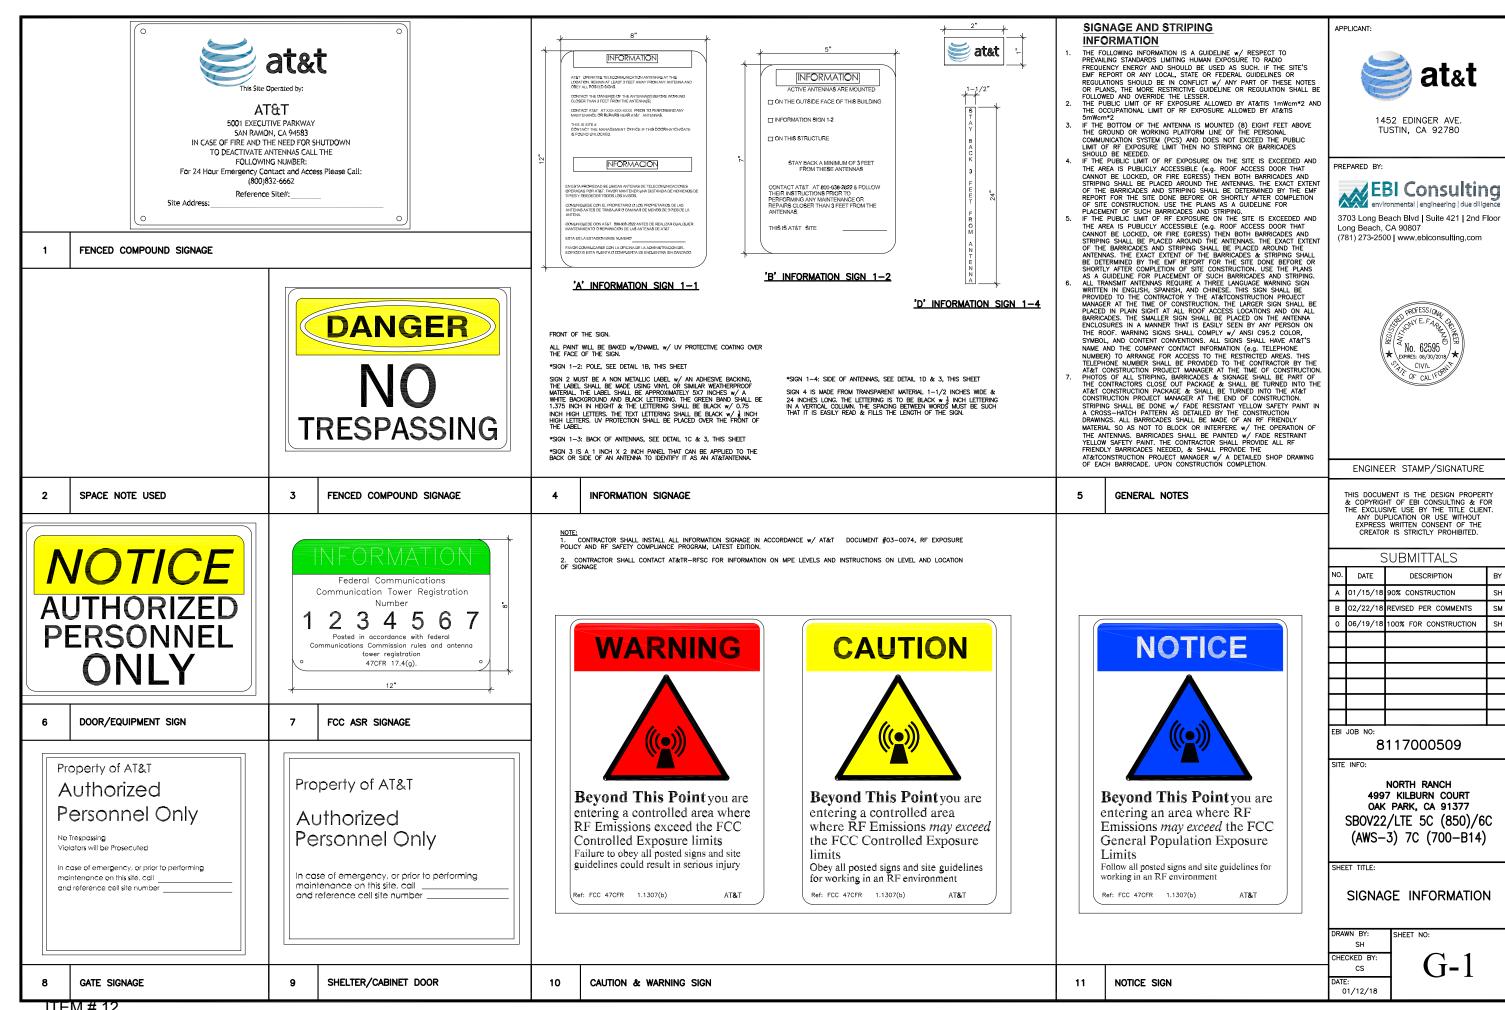









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PREPARED BY:



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# SUBMITTALS

NO.	DATE	DESCRIPTION	8
Α	01/15/18	90% CONSTRUCTION	s
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8117000509

SITE INFO:


NORTH RANCH 4997 KILBURN COURT OAK PARK, CA 91377 SBOV22/LTE 5C (850)/6C (AWS-3) 7C (700-B14)

SHEET TITLE:

ENLARGED SITE PLAN

SH CHECKED BY:


A-2

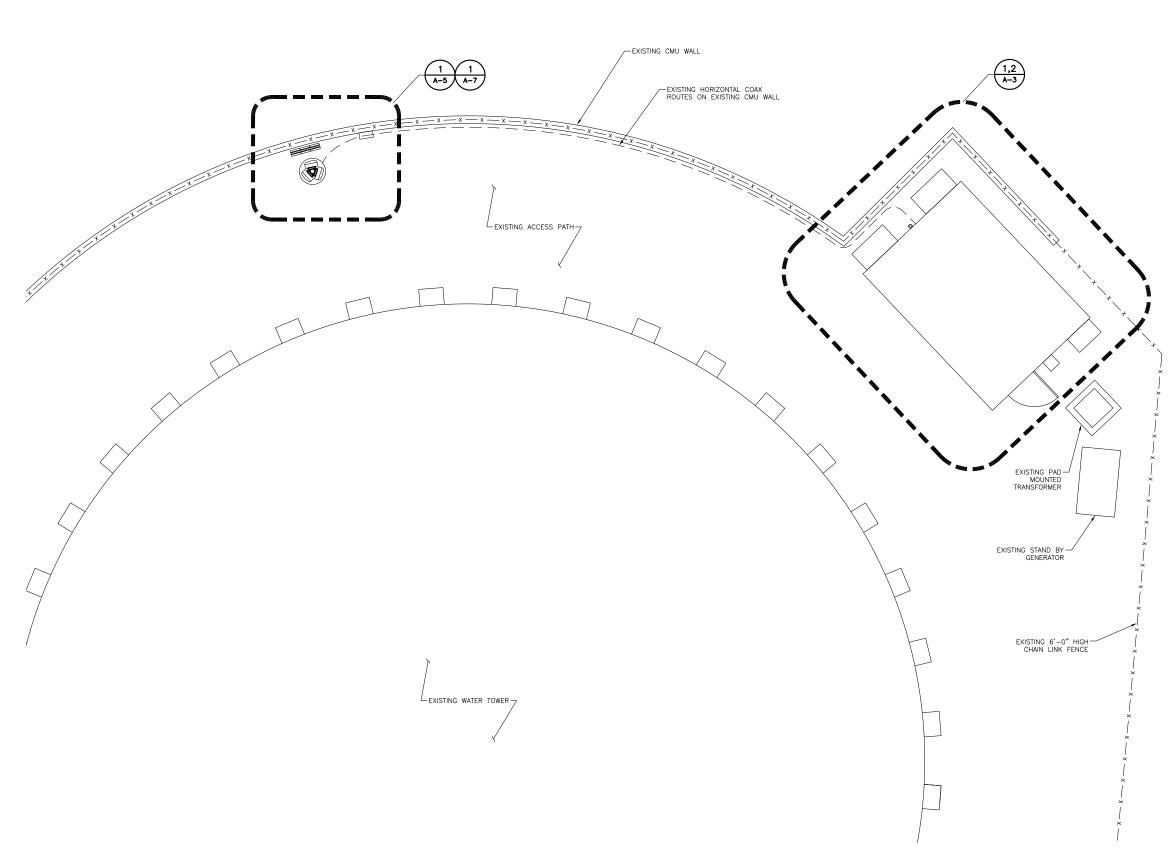


APPROX. NORTH

11x17 SCALE: 1/8" = 1'-0" 22x34 SCALE: 1/4" = 1'-0"

ENLARGED SITE PLAN

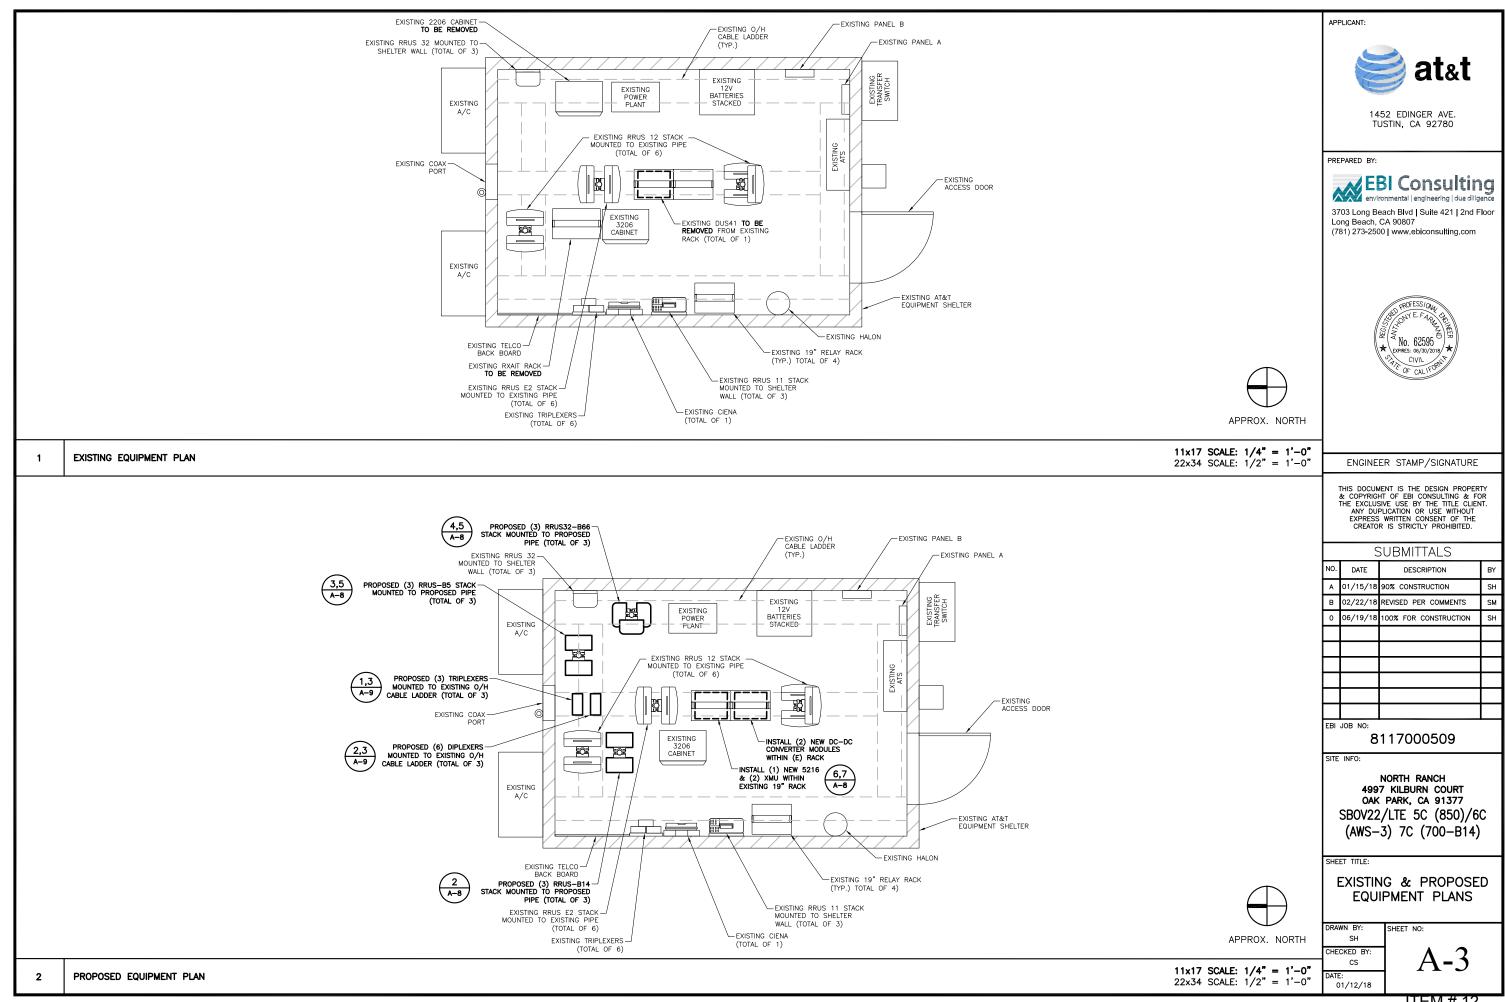

- DESIGN BASED ON RFDS DATED 11/09/2017. CONTRACTOR TO REQUEST CURRENT RFDS PRIOR TO CONSTRUCTION.
- 2. ALL PROPOSED EQUIPMENT TO BE INSTALLED IN ACCORDANCE WITH CORRESPONDING STRUCTURAL ANALYSIS, EQUIPMENT MANUFACTURER'S RECOMMENDATIONS AND FINAL AT&T RF DATA SHEET.
- 3. EXISTING & PROPOSED EQUIPMENT TO BE PAINTED TO MATCH EXISTING.
- 4

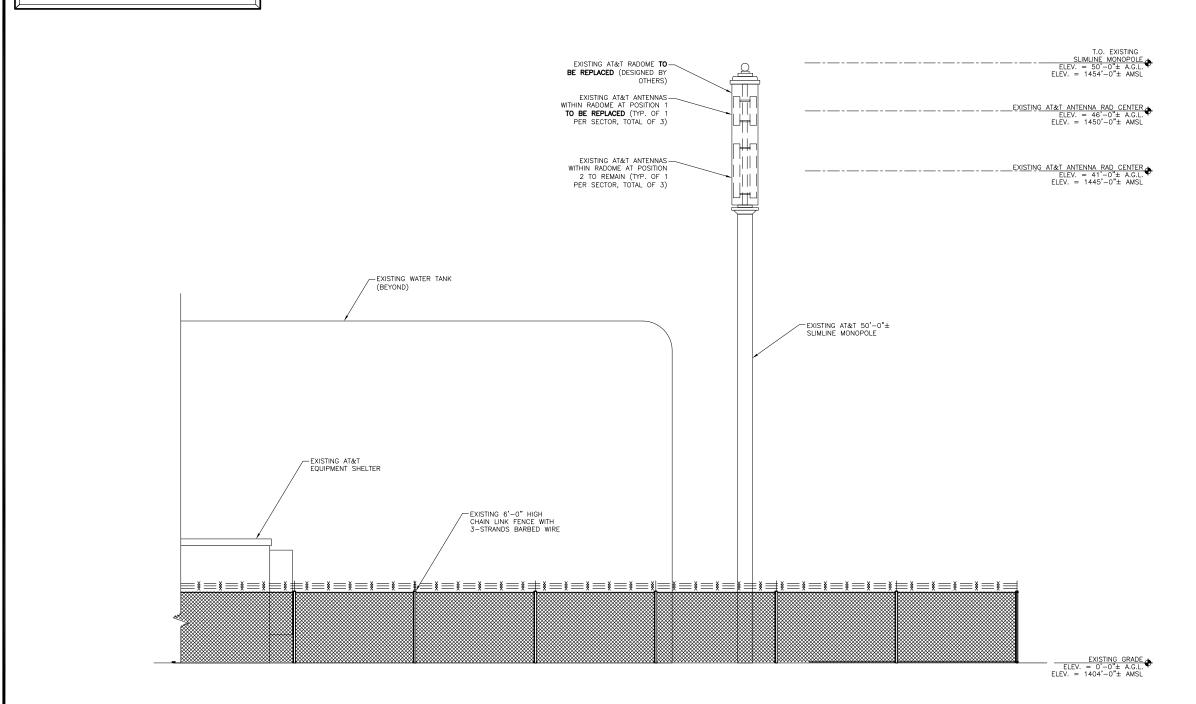

APPLICANT:



1452 EDINGER AVE. TUSTIN, CA 92780

PREPARED BY:



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8117000509

SITE INFO:

NORTH RANCH 4997 KILBURN COURT OAK PARK, CA 91377 SBOV22/LTE 5C (850)/6C (AWS-3) 7C (700-B14)

SHEET TITLE:

**EXISTING ELEVATION** 

SHEET NO:

SH CHECKED BY: CS


01/12/18

A-4


EXISTING NORTHEAST ELEVATION

11x17 SCALE: 1/8" = 1'-0" 22x34 SCALE: 1/4" = 1'-0"

- DESIGN BASED ON RFDS DATED 11/09/2017.
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- 3. EXISTING & PROPOSED EQUIPMENT TO BE PAINTED TO MATCH EXISTING.

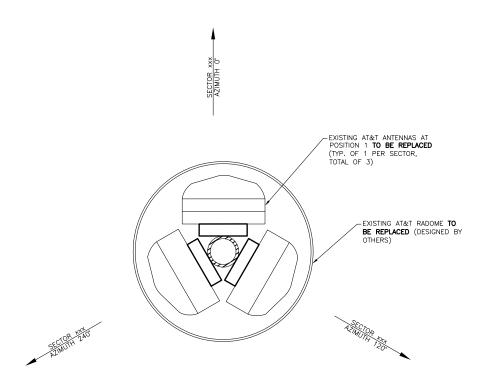

POSITION 1 ANTENNAS @ 46'-0" (A.G.L.)

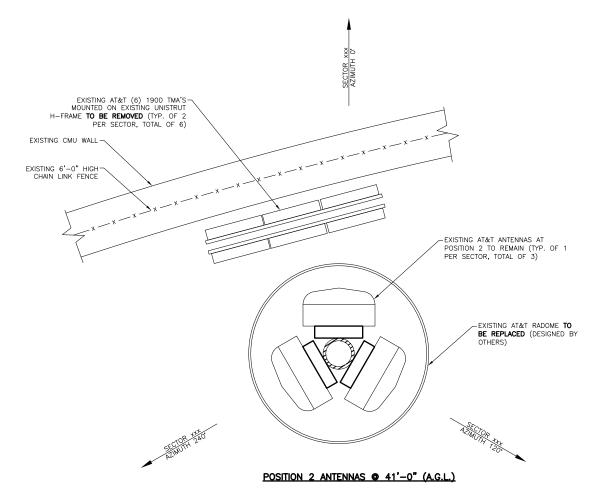



APPLICANT:

PREPARED BY:

at&t

1452 EDINGER AVE. TUSTIN, CA 92780

EBI Consulting
environmental | engineering | due diligence

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FRI	JOB NO:		

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SITE INFO:

NORTH RANCH
4997 KILBURN COURT
OAK PARK, CA 91377
SBOV22/LTE 5C (850)/6C
(AWS-3) 7C (700-B14)

SHEET TITLE:

EXISTING ANTENNA ORIENTATION PLAN


DRAWN BY: SH CHECKED BY: CS

01/12/18

A-5

APPROX. NORTH

- DESIGN BASED ON RFDS DATED 11/09/2017. CONTRACTOR TO REQUEST CURRENT RFDS PRIOR TO CONSTRUCTION.
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NORTH RANCH 4997 KILBURN COURT OAK PARK, CA 91377 SBOV22/LTE 5C (850)/6C (AWS-3) 7C (700-B14)

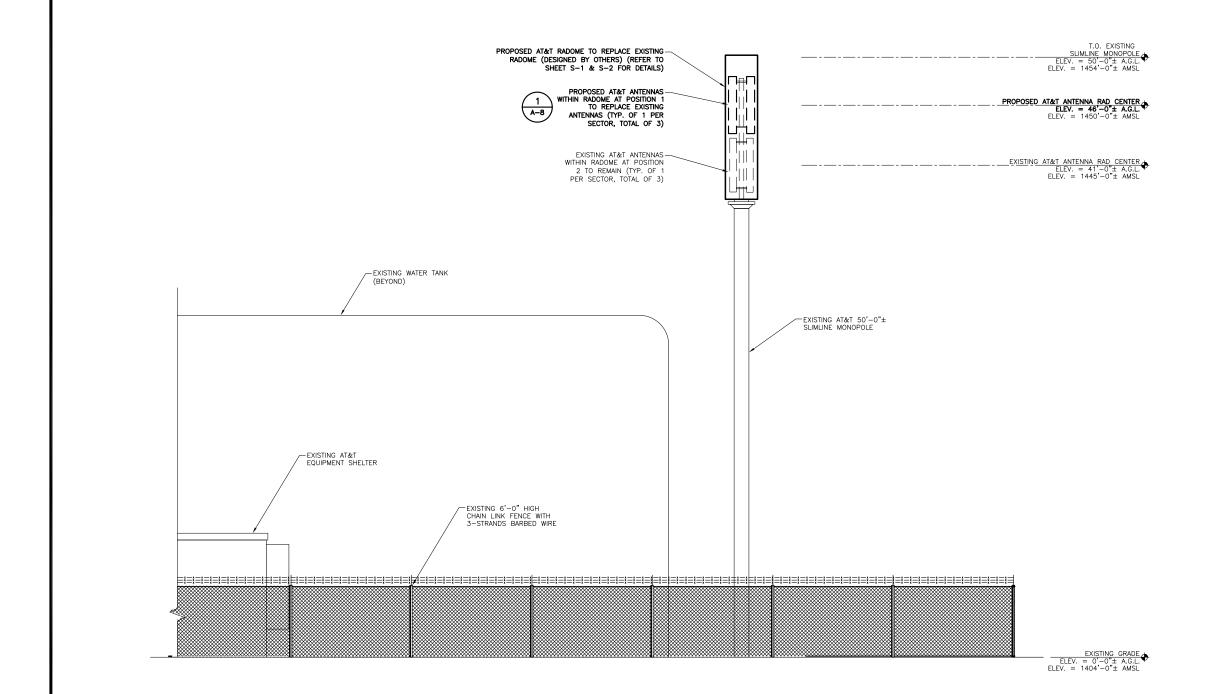SHEET TITLE:

PROPOSED ELEVATION

SH

11x17 SCALE: 1/8" = 1'-0" 22x34 SCALE: 1/4" = 1'-0"


CHECKED BY: cs

01/12/18


A-6

- DESIGN BASED ON RFDS DATED 11/09/2017.
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   PRIOR TO CONSTRUCTION.
- 2. ALL PROPOSED EQUIPMENT TO BE INSTALLED IN ACCORDANCE WITH CORRESPONDING STRUCTURAL ANALYSIS, EQUIPMENT MANUFACTURER'S RECOMMENDATIONS AND FINAL AT&T RF DATA SHEET.
- 3. EXISTING & PROPOSED EQUIPMENT TO BE PAINTED TO MATCH EXISTING.

1 711

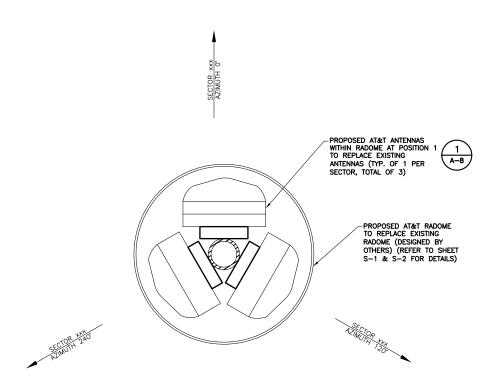

POSITION 1 ANTENNAS @ 46'-0" (A.G.L.)

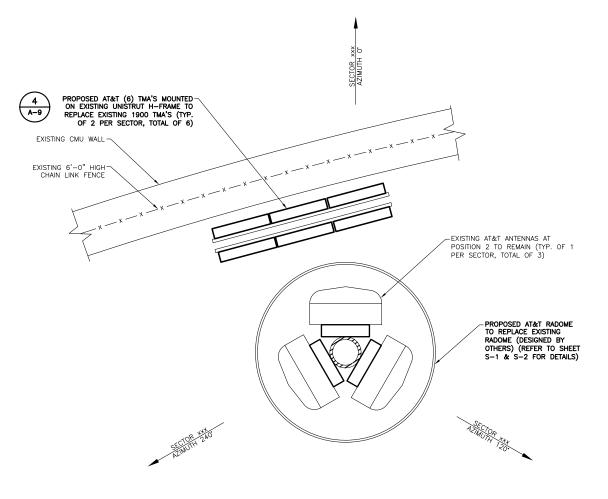

POSITION 2 ANTENNAS @ 41'-0" (A.G.L.)



APPROX. NORTH

11x17 SCALE: 3/4" = 1'-0" 22x34 SCALE: 1/2" = 1'-0" APPLICANT:



1452 EDINGER AVE. TUSTIN, CA 92780

PREPARED BY:



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## SUBMITTALS

			0 0 1 1 1 1 1 1 1 1 1 1 1 1 1 1 1 1 1 1	
	NO.	DATE	DESCRIPTION	BY
ĺ	Α	01/15/18	90% CONSTRUCTION	SH
	В	02/22/18	REVISED PER COMMENTS	SM
	0	06/19/18	100% FOR CONSTRUCTION	SH

EBI JOB NO:

8117000509

SITE INFO:

NORTH RANCH 4997 KILBURN COURT OAK PARK, CA 91377 SBOV22/LTE 5C (850)/6C (AWS-3) 7C (700-B14)

SHEET TITLE:


PROPOSED ANTENNA ORIENTATION PLAN


DRAWN BY: SH CHECKED BY: CS

01/12/18

SHEET NO

A-7

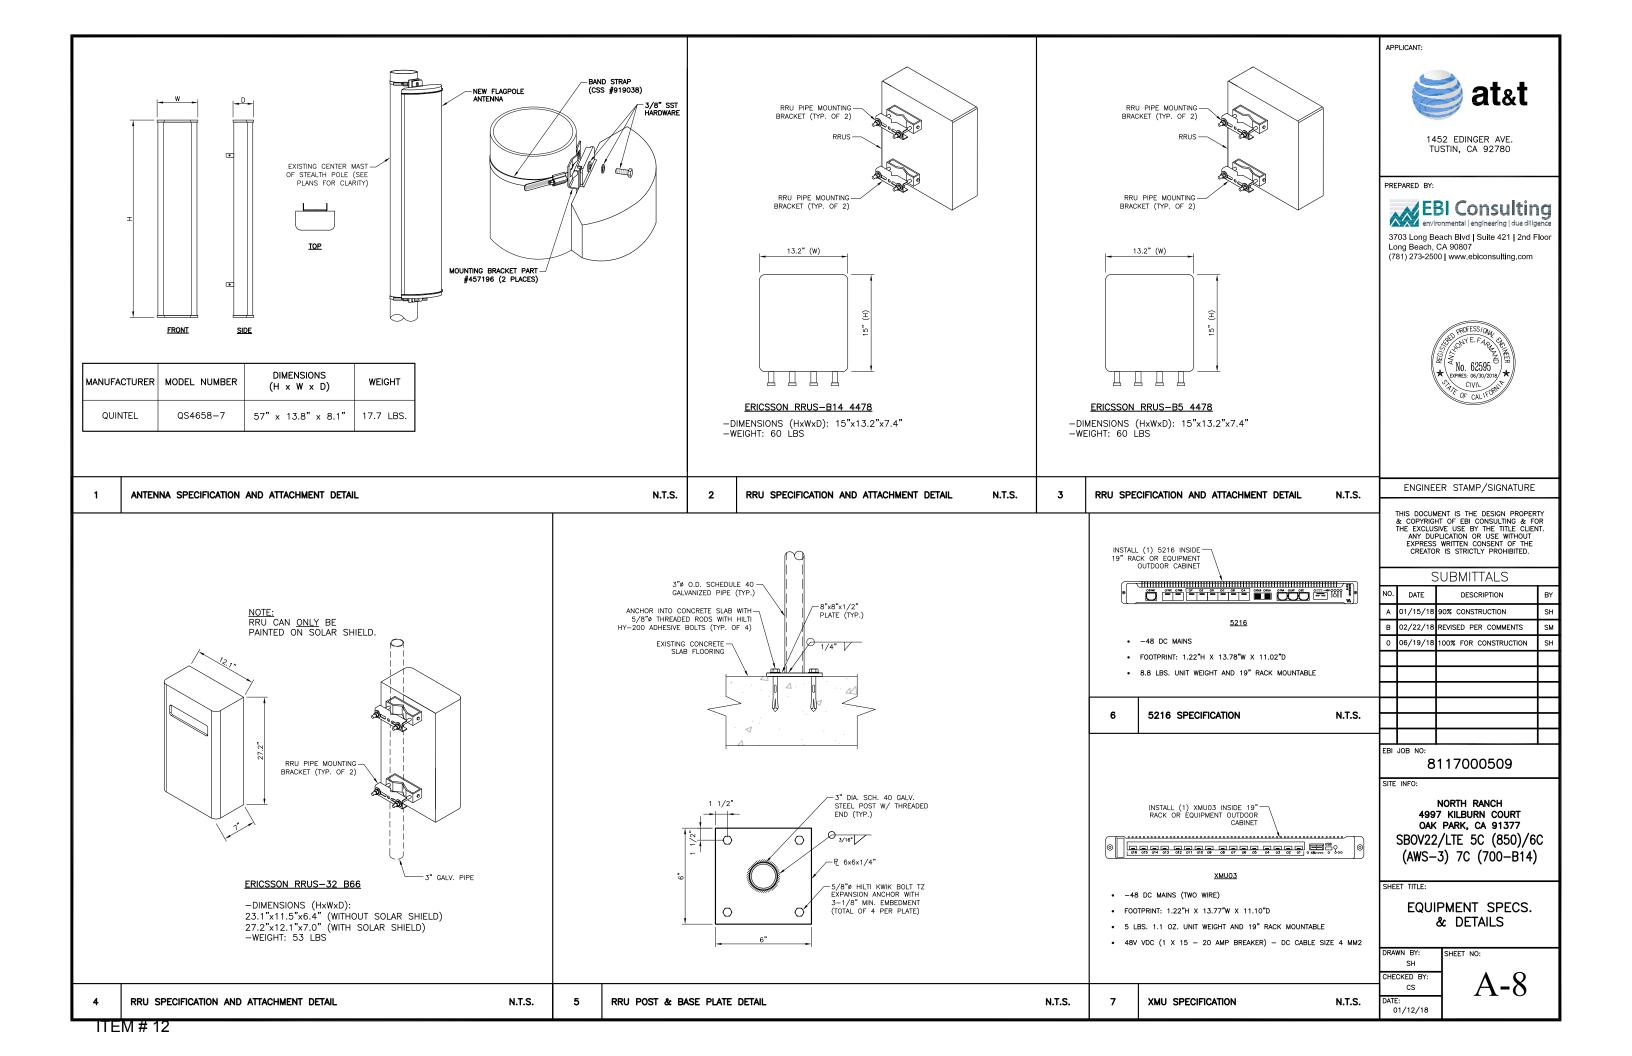

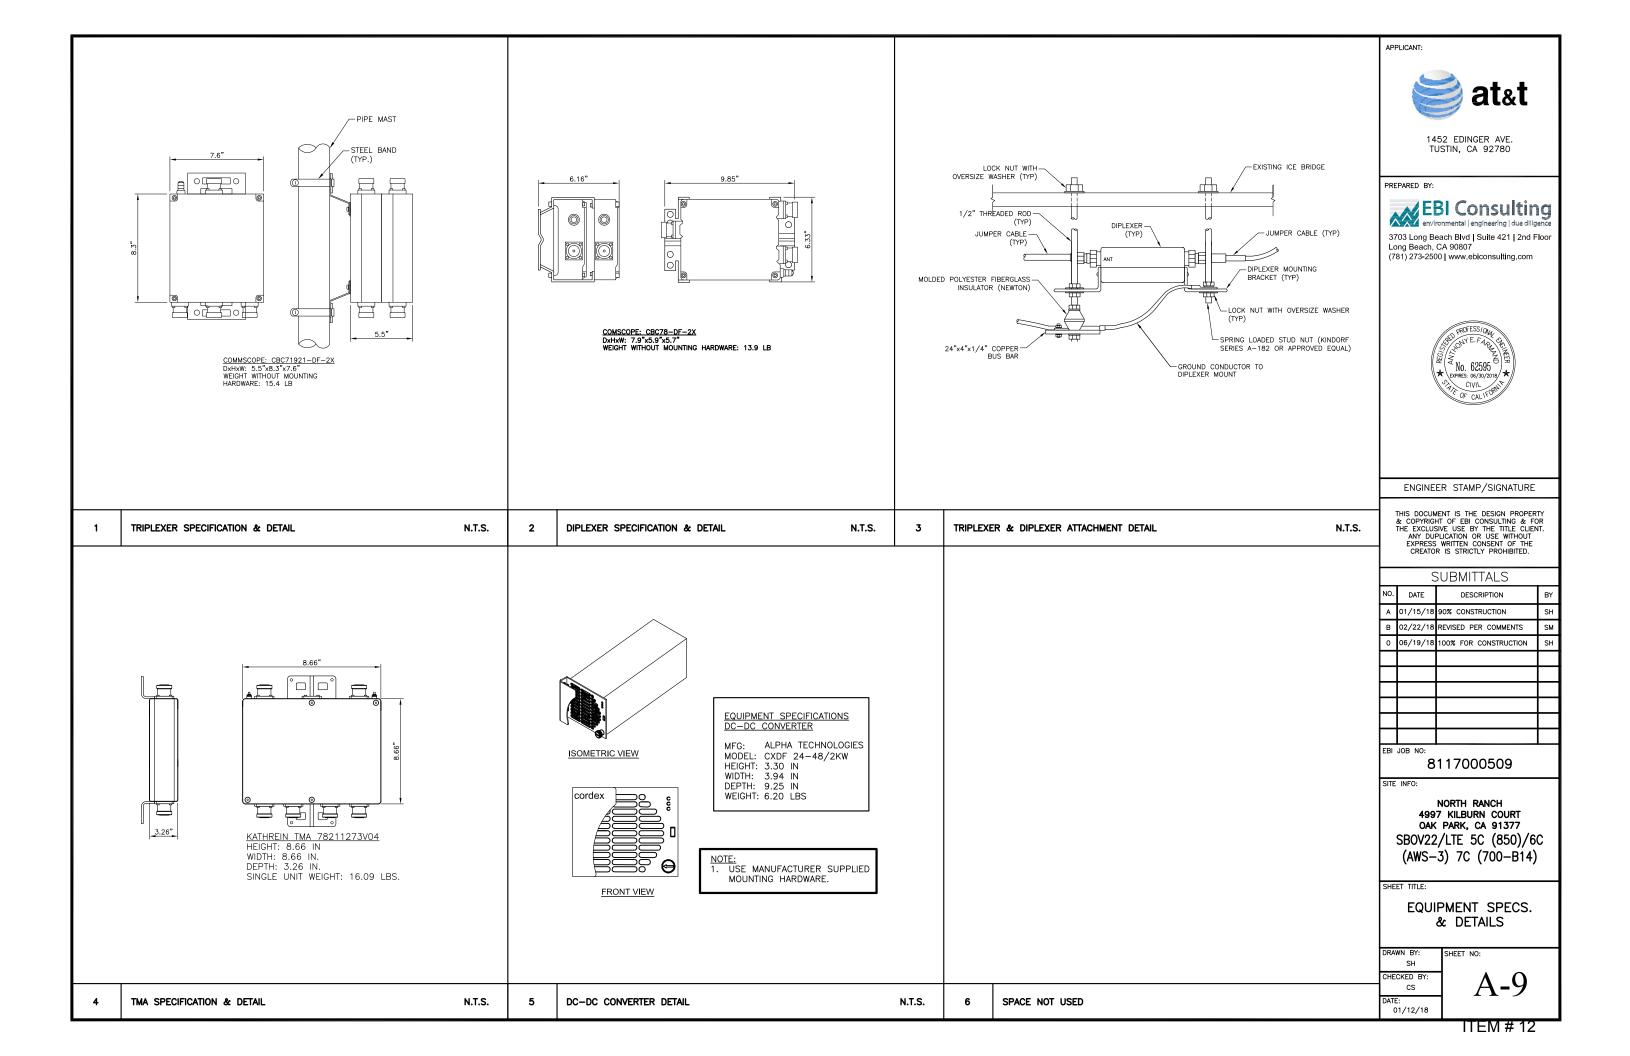

#### EXISTING RF DATA FOR SECTOR A ANTENNA RAD CENTER REPLACE ANTENNA ANTENNA POSITION ANTENNA SIZE RRU - 700 BAND RRU - 850 BAND RRU - 1900 BAND RRU - AWS BAND RRU - WCS BAND RRU - ANY BAND ANTENNA ANTENNA TMA/LNA (MODEL/QTY) ANTENNA MODEL VENDOR (HxWxD) AZIMUTHS (MODEL/QTY) (MODEL/QTY) (MODEL/QTY) (MODEL/QTY) (MODEL/QTY) (MODEL/QTY) (FEET) YES P6T2BF-V1 FILTRONICS 27.6"x13.8"x8.1" A 0° 46 DTMABP7819VG12A/78211273V04 (2) RRUS-E2 (1) NONE RRUS-12 (2) NONE NONE NONE

# EXISTING RF DATA FOR SECTOR B

RRUS-11 (1)

NONE

NONE

REPLACE ANTENNA			ANTENNA VENDOR	ANTENNA SIZE (HxWxD)	ANTENNA AZIMUTHS	ANTENNA RAD CENTER (FEET)	TMA/LNA (MODEL/QTY)	RRU — 700 BAND (MODEL/QTY)	RRU – 850 BAND (MODEL/QTY)	RRU — 1900 BAND (MODEL/QTY)	RRU — AWS BAND (MODEL/QTY)	RRU - WCS BAND (MODEL/QTY)	RRU — ANY BAND (MODEL/QTY)
YES	1	P6T2BF-V1	FILTRONICS	27.6"x13.8"x8.1"	B 240*	46	DTMABP7819VG12A/78211273V04 (2)	RRUS-E2 (1)	NONE	RRUS-12 (2)	NONE	NONE	RRUS -B14 4478 (1)
NO	2	ET-X-UW-70-13-70-17-iR-AT	KMW	53.8"12"6.3"	B 240*	41	TMA23-11A (1)	RRUS-11 (1)	NONE	NONE	NONE	RRUS-32 (1)	NONE

# EXISTING RF DATA FOR SECTOR C

	ANTENNA POSITION		ANTENNA VENDOR	ANTENNA SIZE (HxWxD)	ANTENNA AZIMUTHS	ANTENNA RAD CENTER (FEET)	TMA/LNA (MODEL/QTY)	RRU — 700 BAND (MODEL/QTY)	RRU – 850 BAND (MODEL/QTY)	RRU — 1900 BAND (MODEL/QTY)	RRU – AWS BAND (MODEL/QTY)	RRU — WCS BAND (MODEL/QTY)	RRU — ANY BAND (MODEL/QTY)
YES	1	P6T2BF-V1	FILTRONICS	27.6"x13.8"x8.1"	C 120°	46	DTMABP7819VG12A/78211273V04 (2)	RRUS-E2 (1)	NONE	RRUS-12 (2)	NONE	NONE	RRUS -B14 4478 (1)
NO	2	ET-X-UW-70-13-70-17-iR-AT	KMW	53.8"12"6.3"	C 120°	41	TMA23-11A (1)	RRUS-11 (1)	NONE	NONE	NONE	RRUS-32 (1)	NONE

NOTE:

TMA23-11A (1)

53.8"12"6.3"

KMW

41

Α 0

JUMPERS NOT TO EXCEED 10 FEET WITHOUT RAN APPROVAL.

1 EXISTING RF DATA

NO

2

ET-X-UW-70-13-70-17-iR-AT

APPLICANT:



1452 EDINGER AVE. TUSTIN, CA 92780

PREPARED BY:

RRUS-32 (1)

NONE

NONE



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В	02/22/18	REVISED PER COMMENTS	SM
0	06/19/18	100% FOR CONSTRUCTION	SH
EDI	IOD NO.		

1 JOB NO: 8117000509

SITE INFO:

NORTH RANCH 4997 KILBURN COURT OAK PARK, CA 91377 SBOV22/LTE 5C (850)/6C (AWS-3) 7C (700-B14)

SHEET TITLE:

EXISTING RF DATA

SH

CHECKED BY:

CS

A-10

cs ATE: 01/12/18

SPACE NOT USED

# PROPOSED RF DATA FOR SECTOR A

REPLACE ANTENNA		ANTENNA MODEL	ANTENNA VENDOR	ANTENNA SIZE (HxWxD)	ANTENNA AZIMUTHS	ANTENNA RAD CENTER (FEET)	TMA/LNA (MODEL/QTY)	RRU – 700 BAND (MODEL/QTY)	RRU – 850 BAND (MODEL/QTY)	RRU — 1900 BAND (MODEL/QTY)	RRU — AWS BAND (MODEL/QTY)	RRU – WCS BAND (MODEL/QTY)	RRU — ANY BAND (MODEL/QTY)
YES	1	QS4658-7	QUINTEL	57"x13.8"x8.1"	A 0°	46	DTMABP7819VG12A/78211273V04 (2)	RRUS-E2 (1)	NONE	RRUS-12 (2)	RRUS-32 B66 (1)	NONE	RRUS -B14 4478 (1)
NO	2	ET-X-UW-70-13-70-17-iR-AT	KMW	53.8"12"6.3"	A 0°	41	TMA23-11A (1)	RRUS-11 (1)	RRUS -B5 4478 (1)	NONE	NONE	RRUS-32 (1)	NONE

# PROPOSED RF DATA FOR SECTOR B


REPLACE ANTENNA			ANTENNA VENDOR	ANTENNA SIZE (HxWxD)	ANTENNA AZIMUTHS	ANTENNA RAD CENTER (FEET)	TMA/LNA (MODEL/QTY)	RRU — 700 BAND (MODEL/QTY)	RRU — 850 BAND (MODEL/QTY)	RRU — 1900 BAND (MODEL/QTY)	RRU — AWS BAND (MODEL/QTY)	RRU – WCS BAND (MODEL/QTY)	RRU – ANY BAND (MODEL/QTY)
YES	1	QS4658-7	QUINTEL	57"x13.8"x8.1"	B 240*	46	DTMABP7819VG12A/78211273V04 (2)	RRUS-E2 (1)	NONE	RRUS-12 (2)	RRUS-32 B66 (1)	NONE	RRUS -B14 4478 (1)
NO	2	ET-X-UW-70-13-70-17-iR-AT	KMW	53.8"12"6.3"	B 240*	41	TMA23-11A (1)	RRUS-11 (1)	RRUS -B5 4478 (1)	NONE	NONE	RRUS-32 (1)	NONE


# PROPOSED RE DATA FOR SECTOR C


	THE GOLD THE BRITAIN SECTION S												
REPLACE ANTENNA		ANTENNA MODEL	ANTENNA VENDOR	ANTENNA SIZE (HxWxD)	ANTENNA AZIMUTHS	ANTENNA RAD CENTER (FEET)	TMA/LNA (MODEL/QTY)	RRU — 700 BAND (MODEL/QTY)	RRU — 850 BAND (MODEL/QTY)	RRU — 1900 BAND (MODEL/QTY)	RRU — AWS BAND (MODEL/QTY)	RRU — WCS BAND (MODEL/QTY)	RRU – ANY BAND (MODEL/QTY)
YES	1	QS4658-7	QUINTEL	57"x13.8"x8.1"	C 120°	46	DTMABP7819VG12A/78211273V04 (2)	RRUS-E2 (1)	NONE	RRUS-12 (2)	RRUS-32 B66 (1)	NONE	RRUS -B14 4478 (1)
NO	2	ET-X-UW-70-13-70-17-iR-AT	KMW	53.8"12"6.3"	C 120°	41	TMA23-11A (1)	RRUS-11 (1)	RRUS -B5 4478 (1)	NONE	NONE	RRUS-32 (1)	NONE

JUMPERS NOT TO EXCEED 10 FEET WITHOUT RAN APPROVAL.

PROPOSED RF DATA

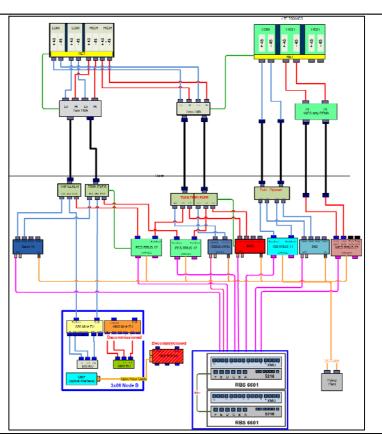

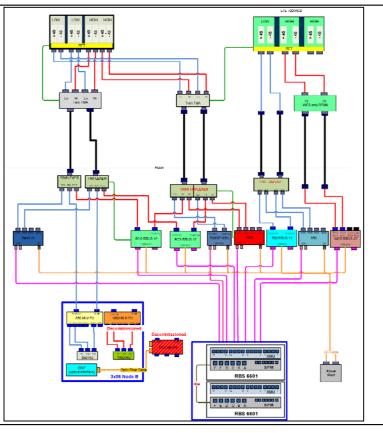

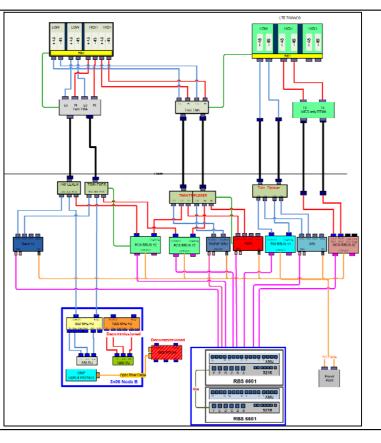

APPLICANT:



1452 EDINGER AVE. TUSTIN, CA 92780

PREPARED BY:



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## SUBMITTALS

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Α	01/15/18	90% CONSTRUCTION	SH
В	02/22/18	REVISED PER COMMENTS	SM
0	06/19/18	100% FOR CONSTRUCTION	SH
EBI	JOB NO:		

8117000509

SITE INFO:

NORTH RANCH 4997 KILBURN COURT OAK PARK, CA 91377 SBOV22/LTE 5C (850)/6C (AWS-3) 7C (700-B14)

PROPOSED RF DATA & ANTENNA LAYOUT DIAGRAMS

SH CHECKED BY: CS

01/12/18

A-11

ANTENNA LAYOUT DIAGRAM

#### NOTES TO CONTRACTOR

- ALL DRAWINGS SHALL BE READ IN CONJUNCTION WITH ARCHITECTURAL AND ENGINEERING DRAWINGS AND SPECIFICATIONS.
- THE LOCATION OF EQUIPMENT, CONDUIT AND DEVICES SHOWN ON THE PLANS ARE DIAGRAMMATIC. EXACT LOCATION AND ROUTING SHALL BE DETERMINED BY THE CONTRACTOR IN THE FIELD PRIOR TO INSTALLATION.
- ELECTRICAL CHARACTERISTICS OF ALL EQUIPMENT (NEW AND EXISTING) SHALL BE FIELD VERIFIED WITH THE OWNER'S REPRESENTATIVE AND EQUIPMENT SUPPLIER PRIOR TO ROUGH-IN OF CONDUITS. ALL EQUIPMENT SHALL BE PROPERLY CONNECTED ACCORDING TO THE NAMEPLATE DATA FURNISHED ON THE EQUIPMENT (THE DESIGN OF THESE PLANS ARE BASED UPON BEST AVAILABLE INFORMATION AT THE TIME OF DESIGN DRAWINGS). LOCATION OF OUTLETS, BOXES, ETC. AND THE TYPE OF CONNECTION (PLUG OR DIRECT), SHALL BE CONFIRMED WITH THE OWNER'S REPRESENTATIVE PRIOR TO ROUGH-IN.
- ELECTRICAL EQUIPMENT SHALL BE FIRMLY SECURED TO THE SURFACE ON WHICH IT IS MOUNTED.
- COMMUNICATION FOUIPMENT AND RACEWAYS SHALL COMPLY WITH REQUIREMENTS OF NEC CHAPTER 8 AND ARTICLE 480 WHERE APPLICABLE.

#### **ELECTRICAL SPECIFICATIONS**

#### SECTION 16010 - GENERAL PROVISIONS

- THIS CONTRACTOR SHALL GUARANTY FULLY ALL WORKMANSHIP, MATERIAL, EQUIPMENT, SYSTEMS, ETC., PROVIDED BY HIM FOR A PERIOD OF ONE YEAR AFTER SUBSTANTIAL COMPLETION OF THE PROJECT. ALL EQUIPMENT SHALL BE PROVIDED IN NEW CONDITION AND BE COVERED BY A FULL MANUFACTURER'S WARRANTY OF NOT LESS THAN THREE YEARS.
- ALL WORK SHALL BE PERFORMED IN ACCORDANCE WITH THE LATEST EDITIONS OF THE APPLICABLE STATE, NATIONAL AND LOCAL ORDINANCES BUILDING CODES AND THE NATIONAL ELECTRIC CODE, AND THE TERMS AND THE CONDITIONS OF THE AUTHORITIES HAVING LAWFUL JURISDICTION PERTAINING TO THE WORK REQUIRED ALL MODIFICATIONS REQUIRED BY THESE CODES, RULES, REGULATIONS, AND AUTHORITIES SHALL BE MADE BY THE CONTRACTOR WITHOUT ADDITIONAL CHARGE TO THE OWNER.
- ALL MATERIALS, APPLIANCES, EQUIPMENT, OR DEVICES SHALL BE NEW AND SHALL BE SPECIFICATION GRADE AND LISTED, LABELED AND CERTIFIED BY UNDERWRITER'S LABORATORIES INC. FOR THE USE. ALL OUTDOOR ELECTRICAL ENCLOSURES SHALL BE WEATHERPROOF AND BE NEMA 250, TYPE 3R RATED, OR BETTER.

#### SECTION 16075 - ELECTRICAL IDENTIFICATION

- PROVIDE AND INSTALL WARNING, CAUTION AND INSTRUCTION SIGNS WHERE REQUIRED TO COMPLY WITH N.F.C AND OSHA REGULATIONS AND WHERE NEEDED TO ENSURE SAFE OPERATION AND MAINTENANCE OF ELECTRICAL SYSTEMS AND OF ITEMS TO WHICH THEY CONNECT. ALL LABELS SHALL BE SUITABLE FOR EXTERIOR USE WHEN INSTALLED OUTDOORS.
- ALL ELECTRICAL EQUIPMENT SHALL BE MARKED AND LABELED FOR IDENTIFICATION PURPOSES WITH PHENOLIC NAMEPLATES SIZED IN RELATION TO THE APPARATUS AND ATTACHED ON THE EXTERIOR SURFACES INDICATING THE EQUIPMENT DESIGNATION, OPERATING VOLTAGE AND THE SOURCE SUPPLYING THE EQUIPMENT. ENGRAVED LABEL SHALL BE PROVIDED ON METER SOCKET ENCLOSURE.
- ALL CABLES OR CONDUCTORS SHALL BE IDENTIFIED WITH CIRCUIT IDENTIFICATION MARKERS IN EACH PULL BOX. J-BOXES, EQUIPMENT BOXES AND CABINETS WITH APPROVED PLASTIC TAGS OR APPROVED EQUAL.
- ALL DIRECT BURIED CONDUITS SHALL BE PROVIDED WITH 6" WIDE 5 MIL THICK ALUMINIZED PLASTIC WARNING TAPE IDENTIFYING CONTENTS. TAPE COLORS SHALL BE ORANGE FOR TELEPHONE AND RED FOR ELECTRIC.
- E. ALL LABELS AND PANEL DIRECTORIES SHALL BE TYPEWRITTEN, NOT HAND
- F. INSTALL LABEL ON EACH ACCESSIBLE SIDE OF ENERGIZED EQUIPMENT TO READ: MAINTAIN 30"(MIN)W X 36"D X 78"H CLEAR WORKING SPACE.

#### SECTION 16110 - RACEWAYS, BOXES AND FITTINGS

- INSTALL ALL CONDUIT AS REQUIRED FOR THIS CONTRACT PER NEC BY TYPE AND USE, UNLESS NOTED OTHERWISE WITHIN THIS SPECIFICATION
- B. EXERCISE PARTICULAR CARE IN ROUTING AND GROUPING EXPOSED CONDUIT

- TO PRESENT NEAT AND WORKMANLIKE APPEARANCE WITH ALL LINES RUNNING PARALLEL WITH OR PERPENDICULAR TO SITE LINES AND
- C. CUT ALL CONDUITS WITH AN APPROVED CUTTING MACHINE AND REAM AFTER THREADING TO REMOVE ALL BURRS.
- D. WHERE SIZE IS NOT SPECIFIED ON DRAWINGS, THE CONTRACTOR SHALL SIZE CONDUIT, JUNCTION BOX AND/OR PULL BOXES PER N.E.C BASED ON WIRING REQUIREMENT. THE CONTRACTOR SHALL PROVIDE PULL BOXES AND JUNCTION BOXES WHERE SHOWN ON THE DRAWINGS OR NOT SHOWN, AND AS REQUIRED BY N.E.C TO LIMITED BENDS IN CONDUITS TO AN EQUIVALENT OF (4) 90-DEGREE BENDS.
- E. INSTALL FACTORY ELBOWS ON 2" AND ABOVE CONDUIT. FIELD BENDS AND OFFSETS SHALL BE MADE WITH AN APPROVED BENDING MACHINE. USE CONDUIT BODIES ASSEMBLY TO FACILITATE PULLING OF CONDUCTORS OR TO MAKE CHANGES IN CONDUIT DIRECTION TO AVOID CONFLICT IN CONFINED
- F. BURIED ELECTRICAL DUCTS SHALL USE SCHEDULE 40 RIGID PVC PLASTIC CONDUIT WITH WATERTIGHT JOINTS (SCHEDULE 80 WHERE EXPOSED TO VEHICULAR TRAFFIC). ALL UNDERGROUND/BURIED 90° ELLS SHALL BE RIGID TYPE FITTINGS. ALL PVC CONDUITS BURIED LESS THAN 18" BELOW GRADE SHALL BE SCHEDULE 80.
- G. DRY INTERIOR LOCATIONS SHALL BE ELECTRICAL METALLIC TUBING (EMT) UNLESS NOTED OTHERWISE WITH STEEL COMPRESSION TYPE FITTINGS. THE USE OF SET SCREW FITTING IS NOT PERMITTED - NO EXCEPTION.
- H. PROVIDE INSULATED BUSHINGS TO PREVENT ABRASION OF WIRES AND DOUBLE LOCKNUTS ON CONDUITS ENTERING OR LEAVING JUNCTION BOXES, ELECTRICAL DEVICES AND EQUIPMENT CABINETS. EQUIP ALL RGS CONDUIT WITH GROUND BUSHINGS AND GROUND IT TO THE COMMON GROUNDING ELECTRODE SYSTEM.
- AVOID CONDENSATION POCKETS IN INSTALLATIONS. KEEP CONDUIT, FITTINGS AND BOXES FREE FROM FOREIGN MATTER BEFORE, DURING AND AFTER
- J. ALL CONDUITS, INCLUDING THOSE WITH NEW CABLES INSTALLED, SHALL HAVF A NYLON PULL ROPE INSTALLED TO FACILITATE FUTURE PULL.
- K. THE MINIMUM SIZE OF CONDUIT SHALL BE 3/4" UNLESS NOTED OTHERWISE.

### SECTION 16120 - CONDUCTORS

- A. ALL POWER WIRE SHALL BE TYPE THHN/THWN INSULATED SINGLE COPPER CONDUCTOR, RATED AT 600 VOLTS 90°C TO COMPLY WITH UL & NEMA WC 70. MINIMUM WIRE SIZE FOR CURRENTS UP TO 20 AMPERE SHALL BE #12 AWG. USE STRANDED COPPER WIRE FOR ALL APPLICATIONS. USE OF ALUMINUM CONDUCTORS WILL NOT BE PERMITTED.
- B. USE MANUFACTURER—APPROVED PULLING COMPOUND OR LUBRICANT WHERE NECESSARY; COMPOUND USED MUST NOT DETERIORATE CONDUCTOR OR
  - DO NOT EXCEED MANUFACTURER'S RECOMMENDED MAXIMUM PULLING TENSIONS AND SIDEWALL PRESSURE VALUES.
- C. USE PULLING MEANS; INCLUDING FISH TAPE, CABLE, ROPE, AND BASKET-WEAVE WIRE/CABLE GRIPS THAT WILL NOT DAMAGE CABLES OR
- D. CONDUCTOR LENGTHS SHALL BE CONTINUOUS FROM TERMINATION TO TERMINATION WITHOUT SPLICES AS MUCH AS POSSIBLE. SPLICES, JOINTS AND CONNECTIONS IN
  - CABLE SHALL BE MADE ONLY IN PULL BOXES, JUNCTION BOXES OR MANHOLES. CABLE SHALL BE LOOPED IN ALL JUNCTION BOXES AND PULL BOXES, AND RACKED IN MANHOLES.
- E. TIGHTEN ELECTRICAL CONNECTORS AND TERMINALS ACCORDING TO MANUFACTURER'S PUBLISHED TORQUE-TIGHTENING VALUES. IF MANUFACTURER'S TORQUE VALUES ARE NOT INDICATED, USE THOSE SPECIFIED IN UL 486A AND UL 486B.
- F. CONNECTORS AND LUGS FOR COPPER CONDUCTORS #8 AND SMALLER: 3M SCOTCHLOK SERIES 61 SNAP SPADE, OR ACCEPTABLE EQUAL OR T & B STA-KON COMPRESSION OR INDENT TYPE CONNECTORS WITH INTEGRAL OR SEPARATE INSULATING CAPS. FOR COPPER CONDUCTORS LARGER THAN #8: SOLDERLESS, INDENT, HEX SCREW OR BOLT TYPE PRESSURE CONNECTORS,

PROPERLY TAPED OR INSULATED.

- G. PROVIDE ADEQUATE LENGTH OF CONDUCTORS WITHIN ELECTRICAL ENCLOSURES AND TRAIN THE CONDUCTORS TO TERMINATION POINTS WITH NO EXCESS. MAKE TERMINATIONS SO THERE IS NO BARE CONDUCTOR AT THE TERMINAL.
- H. COLOR CODE, PHASE, NEUTRAL, AND GROUND CONDUCTORS COLOR-CODED IN ACCORDANCE WITH NEC. IDENTIFY ALL CONDUCTORS OF THE SAME PHASE CONDUCTOR TO THE SAME COLOR CODE. SUGGESTED COLOR CODING FOR 120/208V, SHOULD BE BLACK, RED. BLUE, WHITE, AND 277/480V, SHOULD BE BROWN, ORANGE, YELLOW, GRAY WITH GREEN FOR ALL FOUIPMENT GROUND CONDUCTORS.
- EACH CONDUIT OR RACEWAY THAT HAS A PHASE CONDUCTOR SHALL ALSO CONTAIN A GREEN INSULATED GROUNDING CONDUCTOR SIZED PER N.E.C, UNLESS OTHERWISE INDICATED.

AFTER THE ELECTRICAL EQUIPMENT AND THE WIRING IS INSTALLED, BUT BEFORE ELECTRICAL CONNECTIONS TO EQUIPMENT, TEST PHASE-TO-PHASE AND PHASE-TO-GROUND INSULATION ON SERVICE ENTRANCE AND FEEDERS TO ENSURE THAT THEY HAVE THE PROPER INSULATION AND ARE FREE OF GROUND FAULT. SYSTEMS RATED ABOVE 250 VOLTS SHALL BE TESTED WITH A 1000 VOLT MEGGER. CIRCUITS RATED AT OR BELOW 250 VOLTS SHALL BE TESTED WITH A 500 VOLT MEGGER

J. CORRECT MALFUNCTIONING CONDUCTORS AND CABLES, WHERE POSSIBLE, AND RETEST TO DEMONSTRATE COMPLIANCE; OTHERWISE, REMOVE AND REPLACE WITH NEW UNITS AND RETEST AS SPECIFIED. PER NEC770.3(A) THE REQUIREMENTS OF 300.21 FOR ELECTRICAL INSTALLATIONS SHALL ALSO APPLY TO INSTALLATIONS OF OPTICAL FIBER CABLES AND RACEWAYS. THE ACCESSIBLE PORTION OF ABANDONED OPTICAL FIBER CABLES SHALL BE

SECTION 16410 - ENCLOSED SWITCHES AND CIRCUIT BREAKERS

- A. MOLDED-CASE CIRCUIT BREAKER TO COMPLY WITH NEMA AB 1, WITH INTERRUPTING CAPACITY TO MEET RATING TO MATCH EXISTING OR AS REQUIRED FOR AVAILABLE FAULT CURRENTS. DO NOT USE SERIES RATING FOR NEW FOUIPMENT. IF EXISTING SERIES RATED EQUIPMENT IS SPECIFIED FOR USE IN THIS PROJECT, THEN PROVIDE 'CAUTION' MARKING ON THE EXISTING EQUIPMENT ENCLOSURE THAT ARE SERIES RATED AS DESCRIBED IN NEC 110-22.
- B. PROVIDE MOLDED CASE, SNAP-IN TYPE, THERMAL MAGNETIC TRIP, SINGLE, TWO OR THREE POLE BRANCH CIRCUIT BREAKERS AS SHOWN ON DRAWINGS. MULTIPLE POLE BREAKERS SHALL BE SINGLE HANDLE, COMMON TRIP AND MADE BY EQUIPMENT MANUFACTURER.
- C. PROVIDE ENCLOSURE TO COMPLY WITH NEMA AB 1 AND NEMA KS 1 TO MEET ENVIRONMENTAL CONDITIONS OF INSTALLED LOCATION. OUTDOOR LOCATIONS SHALL BE NEMA 250, TYPE 3R.
- D. VERIFY EXISTENCE OF NEC 110.26 REQUIRED CLEAR WORKING SPACE AT THE FRONT OF ELECTRICAL EQUIPMENT PRIOR TO INSTALLATION.

APPLICANT:



1452 EDINGER AVE. TUSTIN, CA 92780

PREPARED BY:



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#### SUBMITTALS

332:111111120									
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В	02/22/18	REVISED PER COMMENTS	SM						
0	06/19/18	100% FOR CONSTRUCTION	SH						

EBI JOB NO: 8117000509

SITE INFO:

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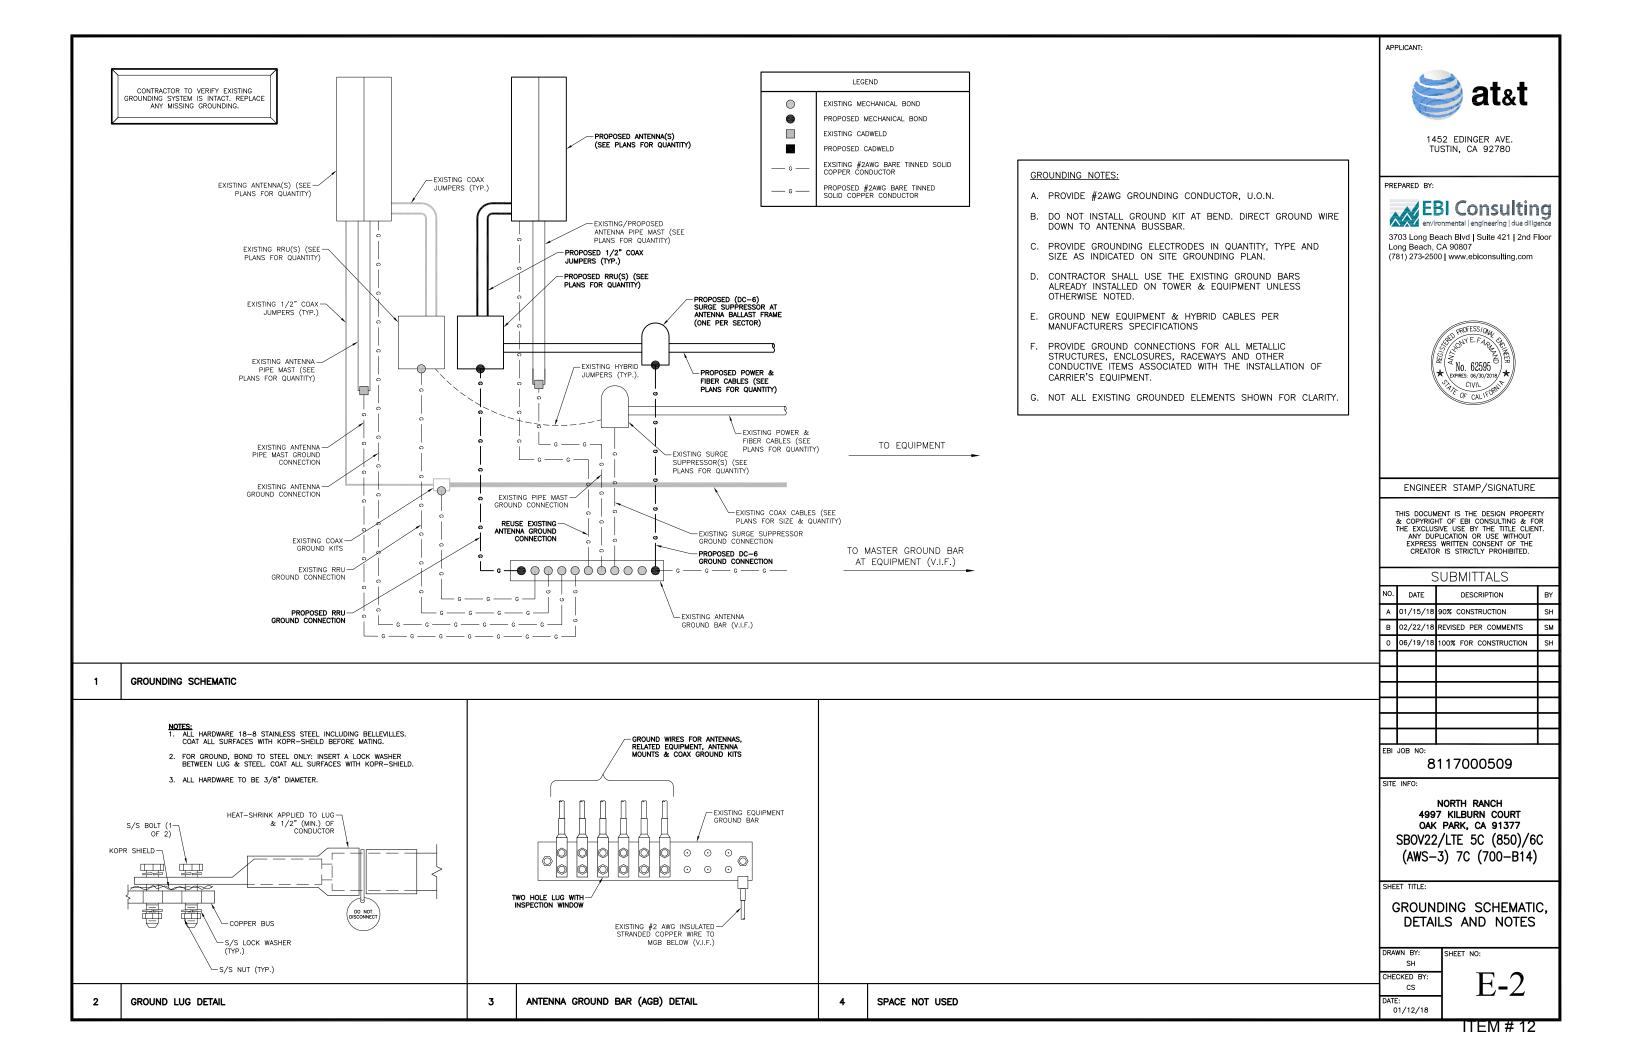
SHEET TITLE:

**ELECTRICAL NOTES & SPECIFICATIONS** 


SHEET NO


SH CHECKED BY

ELECTRICAL NOTES AND SPECIFICATIONS



NOTE:
EXISTING FLANGE PLATE DIAMETER IS ASSUMED
TO BE 1'-10"Ø, GENERAL CONTRACTOR NEEDS
TO VERIFY THIS INFORMATION AND NOTIFY
MASER CONSULTING, P.A. WITH ANY DIFFERENT
FOR A DESIGN REVISION,

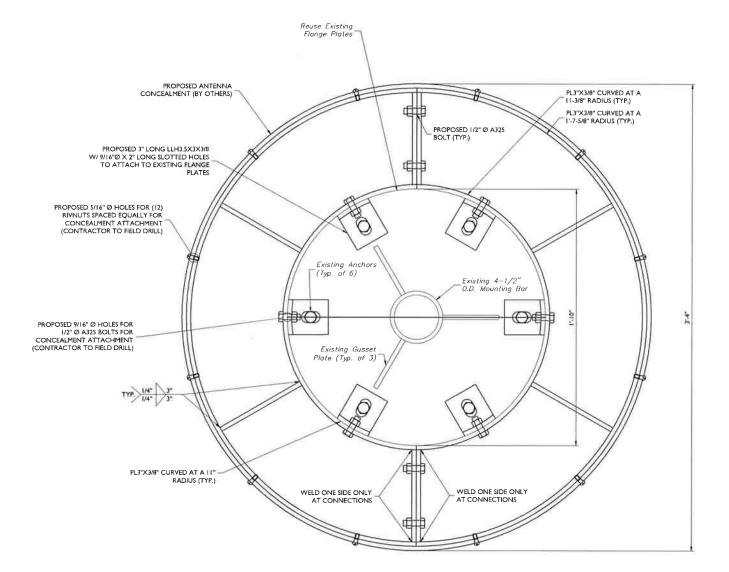

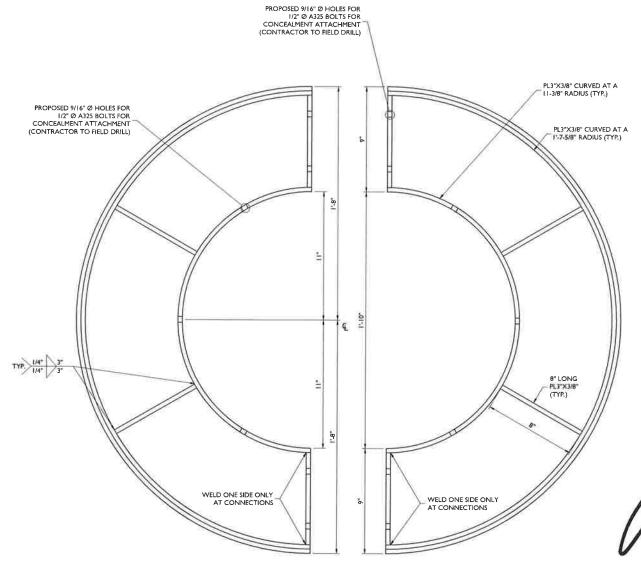

SHROUD CONNECTION DETAIL (TOP AND BOTTOM)

NOT TO SCALE

SHROUD MOUNTING DETAIL



EBI Consulting

PROTECT YOURSELF

ALL STATES REQUIRE NOTIFICATION OF
EXCAVATORS, DESIGNEES, OR, ANY PERSO,
PREPARAING TO DISTURB THE EARTH'S
SURFACE ANYWHERE IN ANY STATE

18975003A

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AS SHOWN

emat sol

2000 Midlantic Drive Suite 100 Mount Laurel, NJ 0805 Phone: 856.792.0412 Fax: 856.722.1120

email: solutions@maserconsulting.com


STRUCTURAL DETAILS-I

EBI JOB: 8117000509


SBOV22 NORTH RANCH 4997 KILBURN COURT OAK PARK, CA 91377

S-1

ITEM # 12

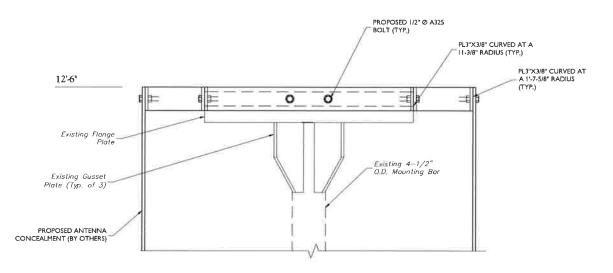

# SHROUD CONNECTION DETAIL (TOP)

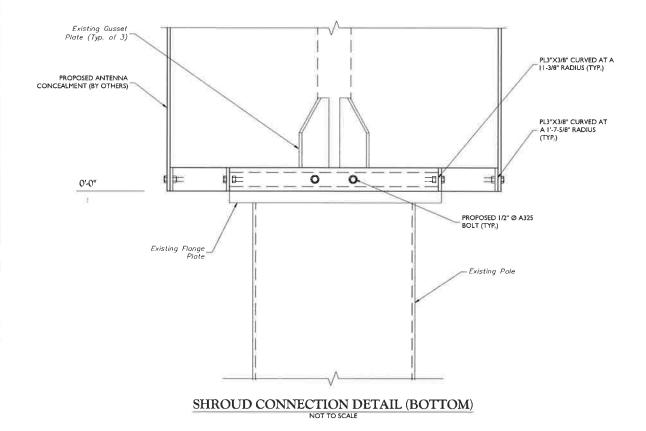

#### STRUCTURAL NOTES

ALL STEEL WORK SHALL GALVANIZED IN ACCORDANCE WITH ASTM 123 SPECIFICATIONS UNLESS NOTED OTHERWISE AND SHALL BE THE FOLLOWING MATERIALS:

a. W-SHAPES ASTM A992 b. CHANNELS, ANGLES, PLATES ASTM A36 c. TUBES ASTM A500 GR, B 46 d. PIPES ASTM AS3 GR. B.

- SHOP AND FIELD WELDING SHALL BE PERFORMED BY WELDERS THAT ARE CERTIFIED (AWS "STANDARD QUALIFICATION PROCEDURE") TO
  PERFORM THE TYPE OF WORK REQUIRED, WELDS SHALL CONFORM TO AMERICAN WELDING SOCIETY (AWS) DILI "STRUCTURAL WELDING CODE - STEEL". PROVIDE THE MINIMUM SIZE PER PART B IN THE AISC "MANUAL OF STEEL CONSTRUCTION", LRFD 3RD EDITION, WHEN WELD SIZES ARE NOT SHOWN, USE E70XX ELECTRODES FOR ALL WELDING,
- 3. GALVANIZED COATING THICKNESS TO BE G90.
- 4. ALL CONNECTIONS SHALL BE IN STRICT ACCORDANCE WITH THE AISC SPECIFICATIONS AND AWS CODES, UNLESS OTHERWISE SHOWN, ALL BOLTED FRAMING CONNECTIONS SHALL USE 3/4" DIAMETER ASTM A325 BOLTS DESIGNED AND DETAILED AS BEARING-TYPE CONNECTIONS IN ACCORDANCE WITH THE 1985 AISC SPECIFICATION FOR STRUCTURAL JOINTS USING ASTM A325 (SURFACE CONDITION SHALL BE CLASS A OR BETTER AND FASTENER TENSION IN ACCORDANCE WITH TABLE 4), CONNECTIONS NOT SHOWN SHALL BE AS SHOWN IN TABLE II OF THE AISC "LOAD AND RESISTANCE FACTOR DESIGN OF SIMPLE SHEAR CONNECTIONS" USING THE MAXIMUM NUMBER OF ROWS OF BOLTS FOR EACH BEAM SIZE, ALL WELDED FRAMING CONNECTIONS SHALL HAVE A CAPACITY NO LESS THAN THAT OF AN EQUIVALENT BOLTED CONNECTION AS STATED ABOVE.
- 5. UNLESS NOTED OTHERWISE ALL BOLTS SHALL BE INSTALLED WITH HEADS UP OR TOWARD THE OUTSIDE FACE, AND NUTS DOWN OR ON THE SIDE MOST PROTECTED FROM WEATHER.
- USE PRECAUTIONS & PROCEDURES PER AWS DI., I WHEN WELDING GALVANIZED MATERIALS, AT COMPLETION OF WELDING, ALL DAMAGE TO GALVANIZED COATING SHALL BE REPAIRED.
- TOUCHUP ALL DAMAGE GALVANIZED STEEL WITH COLD ZINC, "GALVANOX", "DRY GALV,", "ZINC-IT" OR APPROVED EQUIVALENT, IN ACCORDANCE WITH MANUFACTURER'S GUIDELINES. TOUCHUP DAMAGED NON GALVANIZED STEEL WITH SAME PAINT APPLIED IN SHOP
- 8. ALL STRUCTURAL STEEL SHALL BE DETAILED, FABRICATED AND ERECTED IN ACCORDANCE WITH THE CURRENT EDITION OF AISC "SPECIFICATIONS FOR DESIGN, FABRICATION AND ERECTION OF STRUCTURAL STEEL FOR BUILDINGS - LOAD AND RESISTANCE FACTOR
- 9. SHOP DRAWINGS MUST BE SUBMITTED TO ENGINEER OF RECORD FOR REVIEW PRIOR TO ANY FABRICATION. SHOP DRAWINGS MUST GIVE COMPLETE INFORMATION NECESSARY FOR THE FABRICATION OF THE COMPONENT PARTS OF THE FRAMING STRUCTURE, INCLUDING THE LOCATION, TYPE, AND SIZE OF ALL WELDS, BOLTS AND THE ACTUAL FABRICATION. THESE DRAWINGS SHALL CLEARLY DISTINGUISH BETWEEN SHOP AND FIELD WELDS AND BOLTS AND CLEARLY IDENTIFY TYPE OF HIGH-STRENGTH BOLTED CONNECTION (SNUG-TIGHT, OR FULLY TIGHTENED BEARING, OR SLIP-CRITICAL).
- 10. SHOP PAINTING AND SURFACE PREPARATION OF STRUCTURAL STEEL COMPONENTS SHALL BE IN ACCORDANCE WITH THE PROVISIONS OF STEEL CONSTRUCTION, INC.
- THE EQUIPMENT PLATFORM SHALL BE IN ACCORDANCE WITH CURRENT OSHA REGULATIONS.
- 12. MEMBERS SHALL BE LAID PLUMB AND TRUE AS SHOWN ON THE DRAWINGS.
- 13. COPE ALL FRAMING AT ENDS AS NECESSARY, UNLESS NOTED OTHERWISE.
- 14. THE CONTRACTOR SHALL COORDINATE ROOF PENETRATIONS AND FLASHING OPENINGS WITH THE BUILDING OWNER AND THE EXISTING ROOF INSTALLER, WORK SHALL BE PERFORMED IN A WORKMANLIKE MANNER TO MAINTAIN ANY EXISTING ROOFING
- 15. ALL WORK SHALL BE DONE IN ACCORDANCE WITH THE EXISTING ROOFING MANUFACTURER'S WRITTEN RECOMMENDATIONS, INSTRUCTIONS AND DETAILS.
- 16, THE GENERAL CONTRACTOR AND THEIR SUBCONSULTANTS SHALL BE RESPONSIBLE FOR OBTAINING ALL PERMITS AND INSPECTIONS WHICH MAY BE REQUIRED FOR THE WORK.
- 17. THE STRUCTURAL ADDITION HAS BEEN DESIGNED FOR THE FOLLOWING PROPOSED LOADS:

<u>SPECIFIC LOADING:</u>
BASIC WIND LOADING - 85 MPH PER 2016 CALIFORNIA BUILDING STANDARDS CODE & TIA-2220G TOPOGRAPHY CATEGORY 4 WITH CREST HEIGHT OF 300 FT SEISMIC RESPONSE ACCELERATION 0,2s PERIOD - 1,5 SEISMIC RESPONSE ACCELERATION 1.0s PERIOD - 0.6





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STRUCTURAL DETAILS-2

ITEM#12

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