


PROPOSED SAFEROOM - TYPE 1 (SINGLE STOREY)


ARCHITECTURAL & STRUCTURAL DRAWINGS

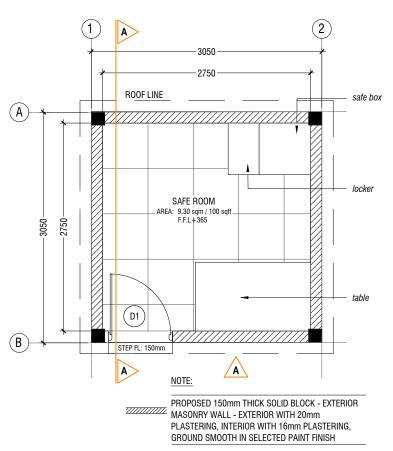


# A SAFE ROOM AREA: 9.30 sqm / 100 sqft F.F.L + 365 PROPOSED 150mm THICK SOLID BLOCK - EXTERIOR MASONRY WALL - EXTERIOR WITH 20mm PLASTERING, INTERIOR WITH 16mm PLASTERING, GROUND SMOOTH IN SELECTED PAINT FINISH


**VENT PIPE- PLAN (+2800)** 

0 0.25 0.5

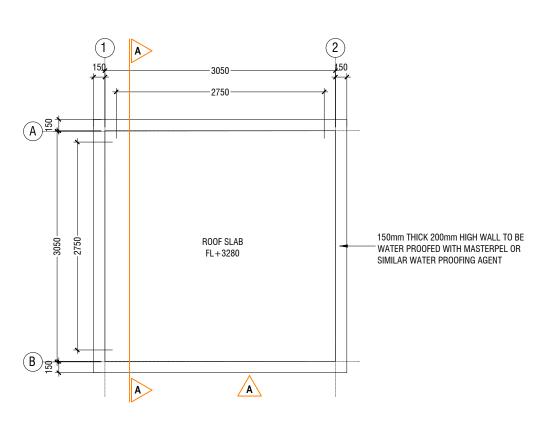


### **SECURE ROOM - PLAN**

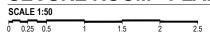


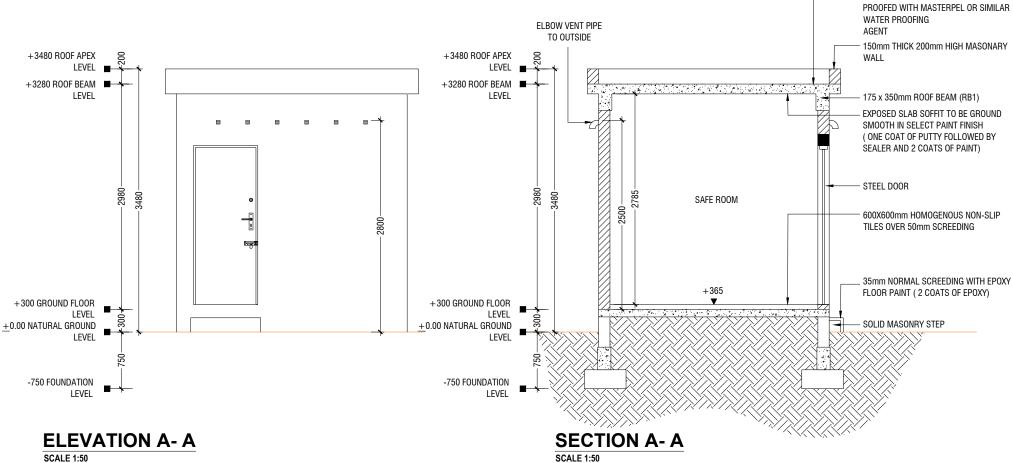

### **SECURE ROOM - PLAN**

130mm THICK SLAB TO BE WATER

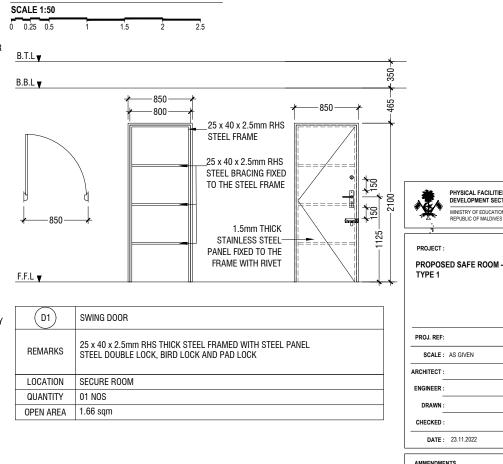

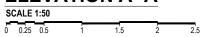

### **SECURE ROOM**


S	CALE	1:50				
0	0.25	0.5	1	1.5	2	2.5

### DOOR SCHEDULE



Issue Date Description

DWG NO: A-01/02

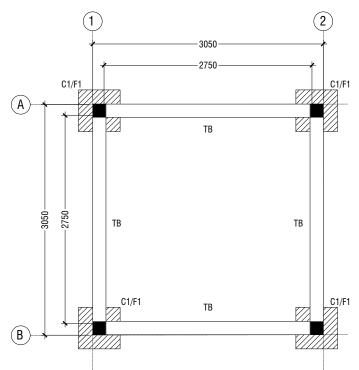

### NOTE:

### COLUMN SIZES : 175x175 mm COVER

FOLINDATION DAD SIZES

FUUNDATION FAD SIZES		
	DIMENSION	REINFORCEMENT
F1	550 x 550 x 250	T10@150 C/C B/W (B)
FOUNDATION DEPTH : 750mm BELOW GROUND LEVEL		

ALL FOOTINGS ARE TO BE LAID ON TOP OF 50mm THICK LEAN CONCRETE APPLY WATER PROOFING TO SUBSTRUCTURE

**TIE BEAM SIZES** 

: 175x300 mm COVER : 50mm

(BELOW GROUND ELEMENTS)

GROUND SLAB: 100MM THICK CONCRETE SLAB, R6@ 200 C/C BW SINGLE LAYER

GRADE OF CONCRETE M25

# **FOUNDATION - PLAN**

		DIMENSION (LxBxD)	REINFORCEMENT
ı	F1	550 × 550 × 250	T10@150 C/C R/M/ (R)


FOUNDATION DEPTH =

0 0.25 0.5

COVER TO FOUNDATION = 50mm COVER TO COLUMNS COVER TO BEAMS = 35mm


GRADE OF CONCRETE M25

### **FOUNDATION PADS**

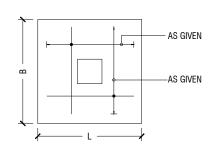



### **PLAN**

### STRUCTURAL DETAILS

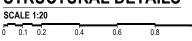

### **SECURE ROOM**

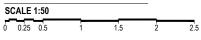

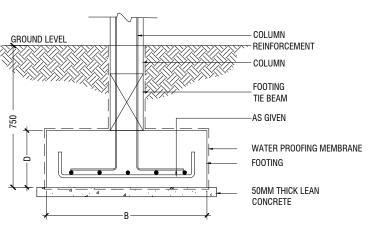


### **SECTION**

0 0.1 0.2

### **FOOTING DETAILS**



0.4 0.6

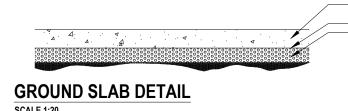

## LINTEL/SILL BEAM DETAIL

(A)

(B)

0 0.25 0.5

-- 4T10 -- R6@200 C/C

**→** 175 🛧

(C1)

**COLUMN DETAILS** 

**★** 150 **★** 


(LT1)

\*LINTEL OVER DOOR

SCALE 1:20


0 0.1 0.2

**ROOF BEAM & SLAB PLAN** 

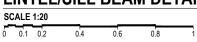

**ROOF BEAM DETAIL SCALE 1:20** 0 0.1 0.2

(RB)

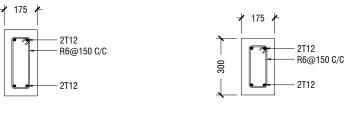

(2)

SLAB THICKNESS - 130 mm

T10@175 C/C BW T&B

-2750

RB

SCALE 1:20 0 0.1 0.2

# **FOUNDATION DETAILS**

(TB)

100mm THICK RC SLAB REINFORCEMENT WITH R6@200c/c (BW) SINGLE LAYER -61000 DAMP PROOF MEMBARANE COMPACTED EARTH

- GRADE OF CONCRETE M25

- PROPER WATER PROOFING SHALL BE APPLIED TO ALL UNDERGROUND STRUCTURES (TO CONSULTANTS SPECIFICATIONS)

-BACKFILLING SHALL BE DONE AS PER TECHNICAL SPECIFICATIONS



PHYSICAL FACILITIES DEVELOPMENT SECTION

l <u></u>			
D.	DATE: 23.11.2022		
AMMENDMENTS			
Issue	Date	Description	

DRAWN:


CHECKED


DWG NO: A-02/02




PROPOSED SAFEROOM - TYPE 1 (SINGLE STOREY)

SERVICES DRAWINGS

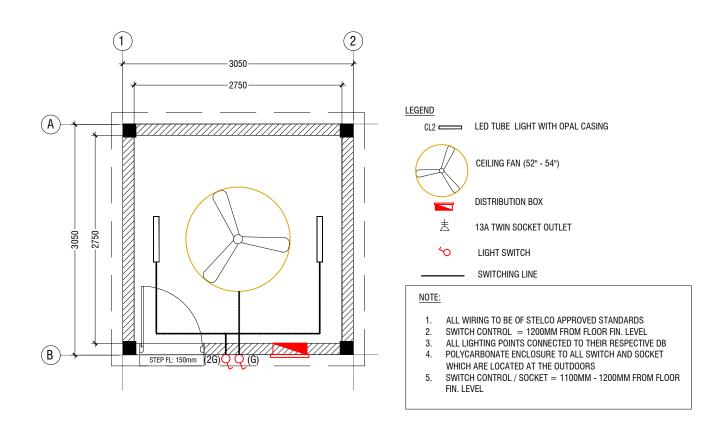

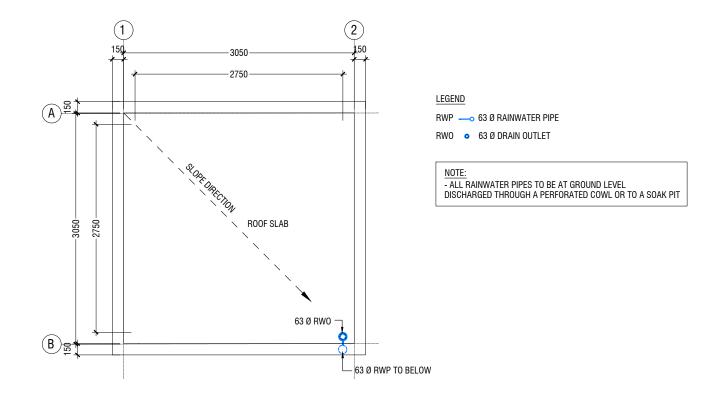

### **SECURE ROOM - LIGHTING & POWER LAYOUT**

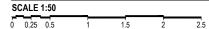

### **SECURE ROOM - DRAINAGE LAYOUT**





AMME	AMMENDMENTS		
Issue	Date	Description	

DWG NO: S-01/01