



PROJECT:
STAGE DRAWING

PROJ. REF:
SCALE: AS GIVEN

ARCHITECT:
ENGINEER:
DRAWN:
CHECKED:

AMMENDMENTS		
Issue	Date	Description


**DATE**: 12.10.2022

DWG NO: A-01/05

STAGE DETAIL


GROUND FLOOR PLAN

SCALE 1:100

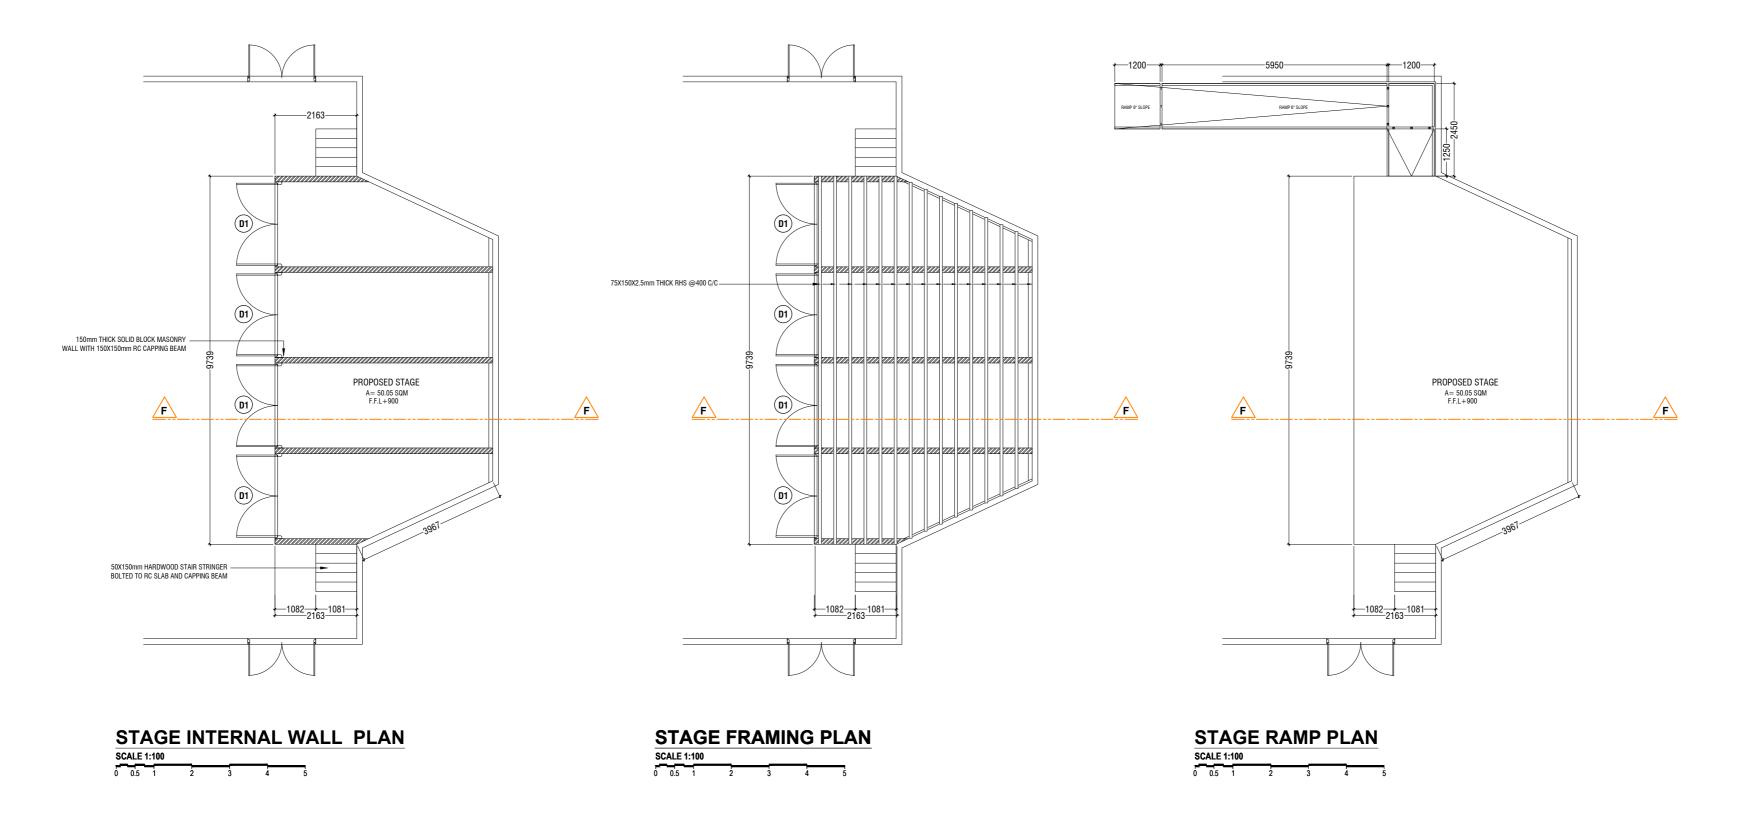


STAGE DETAIL


**GROUND FLOOR PLAN** 

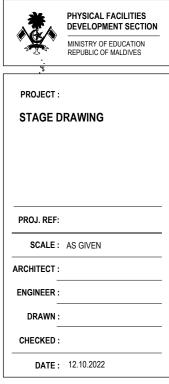

ssue	Date	Description


DWG NO: A-02/05

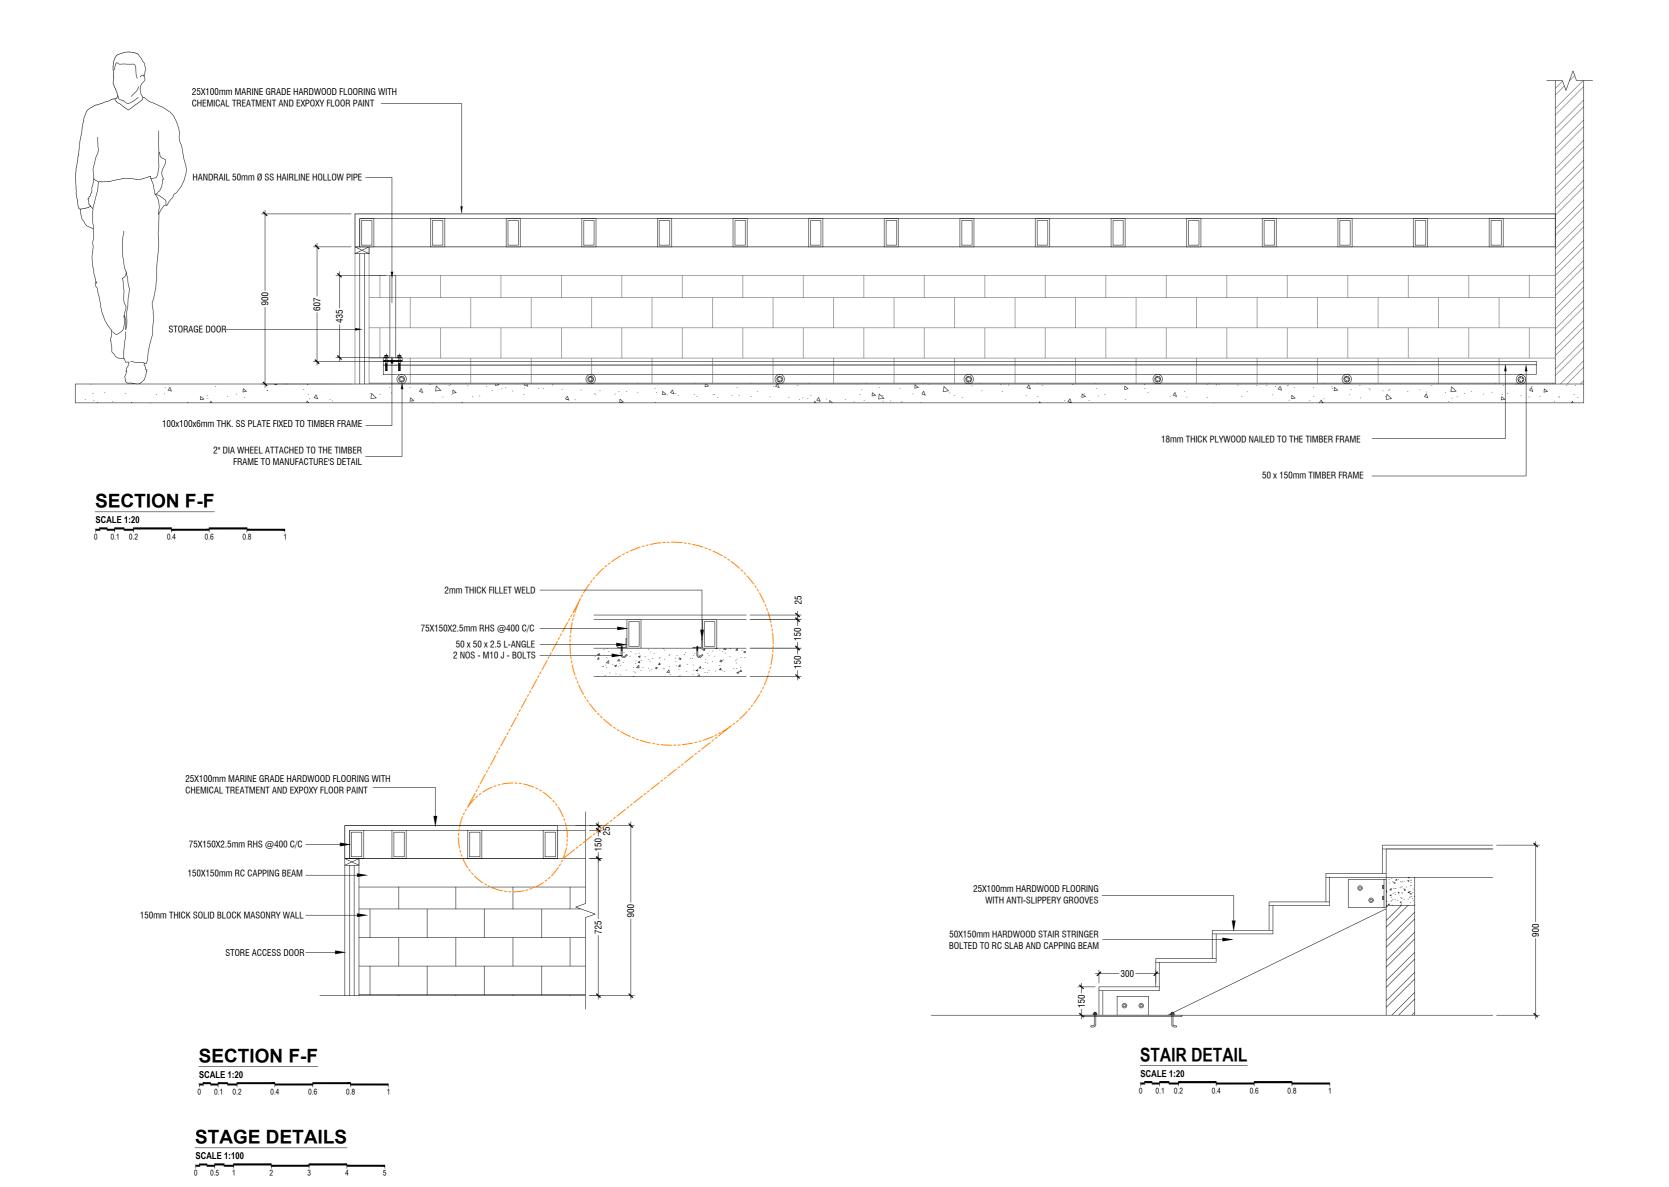

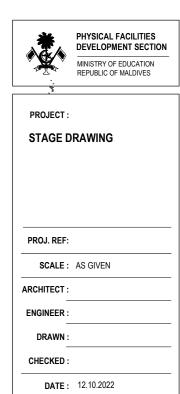



AMMENDMENTS			
Issue	Date	Description	

DWG NO: A-03/05

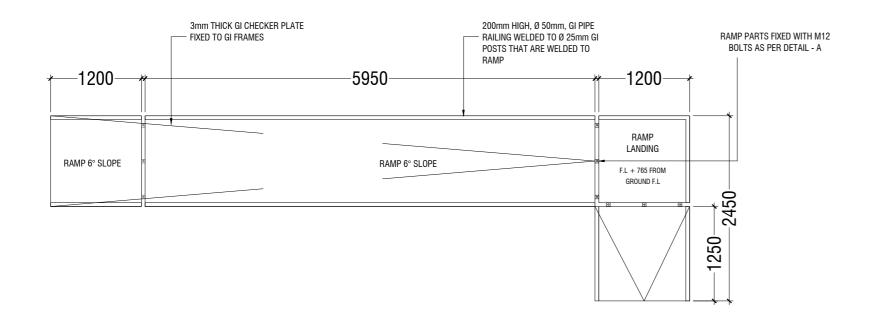



## **STAGE RAMP PLAN**

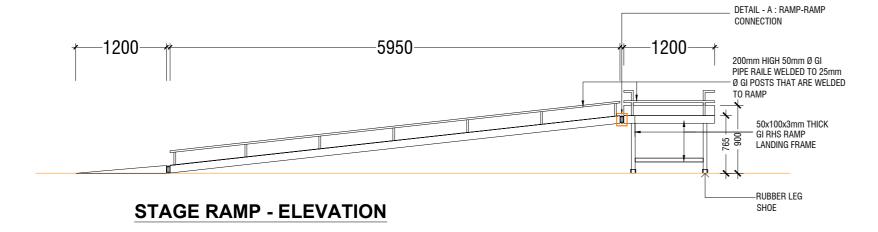

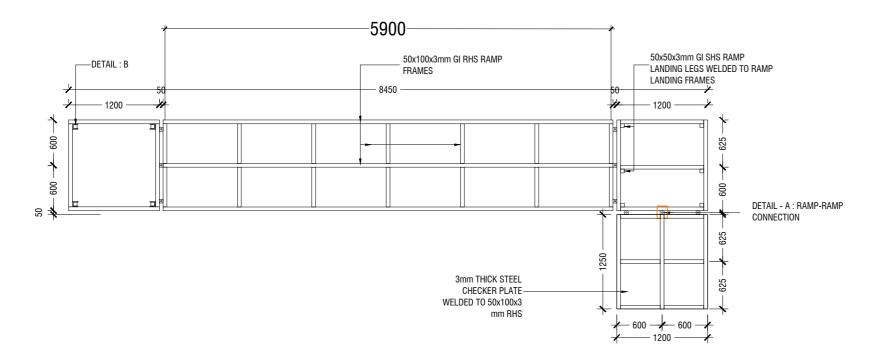


STAGE RAMP - FRAMING PLAN

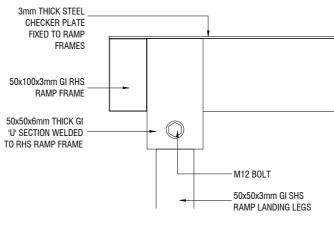


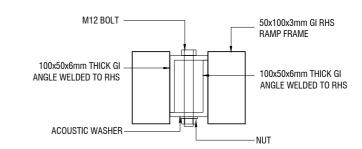

ELEVATION


<u>DETAIL - A</u>
RAMP - RAMP CONNECTION DETAIL

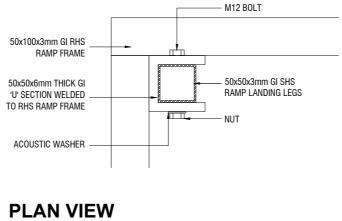

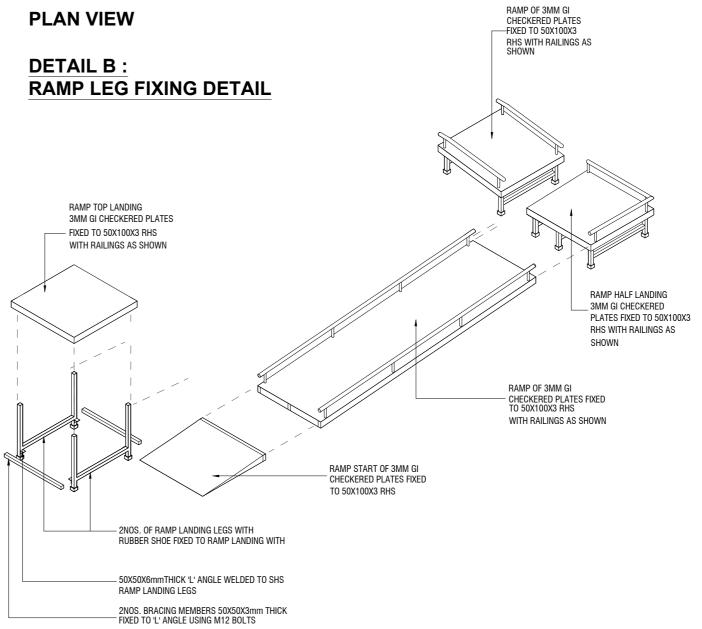

## RAMP ISOMETRIC DETAIL - 5 (STAGE RAMP DETAIL)

CALE 1:50 0.25 0.5 1 1.5 2 2

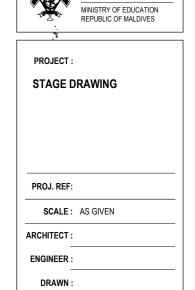


PHYSICAL FACILITIES
DEVELOPMENT SECTION


AMMENDMENTS		
ssue	Date	Description

CHECKED:

**DATE:** 12.10.2022

DWG NO: A-04/05

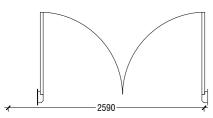

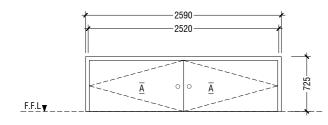

	<b>D8</b>	DOUBLE SWING DOOR
	REMARKS	50mm THICK WHITE POWDER COATED (60 MICRONS) ALUMINU FRAMED WITH ALUMINIUM PANEL
I	LOCATION	STAGE STORE ACCESS
	QUANTITY	05 NOS
	OPEN AREA	1.66 SQM

LEGEND:
FGG - FIXED CLEAR GLASS
FRG - FIXED REFLECTED GLASS
RG - REFLECTED GLASS
AL - ALUMINIUM
PVC - POLYVINYL CHLORIDE

PVC - POLYVINYL CHLORIDE

NOTE:
- FLOOR TO FLOOR HEIGHT VARIES AND WILL BE SUBJECTED TO CHANGES, LIKEWISE, THE BEAM DEPTH CHANGES AT DIFFERENT LOCATIONS OF SIMILAR DOORS/WINDOWS AND WILL BE SUBJECTED TO CHANGES

- ALL DOORS & WINDOWS TO BE CHECKED ON SITE BEFORE FABRICATION.

- ALL DOOR & WINDOWS VIEWED FROM EXTERIOR, FOR DOOR SWING, REFER TO FLOOR PLANS.

- THE DOORS / WINDOWS WHICH DO NOT TOUCH THE BEAM SHALL HAVE A LINTEL BEAM (LB)

ABOVE THE DOOR / WINDOW.

- FOR ALL THE WINDOWS PUT A SILL BEAM BELOW THE WINDOW (SB)

- FOR SAFETY PURPOSES REFER TO TECHNICAL SPECIFICATIONS FOR GLASS THICKNESS.

## **DOOR / WINDOW SCHEDULE - 2**

SCALE 1:50 0 0.25 0.5 1 1.5 2 2.5



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