

PROJECT :
STAGE DRAWING

PROJ. REF: _____

SCALE : AS GIVEN

ARCHITECT : _____

ENGINEER : _____

DRAWN : _____


CHECKED : _____

DATE : 12.10.2022


AMMENDMENTS		
Issue	Date	Description

DWG NO : **A-01/05**


STAGE DETAIL
GROUND FLOOR PLAN
SCALE 1:100
0 0.5 1 2 3 4 5

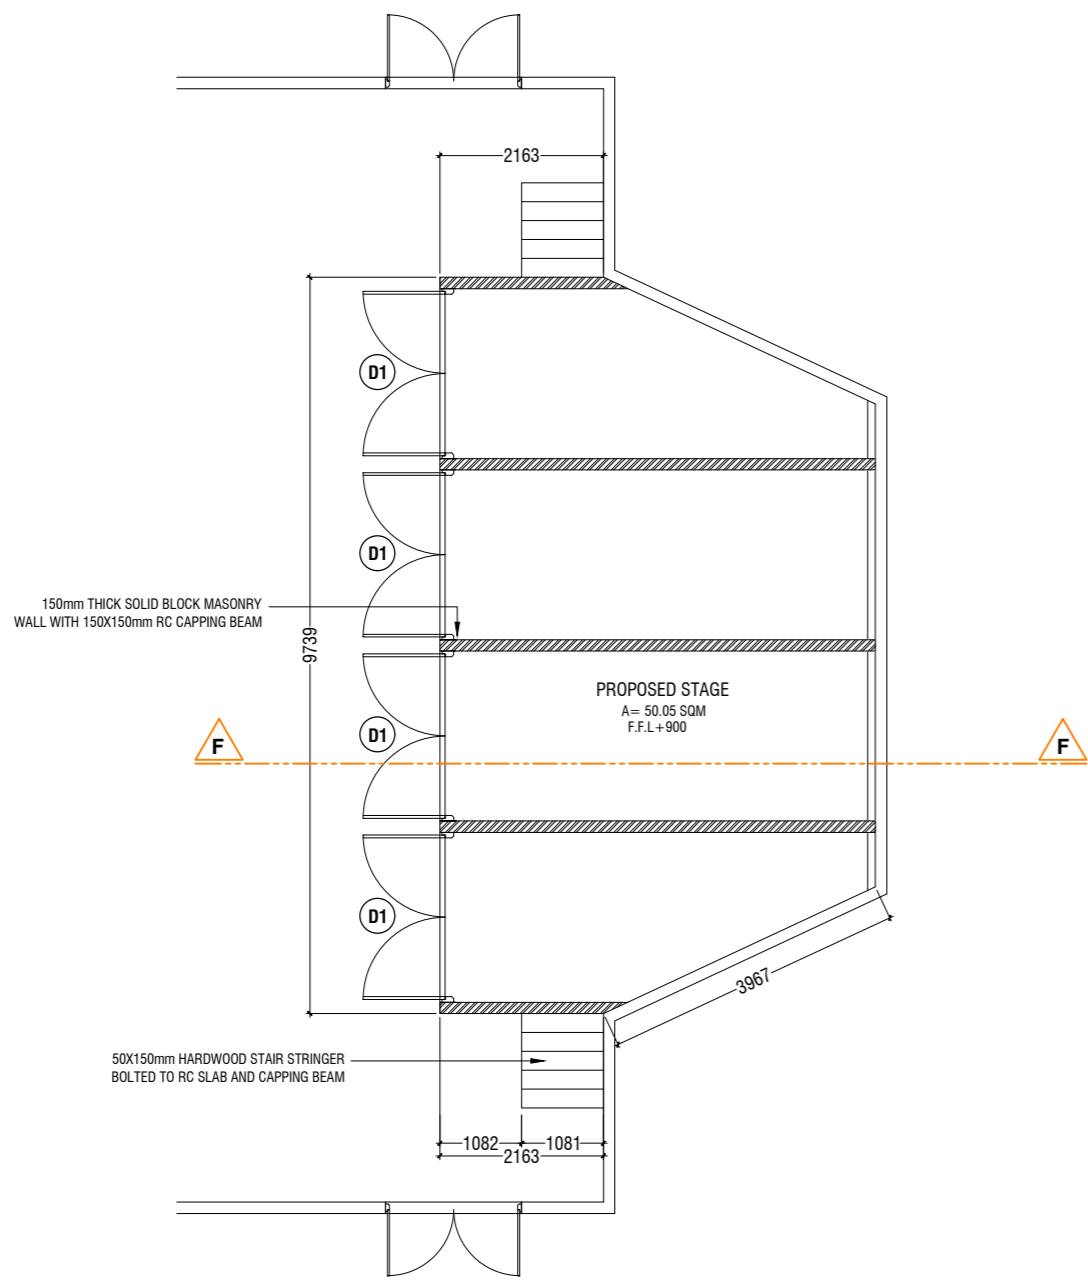

STAGE INTERNAL WALL PLAN
SCALE 1:100

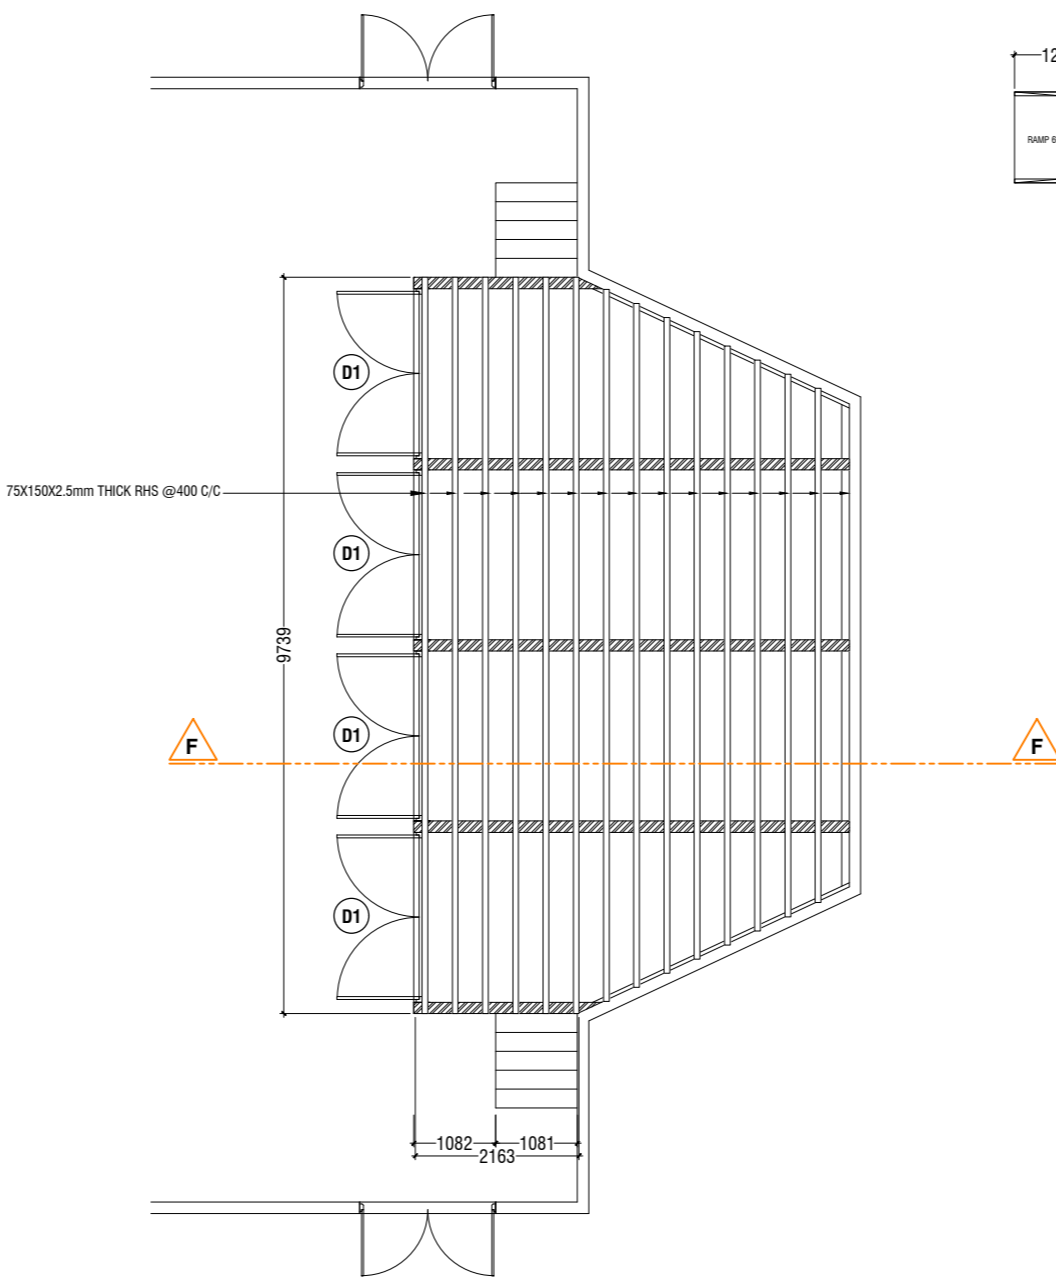

STAGE FRAMING PLAN
SCALE 1:100

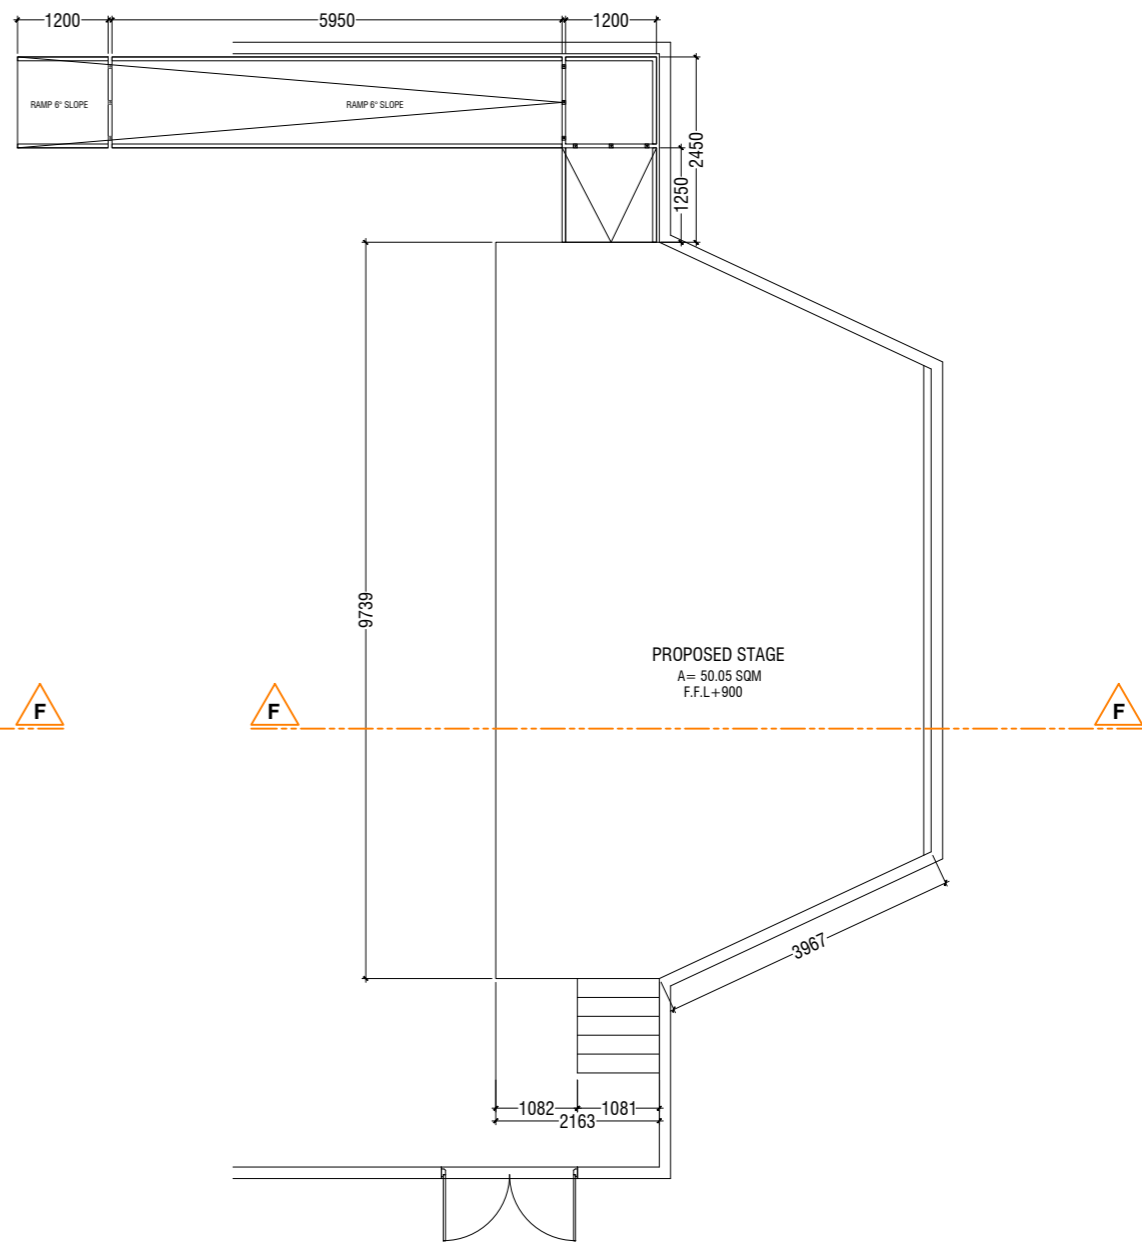

STAGE RAMP PLAN
SCALE 1:100

STAGE DETAIL
GROUND FLOOR PLAN
SCALE 1:100




PROJECT :
STAGE DRAWING

PROJ. REF:
SCALE : AS GIVEN



ARCHITECT :
ENGINEER :
DRAWN :
CHECKED :
DATE : 12.10.2022

AMMENDMENTS		
Issue	Date	Description


DWG NO : **A-02/05**

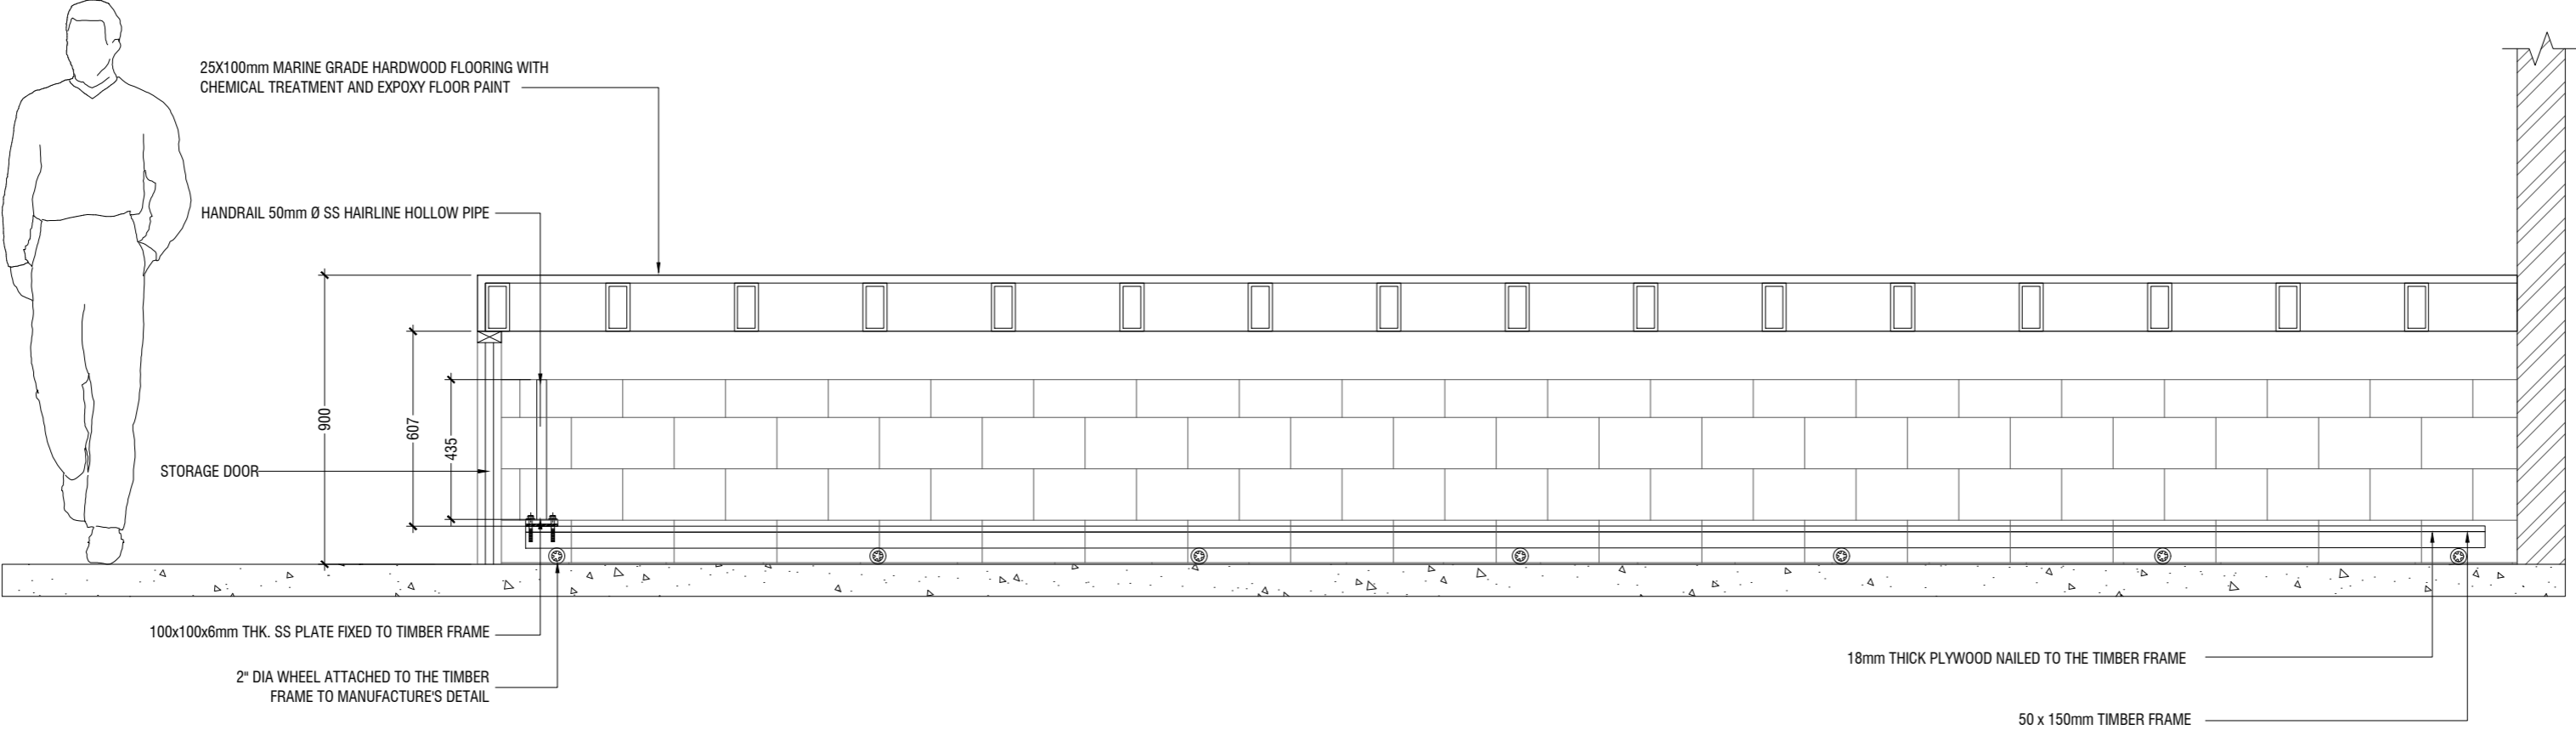



SECTION F-F

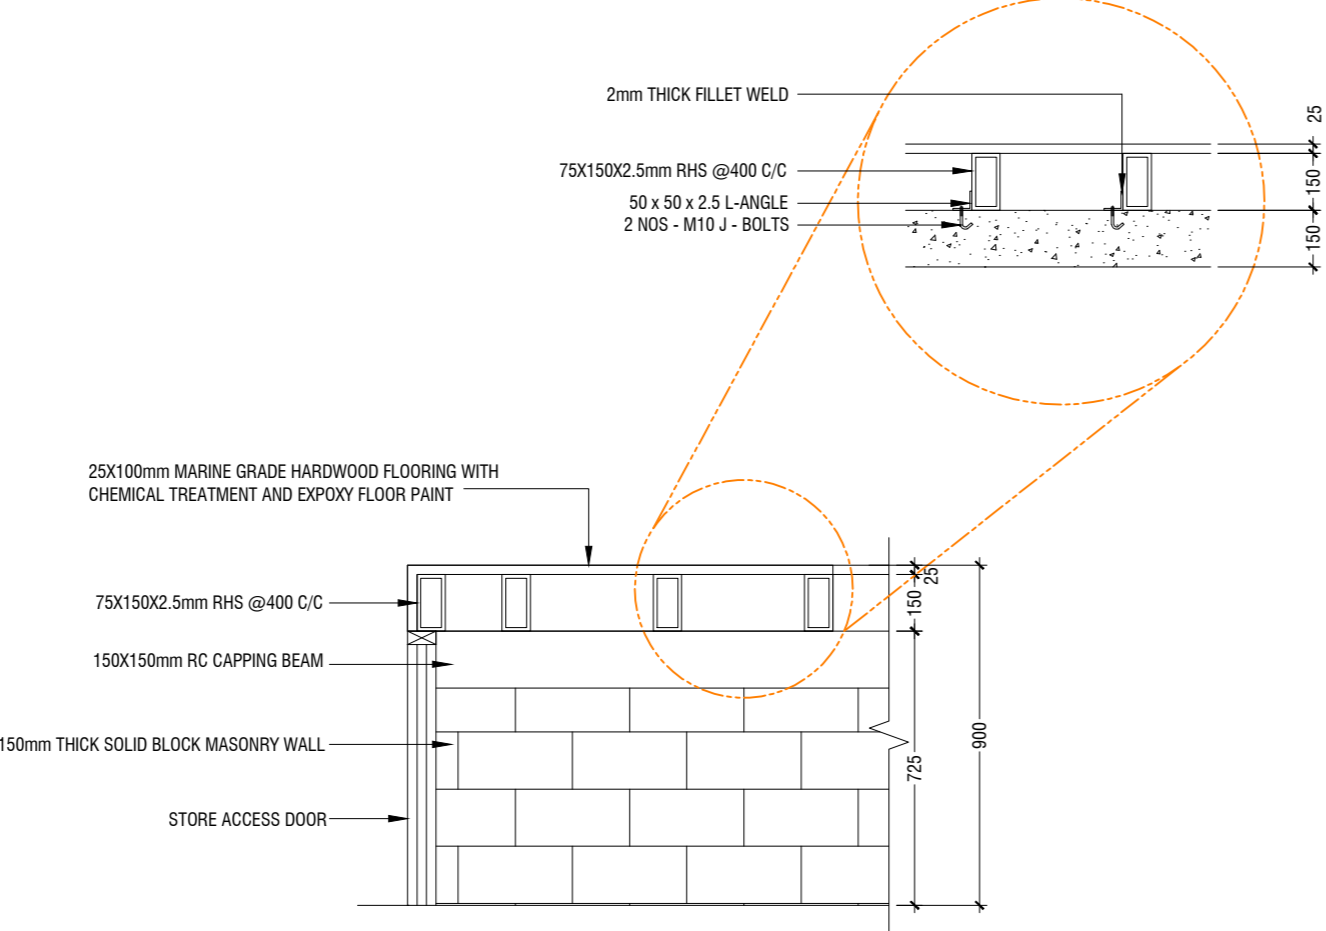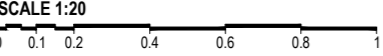


SECTION F-F

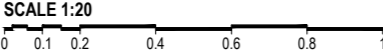


STAGE DETAILS

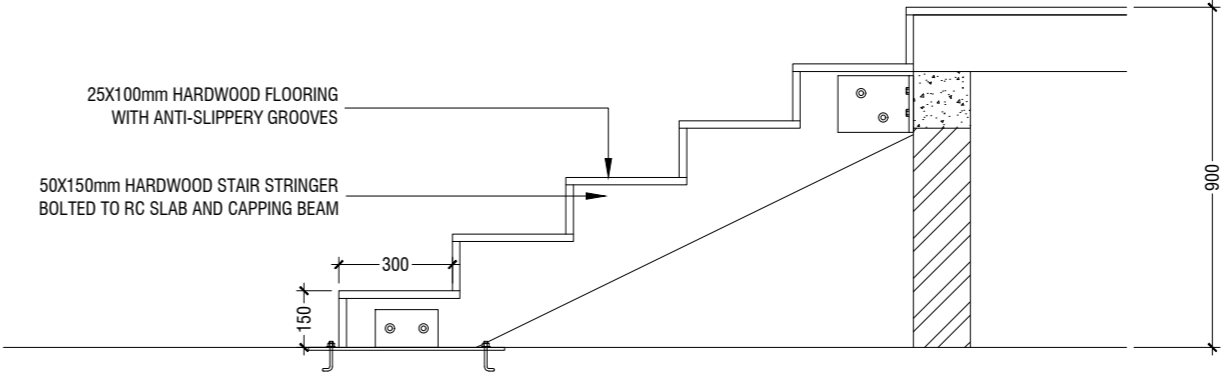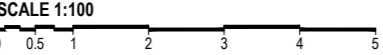

STAIR DETAIL

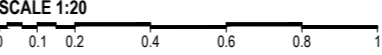



PHYSICAL FACILITIES
DEVELOPMENT SECTION
MINISTRY OF EDUCATION
REPUBLIC OF MALDIVES

PROJECT :
STAGE DRAWING

PROJ. REF: _____

SCALE : AS GIVEN

ARCHITECT : _____

ENGINEER : _____

DRAWN : _____


CHECKED : _____

DATE : 12.10.2022


AMMENDMENTS

Issue	Date	Description


DWG NO : **A-03/05**

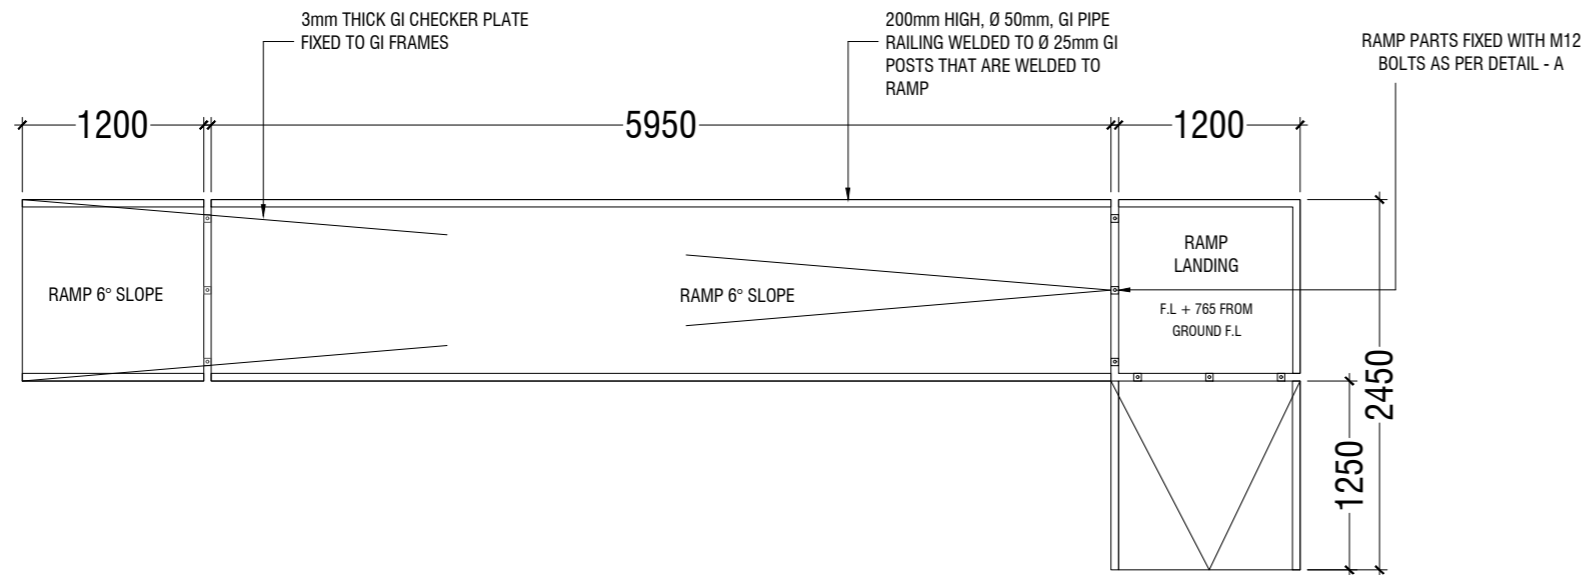


STAGE RAMP PLAN

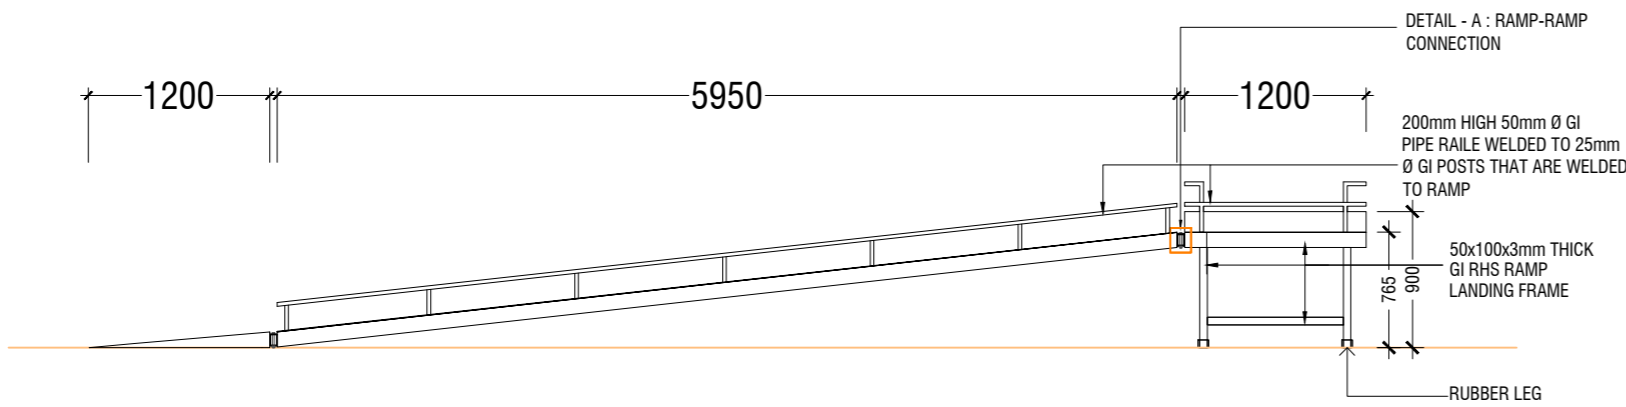


STAGE RAMP - ELEVATION

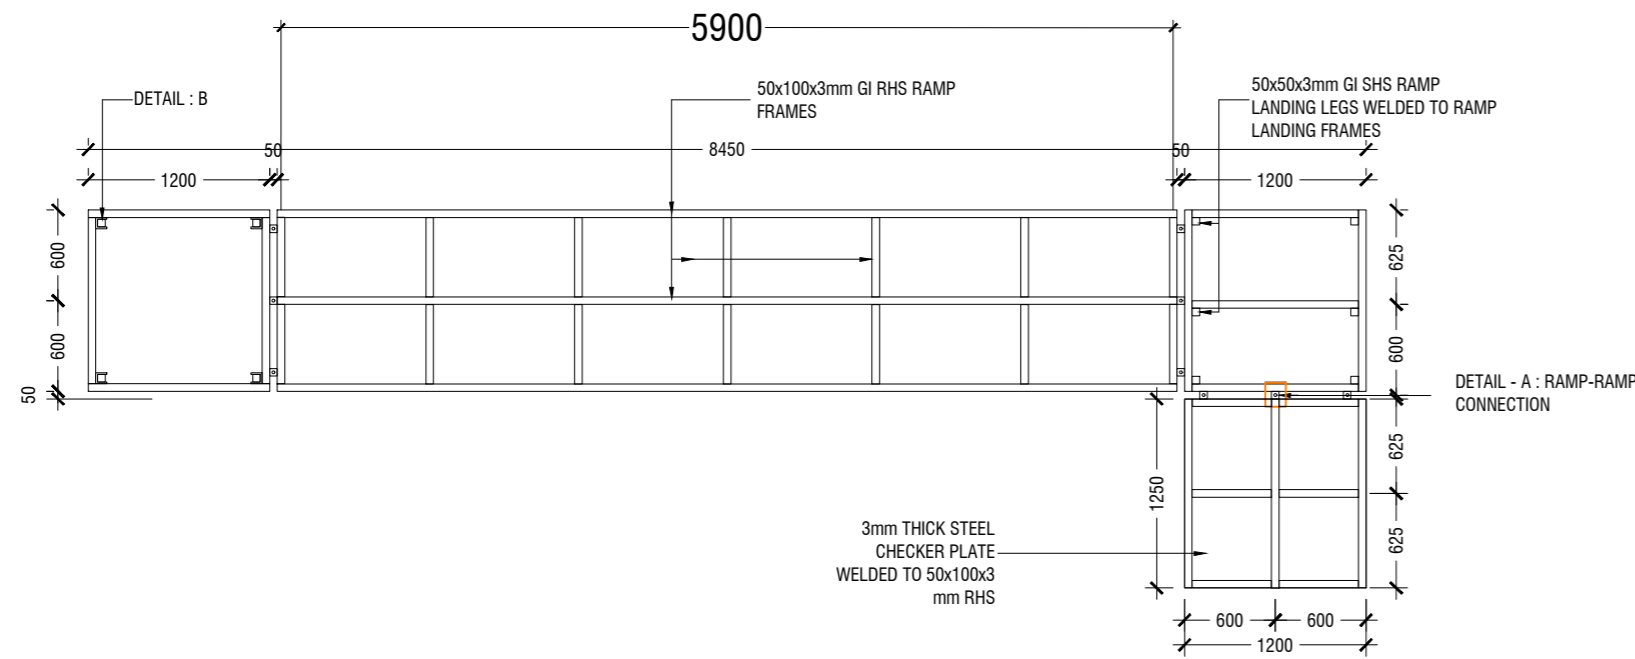

STAGE RAMP - FRAMING PLAN

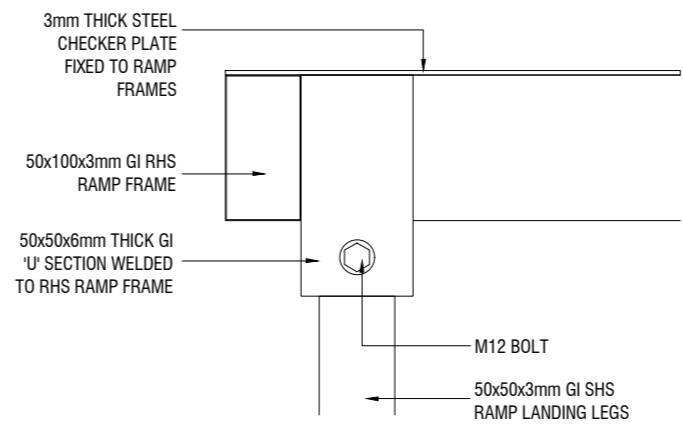


ELEVATION

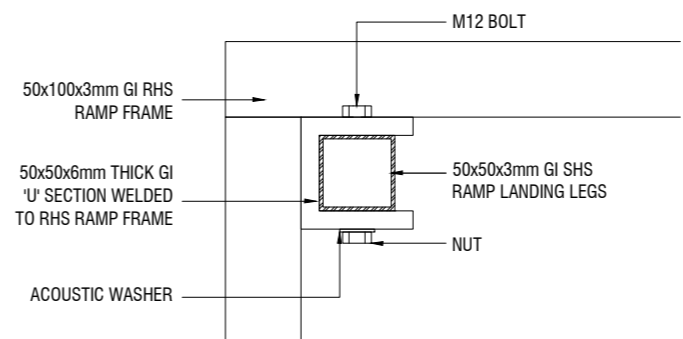


PLAN VIEW

DETAIL B :
RAMP LEG FIXING DETAIL

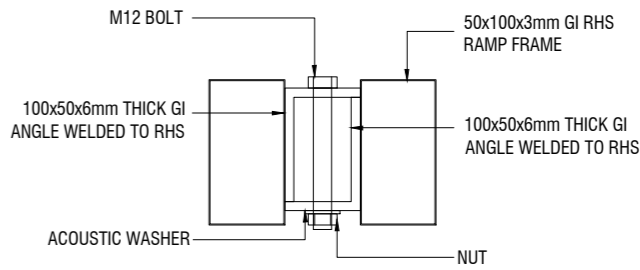

DETAIL - A
RAMP - RAMP CONNECTION DETAIL

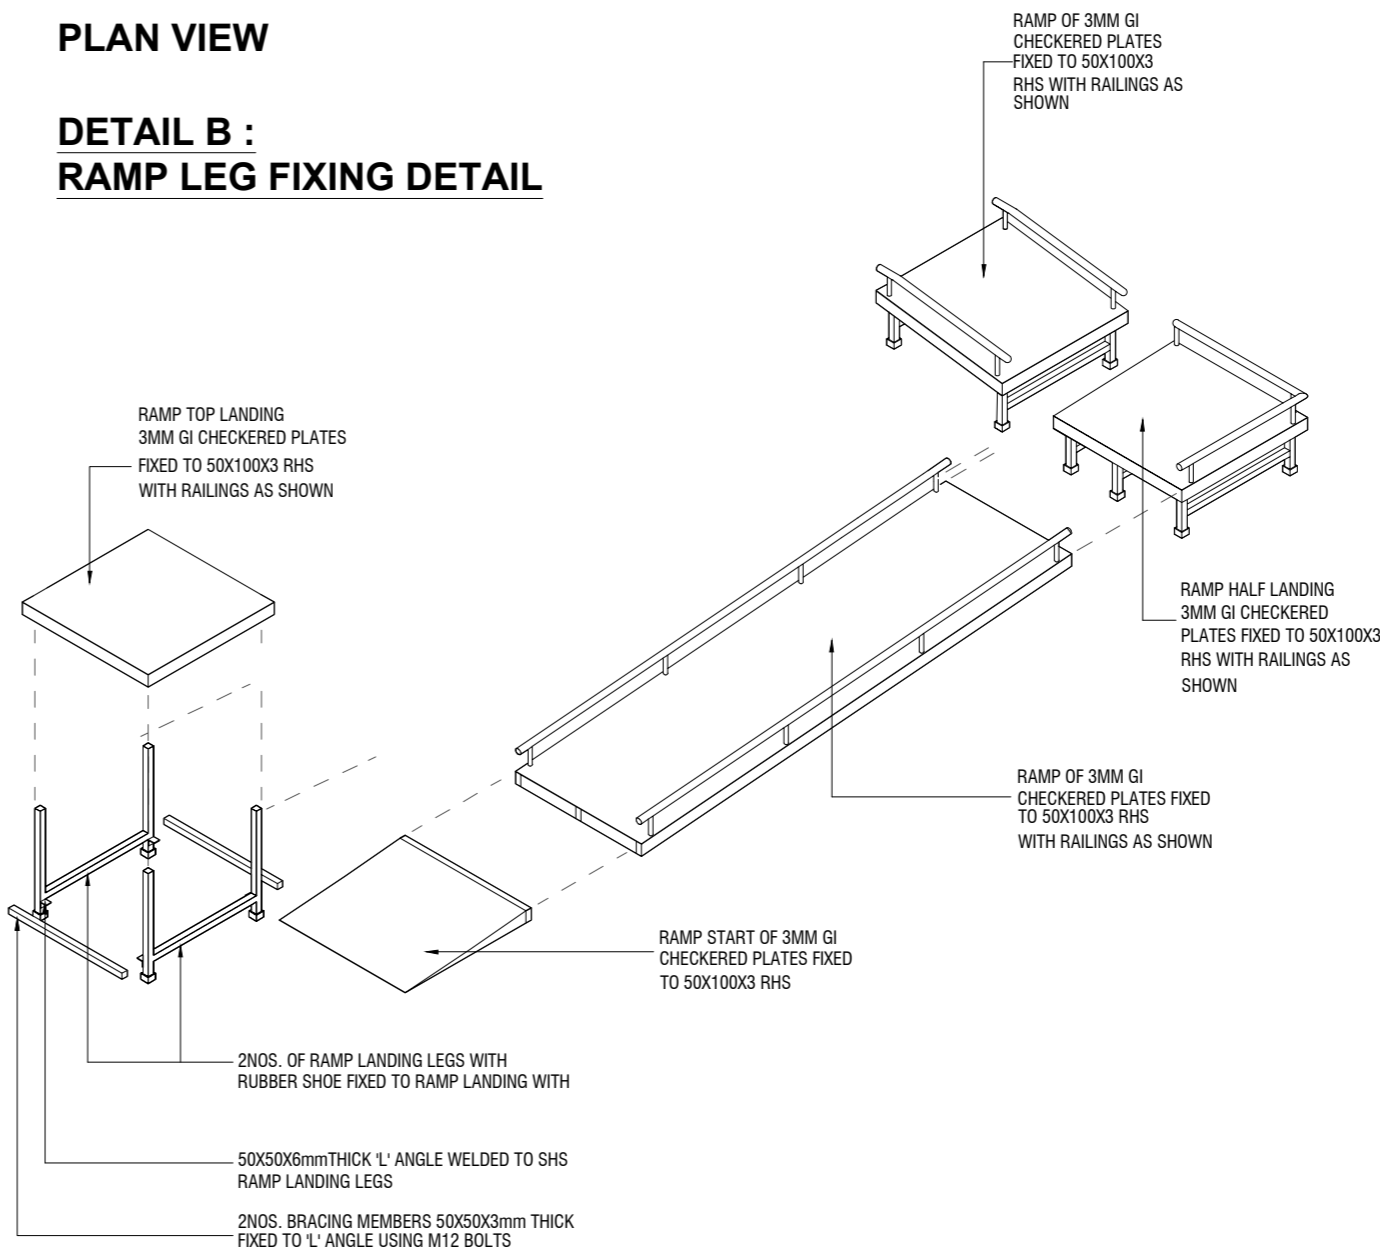

RAMP ISOMETRIC
DETAIL - 5 (STAGE RAMP DETAIL)

SCALE 1:50

0 0.25 0.5 1 1.5 2 2.5




PROJECT :
STAGE DRAWING

PROJ. REF:
SCALE : AS GIVEN

ARCHITECT :
ENGINEER :
DRAWN :
CHECKED :
DATE : 12.10.2022

AMMENDMENTS		
Issue	Date	Description

DWG NO : A-04/05

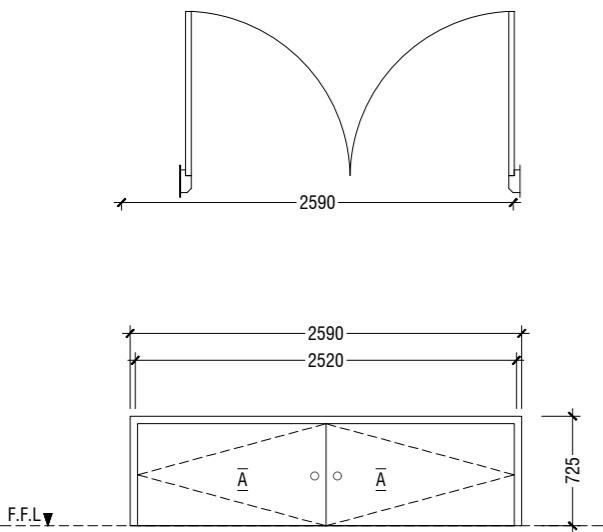


DB	DOUBLE SWING DOOR
REMARKS	50mm THICK WHITE POWDER COATED (60 MICRONS) ALUMINIUM FRAMED WITH ALUMINIUM PANEL
LOCATION	STAGE STORE ACCESS
QUANTITY	05 NOS
OPEN AREA	1.66 SQM

LEGEND:
FCG - FIXED CLEAR GLASS
FRG - FIXED REFLECTED GLASS
RG - REFLECTED GLASS
AL - ALUMINIUM
PVC - POLYVINYL CHLORIDE

NOTE:-
- FLOOR TO FLOOR HEIGHT VARIES AND WILL BE SUBJECTED TO CHANGES, LIKEWISE, THE BEAM DEPTH CHANGES AT DIFFERENT LOCATIONS OF SIMILAR DOORS/WINDOWS AND WILL BE SUBJECTED TO CHANGES
- ALL DOORS & WINDOWS TO BE CHECKED ON SITE BEFORE FABRICATION.
- ALL DOOR & WINDOWS VIEWED FROM EXTERIOR, FOR DOOR SWING, REFER TO FLOOR PLANS.
- THE DOORS / WINDOWS WHICH DO NOT TOUCH THE BEAM SHALL HAVE A LINTEL BEAM (LB) ABOVE THE DOOR / WINDOW.
- FOR ALL THE WINDOWS PUT A SILL BEAM BELOW THE WINDOW (SB)
- FOR SAFETY PURPOSES REFER TO TECHNICAL SPECIFICATIONS FOR GLASS THICKNESS.

DOOR / WINDOW SCHEDULE - 2

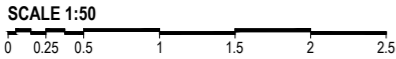

PROJECT :
STAGE DRAWING

PROJ. REF: _____
SCALE : AS GIVEN
ARCHITECT : _____
ENGINEER : _____
DRAWN : _____
CHECKED : _____
DATE : 12.10.2022

AMMENDMENTS		
Issue	Date	Description

DWG NO : A-04/05