




PROPOSED SAFEROOM - TYPE 3 (SINGLE STOREY)


ARCHITECTURAL & STRUCTURAL DRAWINGS

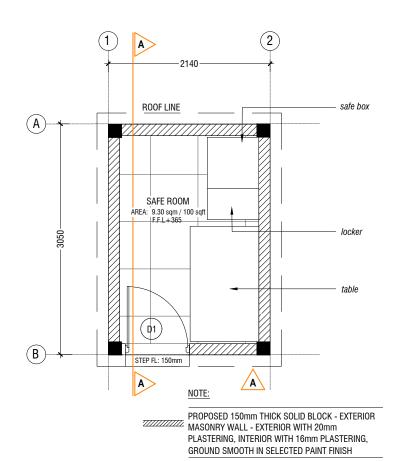

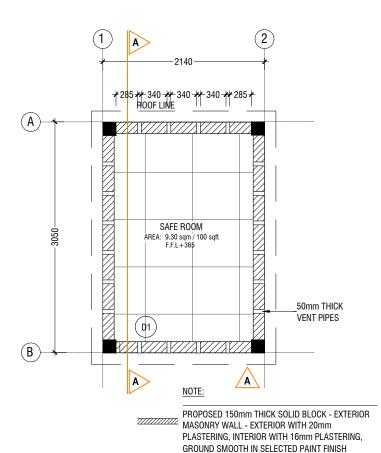

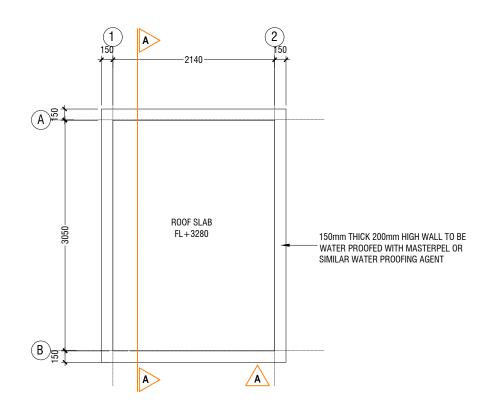


SECURE ROOM - PLAN

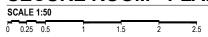






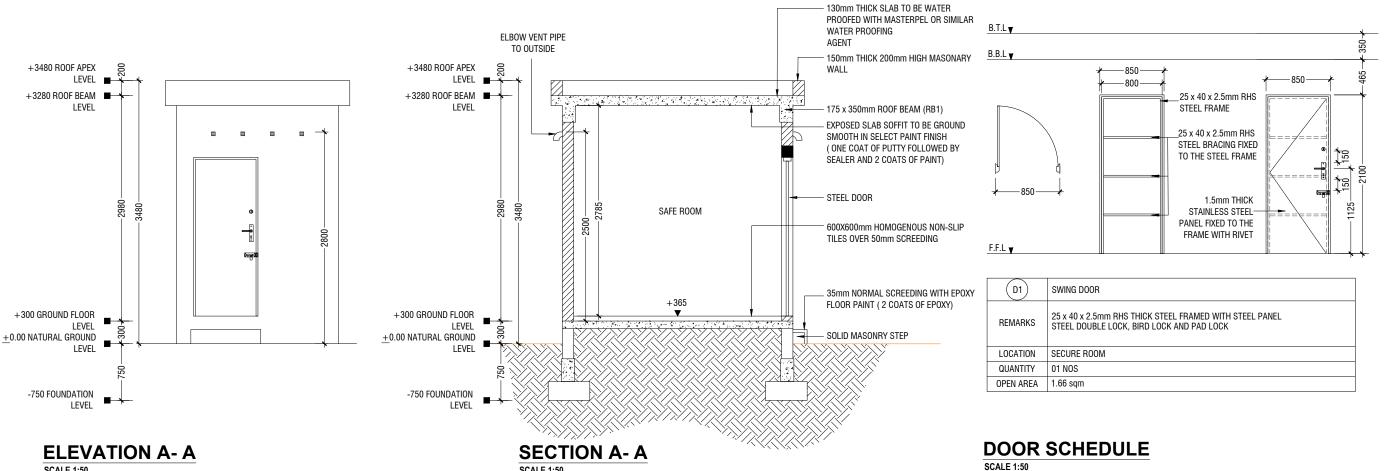


SCALE 1:50 0 0.25 0.5		15		2.5
0 0.25 0.5	'	1.5	2	2.0
SECII	RF F	SOOI	М	
SECU	RE F	ROOI	M	
SECU SCALE 1:50	RE F	ROOI	M	

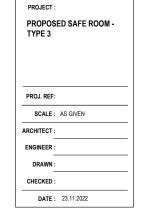



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NOTE:

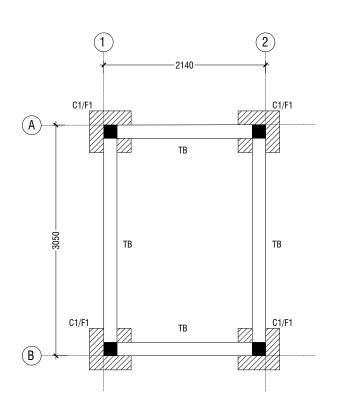COLUMN SIZES : 175x175 mm

: 40mm FOUNDATION PAD SIZES

1001	TOONDATION TAD OIZEO						
	DIMENSION		REINFORCEMENT				
F1		550 x 550 x 250	T10@150 C/C B/W (B)				

FOUNDATION DEPTH: 750mm BELOW GROUND LEVEL

ALL FOOTINGS ARE TO BE LAID ON TOP OF 50mm THICK LEAN CONCRETE


APPLY WATER PROOFING TO SUBSTRUCTURE (BELOW GROUND ELEMENTS)

TIE BEAM SIZES

: 175x300 mm COVER : 50mm

GROUND SLAB: 100MM THICK CONCRETE SLAB, R6@ 200 C/C BW SINGLE LAYER

GRADE OF CONCRETE M25

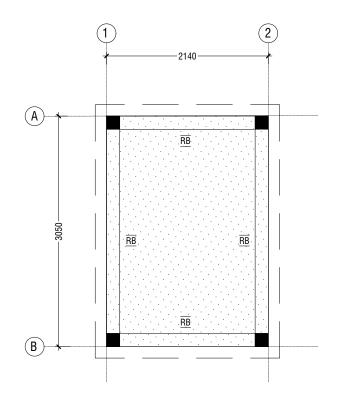


ROOF BEAM & SLAB PLAN

SLAB THICKNESS - 130 mm

T10@175 C/C BW T&B

FOUNDATION - PLAN

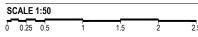


	DIMENSION (LxBxD)	REINFORCEMENT
F1	550 x 550 x 250	T10@150 C/C B/W (B)

FOUNDATION DEPTH =

COVER TO FOUNDATION = 50mm COVER TO COLUMNS COVER TO BEAMS = 35mm


GRADE OF CONCRETE M25

FOUNDATION PADS

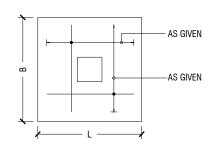



PLAN

STRUCTURAL DETAILS

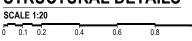

SECURE ROOM

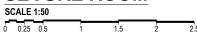


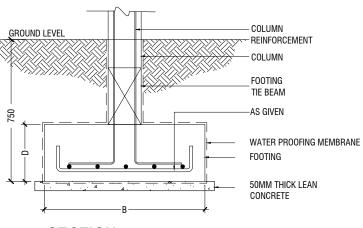

SECTION

FOOTING DETAILS




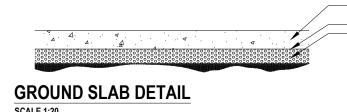

(C1)


0 0.25 0.5

→ 175 🛧

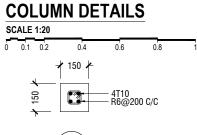




LINTEL/SILL BEAM DETAIL

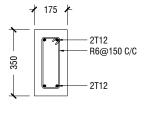



ROOF BEAM DETAIL SCALE 1:20 0 0.1 0.2 0.4

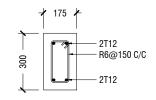



FOUNDATION DETAILS

I COMBINION DETIMES						
SC	CALE	1:20				
0	0.1	0.2	0.4	0.6	0.8	

	sc	ALE	1:20				
1	0	0.1	0.2	0.4	0.6	0.8	

-	_ TOOMIN THIOTETIC CEAD TENT OFFICEMENT WITH THOSE 2000,0 (BW)
	SINGLE LAYER
_	-61000 DAMP PROOF MEMBARANE
-	COMPACTED EARTH
	NOTE:-
	CDADE OF CONCRETE MOS

100mm THICK RC SLAB REINFORCEMENT WITH R6@200c/c (BW)

- GRADE OF CONCRETE M25
- PROPER WATER PROOFING SHALL BE APPLIED TO ALL UNDERGROUND
- STRUCTURES (TO CONSULTANTS SPECIFICATIONS)
- -BACKFILLING SHALL BE DONE AS PER TECHNICAL SPECIFICATIONS



CHECKED:

DATE: 23.11.2022

PHYSICAL FACILITIES DEVELOPMENT SECTION


AMMENDMENTS				
Issue	Date	Description		


DWG NO: A-02/02



PROPOSED SAFEROOM - TYPE 3 (SINGLE STOREY)

SERVICES DRAWINGS

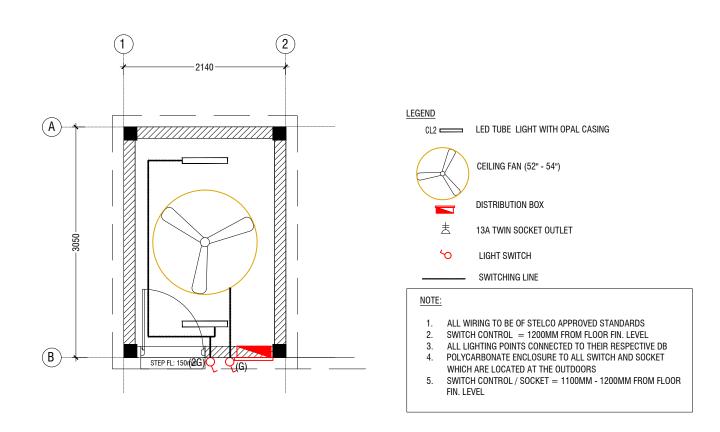

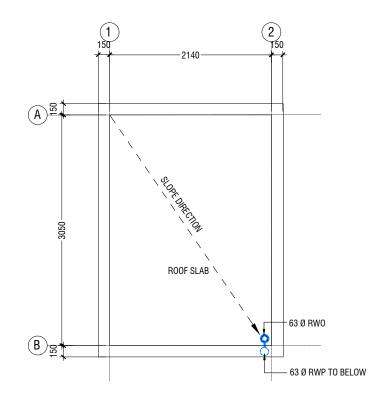

LEGEND

RWP — 63 Ø RAINWATER PIPE RWO • 63 Ø DRAIN OUTLET

<u>NOTE:</u>
- ALL RAINWATER PIPES TO BE AT GROUND LEVEL
DISCHARGED THROUGH A PERFORATED COWL OR TO A SOAK PIT

SECURE ROOM - LIGHTING & POWER LAYOUT

S	CALE	1:50				
0	0.25	0.5	1	1.5	2	2.5

SECURE ROOM - DRAINAGE LAYOUT

SCALE 1:50							
0	0.25	0.5	1	1.5	2	2.5	



DWG NO: S-01/01