

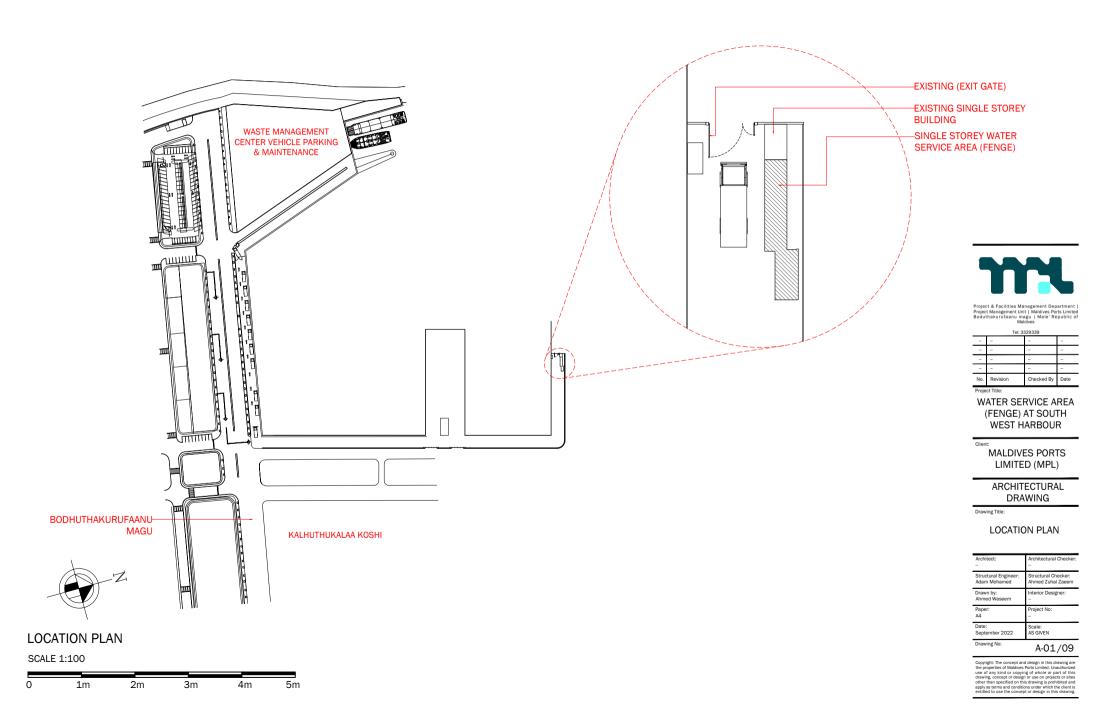
DESIGN BY:

Project & Facilities Management Department | Project Management Unit | Maldives Ports Limited Boduthakurufaanu magu | Male' Republic of Maldives

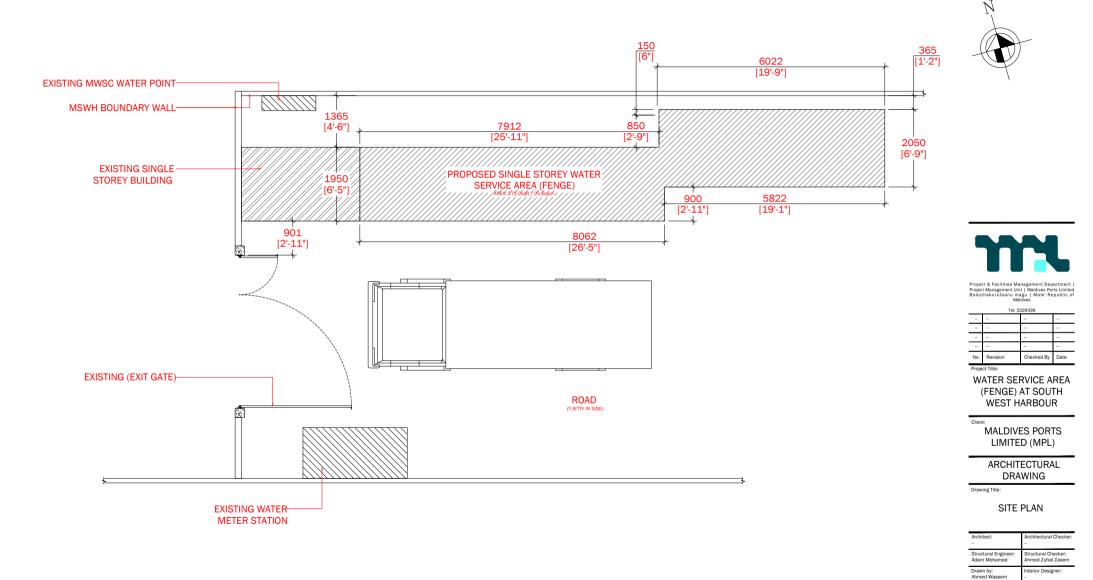
Tel: 3329339

PROJECT: WATER SERVICE AREA (FENGE) at (South West Harbor)

CLIENT: Maldives Ports Limited



EXCEPT OTHERWISE NOTED: - ALL THE MEASUREMENTS TO BE CHECK ON THE SITE.



SITE PLAN SCALE 1:100 0 1m 2m 3m 4m

5m

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roiect No:

Scale: AS GIVEN

Paper: A4

Date: September 2022

TOILET AREA: 21.94sqft / 2.1sqm - ALL OUTDOOR EXPOSED TIMBER SHOULD BE WETHER TREATED

- ALL THE WALLS EXPOSED TO RAIN SHOULD BE PLASTERED WITH WATER PROOFING CHEMICAL.

- ALL THE WORK SHOULD BE CHECK OUT ACCORDING TO THE CONSULTANT OR THE SITE ENGINEER.

EXCEPT OTHERWISE NOTED: - ALL THE MEASUREMENTS TO BE CHECK ON THE SITE.

- MCV (MECHANICALLY VENTILATED).



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	Tel: 3	329339	
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No.	Revision	Checked By	Date
Proje	ct Title:		

WATER SERVICE AREA (FENGE) AT SOUTH WEST HARBOUR

Client: MALDIVES PORTS LIMITED (MPL)

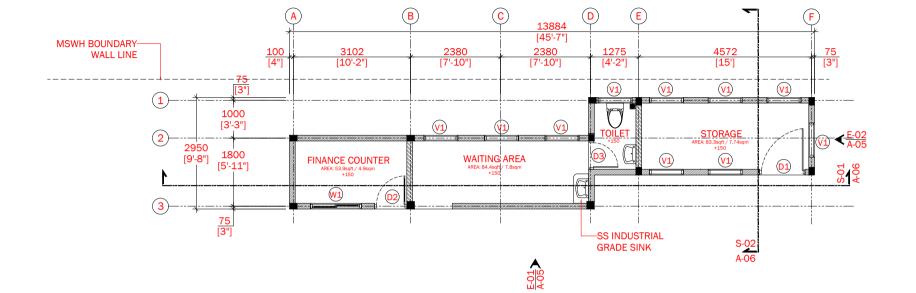
> ARCHITECTURAL DRAWING

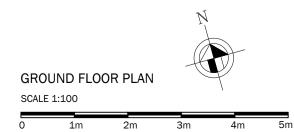
Drawing Title:

GROUND FLOOR PLAN

Architect:	Architectural Checker:
Structural Engineer:	Structural Checker:
Adam Mohamed	Ahmed Zuhal Zaeem
Drawn by:	Interior Designer:
Ahmed Waseem	
Paper:	Project No:
A4	
Date:	Scale:
September 2022	AS GIVEN
Drawing No:	A-03/09

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WALL TYPE:

 150mm THICK HOLLOW BLOCK WALL.

 150mm THICK SOLID BLOCK WALL.

NOTE:

- EXTERIOR PLASTERING SHALL BE 2 COAT EACH 10MM THICK. - INTERIOR PLASTERING SHALL BE 1 COAT EACH 13MM THICK. - STIFFENER BEAM AT MID HEIGHT OF SOLID BLOCK WALL

- ALL OUTDOOR EXPOSED TIMBER SHOULD BE WETHER TREATED

- ALL THE WALLS EXPOSED TO RAIN SHOULD BE PLASTERED WITH WATER PROOFING CHEMICAL.

- ALL THE WORK SHOULD BE CHECK OUT ACCORDING TO THE CONSULTANT OR THE SITE ENGINEER.

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- MCV (MECHANICALLY VENTILATED).



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No.	Revision	Checked By	Date
Proje	ct Title:		

WATER SERVICE AREA (FENGE) AT SOUTH WEST HARBOUR

Client: MALDIVES PORTS LIMITED (MPL)

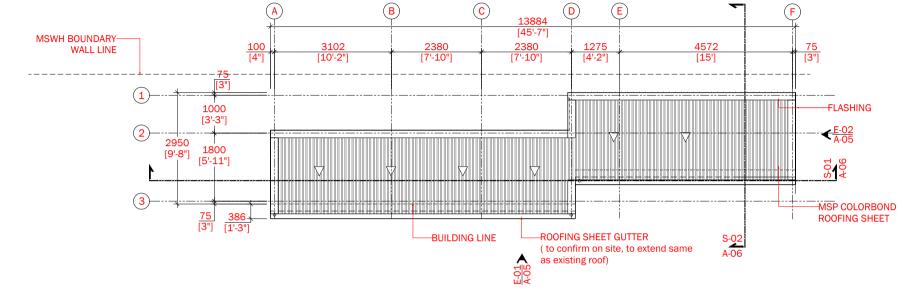
> ARCHITECTURAL DRAWING

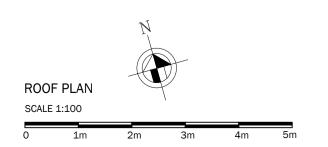
Drawing Title:

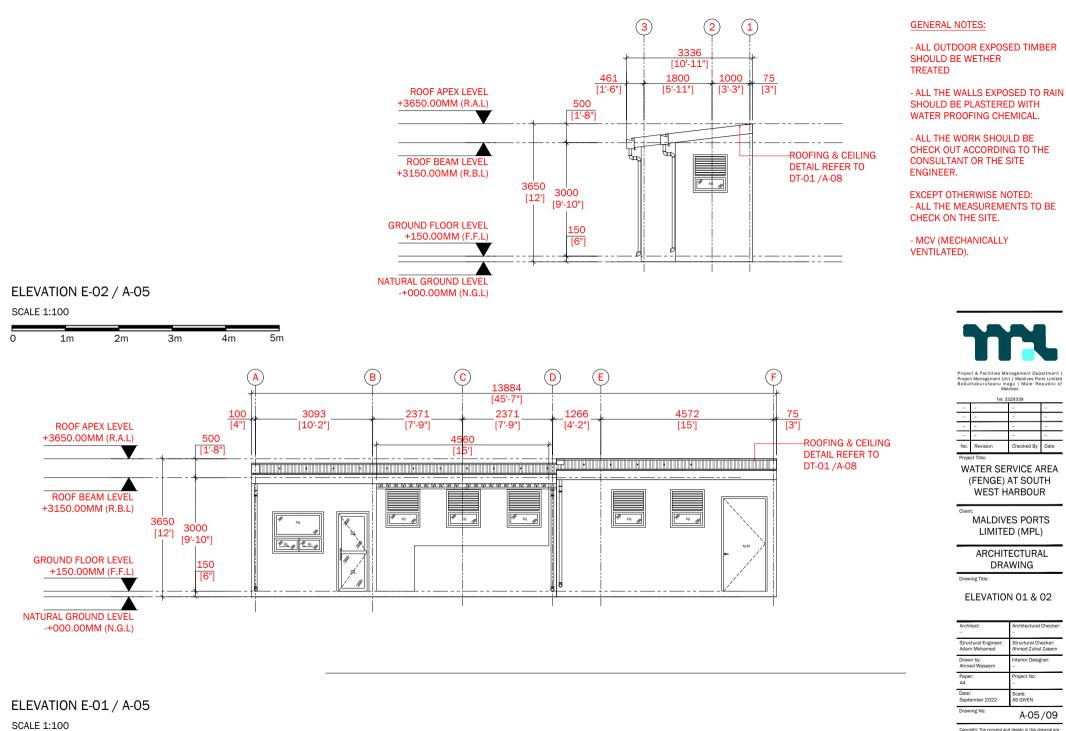
ROOF PLAN

Drawing No:	A-04/09
Date:	Scale:
September 2022	AS GIVEN
Paper:	Project No:
A4	
Drawn by:	Interior Designer:
Ahmed Waseem	
Structural Engineer:	Structural Checker:
Adam Mohamed	Ahmed Zuhal Zaeem
Architect:	Architectural Checker: -

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Tel: 3320330

Checked By Date

chitectural Checke

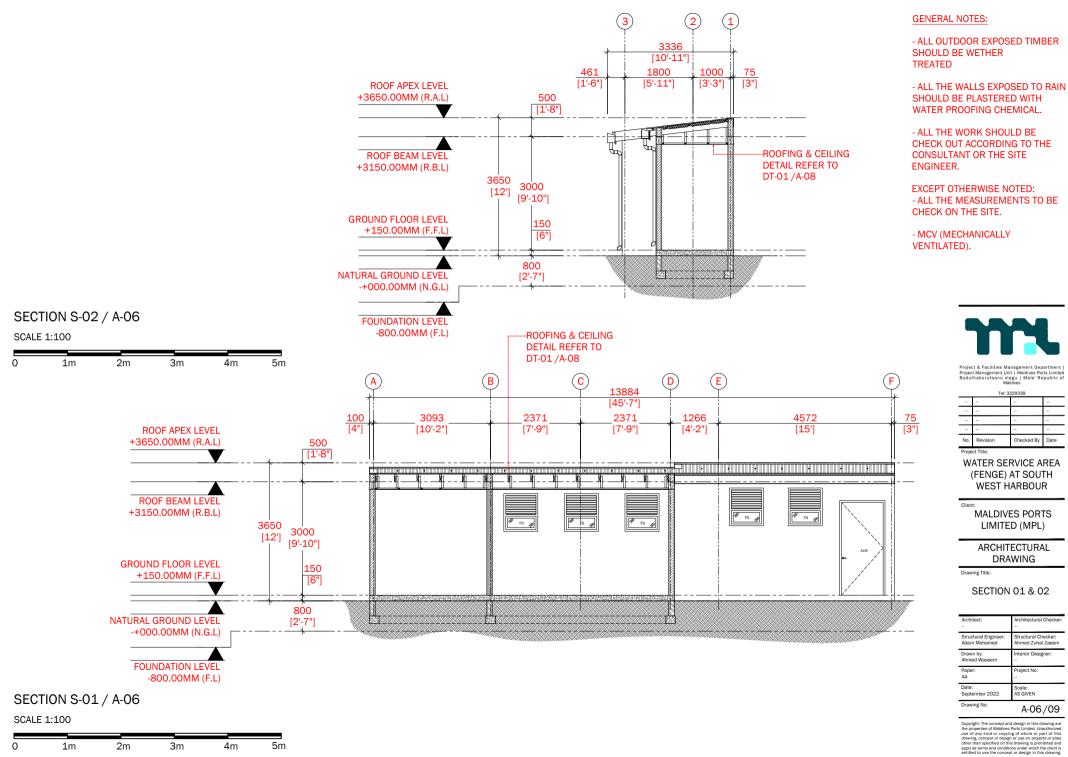
Structural Checker: Ahmed Zuhal Zaeen

terior Designer:

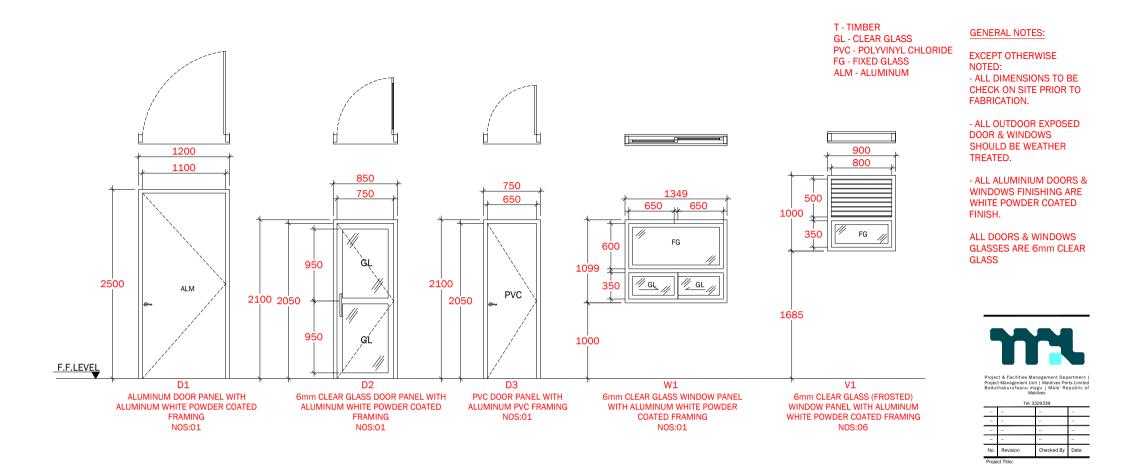
A-05/09

roiect No:

Scale: AS GIVEN



1m 2m Зm 4m



SCHEDULE OF VENTILATION FOR THE PROPOSED TWO STOREY HMT MAJOORI WAITING AREA & TUCK SHOP					
ROOM NAME / NUMBER	SPACE AREA (sqm) SPECIFY CENTER TO CENTER OR CLEAR	WINDOW (OPENING NUMBER)	REQUIRED OPENING AREA (sqm)	DESIGNED OPENING AREA (sqm)	
GROUND FLOOR					
WAITING AREA	WAITING AREA 7.8 OPEN				
FINANCE COUNTER	4.9	W1	0.49	0.30	
TOILET	2.1	V1	0.21	0.68	
STORAGE	5.2	V1x6	0.52	4.08	

DOORS & WINDOWS & VENTILATION SCHEDULE

SCALE 1:50

0 1m 2m 3m 4m 5m

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WATER SERVICE AREA (FENGE) AT SOUTH WEST HARBOUR

> MALDIVES PORTS LIMITED (MPL) ARCHITECTURAL DRAWING

DOOR, WINDOWS & VENTILATION SCHEDULE

chitectural Checke

Structural Checker: Ahmed Zuhal Zaeen

terior Designer:

A-07/09

roiect No:

Scale: AS GIVEN

Client:

Drawing Title:

Architect:

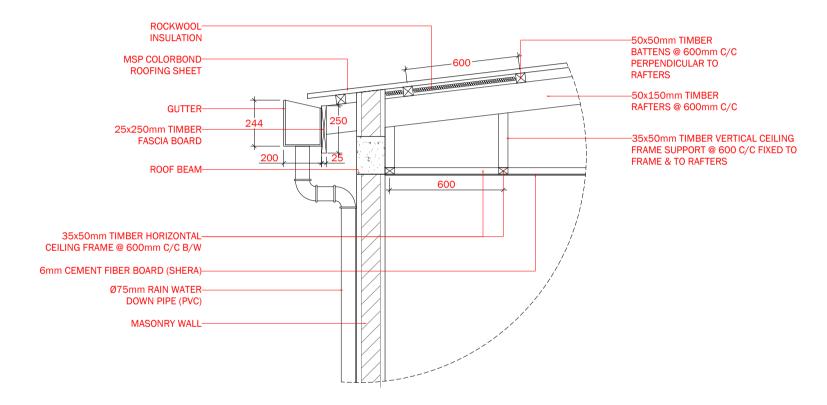
Structural Engine Adam Mohamed

Drawn by: Ahmed Waseem

September 2022 Drawing No:

Paper: A4

Date:



ROOFING & CEILING DETAIL DT-01 / A-08 SCALE 1:20



22

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	Tel: 33	329339	
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No.	Revision	Checked By	Date
Proje	ct Title:		

WATER SERVICE AREA (FENGE) AT SOUTH WEST HARBOUR

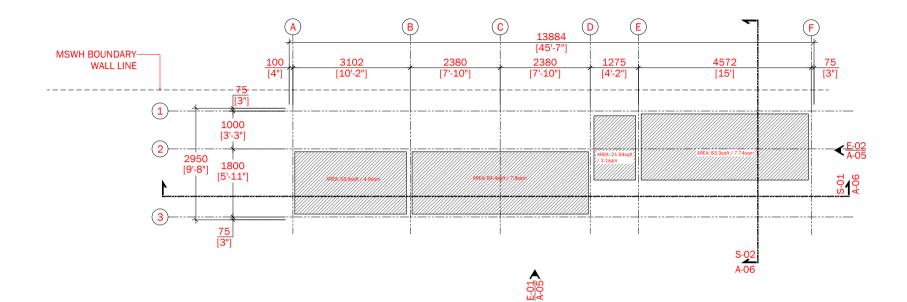
Client: MALDIVES PORTS LIMITED (MPL)

ARCHITECTURAL DRAWING Drawing Title:

> ARCHITECTURAL DETAILS

Architect:	Architectural Checker: -
Structural Engineer:	Structural Checker:
Adam Mohamed	Ahmed Zuhal Zaeem
Drawn by:	Interior Designer:
Ahmed Waseem	
Paper:	Project No:
A4	
Date:	Scale:
September 2022	AS GIVEN
Drawing No:	A-08/09

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CEILING TYPE:

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6MM CEMENT FIBRE BOARD FLAT CEILING (SHERA)

REFER TO DETAIL DT-01 / A-08



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No.	Revision	Checked By	Date	
Proje	ct Title:			

WATER SERVICE AREA (FENGE) AT SOUTH WEST HARBOUR

Client: MALDIVES PORTS LIMITED (MPL)

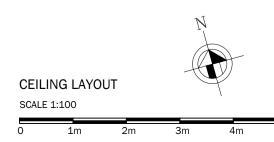
> ARCHITECTURAL DRAWING

Drawing Title:

CEILING PLAN

Architect:	Architectural Checker:
Structural Engineer:	Structural Checker:
Adam Mohamed	Ahmed Zuhal Zaeem
Drawn by:	Interior Designer:
Ahmed Waseem	
Paper:	Project No:
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5m

F1 - 450mm X 450mm X 200mm (T12@100 C/C B/W (BOTTOM)

FB (FOUNDATION BEAM) 200x200mm

C1 : 200x200mm RC COLUMN STUMP WITH Ø76 x 3.2mm CHS SINGLE PIPE

C2 - (COLUMN 2) 200x150mm

C3 - (COLUMN 3) 200x200mm

SC - (STIFFENER COLUMN) 150x150mm

FOUNDATION DEPTH = 800mm BELOW NATURAL GROUND LEVEL



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Denio	et Titler			

WATER SERVICE AREA (FENGE) AT SOUTH WEST HARBOUR

Client: MALDIVES PORTS LIMITED (MPL)

EXCEPT OTHERWISE NOTED:

- BEAM = 35mm - COLUMNS = 40mm

GRADE = C25)

GRADE = C25)

BENDS = $10x\emptyset$ (\emptyset = BAR DIAMETER) LAPS = $45x\emptyset$ (\emptyset = BAR DIAMETER)

- FOOTINGS & FOOTING BEAM = 50mm

STUMP COLUMN COVER = 40mm
 FLOOR SLAB COVER = 30mm
 STIFFENER & LINTEL COVER = 30mm
 FOOTINGS (CONCRETE GRADE = C25)
 STUMP COLUMN (CONCRETE

- TIE BEAM (CONCRETE GRADE = C25) - FLOOR SLAB (CONCRETE GRADE = C25)

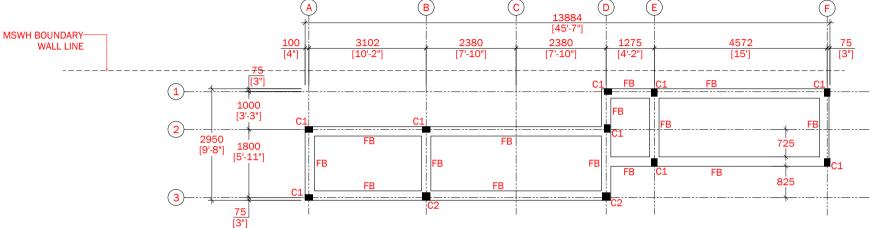
- STIFFENER & LINTEL (CONCRETE

- MASS CONCRETE GRADE = C25 - LEAN CONCRETE GRADE = C15 STRUCTURAL DRAWING

Drawing Title: FOUNDATION & COLUMN LOCATION PLAN

Architect:	Architectural Checker:
Structural Engineer: Adam Mohamed	Structural Checker: Ahmed Zuhal Zaeem
Drawn by: Ahmed Waseem	Interior Designer:
Paper: A4	Project No:
Date: September 2022	Scale: AS GIVEN
Drawing No:	S-01/08

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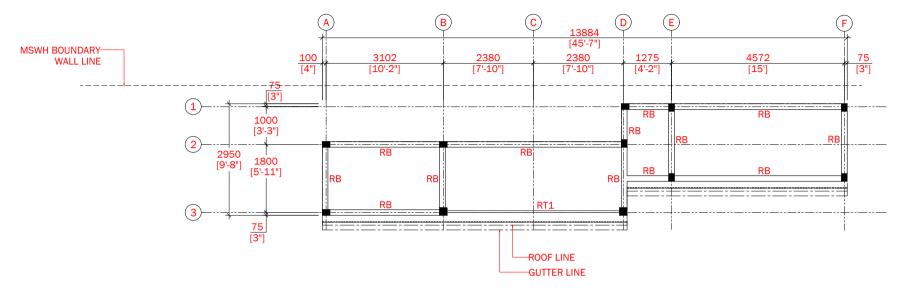


FOUNDATION & COLUMNS LOCATION PLAN



RB - ROOF BEAM (150x200mm)

TR1 - (TRUSS 1) 48.3x1.8mm (1.5") TOP & BOTTOM MEMBER, 33.4x1.8mm (1") WEB MEMBER



EXCEPT OTHERWISE NOTED:

BENDS = $10x\emptyset$ (\emptyset = BAR DIAMETER) LAPS = $45x\emptyset$ (\emptyset = BAR DIAMETER)

- FOOTINGS & FOOTING BEAM = 50mm - BEAM = 35mm

- COLUMNS = 40mm - STUMP COLUMN COVER = 40mm

- FLOOR SLAB COVER = 30mm

- STIFFENER & LINTEL COVER = 30mm

- FOOTINGS (CONCRETE GRADE = C25) - STUMP COLUMN (CONCRETE GRADE = C25)

- TIE BEAM (CONCRETE GRADE = C25) - FLOOR SLAB (CONCRETE GRADE = C25) - STIFFENER & LINTEL (CONCRETE GRADE = C25)

- MASS CONCRETE GRADE = C25 - LEAN CONCRETE GRADE = C15

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No.	Revision	Checked By	Date	
Proje	ct Title:			

WATER SERVICE AREA (FENGE) AT SOUTH WEST HARBOUR

Client: MALDIVES PORTS LIMITED (MPL)

STRUCTURAL DRAWING

Drawing Title:

ROOF BEAM PLAN

Architect:	Architectural Checker:
Structural Engineer:	Structural Checker:
Adam Mohamed	Ahmed Zuhal Zaeem
Drawn by:	Interior Designer:
Ahmed Waseem	-
Paper:	Project No:
A4	-
Date:	Scale:
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Drawing No:	S-02/08

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50 x 150mm TIMBER RAFTERS @ 600mm C/C

25 x 250mm FASCIA BEAM

50 x 50mm TIMBER BATTENS @ 600mm C/C FIXED PERPENDÍCULAR TO RAFTERS.

35x50x1.5mm RHS BATTENS @ 600mm C/C

MASONRY BLOCKWORK SHALL BE BUILT ABOVE ROOF BEAMS TO RECEIVE RAFTERS, BLOCKWORK SHALL BE PROPERLY BRACED ON ALL SIDES WITH COPING BEAM & STIFFENER COLUMNS.

MINIMUM TIMBER GRADE = C30



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No.	Revision	Checked By	Date	
Broject Title:				

WATER SERVICE AREA (FENGE) AT SOUTH WEST HARBOUR

Client: MALDIVES PORTS LIMITED (MPL)

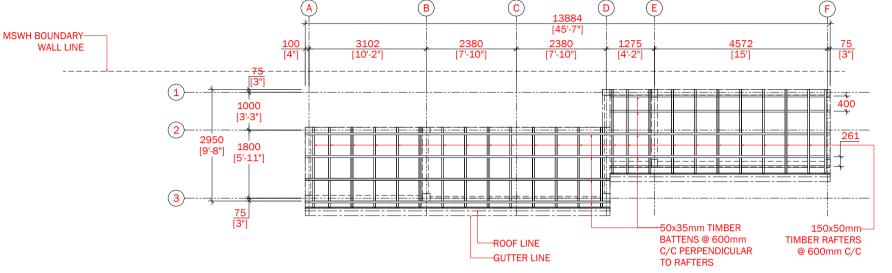
STRUCTURAL DRAWING

Drawing Title:

ROOF FRAMING PLAN

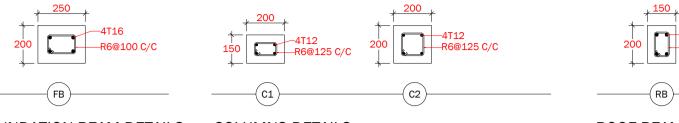
Architect:	Architectural Checker
Structural Engineer:	Structural Checker:
Adam Mohamed	Ahmed Zuhal Zaeem
Drawn by:	Interior Designer:
Ahmed Waseem	
Paper:	Project No:
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ROOF FRAMING PLAN

NATURAL GROUND LEVEL



COLUMNS DETAILS: FOUNDATION BEAM DETAILS:

MEMBER	COVER	CONCRETE GRADE
FOOTINGS & FOUNDATION BEAM	50mm	
STUMP COLUMNS	35mm	C25
COLUMNS	40mm	625
BEAMS	35mm	-
FLOOR SLABS	30mm	
STIFFENER & LINTEL	30mm	C25
MASS CONCRETE		C25
LEAN CONCRETE		C15

RC COVER & CONCRETE GRADE SCHEDULE (BS 5328)

TYPE DIMENSIONS		REINFORCEMENT		
F1 450mm x 450mm x 200mm		T12@100 C/C B/W (BOTTOM)		
FOUNDATION DEPTH = 800mm BELOW NATURAL GROUND LEVEL				

FOOTING SCHEDULE

STRUCTURAL DETAILS

SCALE 1:20

2m 0 1m 3m 4m 5m

-4T16 -R6@150 C/C

ROOF BEAM DETAILS:

WEB MEMBER TO CHORD MEMBER BY

FOUNDATION DEPTH = 800mm BELOW

5mm FILLET WELD ALL AROUND PIPE

ALL GI PIPES & MS PLATES SHOULD BE FIRST APPLIED WITH REDOXIDE PRIMER & THAN WITH TWO COATS OF APPROVED QUALITY OF ENAMAL PAINT.

EXCEPT OTHERWISE NOTED: - FOOTINGS = 50mm - FOUNDATION BEAM = 50mm -TIE BEAM = 35mm - STUMP COLUMN COVER = 35mm - COLUMN = 40mm - FLOOR SLAB COVER = 30mm - STIFFENER & LINTEL COVER = 30mm - MINIMUM TIMBER GRADE = C30



Project Management Unit | Maldives Ports Limited Boduthakurufaanu magu | Male' Republic of Maldiven Tol: 3320330

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No.	Revision	Checked By	Date
Project Title:			

WATER SERVICE AREA (FENGE) AT SOUTH WEST HARBOUR

Client MALDIVES PORTS LIMITED (MPL)

STRUCTURAL DRAWING

Drawing Title:

STRUCTURAL DETAILS

Architect:	Architectural Checker:
Structural Engineer:	Structural Checker:
Adam Mohamed	Ahmed Zuhal Zaeem
Drawn by:	Interior Designer:
Ahmed Waseem	
Paper:	Project No:
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FOOTING 1 (F1) & STUMP COLUMN (C1) DETAIL:



WEB MEMBER TO CHORD MEMBER BY 5mm FILLET WELD ALL AROUND PIPE

ALL GI PIPES & MS PLATES SHOULD BE FIRST APPLIED WITH REDOXIDE PRIMER & THAN WITH TWO COATS OF APPROVED **QUALITY OF ENAMAL PAINT.**

EXCEPT OTHERWISE NOTED: - FOOTINGS = 50mm - FOUNDATION BEAM = 50mm -TIE BEAM = 35mm - STUMP COLUMN COVER = 35mm - COLUMN = 40mm - FLOOR SLAB COVER = 30mm - STIFFENER & LINTEL COVER = 30mm - MINIMUM TIMBER GRADE = C30





WATER SERVICE AREA (FENGE) AT SOUTH WEST HARBOUR

Client MALDIVES PORTS LIMITED (MPL)

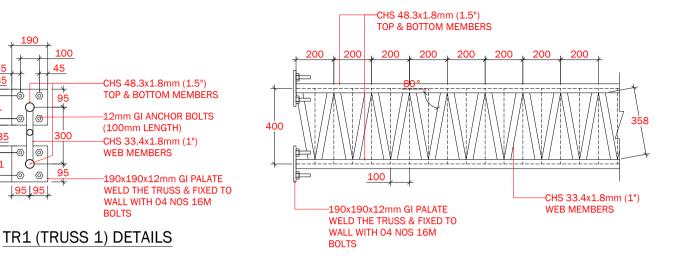
STRUCTURAL DRAWING

Drawing Title:

STRUCTURAL DETAILS

Architect:	Architectural Checker:
Structural Engineer: Adam Mohamed	Structural Checker: Ahmed Zuhal Zaeem
Drawn by: Ahmed Waseem	Interior Designer:
Paper: A4	Project No:
Date: September 2022	Scale: AS GIVEN
Drawing No:	S-05/08

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LINTEL BEAM

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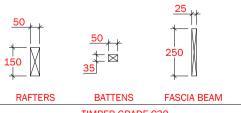
100

-2T12

-R6@150 C/C

COVER = 30 MM (T/B)





TIMBER GRADE C30

STRUCTURAL TIMBER DETAILS

STRUCTURAL DETAILS

SCALE 1:20

Ω 1m 2m 3m 4m 5m

TYPICAL RC MEMBER DETAILS FOR 100mm & 150mm THK WALLS

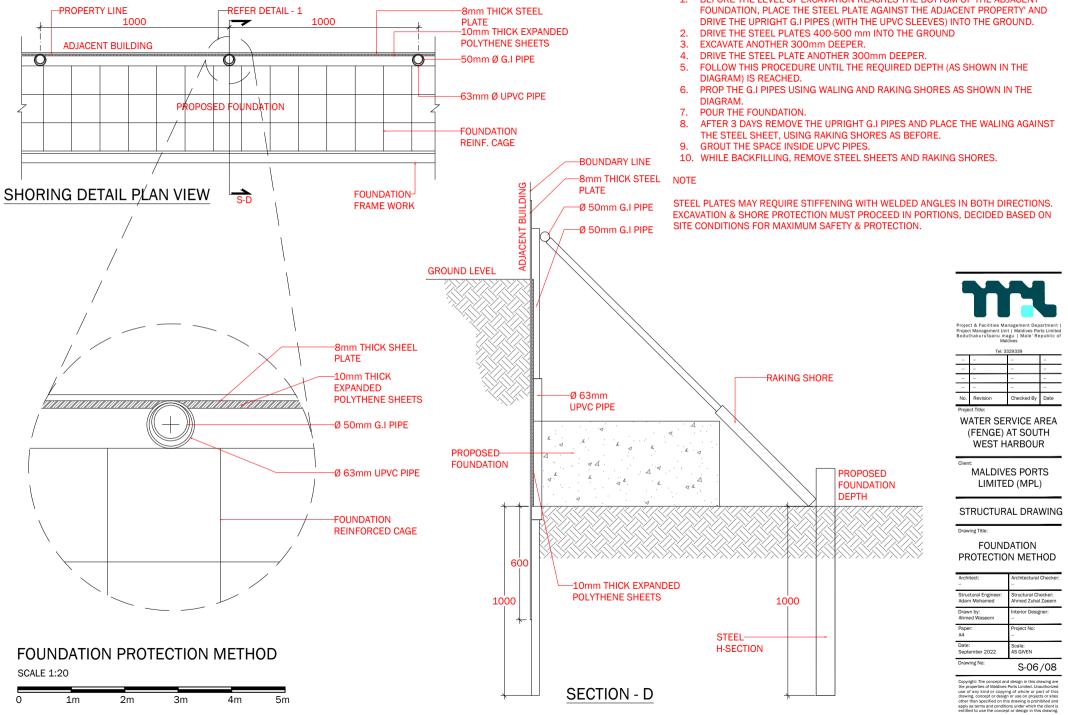
NOTES:

1. STIFFENER BEAMS / COLUMNS SHALL BE REQUIRED TO WALL AREAS GREATER THAN 12 SQM WHICH ARE UNSUPPORTED LATERALLY BY CONCRETE WALLS OR COLUMNS.

2. APPROVED FLEXIBLE SEALANT SHALL BE PROVIDED AT THE INTERFACE OF CONCRETE & BLOCK WORK MASONRY AS SHOWN.

3. BLOCK WORK RATES SHOULD INCLUDE FOR ALL CONSTRUCTION OF R.C. STIFFENER COLUMN / BEAMS FLEXIBLE JOINTS, ANCHORS ETC.

4. BLOCK WORK FOR EXTERIOR SHALL BE USED GALVANIE "X" MESH.



1. BEFORE THE LEVEL OF EXCAVATION REACHES THE BOTTOM OF THE ADJACENT

METHOD OF PROTECTING ADJACENT STRUCTURES DURING EXCAVATION FOR FOUNDATION

GENERAL

- 1. ALL STRUCTURAL DRAWINGS SHALL BE READ IN CONJUNCTION WITH ALL ARCHITECTURAL AND SERVICE DRAWINGS, SPECIFICATIONS AND WRITTEN INSTRUCTIONS IF ISSUED DURING THE COURSE OF THE CONTRACT. ALL DISCREPANCIES SHALL BE REFEREED FOR DECISION BEFORE PROCEEDING WITH THE WORK.
- 2. THE DRAWINGS SHALL NOT BE SCALED. ALL DIMENSIONS RELEVANT TO SETTING OUT AND OFF-SITE SHALL BE VERIFIED BY THE CONTRACTOR BEFORE CONSTRUCTION AND FABRICATION IS COMMENCED.
- DURING THE CONSTRUCTION PERIOD THE CONTRACTOR SHALL BE RESPONSIBLE TO MAINTAIN THE STABILITY OF STRUCTURE AND ENSURE THAT NO STRUCTURAL ELEMENT BE OVERSTRESSED UNDER CONSTRUCTION ACTIVITIES.
- WORKMANSHIP AND MATERIALS SHALL BE IN ACCORDANCE WITH THE RELEVANT RECENT BS CODES OR OTHER ACCEPTABLE STANDARDS.
- 5. BASED ON THE DRAWINGS AND SPECIFICATIONS THE CONTRACTOR SHALL PRODUCE STRUCTURAL SHOP DRAWINGS FOR APPROVAL IF REQUESTED.
- 6. ALL DIMENSIONS TO STRUCTURAL DRAWINGS ARE IN MILLIMETERS UNLESS STATED OTHERWISE. ALL LEVELS ARE EXPRESSED IN METERS.
- 7. THE REINFORCED CONCRETE DESIGN IS BASED ON BS 8110' STRUCTURAL USE OF CONCRETE'
- REFER TO STANDARD AND TYPICAL DETAILS AS SHOWN IN THE TYPICAL DRAWINGS FOR DETAILS NOT SHOWN SPECIFICALLY.
- 9. ALL PROPS AND FRAMEWORK FOR BEAMS AND SLABS SHALL BE REMOVED BEFORE CONSTRUCTION OF ANY MASONRY WALLS OR OTHER PERMANENT LOADING ON THE SLAB.
- 10. ALL NON-LOAD BEARING WALLS SHALL BE KEPT CLEAR OFF THE UNDERSIDE OF SLABS AND BEAMS BY 30MM. THE JOINT SHALL BE FILLED WITH FIBRE BOARD OR COMPRESSIBLE MATERIAL PRESSED METAL COVERING BOTH SIDES OF THE JOINT, AND THE METAL COVERING SHALL BE FIXED TO SOFFIT OF THE BEAM OR SLAB A S THE CASE MAYBE.

REINFORCEMENT

- HIGH STRENGTH DEFORMED BARS DENOTED T SHALL CONFIRM TO BS-4449 WITH MINIMUM YIELD STRENGTH Fy= 460 N/mm², MILD STEEL DENOTED R SHALL HAVE 250 N/mm² YIELD STRENGTH. WIELDED WIRE MESH SHALL COMPLY WITH BS-4483.
- 2. SPLICES IN REINFORCEMENT SHALL BE MADE ONLY IN THE POSITION SHOWN OR AS OTHERWISE APPROVED
- 3. SPACER BARS SHALL BE PROVIDED AT 100 cm CENTERS WHEREVER REINFORCEMENT IS PLACED IN MORE THAN ONE LAYER, UNLESS STATED OTHERWISE
- 4. WELDING OF REINFORCEMENT SHALL NOT BE PERMITTED. IF REINFORCEMENT SHOULD BE WELDED, APPROVAL IS REQUIRED.
- 5. ALL REINFORCEMENT SHALL BE SUPPORTED IN ITS CORRECT POSITION DURING CONCRETING BY APPROVED BAR CHAIRS, SPACERS, OR SUPPORT BARS.
- 6. TYPICAL DEVELOPMENT AND SPLICES OF DEFORMED BARS WITH Fy = 460 N/mm² AND Fcu = 30 N/mm², (CUBE STRENGTH) SHALL BE AS FOLLOWS, UNLESS OTHERWISE MENTIONED IN DRAWINGS:
 - 6.1 BASIC TENSION DEVELOPMENT LENGTH, LD = 56 x BAR Ø
 - 6.2 MINIMUM COMPRESSION DEVELOPMENT LENGTH, LDC = 40 x BAR Ø (OR 300MM WHICH EVER IS MORE)

FOUNDATIONS

1. ALL FOUNDATIONS HAS BEEN DESIGNED FOR SAFE GROUND PRESSURE OF 150 $\rm kN/m^2$

2. ALL FOOTINGS SHALL BE PLACED MINIMUM 1.2 m BELOW THE NATURAL GROUND LEVEL

UNLESS STATED OTHERWISE

 ALL BACKFILL SHOULD BE DONE WITH APPROVED MATERIAL AND SOURCE. ALL BACKFILL SHOULD BE STRUCTURAL FILL, COMPACTED IN LAYERS AS SPECIFIED.

4. WEAK POCKETS FOUND BELOW THE ASSUMED FOUNDATION LEVELS SHALL BE REMOVED AND REPLACED BY PLAIN CONCRETE.

REPLACED BY FLAIN CONCRETE.

5. IN CASE OF EXCAVATIONS BELOW THE ASSUMED LEVEL OF THE FOOTING, THE SOIL SHALL BE REPLACED BY PLAIN CONCRETE.

6. IN CASE GROUND WATER IS PRESENT ABOVE FOUNDATION LEVEL, THE

CONTRACTOR SHALL BE

RESPONSIBLE FOR DE-WATERING THE SITE, AND LOWERING THE GROUND WATER TO AT LEAST

70CM BELOW LEVEL OF FOUNDATIONS.

7. THE CONTRACTOR SHALL MAINTAIN DRY WORKING CONDITIONS THROUGHOUT THE CONSTRUCTION

PERIOD. RESTORING WATER TABLE CAN BE DONE AFTER BACKFILLING AND COMPACTION UP TO

THE SLAB ON GRADE LEVEL, OR AS DIRECTED BY THE ENGINEER.

8. NO BACK FILLING SHALL BE PLACED AGAINST WALLS RETAINING EARTH, UNLESS THE WALLS

ACHIEVE SUFFICIENT STRENGTH TO PREVENT MOVEMENT OR STRUCTURAL DAMAGE.

9. UNLESS OTHERWISE SHOWN ALL FOOTINGS ARE CONCENTRIC TO COLUMNS.



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No.	Revision	Checked By	Date

WATER SERVICE AREA (FENGE) AT SOUTH WEST HARBOUR

Client: MALDIVES PORTS LIMITED (MPL)

STRUCTURAL DRAWING

Drawing Title:

Project Title:

GENERAL NOTE

Architect:	Architectural Checker:
Structural Engineer:	Structural Checker:
Adam Mohamed	Ahmed Zuhal Zaeem
Drawn by:	Interior Designer:
Ahmed Waseem	
Paper:	Project No:
A4	
Date:	Scale:
September 2022	AS GIVEN
Drawing No:	S-07/08

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CONCRETE

- 1. A. ALL INSITU STRUCTURAL CONCRETE SHALL HAVE MINIMUM 28 DAYS CUBE STRENGTH OF 30 N/mm² TO THE RELEVANT CLAUSES OF BS5328.
- B. ALL PLAIN CONCRETE (OR BLINDING)SHALL HAVE MINIMUM 28 DAYS CUBE STRENGTH OF 15 N/mm² (EQUIVALENT CYLINDER STRENGTH, Fc = 12 N/mm²), TO THE RELEVANT CLAUSES OF BS538.
- 2. SULPHATE RESISTING CEMENT SHALL BE USED FOR ALL CONCRETE IN CONTACT WITH GARBAGE.
- NO OPENINGS, HOLES, CHASES OR EMBEDMENT OF PIPES OTHER THAN THOSE IN THE STRUCTURAL DRAWINGS SHALL BE MADE IN CONCRETE MEMBERS WITHOUT PRIOR APPROVAL.
- 4. CONSTRUCTION AND EXPANSION JOINTS SHALL BE PROPERLY FORMED AND USED ONLY WHERE SHOWN OR SPECIFICALLY APPROVED.
- 5. NO ELECTRICAL CONDUIT AND PIPES ARE TO BE CAST IN COLUMNS OR THROUGH BEAMS WITHOUT PRIOR APPROVAL UNLESS OTHERWISE SHOWN IN THE DRAWINGS.
- 6. SPECIAL RULES REGARDING CONCRETING IN HOT WEATHER SHALL BE OBSERVED
- 7. OPENING IN SLABS:
- FOR OPENING LESS THAN 150 x 150 MM, BARS SHALL BE RE-ARRANGED AROUND THE OPENING.

- FOR OPENINGS GREATER THAN 300 x 300 MM BUT LESS THAN 600 x 600 MM AND NOT SHOWN ON PLAN, PROVIDE 2xØ 16 TOP AND BOTTOM ALONG EACH SIDE AND DIAGONALLY AT CORNERS OR AS OTHERWISE DETAILED. AMOUNT OF BARS DISCONTINUED DUE TO THE OPENING SHALL BE PLACED AT THE RESPECTIVE SIDES. OPENINGS GREATER THAN 600 X 600 MM AND NOT SHOWN ON PLAN SHALL BE APPROVED.

8. SHEAR KEY SHALL BE PROVIDED AT ALL CONSTRUCTION JOINTS.

ABBREVIATIONS:

APPROX - APPROXIMATE B - BEAM B.W - BOTH WAYS BOT OR BTM - BOTTOM BOB - BOTTOM OF BASE BOS - BOTTOM OF STEEL **BOT - BOTTOM OF TRUSS** (B1) - BOTTOM STEEL BOTTOM RNFMT (B2) - BOTTOM STEEL TOP RNFMT BLDG - BUILDING € - CENTER LINE C/C - CENTER TO CENTER C - COLUMN CO-ORD - CO-ORDINATE DPC - DAMP PROOF COURSE DET OR DTL - DETAIL DIA - DIAMETER D/B - DISTRIBUTION BAR DWG - DRAWING EF - EACH FACE EW - EACH WAY EL - ELEVATION (HEIGHT) ELEV - ELEVATION (VIEW) FF - FAR FACE FS - FAR SIDE FW - FILLET WELD FFL - FINISHED FLOOR LEVEL FDN OR FND - FOUNDATION **FB - FOUNDATION BEAM** GA - GENERAL ARRANGEMENT G.I - GALVANIZED IRON IL - INVERT LEVEL IG-LONG OR LENGTH MAX - MAXIMUM MKD - MARKED MIN - MINIMUM MISC - MISCELLANEOUS N/F - NEAR FACE N/S - NEAR SIDE NOM - NOMINAL NTS - NOT TO SCALE NOS - NUMBERS **O/D - OUTSIDE DIAMETER** PL - PAVEMENT LEVEL **PROJ - PROJECTION** QTY - QUANTITY RAD - RADIUS **R.C - REINFORCED CONCRETE RE'O - REQUIRED** SW - SHEAR WALL STIFF - STIFFENER SO - SOUARE

SFL - STRUCTURAL FINISH LEVEL THK - THICK (NESS) TEMP - TEMPORARY TOB - TOP OF BEAM TOC - TOP OF COLUMN TOG - TO OF GROUT TO Platf - TOP OF PLATFORM TS - TOP OF SLAB TOS - TOP OF STEEL TOT - TOP OF TRUSS TYP - TYPICAL U/S - UNDERSIDE **UNO - UNLESS NOTED OTHERWISE** (T1) - TOP STEEL TOP RNFMT (T2) - TOP STEEL BOTTOM RNFMT (UPB) - UPSTAND BEAM



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Project Title:			

WATER SERVICE AREA (FENGE) AT SOUTH WEST HARBOUR

Client: MALDIVES PORTS LIMITED (MPL)

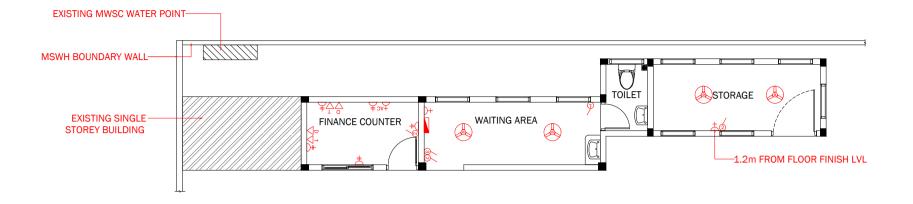
STRUCTURAL DRAWING

Drawing Title:

GENERAL NOTE

Architect:	Architectural Checker: -
Structural Engineer:	Structural Checker:
Adam Mohamed	Ahmed Zuhal Zaeem
Drawn by:	Interior Designer:
Ahmed Waseem	-
Paper:	Project No:
A4	
Date:	Scale:
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Drawing No:	S-08/08

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GROUND FLOOR
ELECTRICAL LAYOUT

Architect:	Architectural Checker: -
Structural Engineer:	Structural Checker:
Adam Mohamed	Ahmed Zuhal Zaeem
Drawn by:	Interior Designer:
Ahmed Waseem	
Paper:	Project No:
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Date:	Scale:
September 2022	AS GIVEN
Drawing No:	SE-01/04

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ELECTRICA	L POWER AND LIGHTING LEGEND
SYMBOL	DESCRIPTION
	Ø400mm CEILING MOUNT FAN (360 DEGREE GYROSCOPIC MOVEMENT/ADJUSTABLE)
<u>í</u>	1GANG SWITCH
	2GANG SWITCH
<u> </u>	3GANG SWITCH
土	13AMP X 1 GANG POWER SOCKET
<u></u>	13AMP X 2 GANG POWER SOCKET
±ac	15AMP X 1 GANG POWER SOCKET @ BEAM LVL
	DATA SOCKET (RJ45)
Ţ	TELEPHONE SOCKET (RJ11)
O	CEILING RECESSED LIGHT @ CEILING LVL
Ю	IP65 WALL LIGHT @ 2100 FROM FFL
	ELECTRICAL DISTRIBUTION BOARD
\square	CEILING MOUNT EXHAUST FAN @ CEILING LVL

IMPORTANT:

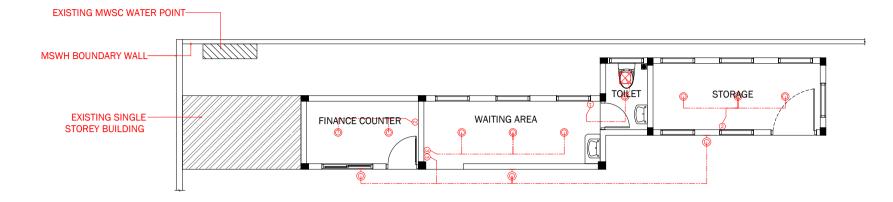
- ٠ ALL GIVEN HEIGHTS ARE FROM FINISHED FLOOR LEVEL
- ALL SWITCHES AT 1.2M HEIGHT ABOVE FINISHED FLOOR LEVEL EXCEPT ٠ WHERE SPECIFIED
- ALL SOCKETS AT 0.3M HEIGHT ABOVE FINISHED FLOOR LEVEL EXCEPT . WHERE SPECIFIED
- ALL WEATHER EXPOSED LIGHTS, SWITCHES & SOCKETS AREA IP65 ٠
- CEILING MOUNT EXHAUST FAN CONNECT TO TOILET LIGHT SWITCH .

GROUND FLOOR ELECTRICAL LAYOUT

SCALE 1:100



ELECTRICAL POWER AND LI





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ON	NOS	_	-	-	-	
G MOUNT FAN (360 DEGREE VEMENT/ADJUSTABLE)	04	-	- - No.	- - Revision	- - Checked By	 Date
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Drawing Title:
GROUND FLOOR
LIGHTING LAYOUT

Architect:	Architectural Checker:
Structural Engineer:	Structural Checker:
Adam Mohamed	Ahmed Zuhal Zaeem
Drawn by:	Interior Designer:
Ahmed Waseem	
Paper:	Project No:
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ELECTRICA	L POWER AND LIGHTING LEGEND
SYMBOL	DESCRIPTION
	Ø400mm CEILING MOUNT FAN (360 DEGREE GYROSCOPIC MOVEMENT/ADJUSTABLE)
1	1GANG SWITCH
0	2GANG SWITCH
6	3GANG SWITCH
Ŧ	13AMP X 1 GANG POWER SOCKET
±.	13AMP X 2 GANG POWER SOCKET
± ^{AC}	15AMP X 1 GANG POWER SOCKET @ BEAM LVL
D √	DATA SOCKET (RJ45)
Ţ	TELEPHONE SOCKET (RJ11)
0	CEILING RECESSED LIGHT @ CEILING LVL
Ю	IP65 WALL LIGHT @ 2100 FROM FFL
	ELECTRICAL DISTRIBUTION BOARD
\boxtimes	CEILING MOUNT EXHAUST FAN @ CEILING LVL

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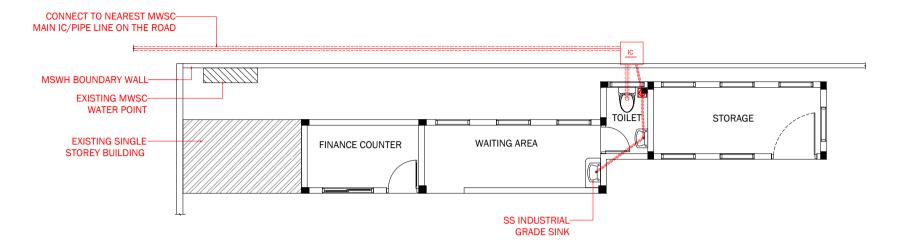
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- ALL SOCKETS AT 0.3M HEIGHT ABOVE FINISHED FLOOR LEVEL EXCEPT ٠ WHERE SPECIFIED
- ALL WEATHER EXPOSED LIGHTS, SWITCHES & SOCKETS AREA IP65 ٠
- CEILING MOUNT EXHAUST FAN CONNECT TO TOILET LIGHT SWITCH ٠

GROUND FLOOR LIGHTING LAYOUT

SCALE 1:100

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	roject Management Unit Maldives Ports Limited oduthakurufaanu magu Male' Republic of Maldives		
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WATER SERVICE AREA (FENGE) AT SOUTH WEST HARBOUR

Client: MALDIVES PORTS LIMITED (MPL)

SERVICES DRAWING

Drawing Title: GROUND FLOOR SEWAGE LAYOUT

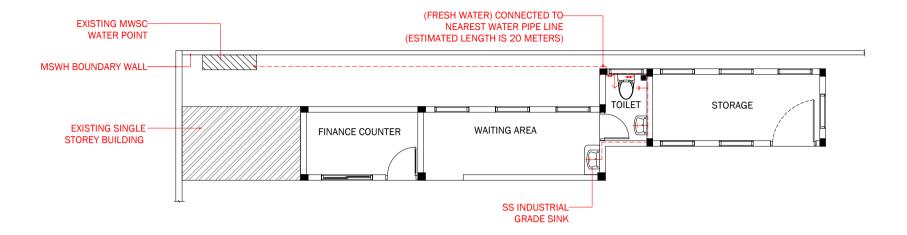
Architect:	Architectural Checker
Structural Engineer:	Structural Checker:
Adam Mohamed	Ahmed Zuhal Zaeem
Drawn by:	Interior Designer:
Ahmed Waseem	
Paper:	Project No:
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Drawing No:	SE-03/04

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SYMBOL	DESCRIPTION	NOS
	CLEANING / RODDING EYE	
	FLOOR TRAP WITH GULLY	01
	SHOWER	00
\rightarrow	BIDET SHOWER	01
-+	FAUCET	02
	ТАР	02
	GATE VALVE / BALL VALVE	02
	ELECTRIC PUMP	-
	HDPE FRESH WATER PIPE	
	HDPE WELL WATER PIPE	
	Ø50mm UPVC VENT PIPE	
	Ø50mm UPVC WASTE WATER PIPE	
	Ø100mm UPVC SEWAGE PIPE	-
IC	INSPECTION CHAMBER	01

SANITARY & PLUMBING LEGEND

GROUND FLOOR SEWAGE LAYOUT





SYMBOL	DESCRIPTION	NOS
⊕⊫	CLEANING / RODDING EYE	
	FLOOR TRAP WITH GULLY	01
	SHOWER	00
\longrightarrow	BIDET SHOWER	01
-+	FAUCET	02
	ТАР	02
	GATE VALVE / BALL VALVE	02
	ELECTRIC PUMP	
	HDPE FRESH WATER PIPE	
	HDPE WELL WATER PIPE	
	Ø50mm UPVC VENT PIPE	
	Ø50mm UPVC WASTE WATER PIPE	
	Ø100mm UPVC SEWAGE PIPE	

INSPECTION CHAMBER

SANITARY & PLUMBING LEGEND

IC

Project & Facilities Management Department | Project Management Unit | Maldives Ports Limited Boduthakurufaanu magu | Male' Republic of Maldives

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WATER SERVICE AREA (FENGE) AT SOUTH WEST HARBOUR

Client: MALDIVES PORTS LIMITED (MPL)

SERVICES DRAWING

Drawing Title: GROUND FLOOR PLUMBING LAYOUT

Architect:	Architectural Checker:
Structural Engineer:	Structural Checker:
Adam Mohamed	Ahmed Zuhal Zaeem
Drawn by:	Interior Designer:
Ahmed Waseem	
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01

GROUND FLOOR PLUMBING LAYOUT

Project Management Unit Facilities Management & Maintenance Department Maldives Ports Limited

Date: March 2023

SCOPE OF WORKS

PROJECT: CONSTRUCTION OF WATER SERVICE AREA (FENGE) AT SOUTH WEST HARBOUR

1. GENERAL DESCRIPTION

Maldives Ports Limited has a requirement to expand the existing water service area to facilitate the growing needs at Male' Southwest Harbour. The works shall be done as per drawings, the scope of work, and general contract conditions.

The Contractor shall provide all labor, material tools, equipment, supervision, and other related items required to complete the project as per the scope of work and attached drawings.

2. SCOPE OF WORK

The general scope of work can be summarized as follows:

- o Construction of a finance counter, storeroom, waiting room, and toilet
 - Concrete Works, Masonry & Plastering Works, Ceiling Works, Tiling Works, Plumbing & Electrical Works.
- Site Cleaning & Disposing of surplus materials.

3. SITE LOCATION

The project site is located inside Male' South West Harbour (T Jetty).

4. WORKING HOURS

Working hours shall be 8:00 hrs to 22:30 hrs. Saturday to Thursday. No work shall be done on public holidays and port holidays without prior approval from MPL.

5. EXECUTION OF WORK

On award of the work, the Contractor shall submit all items below via email:

- a) Proposed start date
- b) Weekly schedule/activity plan for the duration of the project prior to the start date.
- c) For dismantling/blocking or making a connection to any existing services or any shut-down, the contractor shall inform the MPL at least 1 working day in advance and proceed with the work only after permission from the MPL.

6. PROGRESS REPORT

- a) The Contractor shall submit weekly progress reports to the employer which shall be prepared to a format acceptable to the employer.
- b) Daily logbook will be set up at the site to be signed at the end of each working day by the representative from the contractor and MPL.
- c) Weekly site meetings attended by all Parties shall be conducted at an agreed location to discuss the progress of the project and the minutes of such meetings shall become part of this contract.

7. MATERIALS

- a) All materials used on this work shall be new and approved by MPL.
- b) The contractor shall submit material samples and catalog for pre-approval.
- c) Any changes/substitutes on material shall be approved by MPL before proceeding.
- d) All materials shall be stored in a proper manner and protected from natural elements to avoid deterioration.
- e) The contractor shall provide at his own expenses all materials, labor, tools and equipment including all necessary transport for the proper execution and completion of the works.

8. <u>SITE CLEARANCE AND CLEANUP</u>

On completion of the project, The Contractor shall clear away all debris and excess materials accumulated at the site and dispose of it away from the premises, maintaining a neat site condition.

9. SECURITY CLEARANCE

- a) The contractor shall give workers' names at least 2 days in advance to get the security clearance.
- b) All team workers shall have an official photo ID or photo ID with the company name on it.
- c) The Contractor shall inform and provide in writing transportation details vehicle registration number, driver's name, and date of delivery to MPL at least 24 hours in advance for material deliveries.

10. <u>SAFETY</u>

- a) The contractor shall provide all Personal Protective Equipment for the workers as per the requirement of the site and ensure safety of workmen, Employers staff and any third party.
 - i. Work will be stopped in case the proper protective equipment is not found with the workers and the lapse of time shall be at the Contractor's expense.
 - ii. MPL reserves the right to suspend work when and where Contractor's safety and health program is considered to be operating in an inadequate or non-complying manner.
- b) Contractor should take all safety measures and all precautions to prevent any damages to Employer's installation, equipment or any other utility or features and if any damage occurs the contractor should pay the cost of repair for the respective party.

NOTE

The Bidder should thoroughly go through Scope of Works, Drawings and the worksite, and should include all necessary costs not included in BOQ as Addition / Omission Bill. If there are any concerns regarding anything the bidder should inform MPL and have it sorted out before quoting for the works.

- All works is to be carried out with good workmanship practice to the satisfaction of Maldives Ports Limited.
- 2. Maldives Ports Limited <u>will provide **ELECTRICITY & WATER**</u> required for the work. (Contractor shall provide an electricity Board as per the standards of STELCO)
- Special consideration shall be given NOT to disrupt any ongoing works of inside the boundaries of MPL site and adjacent sites. Contractor is to co-ordinate with Projects Management Department of MPL in coming up with a proper work schedule.