


DRAWINGS

**Construction of 2 x Substations -Location 2
K.Thulusdhoo**

N. Suman

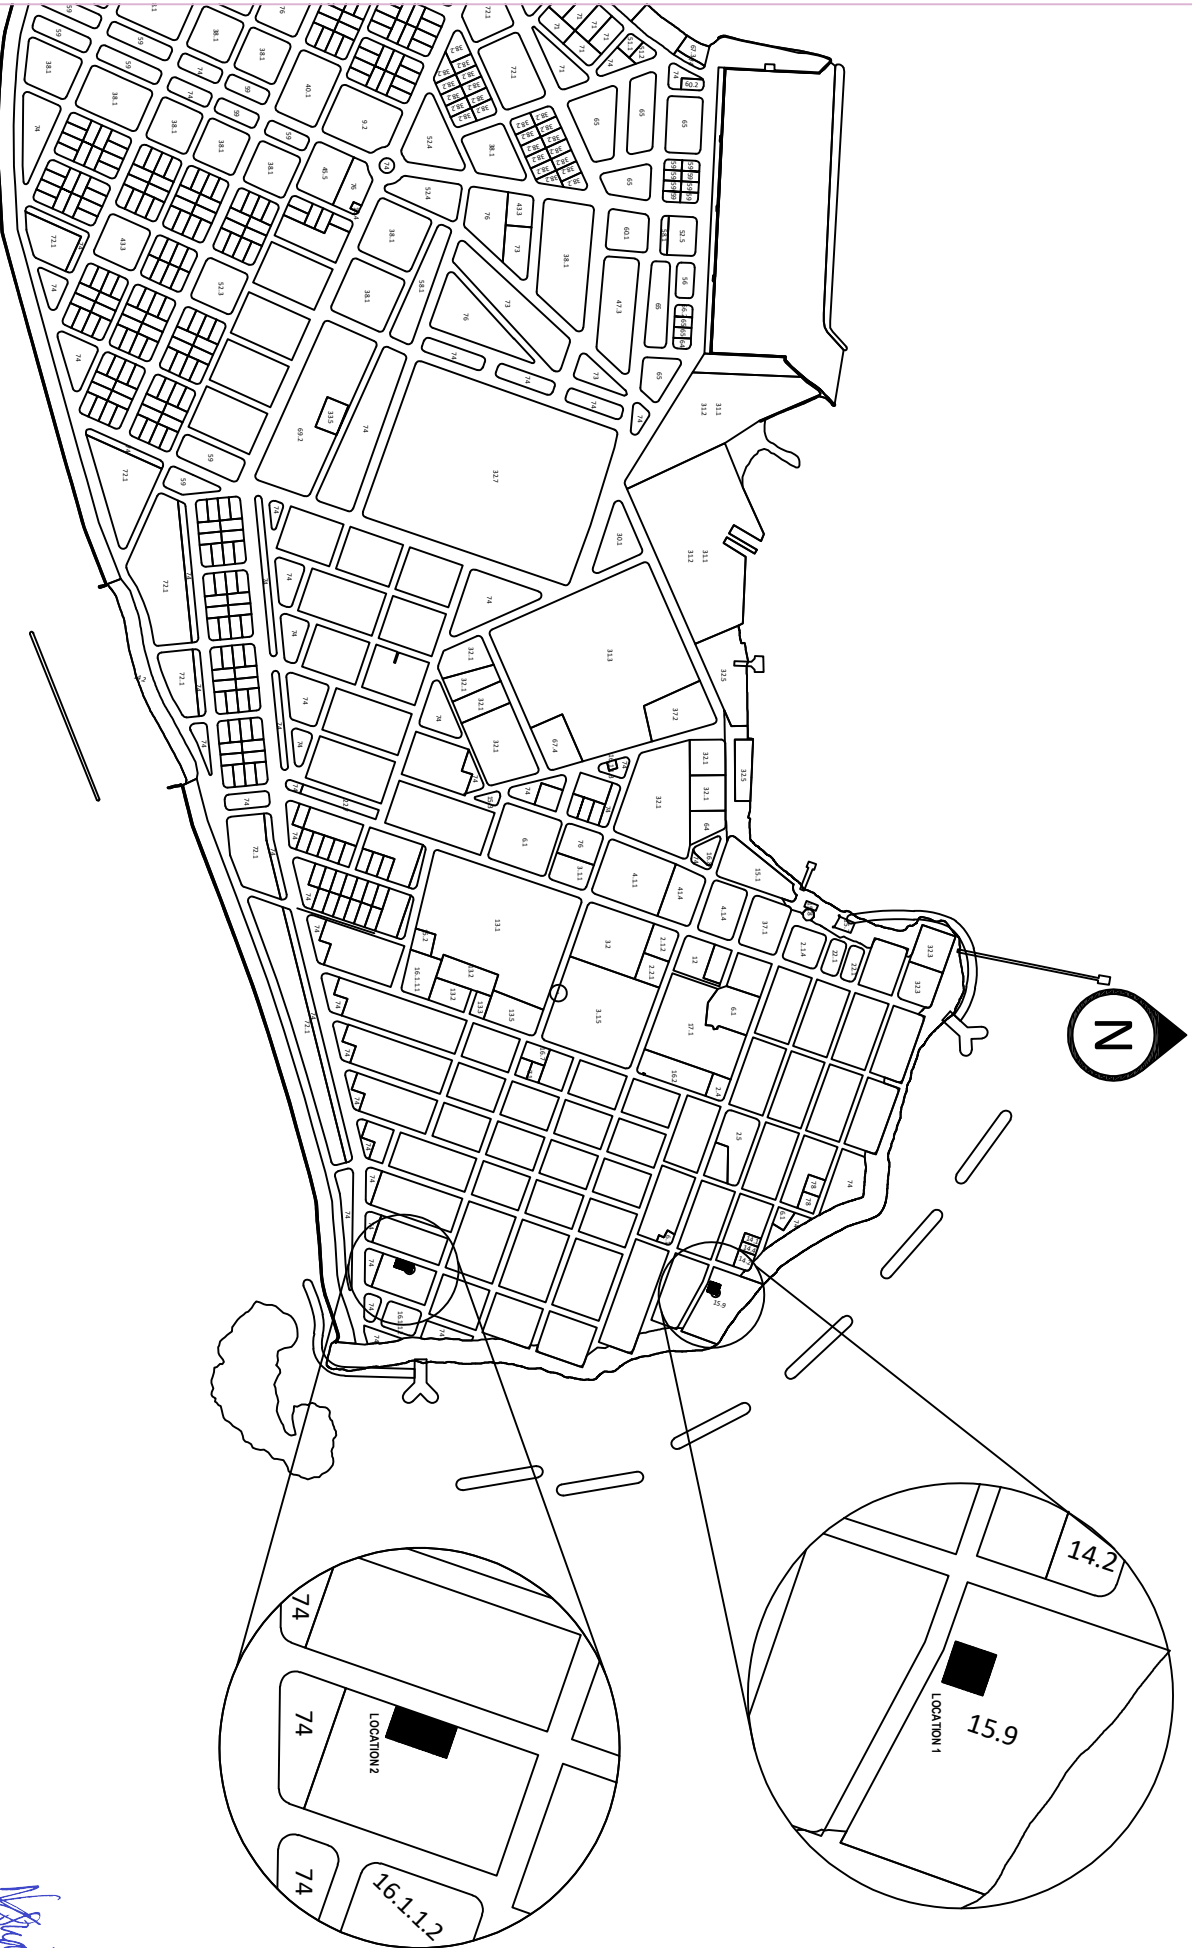

M. S. S. S.



STELCO
 STATE ELECTRIC COMPANY LIMITED
 PROJECTS@STELCO.COM.LK

PROJECT NAME
K. THULUSDHOO 2 SUBSTATION
CONCEPT DESIGN

DRAWN BY:
 HASHIM
 ARCHITECT
ENGINEER
 ANOOF

CHECKED BY:
 AMJAD
APPROVED BY:
 MALIK

SCALE AS GIVEN
DATE ...

REVISION:

NAME	DATE

PAGE NO.

SITE PLAN

Scale 1:50

PROJECT NAME
THULUSDHOO SUBSTATION
LOCATION 2

DRAWN BY:
ALI HASHIM
ARCHITECT
ENGINEER
MOHAMMED ANOOF ANWAR


CHECKED BY:
AMJAD MOHAMMED
APPROVED BY:
ABDUL MALIK

SCALE
DATE

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NAME	DATE

PAGE NO.
1

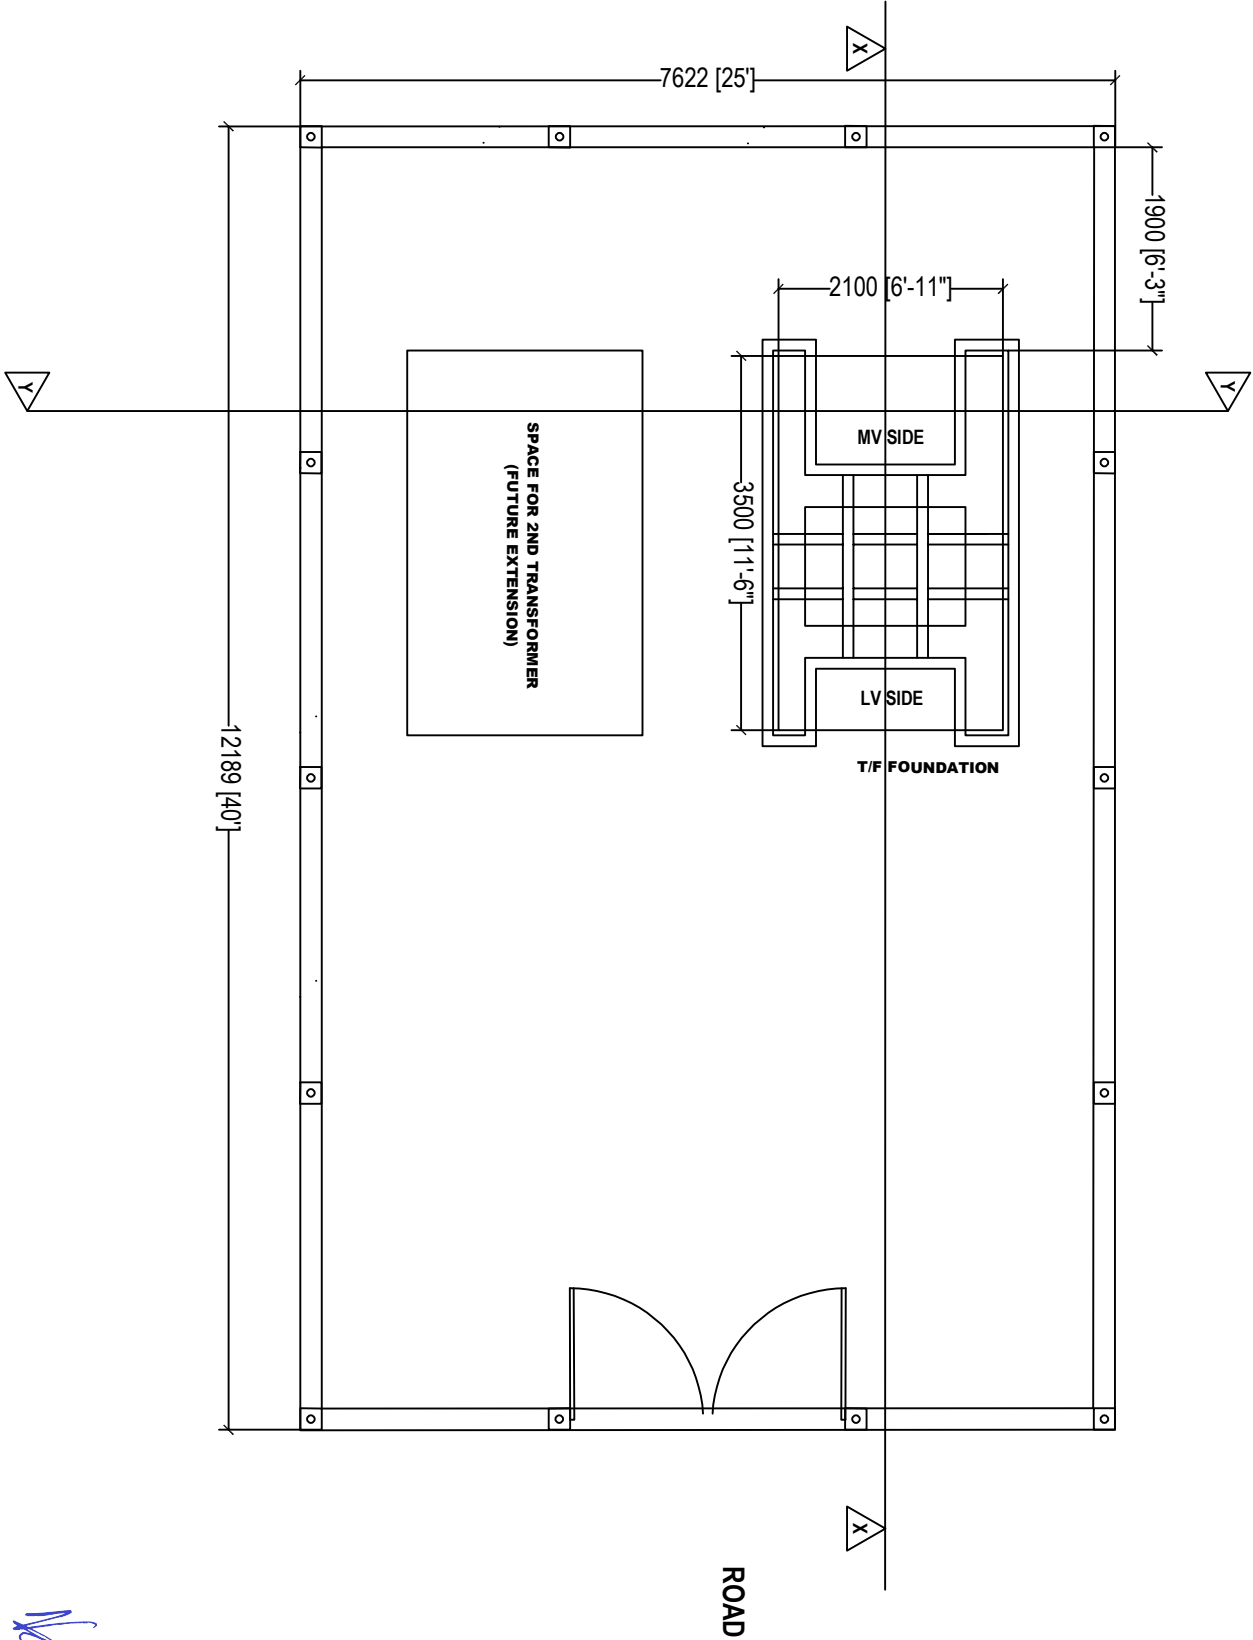

Mohammed Anooof Anwar

PROJECT NAME
THULUSDHOO SUBSTATION
LOCATION 2

DRAWN BY:
ALI HASHIM
ARCHITECT

ENGINEER
MOHAMMED ANOOF ANWAR

CHECKED BY:
AMJAD MOHAMMED

APPROVED BY:
ABDUL MALIK

SCALE


DATE

REVISION:

NAME	DATE


COLUMNS AND BEAMS PLAN

Scale 1:50

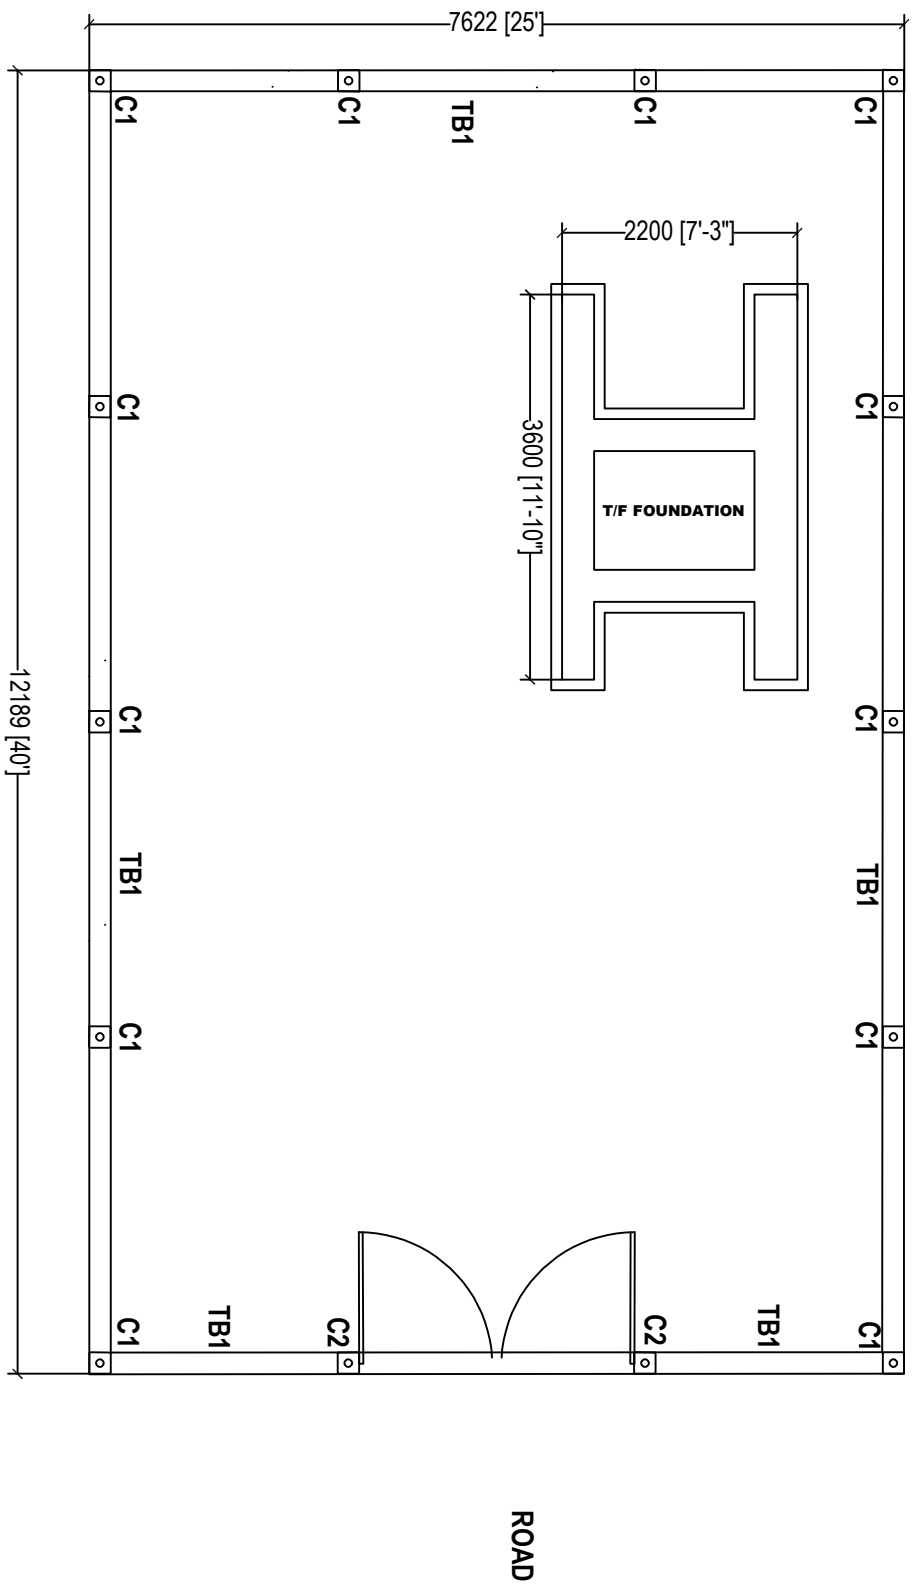


Mohammed Anooof Anwar

SIDE ELEVATION(B)

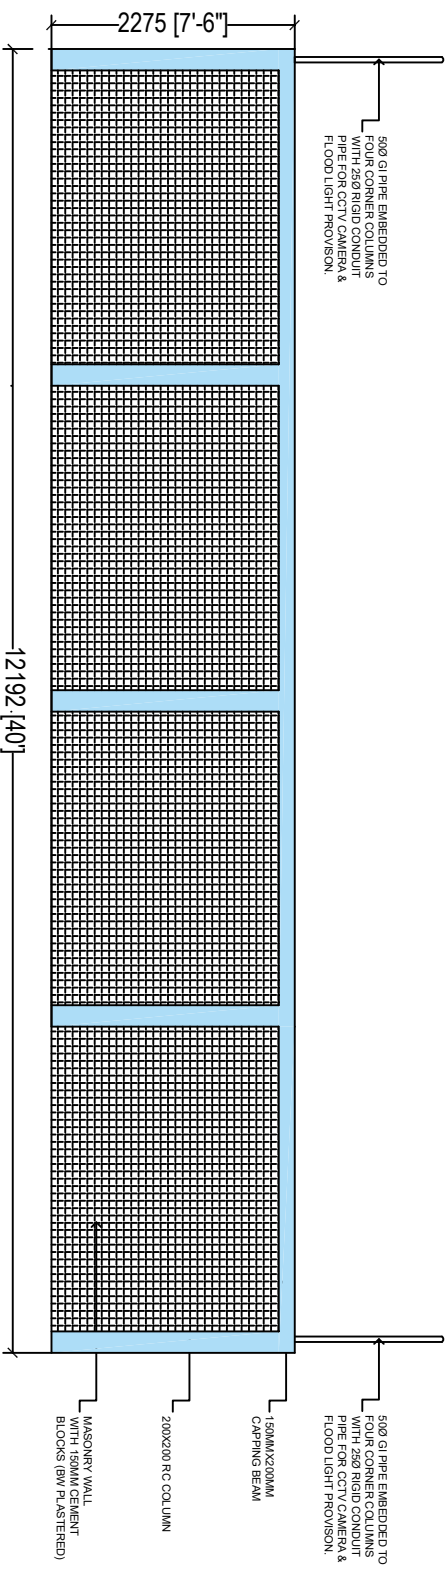

FRONT ELEVATION (A)

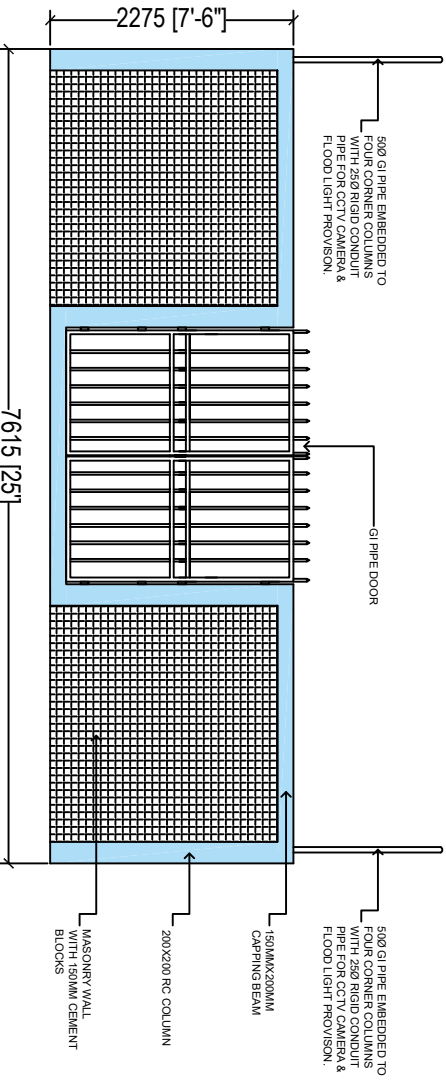

Scale 1:50



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STATE ELECTRIC COMPANY LIMITED

PROJECT'S PLANNING AND DEVELOPMENT DEPARTMENT
REPUBLIC OF MALDIVES
PROJECTS@STELCO.COM.MV

PROJECT NAME
THULUSDHOO SUBSTATION
LOCATION 2

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ARCHITECT

ENGINEER
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CHECKED BY:
AMJAD MOHAMMED

APPROVED BY:
ABDUL MALIK

SCALE


REVISION:

NAME	DATE


PAGE NO.
3

Mohamed Anooof Anwar

SECTIONAL X-X

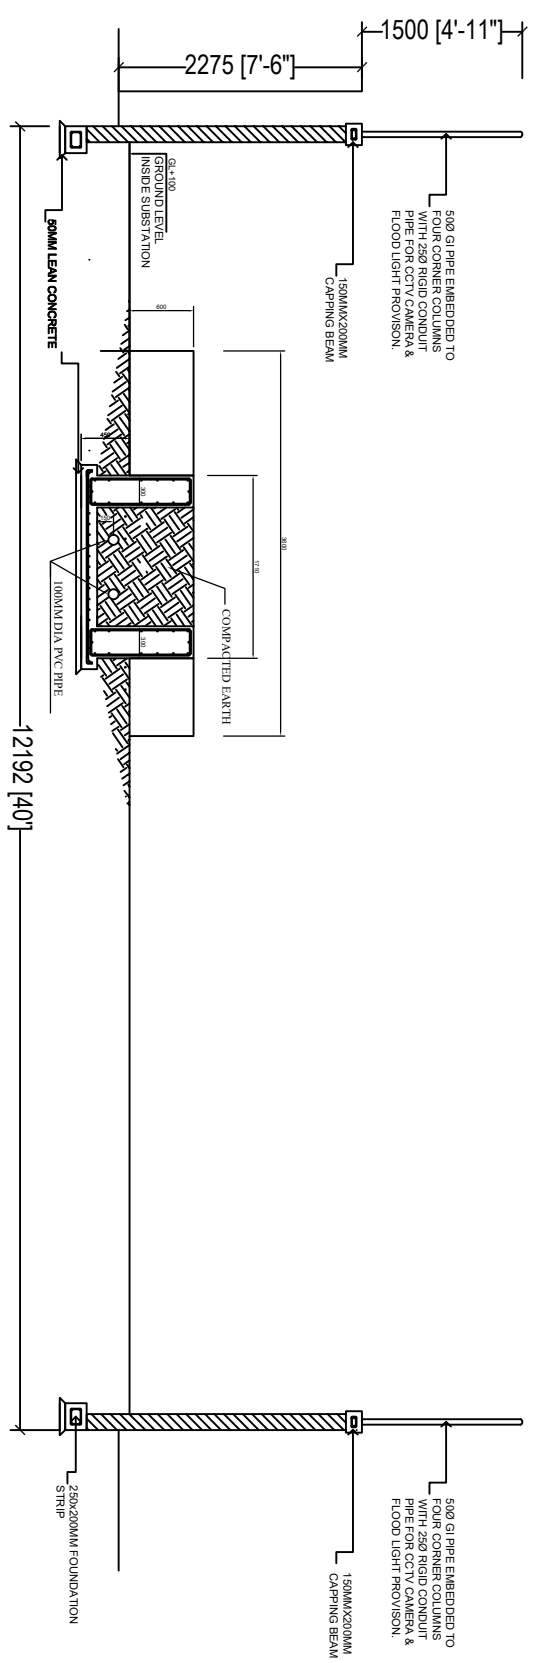


SECTIONAL Y-Y

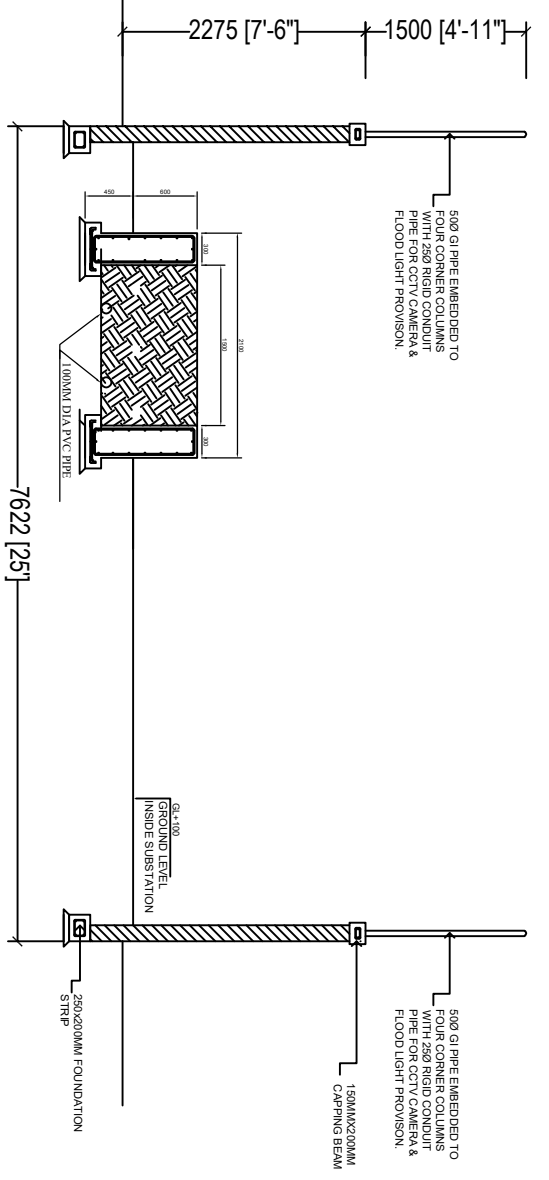


Handwritten signature


GATE COLUMN DETAIL (C2)
Scale 1:50

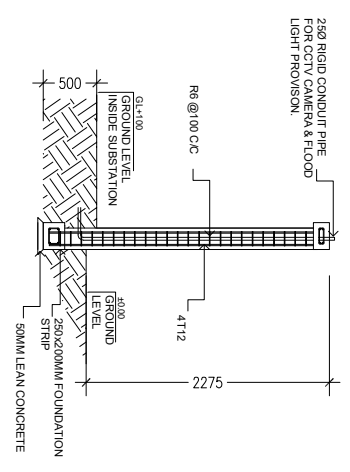

BOUNDARY WALL DETAIL
Scale 1:50

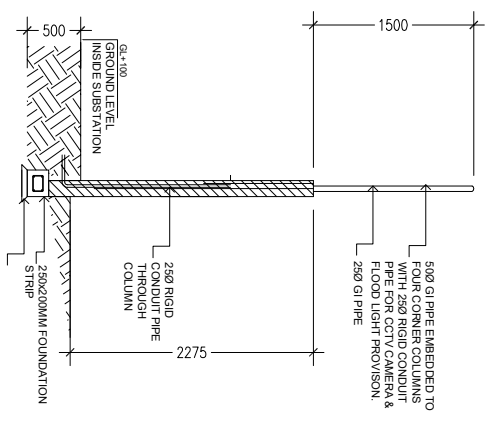

GATE DETAIL
Scale 1:50

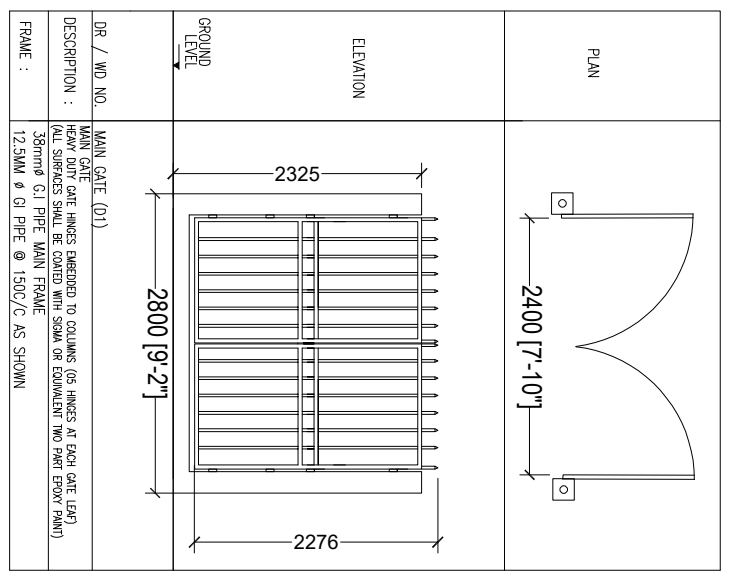

PROJECT NAME
THULUSDHOO SUBSTATION
LOCATION 2

DRAWN BY:
ALI HASHIM
ARCHITECT

ENGINEER
MOHAMMED ANOOF ANWAR

CHECKED BY:
AMJAD MOHAMMED


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ABDUL MALIK

SCALE
DATE


REVISION:

NAME	DATE


TRANSFORMER FOUNDATION PLAN
Scale 1:50

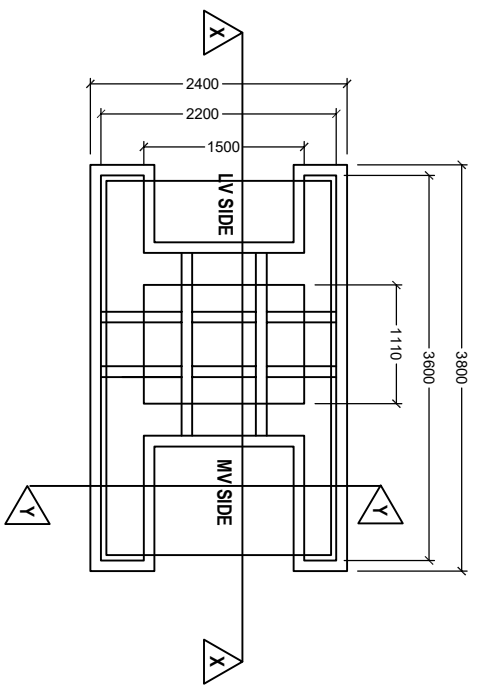

SECTION X-X
Scale 1:50

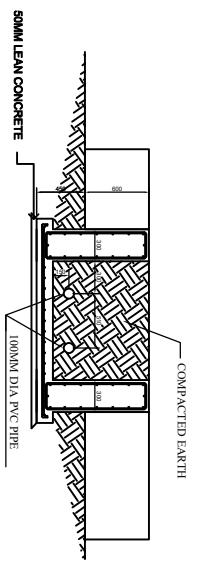


SECTION Y-Y
Scale 1:50

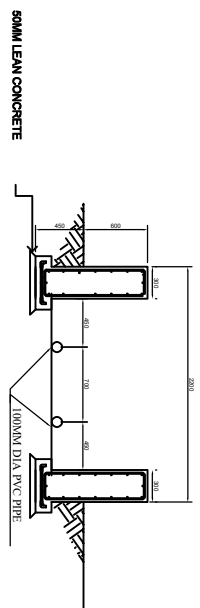





COLUMN DETAIL: C1

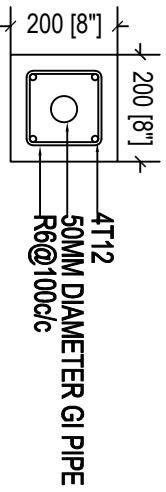

COLUMN DETAIL: C2

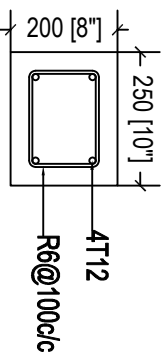

TIE BEAM: TB

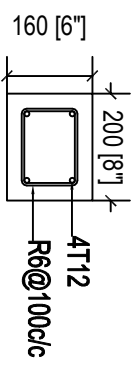

CAPPING BEAM: CB

STRUCTURAL DETAILS

Scale 1:10



PROJECT NAME THULUSDHOO SUBSTATION LOCATION 2	DRAWN BY: AUI HASHIM ARCHITECT	CHECKED BY: AMJAD MOHAMMED	SCALE	REVISION:	PAGE NO. 7
	ENGINEER MOHAMMED ANOOF ANWAR	APPROVED BY: ABDUL MALIK	DATE		

Mohammed Anooof Anwar