# VILLAGE OF SARANAC LAKE

### SARANAC LAKE, NEW YORK

## ENTRY SIGNS

MAYOR JAMES WILLIAMS

VILLAGE BOARD MEMBERS

MATT SCOLLIN **KELLY BRUNETTE RICH SHAPIRO** TOM CATILLAZ

VILLAGE MANAGER **ERIK STENDER** 



IT IS A VIOLATION OF NEW YORK STATE LAW FOR ANY PERSON, UNLESS ACTING UNDER THE SUPERVISION OF A LICENSED PROFESSIONAL ENGINEER, TO ALTER AN ITEM IN ANY WAY.

PROJECT TITLE:

VILLAGE OF SARANAC LAKE **ENTRY SIGNS** 

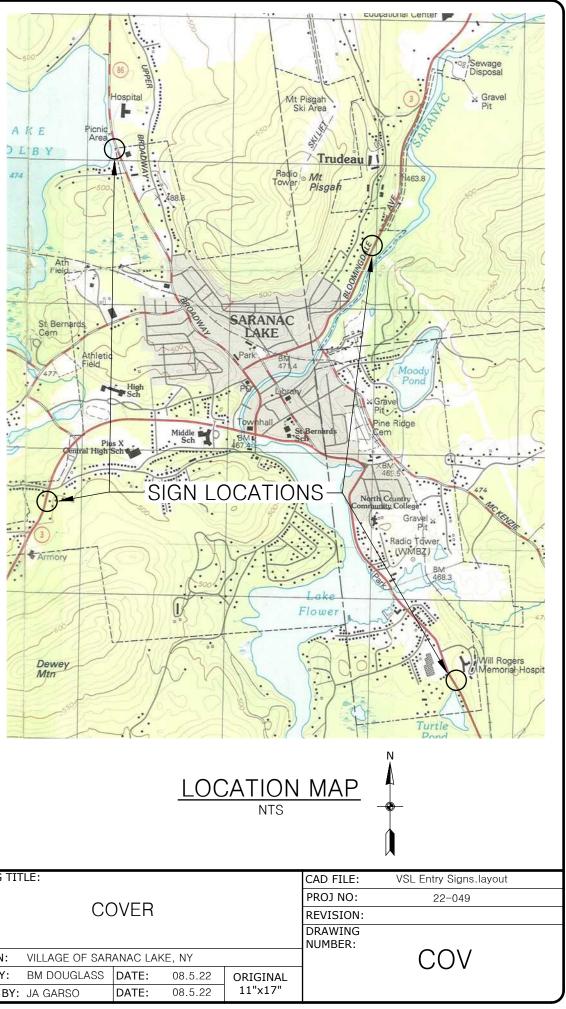
North Woods	
348 Lake Street · Saranac Lake, NY 12983	
🖤 (518) 891-4975	1

www.north-woods-engineering.com

New York State Certified

DRAWING TITLE:

LOCATION:	VILLAGE OF SAR	ANAC I
DRAWN BY:	BM DOUGLASS	DATE
CHECKED BY:	JA GARSO	DATE



		— 6 MIL ALUMINUM COMPOSITE MATERIAL, PAINTED	
	SARANAC	<ul> <li>PAINTED PVC SIGN W/ RAISED LETTERING FOR "SARANAC LAK IN POWDER COATED STEEL FR/ MOUNT TO WOOD FRAME WITH STAINLESS STEEL HARDWARE</li> <li>6x6 SIGN POST PER 1/S51</li> </ul>	AME,
		<ul> <li>POST BASE PER 1/S51</li> <li>CAST IN PLACE CONCRETE CAP, EPOXY COATED, COLOR BY OWNER</li> <li>THIN STONE VENEER, SELECTIC BY OWNER, INSTALL IAW MANUFACTURER'S SPECS &amp;</li> </ul>	DN
	1 SIGN ELEVATION 1/2"=1'	<ul> <li>INSTRUCTIONS</li> <li>NOTES: <ol> <li>GRAPHICS CAN BE PROVIDED</li> <li>VSL TO CONTRACTOR FOR SIGN</li> <li>THIN STONE VENEER ON ALL</li> <li>BASE FOR SIGNS ON ROUTE 3 I</li> <li>AND ROUTE 86 NORTHBOUND.</li> <li>BACK FOR SIGNS ON ROUTE 3 AND ROUTE 86 SOUTHBOUND.</li> </ol> </li> </ul>	NAGE. 4 SIDES OF EASTBOUND OMITTED ON
IT IS A VIOLATION OF NEW YORK STATE LAW FOR ANY	PROJECT TITLE:	P North Woods	
PERSON, UNLESS ACTING UNDER THE SUPERVISION OF A LICENSED PROFESSIONAL ENGINEER, TO ALTER AN ITEM IN ANY WAY.	VILLAGE OF SARANAC LAKE ENTRY SIGNS	Address Woodds Engineering PLLC 348 Lake Street · Saranac Lake, NY 12983 (518) 891-4975 www.north-woods-engineering.com New York State Certified Service-Disabled Veteran-Owned Business	ELEVATION: VILLAGE OF SARANAC L DRAWN BY: BM DOUGLASS DATE: CHECKED BY: JA GARSO DATE:



		CAD FILE:	VSL Entry Signs.layout
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AKE, NY	-		A20
08.5.22	ORIGINAL		, (= 0
08.5.22	11"x17"		

#### **GENERAL NOTES**

- FOUNDATION DESIGN IS BASED ON SKETCHES OF SIGN PROVIDED BY 1. VILLAGE OF SARANAC LAKE. NOTIFY ENGINEER IF DESIGN OF SIGN CHANGES SUBSTANTIALLY.
- THE CONTRACTOR SHALL OBTAIN ALL REQUIRED PERMITS BY GOVERNING 2. AGENCIES HAVING JURISDICTION OVER THE PROJECT.

### FOUNDATION NOTES

- FOOTINGS SHALL BEAR ON FIRM UNDISTURBED SOIL OR COMPACTED 1. STRUCTURAL FILL.
- 2. ALLOWABLE SOIL BEARING PRESSURE (PER STRUCTURAL DESIGN NOTES) SHALL BE VERIFIED BY OWNER'S REPRESENTATIVE BEFORE PLACING FOUNDATION CONCRETE.
- SOIL BEARING SURFACES PREVIOUSLY ACCEPTED BY OWNER'S 3. REPRESENTATIVE, WHICH ARE ALLOWED TO BE SATURATED, FROZEN, OR DISTURBED SHALL BE REWORKED TO THE SATISFACTION OF OWNER'S REPRESENTATIVE.
- DO NOT PLACE FOOTINGS IN WATER OR ON FROZEN GROUND. 4.
- 5. DO NOT ALLOW GROUND BENEATH FOOTINGS TO FREEZE.

#### STRUCTURAL DESIGN INFORMATION

- 1. LOADING INFORMATION
  - A. WIND LOAD
    - BASIC WIND SPEED..... 100 mph (3 sec gust) ii. EXPOSURE C
    - iii. qz = 17.5 PSF
    - iv. WIND PRESSURE PER ASCE7-16 29.3 (SOLID FREESTANDING SIGNS)
    - v. Cf = 1.4vi. p = 20.3 PSF (APPLIED TO GROSS AREA)
- 3. ALL STRUCTURAL ELEMENTS DESIGNED BY OTHERS SHALL MEET THE REQUIREMENTS OF THE 2020 BUILDING CODE OF NEW YORK STATE.



- ALL CONCRETE WORK SHALL COMPLY WITH THE LATEST RECOMMENDATIONS AND SPECIFICATIONS OF THE 1. AMERICAN CONCRETE INSTITUTE (ACI) AND THE LOCAL BUILDING CODES
- 2. ALL CONCRETE WORK SHALL BE NORMAL WEIGHT HAVING A MINIMUM 28 DAY COMPRESSIVE STRENGTH OF 4000 PSI, UNO. WATER CEMENT RATIO TO BE KEPT TO A MINIMUM TO ENHANCE STRENGTH.
- ALL REINFORCING STEEL SHALL COMPLY WITH ASTM A615, GRADE 60, WELDED WIRE FABRIC SHALL CONFORM 3. TO ASTM A185.
- THE CONCRETE CONTRACTOR SHALL INSTALL (OR GIVE OTHER TRADES AMPLE OPPORTUNITY TO INSTALL) ALL 4. ANCHORS, BOLTS, PLATES, NAILERS, SLOTS, CHASES, PIPE SLEEVES, ETC AS REQUIRED BY OTHER TRADES. THE CONTRACTOR SHALL VERIFY ALL DIMENSIONS BEFORE SETTING SCREEDS AND FORMS. FORM RELEASE OIL TO BE APPROVED NON-TOXIC AND APPLIED TO FORMS PRIOR TO SET-UP.
- FOOTINGS SHALL REST ON SUITABLE UNDISTURBED SOIL OR COMPACTED GRANULAR FILL HAVING A MINIMUM 5. BEARING CAPACITY OF 2000 PSF. ELEVATION OF FOOTINGS ARE SHOWN ON PLANS. BUT ARE SUBJECTED TO REVISIONS WHEN TRUE SOIL CONDITIONS ARE EXPOSED BY EXCAVATION. THE ENGINEER SHALL BE NOTIFIED PROMPTLY OF ANY WEAK STRATA, WATER CONDITIONS OR OTHER POOR BEARING CONDITIONS.
- CONCRETE TEMPERATURES DURING THE FIRST SEVEN DAYS SHALL BE MAINTAINED BETWEEN 50 DEG F AND 90 6. DEG F. RAPID DRYING MUST BE PREVENTED.
- FOUNDATIONS MUST BE AT LEAST SEVEN DAYS OLD BEFORE BACKFILL. 7.
- BACKFILLING SHALL BE DONE BY PLACING SIMULTANEOUS LEVEL LAYERS AROUND THE FOUNDATION SUCH THAT 8. THE DIFFERENCE BETWEEN ONE SIDE AND THE OTHER DOES NOT EXCEED 24 INCHES.
- BACKFILL SHALL BE APPROVED MATERIAL, FREE OF BOULDERS LARGER THAN 6" DIAMETER, ORGANIC MATERIAL, 9. TOPSOIL OR DEBRIS. BACKFILL SHALL BE PLACED IN MAXIMUM 8" LIFTS AND COMPACTED TO 95% OF MAXIMUM DENSITY AT OPTIMUM WATER CONTENT AS DEFINED BY ASTM D1557 (MODIFIED PROCTOR).
- CONTRACTOR TO DESIGN, FURNISH AND INSTALL ALL TEMPORARY SHEETING, SHORING AND BRACING 10. NECESSARY TO SAFELY COMPLETE THE CONSTRUCTION. ALL WORK SHALL BE COMPLETED IN ACCORDANCE WITH OSHA STANDARDS.
- IF NECESSARY, THE CONTRACTOR SHALL PROVIDE THE NECESSARY EQUIPMENT AND CONTINUOUSLY DEWATER 11. THE SITE TO FACILITATE THE CONSTRUCTION AND SAFE WORKING CONDITIONS.
- ADHESIVE ANCHORS SHALL BE INSTALLED IN CONCRETE HAVING A MINIMUM AGE OF 21 DAYS AT THE TIME OF 12. ANCHOR INSTALLATION.

#### CONCRETE MIX DESIGN

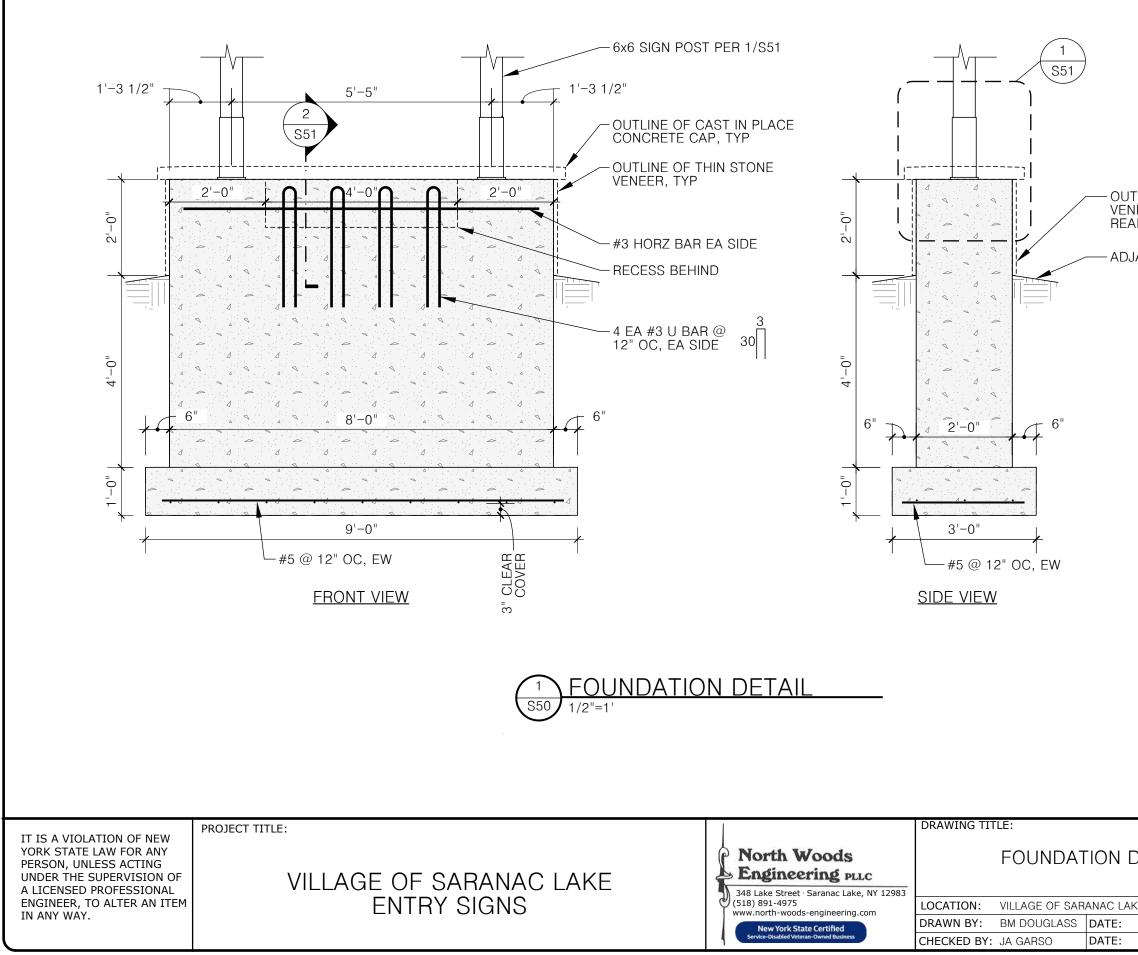
LOCATION	UNIT	MEASUREMENT
	COMPRESSIVE STRENGTH (28 DAY)	4000 PSI
WALLS AND FOUNDATIONS	WATER/CEMENT RATIO (MAX)	0.44 BY WEIGH
	AIR ENTRAINED	6.0% +/- 1.5%

NOTES:

- MIX CONCRETE IN ACCORDANCE WITH ACI 301. DELIVER CONCRETE IN ACCORDANCE WITH ASTM C94. 1. SELECT PROPORTIONS FOR NORMAL WEIGHT CONCRETE IN ACCORDANCE WITH ACI 301. PROVIDE 2. MIX DESIGN FOR REVIEW AND ACCEPTANCE BY ENGINEER PRIOR TO USE. LIMIT FLY ASH TO 15% 3.
- USE ACCELERATING ADMIXTURES IN COLD WEATHER ONLY WHEN APPROVED BY ENGINEER. USE OF 4. ADMIXTURES WILL NOT RELAX COLD WEATHER PLACEMENT REQUIREMENTS.
- USE OF CALCIUM CHLORIDE IS PROHIBITED UNLESS APPROVED BY ENGINEER IN WRITING. 5. 6
  - USE SET RETARDING ADMIXTURES DURING HOT WEATHER ONLY WHEN APPROVED BY ENGINEER.

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IT IS A VIOLATION OF NEW YORK STATE LAW FOR ANY		P North Woods	NOTEO	PROJ NO:	22-049
PERSON, UNLESS ACTING			NOTES	REVISION:	
UNDER THE SUPERVISION OF A LICENSED PROFESSIONAL	VILLAGE OF SARANAC LAKE	Engineering PLLC		DRAWING NUMBER:	
ENGINEER, TO ALTER AN ITEM	ENTRY SIGNS	348 Lake Street Saranac Lake, NY 12983 (518) 891-4975	LOCATION: VILLAGE OF SARANAC LAKE, NY	NUMBER:	S00
IN ANY WAY.		www.north-woods-engineering.com	DRAWN BY: BM DOUGLASS DATE: 08.5.22 ORIGINAL		000
		Service-Disabled Veteran-Owned Business	CHECKED BY: JA GARSO         DATE:         08.5.22         11"x17"		

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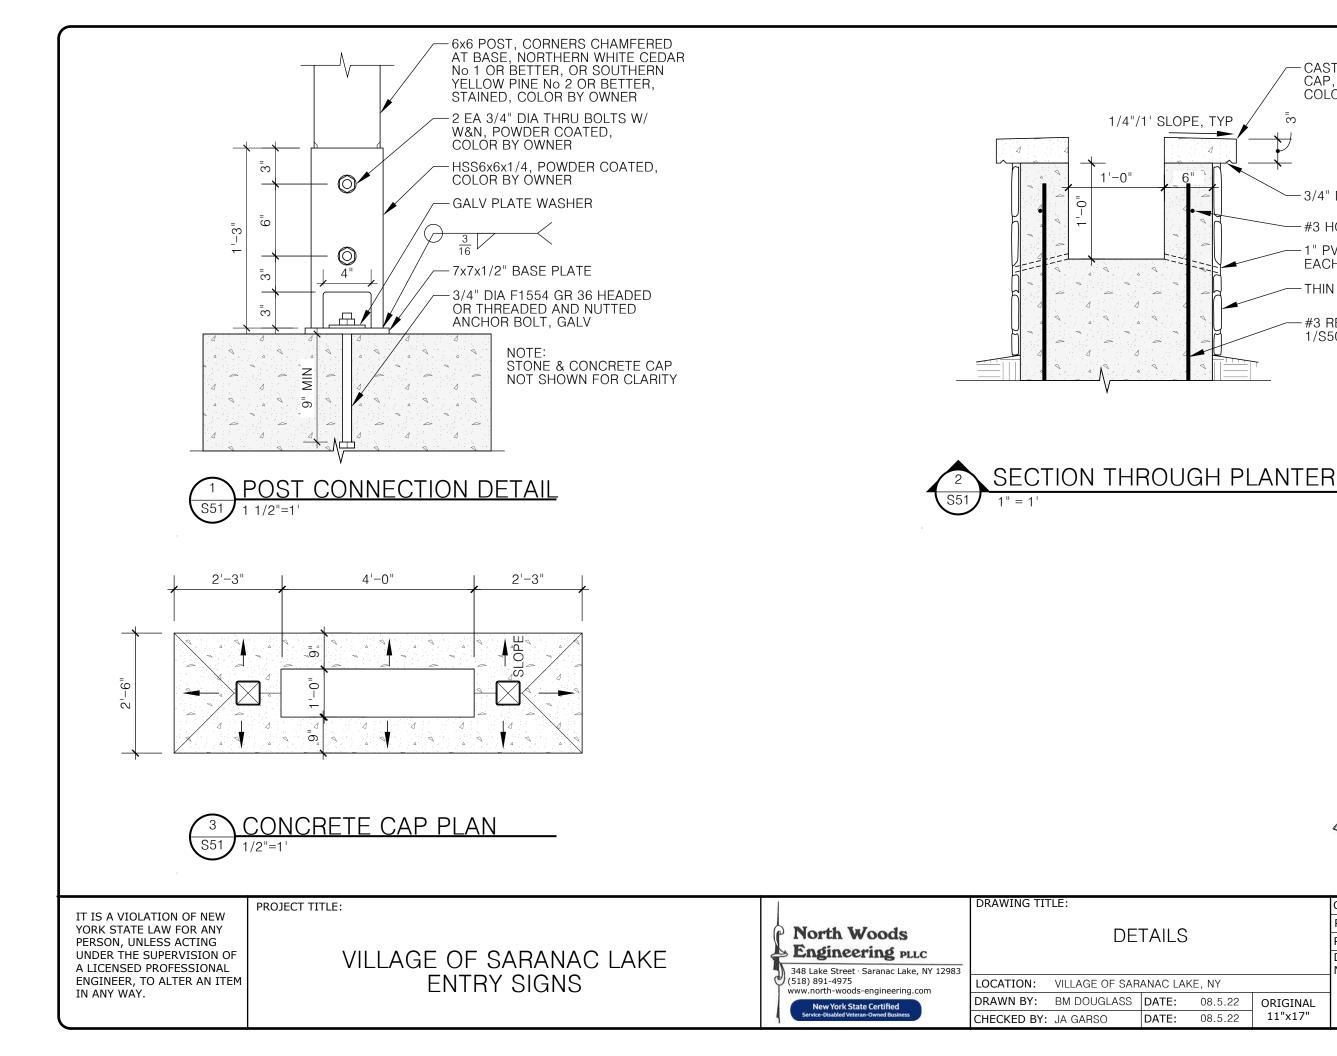


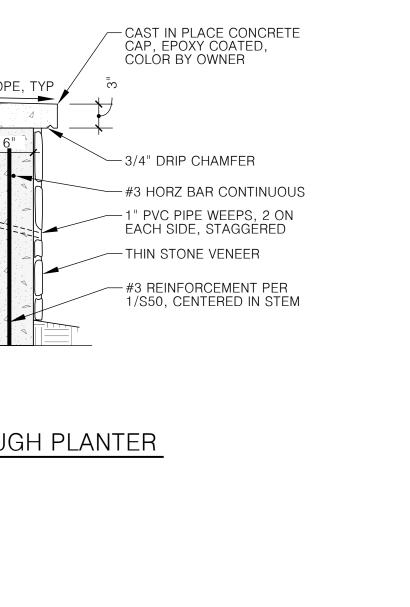
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- OUTLINE OF THIN STONE VENEER, OMITTED ON REAR OF 2 OUT OF 4 SIGNS

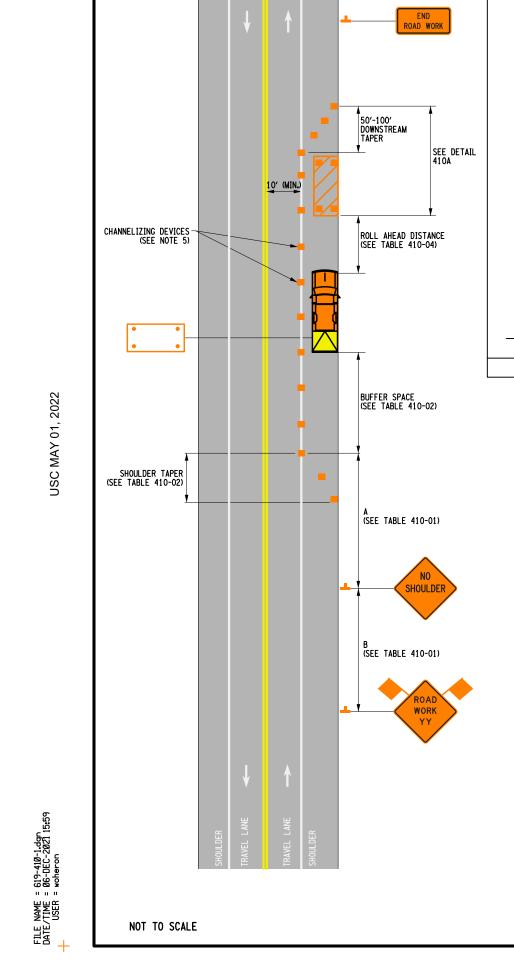
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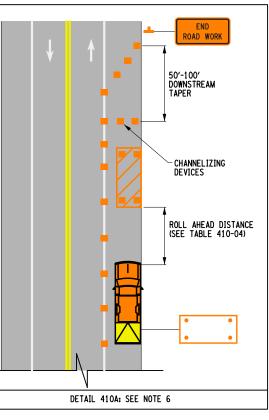


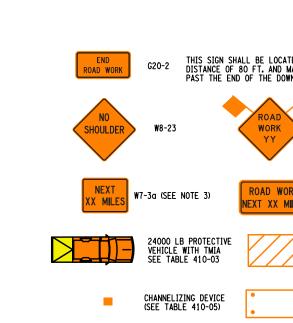




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NOTES:

1. INTERMEDIATE-TERM IS STATIONARY WORK THAT OCCUPIES A LOCATION MORE THAN ONE DAYLIGHT PERIOD UP TO 3 CONSECUTIVE DAYS, OR NIGHTTIME WORK LASTING MORE THAN 1 HOUR.

2. NO WORK ACTIVITY OR STORAGE OF EQUIPMENT, VEHICLES, OR MATERIAL SHOULD OCCUR WITHIN A BUFFER SPACE.

3. XX IS THE EXPECTED OVERALL LENGTH OF THE OPERATION TO BE COMPLETED WITHIN THE WORK DAY. A SUPPLEMENTAL DISTANCE PLAQUE W7-3G SHALL BE USED WITH SIGN W2O-1 WHEN THE DISTANCE BETWEEN THE ADVANCE WARNING SIGNS AND WORK MAY BECOME GREATER THAN 2 MILES AS A RESULT OF THE FOLLOWING SITUATIONS:

THE FOLLOWING SITUATIONS: • MULTIPLE WORK LOCATIONS ARE ANTICIPATED WITHIN XX MILES FROM THE W20-1 SIGN • WORK AREA WILL BE RELOCATED DURING THE DURATION OF THE WORK WITHIN XX MILES FROM THF W20-1 SIGN

THE SUPPLEMENT SIGN W7-3g SHALL INDICATE THE MAXIMUM ANTICIPATED DISTANCE BETWEEN THE W20-1 SIGN AND THE FARTHEST WORK LOCATION.

4. WHEN MULTIPLE WORK LOCATIONS EXIST WITHIN XX MILES FROM THE W20-1 SIGN, A G2O-1 SIGN SHALL BE PLACED EVERY TWO MILES INDICATING THE DISTANCE FROM THE SIGN TO THE FARTHEST WORK LOCATION.

5. CHANNELIZING DEVICE SPACING (CENTER TO CENTER) SHALL NOT EXCEED 20' IN THE ACTIVE WORK SPACE.

6. CHANNELIZING DEVICES SHALL BE PLACED TRANSVERSELY A MINIMUM OF EVERY 800' AS SHOWN WHEN A PAVED SHOULDER HAVING A WIDTH OF 8' OR GREATER IS CLOSED FOR A DISTANCE GREATER THAN 800'.

7. THE PROTECTIVE VEHICLE(S) SHALL MAINTAIN THE APPROPRIATE ROLL AHEAD DISTANCE, BE AN UNOCCUPIED TRUCK POSITIONED PARALLEL TO TRAFFIC, PARKING BRAKE SET, PLACED IN 2ND GEAR (MANUAL TRANSMISSIONS /ENGINE OFF) OR PARK / NEUTRAL (AUTOMATIC TRANSMISSIONS) AND HAVE THE FRONT WHEELS ALIGNED WITH THE LANE STRIPING.

NOTES ON NIGHTTIME WORK:

N1. WORK OCCURRING AFTER SUNSET AND BEFORE SUNRISE WILL BE CONSIDERED NIGHTTIME OPERATIONS.

N2. ALL SIGNS, STOP/SLOW PADDLES AND RED FLAGS USED TO WARN/ALERT/CONTROL TRAFFIC SHALL BE RETROREFLECTIVE.

N3. ALL WORKERS INVOLVED SHALL WEAR PROTECTIVE HELMETS AND NIGHTTIME APPAREL IN ACCORDANCE WITH §107-05A. HIGH VISIBILITY APPAREL AT ALL TIMES.

N4. VEHICLES OPERATING ON THE PAVEMENT OF A CLOSED ROADWAY OR TRAVEL LANE SHALL DISPLAY ROTATING AMBER BEACONS OR FLASHING LED BEACONS AT ALL TIMES.

N5. LEVEL I ILLUMINATION SHALL BE PROVIDED NEAR THE BEGINNING OF LANE CLOSURE TAPERS AND AT ROAD CLOSURES, INCLUDING THE SETUP AND REMOVAL OF THE CLOSURE TAPERS.

NG. LEVEL II ILLUMINATION SHALL BE PROVIDED FOR FLAGGING STATIONS, ASPHALT PAVING, MILLING, AND CONCRETE PLACEMENT AND/OR REMOVAL OPERATIONS, INCLUDING BRIDGE DECKS, 50 FEET AHEAD OF AND 100 FEET BEHIND A PAVING OR MILLING MACHINE.

N7. LEVEL III ILLUMINATION SHALL BE PROVIDED FOR PAYEMENT OR STRUCTURAL CRACK FILLING, JOINT REPAIR, PAVEMENT PATCHING AND REPAIRS, INSTALLATION OF SIGNAL EQUIPMENT OR OTHER ELECTRICAL/MECHANICAL EQUIPMENT, AND OTHER TASKS INVOLVING FINE DETAILS OR INTRICATE PARTS AND EQUIPMENT.

N8. ALL LIGHTING SHALL BE DESIGNED, INSTALLED, AND OPERATED TO AVOID GLARE THAT AFFECTS TRAFFIC ON THE ROADWAY OR THAT CAUSES ANNOYANCE OR DISCOMFORT FOR RESIDENCES ADJOINING THE ROADWAY.

N9. PRIOR TO THE START OF NIGHTTIME OPERATIONS, A WRITTEN NIGHTTIME OPERATIONS AND LIGHTING PLAN IS REQUIRED FOR APPROVAL.

N10. SEE NIGHTTIME SAFETY BULLETIN, HDM §16.5.7, & STANDARD SPECIFICATIONS §619 FOR ADDITONAL REQUIREMENTS AND CONSIDERATIONS.

ED A MINIMUM XXIMUM OF 400 FT. ISTREAM TAPER W20-1		
	REFER TO SHEET 2 OF 3	2 FOR ALL TABLES
K ES G20-1 (SEE NOTE 4)	NEW YORK STATE OF OPPORTUNITY.	Department of Transportation
	U.S. CUSTOMARY STA	NDARD SHEET
WORK AREA	WORK ZONE TRAF TWO-LANE TWO-W SHOULDER C INTERMEDIATE TEF (SHEET 1	AY ROADWAY Losure
(CAUTION MODE)	APPROVED DECEMBER 2, 2021	ISSUED UNDER EI 21-028
_	RobertLímoges ROBERT LIMOGES, P.E. DIRECTOR, OTSM	619-410

	DISTANCE BE	TWEEN SIGNS
ROAD TYPE	A (FT.)	B (FT.)
URBAN (≤ 30 MPH*)	100	100
URBAN (35-40 MPH+)	200	200
URBAN (≥45 MPH+)	350	350
RURAL	500	500

• PRECONSTRUCTION POSTED SPEED LIMIT

TABLE 410-02: LONGITUDINAL BUFFER SPACE AND TAPER LENGTHS							
PRECONSTRUCTION POSTED SPEED	LONGITUDINAL BUFFER SPACE		H:L (FT.)/ * OF CHANNELIZING DI		SHOULDER TAPER LENGTH: L/3 (FT.)/ * OF SKIP LINES/ * OF CHANNELIZING DEVICES		
LIMIT (MPH)	DISTANCE (FT.)/ * OF SKIP LINES	FOR LANE WIDTH IN FT. (LATERAL SHIFT OF TRAFFIC FLOW PATH)			FOR SHOULDER WIDTH		
		10 11		12	≤4 FT.	5 - 7 FT.	≥8 FT.
25	155/4	120/3/4	120/3/4	120/3/4	40/1/2	40/1/2	40/1/2
30	200/5	160/4/5	160/4/5	200/5/6	40/1/2	40/1/2	40/1/2
35	250/6	200/5/6	240/6/7	240/6/7	40/1/2	40/1/2	80/2/3
40	305/8	280/7/8	320/8/9	320/8/9	40/1/2	80/2/3	80/2/3
45	360/9	440/11/12	520/13/14	560/14/15	80/2/3	80/2/3	120/3/4
50	425/11	520/13/14	560/14/15	600/15/16	80/2/3	120/3/4	160/4/5
55	495/13	560/14/15	600/15/16	680/17/18	80/2/3	120/3/4	160/4/5

TABLE 410-03: PROTECTIVE VEHICLE REQUIREMENTS								
CLOSURE TYPE	ROAD TYPE & SPEED	NON-FREEWAY						
	RUAD TIFE & SFEED	≥ 45 MPH	35 - 40 MPH	≤ 30 MPH				
	EXPOSURE CONDITIONS <sup>1</sup>							
LANE CLOSURE OR	WORKERS ON FOOT OR VEHICLE EXPOSED TO TRAFFIC	P, TMIA	P, TMIA	SEE NOTE 2				
ENCROACHMENT	OTHER HAZARDS NO WORKERS EXPOSED	P, TMIA	SEE NOTE 2	SEE NOTE 2				
SHOULDER CLOSURE	WORKERS ON FOOT OR VEHICLE EXPOSED TO TRAFFIC	P, TMIA	SEE NOTE 2	SEE NOTE 2				
OR ENCROACHMENT	OTHER HAZARDS NO WORKERS EXPOSED	SEE NOTE 2	SEE NOTE 2	SEE NOTE 2				

#### LEGEND

P: PROTECTIVE VEHICLE REQUIRED FOR EACH CLOSED LANE & EACH CLOSED PAVED SHOULDER 8' OR WIDER, IF THE WORK SPACE MOVES WITHIN THE STATIONARY CLOSURE, THE PROTECTIVE VEHICLE SHALL BE REPOSITIONED ACCORDINGLY

TMIA: TMIA REQUIRED

NOTES: 1. THE EXPOSURE CONDITIONS ASSUMES THERE IS NO POSITIVE PROTECTION PRESENT

2. EITHER A PROTECTIVE VEHICLE OR THE STANDARD BUFFER SPACE SHALL BE PROVIDED

TABLE 410-04: ROLL AHEAD DISTANCE						
ROLL AHEAD DISTANCE (FT.)/* OF SKIP LINES FOR VEHICLES						
PRECONSTRUCTION	STATIONARY OPERATION					
POSTED SPEED LIMIT (MPH)	MIN	MAX				
≥ 55	120/3	200/5				
45 - 50	80/2	160/4				
≤ <b>4</b> 0	40/1	120/3				

TABLE 4	10-05: CH/	NNELIZ	ING DEVIC	E APPL	ICATIO	N FOR INTE	RMEDIATI	E-TERM	STATIONAR	Y WORK ZON	ES
WORK ZONE PROVISIONS	INC	CHANNELIZING DEVICE									
INTERMEDIATE-TERM STATIONARY WORK ZONES INVOLVE WORK THAT OCCUPIES A LOCATION FOR MORE THAN 1 DAYLIGHT PERIOD OR NIGHTTIME WORK THAT OCCUPIES A LOCATION FOR MORE THAN 1 HOUR	MAXIMUM DEVICE SPACING (CENTER TO CENTER)	DRUMS	STANDARD CONES	TALL CONES	EXTRA TALL CONES	temporary Tubular Markers	Interim Tubular Markers	VERTICAL PANELS	OVERSIZED VERTICAL PANELS	TYPE II BARRICADES	TYPE III BARRICADES
SHOULDER/MERGING/	20 FT. *	Х							х	х	
SHIFTING TAPERS	40 FT.	х							х	х	
MARKING FOR TRANSVERSE BUMPS'	N/A	x²	x		x²				x <sup>2</sup>		
TRANSVERSE DEVICE WITHIN CLOSED TRAFFIC LANE AND/OR SHOULDER	800 FT.	x		x	х			x	x	x	0
REMOVAL OF EXISTING GUIDE RAIL	80 FT. 40 FT.	x		x	x	х		x	x	x	0
NOTES: X= ALLOWED BLANK = NOT ALLOWED 0 = OPTIONAL 1 A TYPE 1 OBJECT MARKER MAY BE USED IN LIEU OF CHANNELIZING DEVICE. 2 CHANNELIZING DEVICES SHALL BE EQUIPPED WITH A FLASHING WARNING LIGHT. • SEE NOTE 5 ON SHEET 1 OF 2.											

TABLE 410-06: REQUIRED SIGN SIZES.					
SIGN	NON-FREEWAY	FREEWAY			
G20-2	36x18	48×24			
W20-1	36x36	48×48			
W21-5	36x36	48×48			
W7-3a	24×18	36x30			
G20-1	36×18	48x24			
WARNING FLAG	18×18	18×18			
•FREEWAY SIZES MAY BE USED ON NON-FREEWAY, IF SPACE CONSTRAINTS DO NOT EXIST.					

	Department of Transportation				
U.S. CUSTOMARY ST	ANDARD SHEET				
WORK ZONE TRAFFIC CONTROL TWO-LANE TWO-WAY ROADWAY SHOULDER CLOSURE INTERMEDIATE TERM OPERATION (SHEET 2 OF 2)					
APPROVED DECEMBER 2, 2021 RobertLimoges ROBERT LIMOGES, P.E. DIRECTOR, OTSM	ISSUED UNDER EI 21-028 619-410				