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**GENERAL NOTES**

1. THE CONTRACTOR SHALL VISIT THE PROJECT SITE PRIOR TO SUBMITTING A PROPOSAL TO FULLY UNDERSTAND THE EXISTING CONDITIONS AND SCOPE OF WORK.
2. VERIFY THAT FIELD MEASUREMENTS, SURFACES, SUBSTRATES AND CONDITIONS ARE AS REQUIRED, AND READY TO RECEIVE WORK.
3. THIS FACILITY IS ASSUMED TO BE CLEAR OF ASBESTOS AND LEAD PAINT. THE CONTRACTOR SHALL NOTIFY THE USPS IF ANY AREAS OF ASBESTOS AND LEAD PAINT ARE DISCOVERED THAT ARE NOT INDICATED IN THE ASBESTOS AND LEAD PAINT SURVEY PROVIDED BY THE USPS. THE CONTRACTOR SHALL REVIEW THE ASBESTOS AND LEAD PAINT SURVEY PROVIDED BY THE USPS.
4. REPORT IN WRITING TO CONTRACTING OFFICER, PREVAILING CONDITIONS THAT WILL AFFECT SATISFACTORY EXECUTION OF THE WORK. DO NOT PROCEED WITH WORK UNTIL UNSATISFACTORY CONDITIONS HAVE BEEN CORRECTED.
5. BY BEGINNING WORK, CONTRACTOR ACCEPTS EXISTING CONDITIONS AND ASSUMES RESPONSIBILITY FOR CORRECTING UNSUITABLE EXISTING CONDITIONS ENCOUNTERED AT NO ADDITIONAL COST TO THE USPS.
6. THE CONTRACTOR SHALL PHOTO DOCUMENT THE EXISTING CONDITIONS OF ALL WORK AREAS (INCLUDING STAGING AREAS) AND RESTORE TO EXISTING CONDITIONS AFTER COMPLETION OF THE WORK.
7. THE CONTRACTOR SHALL PROVIDE ALL LABOR AND MATERIALS NECESSARY TO DELIVER A COMPLETE PROJECT AS REASONABLY IMPLIED IN THESE DOCUMENTS.
8. THE CONTRACTOR SHALL FOLLOW ALL USPS STANDARDS, LOCAL CODES, REGULATIONS AND LAWS.
9. THE CONTRACTOR MAY USE WATER AND ELECTRICAL UTILITIES FROM THE EXISTING FACILITY DURING THE WORK PROVIDED THE USAGE DOES NOT INTERFERE WITH USPS OPERATIONS.
10. PRIOR TO BEGINNING ANY WORK, A PRE-CONSTRUCTION MEETING SHALL BE HELD ONSITE WITH THE CONTRACTOR, ARCHITECT, AND REPRESENTATIVES FROM THE USPS.
11. CURRENT AND ONGOING POSTAL OPERATIONS AT THIS FACILITY SHALL TAKE PRECEDENCE OVER CONSTRUCTION. CONTRACTOR SHALL SCHEDULE ALL WORK WITH THE USPS AND COORDINATE DAILY. ALL TRADES SHALL COOPERATE AND COORDINATE THEIR WORK TO ALLOW THE COMPLETION OF THE WORK WITH MINIMUM INTERFERENCE TO USPS OPERATIONS.
12. CONSTRUCTION STAGING AREA(S) SHALL BE COORDINATED WITH THE FACILITY. STAGING AREA(S) MUST BE KEPT CLEAN AND ORGANIZED, AND MUST NOT INTERFERE WITH POSTAL OPERATIONS.
13. WHERE EXISTING POSTAL EQUIPMENT REQUIRES TEMPORARY RELOCATION FOR THE CONTRACTOR TO GAIN ACCESS TO AN AREA OF WORK, THE CONTRACTOR SHALL COORDINATE WITH THE FACILITY POINT OF CONTACT AT LEAST 48 HOURS IN ADVANCE. POSTAL EQUIPMENT SHALL BE RELOCATED BY USPS PERSONNEL, UNLESS OTHERWISE NOTED.
14. WHERE UTILITIES / SYSTEMS SHUTDOWNS ARE ESSENTIAL TO THE WORK THE CONTRACTOR SHALL COORDINATE SUCH ACTIVITIES WITH THE FACILITY TO MINIMIZE DISRUPTION TO POSTAL OPERATIONS. THIS MAY REQUIRE PHASING WORK DURING NON-BUSINESS HOURS, WEEKENDS, AND/OR HOLIDAYS. EMERGENCY EXITS SHALL REMAIN ACCESSIBLE AT ALL TIMES THROUGHOUT CONSTRUCTION. CONTRACTOR SHALL PROVIDE AND MAINTAIN CLEARLY MARKED DIRECTION, INFORMATION AND WARNING SIGNS AS REQUIRED THROUGHOUT CONSTRUCTION.
15. PROVIDE BARRICADES, PARTITIONS, OR OTHER SEPARATIONS OF THE WORK IN PROGRESS AS REQUIRED TO PROTECT THE USPS AND PUBLIC THROUGHOUT CONSTRUCTION.
16. SPECIAL CARE SHALL BE TAKEN TO MAINTAIN REQUIRED USPS SECURITY. THE CONTRACTOR SHALL OBSERVE ALL USPS SECURITY REGULATIONS AT ALL TIMES.
17. THE CONTRACTOR SHALL COMPLY WITH ALL USPS SAFETY AND OSHA STANDARDS AT ALL TIMES.



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**GENERAL SCOPE OF WORK**

THIS IS A GENERAL LIST OF THE SCOPE OF WORK. REFER TO ENTIRE CONSTRUCTION DOCUMENTS FOR COMPLETE SCOPE.

1. PROVIDE AND INSTALL NEW ACCESS CONTROL SYSTEM.
2. PROVIDE AND INSTALL NEW CCTV SYSTEM FOR SECURITY AND CIS.
3. PROVIDE AND INSTALL NEW HARDWARE WHERE REQUIRED.
4. REPLACE EXISTING DOORS WHERE INDICATED.
5. INSTALL NEW TURNSTILES AND GATE WHERE INDICATED.
6. RECONFIGURE AND CONSTRUCT NEW EMPLOYEE ENTRANCE.
7. REPLACE EXISTING SLIDING GATE CONTROLLER WHERE INDICATED.
8. INSTALL NEW SWINGING GATES WHERE INDICATED.
9. REPLACE HVAC AIR HANDLER AND OTHER HVAC DEVICES.
10. INSTALL NEW LIGHTNING PROTECTION SYSTEM.

**PROJECT PHASING NOTES**

1. THE CONSTRUCTION PHASING OF THIS PROJECT IS OF THE UTMOST IMPORTANCE. ALL USPS SERVICE INTERRUPTION ESSENTIAL TO THE WORK SHALL BE SCHEDULED WITH THE PLANT MANAGER. ALL TRADES SHALL COOPERATE AND COORDINATE THEIR WORK TO ALLOW THE COMPLETION OF THE WORK WITH MINIMUM INTERFERENCE TO USPS OPERATIONS.
2. THE CONTRACTOR SHALL PROVIDE AND UPDATE AS NEEDED A PHASING SCHEDULE FOR THIS PROJECT. THIS SCHEDULE SHALL BE SUBJECT TO APPROVAL BY THE ARCHITECT AND THE USPS.
3. NO WORK CAN BE DONE DURING THE HOLIDAY MAILING SEASON BETWEEN NOVEMBER 15 AND JANUARY 5 WITHOUT WRITTEN PERMISSION FROM THE COR. REFER TO SPECIFICATION SECTION 013200 CONSTRUCTION PROGRESS DOCUMENTATION.

**ALTERNATE NOTE**

REFER TO SPECIFICATION SECTION 12300 "ALTERNATES" FOR INFORMATION ON ALTERNATE # 1. REFER TO SPECIFICATION SECTION 012300 1.5 SCHEDULE OF ALTERNATES AND STATE THE AMOUNT TO BE DEDUCTED FROM THE BASE PROPOSAL FOR DEDUCTIVE ALTERNATE #1 INCLUDING ALL MISCELLANEOUS DEVICES, ACCESSORY OBJECTS AND SIMILAR ITEMS INCIDENTAL TO OR REQUIRED FOR A COMPLETE INSTALLATION ACROSS ALL DISCIPLINES AND TRADES.

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AERIAL MAP  
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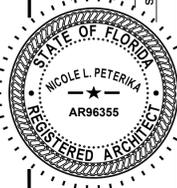
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Cover Sheet



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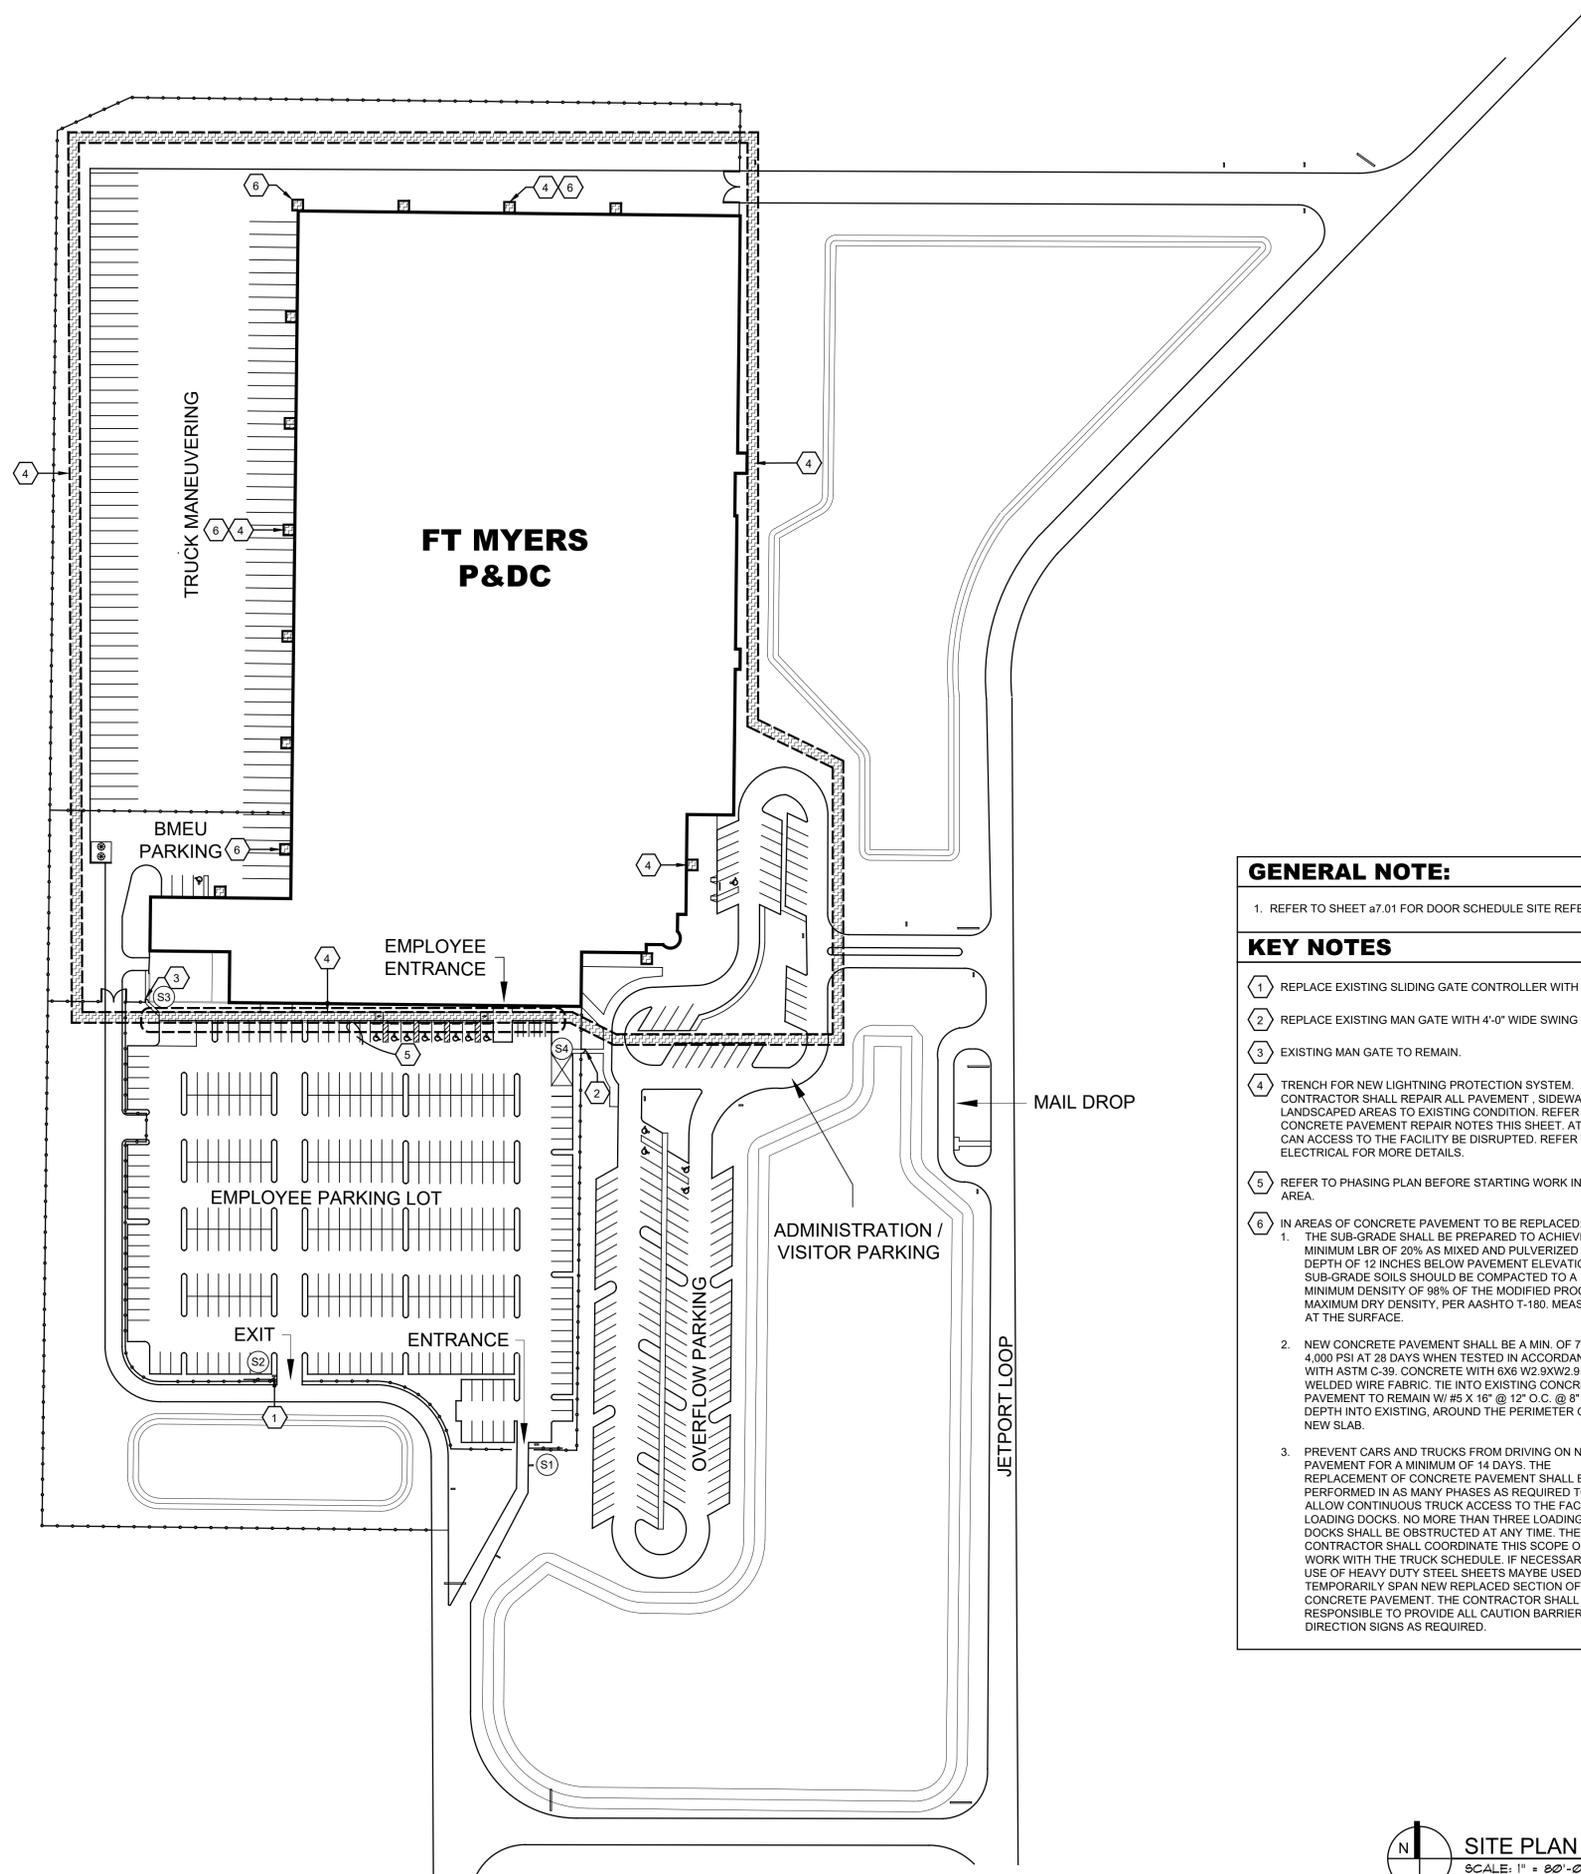
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**GENERAL NOTE:**  
 1. REFER TO SHEET a7.01 FOR DOOR SCHEDULE SITE REFERENCES.

**KEY NOTES**

1. REPLACE EXISTING SLIDING GATE CONTROLLER WITH NEW.
2. REPLACE EXISTING MAN GATE WITH 4'-0" WIDE SWING GATE.
3. EXISTING MAN GATE TO REMAIN.
4. TRENCH FOR NEW LIGHTNING PROTECTION SYSTEM. CONTRACTOR SHALL REPAIR ALL PAVEMENT, SIDEWALKS AND LANDSCAPED AREAS TO EXISTING CONDITION. REFER TO CONCRETE PAVEMENT REPAIR NOTES THIS SHEET. AT NO TIME CAN ACCESS TO THE FACILITY BE DISRUPTED. REFER TO ELECTRICAL FOR MORE DETAILS.
5. REFER TO PHASING PLAN BEFORE STARTING WORK IN THIS AREA.
6. IN AREAS OF CONCRETE PAVEMENT TO BE REPLACED:
  1. THE SUB-GRADE SHALL BE PREPARED TO ACHIEVE A MINIMUM LBR OF 20% AS MIXED AND PULVERIZED TO A DEPTH OF 12 INCHES BELOW PAVEMENT ELEVATION. THE SUB-GRADE SOILS SHOULD BE COMPACTED TO A MINIMUM DENSITY OF 98% OF THE MODIFIED PROCTOR MAXIMUM DRY DENSITY, PER AASHTO T-180. MEASURED AT THE SURFACE.
  2. NEW CONCRETE PAVEMENT SHALL BE A MIN. OF 7" THICK, 4,000 PSI AT 28 DAYS WHEN TESTED IN ACCORDANCE WITH ASTM C-39. CONCRETE WITH 6X6 W2.9XW2.9 WELDED WIRE FABRIC. TIE INTO EXISTING CONCRETE PAVEMENT TO REMAIN W/ #5 X 16" @ 12" O.C. @ 8" DRILL DEPTH INTO EXISTING, AROUND THE PERIMETER OF THE NEW SLAB.
  3. PREVENT CARS AND TRUCKS FROM DRIVING ON NEW PAVEMENT FOR A MINIMUM OF 14 DAYS. THE REPLACEMENT OF CONCRETE PAVEMENT SHALL BE PERFORMED IN AS MANY PHASES AS REQUIRED TO ALLOW CONTINUOUS TRUCK ACCESS TO THE FACILITY LOADING DOCKS. NO MORE THAN THREE LOADING DOCKS SHALL BE OBSTRUCTED AT ANY TIME. THE CONTRACTOR SHALL COORDINATE THIS SCOPE OF WORK WITH THE TRUCK SCHEDULE. IF NECESSARY THE USE OF HEAVY DUTY STEEL SHEETS MAYBE USED TO TEMPORARILY SPAN NEW REPLACED SECTION OF CONCRETE PAVEMENT. THE CONTRACTOR SHALL BE RESPONSIBLE TO PROVIDE ALL CAUTION BARRIERS AND DIRECTION SIGNS AS REQUIRED.



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	Site Plan	




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**LEGEND**

- 1 - HOUR SEPARATION WITH 45 MIN. DOOR.
- 2 - HOUR SEPARATION WITH 90 MIN. DOOR.
- 3 - HOUR SEPARATION WITH 180 MIN. DOOR.

**THIS SHEET FOR INFORMATION ONLY**

**EXISTING FLOOR PLAN**  
SCALE: 1/32" = 1'-0"

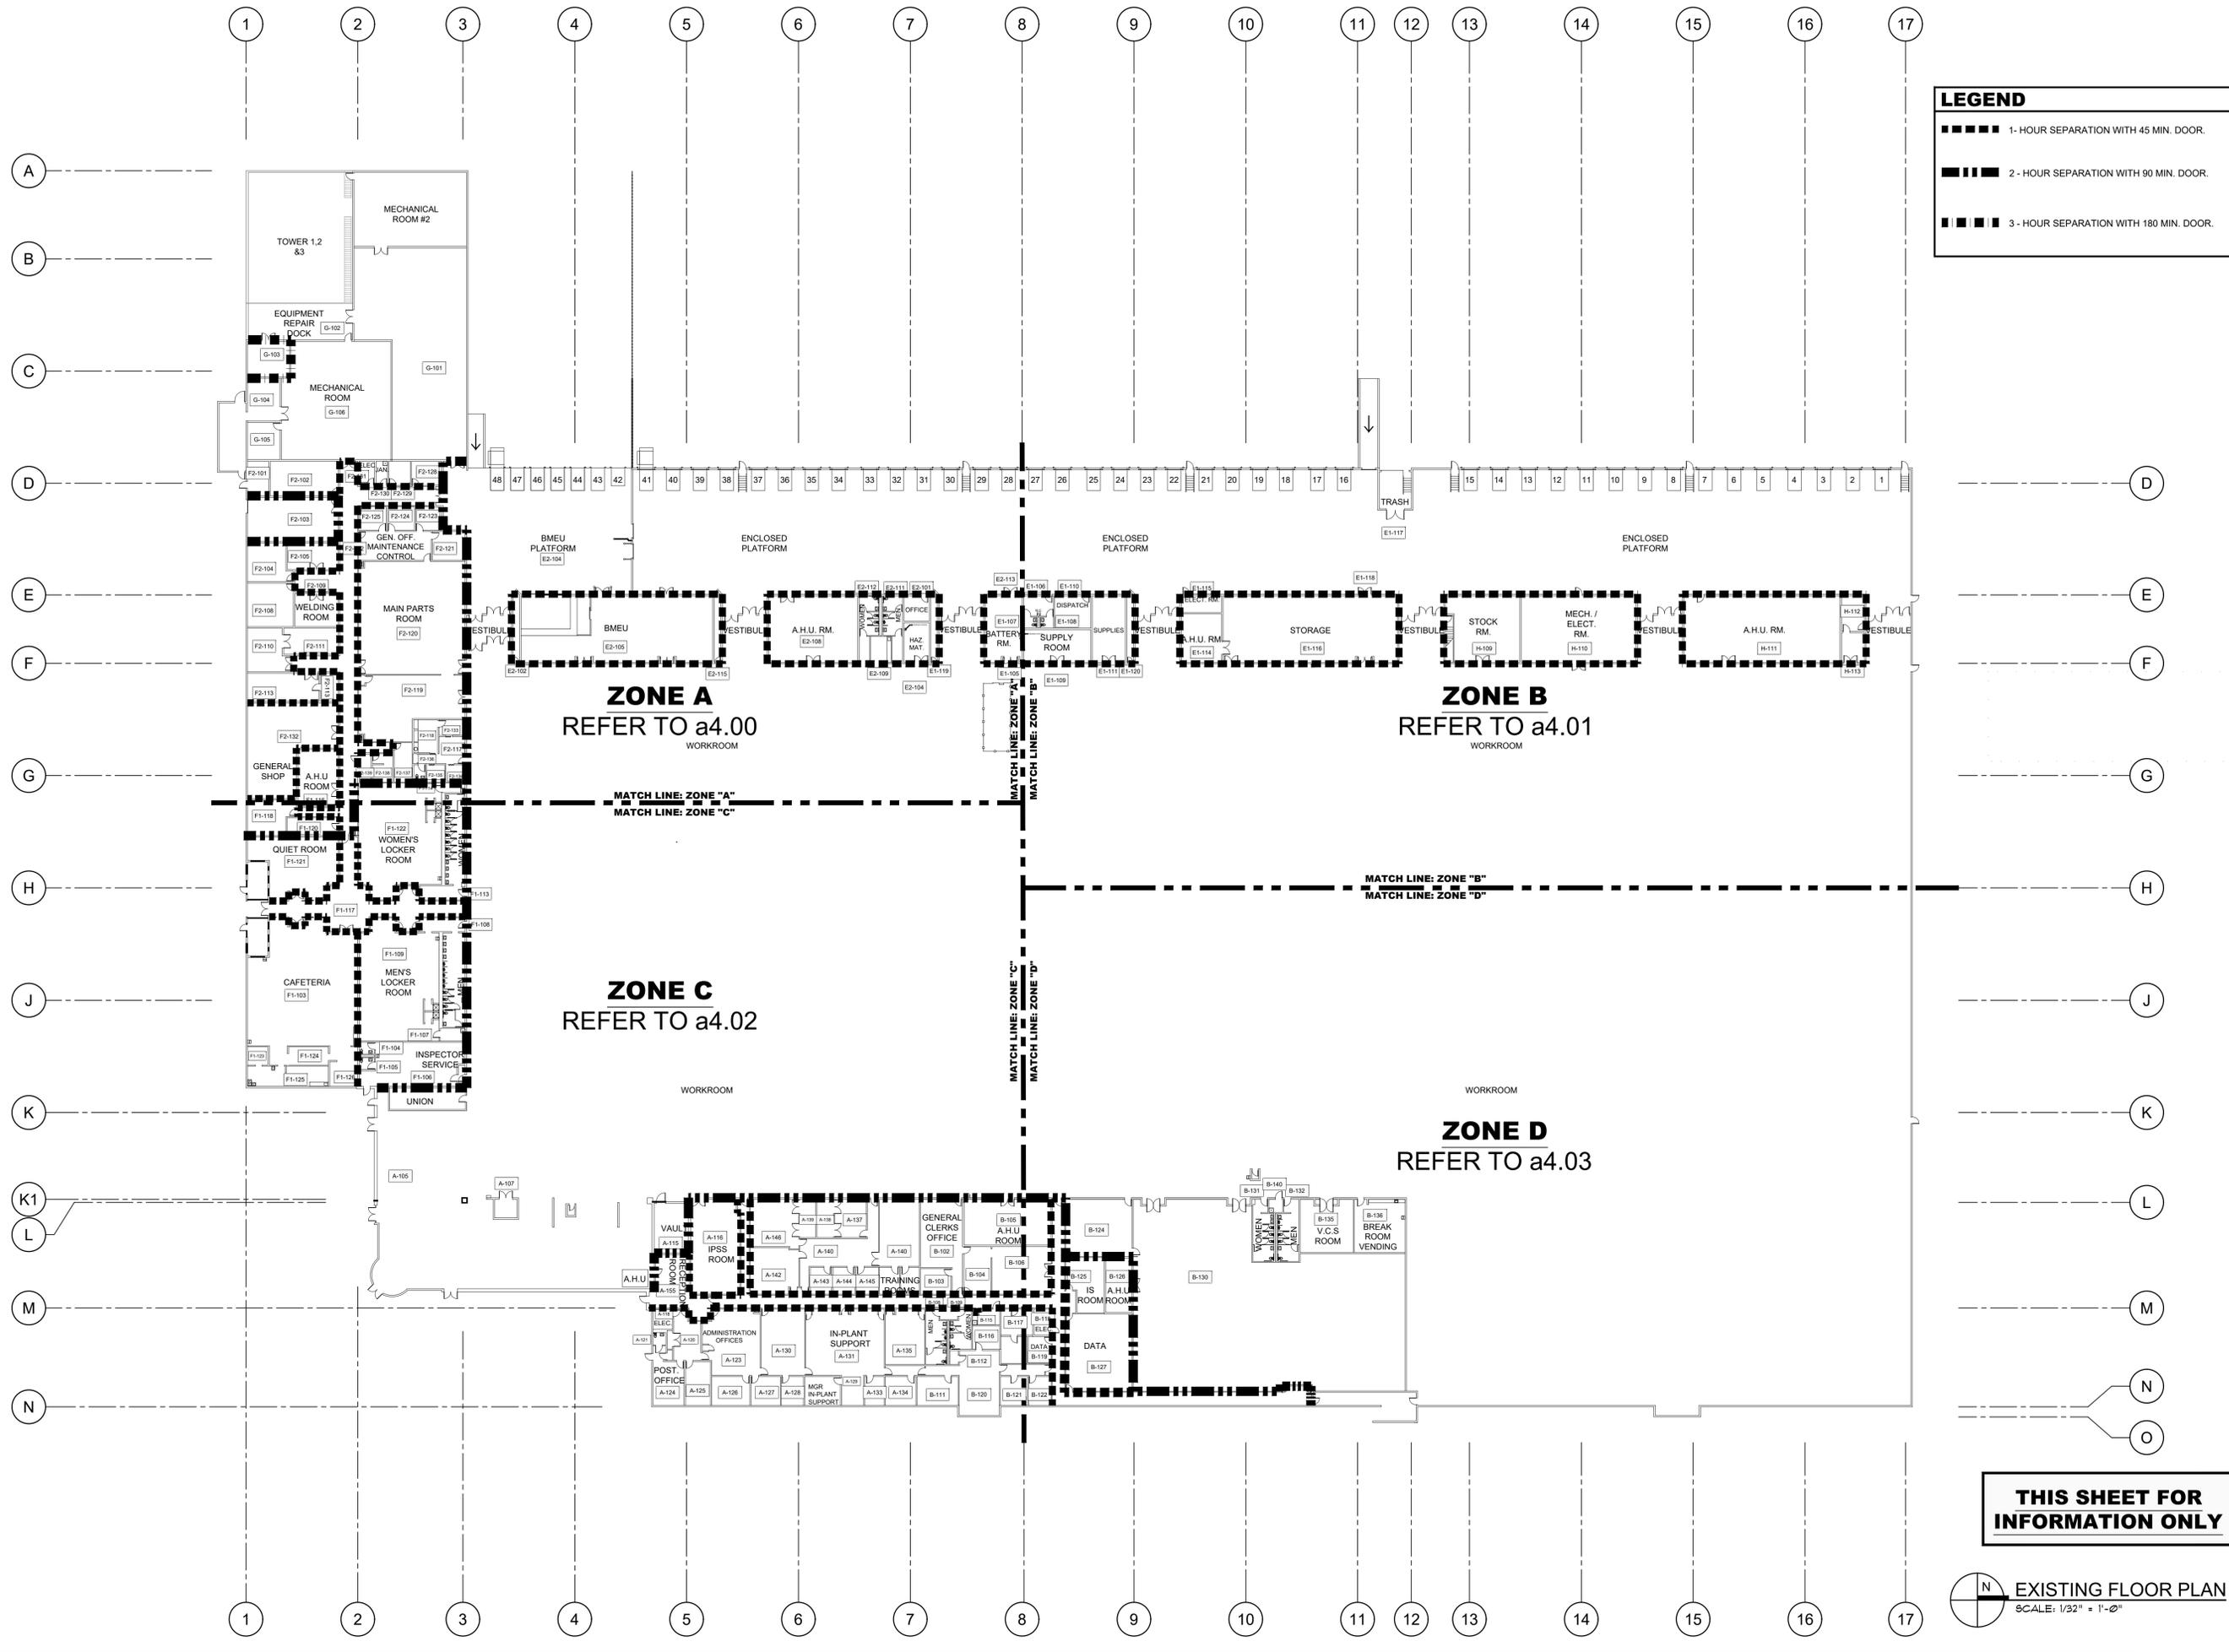
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sheet name	Overall Existing Floor Plan



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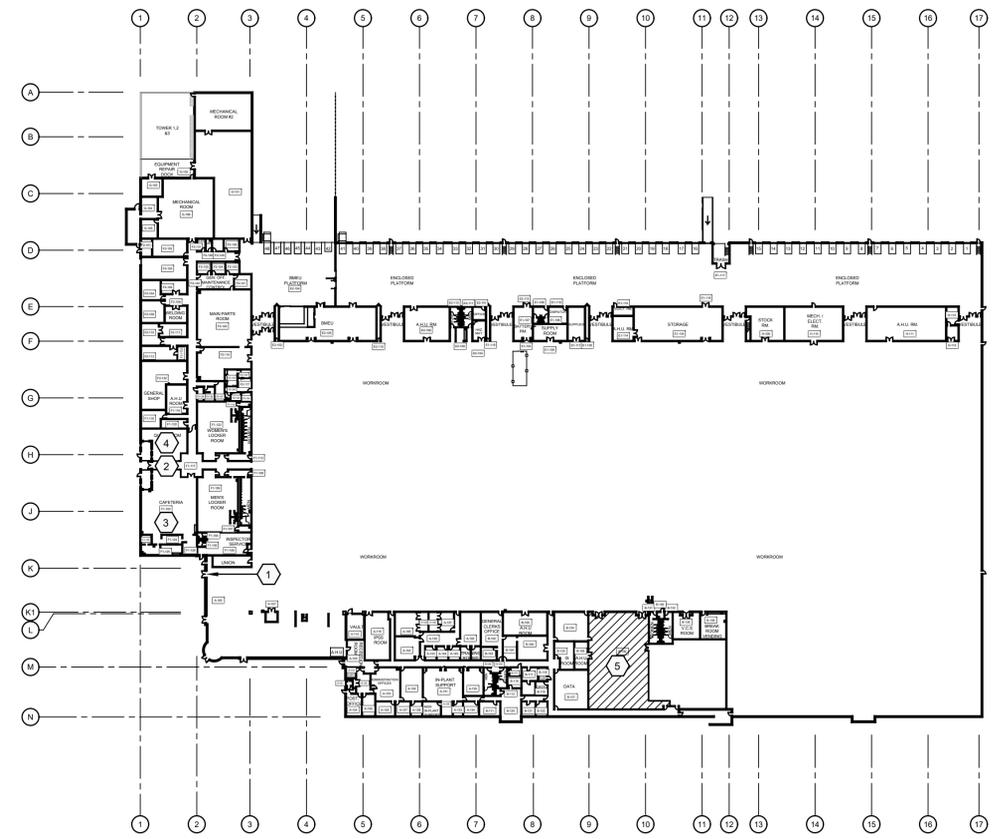
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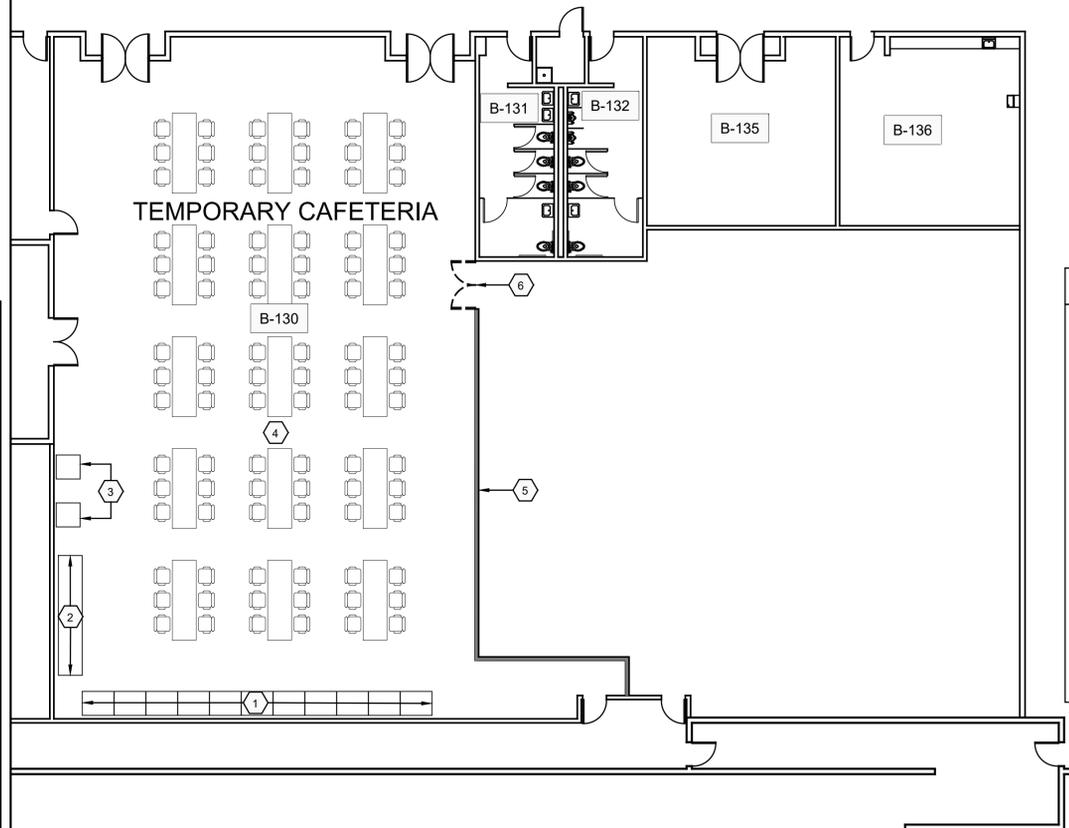
- KEY NOTES:**
- 1 CONSTRUCT TEMPORARY EMPLOYEE ENTRANCE AT EXISTING STOREFRONT DOORS.
  - 2 EMPLOYEE PATH OF TRAVEL.
  - 3 EXISTING MAN GATE.
  - 4 EXISTING EMPLOYEE ENTRANCE TO BE TEMPORARILY CLOSED DURING CONSTRUCTION OF NEW EMPLOYEE ENTRANCE.
  - 5 CONSTRUCTION OF NEW UNDERGROUND LIGHTNING PROTECTION SYSTEM AND ITS REPLACEMENT OF SIDEWALKS AND LANDSCAPE SHALL OCCUR IN CONJUNCTION WITH THE CONSTRUCTION OF THE NEW EMPLOYEE ENTRANCE.

1 PHASING PLAN  
SCALE: 1" = 50'-0"

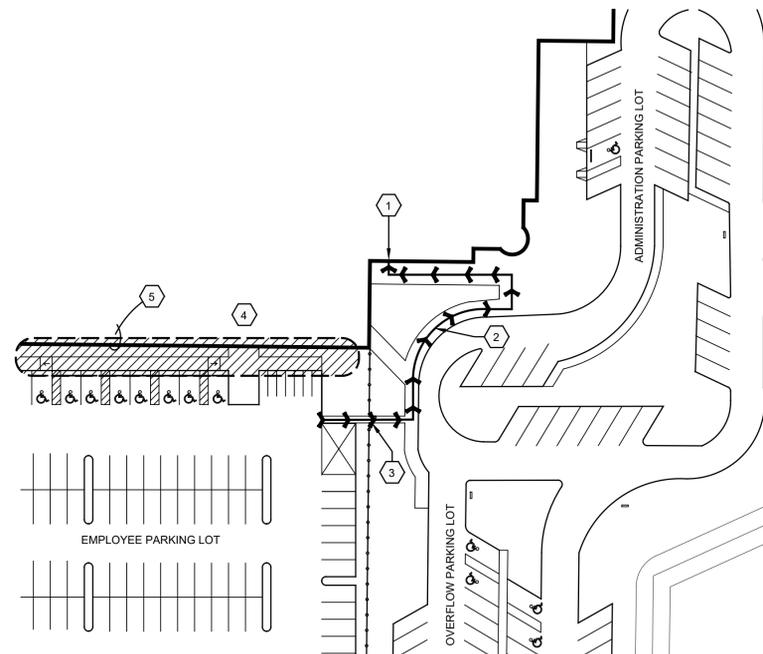


- KEY NOTES:**
- 1 TEMPORARY EMPLOYEE ENTRANCE.
  - 2 EXISTING EMPLOYEE ENTRANCE TO BE TEMPORARILY CLOSED DURING CONSTRUCTION OF NEW EMPLOYEE ENTRANCE.
  - 3 EXISTING EMPLOYEE LUNCHROOM TO BE TEMPORARILY CLOSED DURING CONSTRUCTION OF NEW EMPLOYEE ENTRANCE.
  - 4 EXISTING EMPLOYEE QUIET ROOM TO BE TEMPORARILY CLOSED DURING CONSTRUCTION OF NEW EMPLOYEE ENTRANCE.
  - 5 TEMPORARY EMPLOYEE LUNCHROOM.

2 PHASING PLAN  
SCALE: 1" = 10'-0"



- KEY NOTES:**
- 1 CONTRACTOR TO RELOCATE VENDING MACHINES AND PROVIDE HEAVY DUTY EXTENSION CORDS IF REQUIRED.
  - 2 CONTRACTOR TO PROVIDE POWER STRIPS AND TEMPORARY TABLE FOR RELOCATED MICROWAVES.
  - 3 CONTRACTOR TO PROVIDE TEMPORARY HAND WASHING STATIONS. THESE STATION SHALL INCLUDE A HAND SOAP DISPENSER, PAPER TOWEL DISPENSER, FRESH WATER AND GREY WATER TANKS WITH A CAPACITY OF AT LEAST 250 WASHINGS. BASIS OF DESIGN: "POLYJOHN" PSW1-1000 PORTABLE HAND WASHING SINK OR EQUAL.
  - 4 CONTRACTOR TO PROVIDE TEMPORARY TABLES AND CHAIRS FOR (84) EIGHTY-FOUR PEOPLE.
  - 5 CONTRACTOR TO CONSTRUCT TEMPORARY PARTITION FROM FLOOR TO CEILING.
  - 6 CONTRACTOR TO CONSTRUCT TEMPORARY LOCKABLE 6/0 x 7/0 DOOR.

3 PHASING PLAN  
SCALE: 3/32" = 1'-0"

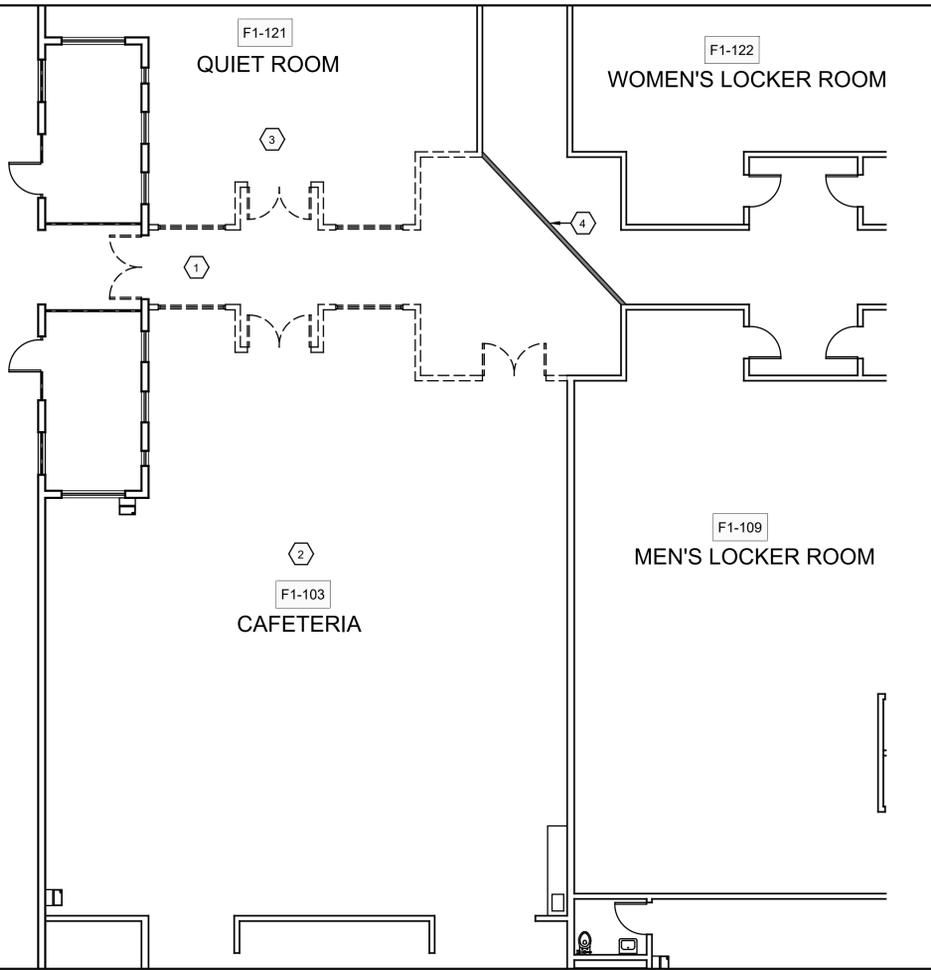


- KEY NOTES:**
- 1 EXISTING EMPLOYEE ENTRANCE TO BE TEMPORARILY CLOSED DURING CONSTRUCTION OF NEW EMPLOYEE ENTRANCE.
  - 2 EXISTING EMPLOYEE LUNCHROOM TO BE TEMPORARILY CLOSED DURING CONSTRUCTION OF NEW EMPLOYEE ENTRANCE.
  - 3 EXISTING EMPLOYEE QUIET ROOM TO BE TEMPORARILY CLOSED DURING CONSTRUCTION OF NEW EMPLOYEE ENTRANCE.
  - 4 CONTRACTOR TO CONSTRUCT TEMPORARY DUST BARRIER FROM FLOOR TO CEILING.

4 PHASING PLAN  
SCALE: 1/8" = 1'-0"

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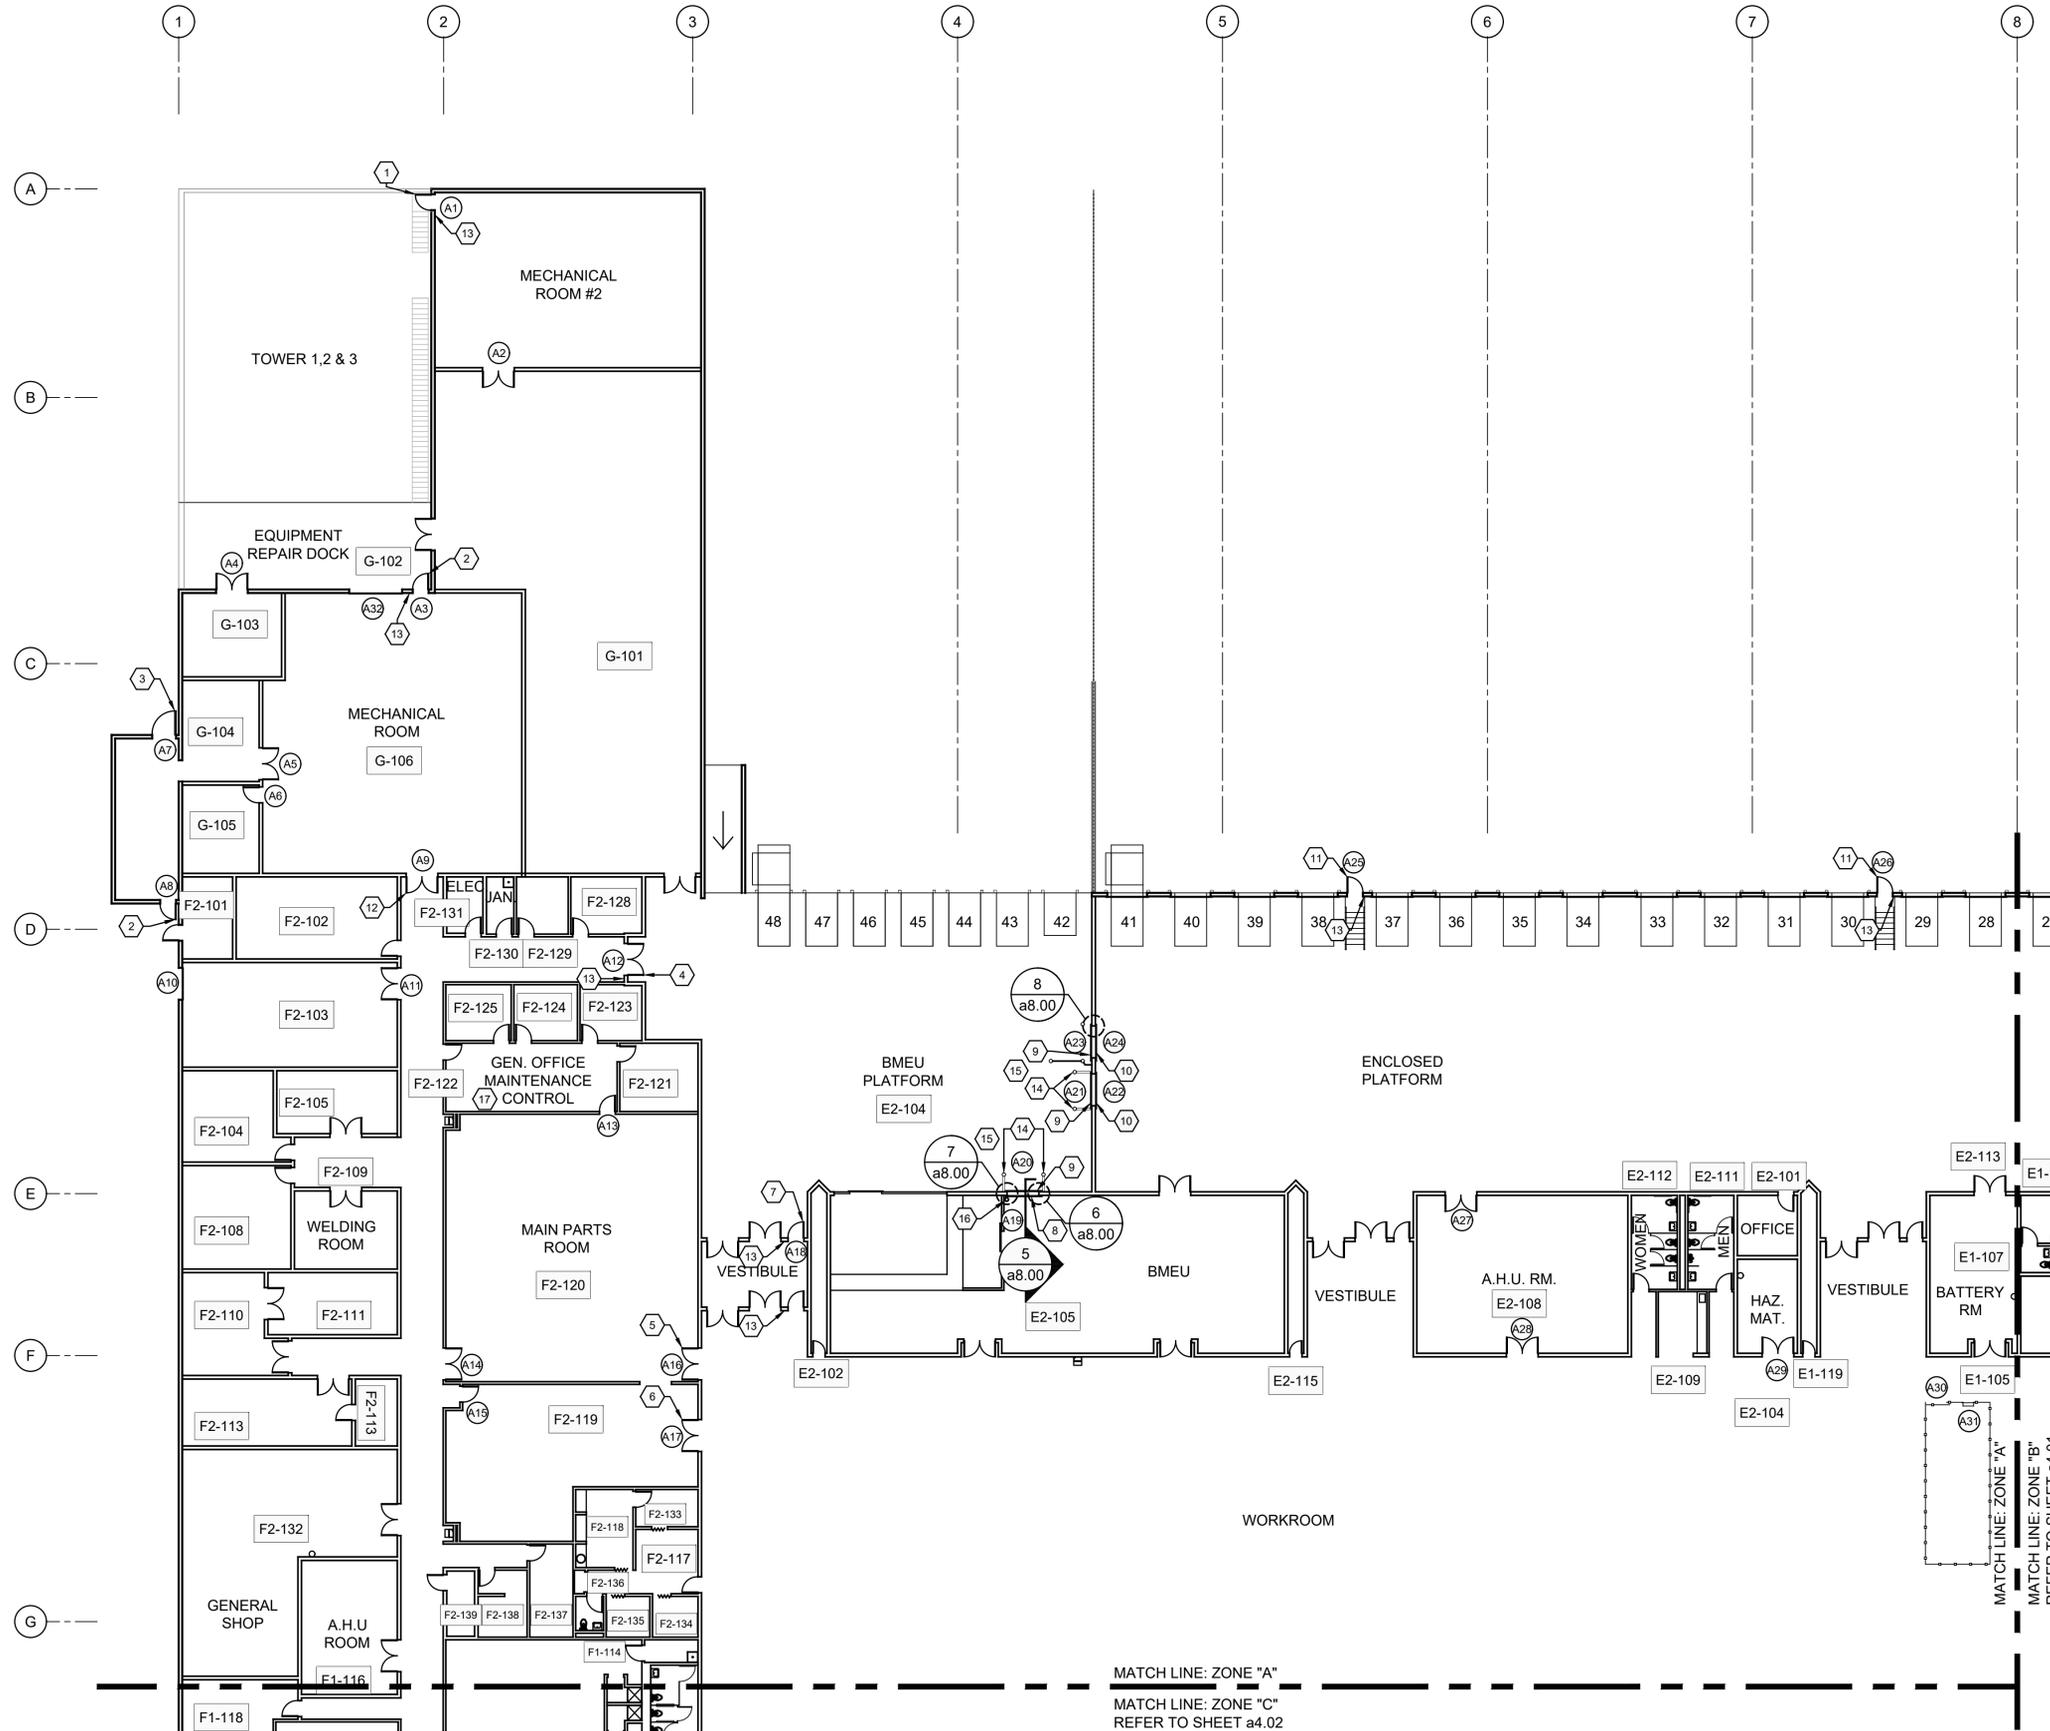
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MATCH LINE: ZONE "A"  
 MATCH LINE: ZONE "C"  
 REFER TO SHEET a4.02

**DOOR NOTES:**

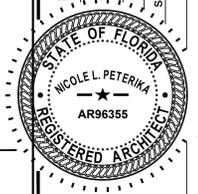- REFER TO DOOR SCHEDULE AND HARDWARE SPECIFICATION FOR COMPLETE DOOR HARDWARE REQUIREMENTS.
- CONTRACTOR SHALL VERIFY THAT NEW DOOR HARDWARE FIT EXISTING DOOR CONFIGURATION. CONTRACTOR SHALL BE RESPONSIBLE TO PATCH AND PAINT EXISTING DOOR LEAFS WHERE EXISTING MOUNTING HOLES ARE NOT COVERED BY NEW HARDWARE.
- CONTRACTOR SHALL FIELD VERIFY DOOR OPENING SIZE BEFORE ORDERING. CONTRACTOR IS RESPONSIBLE TO INSURE THAT ALL NEW DOORS FIT WITHIN SPECIFIED TOLERANCES.

**KEY NOTES:**

- NEW 18 GAGE 3'-0" x 8'-0" HOLLOW METAL DOOR LEAF. NEW LOCKSET, MORTISE TYPE, EXTERIOR KEY W/FREE EXIT. PAINT NEW DOOR LEAF & EXISTING FRAME TO MATCH EXISTING.
- NEW 18 GAGE 3'-0" x 8'-0" HOLLOW METAL DOOR LEAF W/ STEEL LOVER AND INSECT SCREEN. NEW LOCKSET, MORTISE TYPE, EXTERIOR KEY W/FREE EXIT. PAINT NEW DOOR LEAF & EXISTING FRAME TO MATCH EXISTING.
- NEW 18 GAGE 4'-0" x 8'-0" HOLLOW METAL DOOR LEAF W/ STEEL LOVER AND INSECT SCREEN. NEW LOCKSET, MORTISE TYPE, EXTERIOR KEY W/FREE EXIT. PAINT NEW DOOR LEAF & EXISTING FRAME TO MATCH EXISTING.
- TWO NEW 18 GAGE 3'-0" x 7'-0" HOLLOW METAL DOOR LEAF W/ A 1/4" WIRE GLASS WINDOW. NEW PUSH BAR W/ CONTACTS WITH EXTERIOR LEVER, MORTISE TYPE, EXTERIOR KEY W/FREE EXIT. PAINT NEW DOOR LEAVES & EXISTING FRAME TO MATCH EXISTING. NEW VINYL EMERGENCY SIGN.
- TWO NEW 18 GAGE 3'-0" x 7'-0" HOLLOW METAL DOOR LEAF W/ A 1/4" WIRE GLASS WINDOW. NEW LOCKSET, MORTISE TYPE, EXTERIOR KEY W/FREE EXIT ON ACTIVE LEAF. PAINT NEW DOOR LEAVES & EXISTING FRAME TO MATCH EXISTING.
- TWO NEW 18 GAGE 3'-0" x 8'-0" HOLLOW METAL DOOR LEAF. NEW LOCKSET, MORTISE TYPE, EXTERIOR KEY W/FREE EXIT ON ACTIVE LEAF. PAINT NEW DOOR LEAVES & EXISTING FRAME TO MATCH EXISTING.
- NEW 18 GAGE 3'-0" x 7'-0" HOLLOW METAL DOOR LEAF W/ A 1/4" WIRE GLASS WINDOW. NEW PUSH BAR W/ CONTACTS WITH EXTERIOR LEVER, MORTISE TYPE, EXTERIOR KEY W/FREE EXIT. PAINT NEW DOOR LEAF & EXISTING FRAME TO MATCH EXISTING. NEW VINYL EMERGENCY SIGN.
- NEW HIGH SPEED ROLL UP DOOR. BASIS OF DESIGN RYTEC PREDADOOR NXT. (SEE SPECIFICATIONS). EXISTING DOOR OPENING IS 6'-4" X 8'-2". REFER TO DETAILS.
- NEW ROLL UP COILING DOOR. BASIS OF DESIGN OVERHEAD DOOR 620 SERIES (SEE SPECIFICATIONS). EXISTING OPENING IS 6'-4" X 8'-2". REFER TO DETAILS.
- EXISTING HIGH SPEED DOOR TO REMAIN AS IS.
- NEW 18 GAGE 3'-4" x 8'-0" HOLLOW METAL DOOR LEAF W/ A 1/4" WIRE GLASS WINDOW. CUT-IN NEW STRIKE INTO EXISTING DOOR FRAME. NEW PUSH BAR W/ CONTACTS WITH EXTERIOR LEVER, MORTISE TYPE, EXTERIOR KEY W/FREE EXIT. PAINT NEW DOOR LEAF & EXISTING FRAME TO MATCH EXISTING. NEW VINYL EMERGENCY SIGN.
- TWO NEW 18 GAGE 3'-0" x 7'-0" HOLLOW METAL DOOR LEAF. NEW LOCKSET, MORTISE TYPE, EXTERIOR KEY W/FREE EXIT ON ACTIVE LEAF. PAINT NEW DOOR LEAVES & EXISTING FRAME TO MATCH EXISTING.
- PROVIDE AND INSTALL NEW TACTILE EGRESS SIGN. REFER TO DOOR SCHEDULE FOR OTHER TACTILE EGRESS SIGN LOCATIONS. REFER TO DETAIL ON SHEET a7.00 AND TO SPECIFICATION 101414.
- DEMOLISH HORIZONTAL RAIL FROM BOLLARD TO WALL. GRIND BOLLARD SMOOTH AND PAINT SAFETY YELLOW TO MATCH EXISTING. TYPICAL FOR FOUR BOLLARDS.
- MODIFY EXISTING WOOD BUMPERS TO ACCEPT NEW ROLL-UP AND HIGH SPEED DOORS.
- NEW BOLT DOWN 6" BOLLARD. TYPICAL OF ONE (1) BOLLARD.
- NEW KEY STORAGE CABINET. COORDINATE MOUNTING LOCATION WITH FACILITY. BASIS OF DESIGN: MEDECO T21 KEY MANAGEMENT SYSTEM, TRAKA 21. TRAKA USA, 448 COMMERCE WAY, SUITE 100, LONGWOOD, FL, 32750. (1) 407-681-4001.

MATCH LINE: ZONE "A"  
 MATCH LINE: ZONE "B"  
 REFER TO SHEET a4.01

**ENLARGED FLOOR PLAN 'ZONE A'**  
 SCALE: 1/16" = 1'-0"

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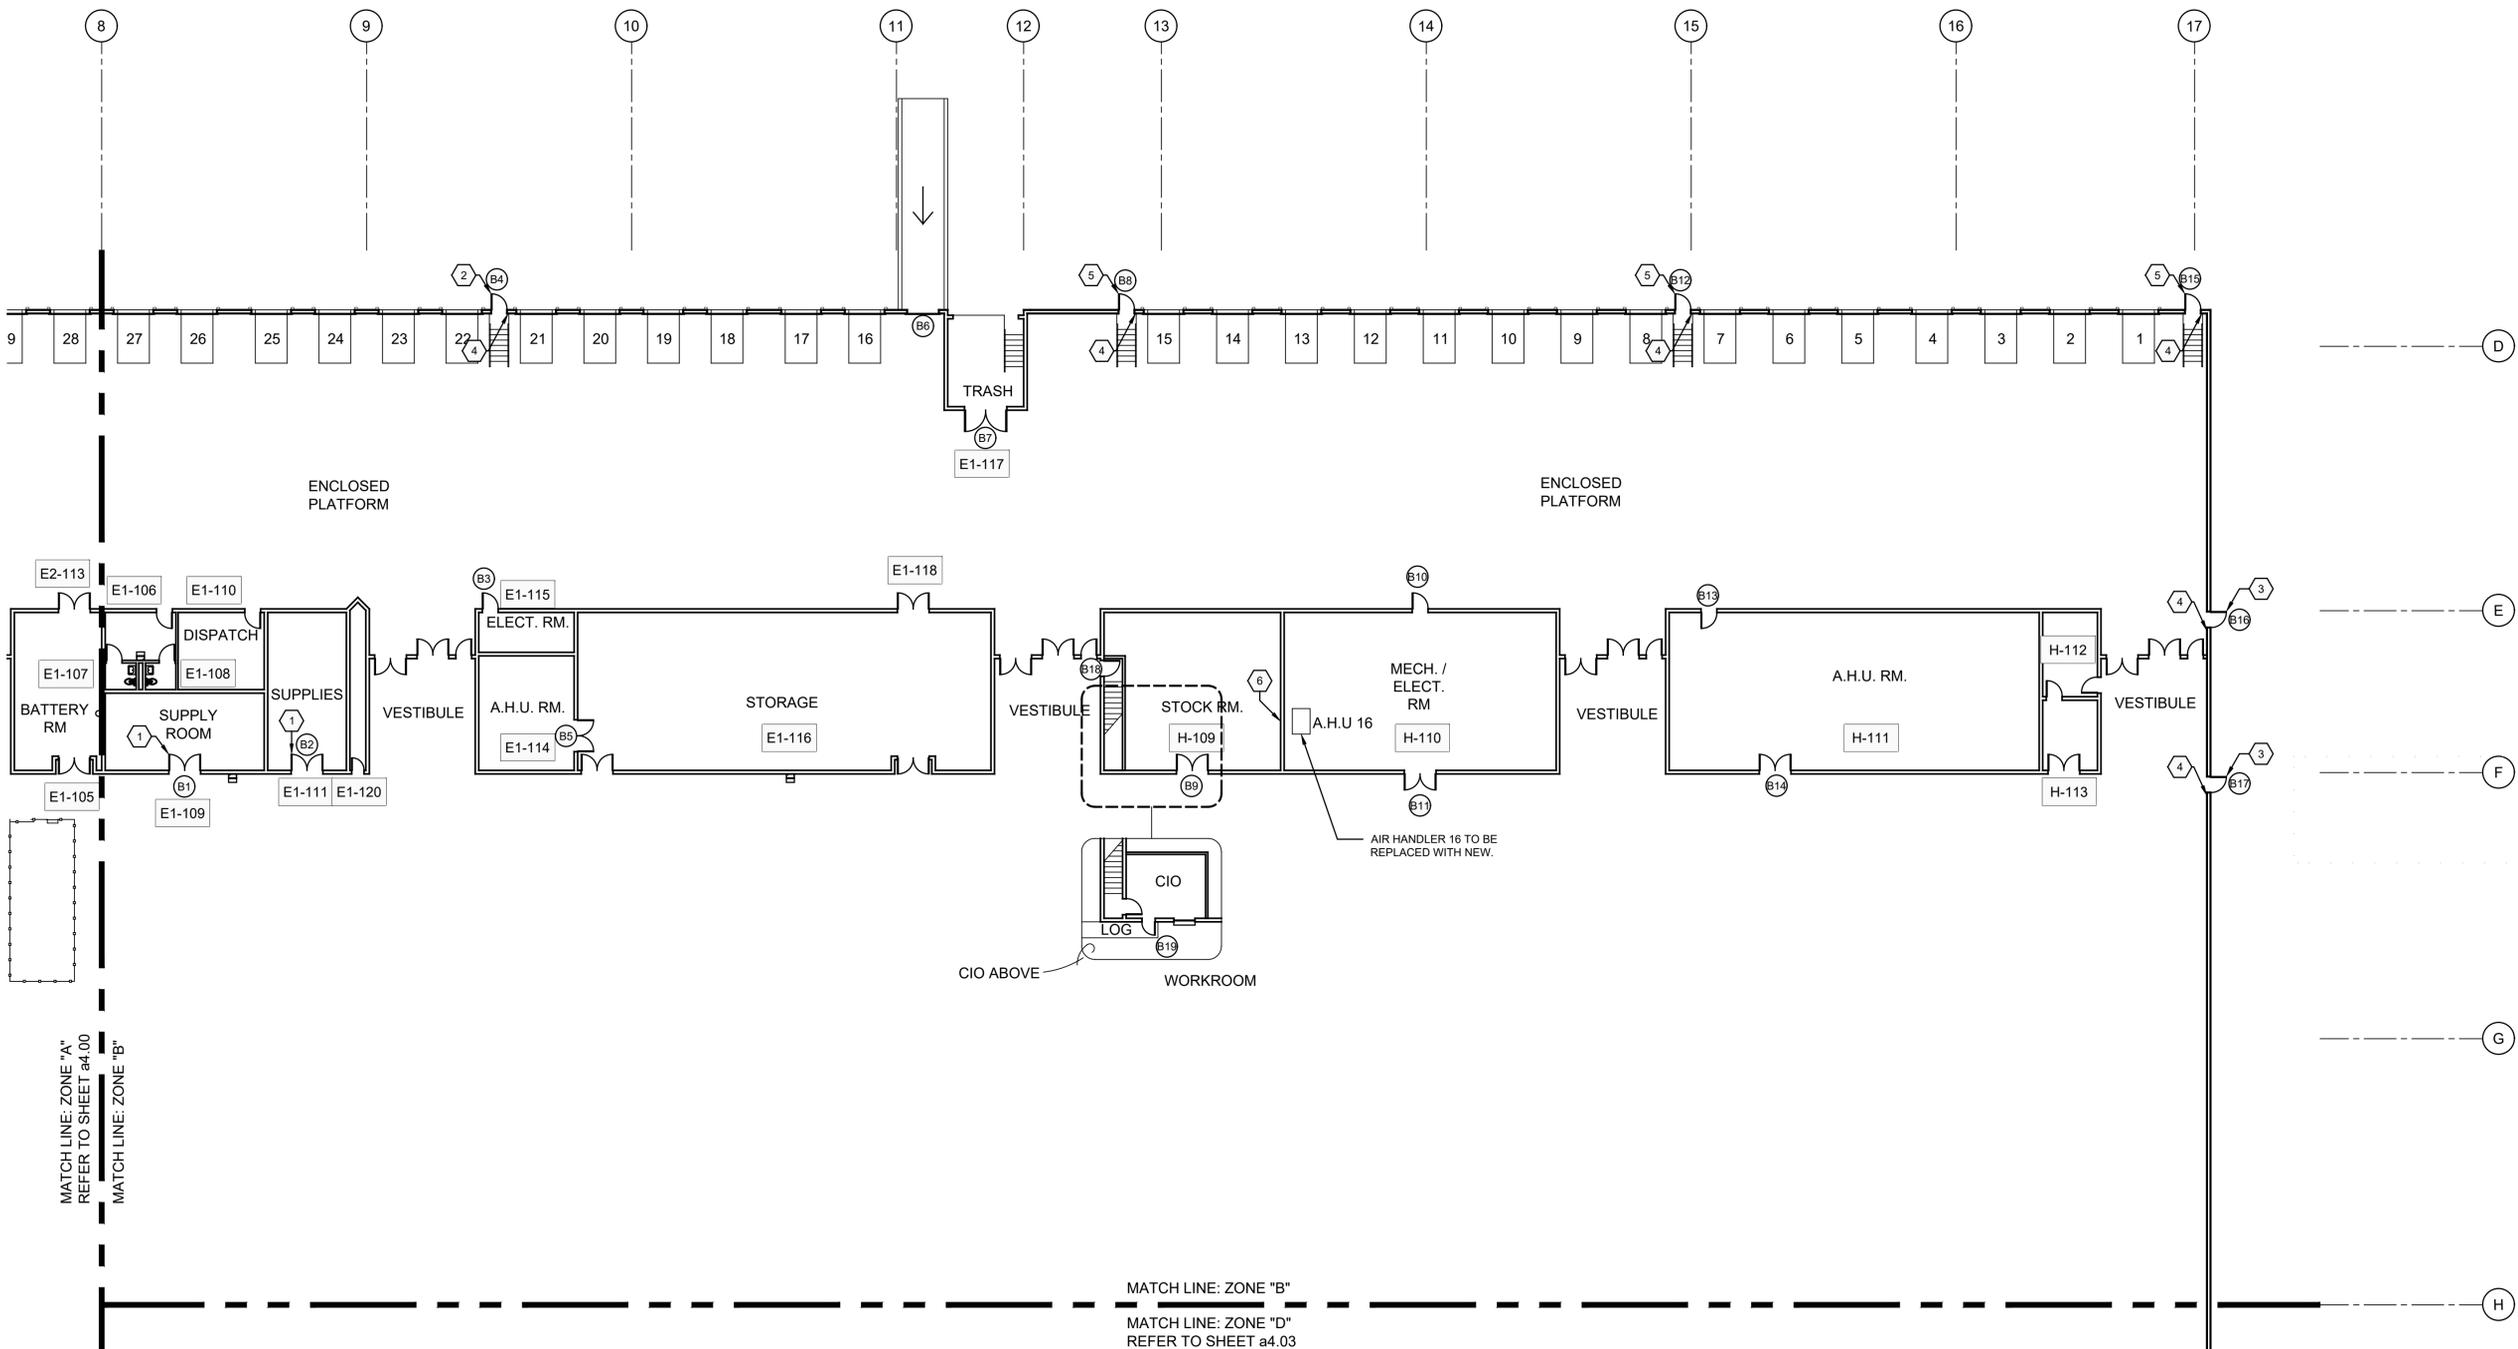
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 REFER TO SHEET a4.00  
 MATCH LINE: ZONE "B"

MATCH LINE: ZONE "B"  
 MATCH LINE: ZONE "D"  
 REFER TO SHEET a4.03

**DOOR HARDWARE NOTE:**

- REFER TO DOOR SCHEDULE AND HARDWARE SPECIFICATION FOR COMPLETE DOOR HARDWARE REQUIREMENTS.
- CONTRACTOR SHALL VERIFY THAT NEW DOOR HARDWARE FIT EXISTING DOOR CONFIGURATION. CONTRACTOR SHALL BE RESPONSIBLE TO PATCH AND PAINT EXISTING DOOR LEAFS WHERE EXISTING MOUNTING HOLES ARE NOT COVERED BY NEW HARDWARE.
- CONTRACTOR SHALL FIELD VERIFY DOOR OPENING SIZE BEFORE ORDERING. CONTRACTOR IS RESPONSIBLE TO INSURE THAT ALL NEW DOORS FIT WITHIN SPECIFIED TOLERANCES.

**KEY NOTES:**

- TWO NEW 18 GAGE 3'-0" x 8'-0" HOLLOW METAL DOOR LEAF, NEW LOCKSET, MORTISE TYPE, EXTERIOR KEY W/FREE EXIT ON ACTIVE LEAF. PAINT NEW DOOR LEAVES & EXISTING FRAME TO MATCH EXISTING.
- NEW 18 GAGE 3'-0" x 8'-0" HOLLOW METAL DOOR LEAF W/ A 1/4" WIRE GLASS WINDOW. CUT-IN NEW STRIKE INTO EXISTING DOOR FRAME. NEW PUSH BAR W/ CONTACTS WITH EXTERIOR LEVER, MORTISE TYPE, EXTERIOR KEY W/FREE EXIT. PAINT NEW DOOR LEAF & EXISTING FRAME TO MATCH EXISTING. NEW VINYL EMERGENCY SIGN.
- EXISTING DOOR TO REMAIN. EMERGENCY EXIT ONLY, NEW PUSHBAR W/ STARWHEEL. NEW VINYL EMERGENCY SIGN.
- PROVIDE AND INSTALL NEW TACTILE EGRESS SIGN. REFER TO DOOR SCHEDULE FOR OTHER TACTILE EGRESS SIGN LOCATIONS. REFER TO DETAIL ON SHEET a7.00 AND TO SPECIFICATION 101414.
- NEW 18 GAGE 3'-0" x 7'-0" HOLLOW METAL DOOR LEAF W/ A 1/4" WIRE GLASS WINDOW. CUT-IN NEW STRIKE INTO EXISTING DOOR FRAME. NEW PUSH BAR W/ CONTACTS WITH EXTERIOR LEVER, MORTISE TYPE, EXTERIOR KEY W/FREE EXIT. PAINT NEW DOOR LEAF & EXISTING FRAME TO MATCH EXISTING. NEW VINYL EMERGENCY SIGN.
- FILL IN OPENINGS LEFT FROM RELOCATED DUCTWORK IN CONCRETE BLOCK WALL. RESTORE FIRE RATING. PAINT REPAIRS TO MATCH EXISTING.

**ENLARGED FLOOR PLAN 'ZONE B'**  
 SCALE: 1/16" = 1'-0"

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revisions

project | phase

19013

issue date

2022.03.03

sheet name

"Zone B"



**FT MYERS P&DC**  
**SECURITY UPGRADES**

14080 JETPORT LOOP  
 FT MYERS, FL. 33913


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MATCH LINE: ZONE "A"  
 REFER TO SHEET a4.00  
 MATCH LINE: ZONE "C"

MATCH LINE: ZONE "C"  
 MATCH LINE: ZONE "D"  
 REFER TO SHEET a4.03

**DOOR HARDWARE NOTE:**


1. REFER TO DOOR SCHEDULE AND HARDWARE SPECIFICATION FOR COMPLETE DOOR HARDWARE REQUIREMENTS.
2. CONTRACTOR SHALL VERIFY THAT NEW DOOR HARDWARE FIT EXISTING DOOR CONFIGURATION. CONTRACTOR SHALL BE RESPONSIBLE TO PATCH AND PAINT EXISTING DOOR LEAFS WHERE EXISTING MOUNTING HOLES ARE NOT COVERED BY NEW HARDWARE.
3. CONTRACTOR SHALL FIELD VERIFY DOOR OPENING SIZE BEFORE ORDERING. CONTRACTOR IS RESPONSIBLE TO INSURE THAT ALL NEW DOORS FIT WITHIN SPECIFIED TOLERANCES.

**KEY NOTES:**

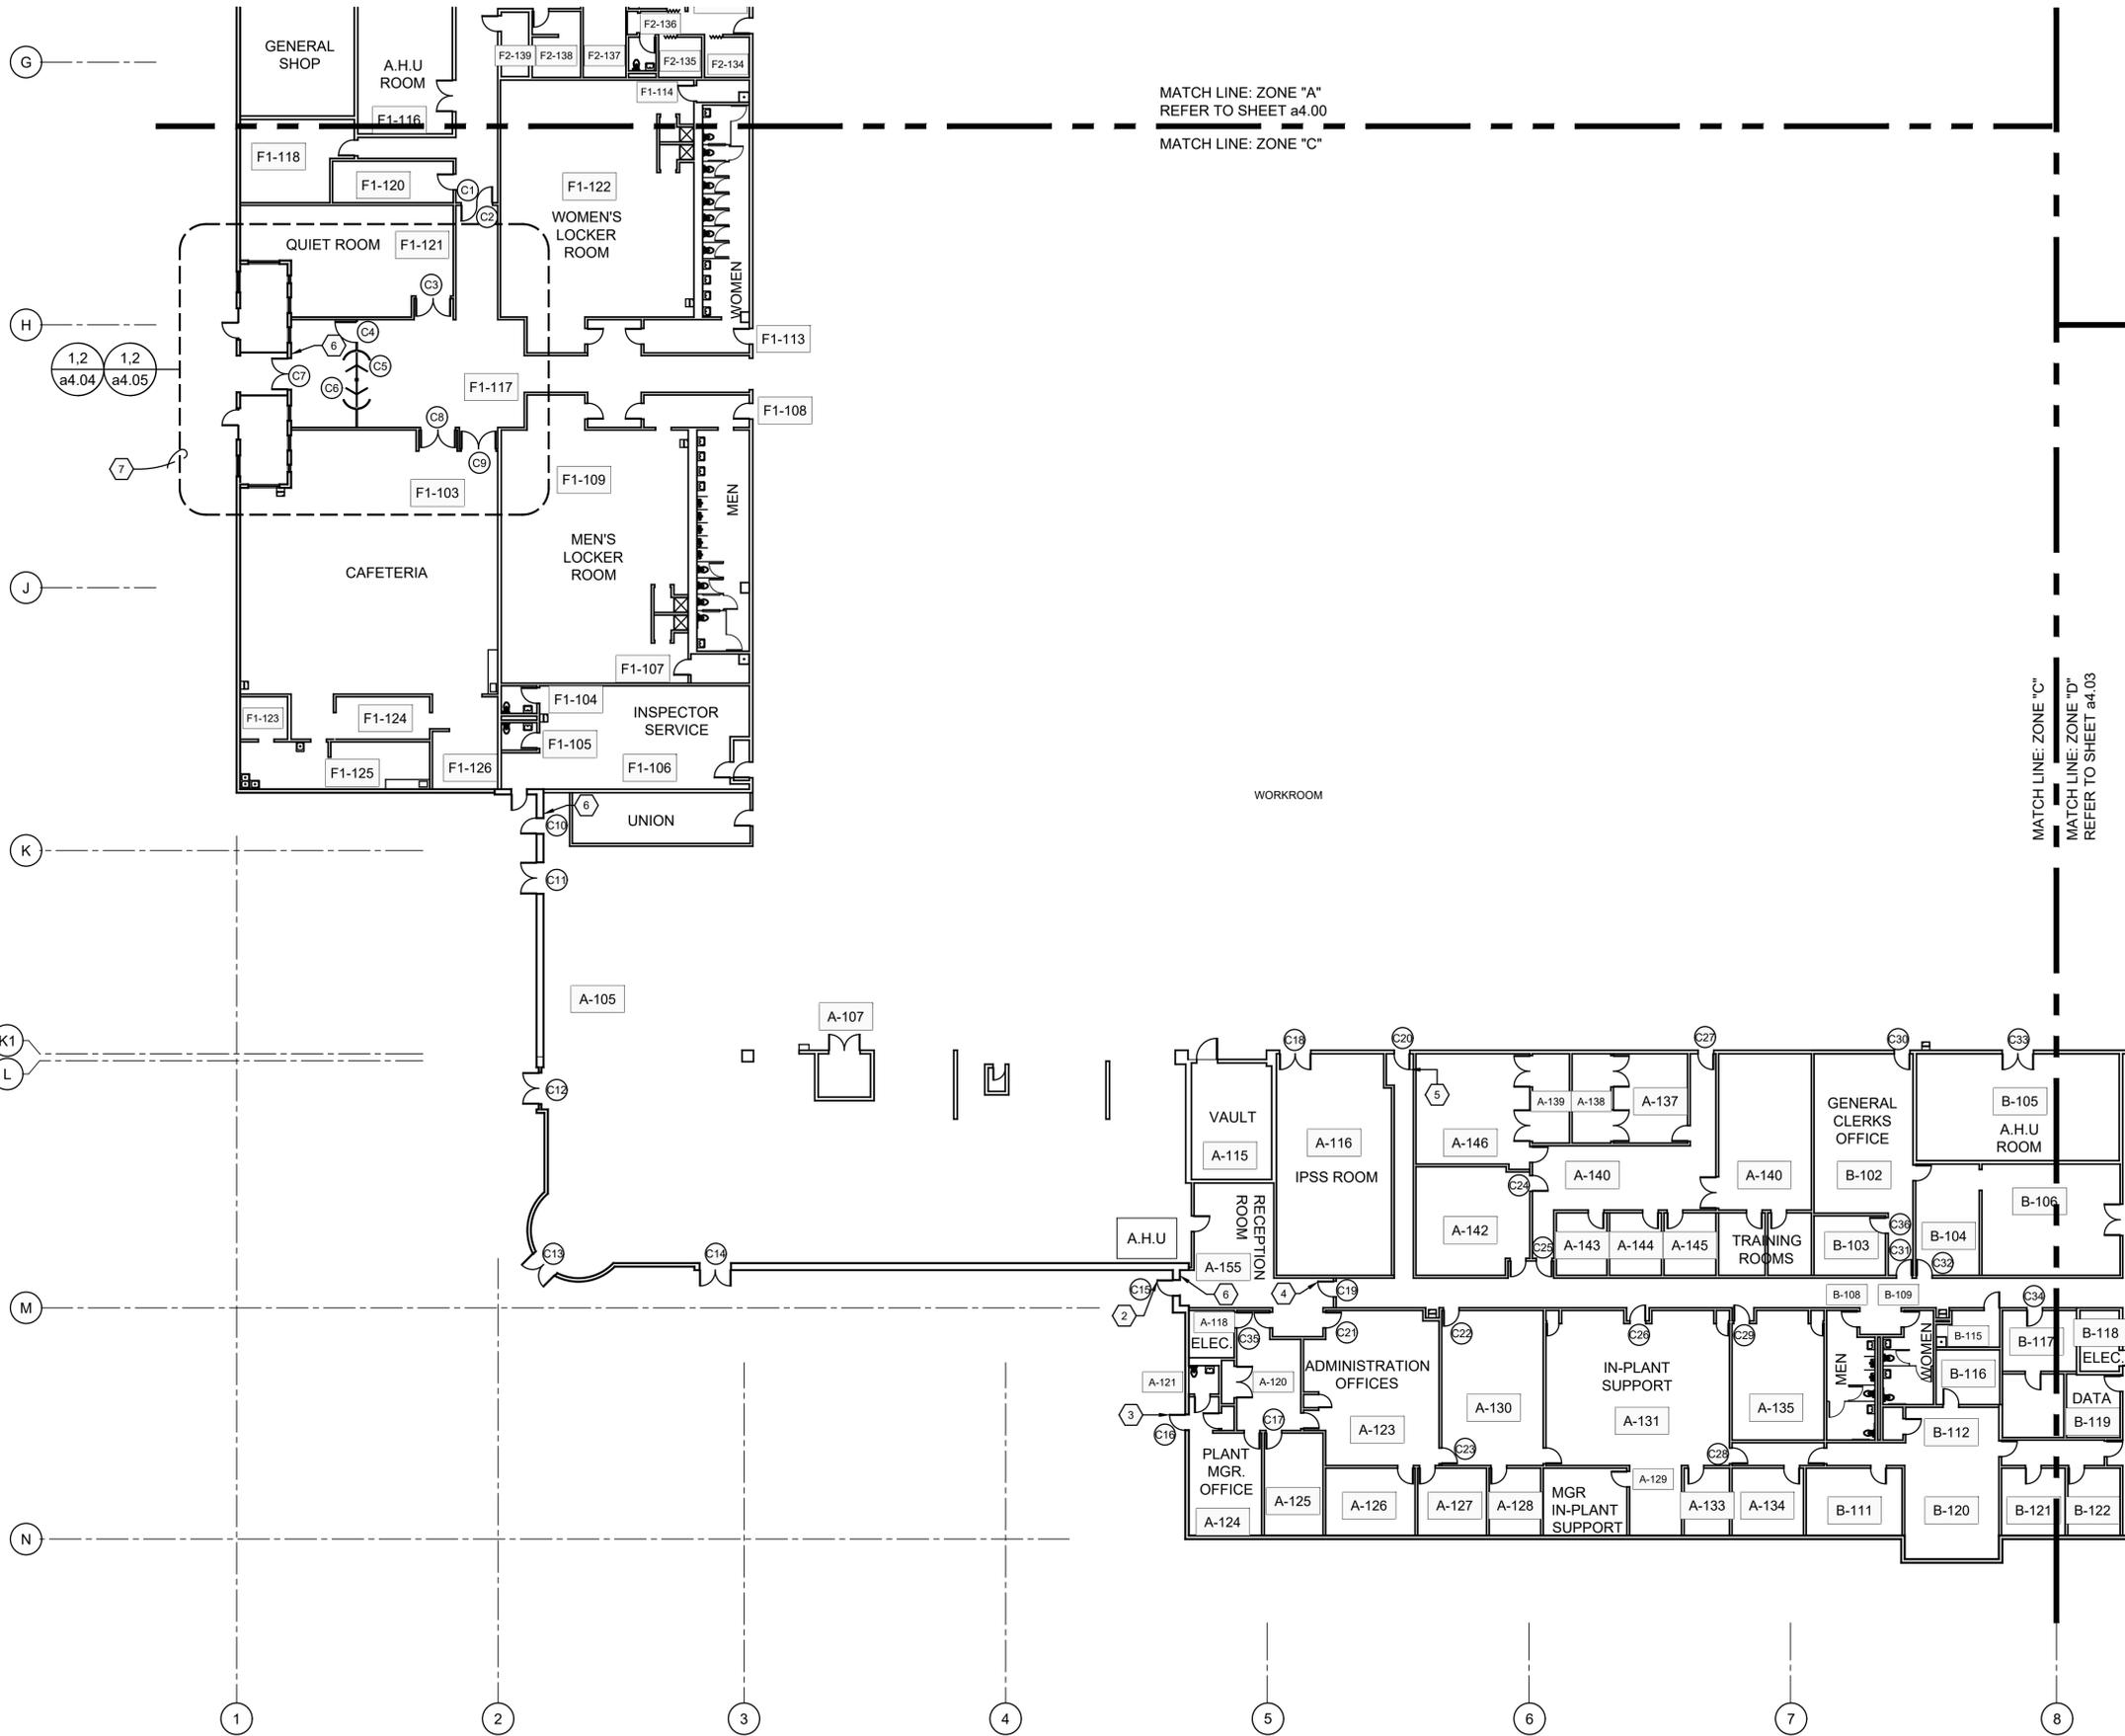- 1 NOT USED.
- 2 NEW 18 GAGE 3'-0" x 7'-0" HOLLOW METAL DOOR LEAF W/ A 1/4" WIRE GLASS WINDOW. NEW PUSH BAR W/ CONTACTS WITH EXTERIOR LEVER, MORTISE TYPE. EXTERIOR KEY W/FREE EXIT. PAINT NEW DOOR LEAF & EXISTING FRAME TO MATCH EXISTING. NEW VINYL EMERGENCY SIGN.
- 3 NEW 18 GAGE 3'-0" x 7'-0" HOLLOW METAL DOOR LEAF. NEW LOCKSET, MORTISE TYPE. EXTERIOR KEY W/FREE EXIT. PAINT NEW DOOR LEAF & EXISTING FRAME TO MATCH EXISTING.
- 4 EXISTING ALUMINUM STOREFRONT DOOR TO BE MODIFIED TO ACCEPT NEW DOOR HARDWARE. DOOR SHALL BE EQUIPPED WITH NEW PUSH BAR (NON-LATCHING).
- 5 NEW 18 GAGE 3'-0" x 7'-0" HOLLOW METAL DOOR LEAF W/ A 1/4" WIRE GLASS WINDOW. NEW PUSH BAR W/ CONTACTS WITH EXTERIOR LEVER, MORTISE TYPE. W/FREE EXIT. PAINT NEW DOOR LEAF & EXISTING FRAME TO MATCH EXISTING. NEW VINYL EMERGENCY SIGN.
- 6 PROVIDE AND INSTALL NEW TACTILE EGRESS SIGN. REFER TO DOOR SCHEDULE FOR OTHER TACTILE EGRESS SIGN LOCATIONS. REFER TO DETAIL ON SHEET a7.00 AND TO SPECIFICATION 101414.
- 7 REFER TO PHASING PLAN BEFORE STARTING WORK IN THIS AREA.

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revisions	project / phase	issue date	sheet name
19013		2022.03.03	"Zone C"

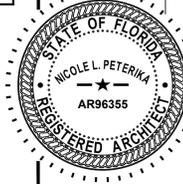

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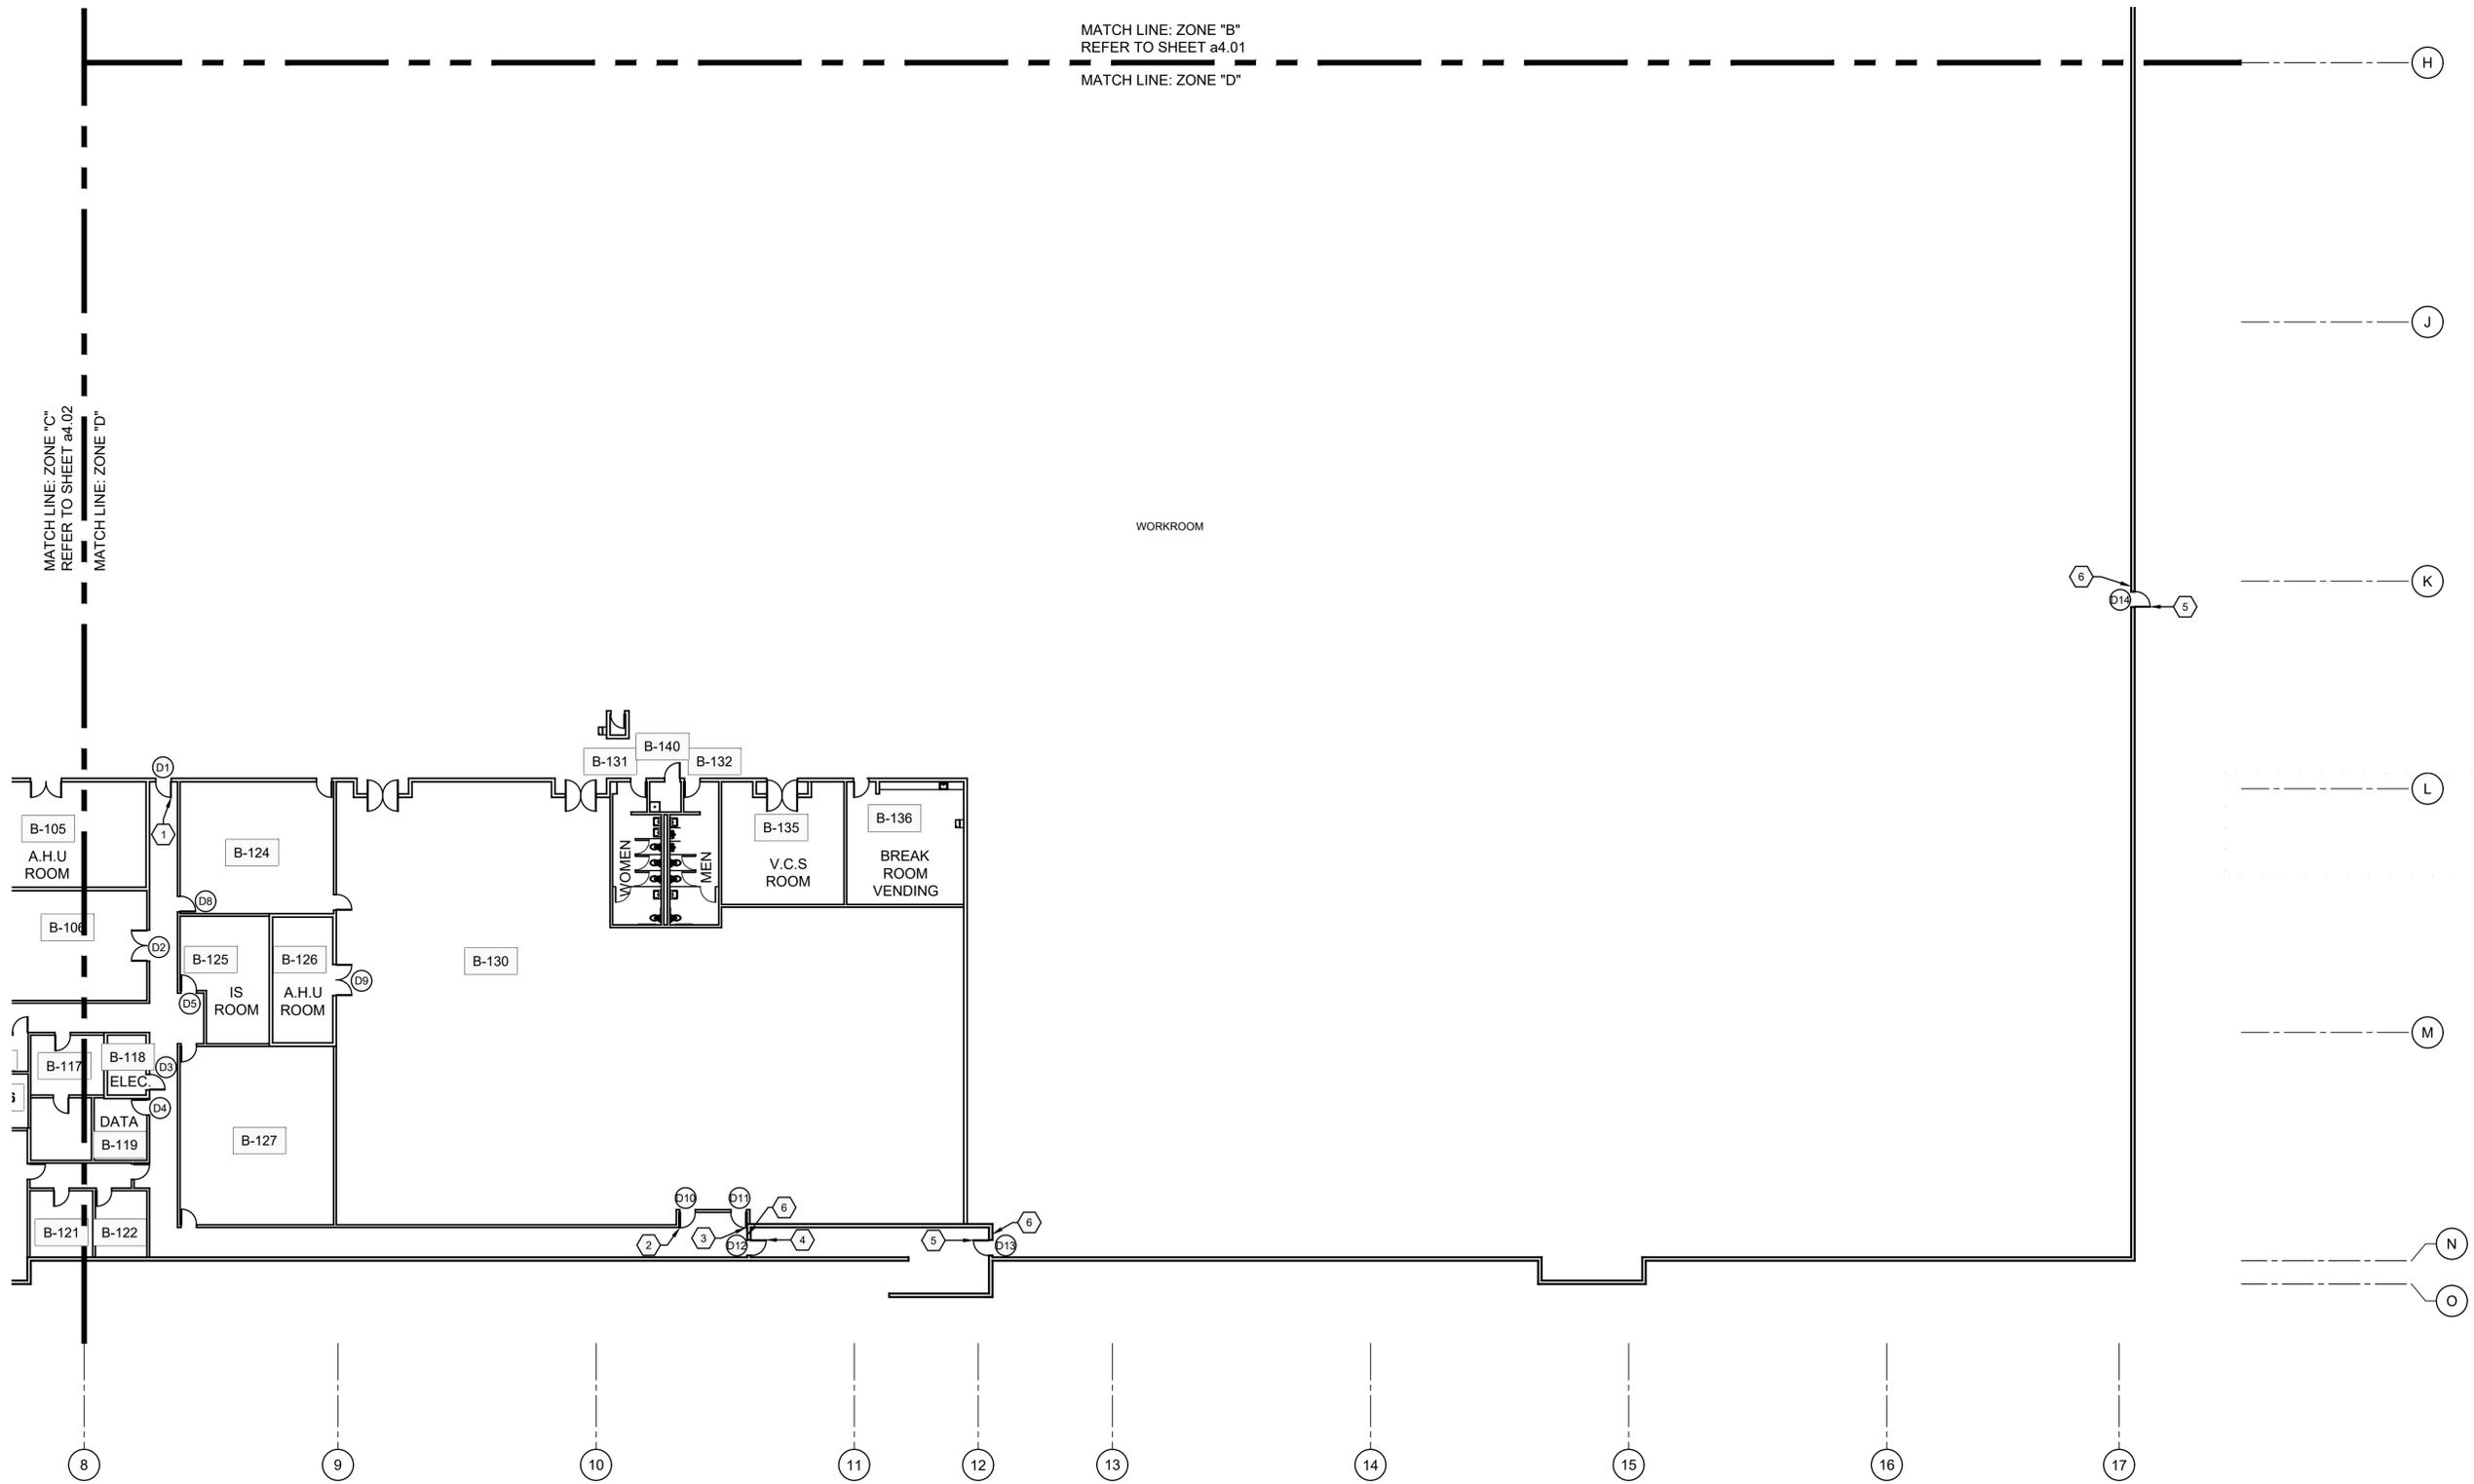
**ENLARGED FLOOR PLAN 'ZONE C'**  
 SCALE: 1/16" = 1'-0"

sheet  
**a4.02**  
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MATCH LINE: ZONE "B"  
 REFER TO SHEET a4.01  
 MATCH LINE: ZONE "D"

MATCH LINE: ZONE "C"  
 REFER TO SHEET a4.02  
 MATCH LINE: ZONE "D"



**DOOR HARDWARE NOTE:**

1. REFER TO DOOR SCHEDULE AND HARDWARE SPECIFICATION FOR COMPLETE DOOR HARDWARE REQUIREMENTS.
2. CONTRACTOR SHALL VERIFY THAT NEW DOOR HARDWARE FIT EXISTING DOOR CONFIGURATION. CONTRACTOR SHALL BE RESPONSIBLE TO PATCH AND PAINT EXISTING DOOR LEAFS WHERE EXISTING MOUNTING HOLES ARE NOT COVERED BY NEW HARDWARE.
3. CONTRACTOR SHALL FIELD VERIFY DOOR OPENING SIZE BEFORE ORDERING. CONTRACTOR IS RESPONSIBLE TO INSURE THAT ALL NEW DOORS FIT WITHIN SPECIFIED TOLERANCES.

**KEY NOTES:**

- 1 NEW 18 GAGE 3'-0" x 7'-0" HOLLOW METAL DOOR LEAF W/ A 1/4" WIRE GLASS WINDOW. NEW PUSH BAR W/ CONTACTS WITH EXTERIOR LEVER, MORTISE TYPE, W/FREE EXIT. PAINT NEW DOOR LEAF & EXISTING FRAME TO MATCH EXISTING. NEW VINYL EMERGENCY SIGN.
- 2 NEW LOCKSET, CYLINDER TYPE.
- 3 NEW 18 GAGE 3'-0" x 7'-0" HOLLOW METAL DOOR LEAF. EMERGENCY EXIT ONLY. NEW PUSHBAR W/ STARWHEEL. NEW VINYL EMERGENCY SIGNS. PAINT NEW DOOR LEAF & EXISTING FRAME TO MATCH EXISTING.
- 4 NEW 18 GAGE 3'-0" x 7'-0" HOLLOW METAL DOOR LEAF W/ A 1/4" WIRE GLASS WINDOW. NEW PUSH BAR W/ CONTACTS WITH EXTERIOR LEVER, MORTISE TYPE, EXTERIOR KEY W/FREE EXIT. PAINT NEW DOOR LEAF & EXISTING FRAME TO MATCH EXISTING. NEW VINYL EMERGENCY SIGN.
- 5 EXISTING DOOR TO REMAIN. EMERGENCY EXIT ONLY, NEW PUSHBAR W/ STARWHEEL. NEW VINYL EMERGENCY SIGN.
- 6 PROVIDE AND INSTALL NEW TACTILE EGRESS SIGN. REFER TO DOOR SCHEDULE FOR OTHER TACTILE EGRESS SIGN LOCATIONS. REFER TO DETAIL ON SHEET a7.00 AND TO SPECIFICATION 101414.

1 ENLARGED FLOOR PLAN 'ZONE D'  
 SCALE: 1/8" = 1'-0"

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revisions

project | phase

issue date

sheet name

19013

2022.03.03

"Zone D"

revisions

19013

2022.03.03

"Zone D"

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project | phase

issue date

sheet name

19013

2022.03.03

"Zone D"

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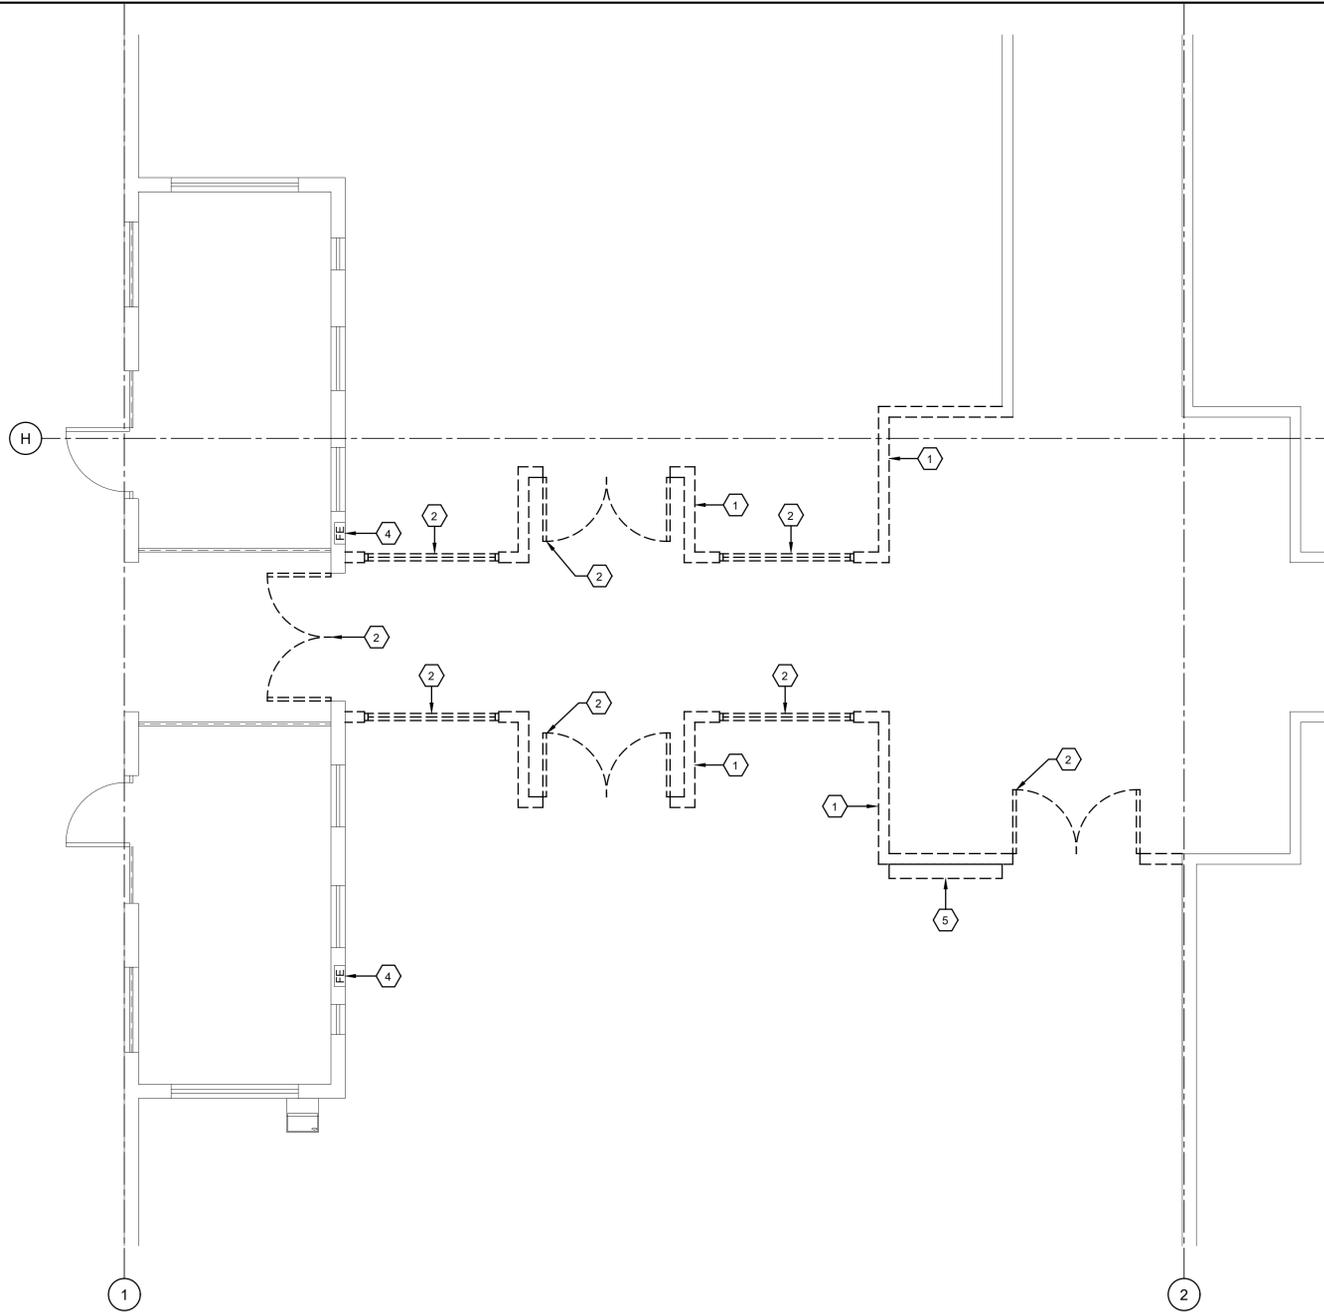
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2022.03.03

"Zone D"

revisions


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**KEY NOTES:**

- 1 DEMOLISH EXISTING STUD WALL FROM FLOOR TO ROOF STRUCTURE ABOVE.
- 2 DEMOLISH EXISTING STOREFRONT, DOORS AND DOOR FRAMES THEN PREPARE FOR NEW WORK.
- 3 DEMOLISH EXISTING VINYL TILE FLOORING AND PREPARE FOR NEW.
- 4 EXISTING FIRE EXTINGUISHER AND CABINET TO REMAIN.
- 5 EXISTING WOOD MAGAZINE RACKS TO BE REMOVED AND STORED AND REINSTALLED. COORDINATE WITH FACILITY FOR NEW LOCATION.

1 EMPLOYEE ENTRANCE PLAN - DEMO  
 SCALE: 1/4" = 1'-0"



**KEY NOTES:**

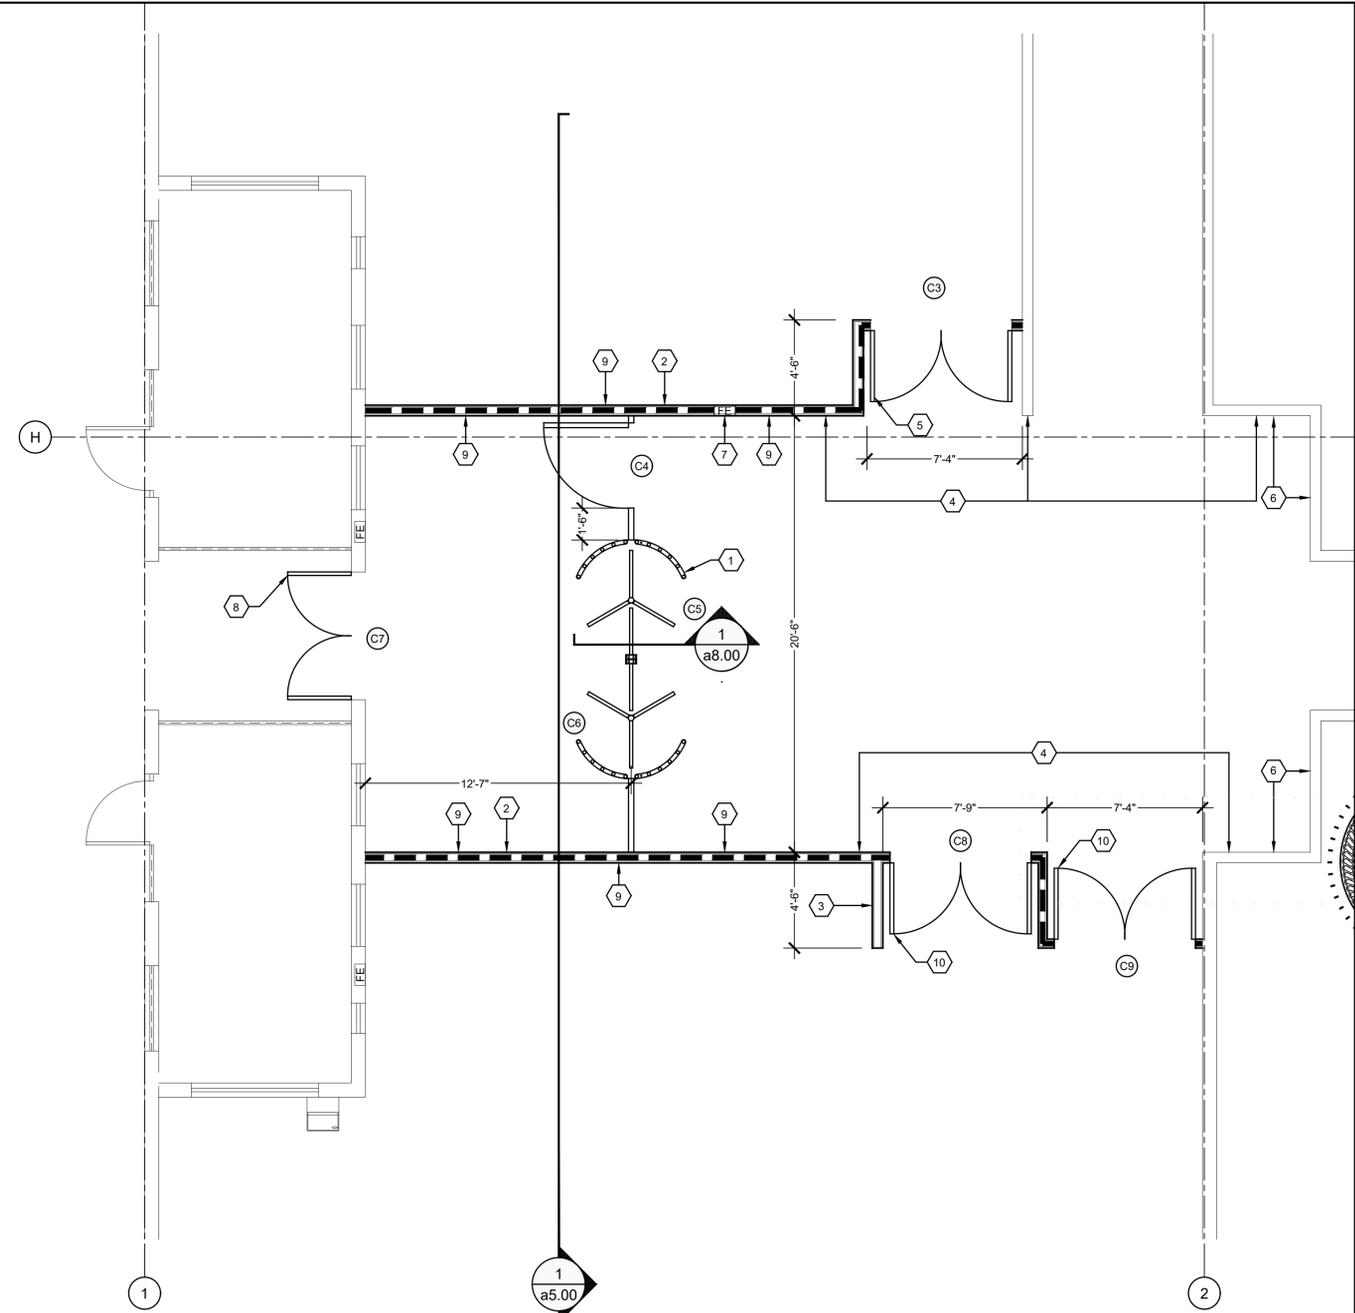- 1 NEW TURNSTILE AND ACCESSIBLE GATE. REFER TO DETAILS AND SPECIFICATIONS. INSTALL PER MANUFACTURER RECOMMENDATIONS.
- 2 CONSTRUCT NEW ONE HOUR WALL FROM FLOOR TO ROOF DECK ABOVE. 22 GAGE METAL STUDS AT 16" O.C. W/ 1 LAYER 5/8" TYPE X GYP. BD. EACH SIDE. APPLY TYPE X GYP. BD. PARALLEL OR AT RIGHT ANGLES EA. SIDE. USE 1" TYPE S DRYWALL SCREWS 8" O.C. AT JOINTS AND 12" O.C. AT RUNNERS AND INTERMEDIATE STUDS. JOINTS SHALL BE STAGGERED AT 16" ON OPPOSITE SIDES. EXTEND ONE HOUR WALL TO ROOF DECK ABOVE.
- 3 CONSTRUCT NEW WING WALL FROM FLOOR TO CEILING ABOVE. 25 GAGE METAL STUDS AT 16" O.C. W/ 5/8" GYP. BD..
- 4 ALIGN NEW WALL WITH EXISTING.
- 5 NEW 6'-8" x 7'-8", 16 GAGE STEEL HOLLOW METAL DOOR FRAME AND TWO NEW 18 GAGE 3'-4" x 7'-8" SOLID CORE WOOD DOOR LEAF W/ A 1/4" WIRE GLASS WINDOW. DOOR ASSEMBLY SHALL BE FORTY-FIVE MINUTE RATED. NEW PUSH BAR W/ SURFACE VERTICAL RODS & EXTERIOR LEVER. W/FREE EXIT. PAINT NEW FRAME TO MATCH EXISTING ADJACENT FINISHES. WOOD DOORS SHALL BE CLEAR FINISH.
- 6 PAINT EXISTING SKYLIGHT AREA TO MATCH EXISTING. CEILING, WALLS AND BULKHEAD.
- 7 NEW FIRE EXTINGUISHER AND CABINET TO MATCH EXISTING IN CORRIDOR. STAINLESS STEEL CABINET WITH ONE HOUR FIRE RATING.
- 8 NEW 6'-4" x 8'-2", ALUMINUM STOREFRONT DOOR FRAME W/ TWO NEW 3'-0" x 7'-0" DOOR LEAFS AND 12" TRANSOM WINDOW. NEW PUSH BAR W/ CONCEALED VERTICAL RODS & LOCKABLE EXTERIOR LEVER. MORTISE TYPE. W/FREE EXIT. CONFIRM SIZE IN FIELD.
- 9 NEW WOOD CHAIR RAIL TO MATCH EXISTING. PAINT TO MATCH EXISTING IN EACH SPACE. TYPICAL ALL NEW WALLS.
- 10 NEW 6'-8" x 7'-8", 16 GAGE STEEL HOLLOW METAL DOOR FRAME AND TWO NEW 18 GAGE 3'-4" x 7'-8" SOLID CORE WOOD DOOR LEAF W/ A 1/4" WIRE GLASS WINDOW. DOOR ASSEMBLY SHALL BE FORTY-FIVE MINUTE RATED. NEW PUSH BAR W/ SURFACE VERTICAL RODS. PAINT NEW FRAME TO MATCH EXISTING ADJACENT FINISHES. WOOD DOOR SHALL BE CLEAR FINISH.

2 EMPLOYEE ENTRANCE PLAN - NEW  
 SCALE: 1/4" = 1'-0"

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revisions

19013

2022.03.03

Employee Entrance

project | phase

issue date

sheet name

revisions

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**SECURITY UPGRADES**

14080 JETPORT LOOP  
 FT MYERS, FL. 33913


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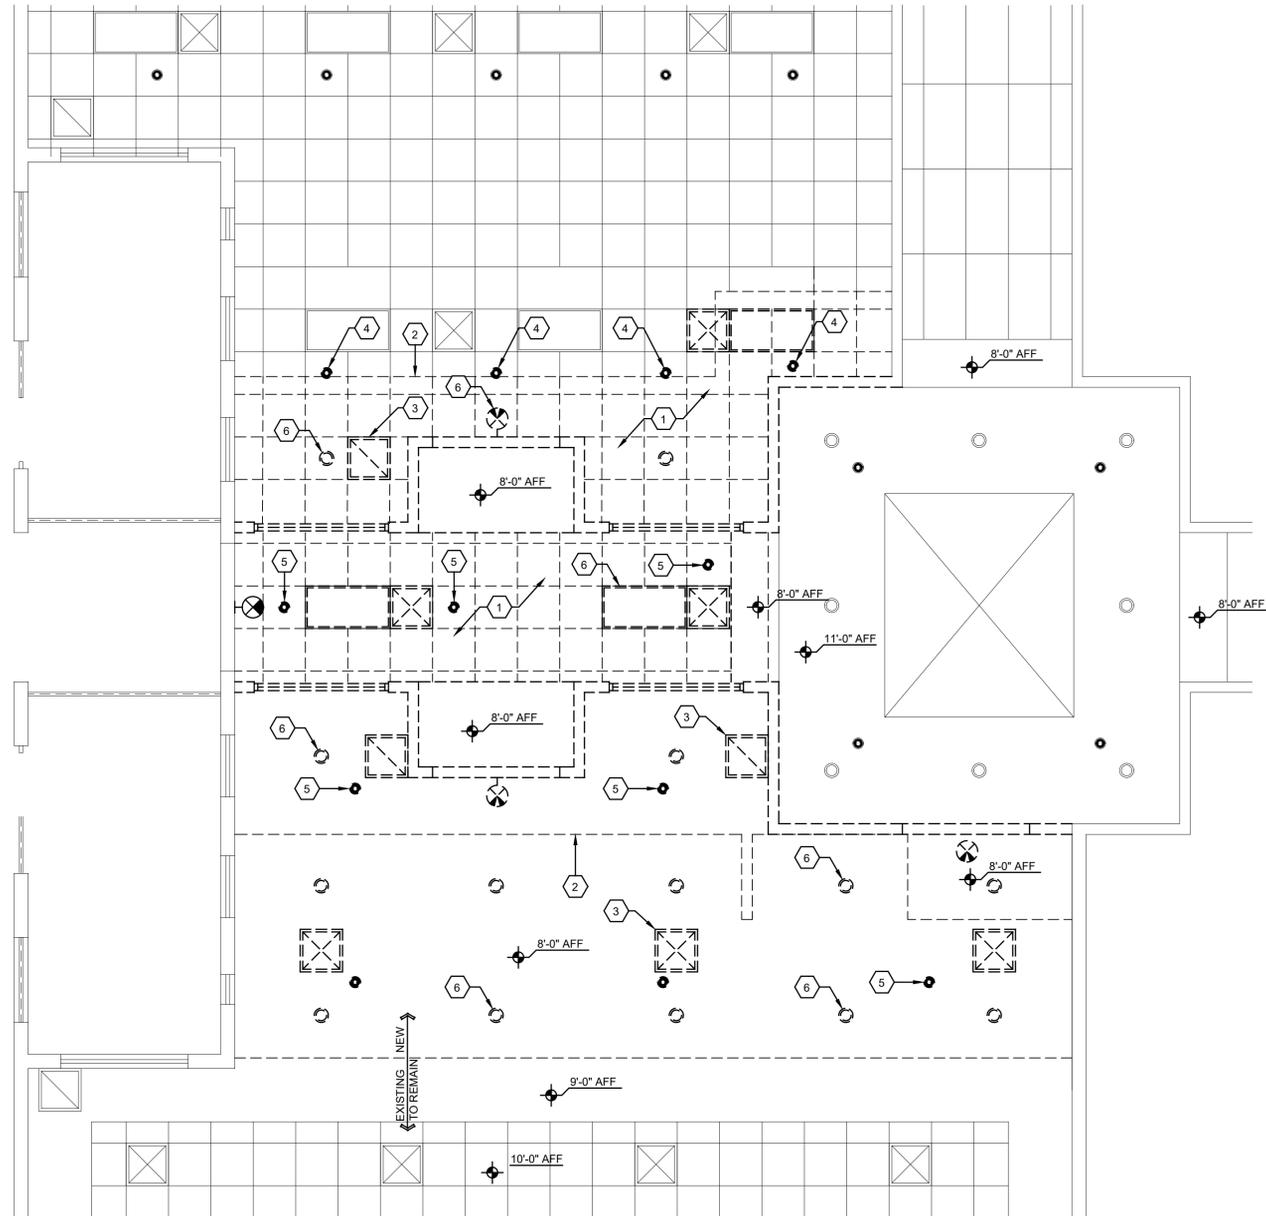
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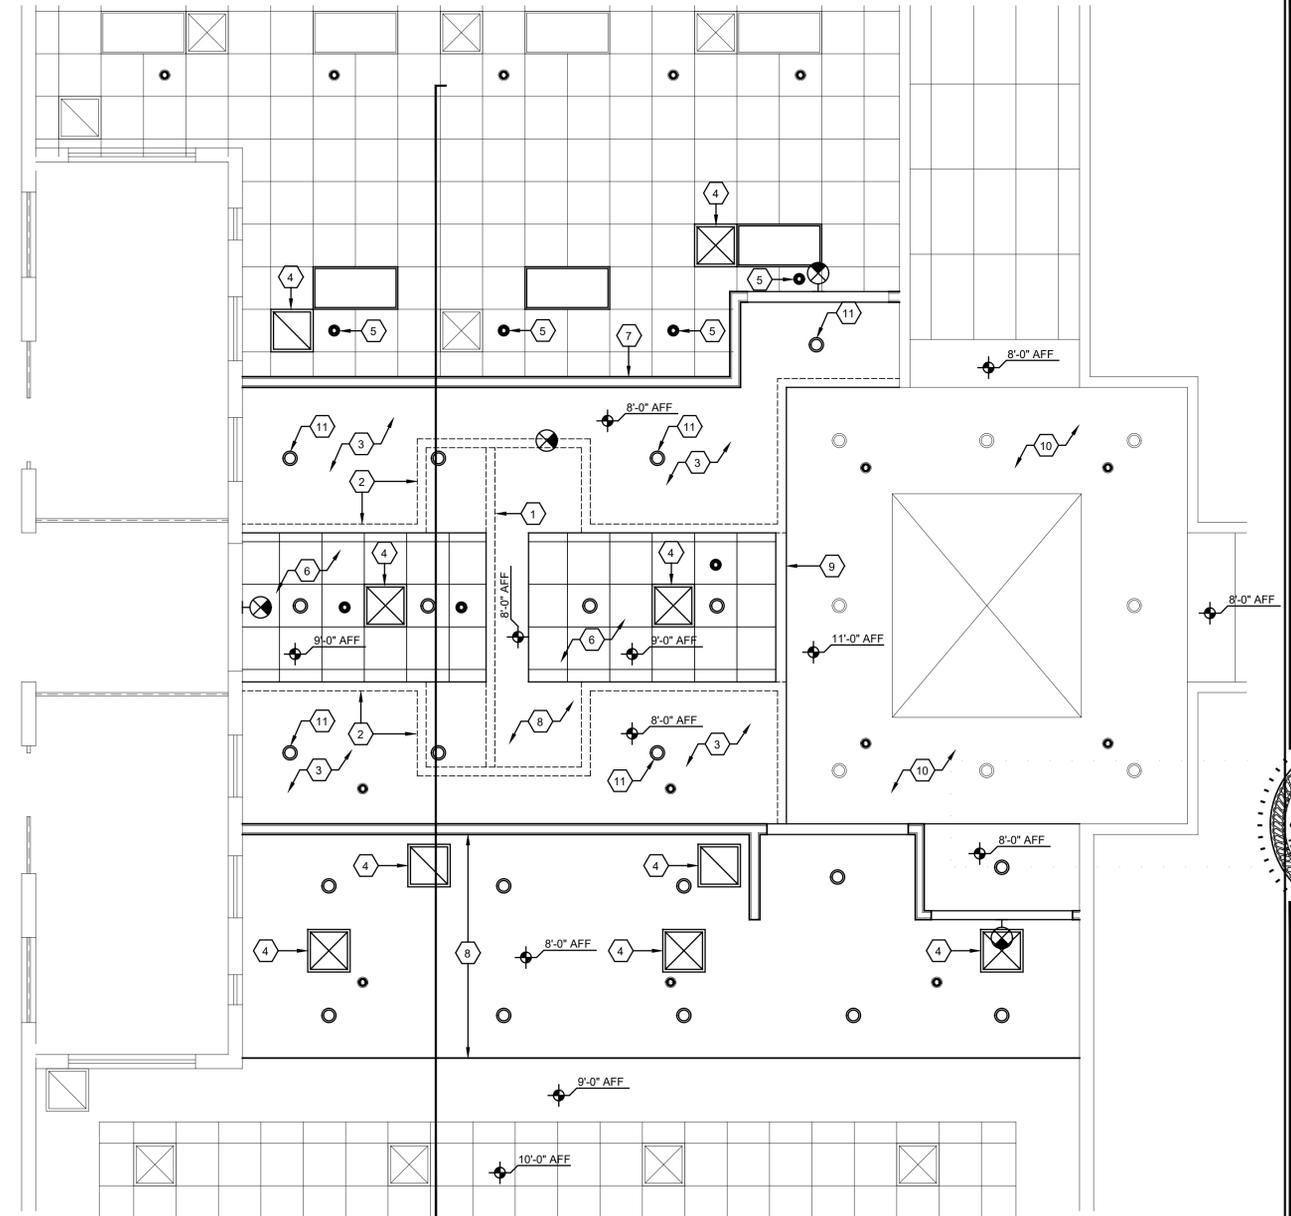
**KEY NOTES:**

- 1 DEMOLISH EXISTING CEILING TILES AND GRID. PREPARE FOR NEW.
- 2 LINE OF EXTENT OF NEW WALLS OR BULKHEAD.
- 3 EXISTING MECHANICAL DEVICES TO BE REPLACED WITH NEW.
- 4 EXISTING FIRE SPRINKLER HEAD TO BE RELOCATED. TYPICAL OF (4) FOUR FIRE SPRINKLER HEADS.
- 5 EXISTING FIRE SPRINKLER HEAD TO REMAIN. PROTECT DURING CONSTRUCTION.
- 6 EXISTING LIGHTING FIXTURE TO BE DEMOLISHED. REFER TO ELECTRICAL.

**FIRE SPRINKLER NOTES:**

- 1. THE WORK SHALL BE PERFORMED BY A FIRE SPRINKLER CONTRACTOR LICENSED BY THE STATE OF FLORIDA TO PERFORM THIS SCOPE OF WORK.
- 2. MODIFY THE EXISTING FIRE SPRINKLER AND SPRINKLER HEAD LOCATIONS AS SHOWN ON THE REFLECTED CEILING PLAN AND AS REQUIRED TO COMPLY WITH ALL CODES.
- 3. ALL FIRE PROTECTION WORK SHALL BE IN STRICT ACCORDANCE WITH NFPA VOLUME 13, THE FLORIDA FIRE PREVENTION CODE LATEST ADDITION, UNDERWRITERS LABORATORY, FACTORY MUTUAL AND ALL STATE AND LOCAL CODES.
- 4. ALL EQUIPMENT, DEVICES AND MATERIALS INCLUDED IN THE INSTALLATION SHALL BE APPROVED OR LISTED BY UNDERWRITER'S LABORATORIES AND/OR FACTORY MUTUAL.

1 **EMPLOYEE ENTRANCE CEILING PLAN - DEMO**  
 SCALE: 1/4" = 1'-0"

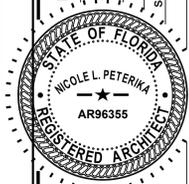

**KEY NOTES:**

- 1 CONSTRUCT NEW SECURITY BULKHEAD FROM TOP OF TURNSTILE TO ROOF DECK ABOVE. CONFIRM BOTTOM HEIGHT OF BULKHEAD WITH TURNSTILE MANUFACTURER. NEW 25 GAGE METAL STUD AND 5/8 GYP. BD. BOTH SIDES TO ROOF DECK ABOVE.
- 2 CONSTRUCT NEW ONE HOUR WALL FROM FLOOR TO ROOF DECK ABOVE. 22 GAGE METAL STUDS AT 16" O.C. W/ 1 LAYER 5/8" TYPE X GYP. BD. EACH SIDE. APPLY TYPE X GYP. BD. PARALLEL OR AT RIGHT ANGLES EA. SIDE. USE 1" TYPE S DRYWALL SCREWS 8" O.C. AT JOINTS AND 12" O.C. AT RUNNERS AND INTERMEDIATE STUDS. JOINTS SHALL BE STAGGERED AT 16" ON OPPOSITE SIDES. EXTEND ONE HOUR WALL TO ROOF DECK ABOVE.
- 3 CONSTRUCT NEW ONE HOUR CEILING ASSEMBLY 22 GAGE METAL STUDS AT 16" O.C. W/ 5/8" TYPE X GYP. BD. EACH SIDE. APPLY TYPE X GYP. BD. PARALLEL OR AT RIGHT ANGLES EA. SIDE. USE 1" TYPE S DRYWALL SCREWS 8" O.C. AT JOINTS AND 12" O.C. AT RUNNERS AND INTERMEDIATE STUDS. JOINTS SHALL BE STAGGERED AT 16" ON OPPOSITE SIDES.
- 4 PROVIDE NEW DIFFUSER/GRILLE TO MATCH EXISTING.
- 5 RELOCATED FIRE SPRINKLER HEAD.
- 6 NEW ACOUSTICAL CEILING GRID SYSTEM, REFER TO SPECIFICATIONS.
- 7 PATCH EXISTING CEILING TILE/GRID AS REQUIRED AT NEW BULKHEAD/WALLS.
- 8 CONSTRUCT NEW CEILING ASSEMBLY 22 GAGE METAL STUDS AT 16" O.C. W/ 5/8" GYP. BD. USE 1" TYPE S DRYWALL SCREWS 8" O.C. AT JOINTS AND 12" O.C. AT RUNNERS AND INTERMEDIATE STUDS.
- 9 PATCH AND PAINT TO MATCH EXISTING BULKHEAD TO REMAIN.
- 10 PAINT EXISTING SKYLIGHT AREA TO MATCH EXISTING. CEILING, WALLS AND BULKHEAD.
- 11 LIGHTING FIXTURES INSTALLED IN FIRE RATED ASSEMBLIES SHALL BE INSTALLED AS TO MAINTAIN THE ASSEMBLIES FIRE RATING. FIXTURES SHALL BE EQUALLY RATED TO THE ASSEMBLY RATING OR INSTALLED IN A BOX CONSTRUCTED USING THE ASSEMBLY.

2 **EMPLOYEE ENTRANCE CEILING PLAN - NEW**  
 SCALE: 1/4" = 1'-0"

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19013

2022.03.03

Employee Entrance Ceiling

project / phase

issue date

sheet name

STATE OF FLORIDA  
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 REGISTERED ARCHITECT  
 AR96355


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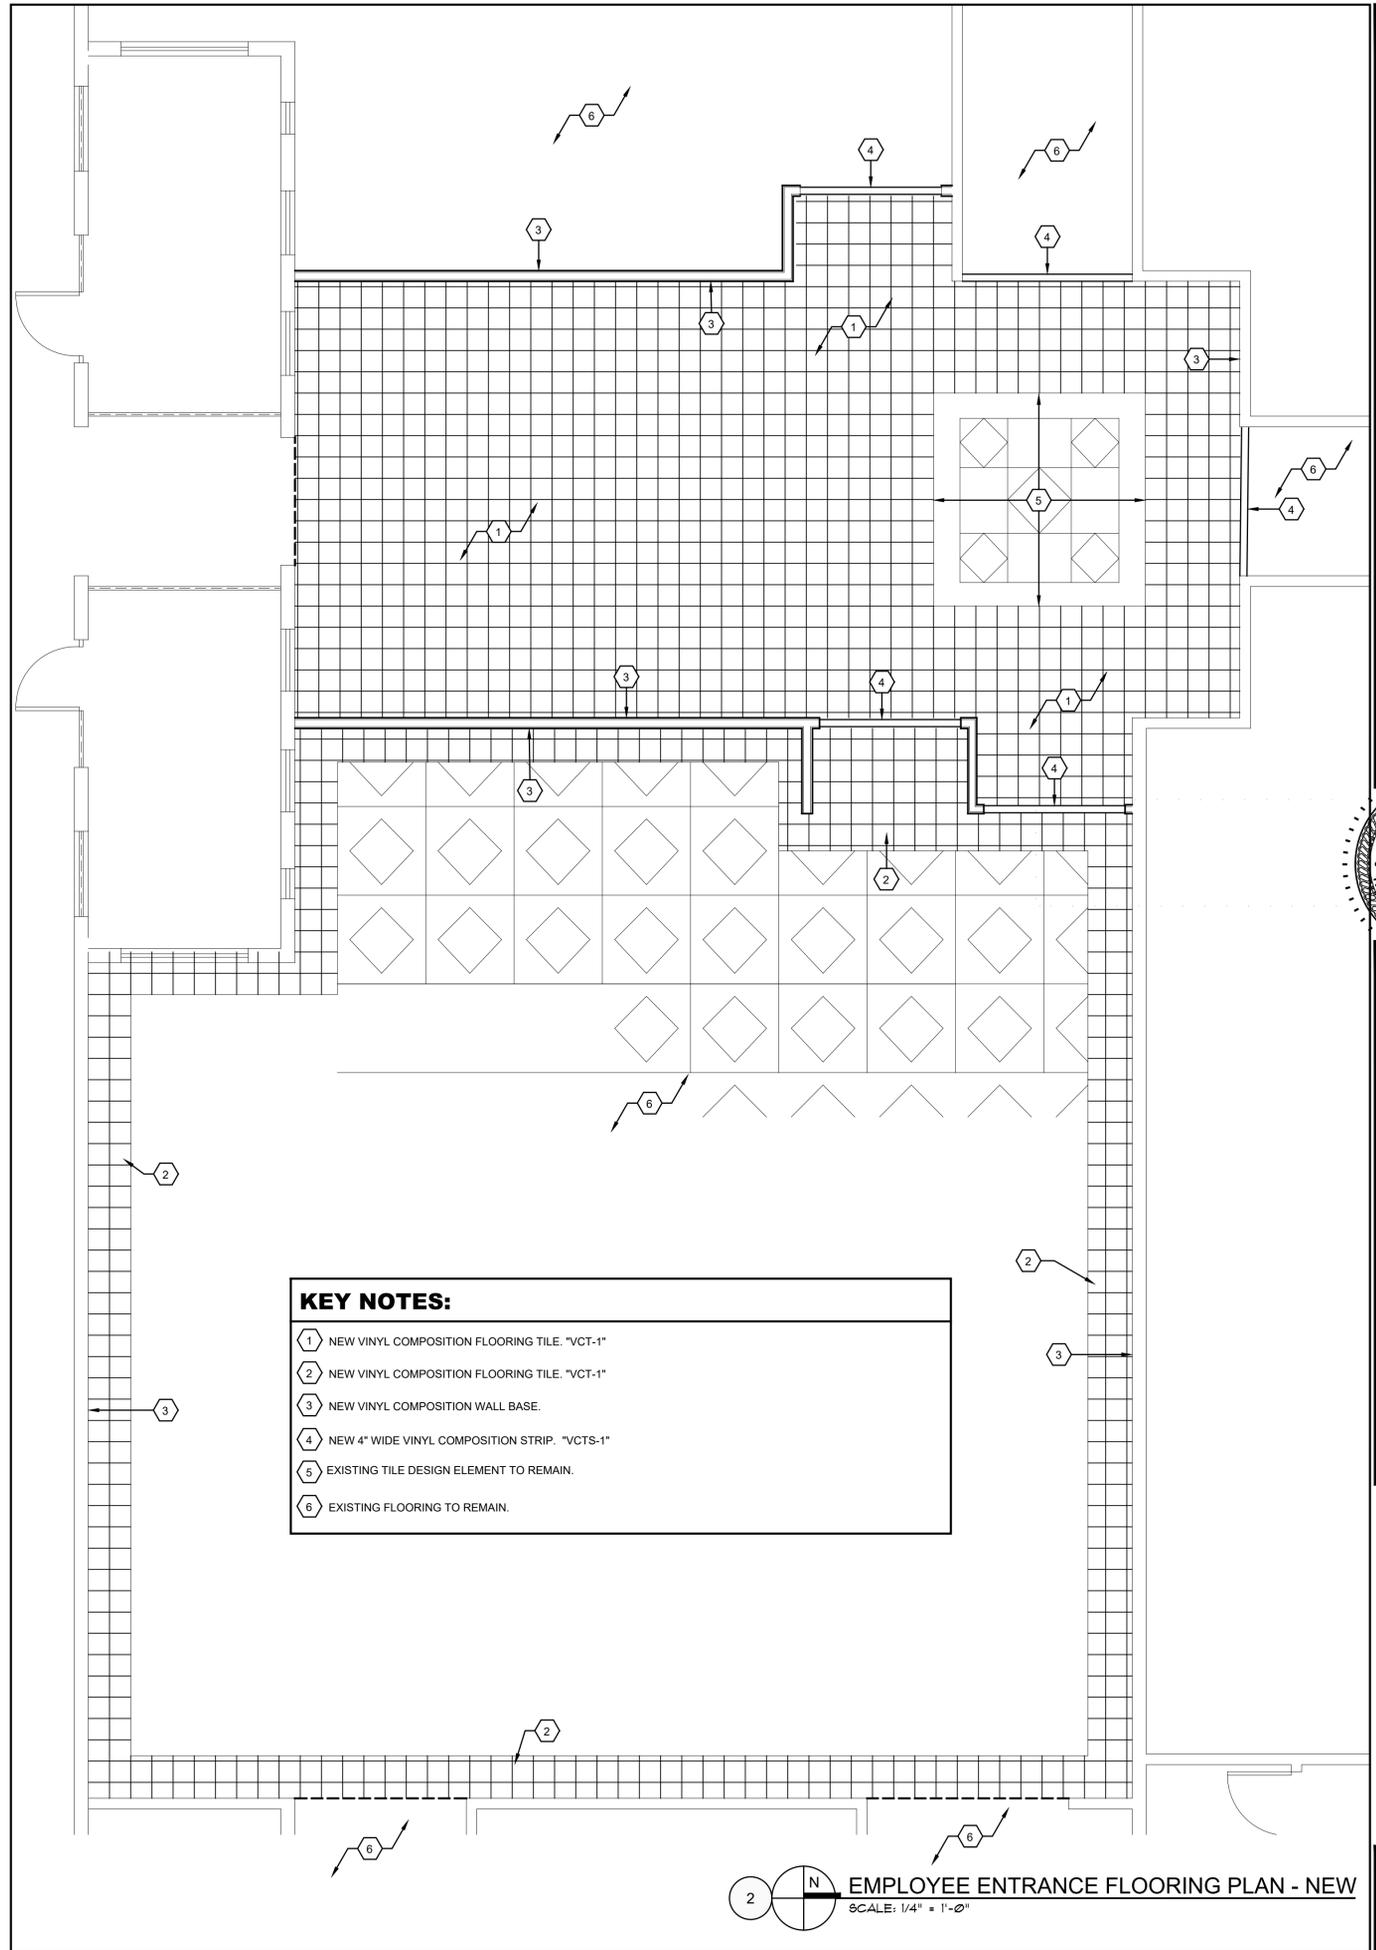
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**KEY NOTES:**

- 1 DEMOLISH EXISTING FLOORING TILE AND WALL BASE IN AREA SHOWN.
- 2 EXISTING TILE DESIGN ELEMENT TO REMAIN.
- 3 EXTENT OF FLOORING DEMOLITION.
- 4 EXISTING FLOORING TO REMAIN.

1 **EMPLOYEE ENTRANCE FLOORING PLAN - DEMO**  
 SCALE: 1/4" = 1'-0"




**KEY NOTES:**

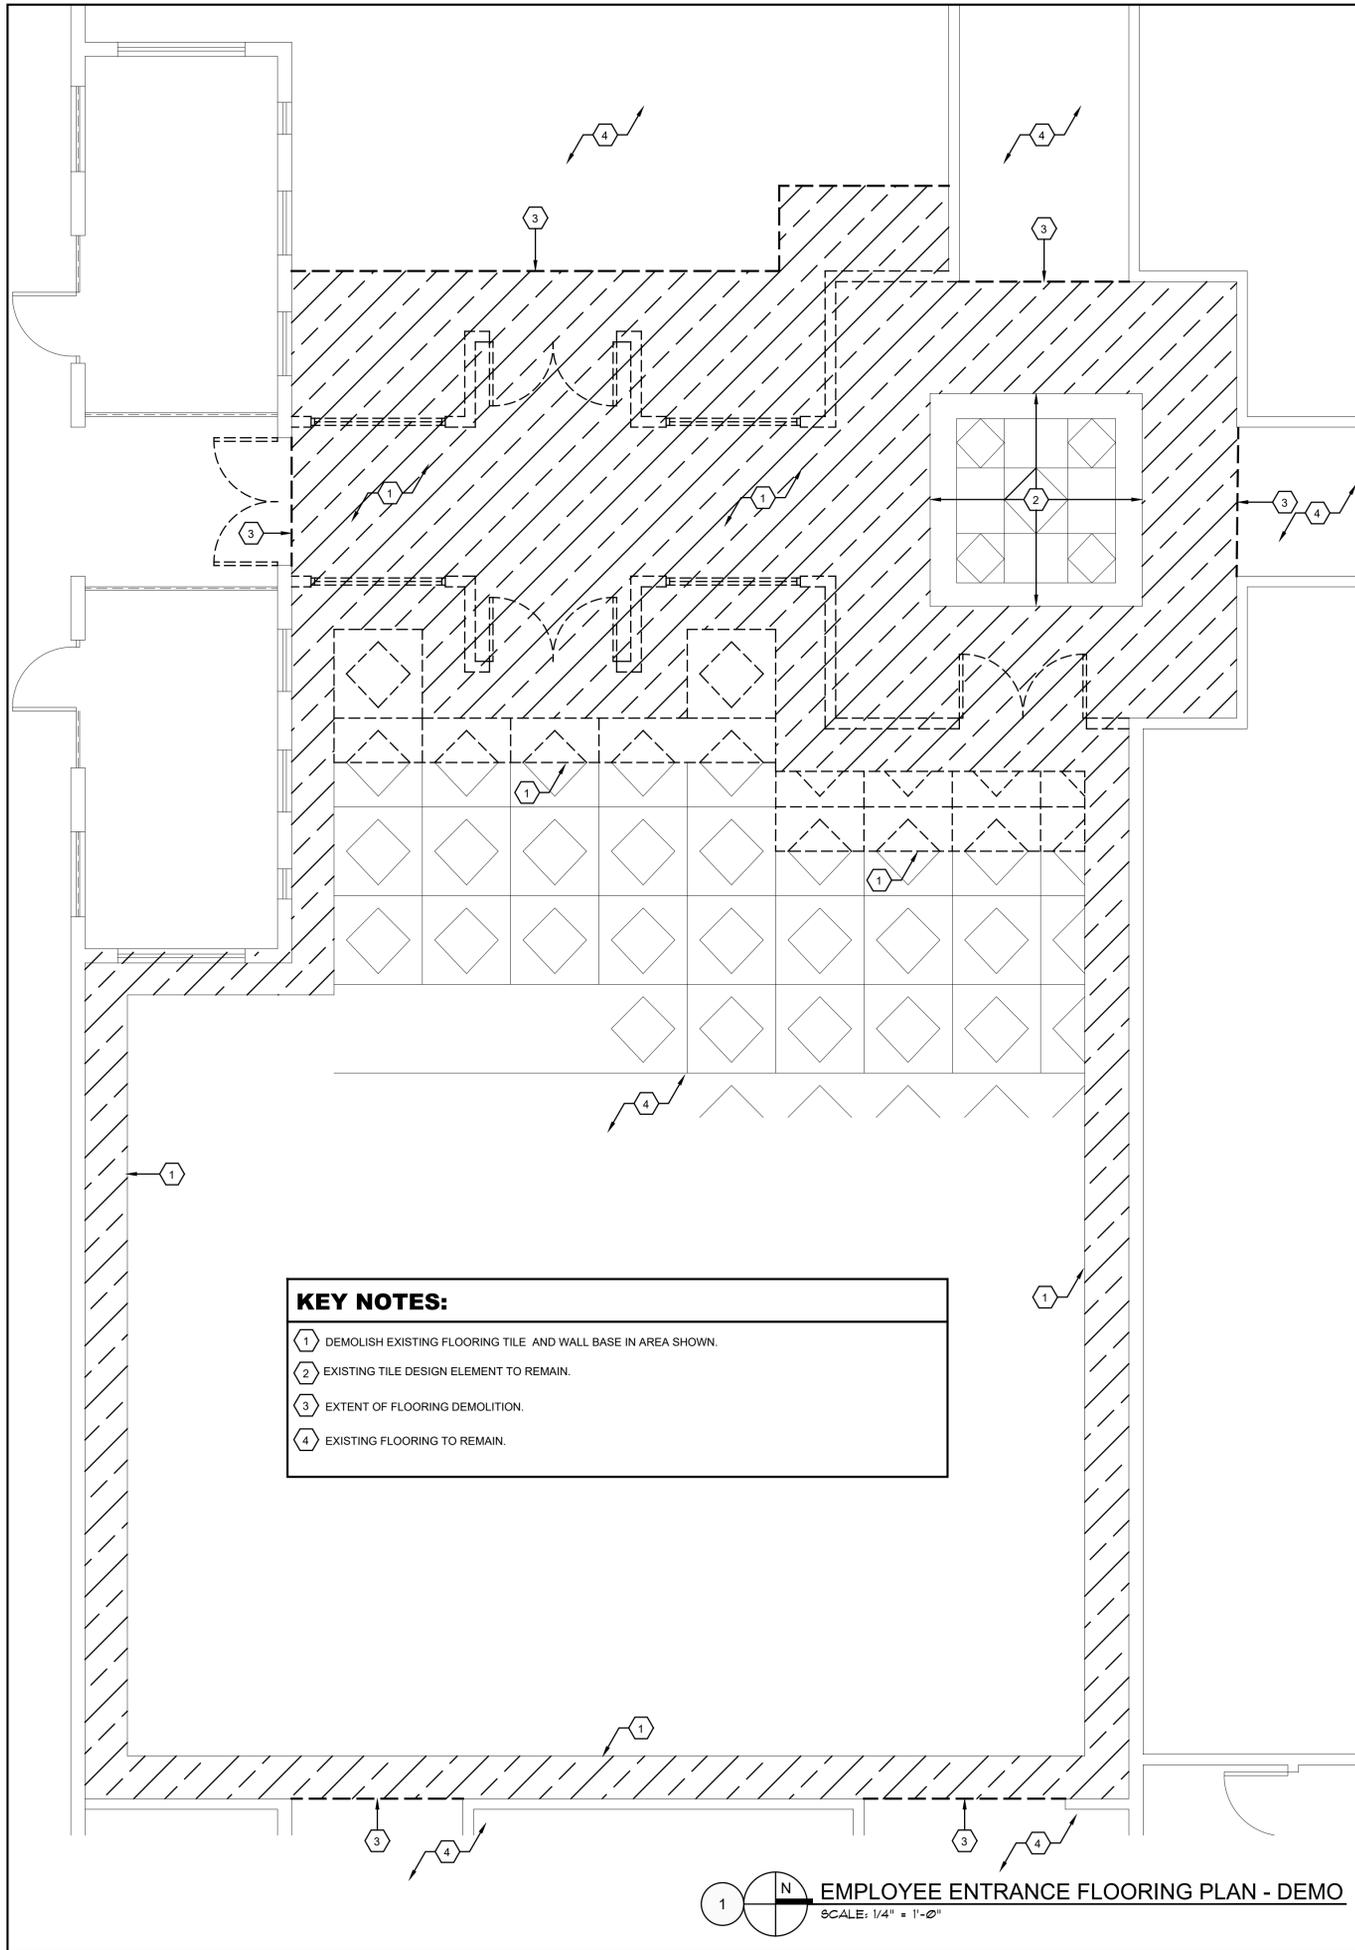- 1 NEW VINYL COMPOSITION FLOORING TILE. "VCT-1"
- 2 NEW VINYL COMPOSITION FLOORING TILE. "VCT-1"
- 3 NEW VINYL COMPOSITION WALL BASE.
- 4 NEW 4" WIDE VINYL COMPOSITION STRIP. "VCTS-1"
- 5 EXISTING TILE DESIGN ELEMENT TO REMAIN.
- 6 EXISTING FLOORING TO REMAIN.

2 **EMPLOYEE ENTRANCE FLOORING PLAN - NEW**  
 SCALE: 1/4" = 1'-0"


project / phase	19013
issue date	2022.03.03
sheet name	Employee Entrance
revisions	
consultant	

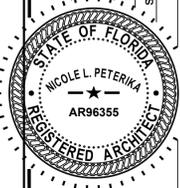

**FT MYERS P&DC**  
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1 SECTION THROUGH NEW EMPLOYEE ENTRANCE  
SCALE: 1/2" = 1'-0"

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19013


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project | phase

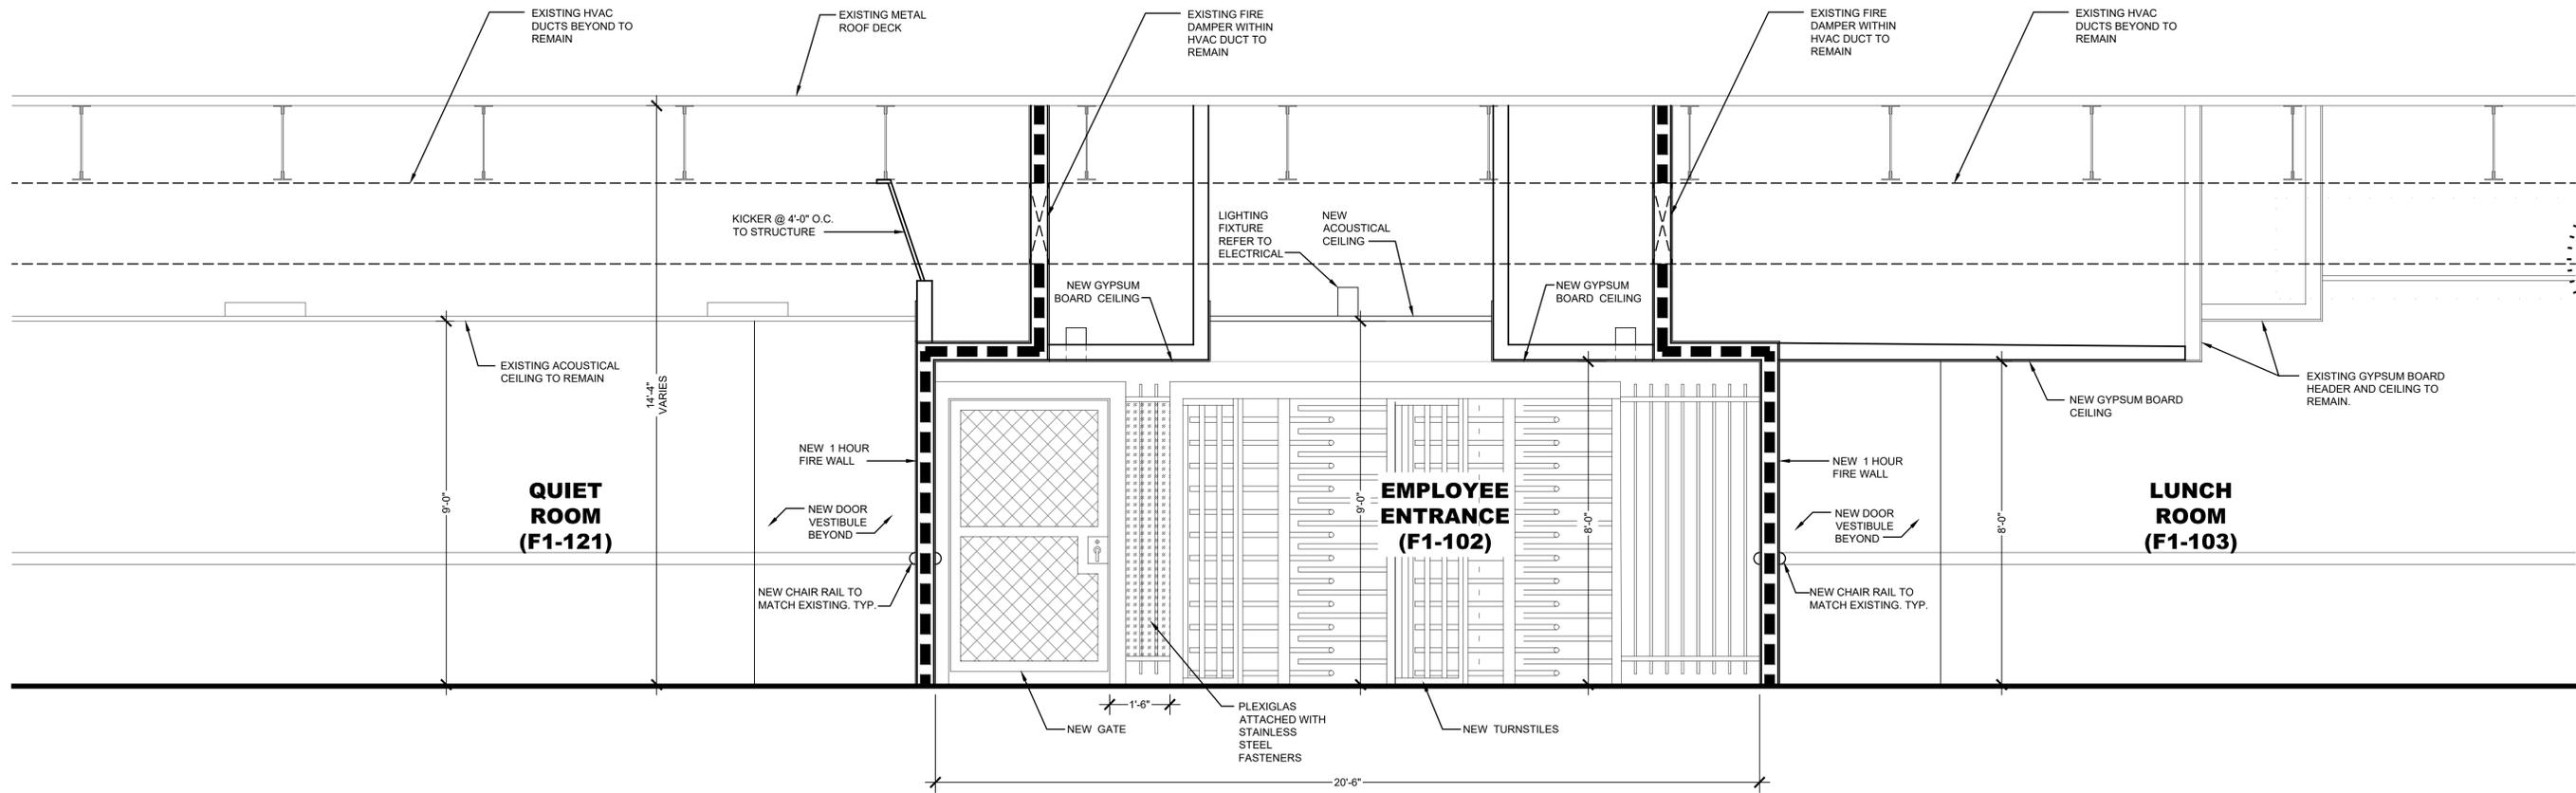issue date

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SECTION



**FT MYERS P&DC**  
**SECURITY UPGRADES**  
14080 JETPORT LOOP  
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sheet **a5.00**  
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**DOOR SCHEDULE FOR ACCESS CONTROL DEVICES**

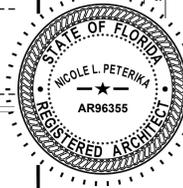**ZONE "A"**





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A2																							
A3	◆	◆		◆	J	◆	◆	◆	◆	3/0X8/0		◆		◆		◆	◆	◆		F20	1		
A4																							
A5																							
A6																							
A7	◆	◆			J	◆	◆	◆	◆	4/0X8/0		◆		◆		◆	◆	◆		F20	1		
A8	◆	◆			J	◆	◆	◆	◆	3/0X8/0		◆		◆		◆	◆	◆		F20	1		
A9	◆	◆			G	◆	◆	◆	◆	6/0X7/0		◆		◆		◆	◆	◆		F20	2		1-HR WALL / 45 MINUTE DOOR
A10																							
A11																							
A12	◆	◆	2	◆	B	◆	◆	◆	◆	6/0X7/0	◆	◆		◆		◆	◆	◆	◆	08	3		2-HR WALL / 90 MINUTE DOOR
A13																							
A14																							
A15																							
A16	◆	◆			B	◆	◆	◆	◆	6/0X7/0		◆		◆		◆	◆	◆		F20	4	◆	2-HR WALL / 90 MINUTE DOOR
A17	◆	◆			G	◆	◆	◆	◆	6/0X8/0		◆		◆		◆	◆	◆		F20	4	◆	2-HR WALL / 90 MINUTE DOOR
A18	◆	◆	2	◆	C	◆	◆	◆	◆	3/0X7/0		◆		◆		◆	◆	◆		08	5		
A19					E	◆	◆	◆	◆														NEW HIGH SPEED DOOR
A20					D	◆	◆	◆	◆														NEW ROLL-UP DOOR
A21					D	◆	◆	◆	◆														NEW ROLL-UP DOOR
A22																							
A23					D	◆	◆	◆	◆														NEW ROLL-UP DOOR
A24																							
A25	◆	◆	2	◆	C	◆	◆	◆	◆	3/4X8/0		◆		◆		◆	◆	◆		08	6		
A26	◆	◆	2	◆	C	◆	◆	◆	◆	3/4X8/0		◆		◆		◆	◆	◆		08	6		
A27																							
A28																							
A29																							
A30																							
A31																							
A32																							

**ZONE "B"**


DR #	NEW LOCK SET	NEW DOOR	NEW ALARM SIGN	NEW EGRESS SIGN	DOOR TYPE	EGRESS REQUIRED	CARD READER	CARD READER	DOOR CONTACT	DOOR SIZE	EXIT ALARM	MAG LOCK	ELECT STRIKE	RX	REX	EMERGENCY EXIT BY MOTION SENSOR	EMERGENCY EXIT BY PUSH BAR	EMERGENCY EXIT BY PUSH BUTTON	INTERCOM	ANSI FUNCT.	HW SET #	CARD READER PROTECTION	NOTES
B1	◆	◆			G	◆	◆	◆	◆	6/0X8/0		◆		◆		◆	◆	◆		F20	7		1-HR WALL / 45 MINUTE DOOR
B2	◆	◆			G	◆	◆	◆	◆	6/0X8/0		◆		◆		◆	◆	◆		F20	7		1-HR WALL / 45 MINUTE DOOR
B3																							
B4	◆	◆	2	◆	C	◆	◆	◆	◆	3/0X8/0		◆		◆		◆	◆	◆		08	6		
B5																							
B6																							
B7																							
B8	◆	◆	2	◆	C	◆	◆	◆	◆	3/0X7/0		◆		◆		◆	◆	◆		08	6		
B9																							
B10																							
B11																							
B12	◆	◆	2	◆	C	◆	◆	◆	◆	3/0X7/0		◆		◆		◆	◆	◆		08	6		
B13																							
B14																							
B15	◆	◆	2	◆	C	◆	◆	◆	◆	3/0X7/0		◆		◆		◆	◆	◆		08	6		
B16	◆	◆	1 & 2	◆		◆	◆	◆	◆											01	8		
B17	◆	◆	1 & 2	◆		◆	◆	◆	◆											01	8		
B18																							IDS DOOR CONTACT W/ KEY PAD
B19																							IDS DOOR CONTACT

**NOTES:**

- REFER TO DRAWING FOR LOCATION OF DEVICES.
- ACCESS CONTROL IS PROVIDED FOR INFORMATION ONLY. REFER TO ELECTRICAL FOR COMPLETE ePACS INFORMATION. ELECTRICAL DRAWINGS SHALL GOVERN.
- THE EXISTING FACILITY KEYING SYSTEM SHALL BE MAINTAINED. IT IS THE CONTRACTOR RESPONSIBILITY TO INSURE THAT ALL NEW LOCKSETS ARE COMPATIBLE WITH THE EXISTING KEYING SYSTEM.

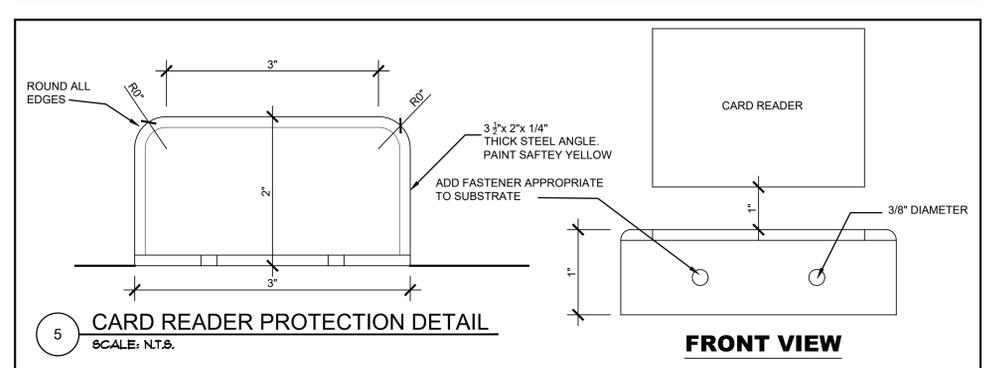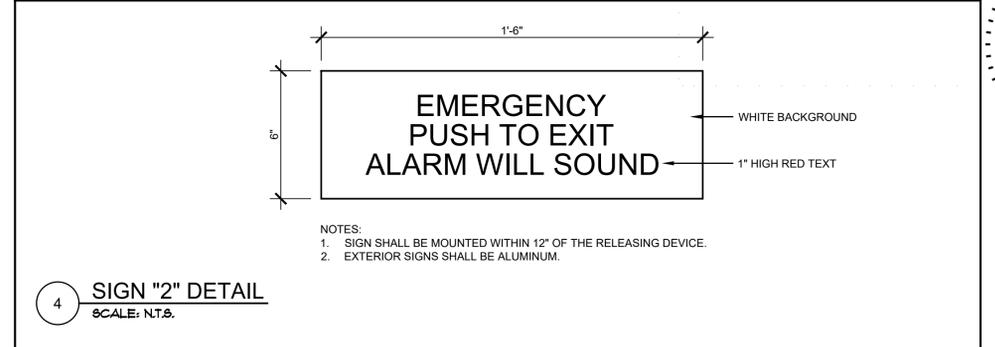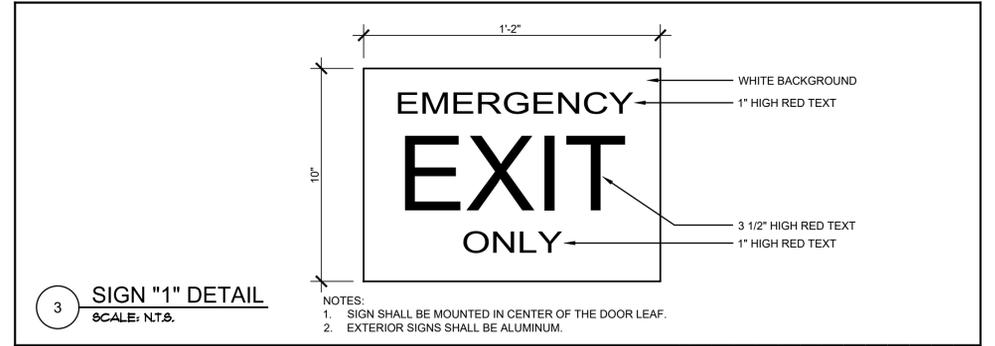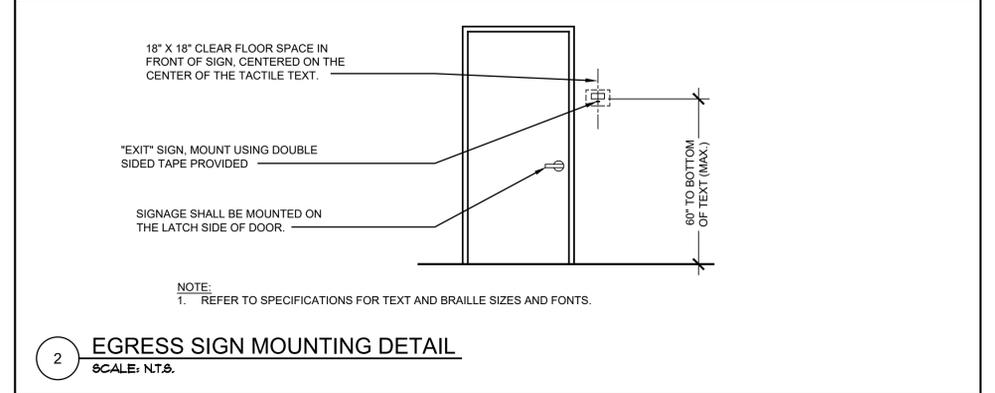

ANSI FUNCT.	NOTES
01	EXIT DEVICE: EXIT ONLY/NO TRIM
08	EXIT DEVICE: ENTRANCE BY LEVER, KEY (PULLSIDE) LOCKS/UNLOCKS LEVER.
14	EXIT DEVICE: NON-LATCHING: ENTRANCE BY PULL
F20	CLASSROOM LOCK: OUTSIDE LEVER LOCKED/UNLOCKED BY KEY. INSIDE LEVER ALWAYS FREE. DEADLOCKING LATCHBOLT.
F15	PASSAGE/ENTRY LOCK: DEADLOCKING LATCH BOLT BY INSIDE LEVER OR KEY OUTSIDE. OUTSIDE LEVER RIGID. DEAD BOLT BY TURN INSIDE OR KEY OUTSIDE. ROTATING INSIDE LEVER RETRACTS BOTH BOLTS.
F84	CLASSROOM LOCK: OUTSIDE LEVER LOCKED/UNLOCKED BY KEY. INSIDE LEVER ALWAYS FREE. DEADLOCKING LATCHBOLT.

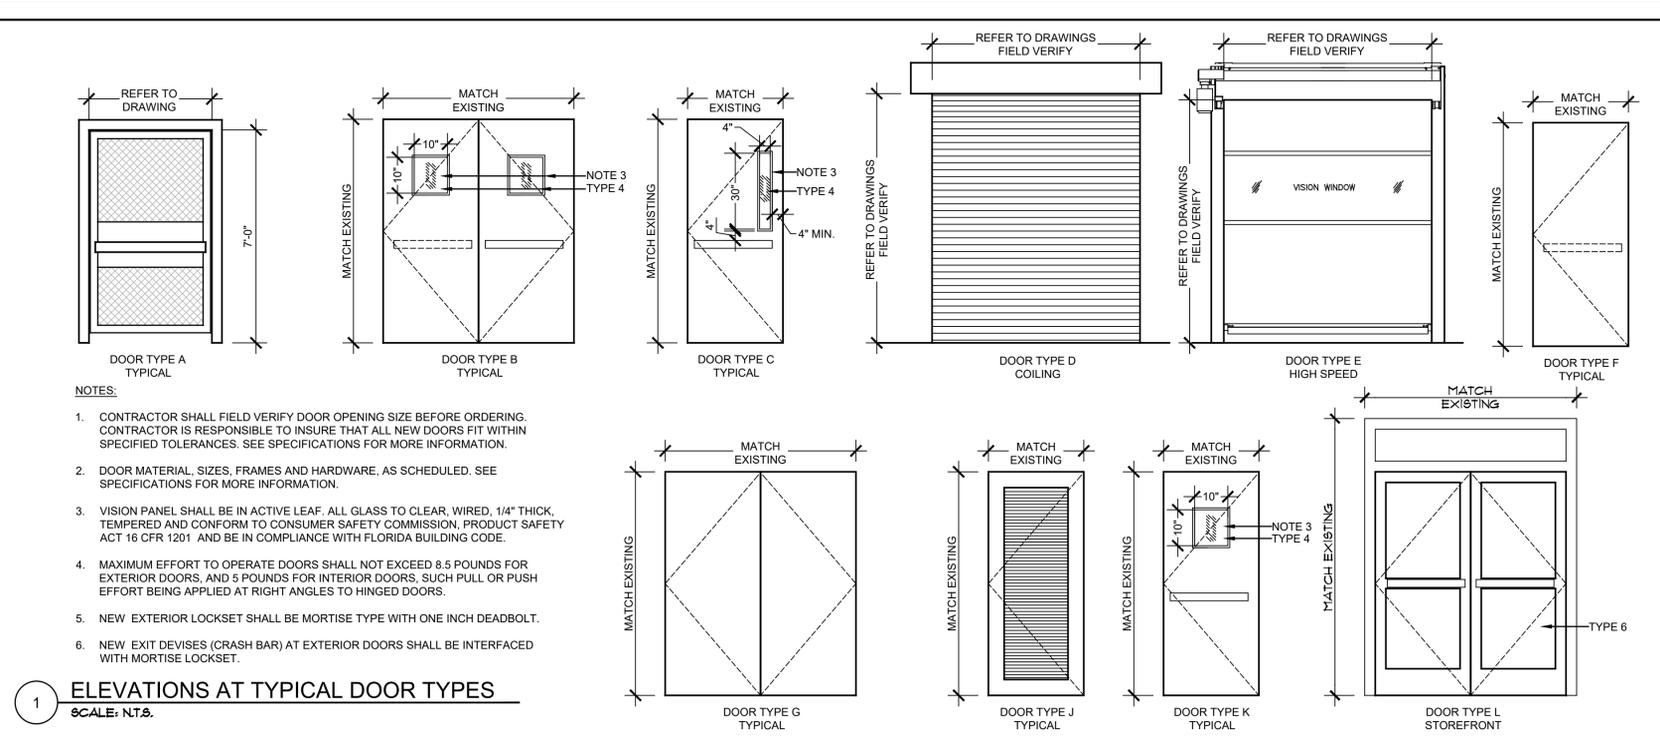

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Door Schedule

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**DOOR SCHEDULE FOR ACCESS CONTROL DEVICES**

**ZONE "C"**

DR #	NEW LOCK SET	NEW DOOR	NEW ALARM SIGN	NEW EGRESS SIGN	DOOR TYPE	EGRESS REQUIRED	CARD READER	CARD READER	DOOR CONTACT	DOOR SIZE	EXIT ALARM	MAG LOCK	ELECT STRIKE	RX	REX	EMERGENCY			INTERCOM	ANSI FUNCT.	HW SET #	CARD READER PROTECTION	NOTES
																EXIT BY MOTION SENSOR	EXIT BY PUSH BAR	EXIT BY PUSH BUTTON					
C1						♦			♦							♦	♦	♦					
C2							♦		♦														
C3	♦	♦			B	♦	♦		♦	6/8X7/8										08	9		1-HR WALL / 45 MINUTE DOOR / PASSAGE NON LOCKING.
C4	♦	♦	2		A	♦	♦		♦	4/0X7/0									♦	08	10		
C5	♦	♦				♦	♦																NEW TURNSTILE
C6	♦	♦				♦	♦																NEW TURNSTILE
C7	♦	♦			L	♦	♦													08	11		NEW STOREFRONT DOOR AND FRAME
C8	♦	♦			B	♦	♦			6/8X7/8									01	12			1-HR WALL / 45 MINUTE DOOR /W MAGNETIC DOOR HOLDS
C9	♦	♦			B	♦	♦			6/8X7/8									01	12			1-HR WALL / 45 MINUTE DOOR /W MAGNETIC DOOR HOLDS
C10			1 & 2	♦					♦														
C11									♦														
C12									♦														
C13									♦														
C14									♦														
C15	♦	♦			C	♦	♦		♦	3/0X7/0									♦	08	6		
C16	♦	♦			F	♦	♦		♦	3/0X7/0										F15	13		
C17						♦	♦		♦														
C18	♦	♦	2			♦	♦		♦											14	14		
C19	♦	♦	2			♦	♦		♦											08	15	♦	2-HR WALL / 90 MINUTE DOOR / PASSAGE NON LOCKING.
C20	♦	♦	2		K	♦	♦		♦	3/0X7/0													
C21						♦	♦		♦														
C22						♦	♦		♦														
C23						♦	♦		♦														
C24						♦	♦		♦														
C25						♦	♦		♦														
C26						♦	♦		♦														
C27						♦	♦		♦														♦
C28						♦	♦		♦														
C29						♦	♦		♦														
C30						♦	♦		♦														
C31						♦	♦		♦														
C32						♦	♦		♦														
C33						♦	♦		♦														♦
C34						♦	♦		♦														♦
C35						♦	♦		♦														
C36						♦	♦		♦														

**ZONE "D"**

DR #	NEW LOCK SET	NEW DOOR	NEW ALARM SIGN	NEW EGRESS SIGN	DOOR TYPE	EGRESS REQUIRED	CARD READER	CARD READER	DOOR CONTACT	DOOR SIZE	EXIT ALARM	MAG LOCK	ELECT STRIKE	RX	REX	EMERGENCY			INTERCOM	ANSI FUNCT.	HW SET #	CARD READER PROTECTION	NOTES	
																EXIT BY MOTION SENSOR	EXIT BY PUSH BAR	EXIT BY PUSH BUTTON						
D1	♦	♦	2		K	♦	♦		♦	3/0X7/0											08	15	♦	2-HR WALL / 90 MINUTE DOOR / PASSAGE NON LOCKING.
D2						♦	♦		♦															
D3						♦	♦		♦															
D4						♦	♦		♦															
D5						♦	♦		♦															
D6																								NOT USED
D7																								NOT USED
D8						♦	♦		♦															
D9						♦	♦		♦												F84	16	♦	2-HR WALL / 90 MINUTE DOOR / SIMILAR TO 08 BUT NON LOCKING.
D10	♦	♦	1 & 2		F	♦	♦		♦	3/0X7/0										01	17		2-HR WALL / 90 MINUTE DOOR	
D11	♦	♦	2			♦	♦		♦	3/0X7/0										08	6			
D12	♦	♦	1 & 2		C	♦	♦		♦											01	8			
D13	♦	♦	1 & 2			♦	♦		♦											01	8			
D14	♦	♦	1 & 2			♦	♦		♦											01	8			

**SITE**

DR #	NEW LOCK SET	NEW DOOR	NEW ALARM SIGN	NEW EGRESS SIGN	DOOR TYPE	EGRESS REQUIRED	CARD READER	CARD READER	DOOR CONTACT	IDS DOOR CONTACT	EXIT ALARM	MAG LOCK	ELECT STRIKE	RX	REX	EMERGENCY			INTERCOM	ANSI FUNCT.	HW SET #	CARD READER PROTECTION	NOTES	
																EXIT BY MOTION SENSOR	EXIT BY PUSH BAR	EXIT BY PUSH BUTTON						
S1							♦																	
S2																								
S3							♦		♦															NEW SLIDING GATE CONTROLLER
S4	♦	♦			A		♦		♦											♦	F84	18		

**NOTES:**

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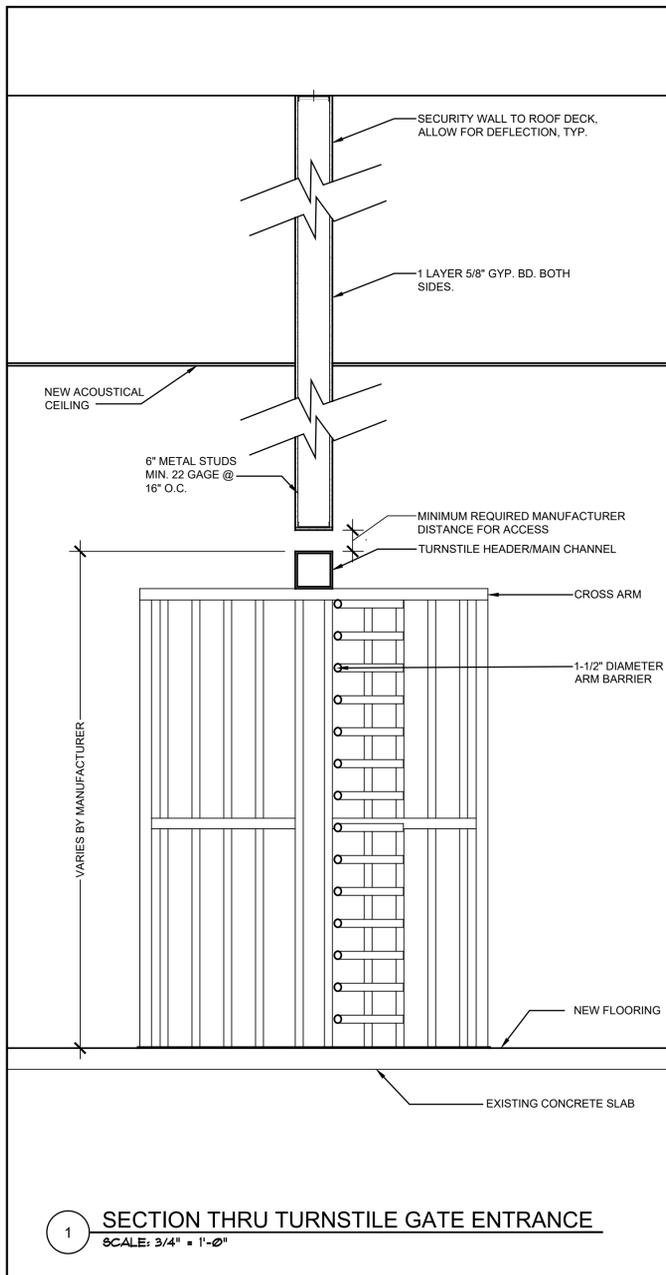


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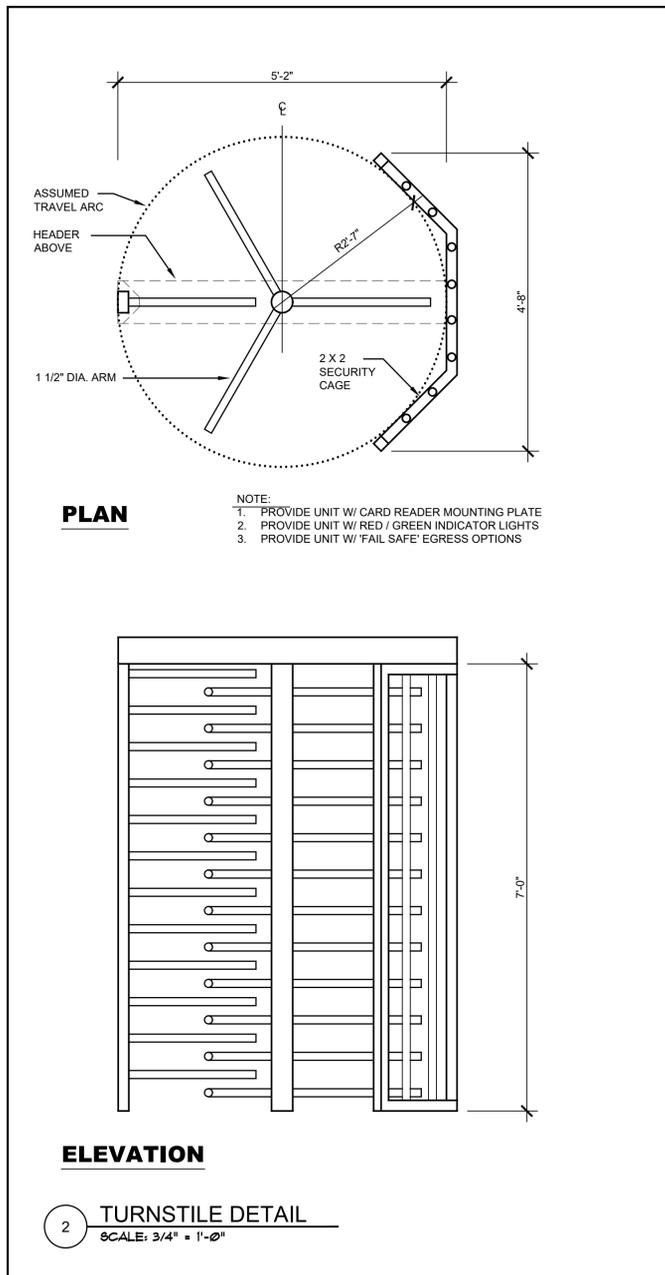
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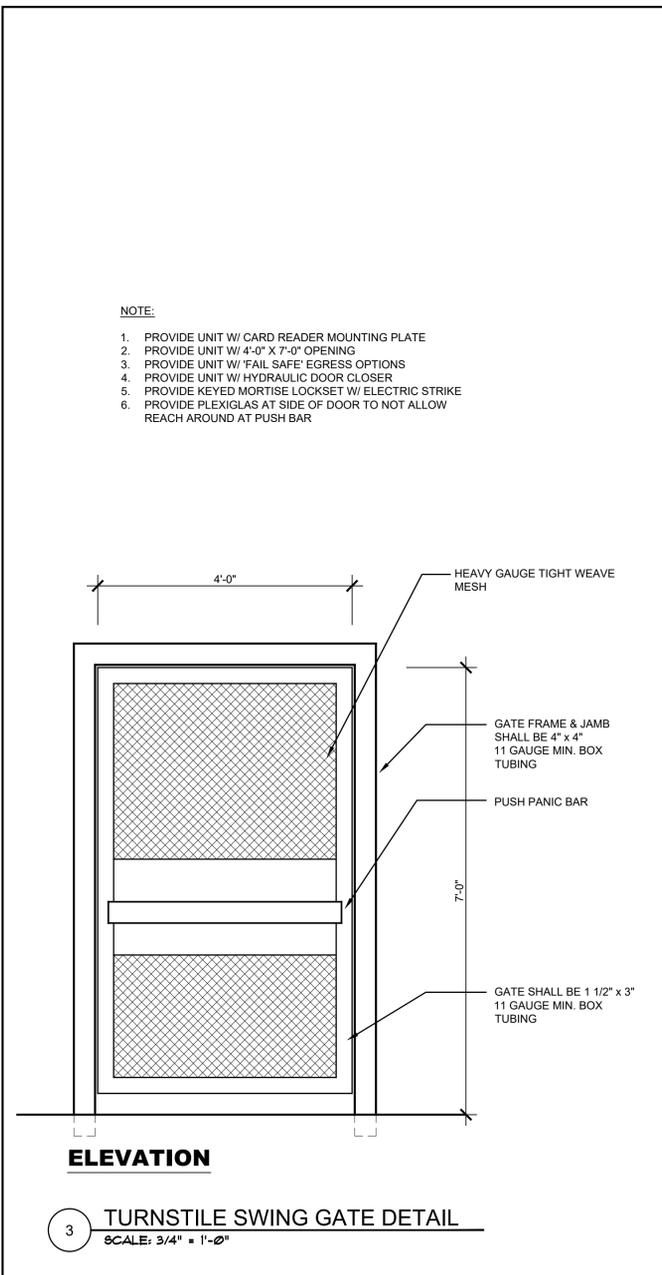
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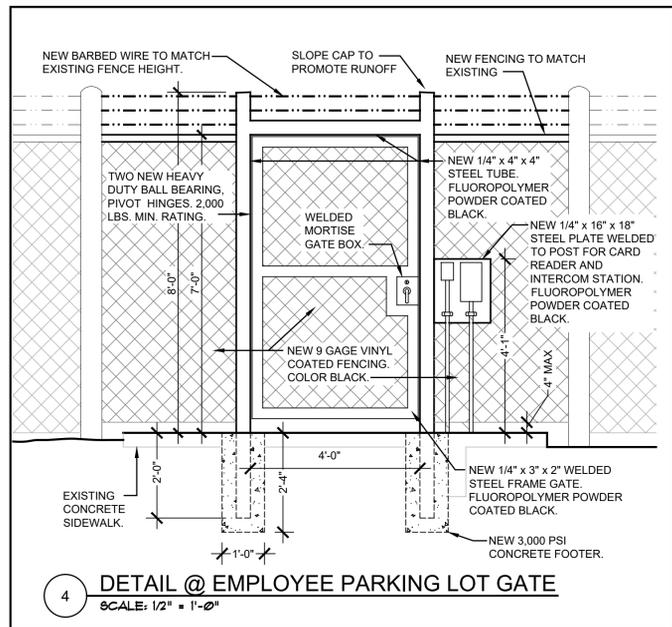
1 SECTION THRU TURNSTILE GATE ENTRANCE  
 SCALE: 3/4" = 1'-0"




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 SCALE: 3/4" = 1'-0"




3 TURNSTILE SWING GATE DETAIL  
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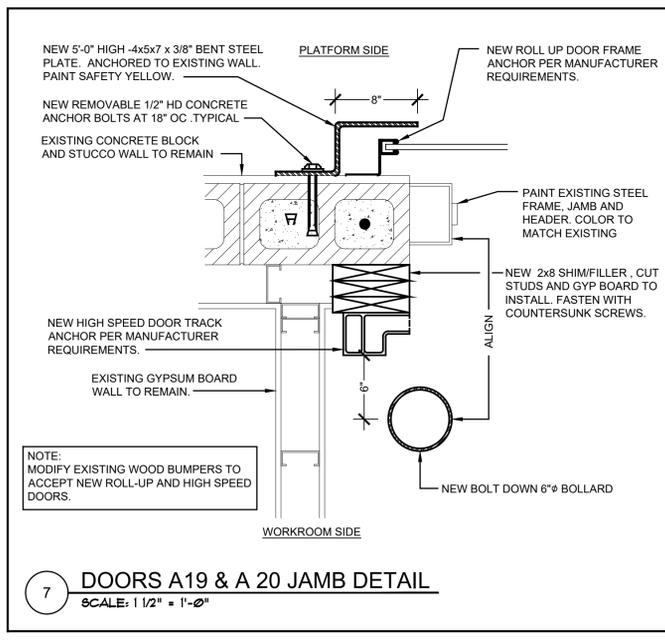
4 DETAIL @ EMPLOYEE PARKING LOT GATE  
 SCALE: 1/2" = 1'-0"




5 DOORS A19 & A20 HEAD DETAIL  
 SCALE: 1" = 1'-0"

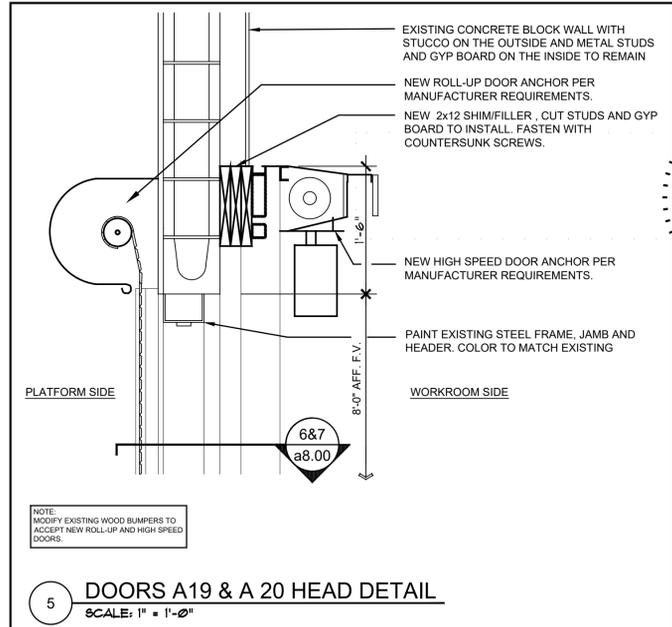


6 DOORS A19 & A20 JAMB DETAIL  
 SCALE: 1 1/2" = 1'-0"

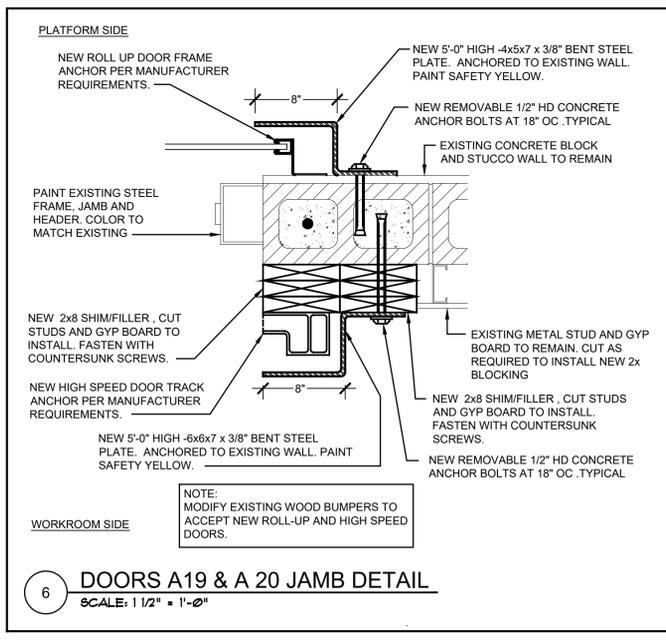

7 DOORS A19 & A20 JAMB DETAIL  
 SCALE: 1 1/2" = 1'-0"

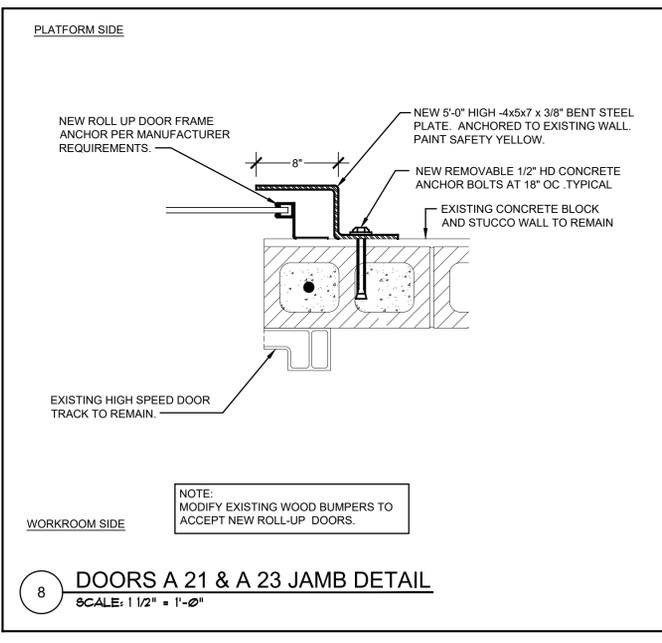

8 DOORS A21 & A23 JAMB DETAIL  
 SCALE: 1 1/2" = 1'-0"

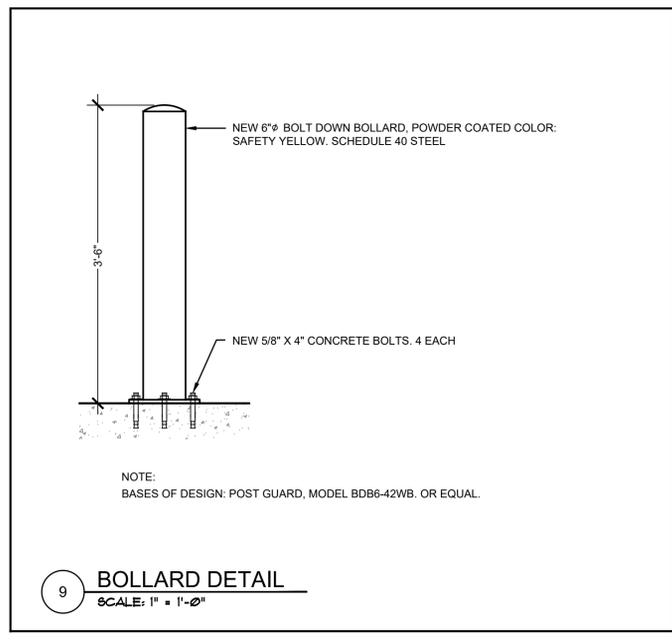

9 BOLLARD DETAIL  
 SCALE: 1" = 1'-0"

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