

Village of Bayside 9075 N Regent Road Architectural Review Committee Meeting February 8, 2021 Remote Teleconferencing, 6:00pm

ARCHITECTURAL REVIEW COMMITTEE AGENDA

PLEASE TAKE NOTE: Due to the COVID-19 Pandemic, the Architectural Review Committee will be meeting via remote conferencing at the above noted time and date, at which the following items of business will be discussed and possibly acted upon.

- I. CALL TO ORDER AND ROLL CALL
- II. APPROVAL OF MINUTES
 - **A.** Approval of December 7, 2020 meeting minutes.
- III. BUSINESS
 - A. 9458 N Regent Court Ryan and Dina Bruce The proposed project is the installation of a two level treehouse, including a cantilevered lookout platform, net and branch railings, and a roof. The structure will rest on a foundation of heliacal auger piers and traditional concrete footings. Cedar and pressure treated framing will be attached to black locust posts and rest atop exterior grade glulam beams.

Please review detailed plans here.

B. 1225 E Manor Circle – Susan Pfleger The proposed project is the conversion of an existing balcony into an enclosed Green Room. All materials for the exterior work will match existing details. The green room will be approximately 105 square feet.

Please review detailed plans here.

C. 290 W Fairy Chasm Road – Gina and Earl Klein The proposed project is the installation of a 24' x 52' above ground pool with a heater. The pool will be buried halfway in the ground. The pool will be surrounded by a deck and a 6 foot fence that will be made out of cedar wood.

Please review detailed plans here.

IV. ADJOURNMENT

Cassie Schmidt Deputy Clerk

The Architectural Review Committee will utilize Zoom video conferencing software for this meeting. To join the zoom meeting using a computer or tablet: https://us02web.zoom.us/j/81308667849?pwd=SWUyMjJvQjArZWk2cWlJMWRBelJpQT09

If using a telephone to dial in: 1-312-626-6799. The meeting id is: 813 0866 7849, password 857926.



Village of Bayside 9075 N Regent Road Architectural Review Committee Meeting Minutes December 7, 2020

CALL TO ORDER

Chairperson Marisa Roberts called the meeting to order via remote teleconferencing at 6:00pm.

II. ROLL CALL

Trustee Liaison:

Mike Barth

Chair:

Marisa Roberts

Members:

Elizabeth Levins

Dan Zitzer Tony Aiello John Krampf

Also Present:

Deputy Clerk Cassie Schmidt

There were 3 people in the audience.

III. APPROVAL OF MINUTES

A. Approval of November 9, 2020 meeting minutes.

Motion by Elizabeth Levins, seconded by Trustee Barth, to approve the November 9, 2020 meeting minutes. Motion carried unanimously.

IV. BUSINESS

A. 8916 N Tennyson Drive- Shantanu and Amanda Singh

Shantanu and Amanda Singh appeared on behalf of the project. Project architect, Dan Betla, was also in attendance. There were no neighbors in attendance.

Mr. Betla described the project as a 694 square foot master bedroom addition off the back of the home. There will be no front elevation change. Sliding doors and casement windows will be installed on the rear of the home, and the new roof will match the existing.

Motion by Trustee Barth, seconded by Elizabeth Levins, to approve the project as described and presented in the application. Motion carried unanimously.

V. ADJOURNMENT

Motion by Trustee Barth, seconded by Elizabeth Levins, to adjourn the meeting at 6:09pm. Motion carried unanimously.

Respectfully submitted,

Cassie Schmidt Deputy Clerk

Project Proposal

	Date Estimated Start Date: March 15	th 202	21
	Property Address 9458 N. Regent Ct. I	Baysid	e WI 53217
	Zoning B		
×	Accessory Structures/Generators		New Construction
	Additions/Remodel		Play Structures
	Bluff Management		Recreational Facilities/Courts
	Commercial Signage		Roofs
	Decks/Patios		Solar Panels/Skylights
	Fence		Swimming Pools
	Fire Pits		Windows/Doors-change exceeds 25% of opening
X	Landscaping requiring Impervious Surface/Fill/Excavation Permit		Other
pos	ed project details (type of work, size, materials,	etc	.):

Pro

The proposed project is a two level treehouse "accessory structure". This structure will include a cantilevered lookout platform, net and branch railings, and a roof. The total square footage of the roof is greater than 50ft2 therefore an application for impervious surface will also be submitted. The structure will rest on a foundation of heliacal auger piers and traditional concrete footings. Cedar and pressure treated framing will be attached to black locust posts and rest atop exterior grade glulam beams. Attachments will be made with hurricane clips where required. Additional attachment to existing trees done using treehouse tabs.

Yes	No	
		Color photographs showing project location, elevations and surrounding views
		Two (2) complete sets of building plans (including elevations and grading)
		Survey
		Samples or brochures showing materials, colors and designs
		Application Fee
		Parcel Number
		ARC Agenda Date:
		Building Permit
		Fill Permit
		Impervious Surface Permit
		Plan Commission/Conditional Use Permit
		Tax Key Number
		Right-of-Way/Excavation Permit
		Variance Required



01/25/2021

Attention:

Village of Bayside, WI

Architecture Review Committee

PROJECT/SITE OWNER:

Ryan Bruce

PROJECT ADDRESS:

9458 N. Regent Ct.

PROJECT SUMMARY: Treehouse accessory structure


VILLAGE CODE REVIEW

Reviewer believes the accessory structure (treehouse) complies with the following Village code section: 14-2(a)(2) Architectural Review Committee: Construction and renovation should be made so that exterior architectural appearance shall be substantially consistent with structures already constructed in the immediate neighborhood, or with the character of the applicable district.

Note: Plans submitted for review are approved

Tod Doebler Plan Reviewer 262-957-7414

tdoebler@safebuilt.com

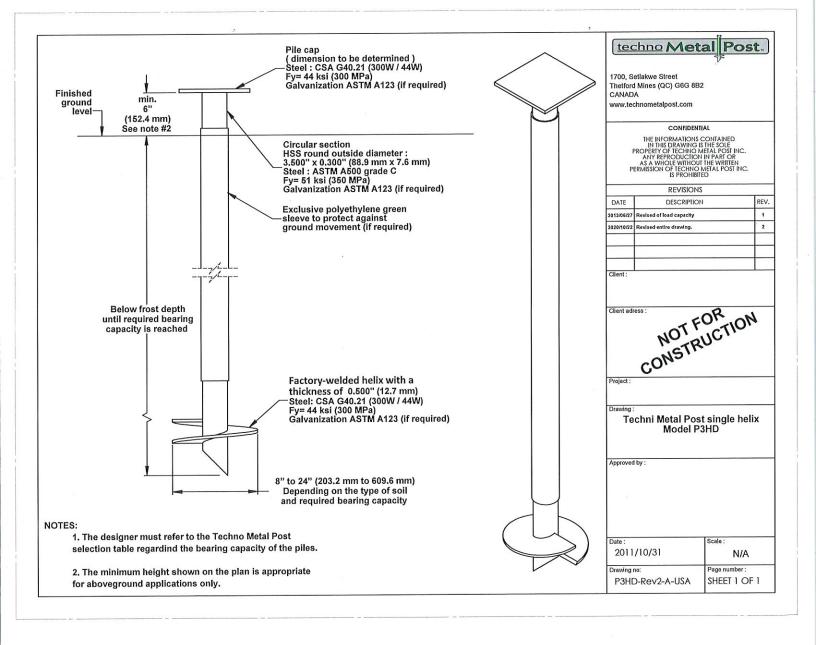




HELICAL PILES MODEL P3

Shaft	
Wall Thickness	0.216" (5.5 mm)
Round HSS Outside Diameter	3.5" (88.9 mm)
Available Standard Lengths	7'-0" (2.1 m) / 10'-6" (3.2 m)

Load Specifications	
Max. Installation Torque :	
with Regular and Expanded coupling	8,509 ft-lb (11,527 N-m)
with Reinforced coupling	11,000 ft-lb (14,902 N-m)
Max. Allowable Capacity*	29.8 kips (132.4 kN) to 33 kips (146.7 kN)


^{*} Higher load ratings could be considered with site-specific engineering.

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Heavy Residential
Light to Medium Commercial
Industrial
Listed per
ICC-ES (ESR-3418) / IAPMO-UES (ER-481)
ASTM A500 Grade C
Fy=51 ksi min (350 MPa)
50 years per AC358
Galvanized or Black Steel
ASTM A123/A123M
Cathodic Protection System available

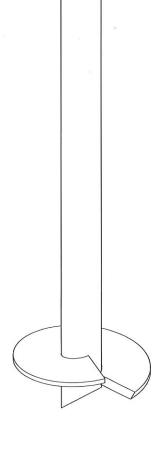

Helix	
Pitch	3" (76.2 mm) / 5" (127 mm)
Thickness	0.5" (12.7 mm)
Standard Steel	CSA G40.21-44W Fy=44 ksi min (300 MPa)
Coating	Galvanized or Black Steel
Multiple Welded Helix	Available
Helix Size*	8" (203 mm) to 24" (610 mm)

^{*} Other sizes available upon request.

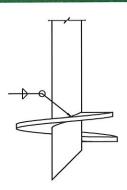




HELICAL PILES MODEL P3


Function Utility Protection against soil movements Wall Thickness 1/16" (1.6 mm) Round HSS Outside Diameter ± 3.75" (± 95.2 mm) Length ± 66" (± 1.67 m) Weight ± 1.5 lb (± 0.68 kg) Material HDPE Color Green

	0	0 0	0
	Regular	Reinforced	Expanded
Assembly	Welded	Welded	-
Wall Thickness	0.226" (6 mm)	0.226" (6 mm)	0.188" (4.8 mm)
Round HSS Outside Diameter	4" (102 mm)	4" (102 mm)	4" (102 mm)
Standard Steel	ASTM A500 Grade C Fy=51 ksi min (350 MPa)	ASTM A500 Grade C Fy=51 ksi min (350 MPa)	ASTM A500 Grade C Fy=51 ksi min (350 MPa)
Length*	3.5" (88.9 mm)	8.75" (222.3 mm)	2.5" (63.5 mm)

^{*} Length of outside coupling welded on-site.

Outside Couplings

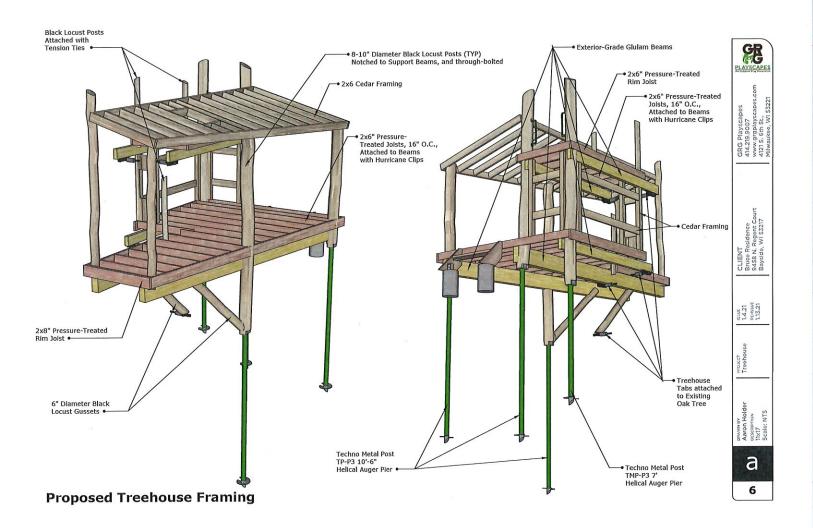

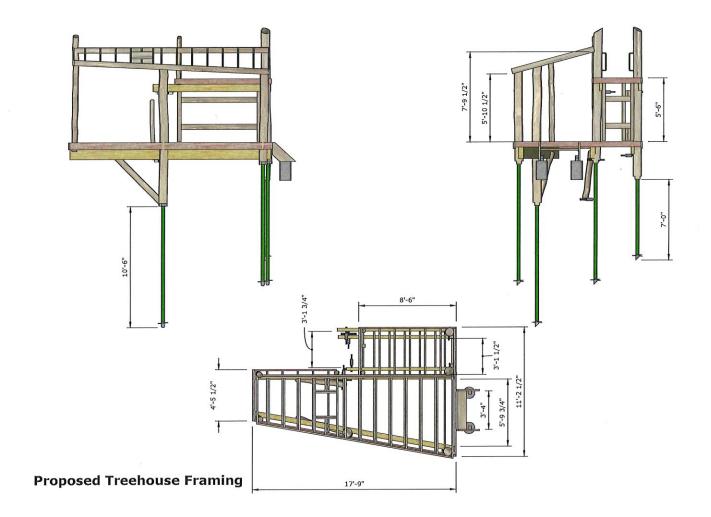

PLAYSCAPE

GRG Playscapes 414,219,9007 www.grgplayscapes.com

Bruce Residence 9458 N. Regent Court


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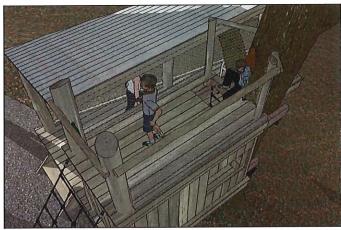
Aaron Holder
bescription
11x17
Scale: 1/4"=1'

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PLAYSCAPES


GRG Playscapes 414.219.9007 www.grgplayscapes.com 4121 S. 6th St., Milwaukee, WI 53221

CLIENT Bruce Residence 9458 N. Regent Court Bayside, WI 53217

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11x17
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GRG Playscapes 414.219.9007 www.grgplayscapes.com 4121 S, 6th St., Milwaukoe, WI 53221

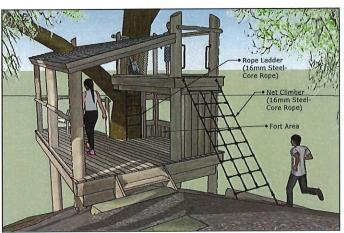
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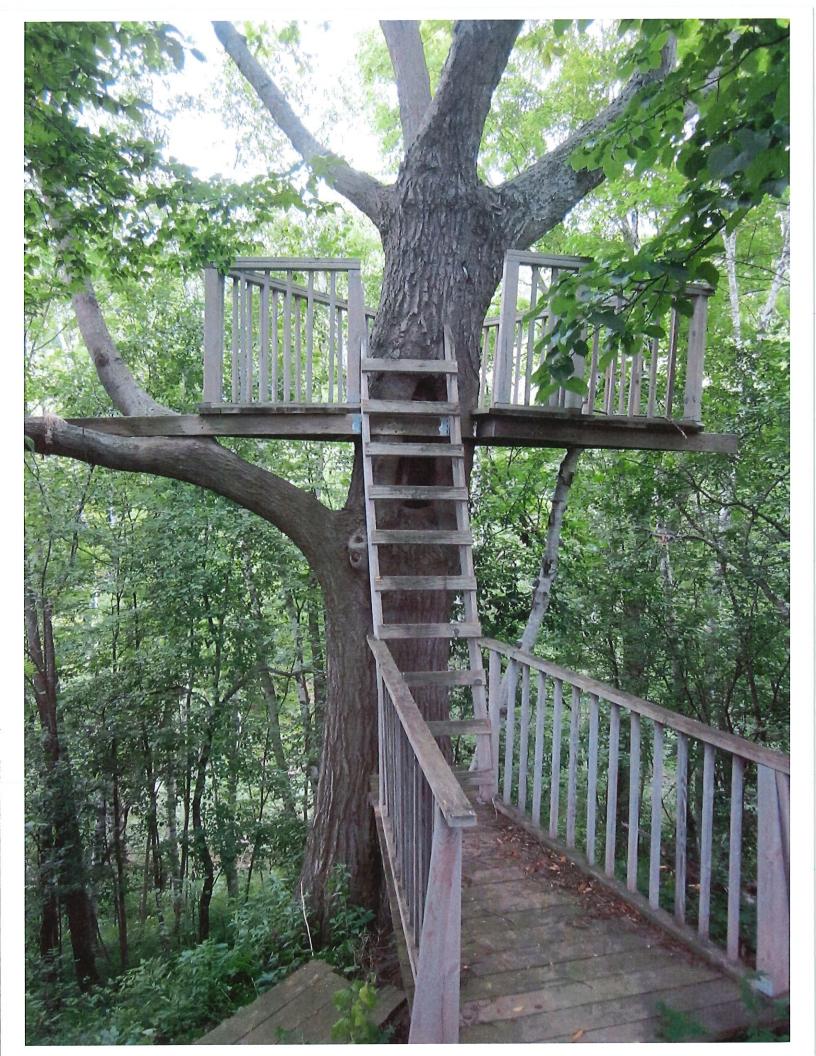
DRAWN UY Aaron Holder DESCRIPTION 11x17 Scale: NTS


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Proposed Treehouse

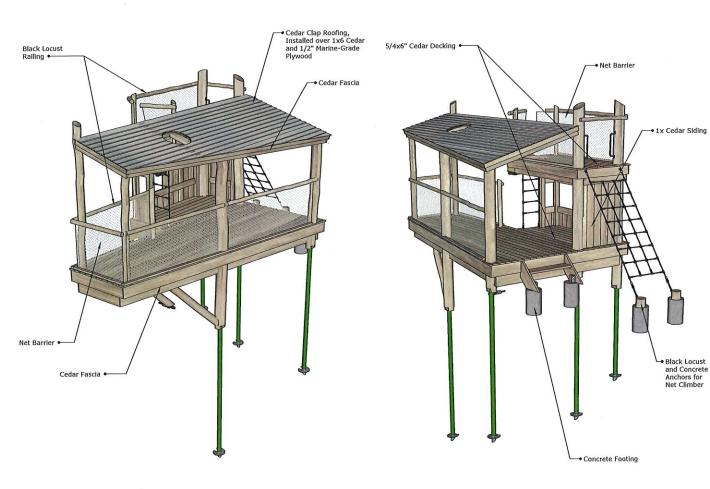



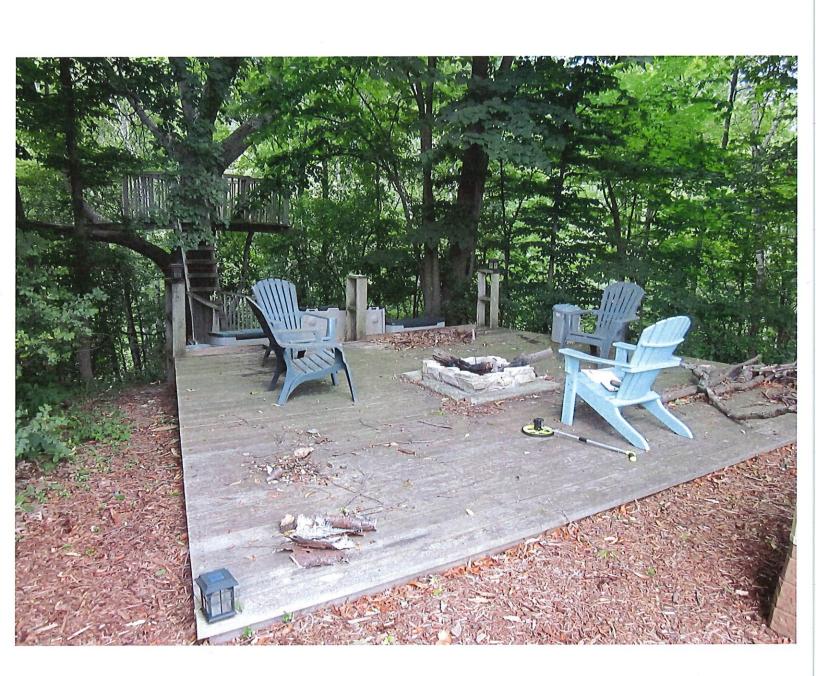

rows Mr. Dave Sice
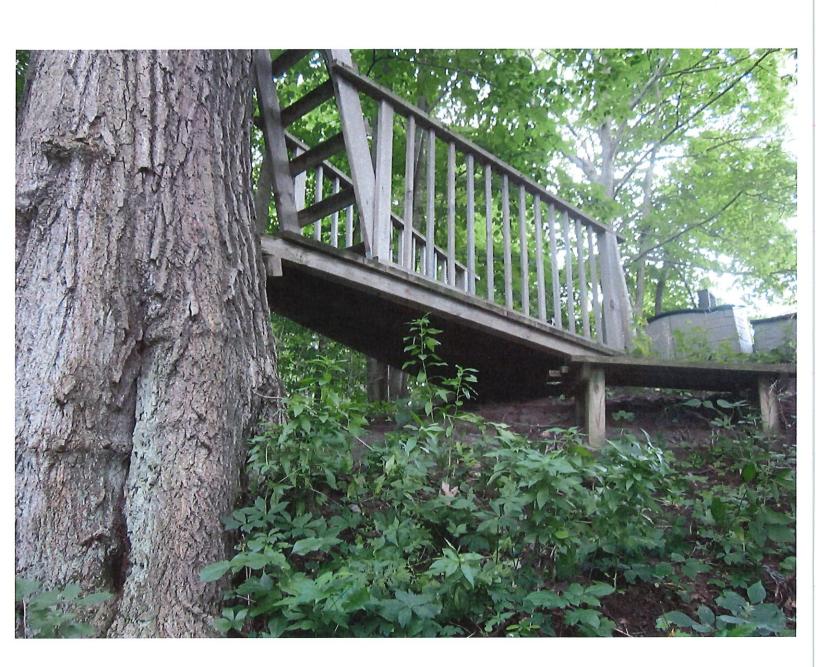
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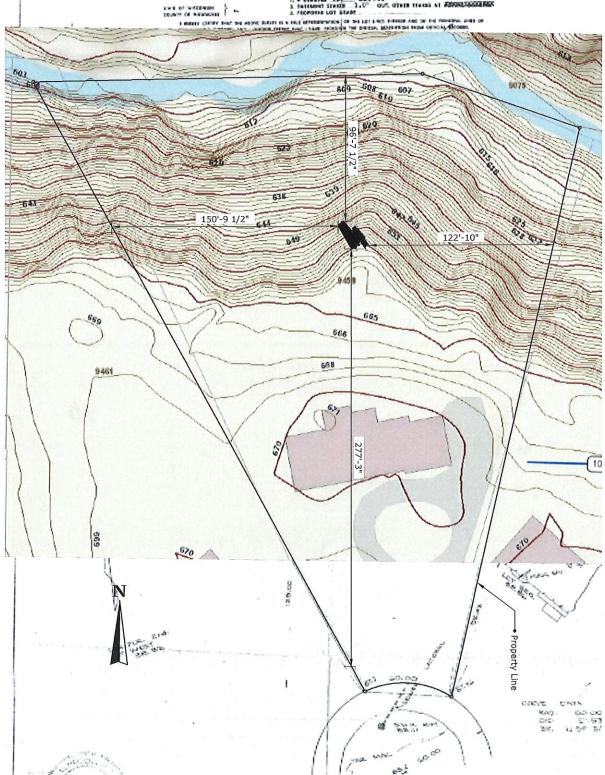
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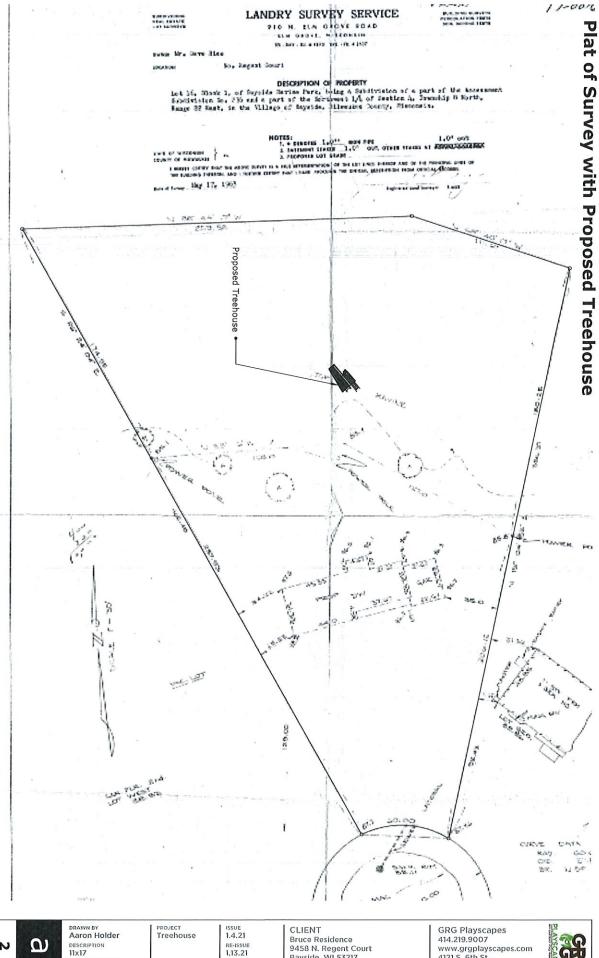
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Project Proposal

	Date 1. LL. LI		
	Property Address 1225 E.	Ma	nor circle
	Zoning		
	Accessory Structures/Generators		New Construction
×	Additions/Remodel		Play Structures
	Bluff Management		Recreational Facilities/Courts
	Commercial Signage		Roofs
	Decks/Patios		Solar Panels/Skylights
	Fence		Swimming Pools
	Fire Pits		Windows/Doors-change exceeds 25% of opening
	Landscaping requiring Impervious Surface/Fill/Excavation Permit		Other

Proposed project details (type of work, size, materials, etc.):

Converting an existing balcony into an enclosed Green Room. All Materials for the exterior work - Roof/trim/siding/etc. to mutch existing details. Project is about 105 SQ.FT.

Yes	No	
		Color photographs showing project location, elevations and surrounding views
		Two (2) complete sets of building plans (including elevations and grading)
		Survey
		Samples or brochures showing materials, colors and designs
		Application Fee
		Parcel Number
	Q	ARC Agenda Date:
		Building Permit
		Fill Permit
		Impervious Surface Permit
		Plan Commission/Conditional Use Permit
		Tax Key Number
		Right-of-Way/Excavation Permit
		Variance Required



01/26/2021

Attention:

Village of Bayside, WI Architecture Review Committee

PROJECT/SITE OWNER:

Mr. & Mrs. Gruendyke

PROJECT ADDRESS:

1225 E. Manor Circle

PROJECT SUMMARY:

Enclose existing balcony to a green house

VILLAGE CODE REVIEW

Reviewer believes the accessory structure (green house) complies with the following Village code section: 14-2(a)(2) Architectural Review Committee: Construction and renovation should be made so that exterior architectural appearance shall be substantially consistent with structures already constructed in the immediate neighborhood, or with the character of the applicable district.

Note: Need structural analysis before issuance of building permit Shall follow all applicable State Codes

Tod Doebler

Plan Reviewer 262-957-7414 tdoebler@safebuilt.com

NOTICE:

SHEET INDEX, PROPOSED EXTERIOR PERSPECTIVES, HOTES

DEHO FLAN PROPOSED FLOOR FLAN ELECTRICAL FLAN NOTES

SHEET INDEX:

SHEET 4 NITERIOR ELEVATION & PERSPECTIVES PROPOSED BUILDING SECTION NO

SHEET 2

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STAN GRADE MATERIAL TO BE INSTALLED - VERFY WITH OWNER/DESIGNER

BASE - TO MATCH EXISTING - VERIFY W/ OWNER CASING - TO MATCH EXISTING - VERIFY W/ OWNER

FNISH CARPENTER TO CONFIRM ALL DETAILS WITH DESIGNER PRIOR TO INSTALLATION

INSULATION CORBOND FOAM - PER CODE REQUIREMENTS

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residential design-build

11124 north cedarburg road suite #350 meauon, wisconsin 53091 (262) 238-0774 feindesigns.com

CONTACTS

RORY

cell: (414) 881 - 1936

CATIE

cell: (262) 483 - 4342

REMODEL

PROPOSED

PPLEGER RESIDENCE 225 E MAYOR GIRCLE BAYONE GIRCLE BAYONE WINCOWN THE

> date : Øl. 25. 2021 revisions:

project numbe 2106

sheet number


1 of 4





EXTERIOR PERSPECTIVES

NOT TO SCALE - FOR CONCEPTUAL DESIGN PURPOSES ONLY

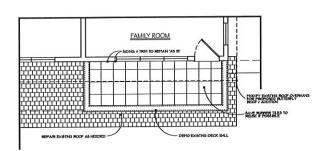

NOTE: CABNET HAKER TO REVEW ELECTRICAL PLAN I POOFY CABNETRY AS NECESSARY FOR SUTICES & OUTLETS

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CONTACTS
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CATIE

cell: (262) 483 - 4342

proposed construction drawings for :
THE PFLEGER RESIDENCE
THE DATABLE MACAGE
THE PAYABLE MICHAGEN

REMODEL

PROPOSED


PROPOSED DEMO PLAN


SCALE - 1/4" = 1'-0"

NOTE:
BUILDER TO VERIFY ANY DISCREPANCIES
WITH DENO PLAN 1 FLOOR PLAN
WITH DESIGNER / OWNER



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ď	OUTLET (verify GFI / switched)
\$	SWITCH (verify dimmer)

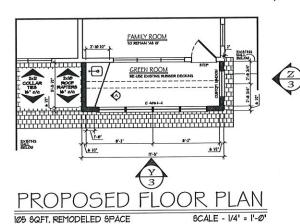

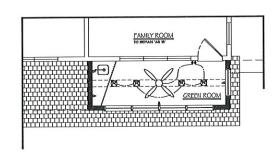

PROPOSED ELECTRICAL PLAN

SCALE - 1/4" = 1'-0"

© DRAWNS COPYRIGHT TO FEN DESKIN, LLC

2106

date : Øl. 25. 2021 revisions :

sheet number

2 of 4







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CONTACTS RORY cell: (414) 881 - 1936 CATIF cell: (262) 483 - 4342

REMODEL proposed construction drawings for:
THE PFLEGER RESIDENCE
TO BE THANK CITCLE
DATABLE, MICHONISM PROPOSED

date : Øl. 25. 2021 revisions :

project numbe 2106

sheet number


3 of 4

EXISTING REAR ELEVATION

SOUTHUESTERN FACING SCALE - 1/8" • 1'-9"

EXISTING SIDE ELEVATION SCALE - 1/8" : 1'-0"



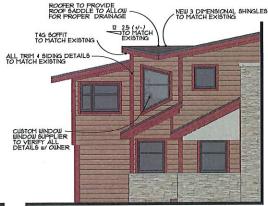




PROPOSED SIDE ELEVATION SOUTHEASTERN FACING


SCALE - 1/4' = 1'-0'


SCALE - 1/4' = 1'-0'

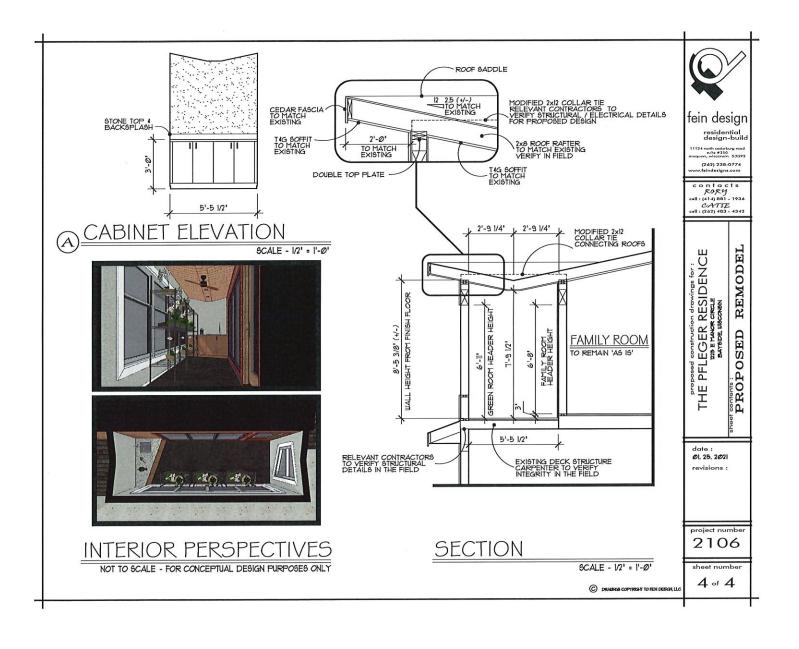





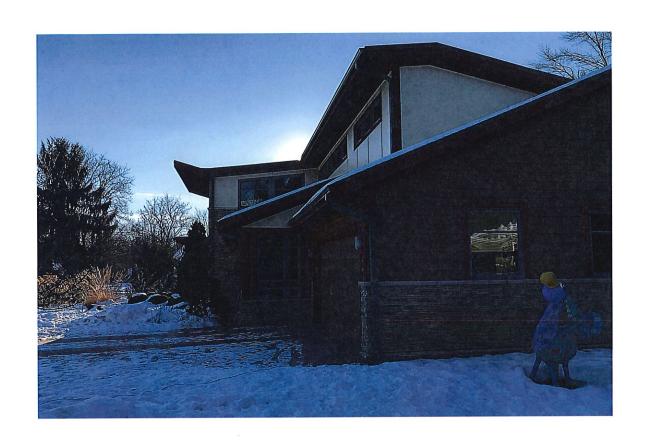

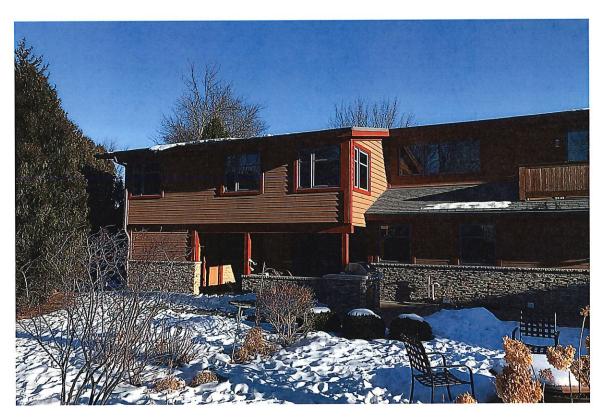
















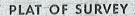

LOT 10 - BLOCK 4 - BAY SIDE SUBDIVISION

A SUBDIVISION IN THE SOUTHEAST 1/4 OF SECTION 4, TOWN 8 NORTH, RANGE 22 EAST, IN THE CITY OF MILWAUKEE, COUNTY OF MILWAUKEE, STATE OF WISCONSIN.

LOCATED AT: 1225 EAST MANOR CIRCLE

MEADOW LARK LANE

14.86-

79.283 MCBIL 133.50 SCALE 1"=20"

ALLAGE OF BAYSIDE

7616 HARWOOD AVE. WAUWATOSA, WIS.

Surveyed and Drawn by WALTER J. CONNELL, INC. Civil Engineer and Surveyor

BLUEMOUND 8-1380

SURVEYED FOR


EARL JANIKOWSKY

WE CERTIFY that we have surveyed the above described property and that the above plat is an accurate survey and a true representation thereof and correctly 1225 East Manor Circlenows the exterior boundary lines and location of buildings and other improve-Milwaukee, Wisconsin ments on said property and the correct measurements thereof.

Date August 3, 1956

- STATE OF WISCONSIN DOWN REGISTERED PROFESSIONAL ENGINEER NO. 655 -

Job No. 20-9490

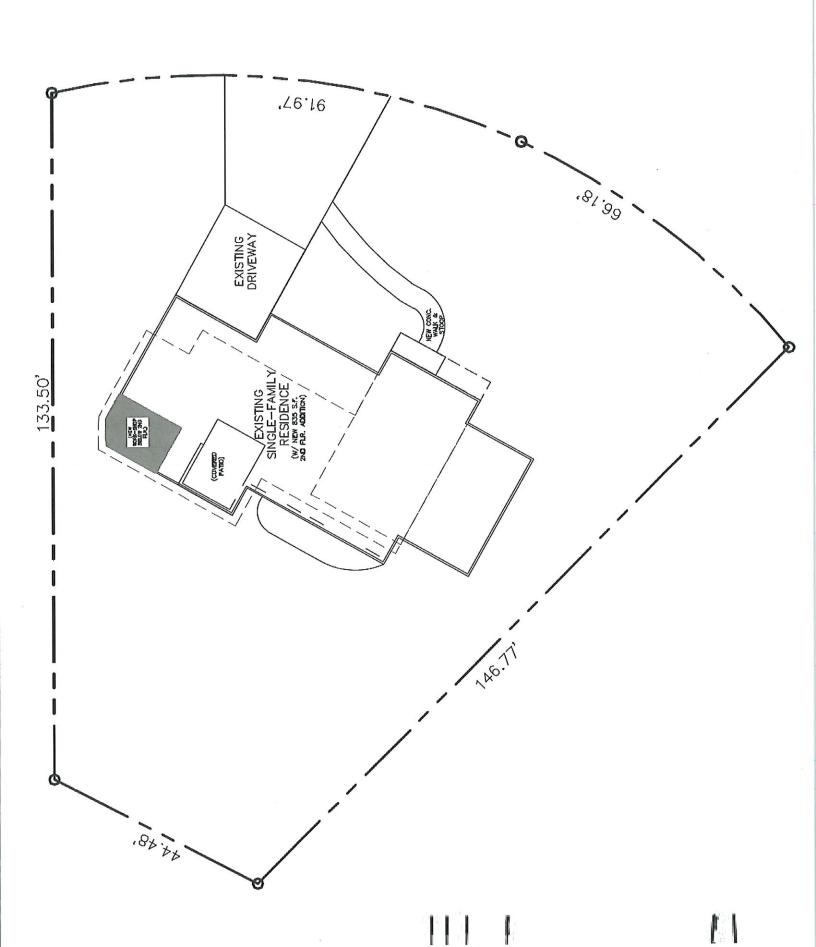

Property Address 290 W. Fair & Chas M Rd Zoning □ New Construction □ Accessory Structures/Generators Play Structures □ Additions/Remodel ☐ Recreational Facilities/Courts Bluff Management ☐ Roofs □ Commercial Signage □ Solar Panels/Skylights Decks/Patios Swimming Pools ☑ Fence ☐ Windows/Doors-change exceeds 25% of ☐ Fire Pits opening □ Landscaping requiring Impervious □ Other Surface/Fill/Excavation Permit Proposed project details (type of work, size, materials, etc.): ******* For Office Use Only ********** No Yes Color photographs showing project location, elevations and surrounding views Two (2) complete sets of building plans (including elevations and grading) Survey Samples or brochures showing materials, colors and designs Application Fee Parcel Number ARC Agenda Date: **Building Permit** Fill Permit Impervious Surface Permit Plan Commission/Conditional Use Permit Tax Key Number Right-of-Way/Excavation Permit

Variance Required

Project Proposal



01/26/2021

Attention:

Village of Bayside, WI Architecture Review Committee

PROJECT/SITE OWNER:

Mr. & Mrs. Klein

PROJECT ADDRESS:

290 W. Fairy Chasm

PROJECT SUMMARY:

Swimming pool with deck and surrounding

fence

VILLAGE CODE REVIEW

Reviewer believes the accessory structure (pool with fence) complies with the following Village code section: 14-2(a)(2) Architectural Review Committee: Construction and renovation should be made so that exterior architectural appearance shall be substantially consistent with structures already constructed in the immediate neighborhood, or with the character of the applicable district.

Note: They must comply with Sec. 104-126 of the Municipal Ordnance.

Need sample of the new fencing material, style and material

Shall follow all applicable State Codes


Tod Doebler

Plan Reviewer 262-957-7414 tdoebler@safebuilt.com







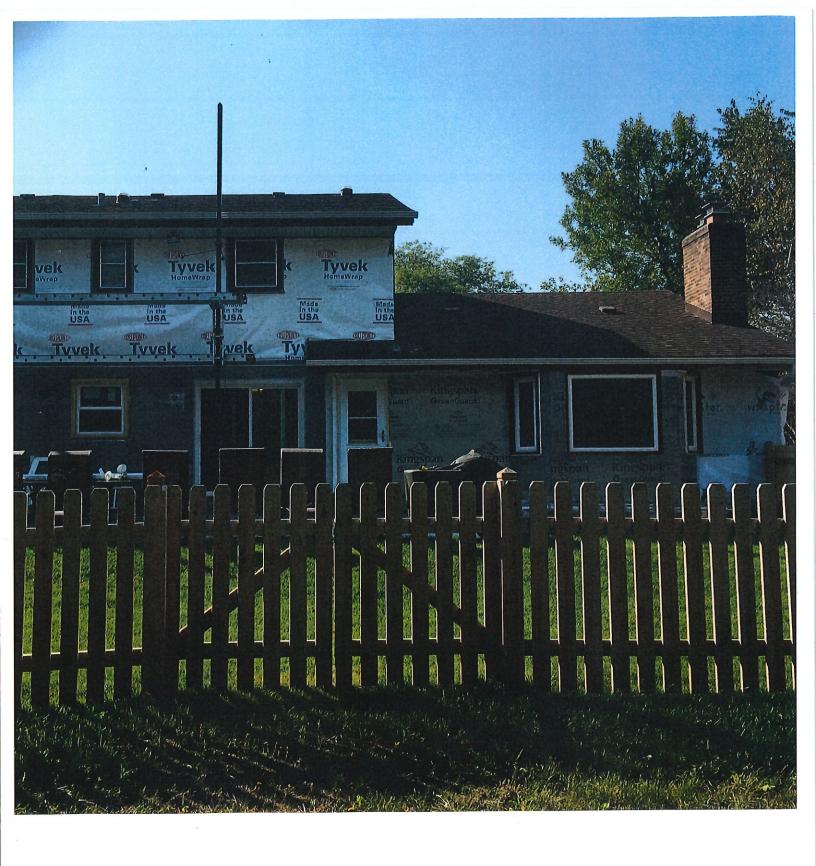





Plat of Survey

16-0162

Known as West Fairy Chasm Road, in the Village of Bayside, Wisconsin Lot 2 in Block 5 in NORTH SHORE EAST ADDITION NO. 1, being a Subdivision of a part of the NE 1/4 of Section 5, T S N, R 22 E, in the Village of Bayside, Milwaukee County, Wisconsin

JUNE 29, 1977 ·

MAY AND STU HIRSCHBEIN-OWNER

SURVEY NO. 141027-S REVISION NO. 1

