

# CITY OF BELMONT BELMONT COMMUNITY RECREATION CENTER

1401 CATAWBA STREET  
BELMONT, NORTH CAROLINA

## SCHEMATIC DESIGN



### CONSTRUCTION MANAGER



EDIFICE  
4111 SOUTH BLVD  
CHARLOTTE, NC 28209

### STRUCTURAL ENGINEERS




MMSA  
30 PATEWOOD DR  
#100  
GREENVILLE, SC 29615

### CIVIL ENGINEERS



ALFRED BENESCH & COMPANY  
2359 PERIMETER POINTE PARKWAY  
SUITE 350  
CHARLOTTE, NC 28208

### M/E/P ENGINEERS

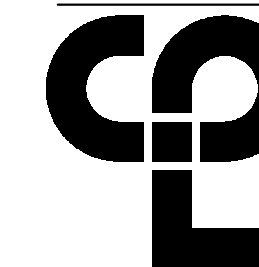


CPL  
912 S MAIN ST  
SUITE 1  
GREENVILLE, SC, 29601

### OWNER




CITY OF BELMONT  
123 STREET NAME RD.  
CITY, ST 12345

### ARCHITECT

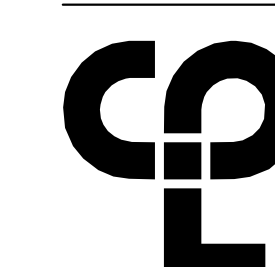

CPL  
6302 FAIRVIEW RD,  
SUITE 102  
CHARLOTTE, NC 28210  
T. 800.274.9000  
CPLteam.com

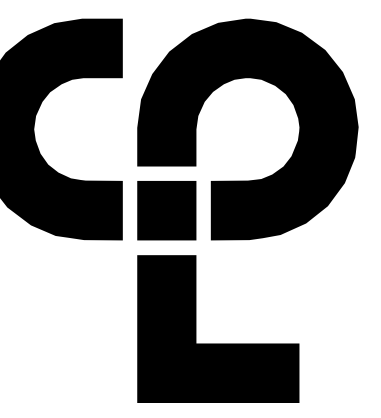

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6302 FAIRVIEW RD, SUITE 102  
CHARLOTTE, NC 28210  
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#### PROJECT INFORMATION

Project Number:  
15651.00  
Client Name:  
CITY OF BELMONT

Project Name:  
BELMONT COMMUNITY  
RECREATION CENTER

Project Address:  
1401 CATAWBA STREET  
BELMONT, NORTH CAROLINA

#### REVISION SCHEDULE

1 Date Description

**FOR REVIEW ONLY  
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CONSTRUCTION**

#### SHEET INFORMATION

Issue:  
07/26/2020  
SCHEMATIC DESIGN  
Drawn By: EAM Checked By: DMS  
Drawing Title: COVER





Seals:  
  
PRELIMINARY  
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CONSTRUCTION


Corp. NC license: F-1320

**Belmont Community Center**  
1401 Catawba Street  
Belmont, North Carolina


Project no: 17.000385  
Date: 09.03.20  
Revisions:



Sheet Title:  
**OVERALL  
SITE PLAN**

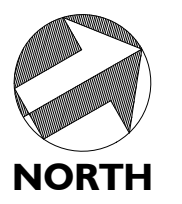

Sheet No:  
**C100**

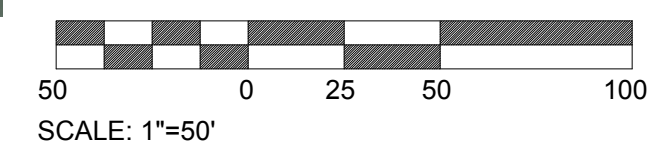





**SITE DEVELOPMENT DATA**

PROJECT NAME: BELMONT COMMUNITY RECREATION CENTER  
 PROJECT ADDRESS: 1401 CATAWBA STREET, BELMONT, NC 28012  
 OWNER: CITY OF BELMONT PHONE # 704 901-2067  
 PLANS PREPARED BY: BENESCH PHONE # 704-521-9880  
 ZONING: IC-D JURISDICTION: CITY OF BELMONT  
 PROPOSED USE: RECREATION CENTER TAX PARCEL #: 222095  
 WATERSHED DISTRICT: WS-IV-CA  
 BUILDING HEIGHT: 45' 8" Feet, Stories: 2  
 BUILDING COVERAGE: 33,959 Sq. Ft. GROSS FLOOR AREA: 42,025 Sq. Ft.  
 LOT SIZE: 4.5 Sq. Ft./Acres

**YARD REQUIREMENTS:**  
 Setback (front): 25 Ft. from R/W,  
 Side Yard (L): 25 Ft. Side Yard (R): 25 Ft.  
 Rear Yard: 25 Ft.  
**REQUIRED BUFFERS:**  
 Front: NO / YES \_\_\_ Ft. Rear: NO / YES \_\_\_ Ft.  
 Side (L): NO / YES \_\_\_ Ft. Side (R): NO / YES \_\_\_ Ft.  
**REQUIRED SCREENING:**  
 Front: NO / YES \_\_\_ Ft. Rear: NO / YES \_\_\_ Ft.  
 Side (L): NO / YES \_\_\_ Ft. Side (R): NO / YES \_\_\_ Ft.  
 Parking, Dumpster & Utilities Only: NO / YES \_\_\_ Ft.

**VEHICLE PARKING DATA:**  
 EXISTING PARKING: 81 SP, includes: 3 accessible sp.  
 NET LOSS W/ PARKING LOT TIE IN: -3 SP.  
 PROPOSED PARKING: 106 SP, includes: 4 accessible sp.  
 TOTAL: 184 SP, includes: 7 (2 van sp.)

ALL SIGNAGE WILL BE APPROVED AND PERMITTED SEPARATELY.  
**PROJECT TIMETABLE:**  
 PERMITTING: FEBRUARY 2, 2021 - APRIL 29, 2021  
 CONSTRUCTION BALANCE OF WORK BEGINS: APRIL 30, 2021  
 CONSTRUCTION COMPLETE: JUNE 15, 2022





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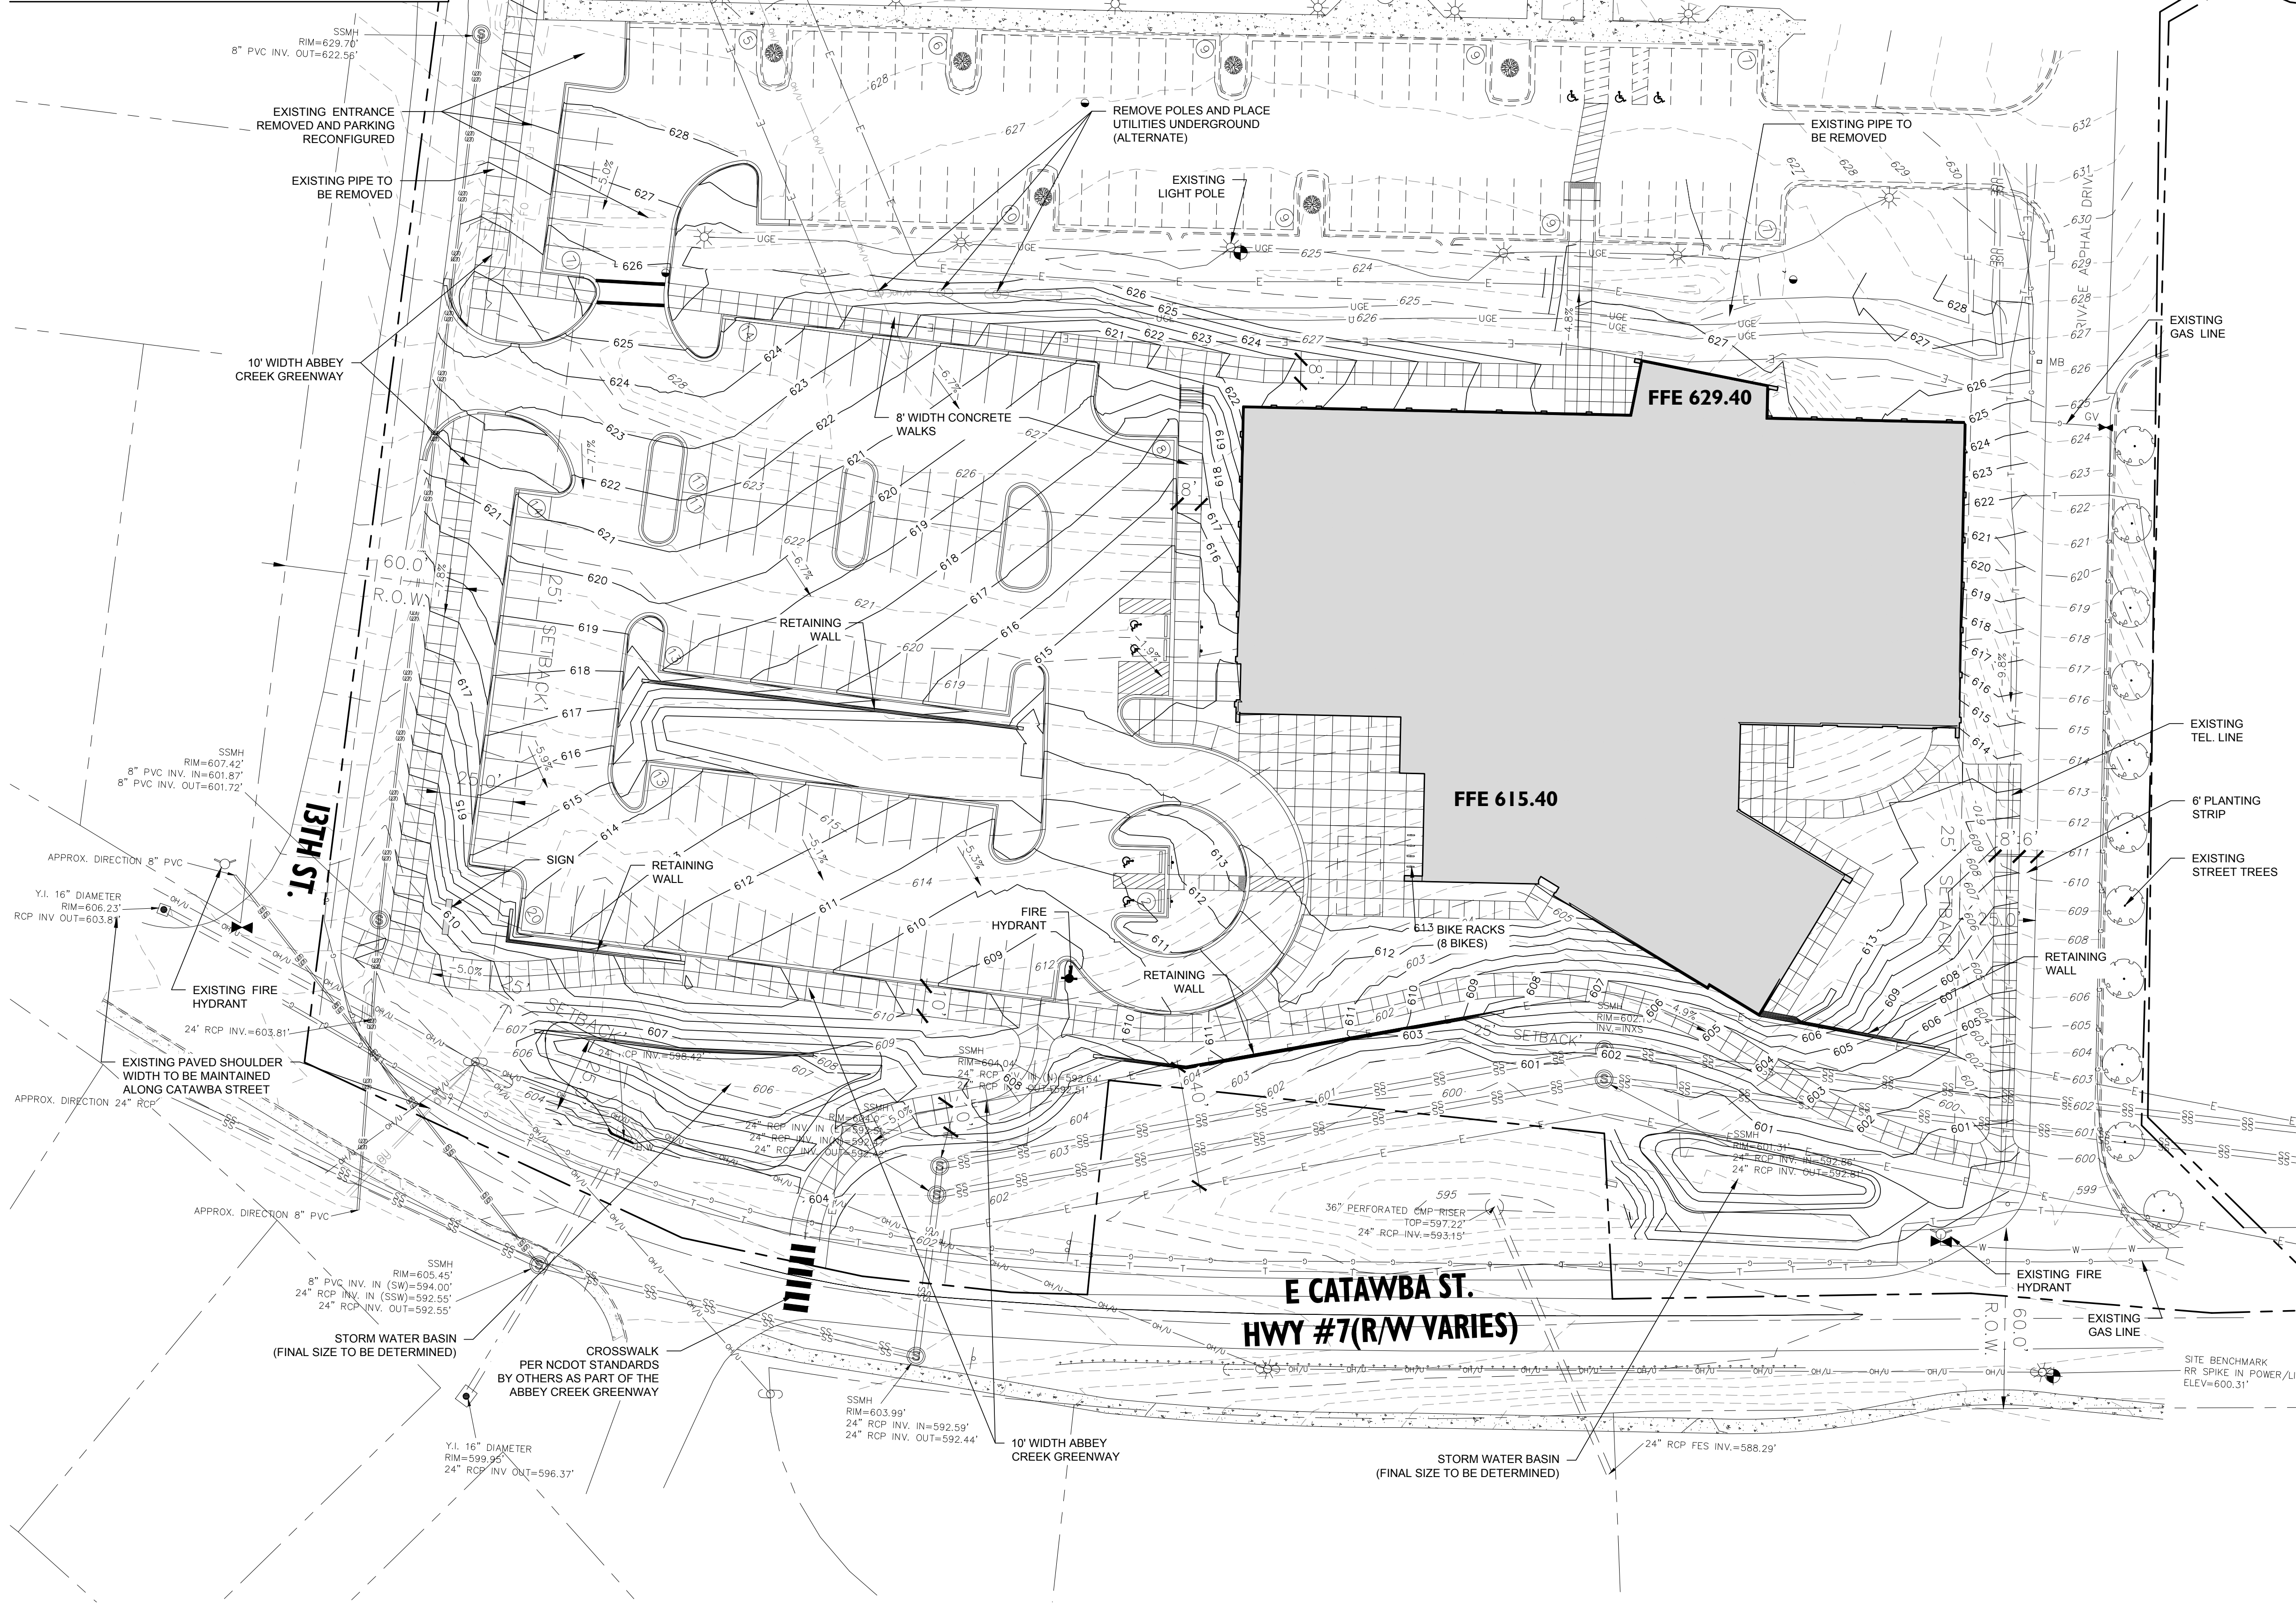
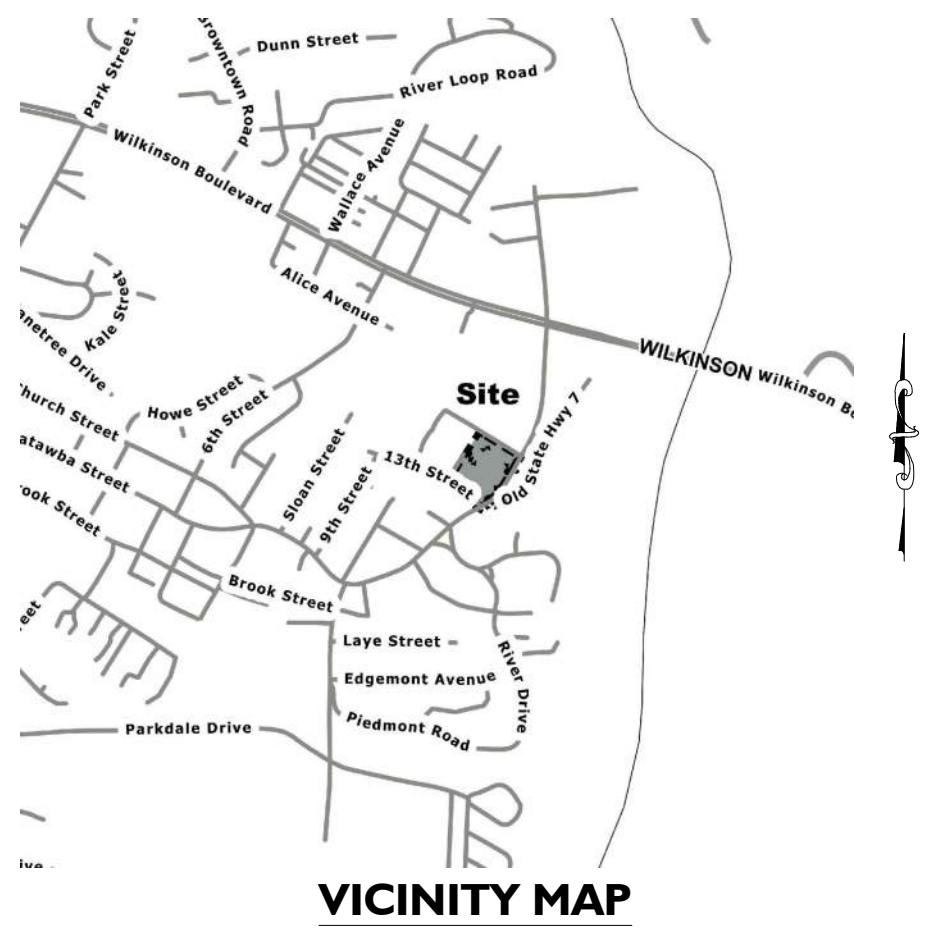
Project no: 17.000385  
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 Revisions:

Sheet Title:  
**SITE PLAN**

Sheet No:  
**C200**





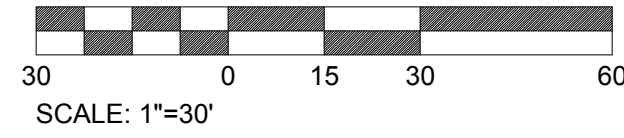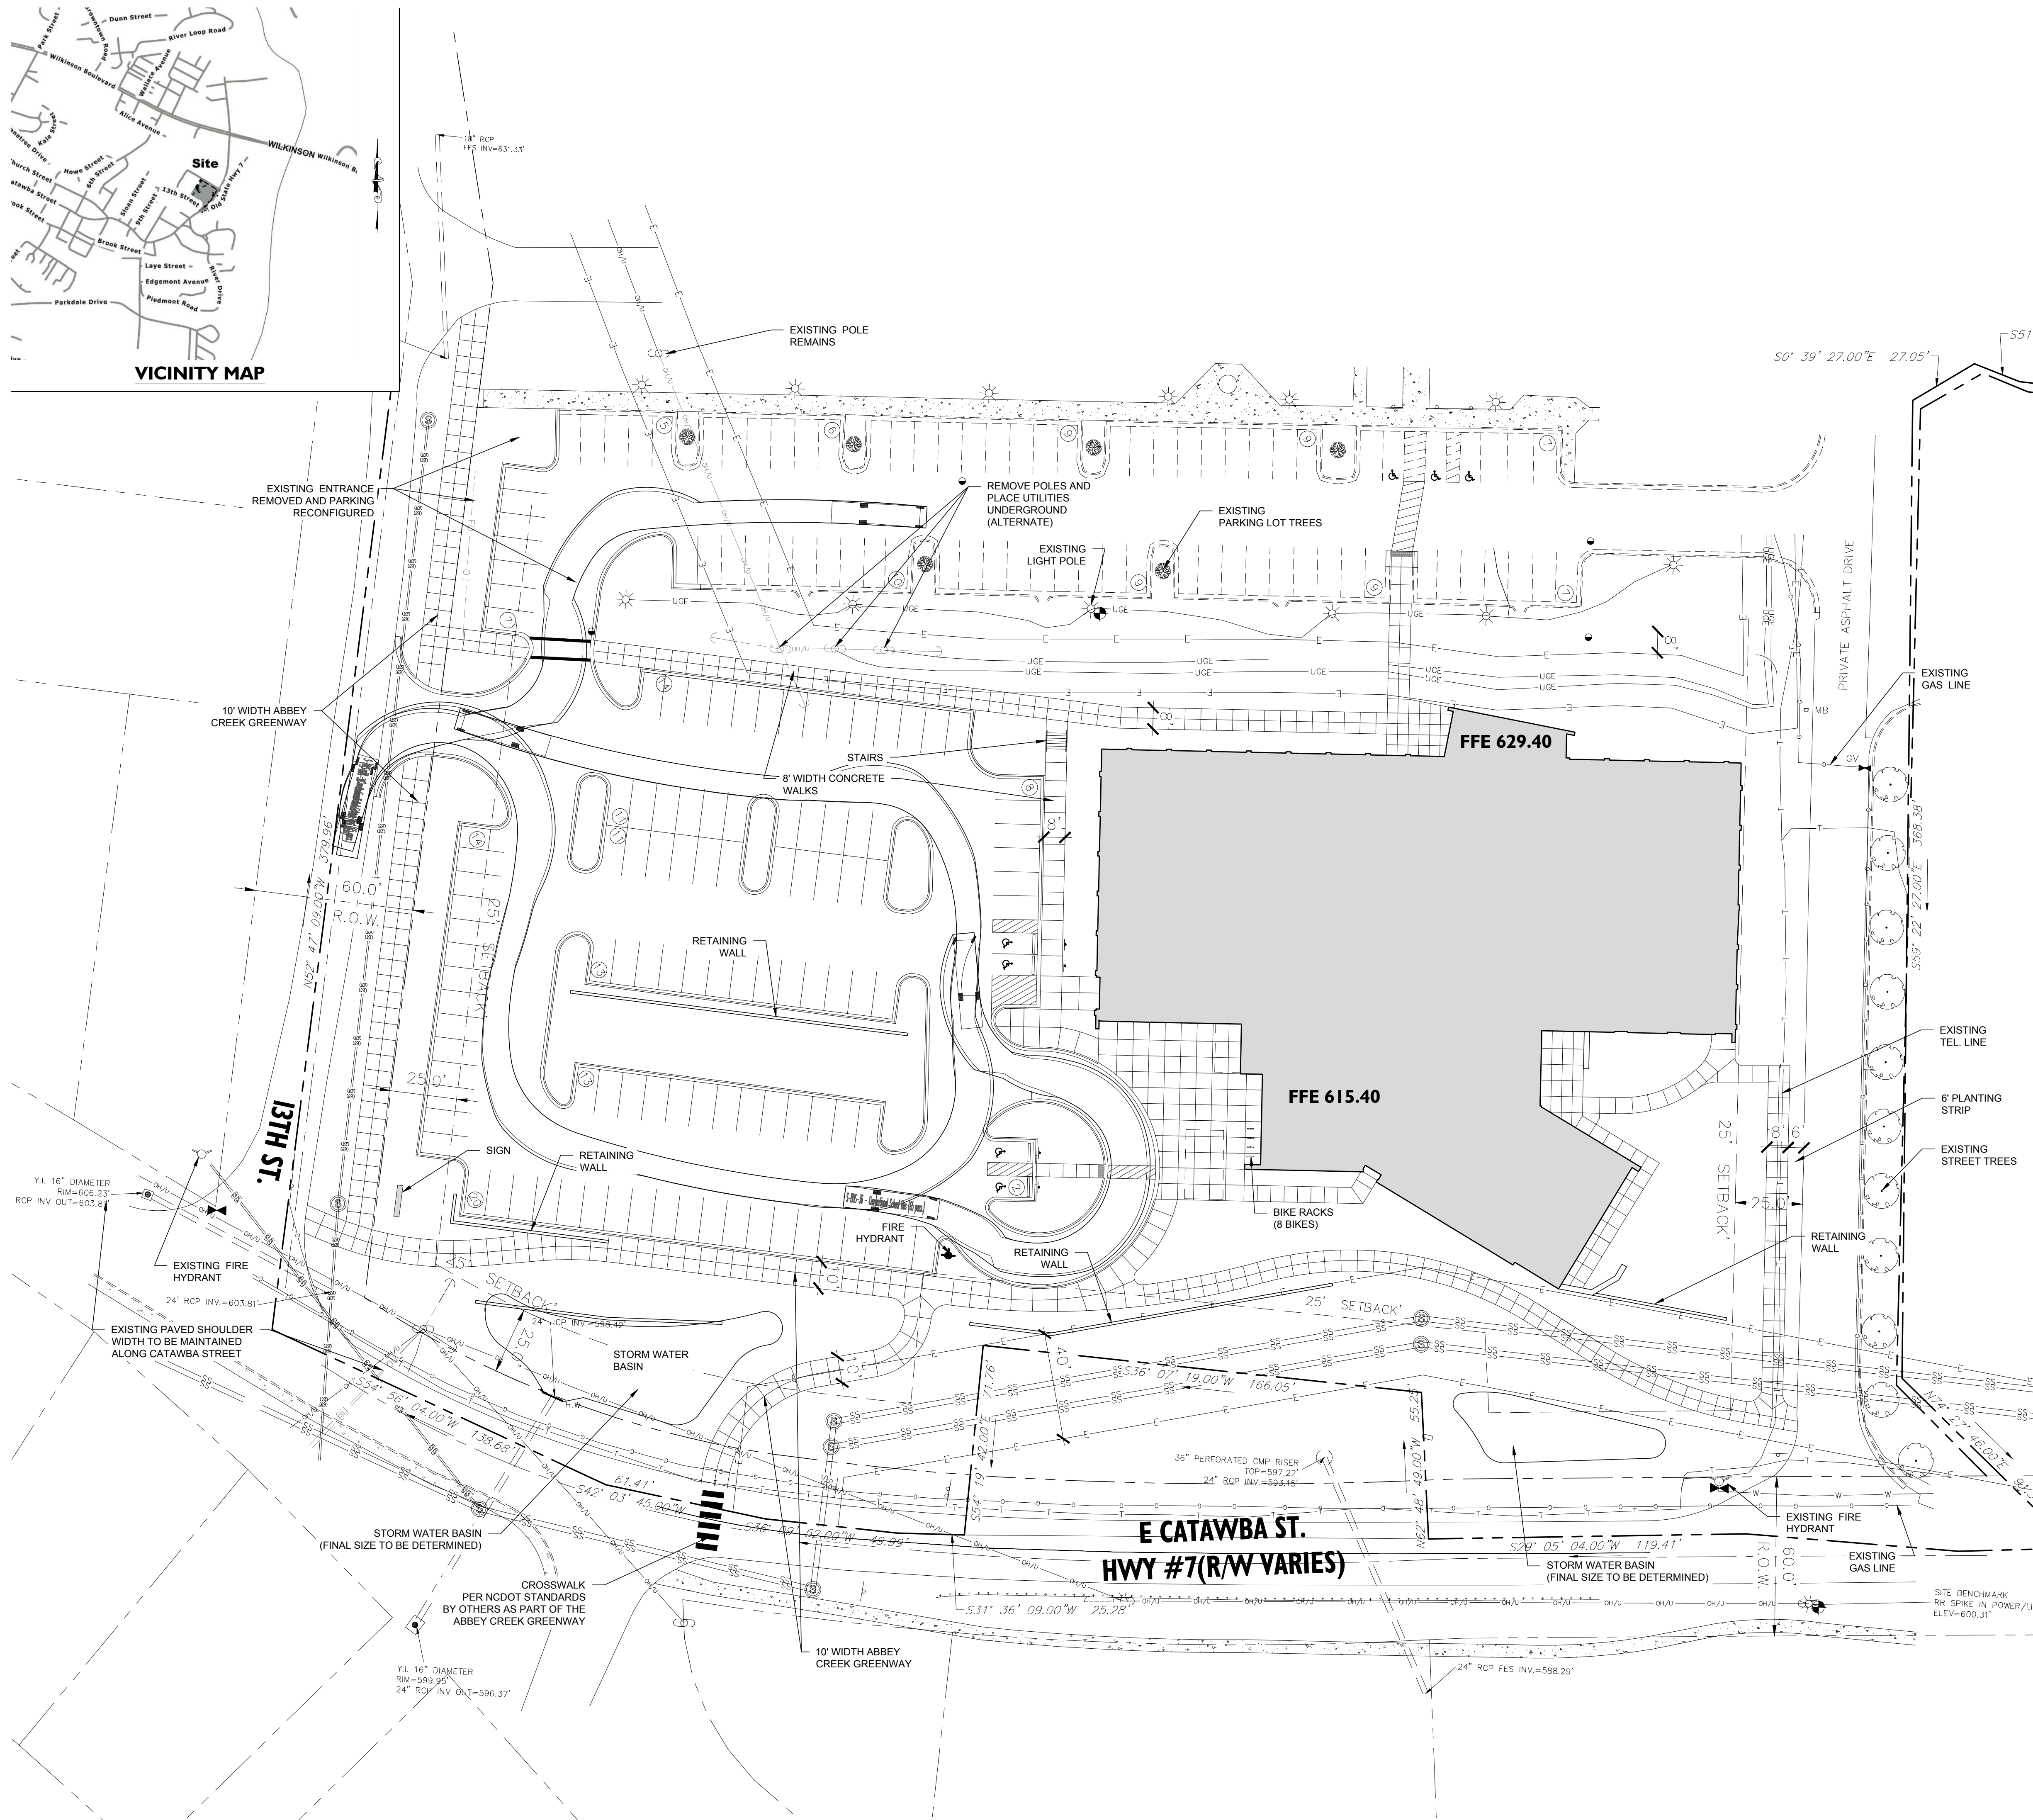


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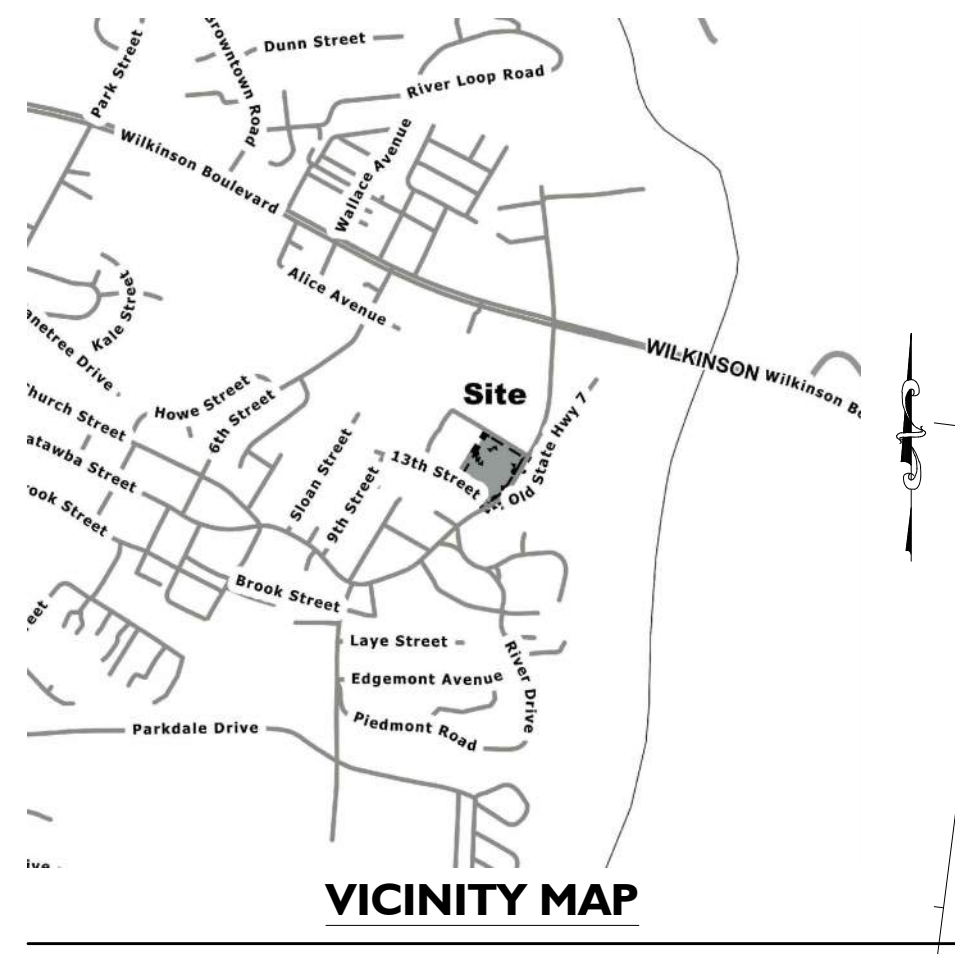
**Belmont Community Center**  
 1401 Catawba Street  
 Belmont, North Carolina

Project no: 17.000385  
 Date: 09.03.20  
 Revisions:

Sheet Title:  
**GRADING PLAN**  
 Sheet No:  
**C300**



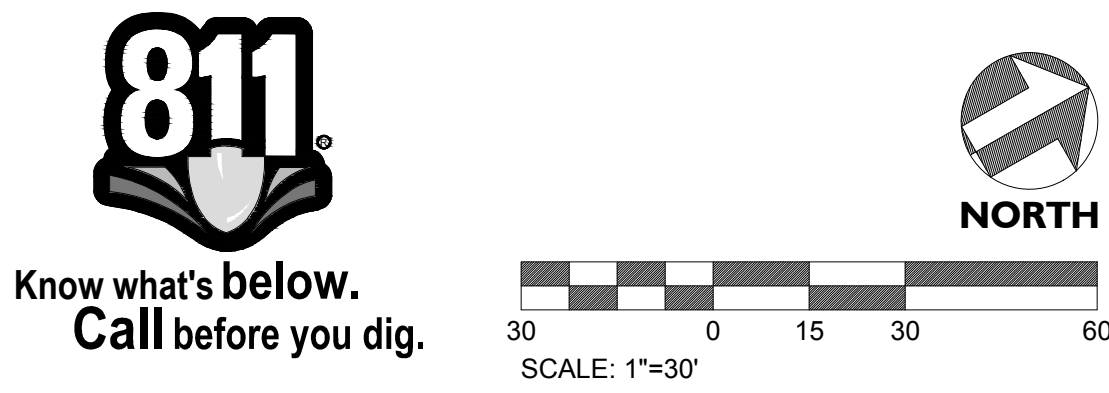



10' WIDTH ABBEY CREEK GREENWAY

13TH ST.

STORM WATER BASIN (FINAL SIZE TO BE DETERMINED)

10' WIDTH ABBEY CREEK GREENWAY

E CATAWBA ST. HWY #7(R/W VARIES)

PLANT SCHEDULE

TREES	QTY	BOTANICAL / COMMON NAME	ROOT	CAL.	REMARKS	SIZE	SPACING
Ck2	7	Cornus kousa / Kousa Dogwood	B & B	3"Cal	Full, Straight Specimen	8'-9" HT.	As Shown
Nw	8	Nyssa sylvatica 'Wildfire' / Black Gum	B & B	4"Cal	Full, Matched, Straight	10-12' HT.	As Shown
PY	4	Prunus x yedoensis / Yoshino Cherry	B & B	3"Cal	MATCHED, STRAIGHT	8-10' HT.	
Ql	7	Quercus lyrata / Overcup Oak	B & B	4"Cal	Full, Matched, Straight	10-12' HT.	As Shown
Qn2	5	Quercus nuttallii / Nuttall Oak	B & B	4"Cal	Full, Straight Specimen	12 min.	As Shown
UP	14	Ulmus parvifolia 'Bosque' / Bosque Elm	B & B	4"Cal	Full, Matched, Straight	10-12' HT.	As Shown
SHRUBS	QTY	BOTANICAL / COMMON NAME	CONT	REMARKS	HEIGHT	SPREAD	
LC3	67	Loropetalum chinensis 'Ruby' / Ruby Loropetalum	5 gal	4" O.C.	18-24" HT.	18-24"	
Vs	40	Viburnum tinus 'Spring Bouquet' / Spring Bouquet Viburnum	Container or B&B	Full Specimen	24"	24"	

SCALE: 1"=30'

LANDSCAPE NOTES

- PLANT MATERIAL**
- MINIMUM TREE SIZE AT PLANTING IS 2" CALIPER AND 8' TALL FOR SINGLE-STEM TREES. ALL MULTI-STEM PLANTS MUST BE TREE FORM, MAXIMUM 3 TO 5 TRUNKS, AND MINIMUM 10' TALL.
  - ALL NEW TREES MUST HAVE STRAIGHT TRUNKS WITH STRONG CENTRAL LEADERS INTACT TO THE TOP OF THE CROWN UNLESS MULTI-STEM TREES ARE SPECIFIED. ALL TREES SHALL BE TYPICAL OF THEIR SPECIES AND VARIETY, HAVE NORMAL GROWTH HABITS, HAVE WELL-DEVELOPED BRANCHES, BE VIGOROUS AND HAVE FIBROUS ROOT SYSTEMS. TREES WITH CO-DOMINANT BRANCHING WILL NOT BE ACCEPTED. TREES THAT HAVE BEEN SHEARED, TOPPED OR CUT BACK TO MULTIPLY THE BRANCHING STRUCTURE WILL NOT BE ACCEPTED. TREES SHALL BE FREE OF ABRASIONS, DAMAGE, DISEASE, PESTS AND CRACKS. ALL PRUNING CUTS GREATER THAN 1" DIAMETER SHALL HAVE CALLUS TISSUE FORMED PRIOR TO PLANTING. NO PRUNING CUT ON THE TRUNK SHALL BE MORE THAN ONE-HALF THE DIAMETER OF THE CENTRAL LEADER AT THE HEIGHT WHERE THE CUT WAS MADE. ROOT FLARES SHALL BE LOCATED AT GRADE. TREES WITH MORE THAN 2" OF SOIL COVERING THE ROOT BALL/FLARE FROM WILL NOT BE ACCEPTED. SIZE OF PLANTS, SPREAD OF ROOTS AND SIZE OF BALLS SHALL BE IN ACCORDANCE WITH ANSI Z60.1 (LATEST EDITION) AS PUBLISHED BY THE AMERICAN NURSERY & LANDSCAPE ASSOCIATION.
  - ALL TREES OF A PARTICULAR SPECIES AND VARIETY SHALL BE UNIFORM IN SIZE AND CONFIGURATION.
- PLANTING REQUIREMENTS**
- PLASTIC HOSE PARTS WILL NOT BE ACCEPTED FOR TREE STAKING. SEE DETAILS AND SPECIFICATIONS FOR APPROVED STAKING METHOD/MATERIALS.
  - ALL STRAPPING, AND TOP 1/2 OF WIRE BASKET AND BURLAP MUST BE CUT AWAY AND REMOVED FROM ROOT BALL WHEN PLANTING.
  - FOR NEW PLANTING AREAS, REMOVE ALL PAVEMENT, GRAVEL SUB-BASE AND CONSTRUCTION DEBRIS; REMOVE COMPACTED SOIL AND ADD 24" NEW TOPSOIL, OR TILL AND AMEND THE TOP 24" OF EXISTING SOIL TO MEET TOPSOIL PLANTING MIX STANDARDS FOR TREES.
  - ALL SAUCERS SHALL BE SOAKED WITH WATER AND MULCHED IMMEDIATELY FOLLOWING PLANTING.
  - THE TOP OF ALL ROOT BALLS FOR SHRUBS & GROUNDCOVERS SHALL BEAR THE SAME RELATIONSHIP TO FINISHED GRADE, AS BORN TO PREVIOUS GROWING CONDITIONS.
  - ALL ROOT BALLS REMOVED FROM CONTAINERS SHALL BE SCARIFIED PRIOR TO BACKFILLING.
  - MULCH A MINIMUM 4 FOOT AREA AROUND EACH TREE AND MULCH A CONTINUOUS AREA AROUND ALL SHRUB BEDS, AS INDICATED ON THE PLAN. MULCH SHALL BE 3-4" THICK. MULCH AROUND TREES SHALL BE TAPERED TOWARD TRUNK SO THAT NO MORE THAN 2" IS PLACED AT TREE TRUNK AS SHOWN ON DETAIL. SEE SPECIFICATIONS FOR TYPE.
- UTILITY ISSUES**
- LARGE MATURING TREES MAY NOT BE PLANTED WITHIN 25' OF OVERHEAD POWER DISTRIBUTION OR TRANSMISSION LINES. IF TREES CONFLICT WITH POWER LINES OR SIGNS, CALL LANDSCAPE ARCHITECT TO RESOLVE BEFORE PLANTING.
  - CONTRACTOR IS RESPONSIBLE FOR HAVING ALL UNDERGROUND UTILITIES LOCATED AND CLEARLY PAINTED WITHIN 10 DAYS OF ANY GROUND DISTURBING ACTIVITY. OWNER WILL NOT PAY FOR UTILITY REPAIRS DUE TO FAILURE TO MARK AND OBSERVE UTILITY LOCATIONS.
  - ADJUST TREE PLANTING LOCATIONS TO AVOID UNDERGROUND UTILITIES- PLANT 15' FROM ALL UNDERGROUND UTILITIES (SEWER AND STORM DRAINAGE, GAS WATER, PHONE AND ELECTRICAL LINES).
- GENERAL**
- THE LANDSCAPE CONTRACTOR SHALL BE RESPONSIBLE FOR THE QUANTITY OF PLANTS SHOWN ON THE PLAN. ANY DISCREPANCIES BETWEEN QUANTITIES ON PLAN AND PLANT LIST SHALL BE BROUGHT TO THE ATTENTION OF THE LANDSCAPE ARCHITECT AND ANY FIELD ADJUSTMENTS OR QUANTITY ADJUSTMENTS MUST BE AUTHORIZED PRIOR TO PLANTING.
  - ALL PLANTS SHALL BE GUARANTEED TO BE IN HEALTHY CONDITION FOR ONE (1) YEAR AFTER ACCEPTANCE BY OWNER OF ALL PLANT MATERIAL.
  - ALL DISTURBED AREAS SHALL BE SEEDDED AS SPECIFIED.
  - SEE EROSION CONTROL/GRADING PLAN FOR ADDITIONAL TREE PRESERVATION NOTES.



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Belmont, North Carolina

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Date: 09.03.20  
Revisions:





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Sheet Title:  
LANDSCAPE PLAN

Sheet No:  
C400





**NOTE:**  
 ESTIMATED VOLUME FOR STORM WATER PONDS IS BASED ON POST CONSTRUCTION STORM WATER REQUIREMENTS. CAPACITY ANALYSIS OF DOWNSTREAM STORM SEWER HAS NOT BEEN COMPLETED AT THIS TIME. PONDS SHOWN ARE NOT SIZED FOR EROSION CONTROL/SEDIMENT BASIN REQUIREMENTS

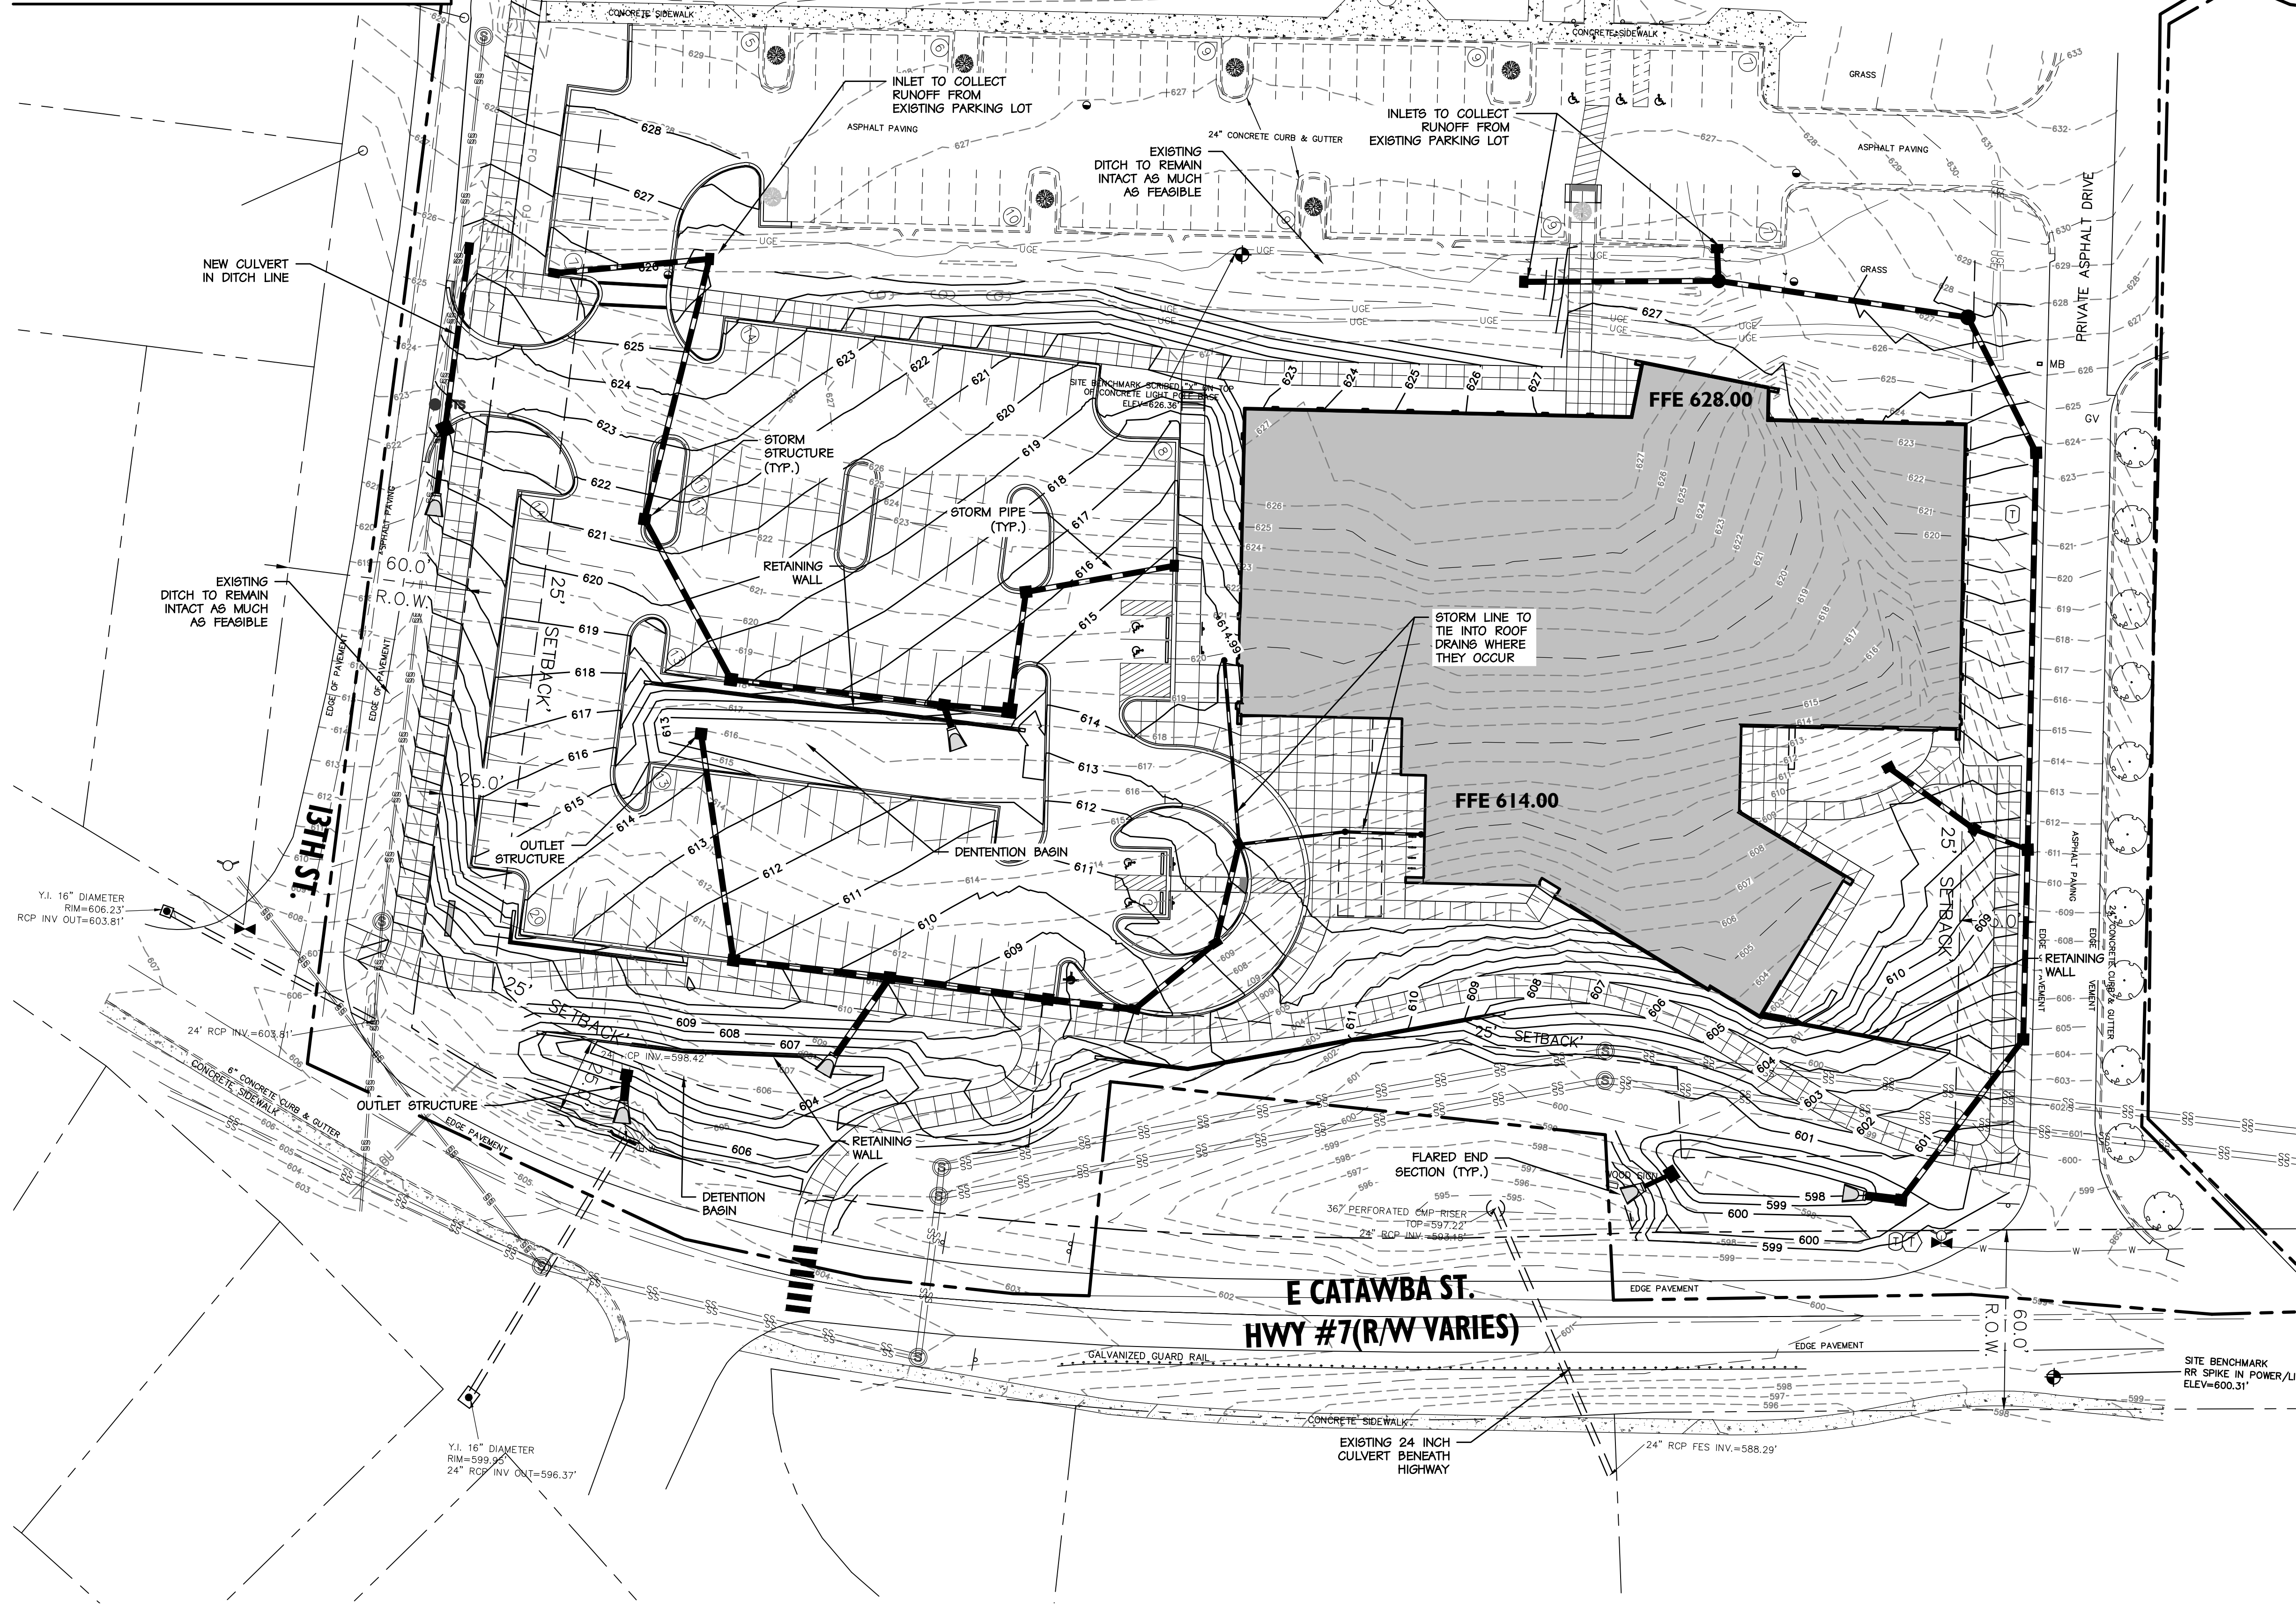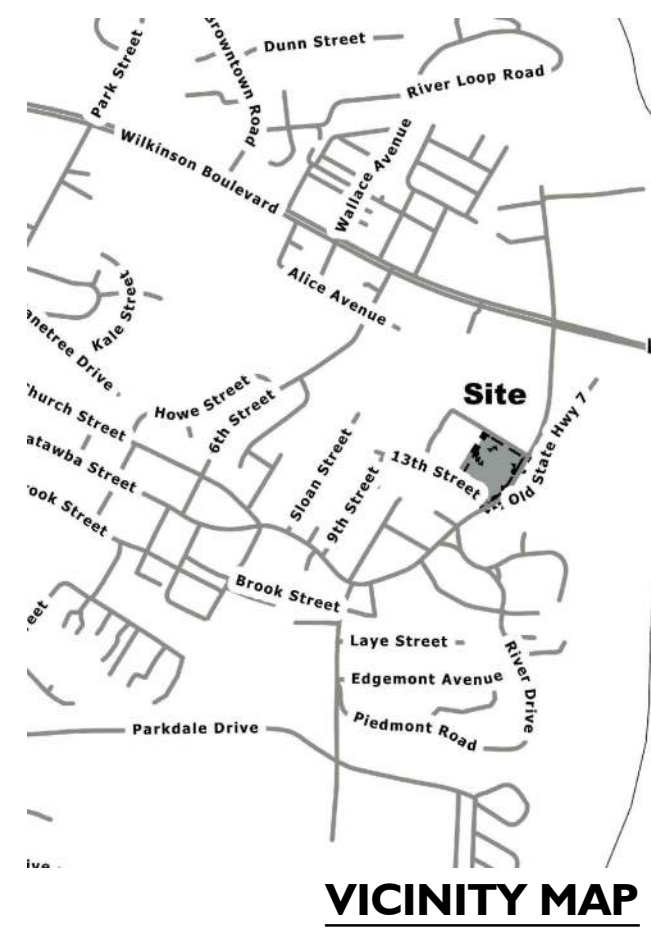Seals:  
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**Belmont Community Center**  
 1401 Catawba Street  
 Belmont, North Carolina

Project no: 17.000385  
 Date: 09.03.20  
 Revisions:

Sheet Title:  
**DRAINAGE  
 PLAN**


Sheet No:  
**C500**

**811**  
 Know what's below.  
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**NORTH**

30 0 15 30 60  
 SCALE: 1"=30'




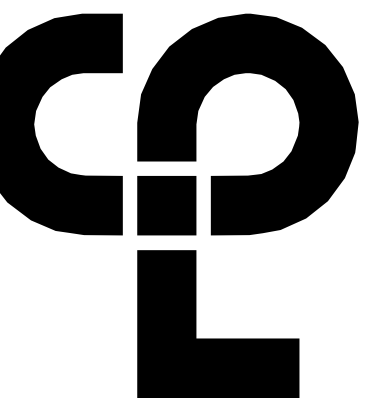

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 6302 FAIRVIEW RD, SUITE 102  
 CHARLOTTE, NC 28210  
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**FLOOR PLAN GENERAL NOTES**

1. ALL DRAWINGS ARE GRAPHIC REPRESENTATIONS OF APPROXIMATE LOCATIONS OF NEW MATERIALS. IT IS THE CONTRACTOR'S RESPONSIBILITY TO FIELD VERIFY ALL EXISTING CONDITIONS PRIOR TO COMMENCEMENT OF WORK.
2. THE GENERAL CONTRACTOR IS RESPONSIBLE TO FIRESTOP ALL NEW PARTITIONS TO THE STRUCTURAL DECK ABOVE. FIRESTOPPING HEADS OF WALLS IS TO OCCUR AT ALL NEW WALL CONSTRUCTION WITHIN THE PROJECT.
3. ALL WALL DIMENSIONS INDICATED ON FLOOR PLANS ARE TO FACE OF STUD FRAMING OR MASONRY UNLESS OTHERWISE NOTED.
4. SEE SHEET A400 FOR INTERIOR PARTITION TYPES.
5. SEE A400 FOR INTERIOR AND EXTERIOR DOORS, WINDOWS, CURTAIN WALLS, AND STOREFRONTS.
6. PROVIDE AN EDGE/TRANSITION STRIP CENTERED UNDER ALL DOORS WHERE ADJACENT FLOOR FINISHES ARE OF DIFFERENT MATERIALS.
7. PROVIDE ACCESS PANELS, MINIMUM 24" X 24" OR OF SIZES REQUIRED, WHERE PLUMBING AND HEATING VALVES, WATER SWITCHES, VENTILATION SPLITTER DAPNERS, ETC. ARE SHOWN ON PLUMBING, HEATING AND VENTILATION DRAWINGS.
8. WORK AREAS SHALL BE MAINTAINED AND ALL WORK AREAS SHALL BE LEFT BROOMED CLEAN AT END OF EACH DAY.
9. ALL DOORS AND WINDOW SYSTEMS TO HAVE SEALANT AROUND THE ENTIRE PERIMETER (BOTH SIDES) OF FRAMES.
10. CONTRACTOR TO COORDINATE WITH OTHER TRADES FOR SEQUENCING OF WORK.
11. REFER TO A200 FOR TYPICAL FIXTURE MOUNTING HEIGHTS AND ACCESSORIES LEGEND.

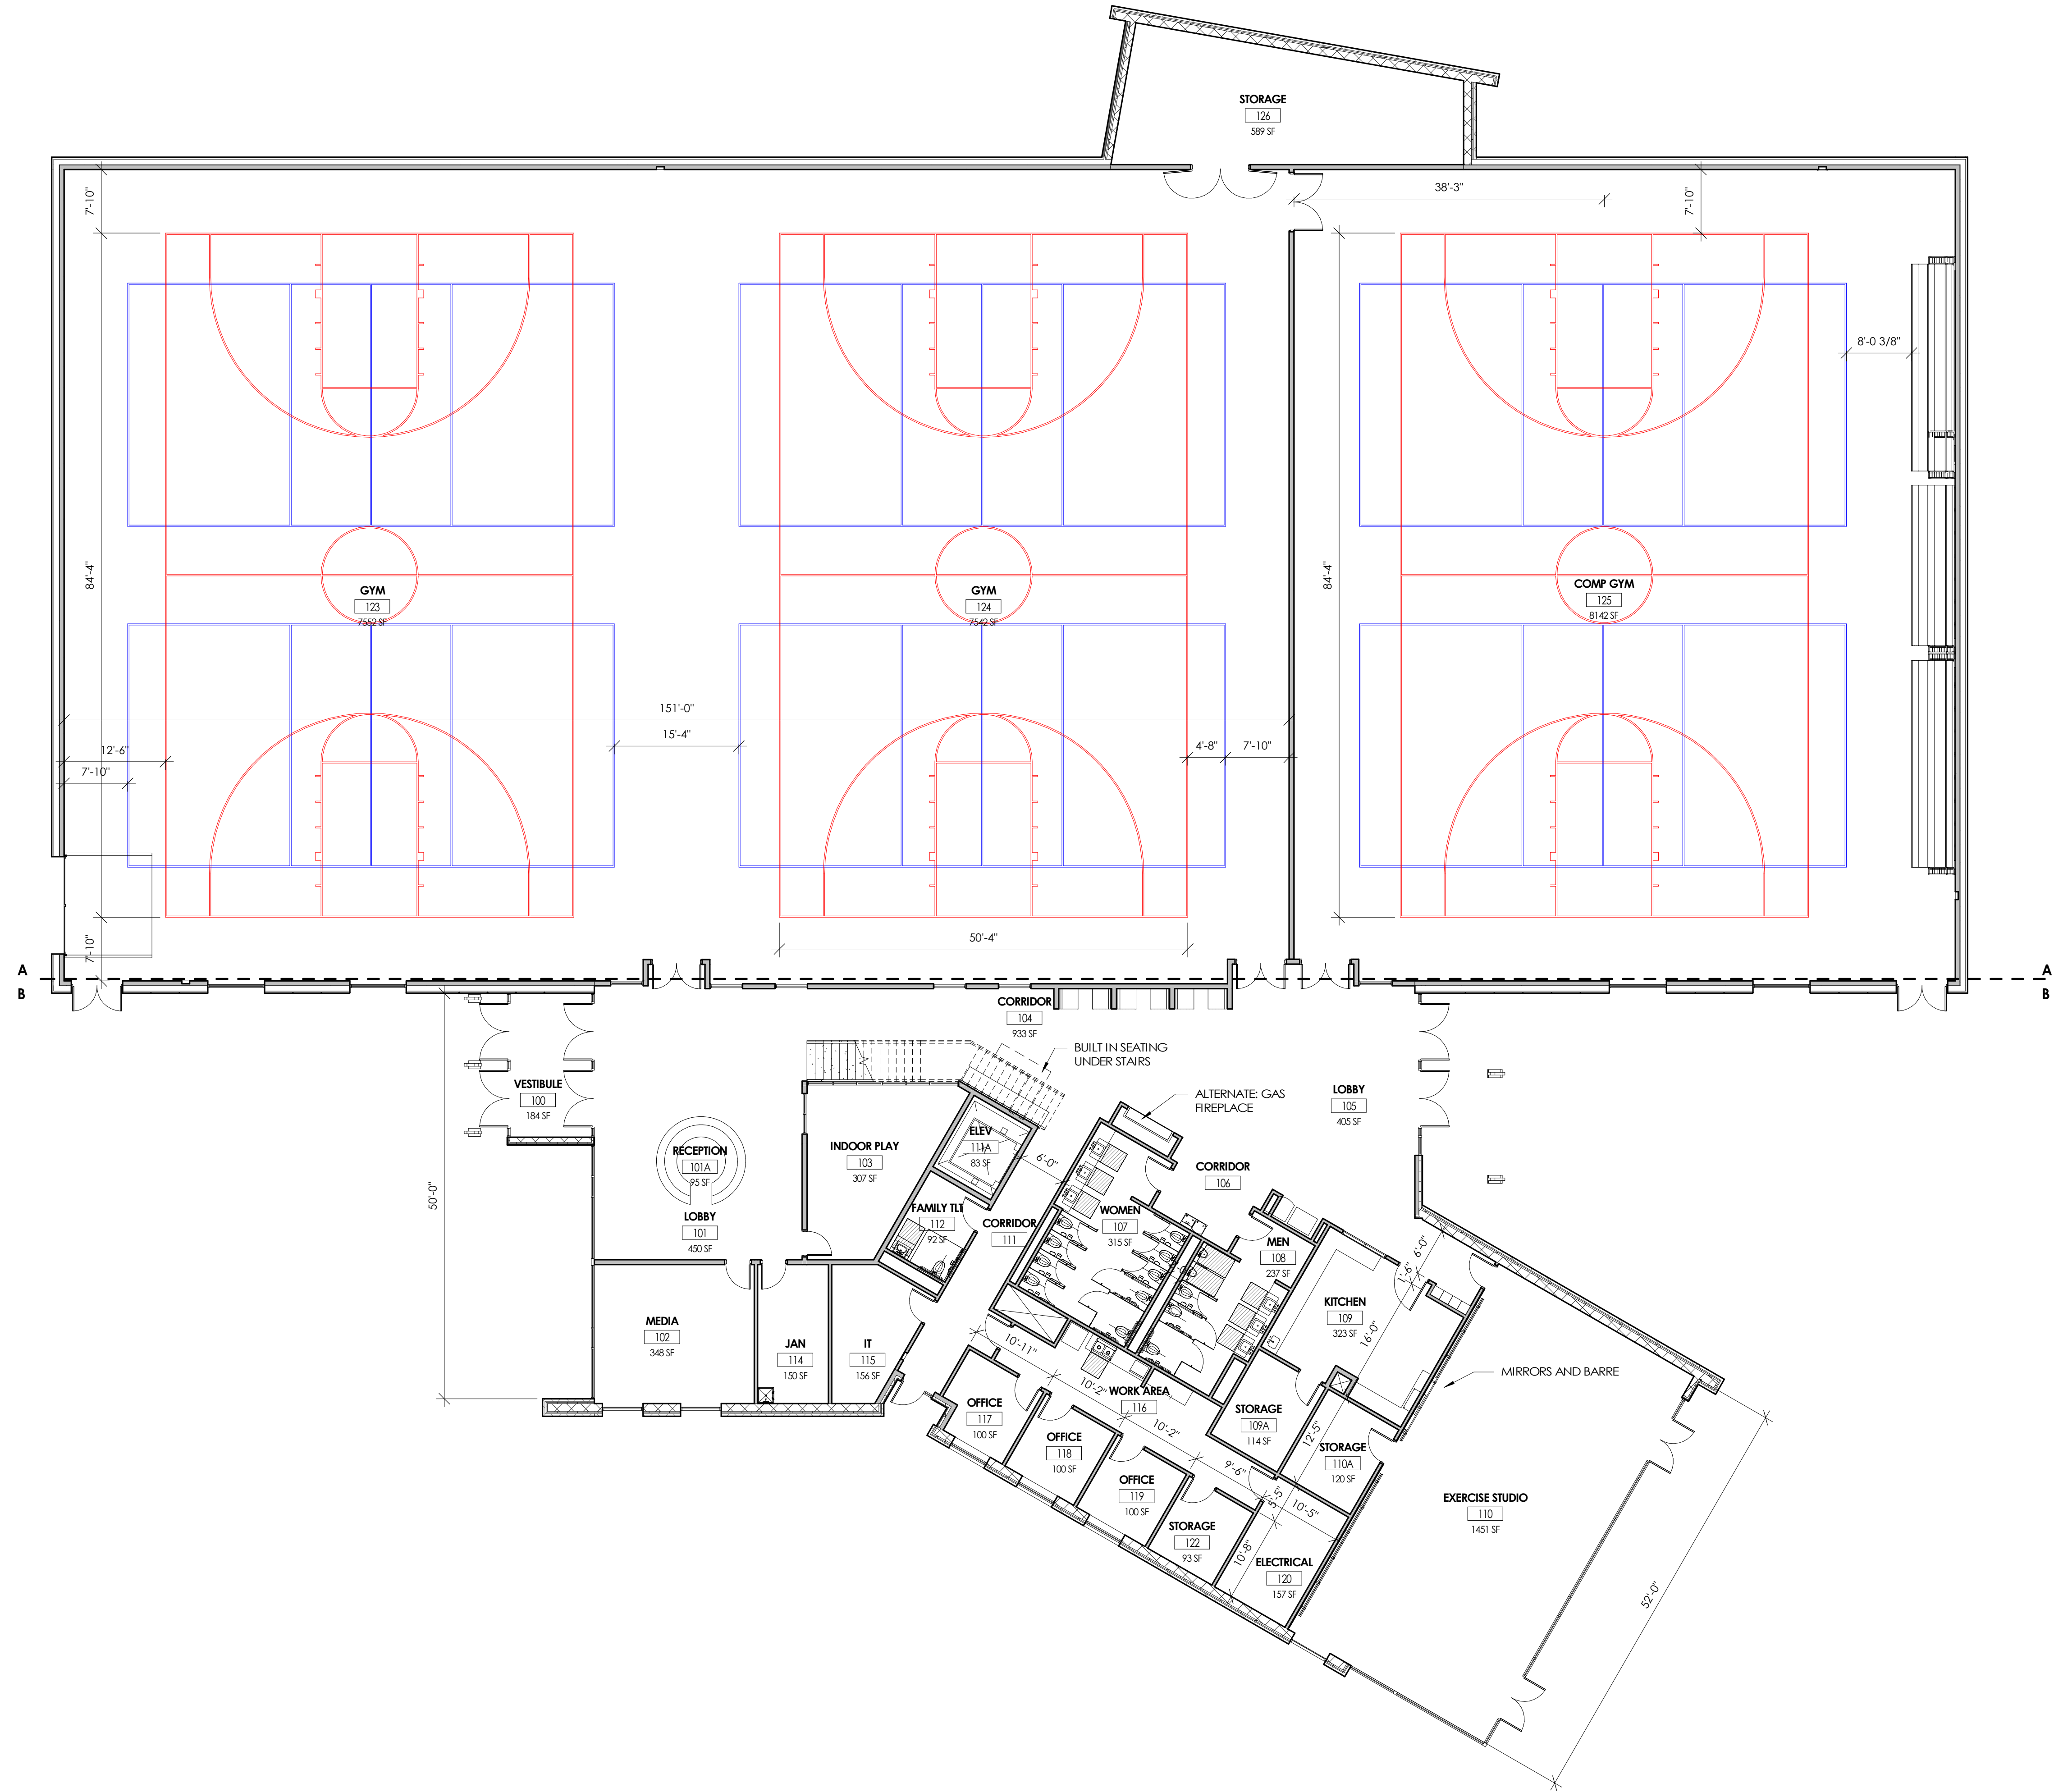

**1 FLOOR PLAN LEVEL 1 OVERALL**  
 A201 3/32" = 1'-0"

**PROJECT INFORMATION**

Project Number: 15651.00  
 Client Name: CITY OF BELMONT  
 Project Name: BELMONT COMMUNITY RECREATION CENTER  
 Project Address: 1401 CATAWBA STREET, BELMONT, NORTH CAROLINA

**REVISION SCHEDULE**


1. Date: 06/03/2020

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**SHEET INFORMATION**

Issue: 07/04/2020  
 SCHEMATIC DESIGN  
 Drawn By: KAM Checked By: DMS  
 Drawing Title: OVERALL FIRST FLOOR PLAN

DD  
 A201

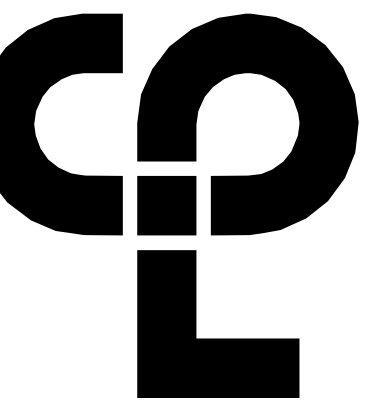

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CHARLOTTE, NC 28210  
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4. SEE SHEET A400 FOR INTERIOR PARTITION TYPES.
5. SEE A400 FOR INTERIOR AND EXTERIOR DOORS, WINDOWS, CURTAIN WALLS, AND STOREFRONTS.
6. PROVIDE AN EDGE/TRANSITION STRIP CENTERED UNDER ALL DOORS WHERE ADJACENT FLOOR FINISHES ARE OF DIFFERENT MATERIALS.
7. PROVIDE ACCESS PANELS, MINIMUM 24" x 24", OR OF SIZES REQUIRED, WHERE PLUMBING AND HEATING VALVES, WATER SWITCHES, VENTILATION SPLITTER DAMPERS, ETC. ARE SHOWN ON PLUMBING, HEATING AND VENTILATION DRAWINGS.
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9. ALL DOORS AND WINDOW SYSTEMS TO HAVE SEALANT AROUND THE ENTIRE PERIMETER (BOTH SIDES) OF FRAMES.
10. CONTRACTOR TO COORDINATE WITH OTHER TRADES FOR SEQUENCING OF WORK.
11. REFER TO A700 FOR TYPICAL FIXTURE MOUNTING HEIGHTS AND ACCESSORIES LEGEND.

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15651.00  
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**CITY OF BELMONT**  
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**REVISION SCHEDULE**


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**SHEET INFORMATION**

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Drawn By  
KAM  
Checked By  
DMS  
Drawing Title  
OVERALL SECOND FLOOR PLAN


A202



**1 SECOND FLOOR PLAN OVERALL**  
A202 3/32" = 1'-0"

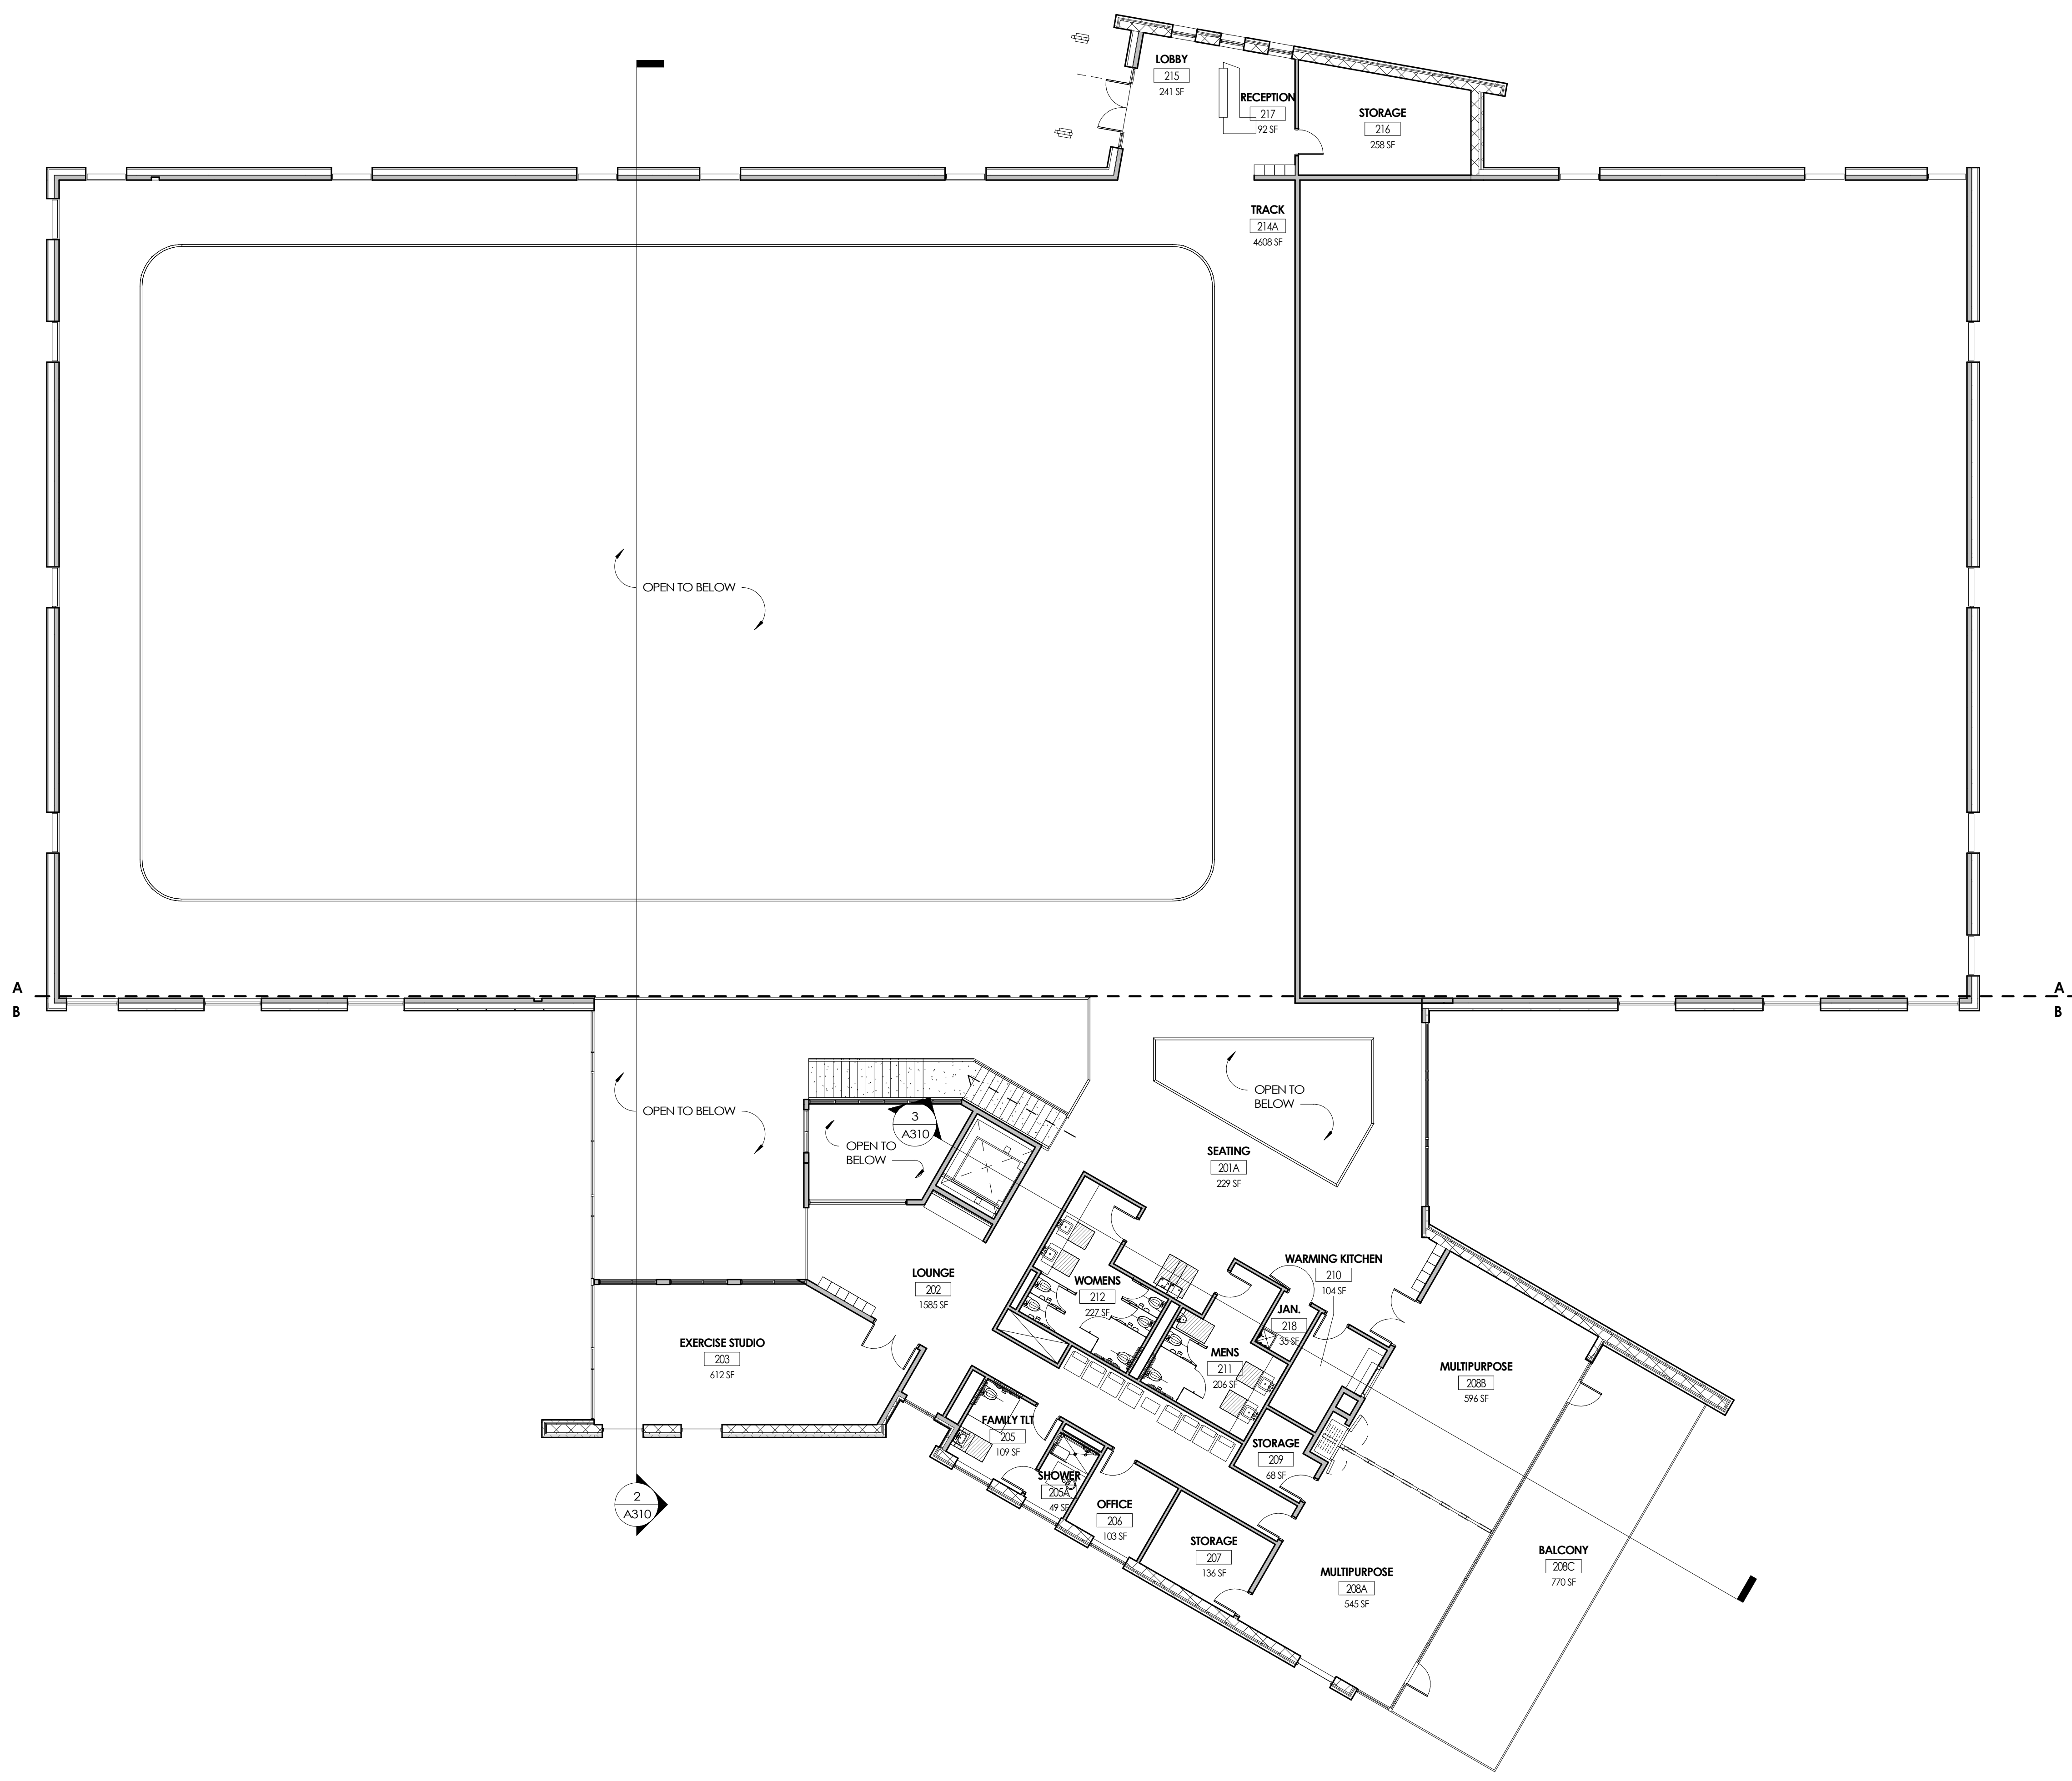9/2/2020 6:01:20 PM s:\project\location\CD\Design\08-CAD\view\02\00\A\A202.rvt



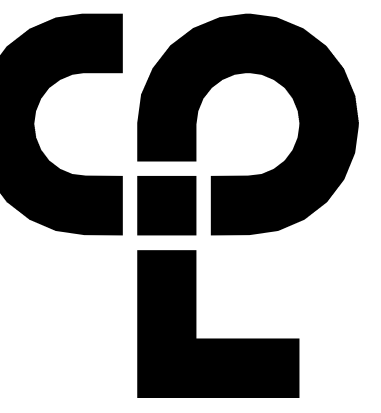

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**ELEVATION GENERAL NOTES**

1. ALL DRAWINGS ARE GRAPHIC REPRESENTATIONS OF APPROXIMATE LOCATIONS OF EXISTING AND NEW MATERIALS. IT IS THE CONTRACTOR'S RESPONSIBILITY TO FIELD VERIFY ALL EXISTING CONDITIONS PRIOR TO COMMENCEMENT OF WORK.
2. MASONRY OPENING ARE APPROXIMATE. THE CONTRACTOR SHALL BE RESPONSIBLE FOR VERIFYING ALL CONDITIONS.
3. REFER TO ARCH'S DRAWINGS FOR DOOR, FRAME, AND WINDOW TYPES.
4. PROVIDE ALL LOUVER OPENINGS AS REQUIRED. COORDINATE WITH MECHANICAL CONTRACTOR FOR FINAL SIZE AND LOCATION.
5. ARCHITECTURAL ELEVATION 0'-0" EQUALS CIVIL DATUM OF XXXX.XX
6. CONTROL JOINT = CJ
7. SOFT JOINT = SJ
8. EXPANSION JOINT = EJ
9. BUILDING EXPANSION JOINT = BEJ

**ELEVATION LEGEND**

	CAST STONE		PRECAST CONCRETE
	CMU (RUNNING)		SIDING 4", HORIZONTAL
	CMU (STACKED)		STACKED STONE
	BRICK (RUNNING)		STANDING SEAM ROOF
	BRICK (STACKED)		
	BRICK (SOLDIER)		

**ELEVATION KEY NOTES**

1. STANDING SEAM METAL ROOM SYSTEM
2. CMU, RUNNING BOND, TRENIWYTH HIGH POLISHED; WINTER WHITE
3. ALUMINUM STOREFRONT SYSTEM W/ 1" INSULATED LOW-E GLAZING
4. WOOD LOOK FASCIA/ SOFFIT (METAL OR OTHER MATERIAL)
5. FLUSH SEAM FLAT ALUMINUM PANEL: COLONIAL RED, 42" PANEL
6. PAINTED STEEL COLUMN W/ WRAPPED BASE
7. CMU, HIGH POLISHED OR OTHER MATERIAL
- 8A. BASE BID: FLUSH SEAM FLAT ALUMINUM PANEL: SILVER, 12" PANEL OR TO FIT
- 8B. ALTERNATE: FLAT TRANSLUCENT WALL PANEL
10. A300 NOTE 10
11. INSULATED METAL PANEL: GRAY STONE


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**CITY OF BELMONT**


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**REVISION SCHEDULE**


1 - Date: 08/08/2020



**1 ELEVATION - SOUTH**  
 A300 1/8" = 1'-0"

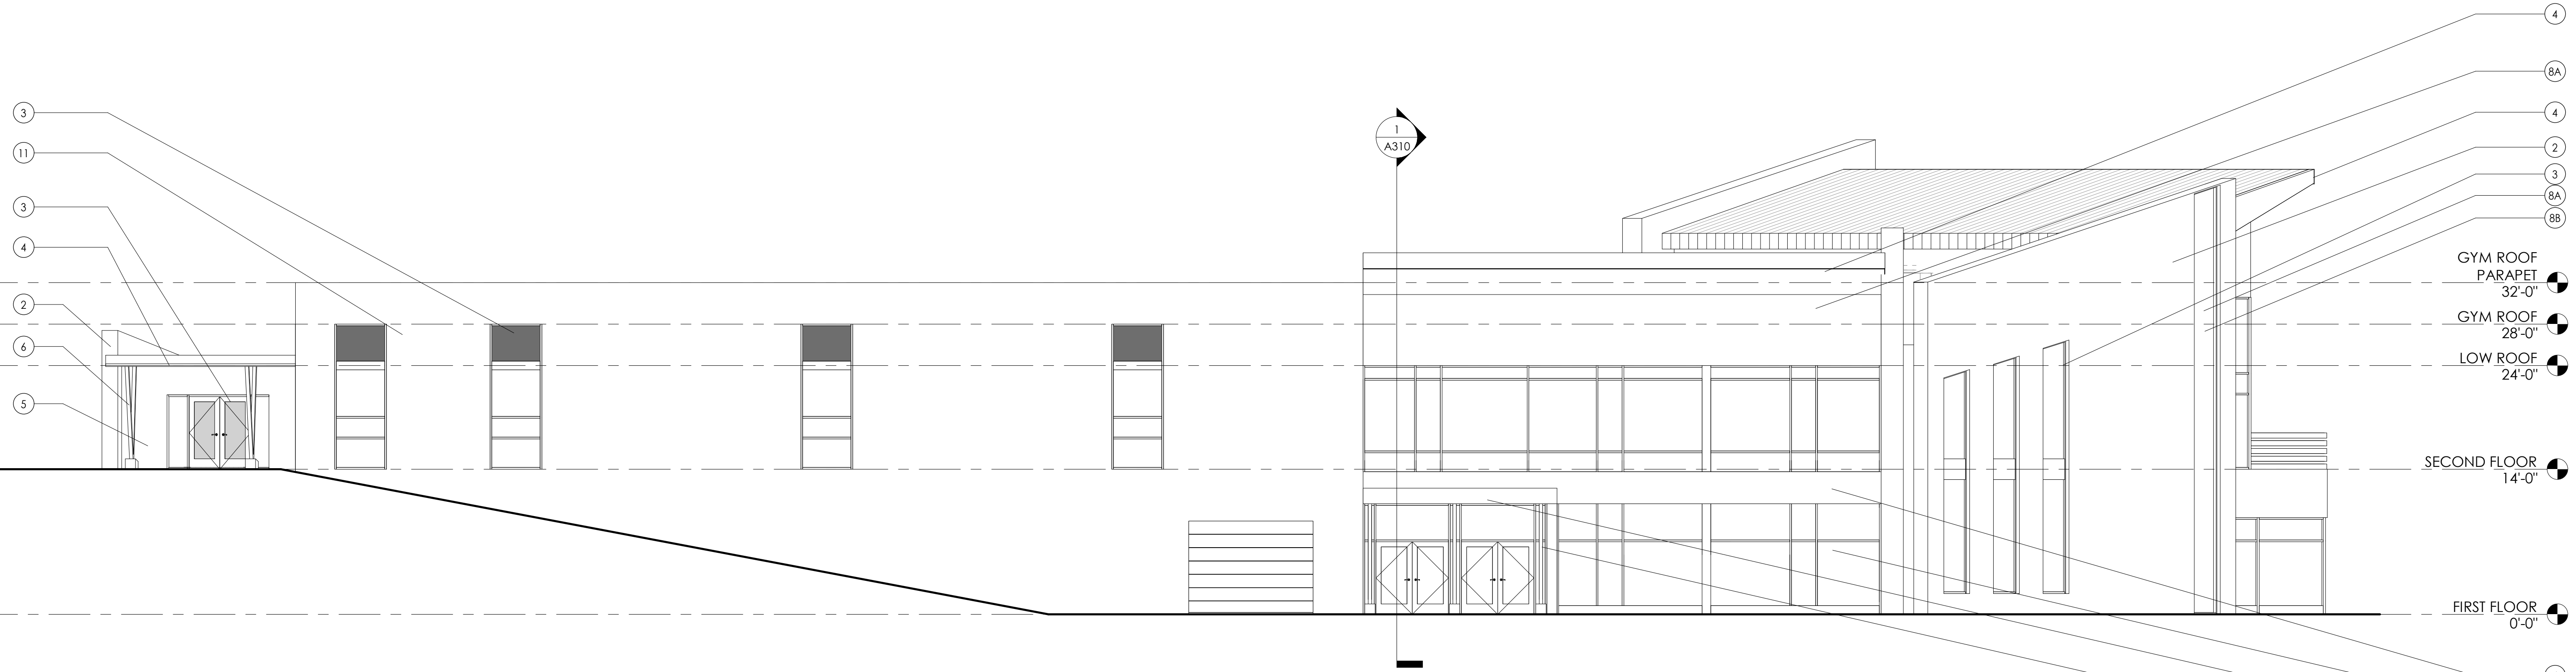

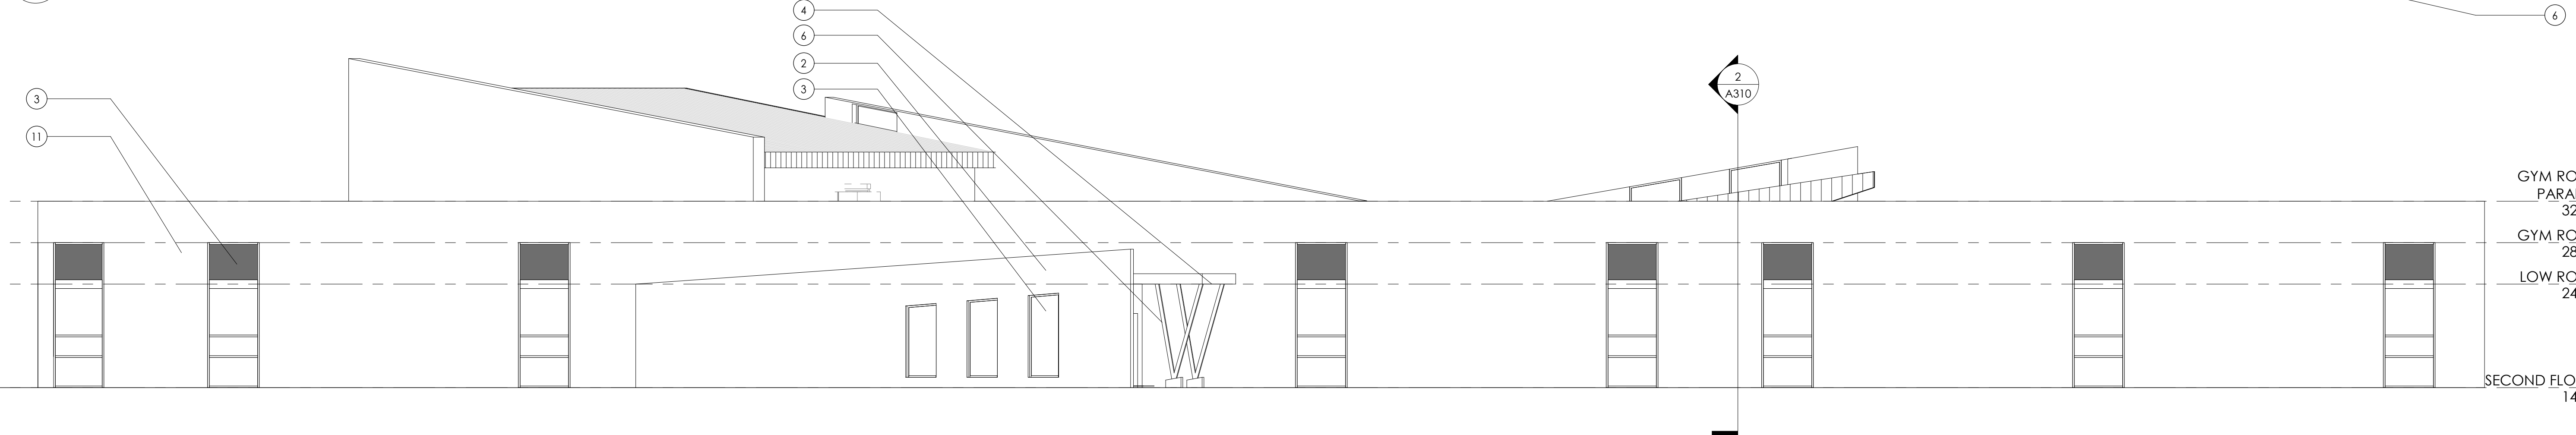**2 ELEVATION - WEST**  
 A300 1/8" = 1'-0"

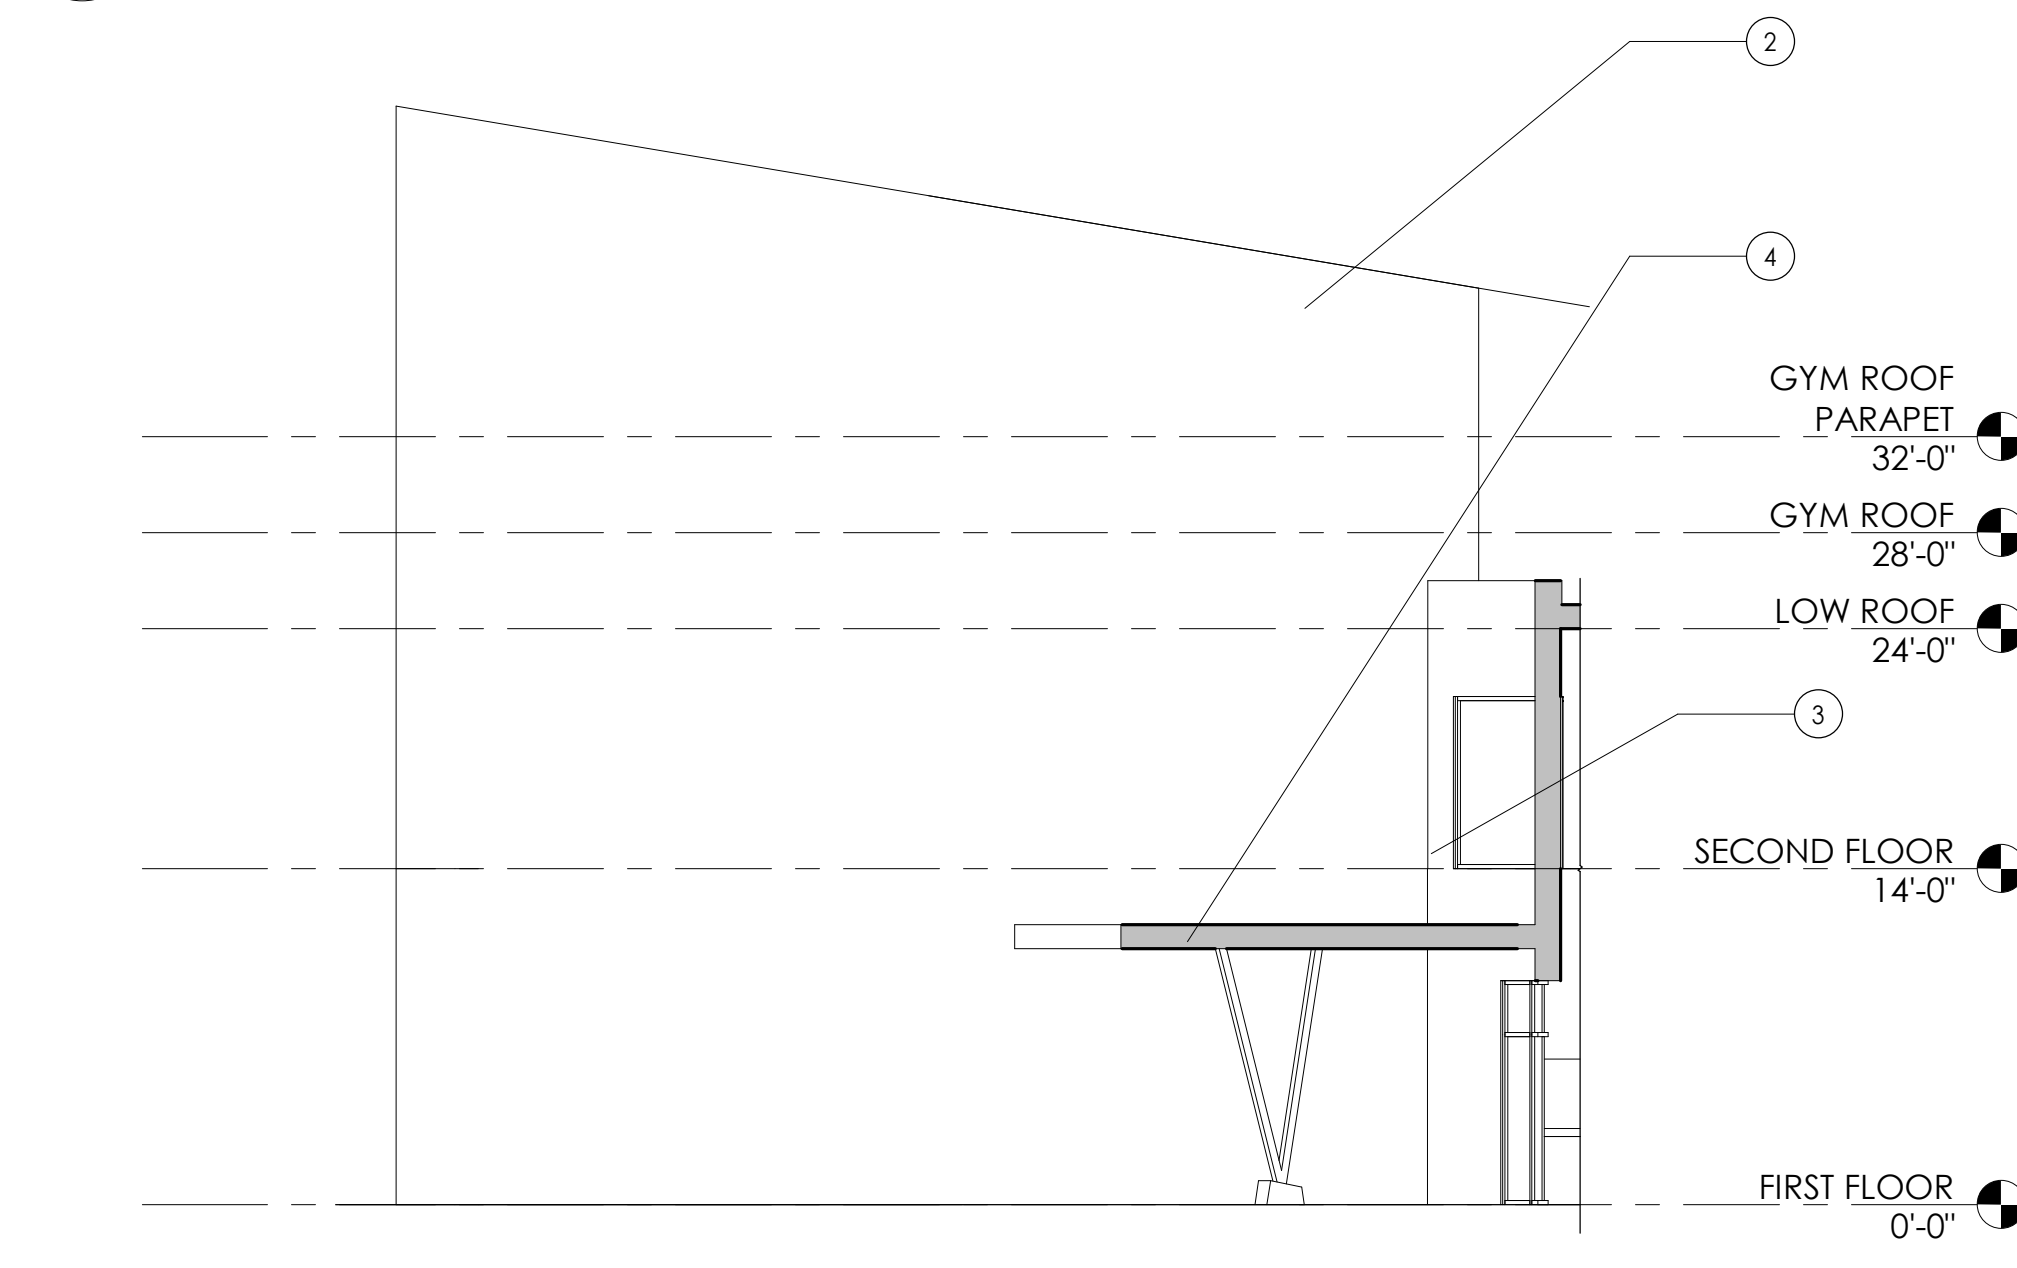

**4 WEST ELEVATION 02**  
 A300 1/8" = 1'-0"


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BUILDING ELEVATIONS

9/2/2020 11:22:50 AM c:\projects\locations\08-CAD\Revit\CENTRAL\_R15





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2. MASONRY OPENINGS ARE APPROXIMATE. THE CONTRACTOR SHALL BE RESPONSIBLE FOR VERIFYING ALL CONDITIONS.
3. REFER TO A300'S DRAWINGS FOR DOOR, FRAME, AND WINDOW TYPES.
4. PROVIDE ALL LOUVER OPENINGS AS REQUIRED. COORDINATE WITH MECHANICAL CONTRACTOR FOR FINAL SIZE AND LOCATION.
5. ARCHITECTURAL ELEVATION 0'-0" EQUALS CIVIL DATUM OF XXX.XX'
6. CONTROL JOINT = CJ
7. SOFT JOINT = SJ
8. EXPANSION JOINT = EJ
9. BUILDING EXPANSION JOINT = BEJ
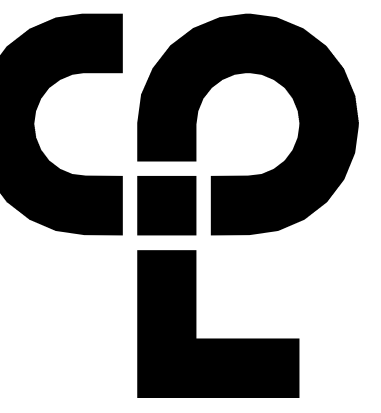
### ELEVATION LEGEND

	CAST STONE		PRECAST CONCRETE
	CMU (RUNNING)		SIDING 4", HORIZONTAL
	CMU (STACKED)		STACKED STONE
	BRICK (RUNNING)		STANDING SEAM ROOF
	BRICK (STACKED)		
	BRICK (SOLDIER)		

### ELEVATION KEY NOTES


1. STANDING SEAM METAL ROOF SYSTEM
2. CMU, RUNNING BOND, TRENWYTH HIGH POLISHED; WINTER WHITE
3. ALUMINUM STOREFRONT SYSTEM W/ 1" INSULATED LOW-E GLAZING
4. WOOD LOOK FASCIA/ SOFFIT (METAL OR OTHER MATERIAL)
5. FLUSH SEAM FLAT ALUMINUM PANEL: COLONIAL RED, 42" PANEL
6. PAINTED STEEL COLUMN W/ WRAPPED BASE
7. CMU, HIGH POLISHED OR OTHER MATERIAL
- 8A. BASE BID: FLUSH SEAM FLAT ALUMINUM PANEL: SILVER, 12" PANEL OR TO FIT
- 8B. ALTERNATE: FLAT TRANSLUCENT WALL PANEL
10. A300 NOTE 10
11. INSULATED METAL PANEL: GRAY STONE

### PROJECT INFORMATION


Project Number:  
15651.00  
Client Name:  
**CITY OF BELMONT**  
Project Name:  
**BELMONT COMMUNITY RECREATION CENTER**  
Project Address:  
1401 CATAWBA STREET  
BELMONT, NORTH CAROLINA

### REVISION SCHEDULE


1. Date: 05/04/2020

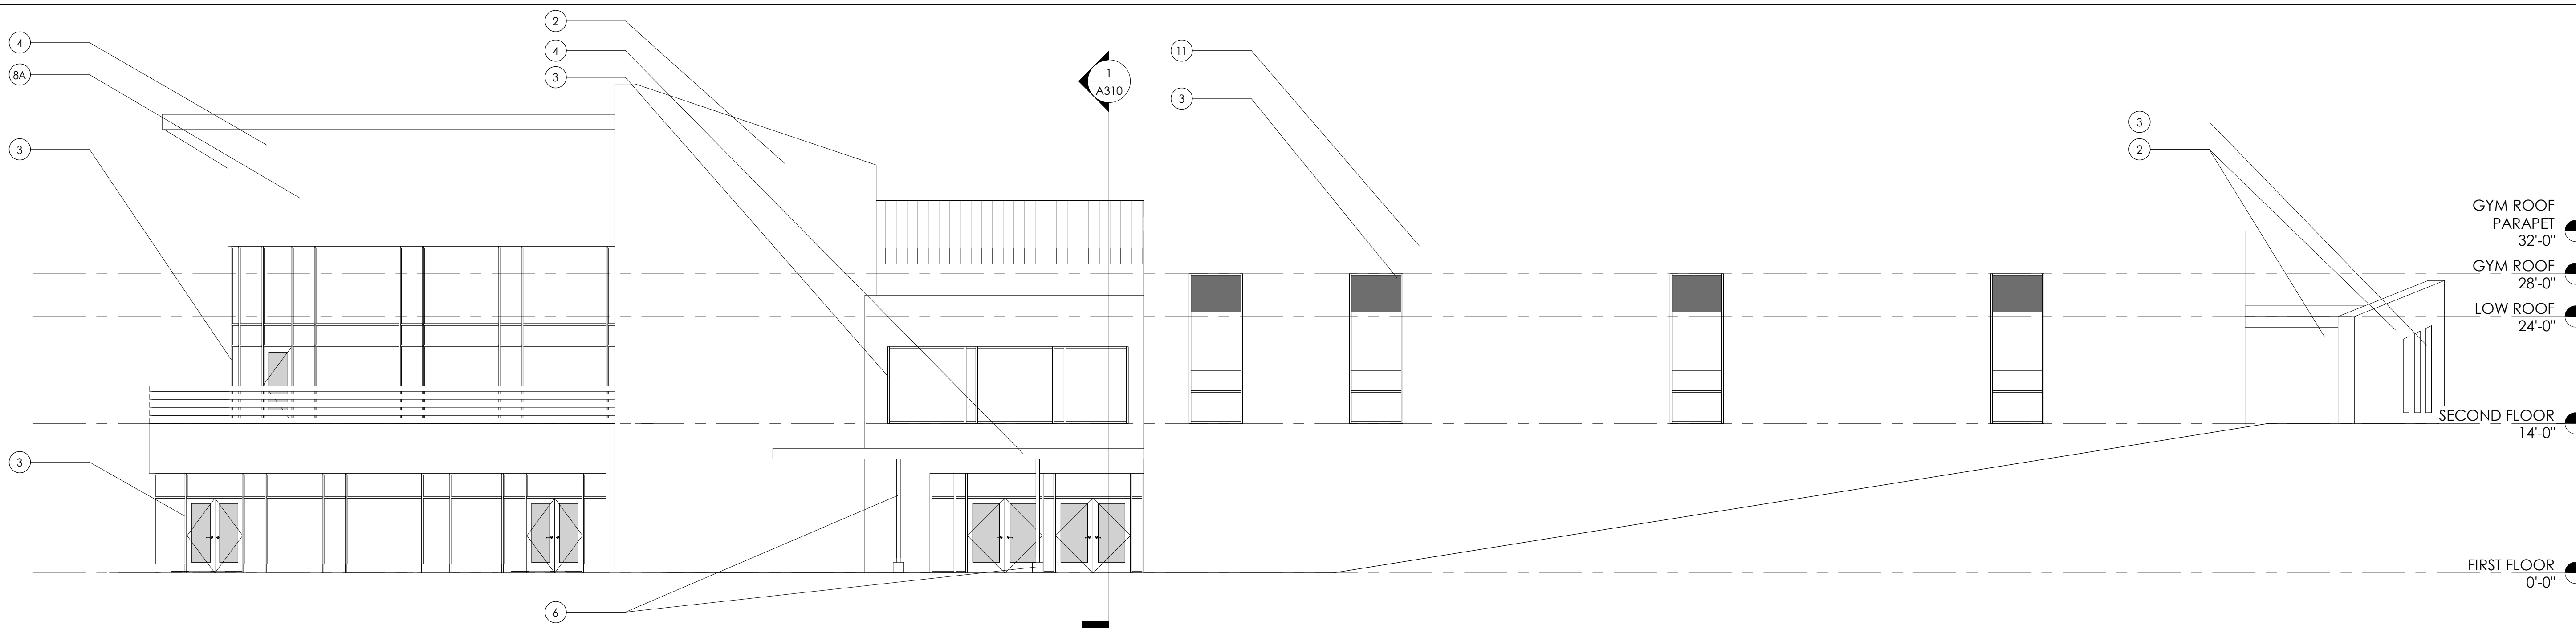


**6 ELEVATION - NORTH**  
A301 1/8" = 1'-0"

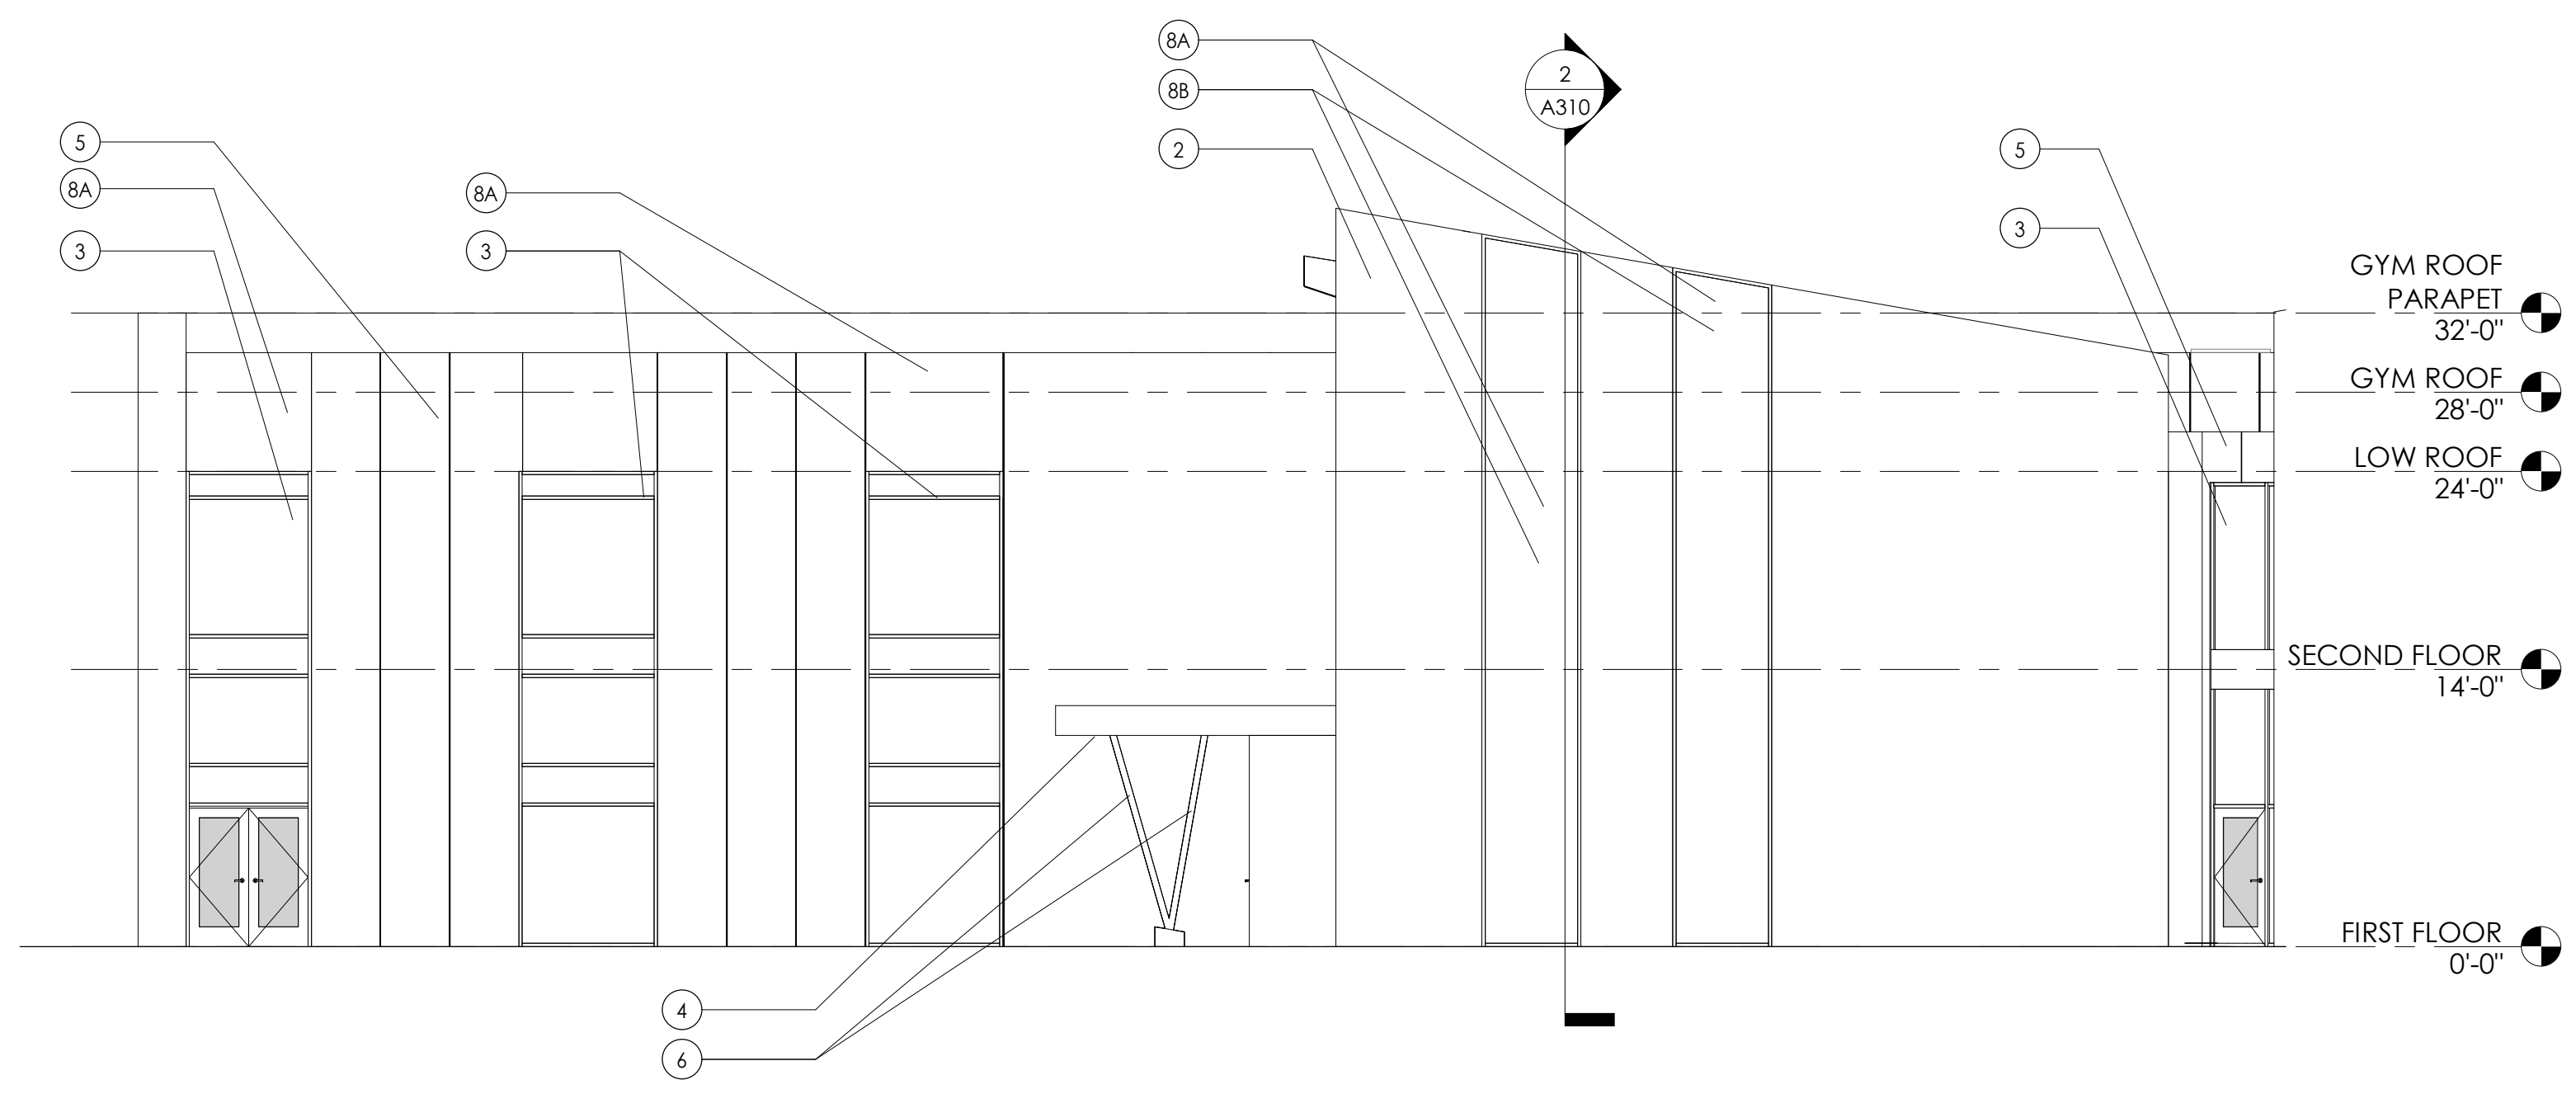


**2 EAST ELEVATION 01**  
A301 1/8" = 1'-0"

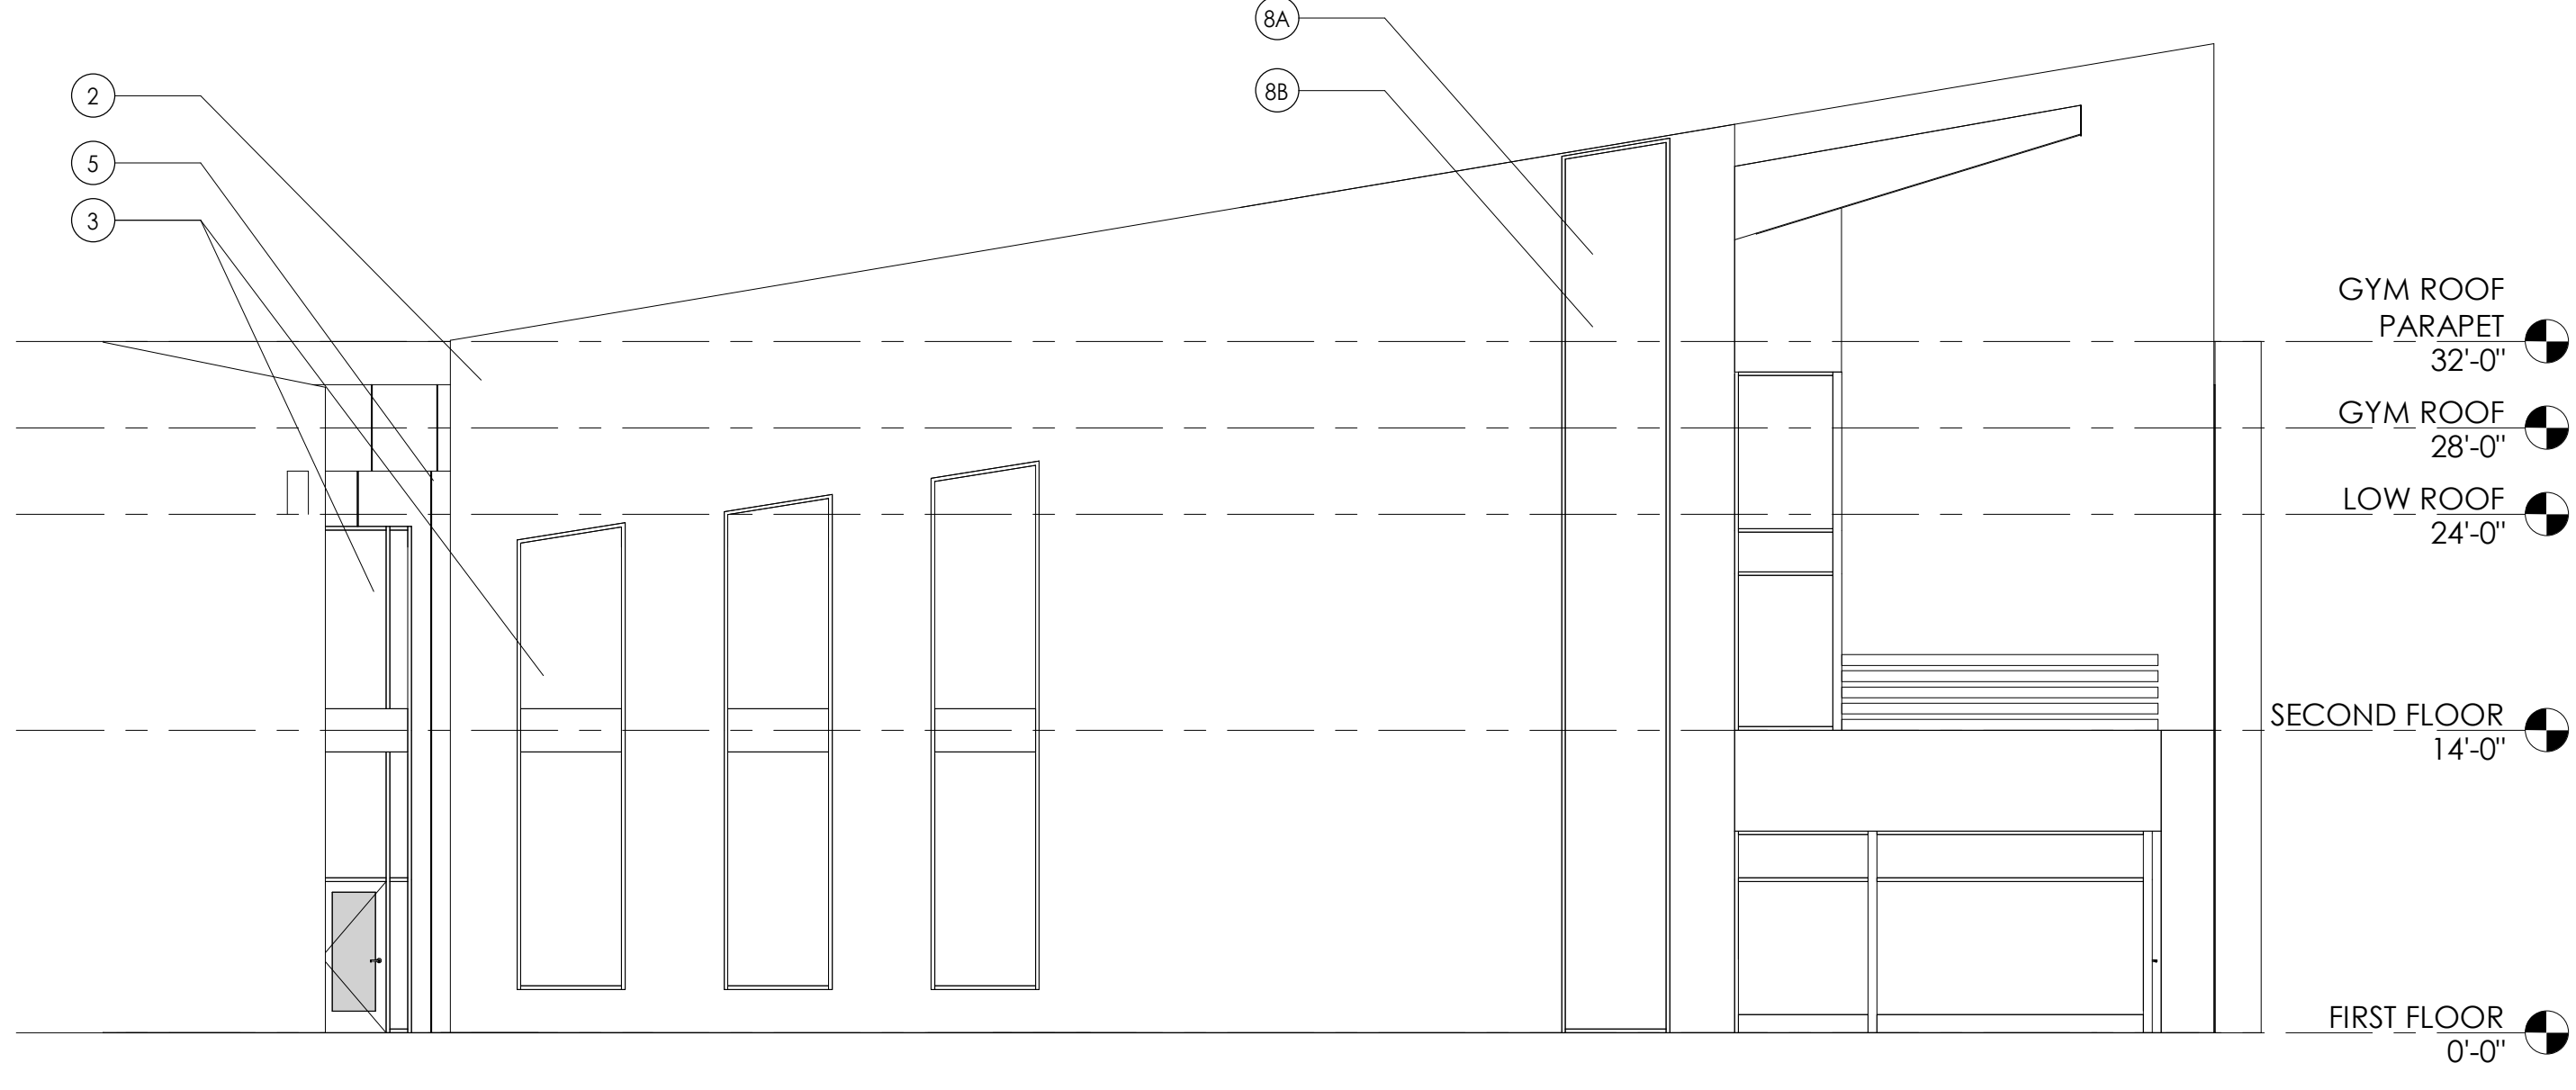

**3 EAST ELEVATION 02**  
A301 1/8" = 1'-0"

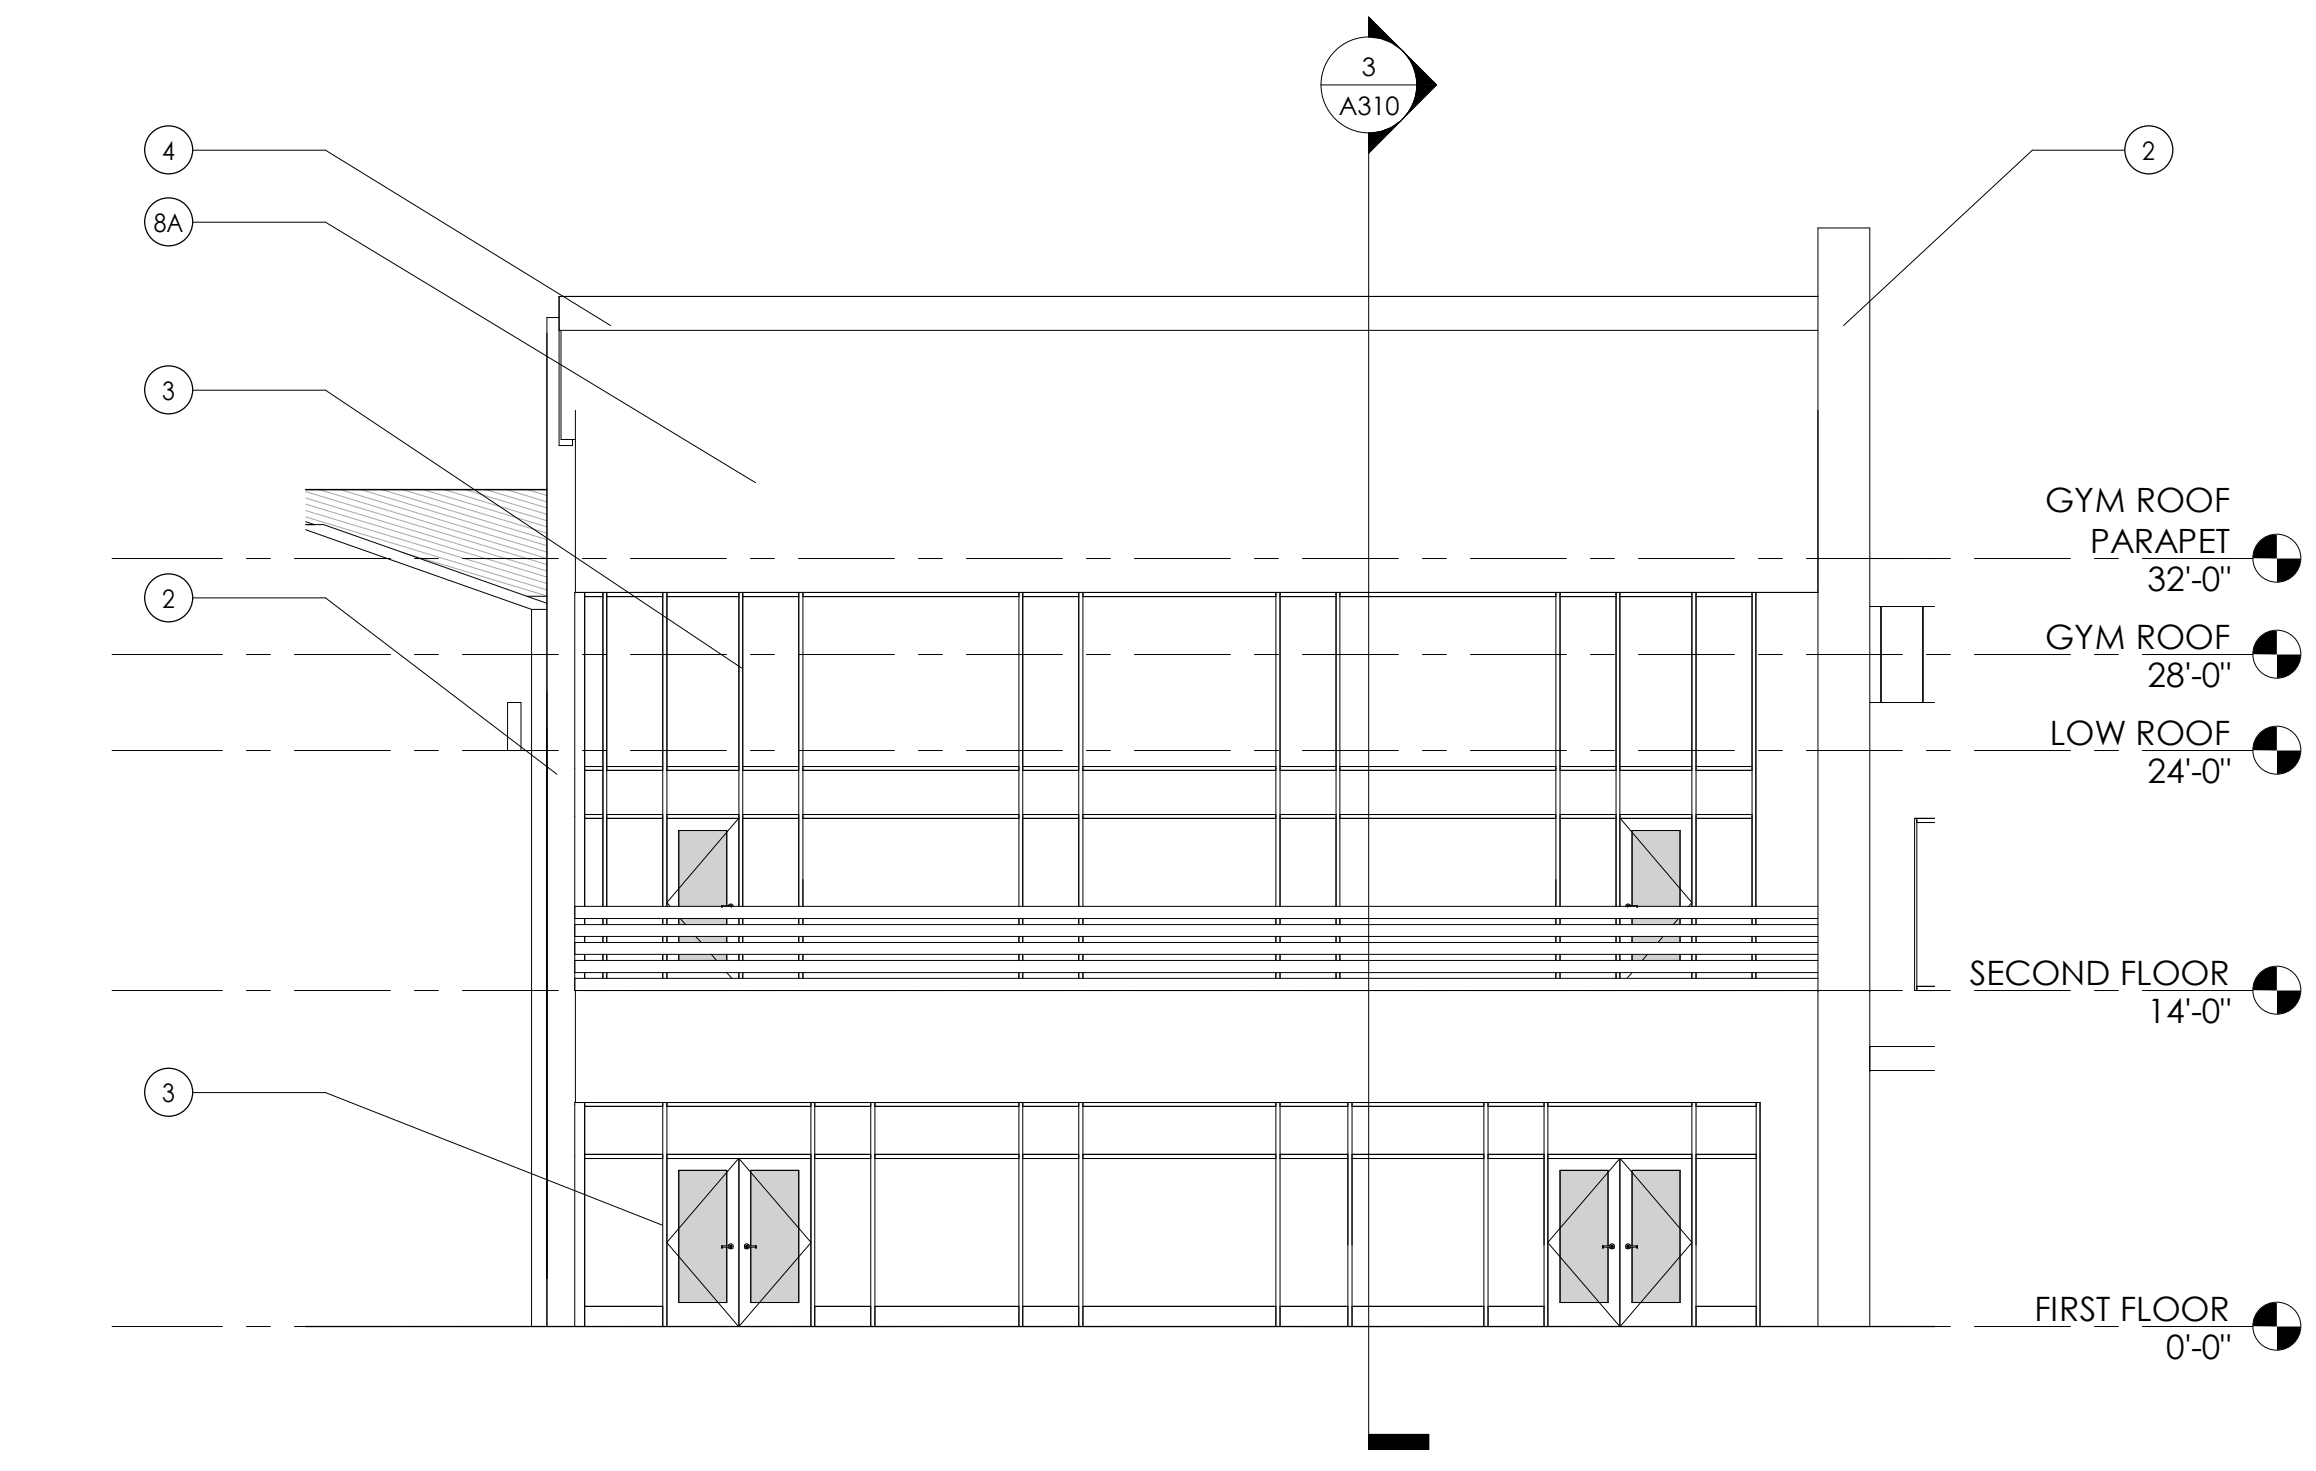

**1 EAST ELEVATION 03**  
A301 1/8" = 1'-0"

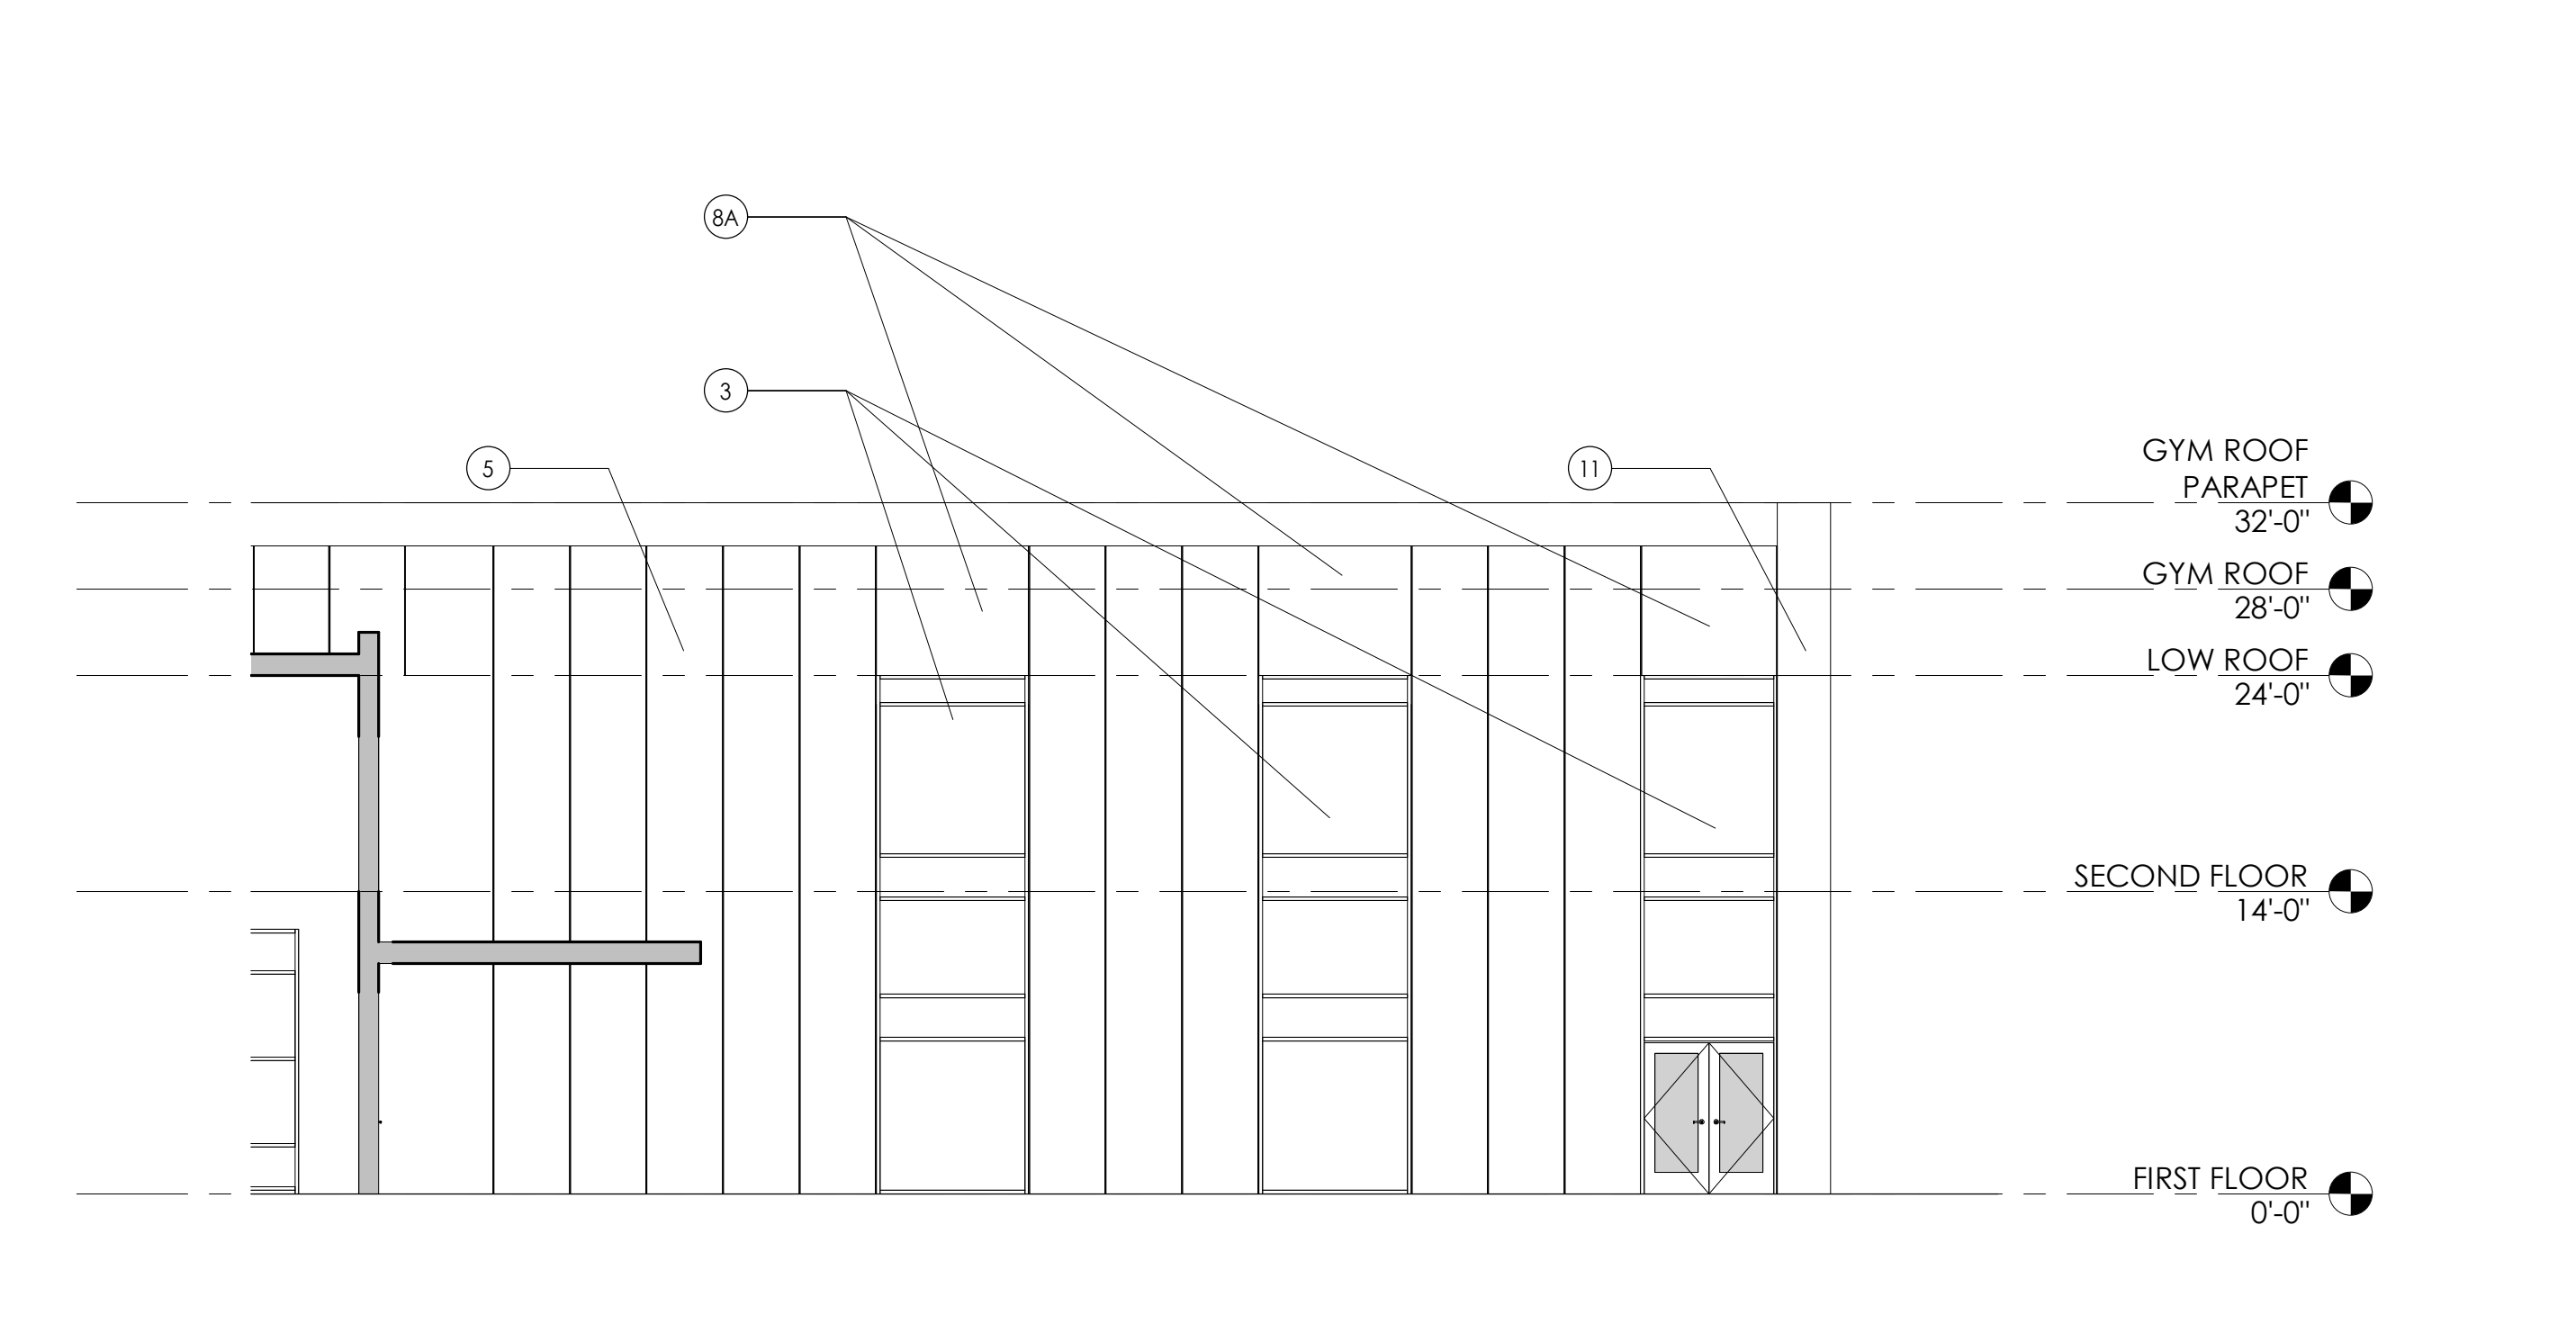

**5 EAST ELEVATION 04**  
A301 1/8" = 1'-0"

**FOR REVIEW ONLY  
NOT FOR PERMIT OR  
CONSTRUCTION**

### SHEET INFORMATION

Issue:  
05/04/2020  
SCHEMATIC DESIGN  
Drawn By: EAM Checked By: DWS  
Drawing Title:  
BUILDING ELEVATIONS