### TOWN OF FAIRFAX STAFF REPORT

#### **Department of Planning and Building Services**

**TO:** Planning Commission December 14, 2023

**FROM:** Linda Neal, Principal Planner

**LOCATION:** 38 Tamalpais Rd.; APN # 001-122-16 **ZONING:** RD 5.5-7 Residential Zone, High Density

**PROJECT:** Two-story addition to the rear of an existing single-family residence


expand the dining room on the first floor and add a pantry, laundry.

area and second story playroom.

**ACTION:** Conditional Use Permit (CUP); Application # 23-34

**APPLICANT:** Joseph Hewlings **OWNER:** Same as applicant

**CEQA STATUS:** Categorically exempt, § 15301(e)

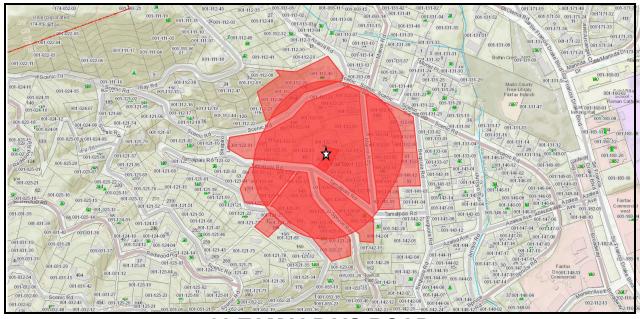

### 38 TAMALPAIS ROAD ASSESSOR'S PARCEL NO. 001-122-16

#### PROJECT DESCRIPTION

The project includes construction of a two-story addition to the rear, north side, of the existing two-bedroom, two-bathroom, single-family residence including a second story playroom and a first-floor dining room expansion, pantry, and laundry area. The addition will increase the residence square-footage from approximately 1,060 square-feet to approximately 1,325 square-feet.

#### BACKGROUND

The site is developed with a single-family residence that was constructed in 1920. Records show that a room was built over the detached garage in 1947 and was

converted into an accessory dwelling as early as 1955. There is a second accessory building at the northeast corner of the property.

The first mention of there being a second accessory structure in addition to the garage/apartment in the property records was in March of 1973 in a resale report. Guest houses not containing cooking facilities and not rented or otherwise used for operating a business were permitted accessory uses in all three of the residential zones throughout Fairfax from 1960 through March of 1973, when such uses became legal non-conforming. After that construction of new guest houses required approval of a conditional use permit by the Planning Commission.

#### DISCUSSION

The project complies with the regulations for the RD 5.5-7 Residential Zone, High Density, as follows:

	Front Setback	Rear Setback	Combined Front/rear Setback	Side Setbacks	Combined Side Setbacks	FAR	Coverage	Height
Required/ Permitted	6 ft.	12 ft.	35 ft.	5 ft. & 5 ft.	20 ft.	.40	.35	35 ft., 3 stories
Existing	13 ft.	2 ft.	15 ft.	1 ft. & 2 ft.	3 ft.	.31	.33	25 ft., 2 stories
Proposed	No change	No change	No change	No change	No change	.37	.32	No change

The applicant is reducing the lot coverage of the site from .37 to .32 by replacing twenty-eight square feet of paved patio on the east side of the residence with a permeable surface.

The project does not constitute a fifty percent remodel as defined in Town Code section 17.008.020, Definitions, Fifty Percent Remodel, and it does not include the addition of a bedroom. Therefore, the proposal does not require Planning Commission approval of a parking variance or of a Design Review Permit. The project is being proposed in an area that is already disturbed by a deck so it will not require the removal of any trees subject to the Fairfax Tree Ordinance (Town Code Chapter 8.36), or a tree removal permit from the Planning Commission with a prior recommendation from the Fairfax Tree Committee (Town Code 8.36.090).

The proposed addition will not project into any required setback, nor will it result in the site exceeding the permitted 35% lot coverage limit or the 40% floor area ratio (FAR) limit [Town Code § 17.040.010 and §17.136.030(A)]. The owner is proposing to remove 136 square-feet of impervious patio and walkway areas as part of the project which will decrease the lot coverage of the site slightly (from .333 to .327).

The height limit for sites that slope down from the street with an average slope above 10% is thirty-five feet and three stories. At twenty-five feet in height and only two stories, the structure complies with the thirty-five-foot height limit (Town Code § 17.084.060(A)(2).

Note: The underfloor area below the house's first floor does not count as a story as it is unimproved, not subdivided and the ceiling height is five feet (less than the seven feet required for living space by the Uniform Building Code).

New windows are proposed on the west and north sides of the first story of the addition and on the east, north and west sides of the addition second story. Due to the large setbacks being maintained by the proposed addition, the location of the existing two-story garage/ADU structure at the northwest corner of the residence, and the differences in elevation of the addition to the houses to the east and west of the site, staff does not believe the windows will impact the neighbor's privacy. If there are concerns about the windows on the east side of the second story addition negatively impacting the privacy of residents in the closest house east of the site at 36 Tamalpais Road or using the outdoor space the Commission can consider adding a condition to the Resolution approving the project that the windows on the east side of the second floor of the addition be opaque to let in light and filter views out.

#### **Nothern Spotted Owl**

The site is not located within \( \frac{1}{4} \) mile of any known Northern Spotted Owl nesting site.

#### Conditional Use Permit (CUP) (Town Code Chapter 17.032)

The site is approximately 4,550 square-feet in size, approximately forty-four feet wide and has an average slope of about 30.7%. Town Code 17.084.050(C) requires a Conditional Use Permit (CUP or a Hill Area Residential Development permit be secured from the Planning Commission for any use, occupancy, or physical improvement of, or on, a building site failing to meet certain requirements. A site with a slope of thirty-one percent must be a minimum of 22,000 square-feet in size and 110-feet wide to meet the minimum size requirements. While a small portion of the front of the site is in a multiple landslides zone, most of the site, including the area where the addition is proposed, is out of any area identified as having landslide hazards (Attachment B- section of General Plan Map S-3, Areas Susceptible to Landslides). Also, the project will only involve the excavation of 5.6 cubic yards of materials. Therefore, the project is not subject to either Town Code § 17.072.020(A)(4) or (B) and requires the approval of a CUP.

Other homes in the immediate neighborhood on similar sized and sloped properties maintain similar setbacks with many structures built up to property lines or maintaining setbacks of zero to three feet for accessory structures and less than 5 feet for main residences which were permitted for lots that were less than fifty feet wide between 1931 until 1973. The addition does not change any of the existing setbacks currently maintained by structures on the site.

New light fixtures are proposed as follows: two on the west side of the addition on either side of the two new windows and one on the north side of the addition. The fixtures will be dark sky compliant (see reduced plan sheets A302 and A701).

#### CUP Findings [Town Code § 17.032.060(A) through (D)]

To approve a CUP, the Planning Commission must be able to make the following findings (Staff's suggested findings follow the required findings in bold italicized font):

The approval of the use permit shall not constitute a grant of special privilege and shall not contravene the doctrines of equity and equal treatment.

SIMILAR SIZED AND	SLOPED SITES WITHIN 1,000 FEE	T OF PROJECT SITE					
APN#	ADDRESS	LOT SIZE	HOUSE SIZE	# BEDROOMS	# BATHS	GARAGE	FAR
001-023-01	542 Scenic Rd.	4500	1444	2	2	0	.32
001-023-08	103 Redwood Rd.	4600	1418	3	2	0	.32
001-023-15	129 Redwood Rd.	4675	720	2	1	0	.15
001-025-13	60 Redwood Rd.	4250	2150	3	2.5	280	.51
001-051-03	412 Scenic Rd.	4000	990	2	2	0	.25
001-051-12	300 Scenic Rd.	4050	2065	4	2	0	.51
001-053-20	107 Spruce Rd.	4408	1152	3	2	0	.26
001-053-34	71 Spruce Rd.	4420	1018	3	2	0	.23
001-053-46	9 Berry Trail	4410	1664	4	2	0	.38
001-053-50	35 Berry Trail	4725	1209	2	2	0	.26
001-054-09	223 Tamalpais Rd.	4950	1053	2	2	0	.21
001-054-18	239 Tamalpais Rd.	4600	1574	3	2	442	.34
001-113-01	34 Acacia Rd.	4800	2575	4	3.5	0	.54
001-113-02	30 Acacia Rd.	4900	1441	3	2	0	.29
001-121-01	185 Scenic Rd.	4500	2235	3	3	470	.50
001-121-25	142 Tamalpais Rd.	4200	1041	2	1	0	.25
001-122-11	124 Manor Rd.	4500	1064	2	1	408	.24
001-122-12	130 Manor Rd.	4500	1588	3	2	0	.35
001-122-15	36 Tamalpais Rd.	4383	858	1	1	0	.20
001-122-25	87 Scenic Rd.	4750	1560	4	2	0	.33
001-122-27	106 Manor Rd.	4800	1297	2	1.5	0	.27
001-123-07	47 Tamalpais Rd.	4000	1392	3	2	0	.35
001-123-33	135 Tamalpais Rd.	4200	1618	3	2	0	.39
001-123-34	51 Tamalpais Rd.	4950	814	2	1	528	.16
001-124-08	38 Redwood Rd.	4800	1168	2	1	0	.24
001-124-10	48 Redwood Rd.	5000	2132	4	1	0	.43
001-125-04	29 Redwood Rd.	4275	1454	3	2	0	.34
001-125-18	17 Redwood Rd.	4550	836	2	1	0	.18
001-125-19	444 Scenic Rd.	4500	1699	2	2	640	.38
PROJECT SITE		•		•	•		
001-122-16	38 Tamalpais Rd.	4500	1661	3	3	198	.37

Residences throughout the immediate neighborhood range in size from a 720 square-foot, two-bedroom, one-bathroom, single-family residence with a floor area ratio of .15 (129 Redwood Road) to a 2,575 square-foot, four bedroom three and one-half bathroom residence with a floor are ratio of .54 (34 Acacia Road). The proposed 1,606 square foot, two-bedroom, two-bathroom single-family residence on the 38 Tamalpais Road site that is also developed with an ADU, and accessory office/studio space proposes an FAR of .37 which will not be out of character with developments on similar sized and sloped properties in the immediate neighborhood. See chart below.

The development and use of property as approved under the use permit shall not cause excessive or unreasonable detriment to adjoining properties or premises, or cause adverse physical or economic effects thereto, or create undue or excessive burdens in the use and enjoyment thereof, or any or all of which effects are substantially beyond that which might occur without approval or issuance of the use permit.

The proposed addition does not constitute a 50% remodel/expansion, does not add bedrooms that would increase the capacity of the residence to house additional residents, and does not encroach into any of the required setbacks or exceed the permitted floor area ratio or lot coverage limitations. Therefore, the project will not cause excessive or unreasonable detriment to adjoining properties.

Approval of the use permit is not contrary to those objectives, goals, or standards pertinent to the particular case and contained or set forth in any Master Plan, or other plan or policy, officially adopted by the City.

The proposed addition does not change the residential character of the building or use of the property and therefore, the proposal is not contrary to the objectives goals or standards contained in 2010-2030 Fairfax General Plan as follows:

Policy LU-7.1.5: New and renewed residential development shall preserve and enhance the existing characteristics of the Town's neighborhoods in their diverse architectural style, size, and mass.

Policy LU-7.2.1: New and renewed development shall be compatible with the general design and scale of structures in the vicinity.

Approval of the use permit will result in equal or better development of the premises than would otherwise be the case, and that said approval is in the public interest and for the protection or enhancement of the general health, safety, or welfare of the community.

The proposed addition at the rear of the structure will maintain the existing streetscape and will not change the height of the existing building. Therefore, the proposed addition will result in equal or better development of premises than might otherwise be the case and is in the public interest.

### Other Agency/Department Comments/Conditions Ross Valley Sanitary District (RVSD)

Ross Valley Sanitary District is requiring that a contractor video all laterals serving the property prior to the project final inspection and submit it to the District with the required fee and form.

#### **Ross Valley Fire Department**

Ross Valley Fire Department indicated that the project would require approval and issuance of a National Fire Protection Association (NFPA) 13-D fire sprinkler system in addition to their standard conditions which can be viewed in their entirely in attached Resolution No. 2023-35

#### Marin Municipal Water District (MMWD)

MMWD had no specific conditions for this project and their standard conditions have been included and can be read in their entirety in the attached Resolution No. 2023-35.

Fairfax Police Department, Public Works Department, Building Department No comments were received from the Police Department, Public Works Department or Building Department.

#### RECOMMENDATION

Conduct the public hearing.

Move to approve Application # 23-24 by adopting Resolution No. 2023-35 setting forth the findings and conditions for the project approval.

#### **ATTACHMENTS**

A - Resolution No. 2023-35

B – Section of General Plan Map S-3, Areas Susceptible to Landslides C – Site topographic Map

Plans

#### **RESOLUTION NO. 2023-35**

A Resolution of the Fairfax Planning Commission Approving Application
No. 23-34 for a Conditional Use Permit for the Construction of an Addition to the
Existing Single-family Residence at 38 Tamalpais Road

**WHEREAS**, the Town of Fairfax received an application on September 12, 2023, for a two-story addition to the existing two-bedroom, two bathroom, single-family residence of a first floor dining room expansion, and remodel to add a pantry and laundry area and a second story play room, increasing the residence square footage from 1,060 square-feet to approximately 1,325 square-feet.

**WHEREAS**, the Planning Commission held a duly noticed Public Hearing on December 14, 2023, at which time the Planning Commission determined that the project complies with the Town Code and that findings can be made to grant the requested Conditional Use Permit (CUP):

**WHEREAS**, the project is exempt from the California Environmental Quality Act per Categorical Exemption §§ 15301(e); and

The project is consistent with the 2010-2030 Fairfax General Plan as follows:

Policy LU-7.1.5: New and renewed residential development shall preserve and enhance the existing character of the Town's neighborhoods in diverse architectural style, size, and mass.

Policy LU-7.2.1: New and renewed development shall be compatible with the general design and scale of structures in the vicinity.

**Whereas,** The Planning Commission has made the following required findings to support the approval of the Conditional Use Permit and the project.

Conditional Use Permit Findings (Town Code § 17.032.060)

Residences throughout the immediate neighborhood range in size from a 720 square-foot, two-bedroom, one-bathroom, single-family residence with a floor area ratio of .15 (129 Redwood Road) to a 2,575 square-foot, four bedroom three and one-half bathroom residence with a floor are ratio of .54 (34 Acacia Road). The proposed 1,606 square foot, two-bedroom two-bathroom single-family residence on the 38 Tamalpais Road site that is also developed with an ADU, and accessory office/studio space proposes a FAR of .37, will not be out of character.

The proposed addition does not constitute a 50% remodel/expansion, does not add bedrooms that would increase the capacity of the residence to house additional residents, and does not encroach into any of the required setbacks or exceed the permitted floor area ratio or lot coverage limitations. Therefore, the project will not cause excessive or unreasonable detriment to adjoining properties.

The proposed addition does not change the residential character of the building or use of the property and therefore, the proposal is not contrary to the objectives goals or standards contained in 2010-2030 Fairfax General Plan as follows:

Policy LU-7.1.5: New and renewed residential development shall preserve and enhance the existing characteristics of the Town's neighborhoods in their diverse architectural style, size, and mass.

Policy LU-7.2.1: New and renewed development shall be compatible with the general design and scale of structures in the vicinity.

The proposed additions at the rear of the structure will maintain the existing streetscape and will not change the height of the existing building. Therefore, the proposed addition will result in equal or better development of premises than might otherwise be the case and is in the public interest.

**WHEREAS**, the Planning Commission approved the project subject to the applicant's compliance with the following conditions:

- 1. The project is approved per the plans prepared by Joseph Hewlings dated received by the Town on November 22, 2023.
- 2. The project is subject to the following conditions of approval:
  - a) Prior to issuance of any of the building permits for the project the applicant or his assigns shall submit a detailed construction management plan subject to approval of the Public Works Director. The plan shall include but is not limited to the following:
    - i. Construction delivery routes approved by the Department of Public Works;
    - ii. Construction schedule (deliveries, worker hours, etc);
    - iii. Notification to area residents:
    - iv. Emergency access routes;
    - v. Construction worker staging area; and,
    - vi. Contractor employee parking locations.
- 3. The applicant shall prepare and file with the Public Works Director, a video of the roadway conditions on the public construction delivery routes (routes to be preapproved by the Public Works Director).
- 4. Submit a cash deposit, bond, or letter of credit to the Town in an amount that will cover the cost of grading, weatherization, and repair of possible damage to public roadways. The applicant shall submit contractor's estimates for any grading, site weatherization, and improvement plans for approval by the Town Engineer. Upon approval of the contract costs, the applicant shall submit a cash deposit, bond or letter of credit equaling 100% of the estimated construction costs.

- 5. The foundation elements shall be designed by a structural engineer certified as such in the state of California. Plans and calculations of the foundation elements shall be stamped and signed by the structural engineer and submitted to the satisfaction of the Town Structural Engineer.
- 6. The grading and foundation elements shall be stamped and signed by the site Geotechnical Engineer as conforming to the recommendations made by the project Geotechnical Engineer.
- 7. During the construction process the following shall be required:
  - a. The Geotechnical Engineer and/or the Civil Engineer shall be on-site during the grading process and prior to installation of foundation forms shall submit written certification to Town staff that the grading has been completed as designed and recommended.
  - b. Prior to the concrete form inspection by the building official, the Civil Engineer shall field check the forms of the foundations and provide written certification to Town staff that the work to this point has been completed in conformance with their recommendations and the approved building plans.
  - c. The Building Official shall field check the concrete forms prior to the pour.
  - d. All construction-related vehicles including equipment delivery, cement trucks, and construction materials shall always be situated off the travel lane of the adjacent public right(s) of way. This condition may be waived by the Building Official on a case-by-case basis with prior notification from the project sponsor.
  - e. Any proposed temporary closures of a public right of way shall require prior approval by the Fairfax Police Department and any necessary traffic control, signage or public notification shall be the responsibility of the applicant or his/her assigns. Any violation of this provision will result in a stop work order being placed on the property and issuance of a citation.
- 8. Prior to issuance of an occupancy permit the following shall be completed:
  - a. The Geotechnical Engineer shall field check the completed project and submit written certification to Town Staff that the grading and foundation elements have been installed in conformance with the approved building plans.
- Excavation shall not occur between October 1st and April 1st of any year. The Town Engineer has the authority to waive this condition depending upon the weather.

- 10. The roadways shall be kept free of dust, gravel, and other construction materials by sweeping them daily, if necessary.
- 11. Any changes, modifications, additions, or alterations made to the approved set of plans will require a modification of Application # 23-34. Modifications that do not significantly change the project, the project design or the approved discretionary permits *may* be approved by the Planning Director or the Planning Commission. Any construction based on job plans that have been altered without the benefit of an approved modification of Application # 23-34 will result in the job being immediately stopped and red tagged.
- 12. Any damage to the public portions of Tamalpais Road, Manor Road, Olema Road, or other public roadway used to access the site resulting from construction-related activities shall be the responsibility of the property owner.
- 13. The applicant and its heirs, successors, and assigns shall, at its sole cost and expense, defend with counsel selected by the Town, indemnify, protect, release, and hold harmless the Town of Fairfax and any agency or instrumentality thereof, including its agents, officers, commissions, and employees (the "Indemnitees") from any and all claims, actions, or proceedings arising out of or in any way relating to the processing and/or approval of the project as described herein, the purpose of which is to attack, set aside, void, or annul the approval of the project, and/or any environmental determination that accompanies it, by the Planning Commission, Town Council, Planning Director, or any other department or agency of the Town. This indemnification shall include, but not be limited to, suits, damages, judgments, costs, expenses, liens, levies, attorney fees or expert witness fees that may be asserted or incurred by any person or entity, including the applicant, third parties and the Indemnitees, arising out of or in connection with the approval of this project, whether or not there is concurrent, passive, or active negligence on the part of the Indemnitees. Nothing herein shall prohibit the Town from participating in the defense of any claim, action, or proceeding. The parties shall use best efforts, acting in good faith, to select mutually agreeable defense counsel. If the parties cannot reach agreement, the Town may select its own legal counsel and the applicant agrees to pay directly, or timely reimburse on a monthly basis, the Town for all such court costs, attorney fees, and time referenced herein, provided, however, that the applicant's duty in this regard shall be subject to the Town's promptly notifying the applicant of any said claim, action, or proceeding.
- 14. The applicant shall comply with all applicable local, county, state and federal laws and regulations. Local ordinances which must be complied with include but are not limited to the following: the Noise Ordinance, Chapter 8.20, Polystyrene Foam, Degradable and Recyclable Food Packaging, Chapter 8.16, Garbage and Rubbish Disposal, Chapter 8.08, Urban Runoff Pollution Prevention, Chapter 8.32, and the Americans with Disabilities Act.

- 15. In accordance with Town Code §8.20.060(C)(1) and (2), the operation of any tools or equipment used in construction or demolition work or in property maintenance work between the hours of 6:00 PM and 8:00 AM Monday through Friday, or on weekends and holidays between 4:00 PM and 9:00 AM is prohibited.
- 16. Conditions placed upon the project by outside agencies or by Town Departments may be eliminated or amended with that agency's or the Town Engineer's written notification to the Planning Department prior to issuance of the building permit.
- 17. Any new exterior fixtures that are installed as part of the project must be dark sky compliant (fully shielded and emit no light above the horizontal plane with no sag or drop lenses, side light panels or upplight panels) as well as compliance with color temperature to minimize blue rich lighting. The lighting plan shall be submitted with the building permit application and be approved by the Planning Department prior to issuance of the project building permit. The lighting shall not emit direct offsite illumination and shall be the minimum necessary for safety.

#### Ross Valley Sanitary District (RVSD) Condition

18. A plumbing contractor must video all laterals serving the property prior to the project final inspection and submit it to the District with the required fee and form.

#### **Ross Valley Fire Department (RVFD) Conditions**

- 19. All vegetation and construction materials are to be maintained away from the residence during construction.
- 20. A class A roof assembly is required.
- 21. A fire sprinkler system shall be installed throughout the house which complies with the requirements of the National Fire Protection Association (NFPA) 13-R and local standards. Separate deferred permits shall be required for these systems. Plans and specifications for the system shall be submitted by an individual or firm licensed to design and /or design-build sprinkler systems.
- 22. All smoke detectors in the residence shall be provided with AC power and be interconnected for simultaneous alarm. Detectors shall be located in each sleeping room, outside of each sleeping room in a central location in the corridor, with a minimum of one detector on each story of the occupied portion of the residence.
- 23. Carbon monoxide alarms shall be provided in existing dwellings when a permit is required for alterations, repairs, or addition and the cost of the permit exceeds \$1,000.00. Carbon monoxide alarms shall be located outside of each sleeping area in the immediate vicinity of the bedrooms and on every level of the dwelling, including basements.
- 24. Address numbers at least 4" tall must be in place adjacent to the front door. If not clearly visible from the street, additional numbers are required. Address numbers

- shall be internally illuminated or illuminated by an adjacent light controlled by a photocell and switched only by a breaker so it will remain illuminated all night.
- 25. Alternative materials or methods may be proposed for any of the above conditions in accordance with Section 103.3 of the Fire Code.
- 26. All approved alternatives requests, and their supporting documentation, shall be included in the plan sets submitted for final approval by the Fire Department.

#### Marin Municipal Water District (MMWD) Conditions

- 27. All indoor and outdoor requirements or District Code Title 13, Water Conservation must be complied with.
- 28. Backflow prevention requirements must be met.
- 29. All the District's rules and regulations in effect at the time service is requested must be complied with.

**NOW, THEREFORE BE IT RESOLVED**, the Planning Commission of the Town of Fairfax hereby finds and determines as follows:


The approval of the Conditional Use Permit conforms to the 2010-2030 Fairfax General Plan and is in compliance with the Fairfax Zoning Ordinance, Town Code Title 17; and


Construction of the project can occur without causing significant impacts on neighboring residences and the environment.

The foregoing resolution was adopted at a regular meeting of the Planning Commission held in said Town, on the 14th day of December 2023 by the following vote:

AYES: NOES: ABSTAIN: ABSENT:		
Attest:	Chair Cindy Swift	
Jeffrey Beiswenger, Director	of Planning and Building Services	

### SECTION FROM 2010-2030 FAIRFX GENERAL PLAN MAP S-3 INCLUDING 38 TAMALPAIS ROAD

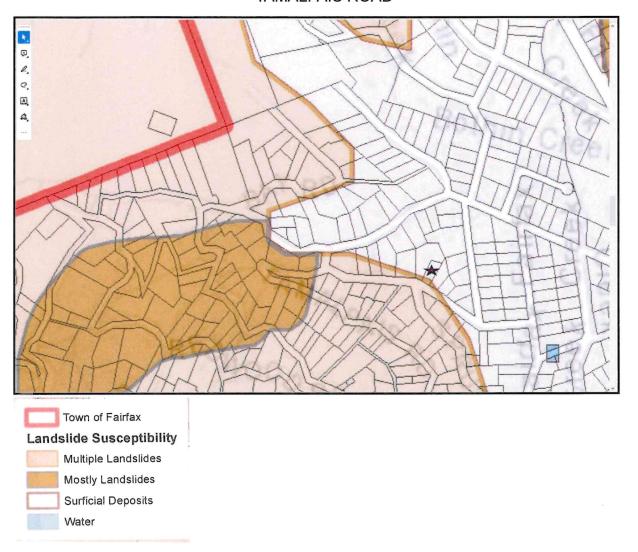

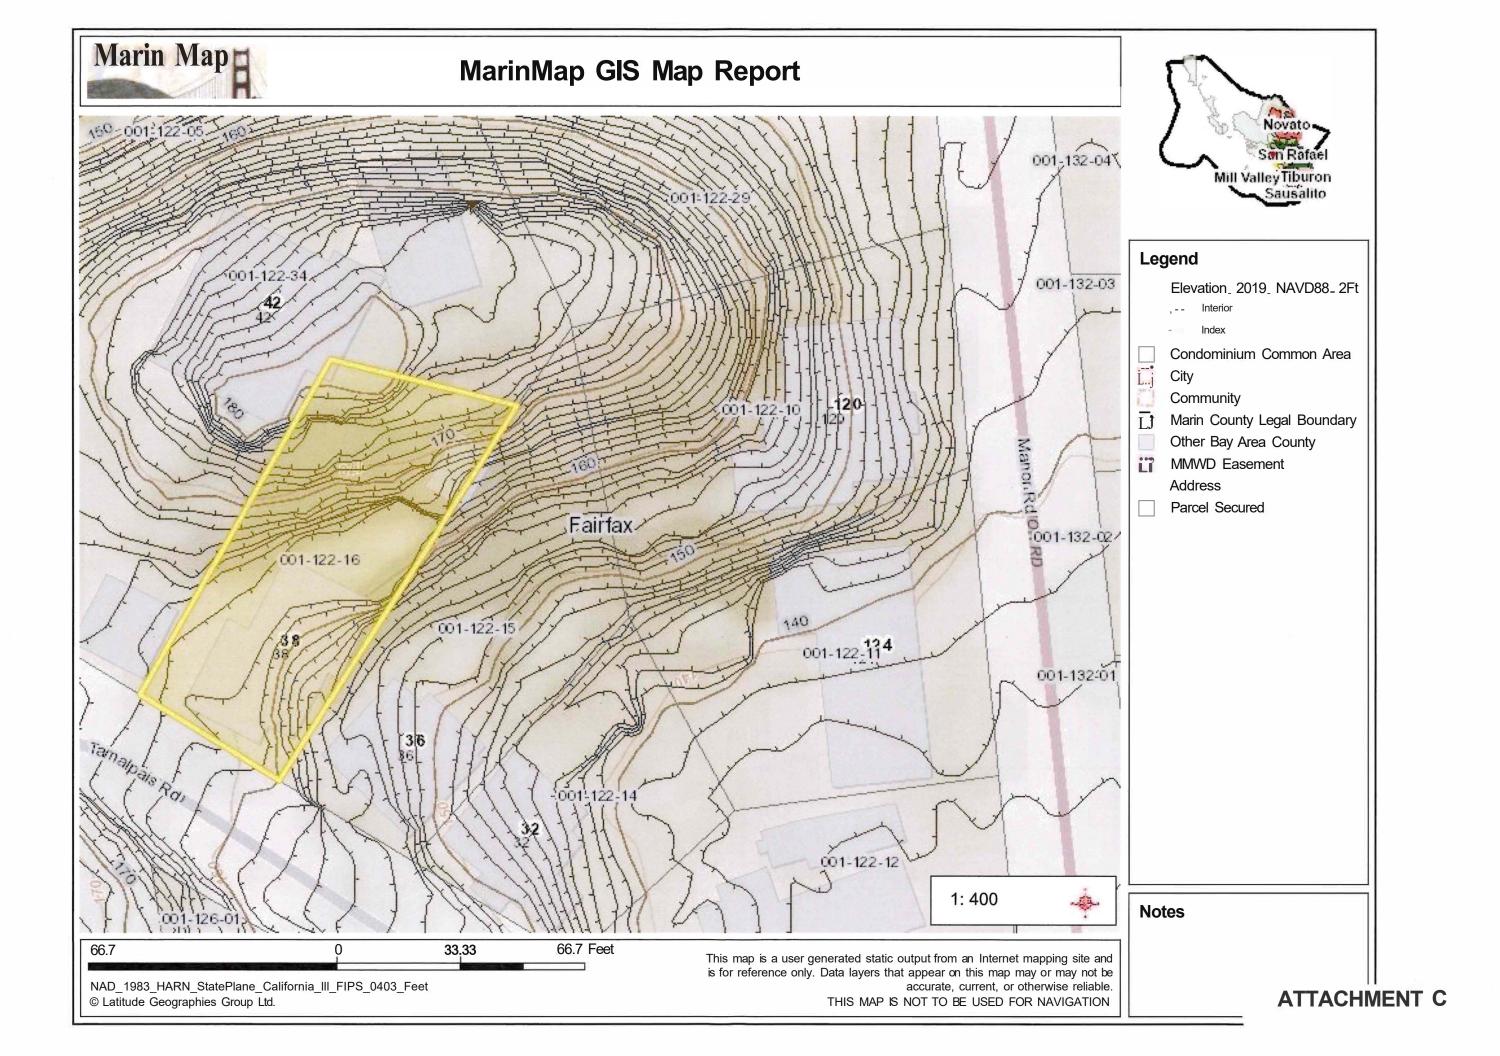

NO. N.T.S. O/ O.A. O.C. PLWD. P.T. QTY REF.

R.W.L. S.A.D. SHT. SIM. S.S. S.S.D. STD. SQ. STL. STOR.

T&B T.B.D.

TEL. TYP. U.O.N V.I.F.

W/ WD. W/D

W.H. W/O

OVERALL ON CENTER

QUANTITY

RISER

SIMILAR STAINLESS STEEL

STANDARD

SQUARE

STORAGE

WOOD

WASHER DRYER

WATER HEATER WITHOUT

SYMMETRICAL TREAD

TOP AND BOTTOM

TO BE DETERMINED TELEPHONE

UNLESS OTHERWISE NOTED VERIFY IN FIELD

PLYWOOD PRESSURE TREATED

RAIN WATER LEADER
SEE ARCHITECTURAL DRAWINGS

SEE STRUCTURAL DRAWINGS

REFRIGERATOR

AT ABOVE FINISH FLOOR APPROXIMATELY

ALL THREADED ROD

BEAM BLOCKING

BOTTOM BETWEEN

CLOSET

CEILING

CONCRETE

DEDICATED

DIAMETER

DOWN

EACH

EXISTING

EDGE NAIL

EXTERIOR

FLOOR

**FOOTING** 

GAUGE

FINISH FLOOR

GALVANIZED GYPSUM BOARD

HANGER HORIZONTAL

INTERIOR

MAXIMUM

MINIMUM

MECHANICAL

TZIOL

HOT DIPPED GALVANIZED

CONTINUOUS DOUBLE

CLEAR

A.F.F. APPROX.

ATR
BM.
BLKG.
BOT.
BTWN.
CLO.
CLG.
CONT.
DBL.
DED
DIA.
DN
(E)
EA.

EN. EXT. F.F.

F.F. FL. FTG. GA. GALV. GYP. BD. H.D.G. HGR. HOR. INT. JST.

MECH

MIN.

1 VICINITY MAP

#### SYMBOLS

SIM	DETAIL
A101)	Detail Numl
$\smile$	Sheet Numb











1 Ref	
A101 2	EXTE
Alone	- Shee
1 Ref <del>≪</del>	— Deta

**ELEVATION HEIGHT** 

(101)

DOOR TAG

ROOM TAG Number Area

#### 1 WINDOW TAG REVISION TAG Name 150 SF

## NUMBER NOT TO SCALE

#### PROJECT INFORMATION

38 TAMALPAIS RD, FAIRFAX, CA 94930 **ADDRESS** JURISDICTION TOWN OF FAIRFAX

ASSESSOR'S PARCEL NO. 001-122-16 ZONING DISTRICT RD5.5 - 7

**USE DESCRIPTION** RESIDENTIAL

R-3 (ONE OR TWO UNIT RESIDENTIAL) OCCUPANCY TYPE

CONSTRUCTION TYPE V-B

NUMBER OF STORIES 2 STORIES OVER BASEMENT

AVERAGE LOT SLOPE 30.74%

PARKING (2) TANDEM SPACES, EACH 9' x 19' x 7'

#### **EXCAVATION AND FILL**

5.6 CU.YD EXCAVATION FILL N/A OFF-HAUL 5.6 CU.YD

#### **BUILDING AREAS AND HEIGHTS**

	EXISTING	PROPOSED	MAXIMUM
LOT AREA	4,550 SF	4,550 SF	N/A
LOT COVERAGE	1,513 SF	1,489 SF	1,593 SF
COVERAGE RATIO	0.333	0.327	0.35
TOTAL FLOOR AREA	1,399 SF	1,663 SF	1,820 SF
FLOOR AREA RATIO	0.31	0.37	0.40
BUILDING HEIGHT	25'-6"	26'-5"	35'-0"

#### **ROOM SCHEDULES**

AREA

EXISTING ROOM SCHEDULE	
NAME	LEVEL
(E) BATHROOM 1	LEVEL 1
(E) BATHROOM 2	LEVEL 1

(E) BATHROOM 1	LEVEL 1	59 SF
(E) BATHROOM 2	LEVEL 1	1 44 SF
(E) BEDROOM 1	LEVEL 1	133 SF
(E) BEDROOM 2	LEVEL 1	118 SF
(E) DINING ROOM	LEVEL 1	117 SF
(E) HALL	LEVEL 1	92 SF
(E) KITCHEN	LEVEL 1	112 SF
(E) LIVING ROOM	LEVEL 1	234 SF
		909 SF
(E) ADU BEDROOM	LEVEL 2	117 SF
(E) ADU KITCHEN	LEVEL 2	72 SF
(E) BEDROOM 3	LEVEL 2	153 SF
(E) STUDIO/OFFICE	LEVEL 2	147 SF
		490 SF
		1 1399 SF

PROPOSED ROOM SCH	EDULE	
NAME	LEVEL	AREA
(E) BATHROOM 1	LEVEL 1	59 SF
(E) BATHROOM 2	LEVEL 1	44 SF
(E) BEDROOM 1	LEVEL 1	133 SF
(E) BEDROOM 2	LEVEL 1	118 SF
(E) HALL	LEVEL 1	92 SF
(E) KITCHEN	LEVEL 1	112 SF
(E) LIVING ROOM	LEVEL 1	234 SF
(N) DINING ROOM	LEVEL 1	226 SF
		1018 SF
(E) ADU BEDROOM	LEVEL 2	117 SF
(E) ADU KITCHEN	LEVEL 2	72 SF
(E) BEDROOM 3	LEVEL 2	1 153 SF
(E) STUDIO/OFFICE	LEVEL 2	147 SF
(N) PLAYROOM	LEVEL 2	156 SF
		645 SF
		1 1663 SF

#### **PROJECT TEAM**

OWNERS (MAIN CONTACT) NICOLE AND JOSEPH HEWLINGS 38 TAMALPAIS RD, FAIRFAX CA 94930 T: 628-800-2152 / 916-396-9512

E: MORTHAM.HEWLINGS@GMAIL.COM

STRUCTURAL ENGINEER DANIEL BARRINGER, P.E.

CONTRACTOR

101 S FEDERAL HWY #129 BOYNTON BEACH, FL 33435 CALIFORNIA LICENCE #68,258 T: 415-863-8900 E: DANIEL@BARRINGERDESIGN.COM

TO BE DETERMINED



#### PROJECT DESCRIPTION

TWO STORY REAR ADDITION. NET INCREASE OF 264 SF OF HABITABLE SPACE INCLUDING A SECOND FLOOR PLAYROOM AND EXTENSION OF EXISTING ADDITION OF PANTRY OFF EXISTING KITCHEN AND LAUNDRY FACILITIES IN DINING ROOM.

#### **APPLICABLE CODES**

2022 CALIFORNIA BUILDING CODE	(TITLE 24, PART 2)
2022 CALIFORNIA ELECTRICAL CODE	(TITLE 24, PART 3)
2022 CALIFORNIA MECHANICAL CODE	(TITLE 24, PART 4)
2022 CALIFORNIA PLUMBING CODE	(TITLE 24, PART 5)
2022 CALIFORNIA ENERGY CODE	(TITLE 24, PART 6)
2022 CALIFORNIA GREEN BUILDING CODE	(TITLE 24, PART 11, "CALGREEN
	WHAT TO COME AND THE THE TAX AND ADDRESS AND THE

WITH TOWN OF FAIRFAX AMENDMENTS

#### SHEET LIST

SHEET NUMBER	SHEET NAME
A001	PROJECT DETAILS
A002	GENERAL NOTES
A003	GREEN BUILDING MEASURES
A004	GREEN BUILDING MEASURES
A101	SITE PLANS
A102	STORY POLE PLAN
A201	EXISTING FLOOR PLANS
A202	PROPOSED FLOOR PLANS
A203	ROOF PLANS
A301	SOUTH AND EAST ELEVATIONS
A302	north and west elevations
A303	STREETSCAPES
A401	SECTIONS
A501	MORNING SHADE STUDIES
A502	NOON SHADE STUDIES
A503	AFTERNOON SHADE STUDIES
A600	SCHEDULES
A701	EXTERIOR FINISHES
7701	EXTERIOR TIMOTIES

38 TAMALPAIS RD FAIRFAX, CA 94930 628-800-2152

PLANS BY JOSEPH HEWLINGS

**NOT FOR** 

CONSTRUCTION

8

**38 TAMALPAIS** CA 94930 REAR ADDITION,


-122-FAIRFAX, 00 APN:

DATE: 09/11/23 SCALE: As Noted

REV DESCRIPTION DATE

SHEET NAME:

PROJECT DETAILS

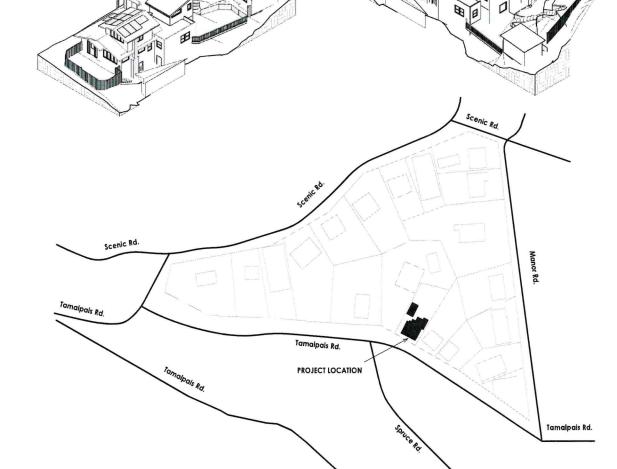



### California 2022 CALIFORNIA GREEN BUILDING STANDARDS CODE RESIDENTIAL MANDATORY MEASURES, SHEET 1 (January 2023)

N/A PPLICABLE
RESPON. PARTY = RESPONSIBLE PARTY (w: ARCHITECT, ENGINEER, OWNER CONTRACTOR INSPECTOR ETC.) CHAPTER 3 1.106.4.2 New multifamily dwellings, hotels and motels and new residential parking facilities. When parking is provided, parking spaces for new multifamily dwellings, hotels and motels shall meet the oquirements of Sections 4.108.4.2.1 and 4.108.4.2.C aclausiations for spaces shall be rounded up to the nearest whole number. A parking space served by electric vehicle supply equipment or designed as a future EV charging space shall count as at least one standard automobile parking space only for the purpose of complying with any applicable minimum parking space requirements established by a local jurisdiction. See Vehicle Code Section 22 or truther details. 4.304 OUTDOOR WATER USE
4.304.1 OUTDOOR POTABLE WATER USE IN LANDSCAPE AREAS. Residential developments shall comply with a local water efficient landscape ordinance or the current California Department of Water Resources' Model Water Efficient Landscape Ordinance (MWELO), whichever is more stringent. **GREEN BUILDING** 4.106.4.2.4 Identification.

The service panel or subpanel circuit directory shall identify the overcurrent protective device space(s future EV charging purpose as "EV CAPABLE" in accordance with the California Electrical Code. SECTION 301 GENERAL 301.1 SCOPE. Buildings shall be designed to include the green building measures specified as mandatory in the application checklists contained in this code. Voluntary green building measures are also included in the application checklists and may be included in the design and construction of structures covered by this code but are not required unless adopted by a city, county, or city and county as specified in Section 101.7. 4.106.4.2.5 Electric Vehicle Ready Space Signage.
Electric vehicle ready spaces shall be identified by signage or pavement markings, in compliance with Caltrant Traffic Operations Policy Directive 13-01 (Zero Emission Vehicle Signs and Pavement Markings) or its The Model Water Efficient Landscape Ordinance (MWELO) is located in the California Code Regulations, Title 23, Chapter 2.7, Division 2. MWELO and supporting documents, including water budget calculator, are .105.4.2.1Multifamily development projects with less than 20 dwalling units; and hotels and motels with less nan 20 sleeping units or guest rooms.

The number of dwelling units, sleeping units or guest rooms shall be based on all buildings on a project site subject to 301.1.1 Additions and alterations. [HCD] The mandatory provisions of Chapter 4 shall be applied to 4.106.4.3 Electric vehicle charging for additions and alterations of parking facilities serving existing multifamily buildings.
When I were parking facilities are added, or electrical systems or lighting of existing parking facilities are added or altered and the work requires a building permit, len (10) percent of the total number of parking spaces added or altered shall be electric vehicle charging spaces (EV spaces) capable of supporting future Level 2 EVSE. additions or alterations of existing residential buildings where the addition or alteration increases the building's conditioned area, volume, or size. The requirements shall apply only to and/or within the specific area of the addition or alteration. DIVISION 4.4 MATERIAL CONSERVATION AND RESOURCE **EFFICIENCY** The mandatory provision of Section 4.106.4.2 may apply to additions or alterations of existing parking facilities or the addition of new parking facilities serving existing multifamily buildings. See Section 4.106.4.3 for application. 4.406 ENHANCED DURABILITY AND REDUCED MAINTENANCE .406.1 RODENT PROOFING. Annular spaces around pipes, electric cables, conduits or other openings in sole/bottom plates at exterior walls shall be protected against the passage of rodents by closing such openings with cement morfar, concrete masonry or a similar method acceptable to the enforcing Note: Repairs including, but not limited to, resurfacing, restriping and repairing or maintaining existing lighting fixtures are not considered alterations for the purpose of this section. The service panel or subpanel circuit directory shall identify the overcurrent protective device space(s) resent for future EV charging purposes as "EV CAPABLE" in accordance with the California Electrical Code. Note: On and after January 1, 2014, residential buildings undergoing permitted alterations, additions, c improvements shall replace noncompliant plumbing fixtures with water-conserving plumbing fixtures. Plumbing fixture replacement is required prior to issuance of a certificate of intal completion, certificate of accupancy or final permit approval by the local building department. See Civil Code Section 1101.1, et seq. for the definition of a noncompliant plumbing fixture, types of residential buildings affected and 4.408 CONSTRUCTION WASTE REDUCTION, DISPOSAL AND RECYCLING
4.408.1 CONSTRUCTION WASTE MANAGEMENT. Recycle and/or salvage for reuse a minimum of 65
percent of the non-hazardous construction and demolition waste in accordance with either Section
4.406.2, 4.406.3 or 4.408.4, or meet a mi DIVISION 4.2 ENERGY EFFICIENCY 1 When EV chargers (Level 2 EVSE) are installed in a number equal to or greater than the required number of EV capable spaces. 4.201.1 SCOPE. For the purposes of mandatory energy efficiency standards in this code, the California Energy Commission will continue to adopt mandatory standards. 2.When EV chargers (Level 2 EVSE) are installed in a number less than the required number of EV capable spaces, the number of EV capable spaces required may be reduced by a number equal to the number of EV chargers installed. 301.2 LOW-RISE AND HIGH-RISE RESIDENTIAL BUILDINGS. [HCD] The provisions of the provisions of the provision Excavated soil and land-clearing debris.
 Riternate waste reduction methods developed by working with local agencies if diversion or recycle facilities capable of compliance with this item do not exist or are not located reasonably close to the jobsite.
 The enforcing agency may make exceptions to the requirements of this section when isolated jobsites are located in areas beyond the hauf boundaries of the diversion facility. DIVISION 4.3 WATER EFFICIENCY AND CONSERVATION individual sections of CALGreen may apply to either low-rise residential buildings high-rise residential buildings high-rise residential buildings, or both. Individual sections will be designated by banners to indicate where the section applies specifically to low-rise only (LR) or high-rise only (HR). When the section applies to both low-rise and high-rise buildings, no banner will be used. 4.303 INDOOR WATER USE
4.303.1 WATER CONSERVING PLUMBING FIXTURES AND FITTINGS. Plumbing fixtures (water closets and urinals) and fittings (faucets and showerheads) shall comply with the sections 4.303.1.1, 4.303.1.2, 4.303.1.3. a.Construction documents are intended to demonstrate the project's capability and capacity for facilitating future EV charging. b. There is no requirement for EV spaces to be constructed or available until receptacles for EV charging of EV charges are installed for the SECTION 302 MIXED OCCUPANCY BUILDINGS Note: All noncompliant plumbing fixtures in any residential real property shall be replaced with water-conserving plumbing fixtures. Plumbing fixture replacement is required prior to issuance of a certificate of final completion, certificate of occupancy, or final parmit approved by the local building department. See Civil Code Section 1101.1, et seq., for the definition of a noncompliant plumbing fixture, types of residential buildings affected and other important enactment dates. 302.1 MIXED OCCUPANCY BUILDINGS. In mixed occupancy buildings, each portion of a building shall comply with the specific green building measures applicable to each specific occupancy. 2.EV Ready. Twenty-five (25) percent of the total number of parking spaces shall be equipped with low power Level Z EV charging receptacles. For mulifamily parking facilities, no more than one receptacle is required per dwelling until when more than one parking space is provided for use by a single dwelling until. Identify the construction and demolition waste materials to be diverted from disposal by recycling, rouse on the project or salvage for future use or sale.
 Specify (nonstruction and demolition waste materials will be sorted on-site (source separated) or tions:
1. [HCD] Accessory structures and accessory occupancies serving residential buildings shall HCU) Accessory structures and accessory occupancies serving residential buildings shall comply with Chapter 4 and Appendix AI, as applicable.
 HCDI For purposes of CALGreen, livelwork units, complying with Section 419 of the Califor-Building Code, shall not be considered mixed occupancies. Liva/Work units shall comply with Chapter 4 and Appendix AA, as applicable. 4.303.1.1 Water Closets. The effective flush volume of all water closets shall not exceed 1.28 gallons per flush. Tank-type water closets shall be certified to the performance criteria of the U.S. EPA WaterSense Specification for Tank-type Tolets. 4.106.4.2.2 Multifamily development projects with 20 or more dwelling units, hotels and motels with 20 or mo sleeping units or guest rooms.
The number of welling units, sleeping units or guest rooms shall be based on all buildings on a project site subject to taken.

4. Identify construction methods employed to reduce the amount of construction and demolition waste Note: The effective flush volume of dual flush toilets is defined as the composite, average flush volume of two reduced flushes and one full flush. **DIVISION 4.1 PLANNING AND DESIGN** generated.

Specify that the amount of construction and demolition waste materials diverted shall be calculated by weight or volume, but not by both. ABBREVIATION DEFINITIONS: 4.303.1.2 Urinals. The effective flush volume of wall mounted urinals shall not exceed 0.125 gallons per flush The effective flush volume of all other urinals shall not exceed 0.5 gallons per flush. 1.EV Capable. Ten (10) percent of the total number of parking spaces on a building site, provided for all types of parking facilities, shall be electric vehicle charging spaces (EV spaces) capable of supporting future Level 2 EVSE. Electrical load calculations shall demonstrate that the electrical panel service capacity and electrical system, including any on-site distribution transformer(s), have sufficient capacity to simultaneously charge all EVs at all required EV spaces at a minimum of 40 amperes. Department of Housing and Community Developm California Building Standards Commission Division of the State Architect, Structural Safety Office of Statewide Health Planning and Developm 4.408.3 WASTE MANAGEMENT COMPANY. Utilize a waste management company, approved by the enforcing agency, which can provide verifiable documentation that the percentage of construction and demolition waste material diverted from the landfill complies with Section 4.08.1. 4.303.1.3.1 Single Showerhead. Showerheads shall have a maximum flow rate of not more than 1.8 gallons per minute at 80 psi. Showerheads shall be certified to the performance criteria of the U.S. EPA WaterSense Specification for Showerheads. **Note:** The owner or contractor may make the determination if the construction and demolition waste materials will be diverted by a waste management company. itions and Alterations 4.303.1.3.2 Multiple showerheads serving one shower. When a shower is served by more than one showerhead, the combined flow rate of all the showerheads and/or other shower outlets controlled by a single valve shall not exceed 18, gallons per minute at 80 psi, or the shower shall be designed to only allow one shower outlet to be in operation at a time. .408.4 WASTE STREAM REDUCTION ALTERNATIVE [LR]. Projects that generate a total combined weight of construction and demolition waste disposed of in landfills, which do not exceed 3.4 lbs.lsq.ft. of the building area shall meet the minimum 65% construction waste reduction requirement in Section 4.408.1 Exception: When EV chargers (Level 2 EVSE) are installed in a number greater than five (5) percent of parking spaces required by Section 4.106.4.2.2. Item 3. the number of EV capable spaces required may reduced by a number equal to the number of EV chargers installed over the five (5) percent required. RESIDENTIAL MANDATORY MEASURES 4.408.4.1 WASTE STREAM REDUCTION ALTERNATIVE. Projects that generate a total combined weight of construction and demolition waste disposed of in landfills, which do not exceed 2 pounds per square foot of the building area, shall meet the minimum 65% construction waste reduction requirement in Section 4.408.1 SECTION 4.102 DEFINITIONS
4.102.1 DEFINITIONS
The following terms are defined in Chapter 2 (and are included here for reference) a. Construction documents shall show locations of future EV spaces 4 303 1.4 Faucets b.There is no requirement for EV spaces to be constructed or available until receptacles for EV charging or EV chargers are installed for use. FRENCH DRAIN. A trench, hole or other depressed area loosely filled with rock, gravel, fragments of brick or simila pervious material used to collect or channel drainage or runoff water. 2.EV Ready. Twenty-five (25) percent of the total number of parking spaces shall be equipped with low power Lovel 2 EV charging receptacles. For multifamily parking facilities, no more than one receptacle is required per 4.303.1.4.2 Lavatory Faucets in Common and Public Use Areas. The maximum flow rate of lavatory faucets installed in common and public use areas (outside of dwellings or sleeping units) in residential buildings shall not exceed 0.5 gallons per minute at 60 ps. Sample forms found in "A Guide to the California Green Building Standards Code (Residential)" located at www.hod.ca.gov/CALGreen.html may be used to assist in documenting compliance with this section.
 Maxed construction and demolition debris (C. A. D) processors can be located at the California Department of Resources Recycling and Recovery (California). Exception: Areas of parking facilities served by parking lifts. 4.303.1.4.3 Metering Faucets. Metering faucets when installed in residential buildings shall not deliver more than 0.2 gallons per cycle. 3.EV Chargers. Five (5) percent of the total number of parking spaces shall be equipped with Level 2 EVSE. Where common use parking is provided, at least one EV charger shall be located in the common use parking area and shall be available for use by all residents or guests. 4.106 SITE DEVELOPMENT 1. GENERAL. Preservation and use of available natural resources shall be accomplished through evaluation and careful planning to minimize negative effects on the site and adjacent areas. Preservation of slopes, management of storm water drainage and erosion controls that complete the 4.303.1.4.4 Kitchen Faucets. The maximum flow rate of kitchen faucets shall not exceed 1.8 gallons per minute at 60 psi. Kitchen faucets may temporarily increase the flow above the maximum rate, but not to exceed 2.2 gallons per minute at 60 psi, and must default to a maximum flow rate of 1.8 gallons per minute at 60 psi. When low power Level 2 EV charging receptacles or Level 2 EVSE are Installed beyond the minimum required an automatic load management system (ALMS) may be used to reduce the maximum required electrical capacity to each space served by the ALMS. The electrical system and any on-site distribution transformers shall have sufficient capacity to deliver at least 3.3 kW simultaneously to each EV charging station (EVCS) served by the ALMS. The branch crucit shall have a minimum capacity of 04 ampers, and installed EVSE shave a capacity of 104 less than 30 amperes. ALMS shall not be used to reduce the minimum required electrical capacity to the required EV capable spaces. 4.106.2 STORM WATER DRAINAGE AND RETENTION DURING CONSTRUCTION. Projects which disturb less than one acre of soil and are not part of a larger common plan of development which in total disturbs one acr 2 STORM WATER DRAINAGE AND RETENTION DURING CONSTRUCTION. Projects which disturbless than one acre of soil and are not part of a larger common plan of development which in load is disturbless one acre or more, shall manage storm water drainage during construction. In order to manage storm water drainage during construction, one or more of the following measures shall be implemented to prevent flooding of adjact property, prevent erosion and retain soil runoff on the site. Note: Where complying faucets are unavailable, aerators or other means may be used to achieve Directions to the owner or occupant that the manual shall remain with the building throughout the life cycle of the structure.

Operation and maintenance instructions for the following:

 a. Equipment and appliances, including water-saving devices and systems, HVAC systems, photovoltalic systems, electric vehicle chargers, water-heating systems and other major appliances and equipment.

 Bod on day yard drainage, including gutters and downspouts.

 Space conditioning systems, including condensers and air filters. Retention basins of sufficient size shall be utilized to retain storm water on the site.
 Where storm water is conveyed to a public drainage system, collection point, guiter or similar disposal method, water shall be littered by use of a barner system, wattle or other method apply the enforcing agency.
 Compliance with a lawfully enacted storm water management ordinance. 4.106.4.2.2.1 Electric vehicle charging stations (EVCS).
Electric vehicle charging stations required by Section 4.106.4.2.2, Item 3, shall comply with Section 4.106.4.2.2.1. FOR REFERENCE ONLY: The following table and code section have been reprinted from the California Code of Regulations, Title 20 (Appliance Efficiency Regulations), Section 1605.1 (h)(4) and Section 1605.3 (h)(4)(4). Exception: Electric vehicle charging stations serving public accommodations, public housing, motels and hotels shall not be required to comply with this section. See California Building Code, Chapter 118, for applicable pace conditioning systems, including condensers and air filters
 Landscape inglation systems.
 Water reuse systems.
 Information from local utility, water and waste recovery providers on methods to further reduce resource consumption, including recycle programs and locations.
 Public transportation and/or carpotol options available in the area.
 Educational material or the positive impacts of an interior relative humidity between 30-60 percent and what methods are occupant may use to maintain the relative humidity level in that range.
 Information about water-conserving landscape and ritration design and controllates within a surface. Note: Refer to the State Water Resources Control Board for projects which disturb one acre or more of soil, or are part of a larger common plan of development which in total disturbs one acre or more of soil. 4.106.4.2.2.1.1 Location.
EVCS shall comply with at least one of the following options: /ebsite: https://www.waterboards.ca.gov/water\_issues/programs/stormwater/construction.html TABLE H-2 1.106.3 GRADING AND PAVING. Construction plans shall indicate how the site grading or drainage system will manage all surface water flows to keep water from entering buildings. Examples of methods to manage surfact water include, but are not limited to, the following: 1. The charging space shall be located adjacent to an accessible parking space meeting the requirements of the California Building Code, Chapter 11A, to allow use of the EV charger from the accessible parking space STANDARDS FOR COMMERCIAL PRE-RINSE SPRAY 2. The charging space shall be located on an accessible route, as defined in the California Building Code, Chapter 2, to the building. VALUES MANUFACTURED ON OR AFTER JANUARY 28, 2019 water.

Instructions for maintaining gutters and downspouts and the importance of diverting water at least 5 feet away from the foundation.

Information on required routine maintenance measures, including, but not limited to, caulking, painting, grading around the building, etc.

Information about state solar energy and incentive programs available.

O. A copy of all special inspections verifications required by the enforcing agency or this code.

Information and residencing limited in Foreity and Fire Protection on maintenance of defensible increases are on residentified into the contractions. Swales
 Water collection and disposal systems
 French drains
 Water retention gardens
 Water retention gardens
 Water retention gardens Product Class 1 (≤ 5.0 ozf) 4.106.4.2.2.1.2 Electric vehicle charging stations (EVCS) dimensions.

The charging spaces shall be designed to comply with the following: Product Class 2 (> 5.0 ozf and ≤ 8.0 ozf) 4.106.4 Electric vehicle (EV) charging for new construction. New construction shall comply with Sections 4,106.4.1 or 4,106.4.2 to facilitate future installation and use of EV chargers. Electric vehicle supply continuous (EVSF) whall be installated in accordance with the Colifornia Electrical Code, Article 625. Product Class 3 (> 8.0 ozf) 1. The minimum length of each EV space shall be 18 feet (5486 mm). 1.410.2 RECYCLING BY OCCUPANTS. Where 5 or more multifamily dwelling units are constructed on a building sile, provide readily accessible area(s) that serves all buildings on the site and are identified for the toposting, storage and collection of non-hazardous materials for recycling, including lat a minimum) paper, corrugated cardboard, glass, plastics, organic waster, and metals, or meet a lawfully enacted local recycling ridinance, if more restrictive. Title 20 Section 1605.3 (h)(4)(A): Commercial prerinse spray values manufactured on or after January 1. 2006. shall have a minimum spray force of not less than 4.0 ounces-force (ozf)[113 grams-force(gf)] 2.The minimum width of each EV space shall be 9 feet (2743 mm). 3.One in every 25 charging spaces, but not less than one, shall also have an 8-tool (2438 mm) wide minimum aisle. A 5-tool (1524 mm) wide minimum aisle shall be permitted provided the minimum width of the EV space is 12 leat (1355 mm). stlons:

1. On a case-by-case basis, where the local enforcing agency has determined EV charging and infrastructure are not feasible based upon one or more of the following conditions;

1.1 Where there is no local utility power supply or the local utility is unable to supply adequate dings. Submeters shall be installed to measure water usage of individual rental dwelling units in accordance with the California Plumbing Code. Exception: Rural jurisdictions that meet and apply for the exemption in Public Resources Code Section 42648.82 (a)(2)(A) et seq. are note required to comply with the organic waste portion of this section. power.

1.2 Where there is evidence suitable to the local enforcing agency substantiating that addition local utility infrastructure design requirements, directly related to the implementation of Section 4.106.4, may adversely impact the construction cost of the project.

2. Accessory Dwelling Units (ADU) and Junior Accessory Dwelling Units (JADU) without additions parking flacities. a. Surface slope for this EV space and the aisle shall not exceed 1 unit vertical in 48 units horizontal (2.083 4.303.3 Standards for plumbing fixtures and fittings. Plumbing fixtures and fittings shall be installed in accordance with the Galiflornia Plumbing Code, and shall meet the applicable standards referenced in Tabl 1701.1 of the California Plumbing Code. 4.106.4.2.2.1.3 Accessible EV spaces. In addition to the requirements in Sections 4.106.4.2.2.1.1 and 4.106.4.2.2.1.2, all EVSE, when installed, shall comply with the accessibility provisions for EV chargers in the California Building Code. Chapter 11B. EV ready spaces and EVCS in multifarmity developments shall comply with California Building Code, Chapter 11A. Section 1109A. DIVISION 4.5 ENVIRONMENTAL QUALITY NOTE: THIS TABLE COMPILES THE DATA IN SECTION 4.303.1, AND IS INCLUDED AS A CONVENIENCE FOR THE USER. SECTION 4.501 GENERAL 4.10.4.1 New one- and two-tamity dwellings and townhouses with situacined private garages. For each dwelling unit, install a listed raceway to accommodate a dedicated 200/240-voil branch circuit. The raceway service or subparel and shall terminate into a listed cabinet, box or other enclosure in close proximity to the proposed location of an EV charger. Raceways are required to be continuous at enclosed, inaccessible or concealed areas and spaces. The service panel and/or subpanel shall provide capacity to install a 40-ampere 208/240-voil minimum dedicated branch circuit and space(s) reserved to permit installation of a branch circuit overcurent with the contraction of the proposed to the continuous and the contraction of the 4.106.4.2.3 EV space requirements.
1.Single EV space requirements.
1.Single EV space required. Install a listed raceway capable of accommodating a 208/240-volt dedicated branch circuit. The raceway shall not be less than trade size 1 (nominal 1-inch inside diameter). The raceway shall originate at the main service or subpanel and shall terminate into a listed cabinet, box or enclosure in close proximity to the location or the proposed location of the EV space. Construction documents shall identify the raceway termination point, receptacle or charger location, as applicable. The service panel and/ or subpanel sha have a 40-apper minimum declared branch circuit, including branch circuit overcurrent protective device installed, or space(s) reserved to permit installation of a branch circuit overcurrent protective device. the provisions of this chapter shall outline means of reducing the quality of air contaminants that are odorous, ritating and/or harmful to the comfort and well being of a building's installers, occupants and neighbors. TABLE - MAXIMUM FIXTURE WATER USE SECTION 4.502 DEFINITIONS SHOWER HEADS (RESIDENTIAL) AGRIFIBER PRODUCTS. Agrifiber products include wheatboard, strawboard, panel substrates and door cores, not including furniture, fixtures and equipment (FF&E) not considered base building elements. MAX. 1.2 GPM @ 60 PSI MIN. 0.8 GPM @ 20 LAVATORY FAUCETS (RESIDENTIAL) COMPOSITE WOOD PRODUCTS. Composite wood products include hardwood plywood, particleboard and medium densitly fiberboard. "Composite wood products" does not include hardboard, structural plywood, structural panels, structural composite lumber, oriented strand board, glued laminated rimber, prefabricated wood l-joists or finger-jointed lumber, all as specified in California Code of regulations (CCR), title 17, Section 93120, 1. LAVATORY FAUCETS IN COMMON & PUBLIC 0.5 GPM @ 60 PSI USE AREAS 4.106.4.1.1 Identification. The service panel or subpanel circuit directory shall identify the overcurrent protective device space(s) reserved for future EV charging as "EV CAPABLE". The raceway terminate location shall be permanently and visibly marked as "EV CAPABLE". 2. Multiple EV spaces required. Construction documents shall indicate the raceway termination point and the location of installed or future EV spaces, receptacles or EV chargers. Construction documents shall also provide information on amperage of installed or future receptacles or EVE. Exceway methods), whiring schematics and electrical load calculations. Plan design shall be based upon a 40-amper minimum branch circuit. Required raceways and related components that are planned to be installed underground, enclosed, inscressible or in KITCHEN FAUCETS 1.8 GPM @ 60 PS METERING FAUCETS 0.2 GAL/CYCLE

PLANS BY

JOSEPH HEWLINGS

38 TAMAL PAIS RD FAIRFAX, CA 94930 628-800-2152

#### **NOT FOR** CONSTRUCTION

# AIS

# AMALP DITION 0 $\triangleleft$

REV DESCRIPTION DATE

DATE: 09/11/23

SCALE:

GREEN BUILDING MEASURES

DISCLAMMEN: THIS DOCUMENT IS PROVIDED AND INTENDED TO BE USED AS A MEANS TO INDICATE AREAS OF COMPLIANCE WITH THE CALIFORNIA GREEN BUILDING STANDARDS (CAL GREEN CODE. DUE TO THE VARIABLES BETWEEN BUILDING DEPARTMENT JURISDICTIONS. THIS CHECKLIST IS TO BE USED AN A MEANS TO INDICATE AREAS OF COMPLIANCE WITH THE USE OF THIS DOCUMENT. INCLUDING VERIFICATION WITH THE FULL CODE

WATER CLOSET

1.28 GAL/FLUSH

0.125 GAL/FLUSH

DIRECT-VENT APPLIANCE. A fuel-burning appliance with a sealed combustion system that draws all air for ombustion from the outside atmosphere and discharges all flue gases to the outside atmosphere.

### California 2022 CALIFORNIA GREEN BUILDING STANDARDS CODE

RESIDENTIAL MANDATORY MEASURES, SHEET 2 (January 2023)

Y = YES
NA = NOT APPLICABLE
RESPON PARTY = RESPONSIBLE PARTY (M: ARCHITECT, ENGINEER
OUNDS CONTRACTOR MISSELTYDE ETC.)

**INSTALLER & SPECIAL INSPECTOR QUALIFICATIONS** 

702.1 INSTALLER TRAINING. HVAC system installers shall be trained and certified in the proper installation of HVAC systems including ducts and equipment by a nationally or regionally recognized training or certification program. Uncertified persons may perform HVAC installations when under the direct supervision and responsibility of a person trained and certified to install HVAC systems or contractor icensed to install HVAC system. Stamples of acceptable HVAC training and certification programs include but are not limited to the following:

State certified apprenticeship programs.
 Public utility training programs.
 Toblic utility training programs.
 Training programs sponsored by trade, labor or statewide energy consulting or verification organizations.
 Frograms apposered by manufacturing organizations.
 Other programs acceptable to the enforcing agency.

702.2 SPECIAL INSPECTION [HCD]. When required by the enforcing agency, the owner or the responsible entity acting as the owner's agent shall employ one or more special inspectors to provide inspection or other duties necessary to substantiate complence with this code. Special inspectors shall demonstrate complence to the satisfaction of the enforcing agency for the particular type of inspection or task to be performed. In addition to other certifications or qualifications acceptable to the enforcing agency, when evaluating the qualifications of a special inspector.

Certification by a national or regional green building program or standard publisher.
Certification by a statewide energy consulting or verification organization, such as HERS raters, building performance contractors, and home energy audition organization, such as HERS raters, building performance contractors, and home energy auditions groups are such as the superposition of a third party apprentice training program in the appropriate trade.

Other programs acceptable to the enforcing appearcy.

Notes:
1. Special inspectors shall be independent entities with no financial interest in the materials or the project they are inspecting for compliance with this code.
2. HERS raters are special inspectors carlifed by the California Energy Commission (CEC) to rate homes in California according to the Home Energy Rating System (HERS).

[BSC]. When required by the enforcing agency, the owner or the responsible entity acting as the owner's agent shall employ one or more special inspectors to provide inspection or other duties necessary to substantiate compliance with this code. Special inspectors shall demonstrate compliance with this code. Special inspectors shall demonstrate compliance with this code. Special inspectors that demonstrate compliance with the particular type of inspection or task to be performed. In addition, the special inspector shall have a certification from a recognized state, national or international association, as determined by the local agency. The area of certification shall be closely related to the primary job function, as determined by the local agency.

Note: Special inspectors shall be independent entities with no financial interest in the materials or the project they are inspecting for compliance with this code.

703.1 DOCUMENTATION. Documentation used to show compliance with this code shall include but is not itied to, construction documents, plans, specifications, builder or installer certification, inspection reports, or other outmentation or special inspection is necessary to verify compliance, that method of compliance will be specified in appropriate section or identified applicable checklist.

CHAPTER 7

**702 QUALIFICATIONS** 

703 VERIFICATIONS

IAXIMUM INCREMENTAL REACTIVITY (MIR). The maximum change in weight of ozone formed by adding a ompound to the "Base Reactive Organic Gas (ROG) Mixture" per weight of compound added, expressed to underedths of a gram (g 0°/g ROC). tote: MIR values for individual compounds and hydrocarbon solvents are specified in CCR, Title 17, Sections 94700 MOISTURE CONTENT. The weight of the water in wood expressed in percentage of the weight of the oven-dry wood PRODUCT-WEIGHTED MIR (PWMIR). The sum of all weighted-MIR for all ingredients in a product subject to this article. The PWMIRI is the total product reactivity expressed to hundredths of a gram of ozone formed per gram of product (excluding container and packaging). Note: PVMMIR is calculated according to equations found in CCR, Title 17, Section 94521 (a). REACTIVE ORGANIC COMPOUND (ROC). Any compound that has the potential, once emitted, to contribute to VOC. A volatile organic compound (VOC) broadly defined as a chemical compound based on carbon chains or rings with vapor pressures greater than 0.1 millimeters of mercury at room temperature. These compounds typically contain hydrogen and may contain oxygen, nitrogen and other etherents See CCR Tille 17, Section 345060; and OF TREF LAND in stalled gas firepiace shall be a direct-vent sealed-combustion type. Any installed tove or pellet stove shall comply with U.S. EPA New Source Performance Standards (NSPS) emission limits as able, and shall have a permanent label indicating laby are certified to meet the emission limits. Woodstoves, stoves and fireplaces shall also comply with applicable local ordinances. 4.504 POLLUTANT CONTROL
4.504.1 COVERING OF DUCT OPENINGS & PROTECTION OF MECHANICAL EQUIPMENT DURING
CONSTRUCTION. At the time of rough installation, during storage on the construction site and until final
startup of the heating, cooling and ventilating equipment, all duct and other related air distribution component
openings shall be covered with lape, plastic, sheat metal or other methods acceptable to the enforcing agency to
reduce the amount of water, dust or orbors which may enter the system. 4,504.2 FINISH MATERIAL POLLUTANT CONTROL. Finish materials shall comply with this section. Adhesives, adhesive bonding primers, adhesive primers, sealants, sealant primers and caulks shall comply with local or regional air pollution control or air quality management district nices where applicable or SCAGMD Rule 1186 VOC limits, as shown in Table 4.50.4 n or 4.50.4 as applicable. Such products also shall comply with the Rule 1186 prohibition on the use of certain toxic compounds (chloroform, ethylene dichlorids, emltylene chlorids, perchloroethylene and tricloroethylene), except for aerosol products, as specified in Subsection 2 below. Aerosol adhesives, and smaller unit sizes of adhesives, and sealant or caulking compounds (in units of product, less packaging, which do not weigh more than 1 pound and do not consist of more than 16 fluid ourses) shall comply with statewide VOC standards and other requirements, including prohibitions on use of certain toxic compounds, of California Code of Regulations, Title 17, commencing with section 94507. 4.594.2.2 Paints and Coatings. Architectural paints and coatings shall comply with VOC limits in Table 1 of the ARB Architectural Suggested Control Measure, as shown in Table 4.504.3, unless more stringent local limit apply. The VOC content limit for coatings that do not meet the definitions for the specialty coatings categories listed in Table 4.504.3 shall be determined by classifying the coating as a Flat, Nonflat or Nonflat-High Gloss coating, based on its gloss, as defined in subsections 4.21, 4.36 and 4.37 of the 2007 California Art Resources Board, Suggested Control Measure, and the corresponding Flat. Nonflat or Nonflat-High Gloss VOC limit in Table 4.504.3 shall apply. 4.504.2.3 Aerosol Paints and Coatings. Aerosol paints and coatings shall meet the Product-weighted MIR Limits for ROC in Section 9452(a)(2) and other requirements, including prohibitions on use of certain toxic compounds and ozone depleting substances, in Sections 94522(e)(1) and (i)(1) of California Code of Regulations, Title 17, commencing with Section 94520; and in areas under the production of the Bay Area Air Quality Management District additionally comply with the percent VOC by weight of product limits of Regulation 8, Rule 49

4.504.2.4 Verification. Verification of compliance with this section shall be provided at the request of the enforcing agency. Documentation may include, but is not limited to, the following:

Manufacturer's product specification.
 Field verification of on-site product containers.

ARCHITECTURAL APPLICATIONS NDOOR CARPET ADHESIVES

OUTDOOR CARPET ADHESIVES WOOD FLOORING ADHESIVES RUBBER FLOOR ADHESIVES SUBELOOR ADHESIVES

CARPET PAD ADHESIVES

FRAMIC TILE ADHESIVES VCT & ASPHALT TILE ADHESIVES RYWALL & PANEL ADHESIVES

OVE BASE ADHESIVES

SPECIALTY APPLICATIONS VC WELDING

PLASTIC CEMENT WELDING

TOP & TRIM ADHESIVE

METAL TO METAL

ASTIC FOAMS

ADHESIVE PRIMER FOR PLASTIC CONTACT ADHESIVE

SPECIAL PURPOSE CONTACT ADHESIVE

STRUCTURAL WOOD MEMBER ADHESIVE

SUBSTRATE SPECIFIC APPLICATIONS

OROUS MATERIAL (EXCEPT WOOD)

1. IF AN ADHESIVE IS USED TO BOND DISSIMILAR SUBSTRATES TOGETHER THE ADHESIVE WITH THE HIGHEST VOC CONTENT SHALL BE ALLOWED FOR ADDITIONAL INFORMATION REGARDING METHODS TO MEASURE THE VOC CONTENT SPECIFIED IN THIS TABLE, SEE SOUTH COAST AIR QUALITY MANAGEMENT DISTRICT RULE 1168.

CPVC WELDING ABS WELDING

TABLE 4.504.1 - ADHESIVE VOC LIMIT12

Less Water and Less Exempt Compounds in Grams per Liter

TABLE 4.504.2 - SEALANT VOC LIMIT Less Water and Less Exempt Compounds in Grams per Liter SEALANTS ARCHITECTURAL ARINE DECK NONMEMBRANE ROOF SINGLE-PLY ROOF MEMBRANE SEALANT PRIMERS ARCHITECTURAL NON-POROUS MODIFIED BITUMINOU MARINE DECK

TABLE 4.504.3 - VOC CONTENT LIMITS FOR

COATING CATEGORY	VOC LIMIT
FLAT COATINGS	50
NON-FLAT COATINGS	100
NONFLAT-HIGH GLOSS COATINGS	150
SPECIALTY COATINGS	
ALUMINUM ROOF COATINGS	400
BASEMENT SPECIALTY COATINGS	400
BITUMINOUS ROOF COATINGS	50
BITUMINOUS ROOF PRIMERS	350
BOND BREAKERS	350
CONCRETE CURING COMPOUNDS	350
CONCRETE/MASONRY SEALERS	100
DRIVEWAY SEALERS	50
DRY FOG COATINGS	150
FAUX FINISHING COATINGS	350
FIRE RESISTIVE COATINGS	350
FLOOR COATINGS	100
FORM-RELEASE COMPOUNDS	250
GRAPHIC ARTS COATINGS (SIGN PAINTS)	500
HIGH TEMPERATURE COATINGS	420
INDUSTRIAL MAINTENANCE COATINGS	250
LOW SOLIDS COATINGS:	120
MAGNESITE CEMENT COATINGS	450
MASTIC TEXTURE COATINGS	100
METALLIC PIGMENTED COATINGS	500
MULTICOLOR COATINGS	250
PRETREATMENT WASH PRIMERS	420
PRIMERS, SEALERS, & UNDERCOATERS	100
REACTIVE PENETRATING SEALERS	350
RECYCLED COATINGS	250
ROOF COATINGS	50
RUST PREVENTATIVE COATINGS	250
SHELLACS	
CLEAR	730
OPAQUE	550
SPECIALTY PRIMERS, SEALERS & UNDERCOATERS	100
STAINS	250
STONE CONSOLIDANTS	450
SWIMMING POOL COATINGS	340
TRAFFIC MARKING COATINGS	100
TUB & TILE REFINISH COATINGS	420
WATERPROOFING MEMBRANES	250
WOOD COATINGS	275
WOOD PRESERVATIVES	350
ZINC-RICH PRIMERS	340

2. THE SPECIFIED LIMITS REMAIN IN EFFECT UNLESS REVISED LIMITS ARE LISTED IN SUBSEQUENT COLUMNS IN THE TABLE.

3. VALUES IN THIS TABLE ARE DERIVED FROM THOSE SPECIFIED BY THE CALIFORNIA AIR RESOURCES BOARD, ARCHITECTURAL COATINGS SUGGESTED CONTROL MEASURE, FEB. 1, 2008. MORE INFORMATION IS AVAILABLE FROM THE AIR RESOURCES BOARD. TABLE 4.504.5 - FORMALDEHYDE LIMITS: MAXIMUM FORMALDEHYDE EMISSIONS IN PARTS PER MILLION CURRENT LIMIT HARDWOOD PLYWOOD VENEER CORE 0.05 HARDWOOD PLYWOOD COMPOSITE CORE 0.05 PARTICLE BOARD 0.09 MEDIUM DENSITY FIRERROARD 0.11 THIN MEDIUM DENSITY FIBERBOARDS 0.13 VALUES IN THIS TABLE ARE DERIVED FROM THOSE SPECIFIED BY THE CALIF. AIR RESOURCES BOARD, AIR TOXICS CONTROL MEASURE FOR COMPOSITE WOOD AS TESTED IN ACCORDANCE WITH ASTM E 1333. FOR ADDITIONAL INFORMATION, SEE CALIF CODE OF REGULATIONS, TITLE 17, SECTIONS 93120 THROUGH

DIVISION 4.5 ENVIRONMENTAL QUALITY (continued)

CARPET SYSTEMS. All carpet installed in the building interior shall meet the requirements of the Castor irent of Public Health. Standard Method for the Testing and Evaluation of Volatile Organic Chemical Emis fonce Sources Using Environmental Chembers, Yesting 1.2, January 2017 (Emission testing method for forces of the Castor Chemical Chem

See California Department of Public Health's website for certification programs and testing labs

4.504.3.1 Carpet cushion. All carpet cushion installed in the building interior shall meet the requirements of the California Department of Public Health, "Standard Method for the Testing and Evaluation of Volatile Organic Chemical Emissions from Indoor Sources Using Environmental Chambers," Version 1.2, January 2017 (Emission testing method for California Spacification 01350)

See California Department of Public Health's website for certification programs and testing labs

https://www.cdph.ca.gov/Programs/CCDPHP/DEODC/EHLB/IAQ/Pages/VOC.aspx

4.504.3.2 Carpet adhesive. All carpet adhesive shall meet the requirements of Table 4.504.1

4.504.4 RESILIENT FLOORING SYSTEMS. Where resilient flooring is installed, at least 80% of floor area receiving resilient flooring shall meet the requirements of the California Department of Public Health: "Standard Method for the Testing and Evaluation of Volatile Organic Chemical Emissions from Indoor Sources Lising Environmental Chambers;" Version 1.2, January 2017 (Emission testing method for California Specification 01350)

See California Department of Public Health's website for certification programs and testing labs

htps://www.cdph.ca.gov/Programs/CCDPHP/DEODC/EHLB/IAQ/Pages/VOC.aspx

4.504.5 COMPOSITE WOOD PRODUCTS. Hardwood plywood, particleboard and medium density fiberboard composite wood products used on the interior or exterior of the buildings shall meet the requirements for ormatdehyde as specified in ARB's Air Toxics Control Measure for Composite Wood (17 CCR 93120 et seq.), y or before the dates specified in those sections, as shown in Table 4.504.5

Product certifications and specifications.

1. Product certifications and specureanume.
2. Chain of custody certifications.
3. Product labeled and invoiced as meeting the Composite Wood Products regulation (see CCR. Title 17. Section 93120. et seq.).
4. Exterior grade products marked as meeting the PS-1 or PS-2 standards of the Engineered Wood Association, the Australian AS/NS2 2269, European 636 SS standards, and Canadian CSA 0121, CSA 0151, CSA 0153 and CSA 0325 standards.
5. Other methods acceptable to the enforcing agency.

4.505 INTERIOR MOISTURE CONTROL
4.505.1 General. Buildings shall meet or exceed the provisions of the California Building Standards Code.

4.505.2 CONCRETE SLAB FOUNDATIONS. Concrete slab foundations required to have a vapor retarder by California Building Code, Chapter 19, or concrete slab-on-ground floors required to have a vapor retarder by the California Residential Code, Chapter 5, shall also comply with this section.

4.505.2.1 Capillary break. A capillary break shall be installed in compliance with at least one of the

- A 4-inch (101.6 mm) thick base of 1/2 inch (12.7mm) or larger clean aggregate shall be provided with a vapor barrier in direct contact with concrete and a concrete mix design, which will address bleeding, shrinkage, and criming, shall be used. For additional information, see American Concrete Institute. ACI 302.248-06.
- 4.505.3 MOISTURE CONTENT OF BUILDING MATERIALS. Building materials with visible signs of water damage shall not be installed. Wall and floor faming shall not be enclosed when the framing members exceed 19 percent moisture content. Moisture content shall be verified in compliance with the followers.
- Moisture content shall be determined with either a probe-type or contact-type moisture meter. Equivalent moisture verification methods may be approved by the enforcing agency and shall satisfy requirements found in Section 101.8 of this code.
   Moisture readings shall be taken at a point 2 feet (610 mm) to 4 feet (1219 mm) from the grade stamped er

At least three random moisture readings shall be performed on wall and floor framing with documentation acceptable to the enforcing agency provided at the time of approval to enclose the wall and floor framing

Insulation products which are visibly wet or have a high moisture content shall be replaced or allowed to dry prior to enclosure in wall or floor cavities. Wet-applied insulation products shall follow the manufacturers' drying recommendations prior to enclosure.

4.506 INDOOR AIR QUALITY AND EXHAUST
4.506.1 Bathroom exhaust fans. Each bathroom shall be mechanically ventilated and shall comply with the

- Fans shall be ENERGY STAR compliant and be ducted to terminate outside the building.
   Unless functioning as a component of a whole house ventilation system, fans must be controlled by a humidity control.
  - Humidity controls shall be capable of adjustment between a relative humidity range less than or equal to 50% to a maximum of 80%. A humidity control may utilize manual or automatic means of
  - adjustment.

    b. A humidity control may be a separate component to the exhaust fan and is not required to be integral (i.e., built-in)

1. For the purposes of this section, a bathroom is a room which contains a bathtub, shower or

4.507 ENVIRONMENTAL COMFORT
4.507.2 HEATING AND AIR-CONDITIONING SYSTEM DESIGN. Heating and air conditioning systems shall be

The heat loss and heat gain is established according to ANSI/ACCA 2 Manual J - 2011 (Residential Load Calculation), ASHRAE handbooks or other equivalent design software or methods.
 Duct systems are sized according to ANSI/ACCA 1 Manual D - 2014 (Residential Duct Systems), ASHRAE handbooks or other equivalent design software or methods.
 Select heating and cooling equipment according to ANSI/ACCA 3 Manual S - 2014 (Residential Equipment Selection), or methods.

Exception: Use of alternate design temperatures necessary to ensure the system functions are

PLANS BY

JOSEPH HEWLINGS

38 TAMALPAIS RD FAIRFAX, CA 94930 628-800-2152

#### **NOT FOR** CONSTRUCTION

ä

# AMALP **38** DDITION 4 EA



09/11/23

SCALE: As Noted

SHEET NAME

DATE:

GREEN BUILDING MEASURES

DISCLAIMER: THIS DOCUMENT IS PROVIDED AND INTENDED TO BE USED AS A MEANS TO INDICATE AREAS OF COMPLIANCE WITH THE CALFORMA GREEN BUILDING STANDARDS ICAL GREEN CODE. DUE TO THE VARIABLES BETWEEN BUILDING STANDARDS ICAL GREEN CODE. DUE TO THE VARIABLES BETWEEN BUILDING STANDARDS ICAL GREEN CODE. DUE TO THE VARIABLES BETWEEN BUILDING STANDARDS ICAL GREEN CODE. DUE TO THE VARIABLES BETWEEN BUILDING STANDARDS ICAL GREEN CODE. DUE TO THE VARIABLES BETWEEN BUILDING STANDARDS ICAL GREEN CODE. DUE TO THE VARIABLES BETWEEN BUILDING STANDARDS ICAL GREEN CODE. DUE TO THE VARIABLES BETWEEN BUILDING STANDARDS ICAL GREEN CODE. DUE TO THE VARIABLES BETWEEN BUILDING STANDARDS ICAL GREEN CODE. DUE TO THE VARIABLES BETWEEN BUILDING STANDARDS ICAL GREEN CODE. DUE TO THE VARIABLES BETWEEN BUILDING STANDARDS ICAL GREEN CODE. DUE TO THE VARIABLES BETWEEN BUILDING STANDARDS ICAL GREEN CODE. DUE TO THE VARIABLES BETWEEN BUILDING STANDARDS ICAL GREEN CODE. DUE TO THE VARIABLES BETWEEN BUILDING STANDARDS ICAL GREEN CODE. DUE TO THE VARIABLES BETWEEN BUILDING STANDARDS ICAL GREEN CODE. DUE TO THE VARIABLES BETWEEN BUILDING STANDARDS ICAL GREEN CODE. DUE TO THE VARIABLES BETWEEN BUILDING STANDARDS ICAL GREEN CODE. DUE TO THE VARIABLES BETWEEN BUILDING STANDARDS ICAL GREEN CODE. DUE TO THE VARIABLES BETWEEN BUILDING STANDARDS ICAL GREEN CODE.

FROM MARINMAP GIS.
PROPERTY LINE NOT FULLY SURVEYED;
BASED ON RECONCILIATION OF 628-800-2152 ASSESSOR'S MAP BK.1 - PG.12 DATED 08/03/2021, PARTIAL SURVEY BY STEPHEN FLATLAND PLS (2012), AND 3D SCAN OF 38 TAMALPAIS RD (2017). SITE PLAN LEGEND NOT FOR - PROPERTY LINE CONSTRUCTION ---- REQUIRED SETBACKS IMPERMEABLE SURFACING CONTRIBUTING TO LOT COVERAGE 80 WINDOWS (TYP.) **TAMALPAIS** WINDOWS (TYP.) (E) MAIN HOUSE, 42 TAMALPAIS (E) MAIN HOUSE, 42 TAMALPAIS (E) FENCE (E) FENCE -(E) STUDIO/ 172'(E) DECK (E) STUDIO/ OFFICE, N.I.C. OFFICE, N.I.C. 172'(E) DECK ADDITION, 38 1 FAX, CA 94930 22-1 - (E) FENCE AT EDGE OF DECK ◆160' (E) DECK 15' STBK FOR 20' COMBINED 15' STBK FOR 20' COMBINED (E) FENCE AT ~1' (E) STBK ---- AREA OF WORK -EDGE OF DECK ◆160' (E) DECK ------FAIRFAX, APN: 001 (E) FLAGSTONE PAVING -(E) FLAGSTONE PAVING -REAR (E) IN-LAW (E) IN-LAW 10' N31°48'E OVER OVER (N) 2-STORY GARAGE, GARAGE, ADDITION N.I.C. N.I.C. (E) ASPHALT DRIVEWAY (E) ASPHALT-DRIVEWAY (E) FLAT ROOF A (E) FENCE -(E) FENCE 162 162 EXTENT OF FIRST EXTENT OF FIRST FLOOR WALLS (TYP.) FLOOR WALLS (TYP.) (E) CONCRETE PAVING REPLACED WITH PERMEABLE SURFACING (E) CONCRETE PAVING WINDOWS (TYP.) <--- WINDOWS (TYP.) PARKING # (E) PARKING #2 (19' x 9' x 7') (E) 38 TAMALPAIS RD (E) 38 TAMALPAIS RD AIN HOUSE 154 MAIN HOUSE (E) HOUSE, 36 TAMALPAIS (E) GARAGE, 42 MAIN HOUSE (E) GARAGE, 42 (E) HOUSE, 36 TAMALPAIS TAMALPAIS TAMALPAIS REV DESCRIPTION DATE 169' SECOND FLOOR LEVEL 160'-FIRST FLOOR LEVEL DATE: 09/11/23 (E) CAR PORT, 5' STBK 36 TAM PORT, PORT, 5' STBK 36 TAM SCALE: As Noted (E) BRICK PATIO (E) BRICK PATIO SHEET NAME: A (E) FENCE (E) FENCE -SITE PLANS (E) CURB -240' S61°34'E 40' S61°34'E TAMALPAIS ROAD TAMALPAIS ROAD

PLANS BY

SHEET NOTES

CONTOURS AT 10FT INTERVALS TAKEN

JOSEPH HEWLINGS

38 TAMALPAIS RD FAIRFAX, CA 94930

UPDATED FOR 11/20/23 COMMENTS FOR PLANNING 09/11/23

STORY POLE PLAN LEGEND

EL = XX FT

STORY POLE

elevation

-X-X-X- STRINGLINE WITH FLAGGING

STORY POLE REFERENCE

JOSEPH HEWLINGS

38 TAMALPAIS RD FAIRFAX, CA 94930 628-800-2152

**NOT FOR** CONSTRUCTION

REAR ADDITION, 38 TAMALPAIS RD FAIRFAX, CA 94930





DATE: 09/11/23

SCALE:


SHEET NAME:

STORY POLE PLAN

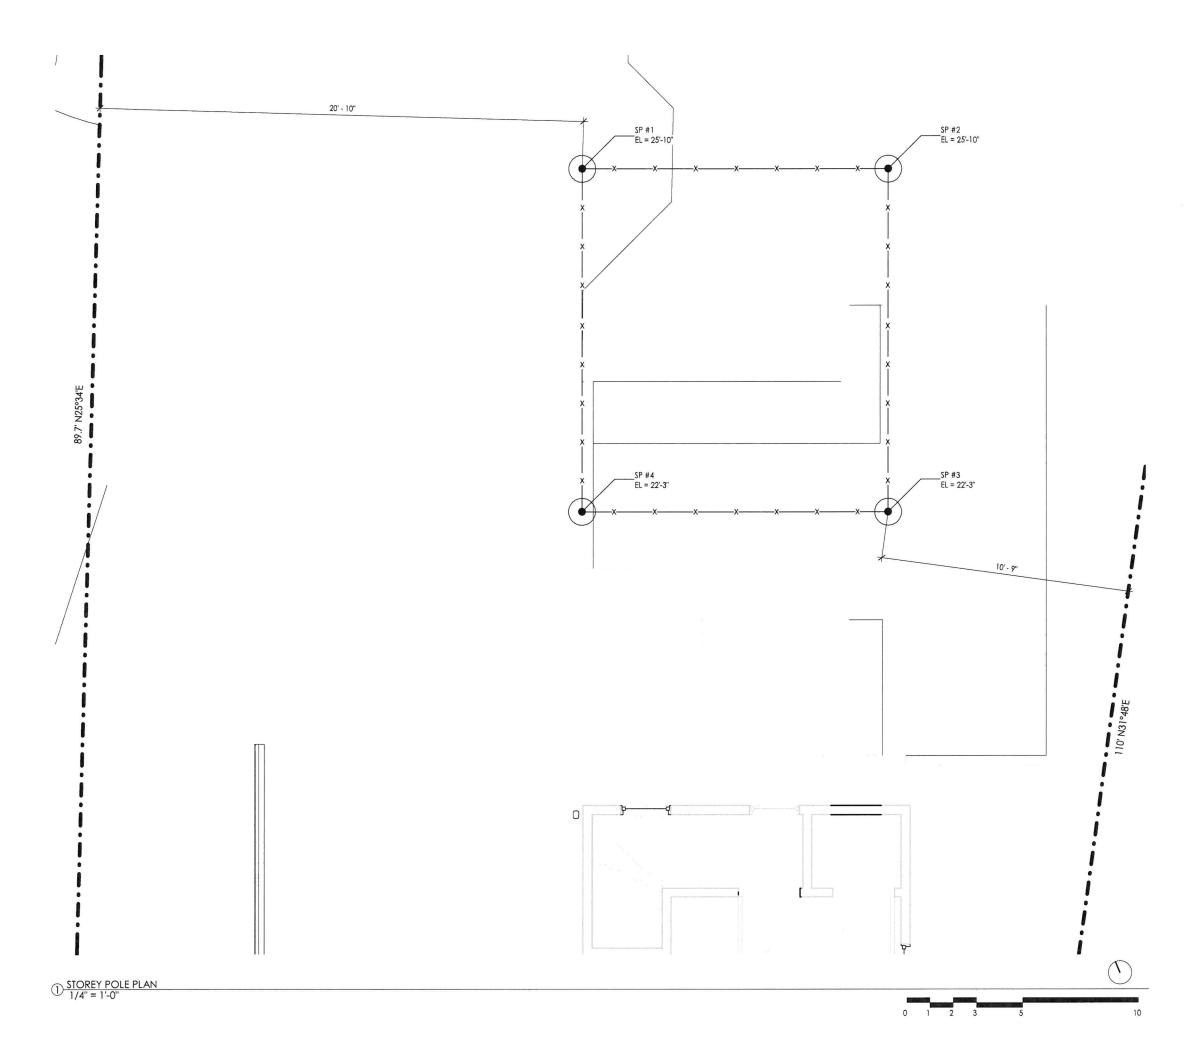

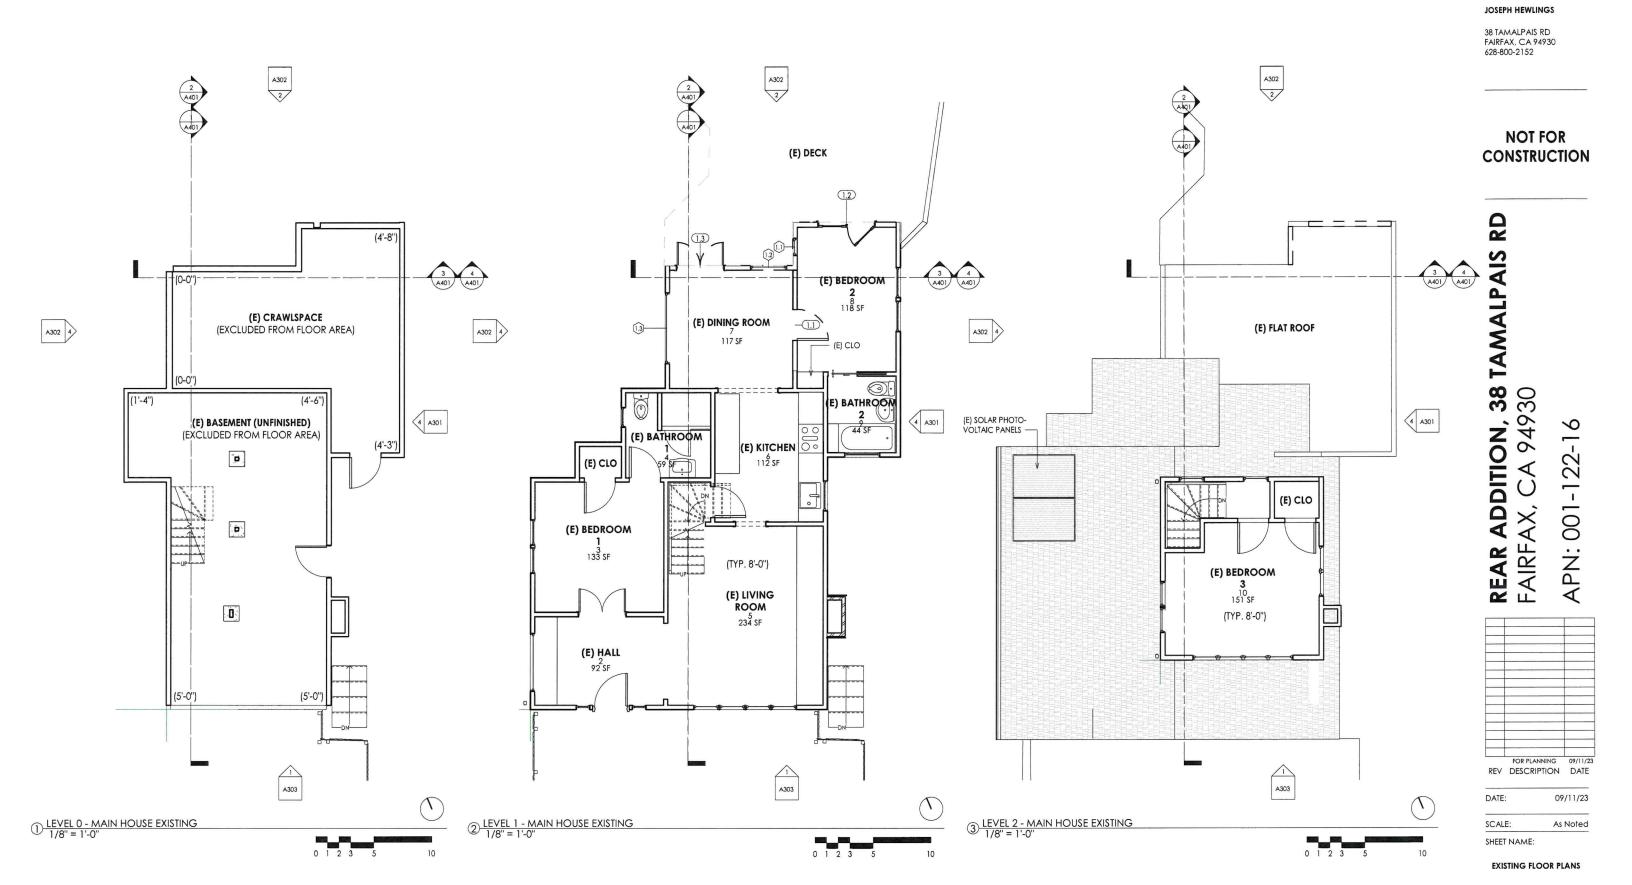

PLANS BY

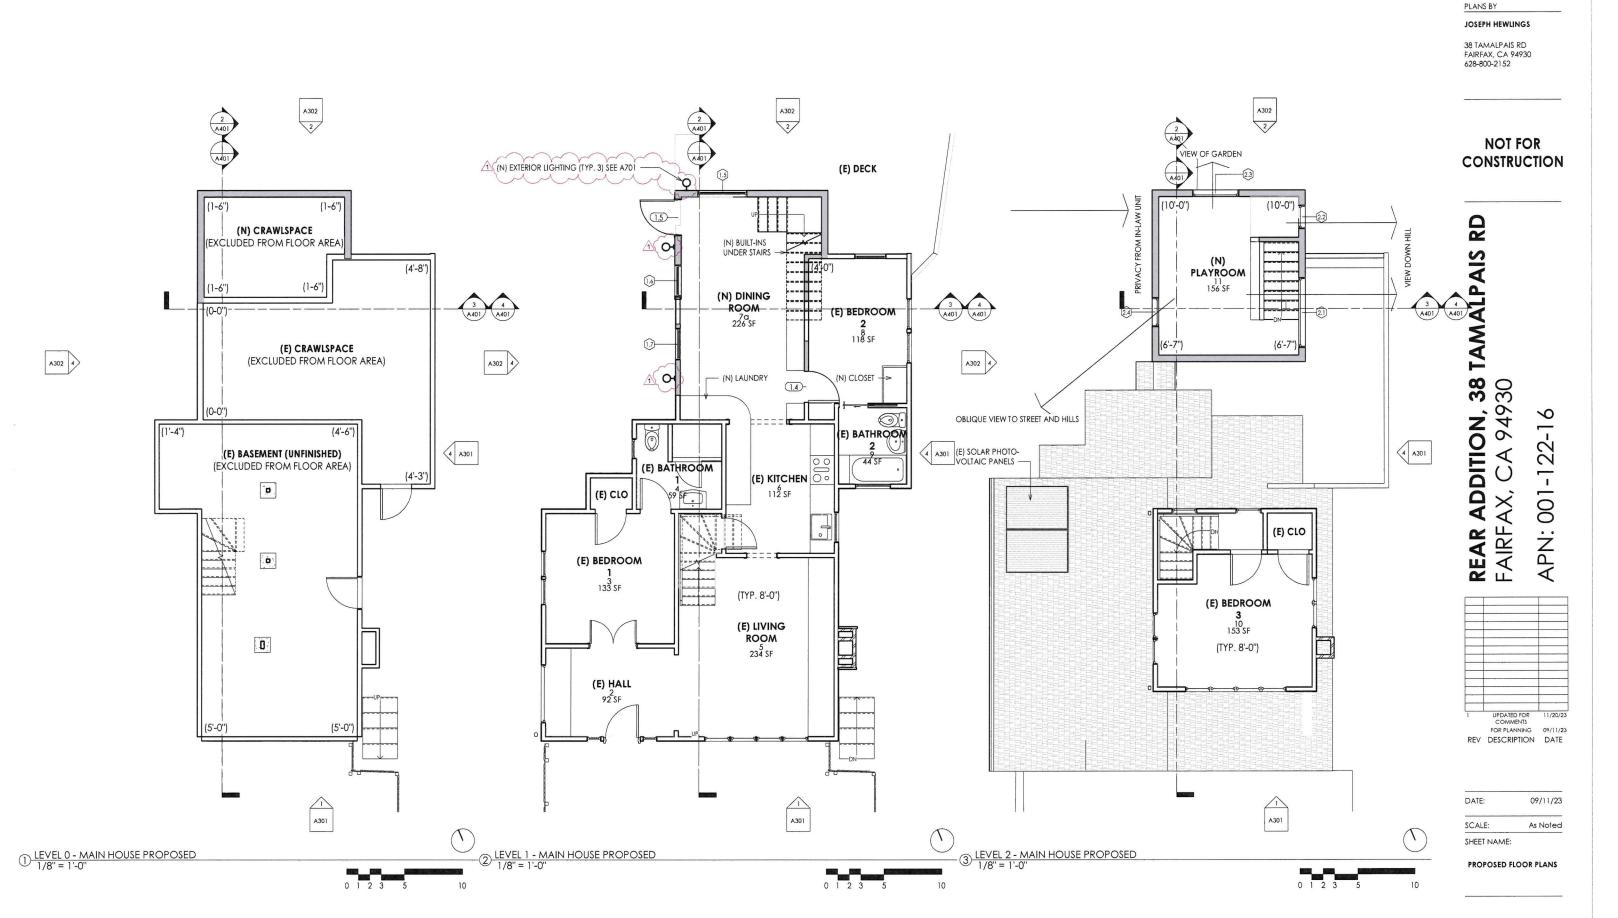



JOSEPH HEWLINGS

38 TAMALPAIS RD FAIRFAX, CA 94930 628-800-2152

### **NOT FOR**

## CONSTRUCTION

REAR ADDITION, 38 TAMALPAIS RD FAIRFAX, CA 94930



DATE: 09/11/23

SCALE: As Noted

SHEET NAME:

ROOF PLANS

A203



4" / 1'-0"

(N) SECOND FLOOR WALLS BELOW


14' - 11"

(E) SOLAR PHOTOVOLTAIC PANEL (TYP. 11)

(E) FLAT ROOF

4" / 1'-0"

3 3/4" / 1'-0"

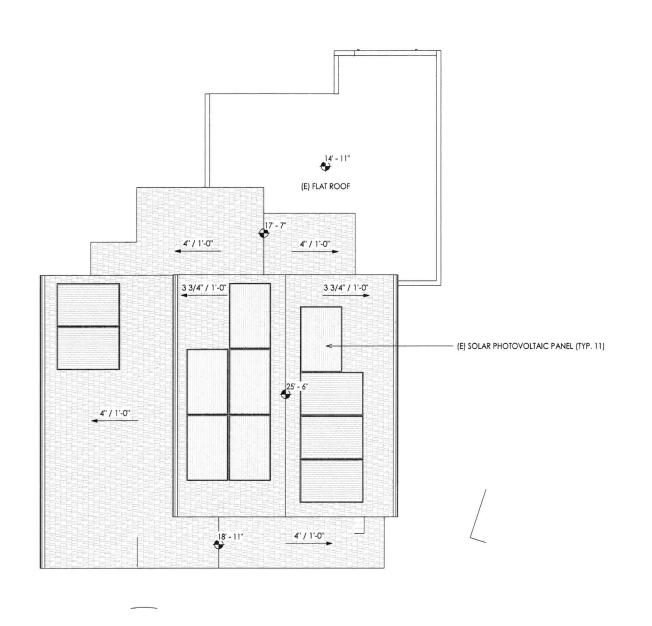



(N) PITCHED ROOF TO CONCEAL FLAT ROOF PARAPET

4" / 1'-0"

4" / 1'-0"

3 3/4" / 1'-0"

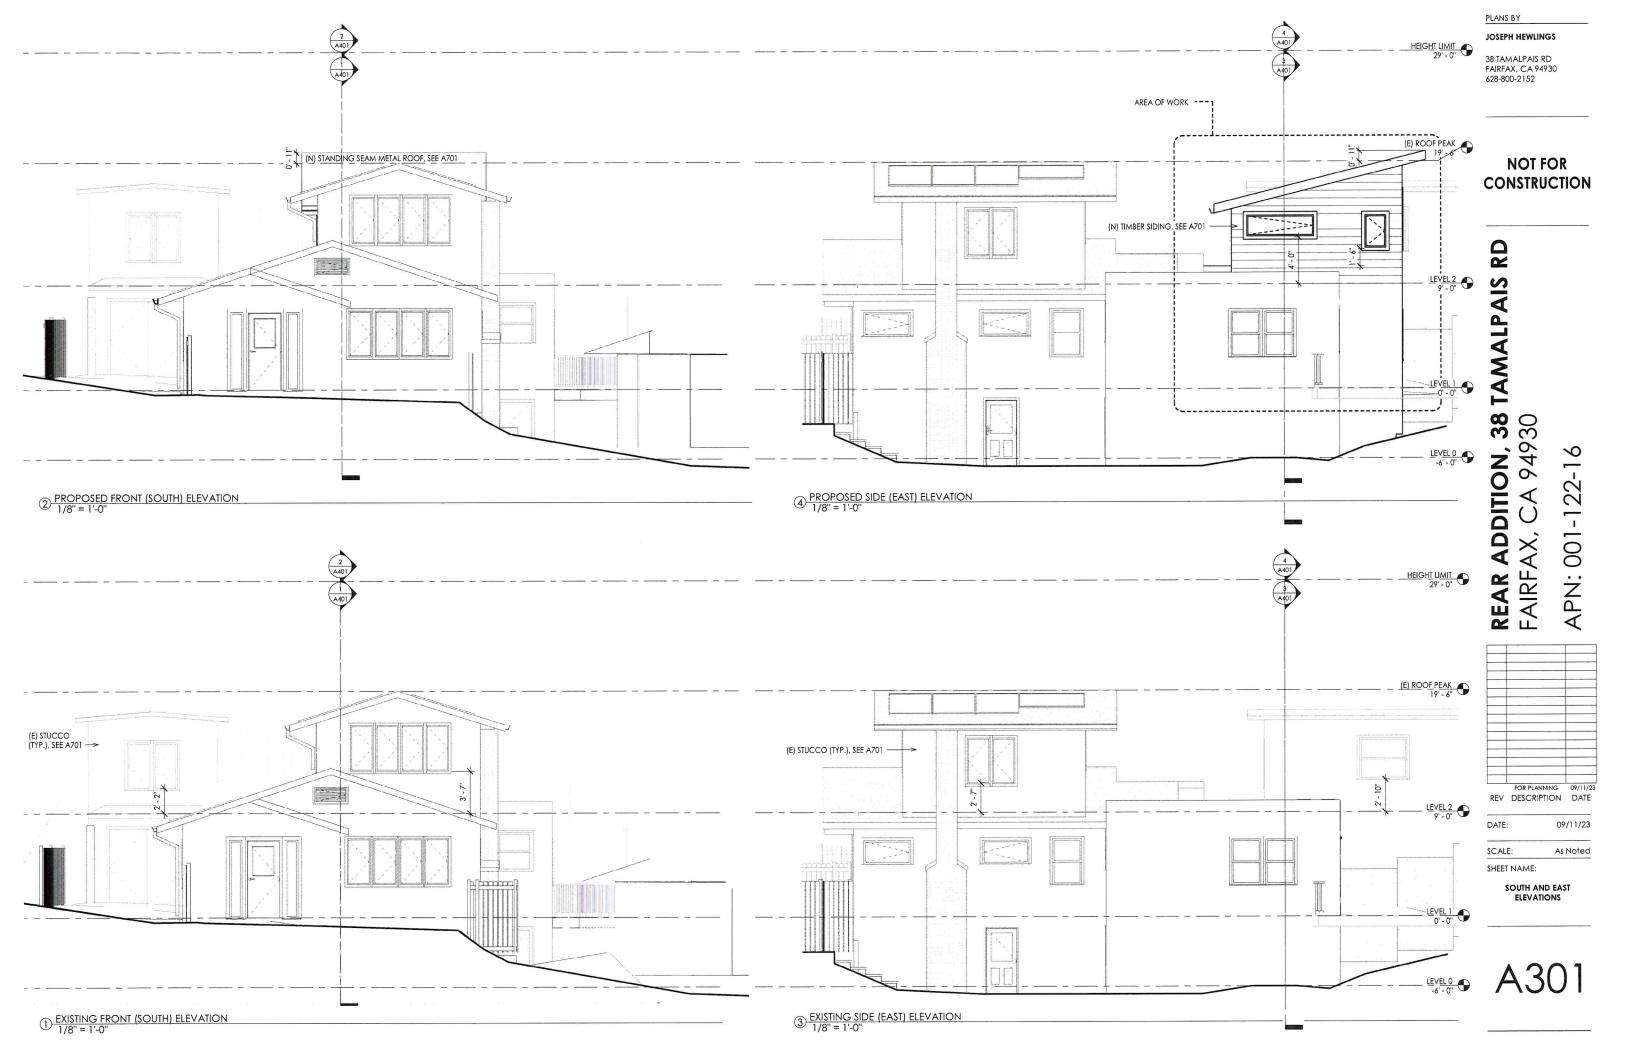

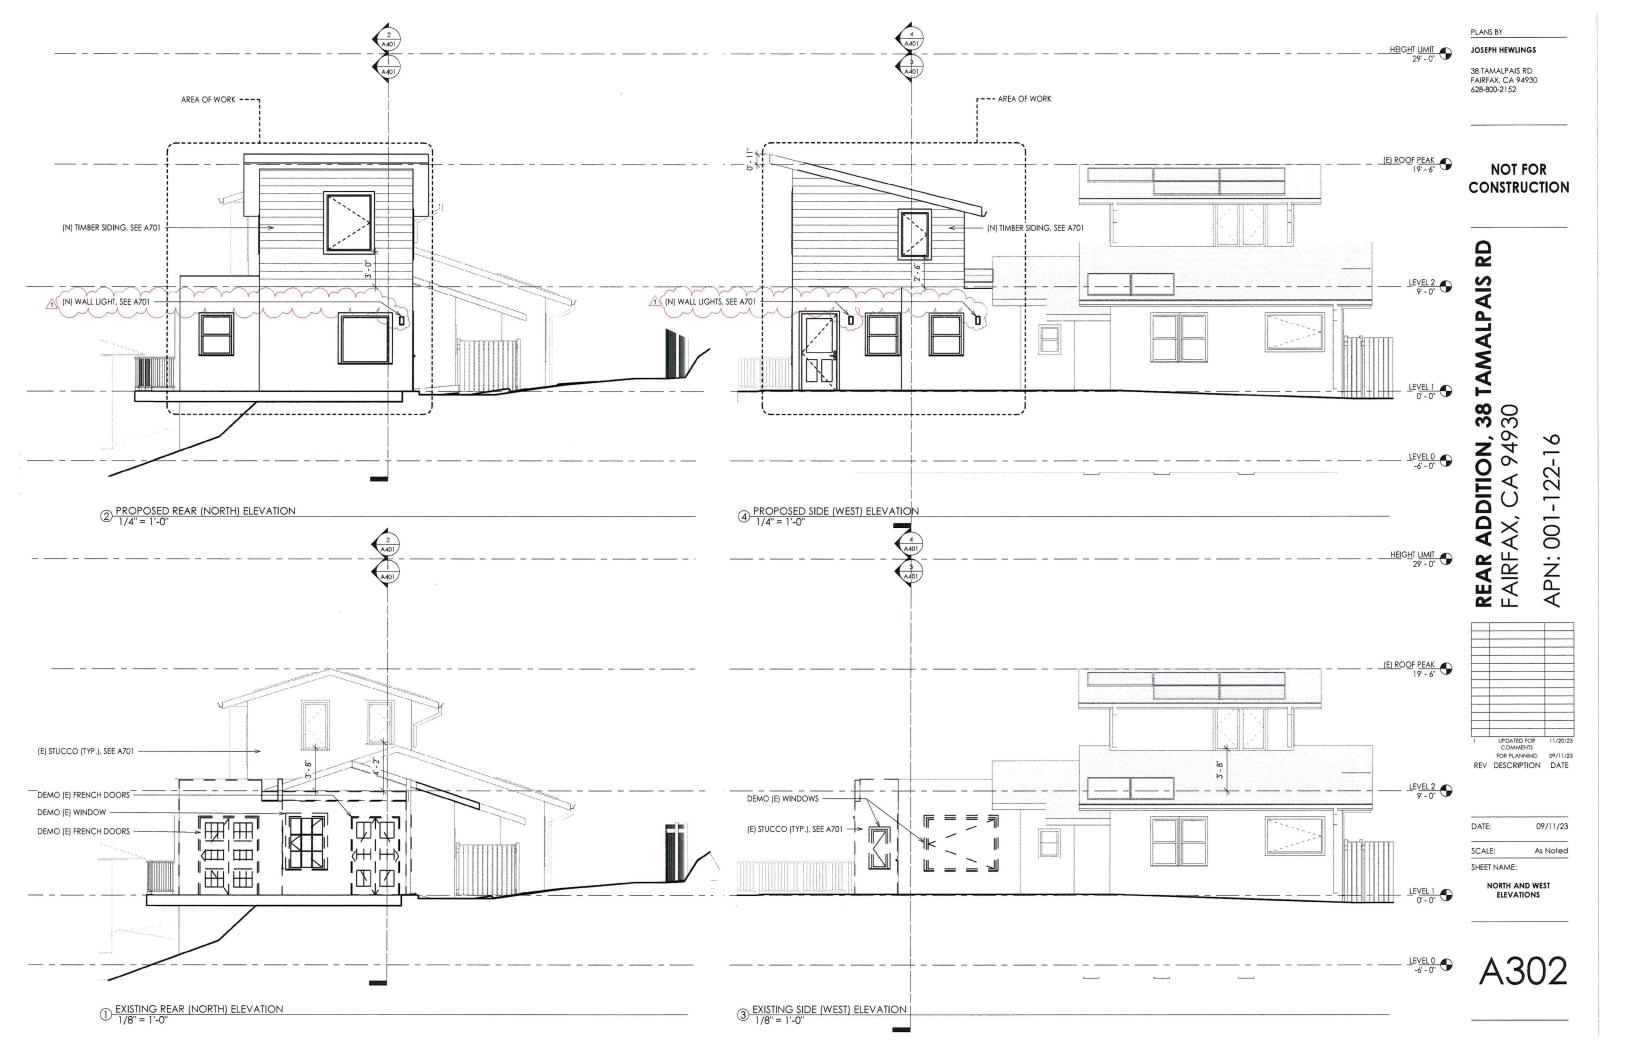

### **NOT FOR**

### CONSTRUCTION

REAR ADDITION, 38 TAMALPAIS RD FAIRFAX, CA 94930





DATE: 09/11/23


SCALE:


SHEET NAME:

STREETSCAPES

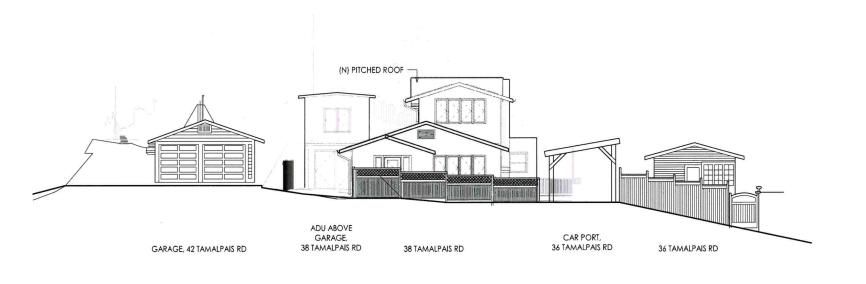

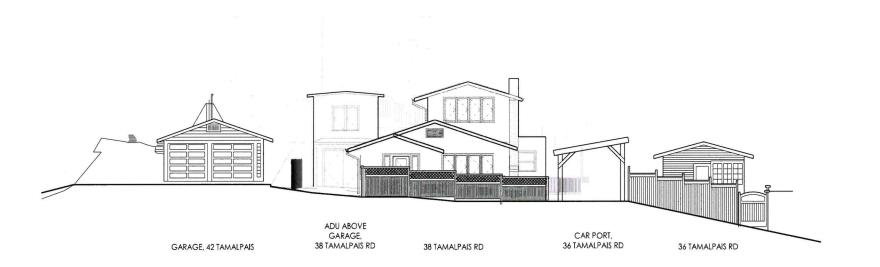

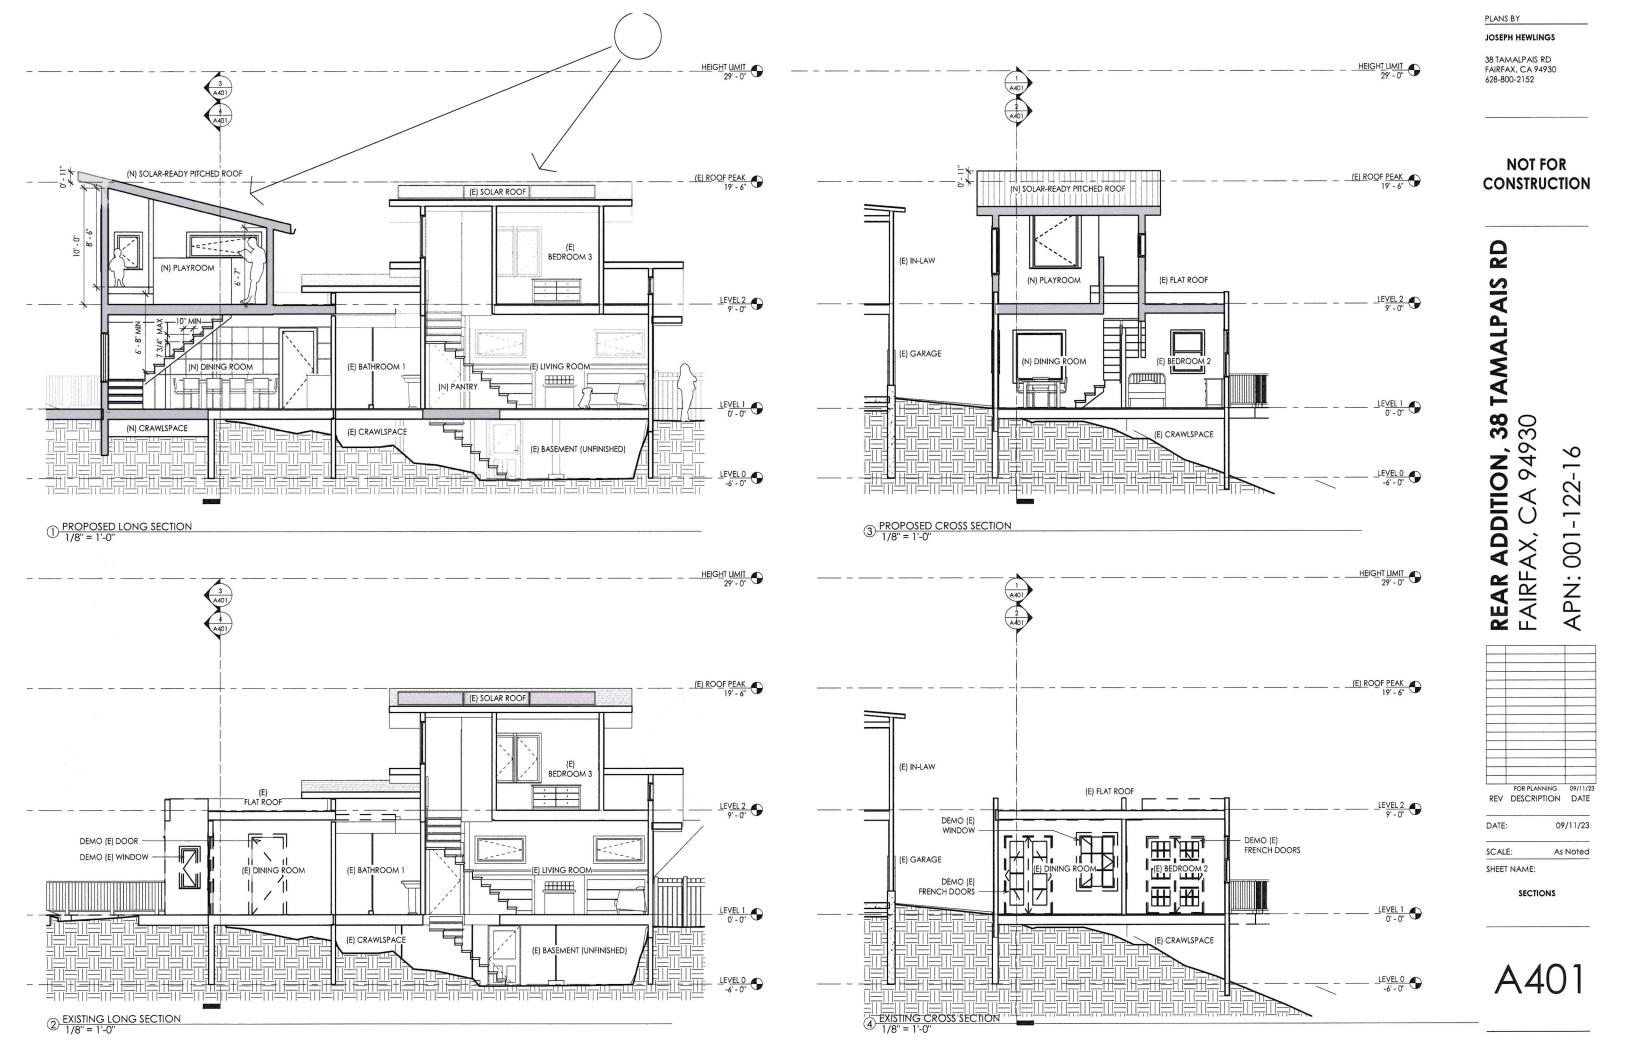

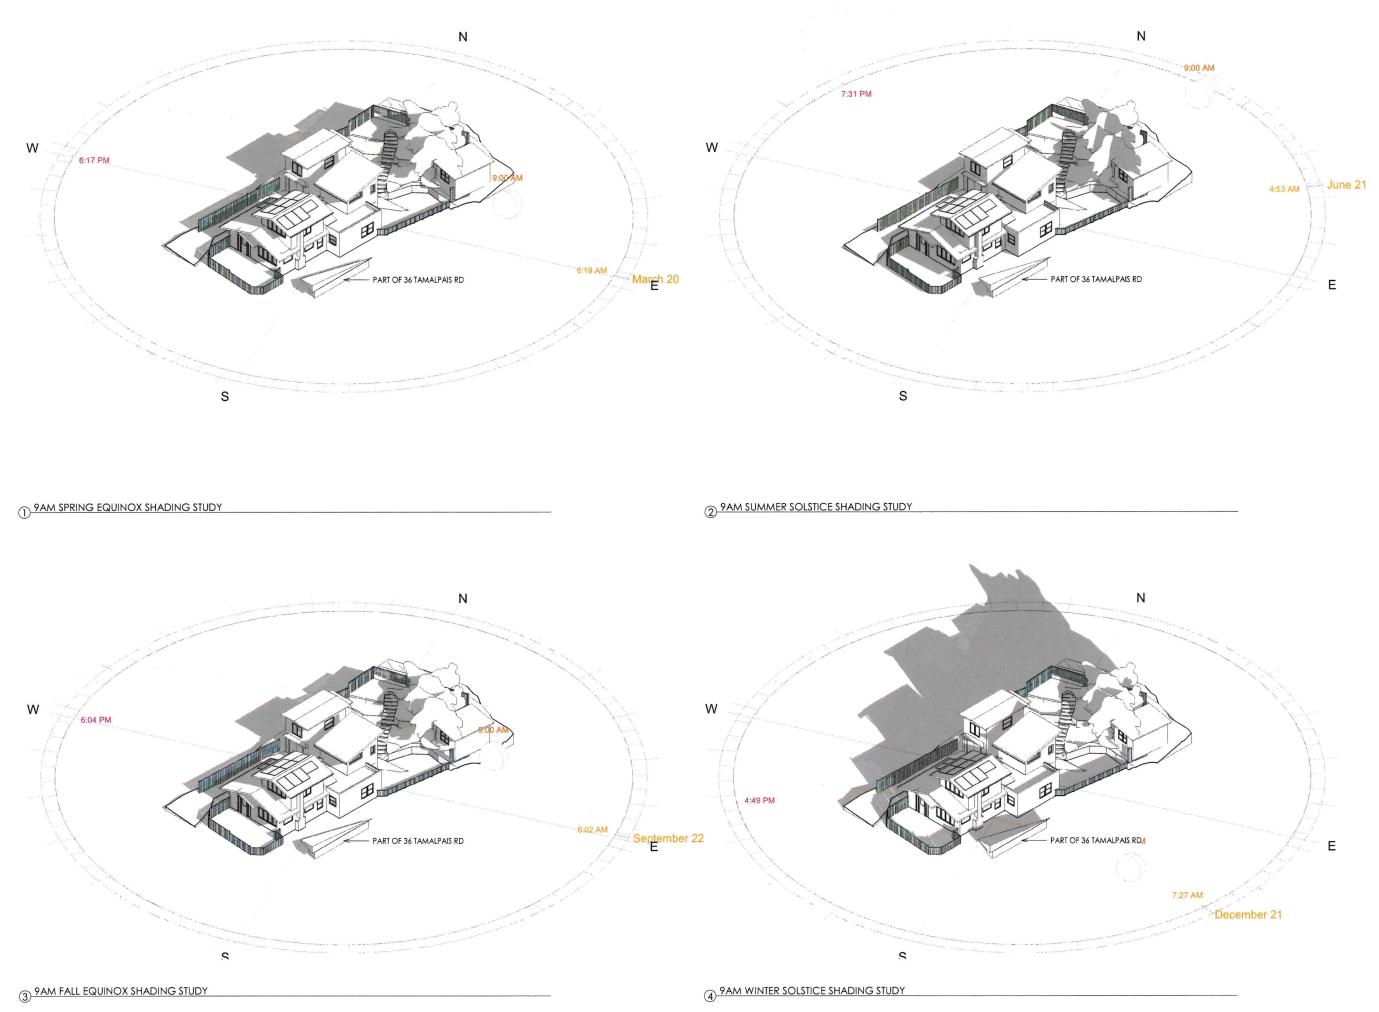

PLANS BY

JOSEPH HEWLINGS

38 TAMALPAIS RD FAIRFAX, CA 94930 628-800-2152

### **NOT FOR**

## CONSTRUCTION


REAR ADDITION, 38 TAMALPAIS RD FAIRFAX, CA 94930

APN: 001-122-16 FOR PLANNING 09/11/23
REV DESCRIPTION DATE

DATE: 09/11/23 SCALE: As Noted

SHEET NAME:

MORNING SHADE STUDIES

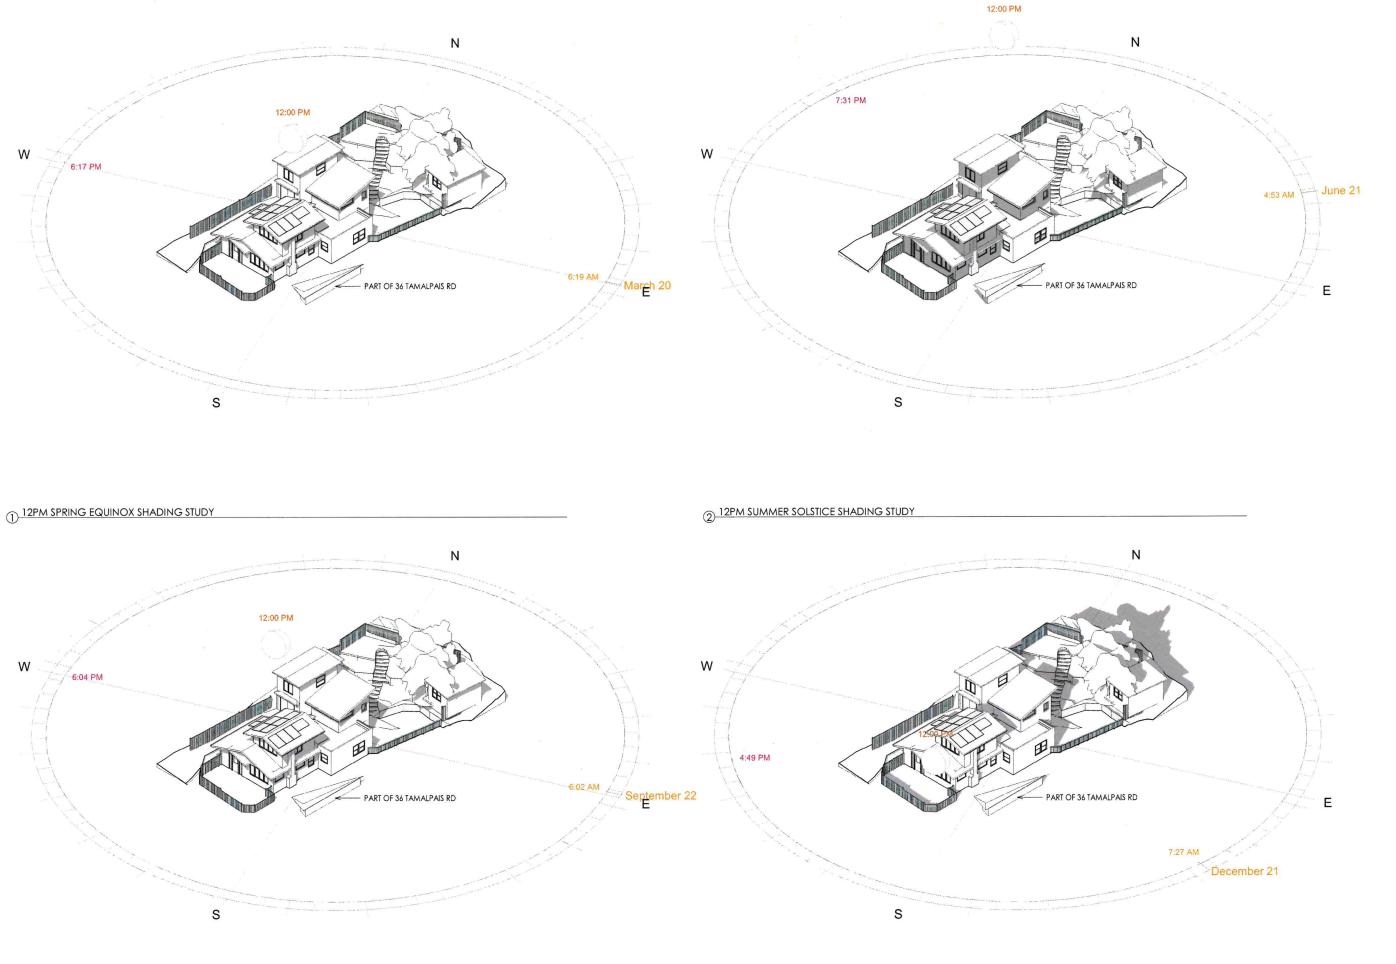

PLANS BY

JOSEPH HEWLINGS

38 TAMALPAIS RD FAIRFAX, CA 94930 628-800-2152

**NOT FOR** 

CONSTRUCTION

REAR ADDITION, 38 TAMALPAIS RD FAIRFAX, CA 94930

APN: 001-122-16 FOR PLANNING 09/11/23
REV DESCRIPTION DATE

DATE: 09/11/23


SCALE: As Noted

SHEET NAME:

NOON SHADE STUDIES

A502

4 12PM WINTER SOLSTICE SHADING STUDY

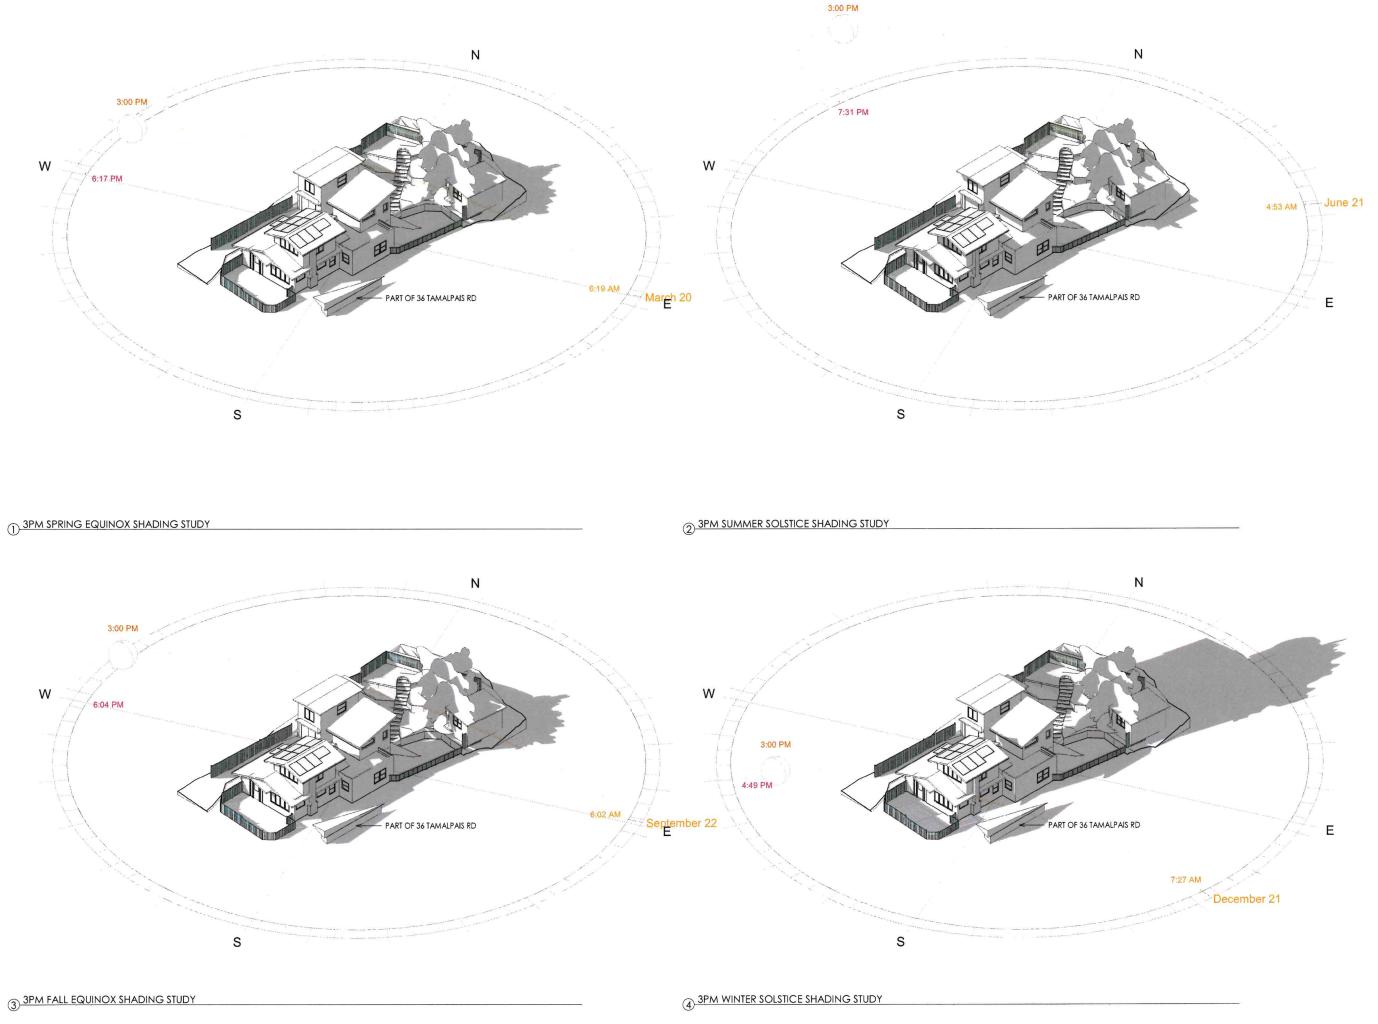

PLANS BY JOSEPH HEWLINGS

38 TAMALPAIS RD FAIRFAX, CA 94930 628-800-2152

**NOT FOR** 

CONSTRUCTION

REAR ADDITION, 38 TAMALPAIS RD FAIRFAX, CA 94930 APN: 001-122-16

FOR PLANNING 09/11/23
REV DESCRIPTION DATE

09/11/23 DATE:

SCALE:

SHEET NAME:

AFTERNOON SHADE STUDIES

WINDOW SCHEDULE										
NO.	ROOM	STATUS	WIDTH	HEIGHT	SILL HEIGHT	DESCRIPTION	GLAZING TYPE	TEMPERED	FRAME/SASH MATERIAL	NOTES
1.1	(E) BEDROOM 2	DEMOLISHED	1' - 6"	3' - 6"	2' - 3"	FIXED	SINGLE PANE	No	WOOD	
1.2	(N) DINING ROOM	DEMOLISHED	3' - 2"	4' - 8"	2' - 2"	FIXED	SINGLE PANE	No	WOOD	
1.3	(N) DINING ROOM	DEMOLISHED	6' - 2"	4' - 8"	2' - 1"	FIXED	SINGLE PANE	No	WOOD	
1.4	(E) BEDROOM 2	NEW	2' - 6"	3' - 4"	3' - 1"	DOUBLE HUNG	DOUBLE PANE	Yes	CLAD WOOD	
1.5	(N) DINING ROOM	NEW	4' - 0"	4' - 0"	2' - 4"	FIXED	DOUBLE PANE	Yes	CLAD WOOD	
1.6	(N) DINING ROOM	NEW	2' - 6"	3' - 4"	3' - 1"	DOUBLE HUNG	DOUBLE PANE	Yes	CLAD WOOD	
1.7	(N) DINING ROOM	NEW	2' - 6"	3' - 4"	3' - 1"	DOUBLE HUNG	DOUBLE PANE	Yes	CLAD WOOD	
2.1	(N) PLAYROOM	NEW	6' - 0"	2' - 0"	4' - 0"	AWNING	DOUBLE PANE	Yes	CLAD WOOD	
2.2	(N) PLAYROOM	NEW	2' - 0"	3' - 0"	3' - 0"	FIXED	DOUBLE PANE	Yes	CLAD WOOD	
2.3	(N) PLAYROOM	NEW	4' - 0"	5' - 0''	3' - 0"	CASEMENT	DOUBLE PANE	Yes	CLAD WOOD	
2.4	(N) PLAYROOM	NEW	2' - 6"	4' - 0"	2' - 6"	CASEMENT	DOUBLE PANE	Yes	CLAD WOOD	
2.5	(E) BEDROOM 2	NEW	2' - 6"	3' - 4"	3' - 1"	DOUBLE HUNG	DOUBLE PANE	Yes	CLAD WOOD	ESCAPE WINDOW

DOOR SCHEDULE									
MARK	ROOM	STATUS	WIDTH	HEIGHT	MATERIAL	GLAZING TYPE	TEMPERED	HARDWARE	NOTES
1.1	(E) BEDROOM 2	DEMOLISHED	2' - 8"	6' - 8"	WOOD	N/A	No	PASSAGE	3.6
1.2	(E) DINING ROOM	DEMOLISHED	4' - 11"	6' - 8"	WOOD	DOUBLE PANE	Yes	DOUBLE DOOR KEYED	
1.3	(N) DINING ROOM	DEMOLISHED	4' - 0"	6' - 8"	WOOD	DOUBLE PANE	Yes	DOUBLE DOOR KEYED	
1.4	(E) BEDROOM 2	NEW	2' - 8"	6' - 8"	WOOD	N/A	No	PASSAGE	
1.5	(N) DINING ROOM	NEW	3' - 0"	6' - 8"	FIBERGLASS	DOUBLE PANE	Yes	KEYED SINGLE DEADBOLT	

PLANS BY

JOSEPH HEWLINGS

38 TAMALPAIS RD FAIRFAX, CA 94930 628-800-2152

### **NOT FOR**

CONSTRUCTION

REAR ADDITION, 38 TAMALPAIS RD FAIRFAX, CA 94930

APN: 001-122-16



DATE: 09/11/23


SCALE: As Noted

SHEET NAME:


**SCHEDULES** 




 $\underbrace{\text{DEXISTING STUCCO SIDING (TEXTURE VARIES)}}_{\text{DEMOSTRIC STUCCO SIDING (TEXTURE VARIES)}} - \text{FIRST FLOOR OF ADDITION SHALL MATCH}$ 

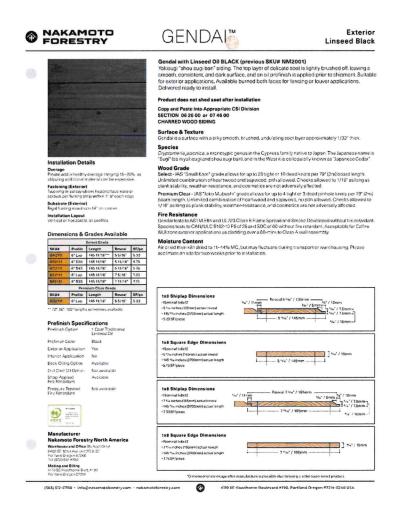

 $\begin{tabular}{ll} \hline \end{tabular} \begin{tabular}{ll} \hline \end{$ 

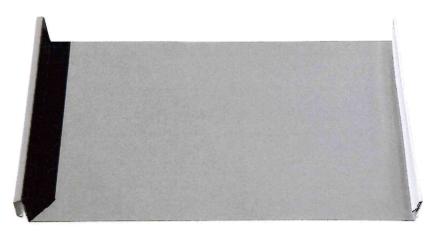

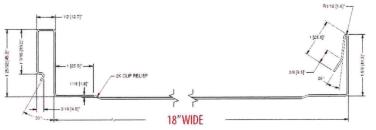

Also available are custom panel widths of: 12", 14", 16", 18", 20" and 24"

3 STANDING SEAM METAL ROOF (CLASS A FIRE RATED) PROPOSED FOR ADDITION



PLANS BY

JOSEPH HEWLINGS

38 TAMALPAIS RD FAIRFAX, CA 94930 628-800-2152

### **NOT FOR**

### CONSTRUCTION

8 **38 TAMALPAIS** 94930 REAR ADDITION, FAIRFAX, CA 949

-122-1



DATE: 09/11/23

SCALE: As Noted SHEET NAME:

EXTERIOR FINISHES