CITY OF LUCAS CONSTRUCTION PLANS FOR

WATER SYSTEM IMPROVEMENTS

NORTH PUMP STATION GROUND STORAGE TANKS & PUMP IMPROVEMENTS

<u>mayor</u> BOB SANDERS

CITY COUNCIL

BILL CARMICKLE

KATHLEEN PEELE

DEBBIE FISHER

DON ZRINY


CITY ADMINISTRATOR
CHARLES FENNER, CPM, AICP, CHRM

DIRECTOR OF PUBLIC WORKS
STACY CAUDELL, P.E.

CONTRACTOR

TANK BUILDERS, INC.
COMPLETED DECEMBER 2009



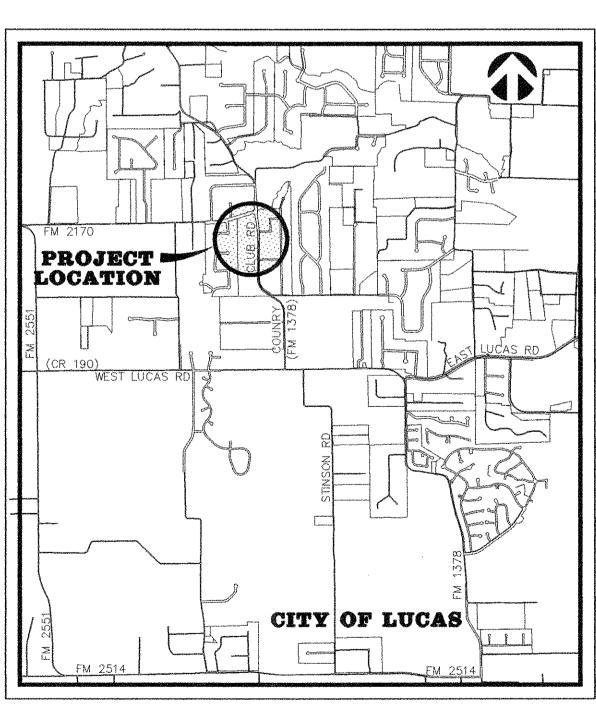

VICINITY MAP

BW2 JOB NO. 06-1207 APRIL 2007

"REVISED PER ADDENDA"


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OWNER:

CITY OF LUCAS
151 COUNTRY CLUB ROAD
LUCAS, TEXAS 75002

ENGINEER:



GENERAL NOTES

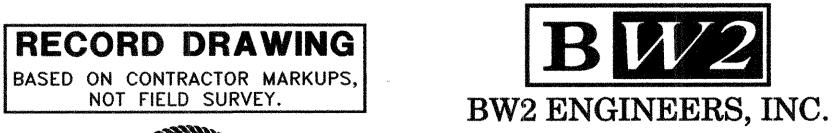1919 S. SHILOH ROAD SUITE 500, L.B. 27 GARLAND, TEXAS 75042 PROVEMENTS - NORTH PUMP STATION GROUND STORAGE TANKS & PUMP IMPROVEMENTS

GENERAL NOTES:

- 1. It is the CONTRACTOR's responsibility to maintain neat and accurate plans of record.
- 2. The CONTRACTOR is responsible for maintaining adequate site drainage throughout the duration of this project.
- 3. The CONTRACTOR is responsible for obtaining all necessary permits and approvals before construction begins.
- 4. The CONTRACTOR shall replace all fence removed during construction in as good as or better condition than before construction.
- 5. The CONTRACTOR shall take all necessary precautions to ensure that electric power and telephone poles are either moved to a safe location by the affected utility company or not disturbed during construction. All costs incurred for moving electric power and telephone poles shall be included in the price bid for the construction of the project.
- 6. The CONTRACTOR shall restore all property including driveways, public streets, sidewalks and all other improvements removed or damaged inside and outside the project limits during construction to as good as or better condition than before construction. Restoration shall be made immediately after the property no longer interferes with construction.
- 7. The information shown on these drawings concerning type and location of underground and other utilities is not guaranteed to be accurate or all—inclusive. The CONTRACTOR is responsible for making his own determinations as to the type and location of underground utilities and other utilities as may be necessary to avoid damage thereto.
- 8. The CONTRACTOR shall not place fill or waste material on any private property without prior written permission from the ENGINEER. No excess excavated material shall be deposited in low areas or along natural drainage ways that will restrict the natural flow of water. If the CONTRACTOR places excavated material in low areas that will cause flood damage, CONTRACTOR will be responsible for all damage resulting from such fill, and he shall remove the fill at CONTRACTOR's expense.
- 9. All streets within the scope of the Contract shall be kept accessible to fire trucks, ambulances and other emergency vehicles.
- 10. The CONTRACTOR shall be responsible for public safety during the duration of construction. All barricades, warning signs, lights, devices, etc., for the guidance and protection of traffic and pedestrians must conform to the installation shown in 1980 Texas Manual of Uniform Traffic Control Devices, as currently amended by the Texas Department of Transportation. CONTRACTOR shall at all times provide barricades, warning signs and lighting adequate to safeguard the public from any hazards resulting from open trenches during non-work hours.
- 11. Filter fabric fence for erosion control shall be provided in accordance with specifications and as shown on the plans and in accordance with the EPA regulations.
- 12. The CONTRACTOR shall use the public right—of—ways and existing utility easements for access to the job site.
- 13. The CONTRACTOR shall select the subcontractor to be utilized for testing and lab work. The CONTRACTOR shall be responsible for paying for testing and lab work. Selection of subcontractor for this purpose will be subject to approval by the OWNER. Testing referred to herein includes compaction and water pressure testing, which shall be required on this project. Testing shall include testing of concrete required to determine and ascertain that concrete strengths in specifications are attained for all concrete members on the project.
- 14. The CONTRACTOR shall keep excavated trenches free of groundwater during construction. If necessary, the CONTRACTOR shall utilize dewatering procedures in order to control groundwater during construction such that it does not affect his construction work.
- 15. The CONTRACTOR shall provide means for adequately controlling and avoiding soil erosion during construction. The CONTRACTOR shall not store spoil in drainage ways during construction.
- 16. All disturbed earth areas are to be finish graded to original or proposed contours, fertilized and either hydromulched with bermuda seed or covered with block sod according to NCTCOG specifications immediately after construction. Backfill to be select material free of rock and other debris. CONTRACTOR shall thoroughly water the hydromulch or block sod immediately after placement. Block sod shall match the existing type of grass on a case by case basis. There shall be no separate pay for matching each type of grass. The CONTRACTOR shall also be responsible for continued maintenance and watering of the newly hydromulched or sodded areas until the entire project is completed and accepted by the City of Lucas. Watering of the bermuda hydromulch or block sod shall be done in a manner and quantity as directed by City of Lucas field representative.
- 17. No existing sprinkler/irrigations systems have been shown on the plans; however, they may exist in certain areas. It is the CONTRACTORS responsibility to locate any existing irrigation systems within the project limits and determine if they will be affected by this construction. If CONTRACTOR encounters any sprinkler systems during construction, he shall repair and/or replace in as good as or better condition than before construction.
- 18. The CONTRACTOR shall maintain adequate sanitary facilities for use by workers throughout construction.
- 19. The CONTRACTOR shall conform to the Occupational Safety and Health Administration's (OSHA) standards for trench safety that are in effect during the period of construction.
- 20. Ground storage tank shall be constructed in accordance with current AWWA Standards and TCEQ requirements, including requirements for roof vent, manways, drains, sample connections, access ladders, overflows, liquid level indicators, and other appurtenances. All materials and workmanship shall conform to the City of Lucas Standards and Specifications and the North Central Texas Council of Government (NCTCOG) Standards and Specifications, except as noted. In the event of a conflict, the City of Lucas Standards and Specifications shall govern.
- 21. No existing trees shall be removed without approval of the City of Lucas.
- 22. CONTRACTOR shall provide all necessary construction staking.
- 23. CONTRACTOR's working hours shall be in accordance with the provisions of the current City Ordinance governing hours of construction work in the City.

GENERAL NOTES CONT'D .:

- 24. All concrete shall have a minimum compressive strength of 4000 psi at 28 days (minimum 6 sacks of cement per cubic yard) unless otherwise noted. All reinforcing steel and dowel bars in pavement shall be supported and maintained at the correct clearances by the use of bar chairs or other approved support.
- 25. All existing water lines and service lines to remain in service during construction. At times when water has to be cut—off, the CONTRACTOR shall coordinate with the OWNER to notify the affected area at least 48 hours prior to water cut—off.
- 26. The CONTRACTOR shall phase his daily work schedule so that all driveway crossings are to be complete prior to the end of the day. No driveway crossings are to be left open overnight. During installation of the pipeline across driveways, the CONTRACTOR shall be prepared to provide access across trenches and driveways at all times in case of emergency.
- 27. Water line shall be polyvinyl chloride (PVC) AWWA C900. New water service line shall be copper pipe with compression type fittings. Main line valves and fittings shall be cast iron.
- 28. CONTRACTOR shall install isolation gate valves and fire hydrants at locations shown on plans unless otherwise directed by OWNER. OWNER may direct CONTRACTOR to locate valves and fire hydrants at locations other than those shown on plans. Also, OWNER may add additional isolation gate valves and fire hydrants as required for operational purposes.
- 29. The CONTRACTOR is responsible for keeping streets, parking areas, sidewalks, etc., adjacent to the project free of mud and debris from construction.
- 30. The CONTRACTOR shall assume responsibility for protection of public utilities in the construction of this project. All manholes, valve boxes, fire hydrants, etc., must be adjusted to proper line and grade by the CONTRACTOR prior to and/or after placing any permanent paving. The CONTRACTOR shall also be responsible for support of existing utility poles, street signs, etc., when excavating in the vicinity of such poles.
- 31. The City of Lucas Public Works Department is to be notified 48 hours (2 working days) prior to any construction of paving and utilities in rights—of—way, easements and alleys.
- 32. Arrangements for construction water shall be made through the City of Lucas.
- 33. All locations of underground utility lines are approximate. CONTRACTOR shall contact the proper utility companies at least 48 hours prior to construction, shall inform them of beginning of construction and shall make arrangements to have utilities located by flagging. Flagging of utilities shall be completed prior to beginning construction.
- 34. PVC pipe shall be manufactured from a low filler PVC component capable of meeting the highest performance standards of the ASTM specifications.
- 35. Construction sites shall be secure at all times. Safety precautions shall be taken to protect the public from any injury which might result from construction activities.
- 36. As part of bid item, "EROSION CONTROL", the CONTRACTOR shall be responsible for implementing any and all erosion control measures as needed to control runoff of siltation from the project site. This shall include, but is not limited to, silt fencing, rock berms, inlet protection, etc. The CONTRACTOR shall maintain these erosion control measures as required until the construction is completed and sod has been placed over disturbed areas.
- 37. There is no separate pay resulting from any of the work required as a result of the requirements included in these general notes. All work required shall be included in the price bid for the project.
- 38. CONTRACTOR shall comply with all applicable Texas Department of Transportation (TXDOT) requirements during any construction activities in the vicinity of F.M. 1378 right—of—way.
- to be removed are 75hp motors.

 10 40. Per a report prepared on the water system for the City, it appears that the existing

/1\ 39. Per a set of sealed plans for the existing facilities, it appears that the existing motors

- pumps to be removed are 1,000 gpm pumps.

 41. CONTRACTOR shall utilize the existing valves and piping in the pump building. The control valves shall be adjusted as necessary to accommodate the additional flow from the new
- 42. Elevations shown on Sheet No. 11 of the plans shall be revised to match elevations
- 43. Location of tank accessories shown on Sheet No. 11 of the plans shall be revised to match location of tank accessories on Sheet No. 9.

GENERAL TRAFFIC CONTROL NOTES

- All temporary signs, markings, cones, channelizing devices, warning lights and barricades shall be in accordance with the current State of Texas Manual on Uniform Traffic Control Devices (MUTCD).
- Type "A" warning lights shall be placed on all advance warning signs. In addition, flags shall be placed on all advance warning signs that detour traffic.
- 3. Any existing conflicting markings shall be removed prior to shifting traffic.
- 4. All temporary pavement markings required during construction shall be of the removable type. Temporary markings and striping may be required to transition travel lanes between construction phases. All pavement markings and striping shall be reflective.
- 5. The spacing of signs and channelization devices may be adjusted to fit the geometric conditions encountered, such as driveways, intersecting roadways, vertical and horizontal alignment, etc., as approved by the City of Lucas.
- Advance warning signs shall not be displayed more than forty—eight (48) hours before
 physical construction begins. Signs may be erected up to one week before needed, if
 the sign face is fully covered.
- 7. Use of barricades, portable barrier rails, vertical panels, and drums shall be limited to the immediate areas of construction where a hazard is present. These devices shall not be stored along the roadway within thirty (30) feet of the edge of the traveled way before or after use unless protected by guardrail, bridge rail, and/or barriers installed for other purposes. These devices shall be removed from the construction work zone when the City of Lucas determines they are no longer needed. Where there is insufficient right—of—way to provide for this thirty (30) foot setback, the City of Lucas shall approve alternate locations.
- 8. The posted speed for warning signage is to be determined at the site by the City of Lucas.
- Reduced speed warning signage should be placed prior to and at regular intervals within the construction zone.
- 10. As part of the bid item, "Construction Barricading/Signing/Traffic Control," the CONTRACTOR is required to submit a traffic control plan for construction a minimum of 3 days prior to changes in traffic handling or movement, These plans are to be reviewed and approved by the City of Lucas prior to construction of that phase.
- 11. The Contractor shall accommodate existing traffic during construction and shall maintain at least one open lane of traffic at all times. Use of flag men, barricades, vertical panels, etc. shall be required and shall be considered subsidiary to "Construction Barricading/Signing/Traffic Control".
- 12. CONTRACTOR shall be required to place temporary pavement markings and/or buttons as needed to mantain traffic in a safe and efficient manner after removal of existing markings. These temporary markings shall not be paid for separately but shall be considered subsidiary to "CONSTRUCTION BARRICADING/SIGNING/TRAFFIC CONTROL".

RECORD DRAWING

BASED ON CONTRACTOR MARKUPS, NOT FIELD SURVEY.

DRAWN: BW2

DESIGN: MRB


REVIEWED: JFW

SCALE: NO SCALE


DATE: APRIL 2007

DWG. NAME: 1207GENNOTE



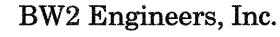

1919 S. Shiloh Road Suite 500, L.B. 27 Garland, Texas 75042 (972) 864-8200 (tel) (972) 864-8220 (fax)

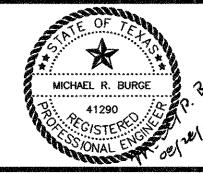

WATER SYSTEM IMPROVEMENTS
GROUND STORAGE TANKS & PUMP IMPROVEMENTS
GENERAL NOTES


CITY OF LUCAS


of 17

SHEET NO.

JOB NO. 06-1207

SHEETS

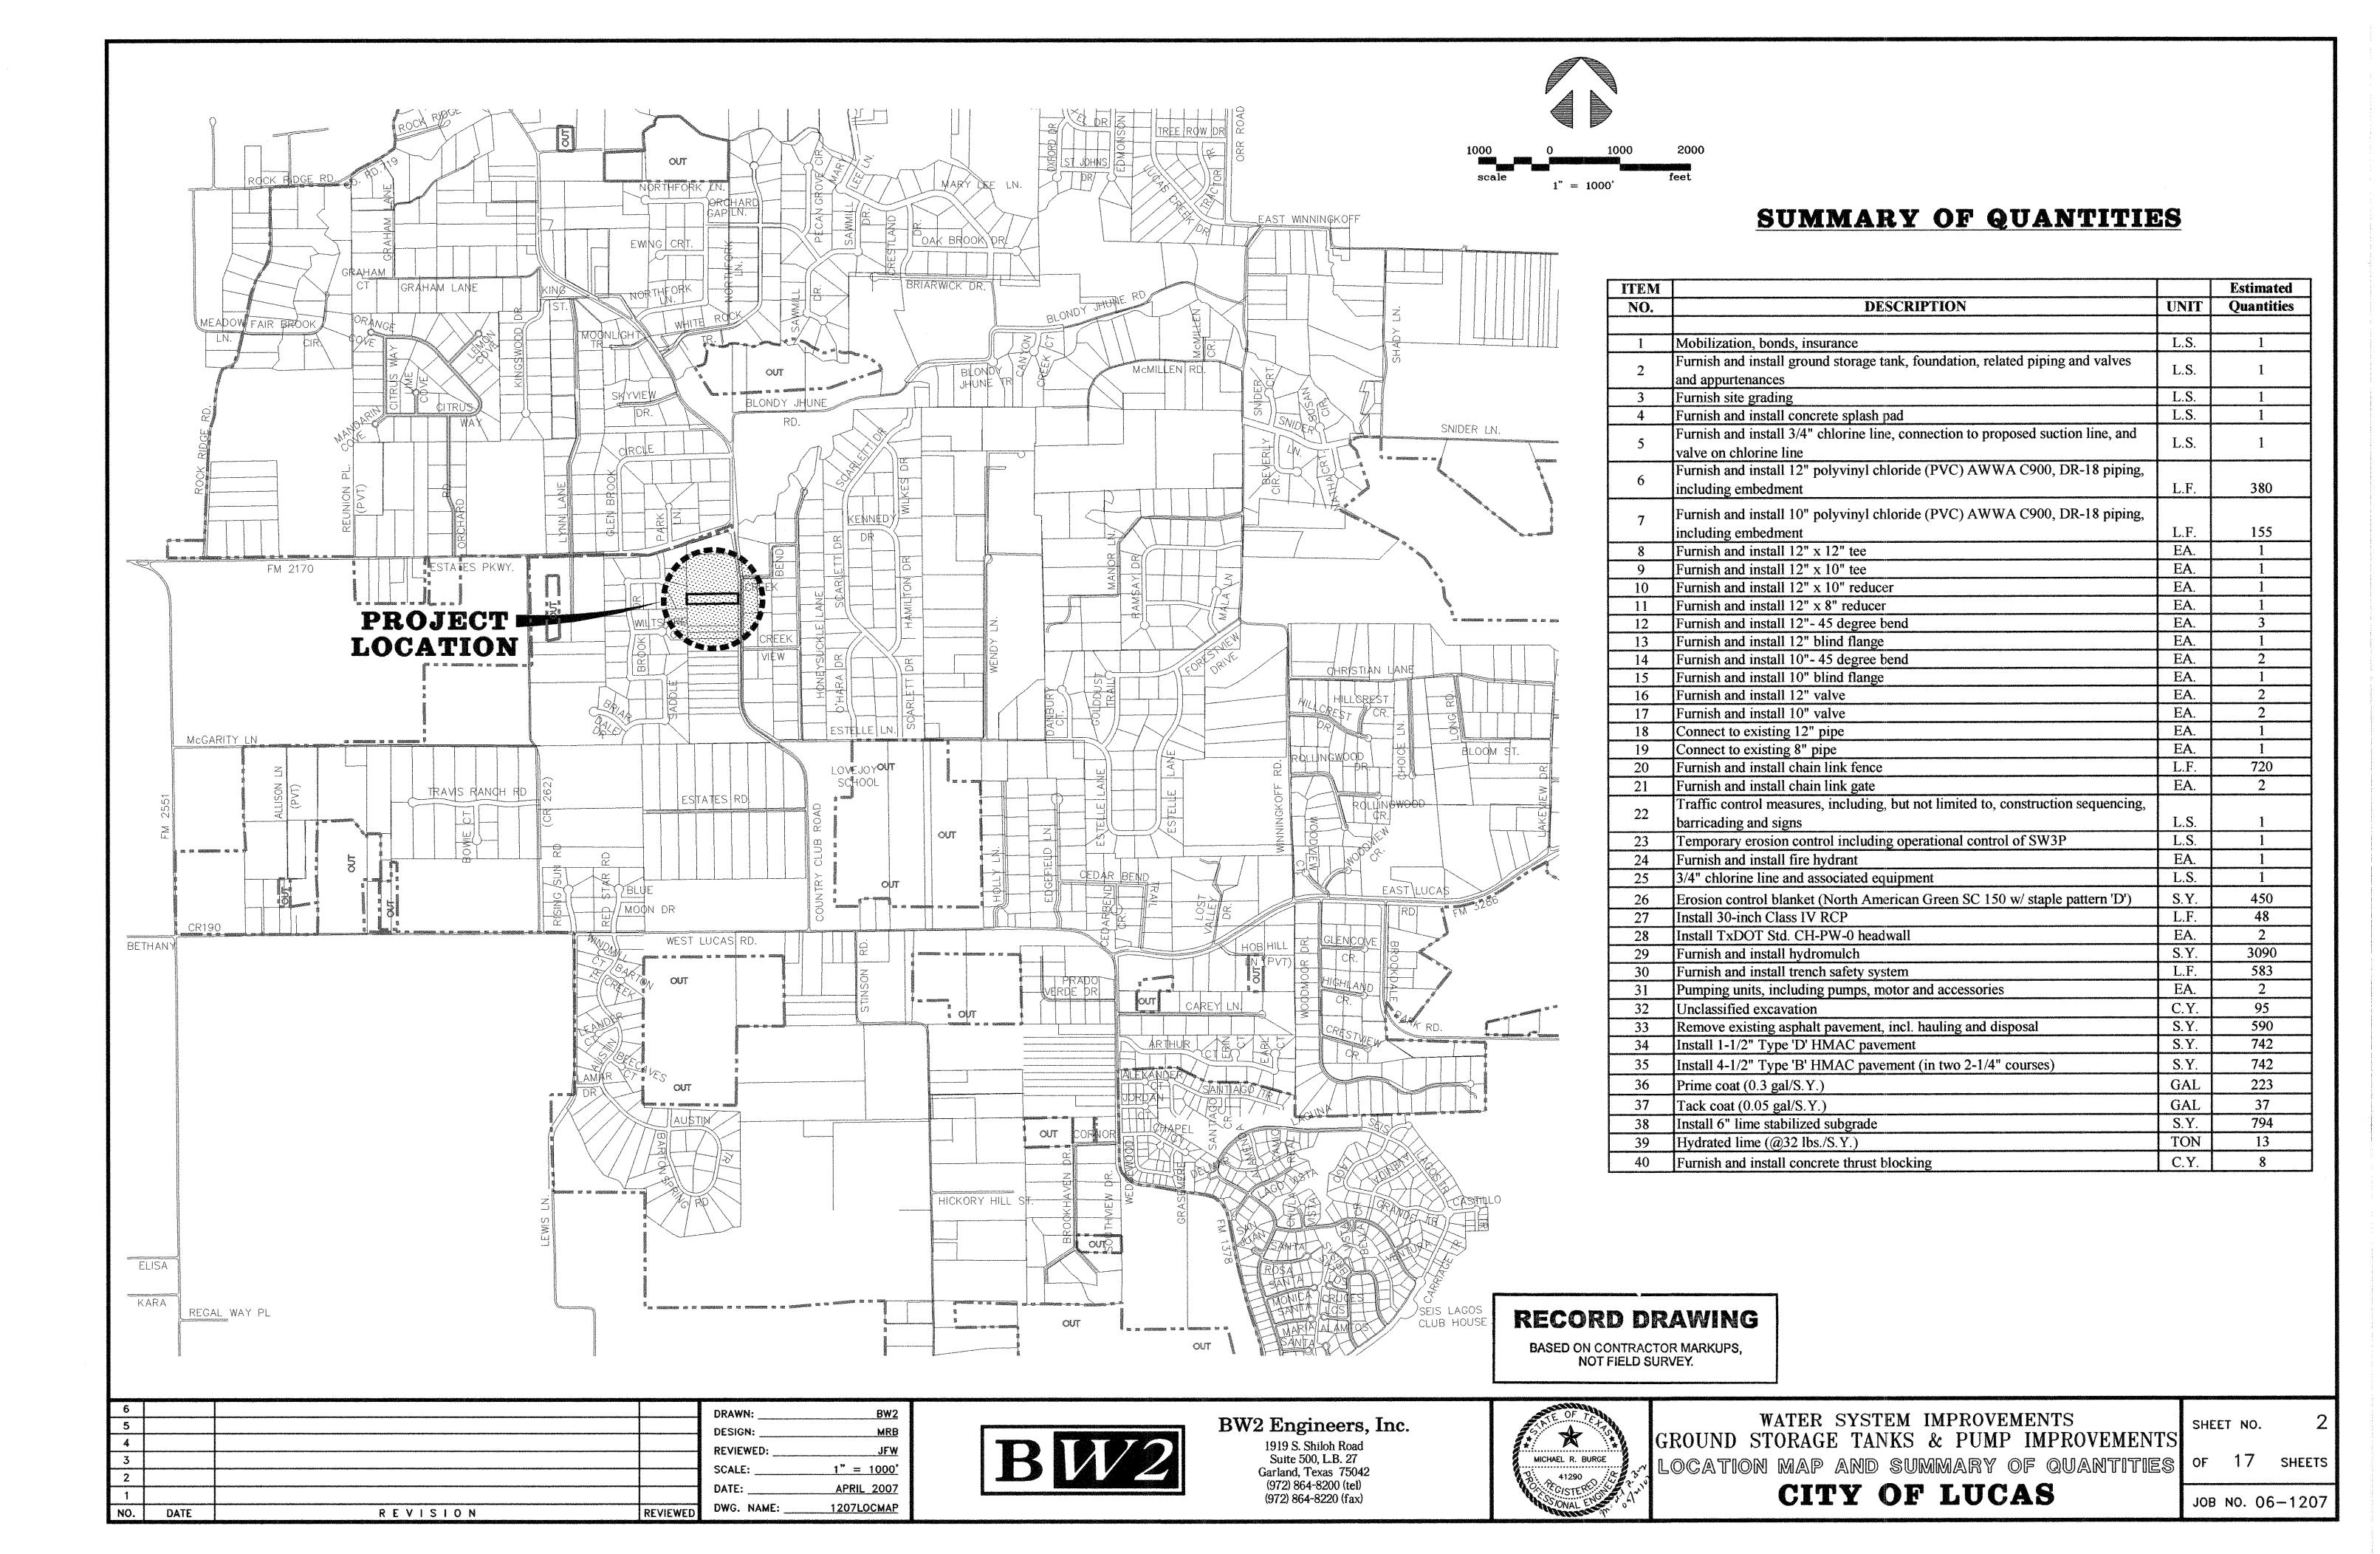

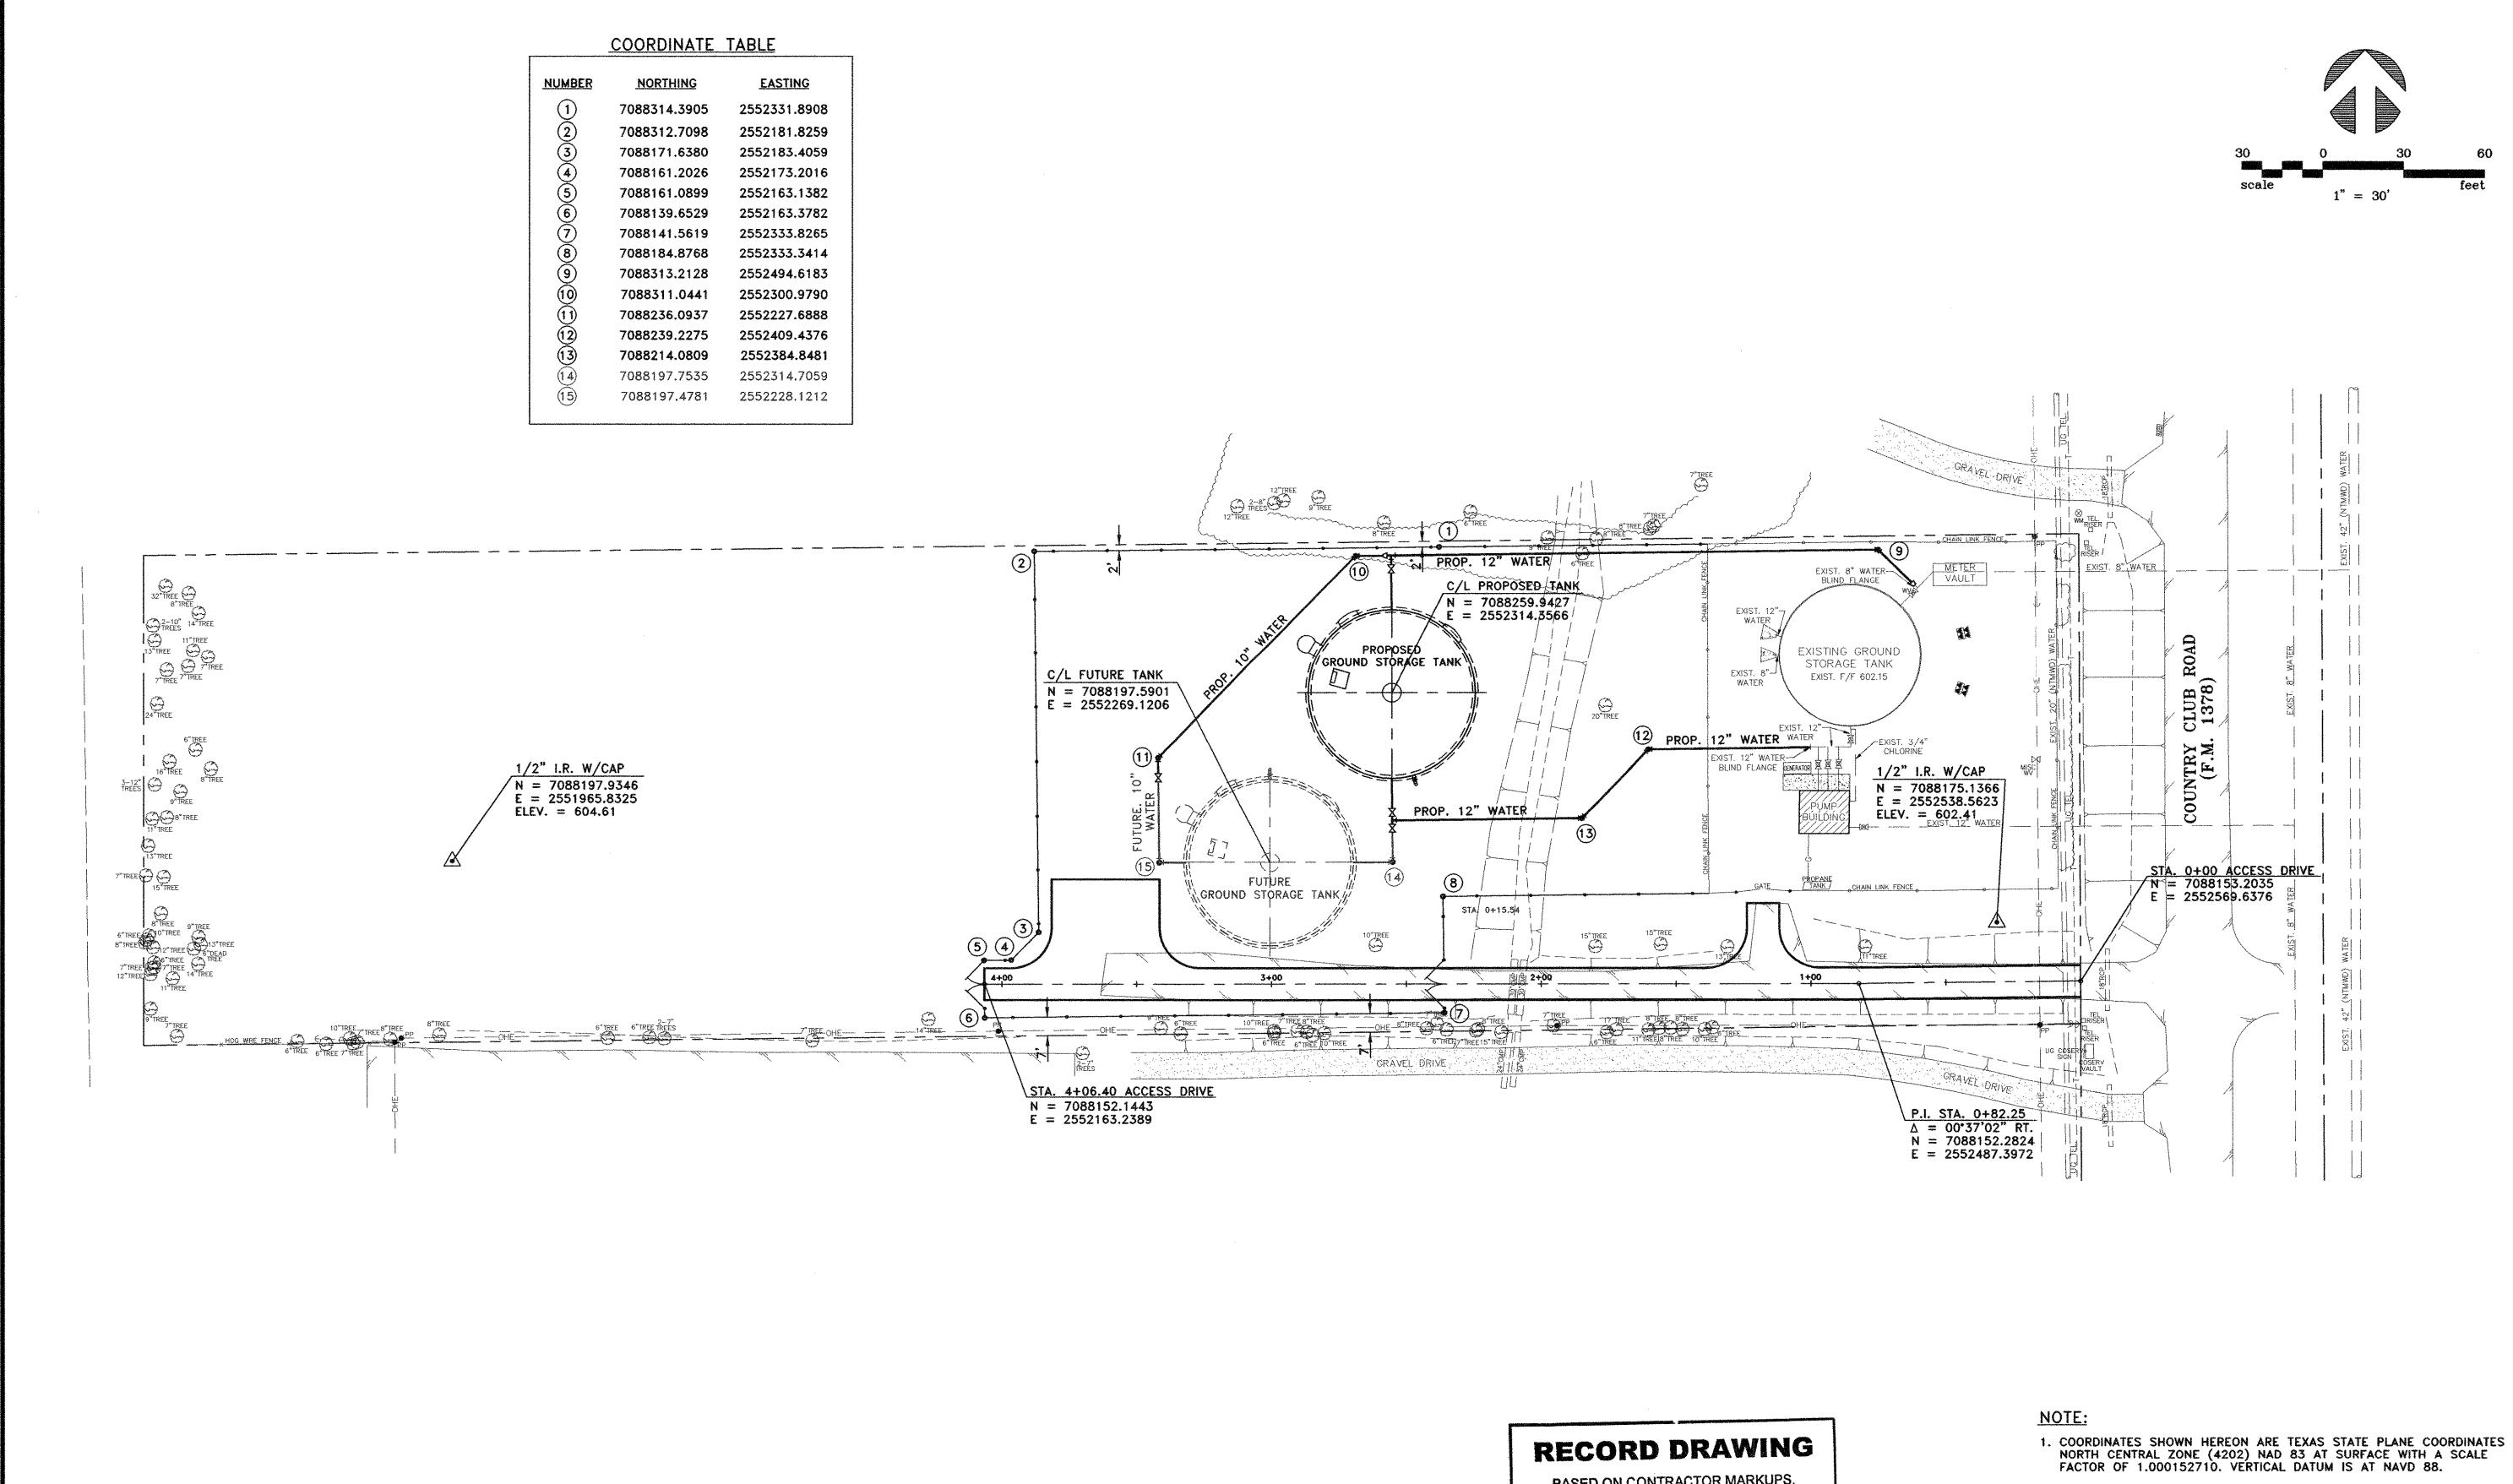

BASED ON CONTRACTOR MARKUPS, NOT FIELD SURVEY.

6				DRAWN: BW2
5				DESIGN: MRB
4				REVIEWED:JFW
3				SCALE:1" = 30'
4				DATE:APRIL 2007
NO.	DATE	REVISION	REVIEWED	DWG. NAME: 1207HORZCONT



BW2 Engineers, Inc.


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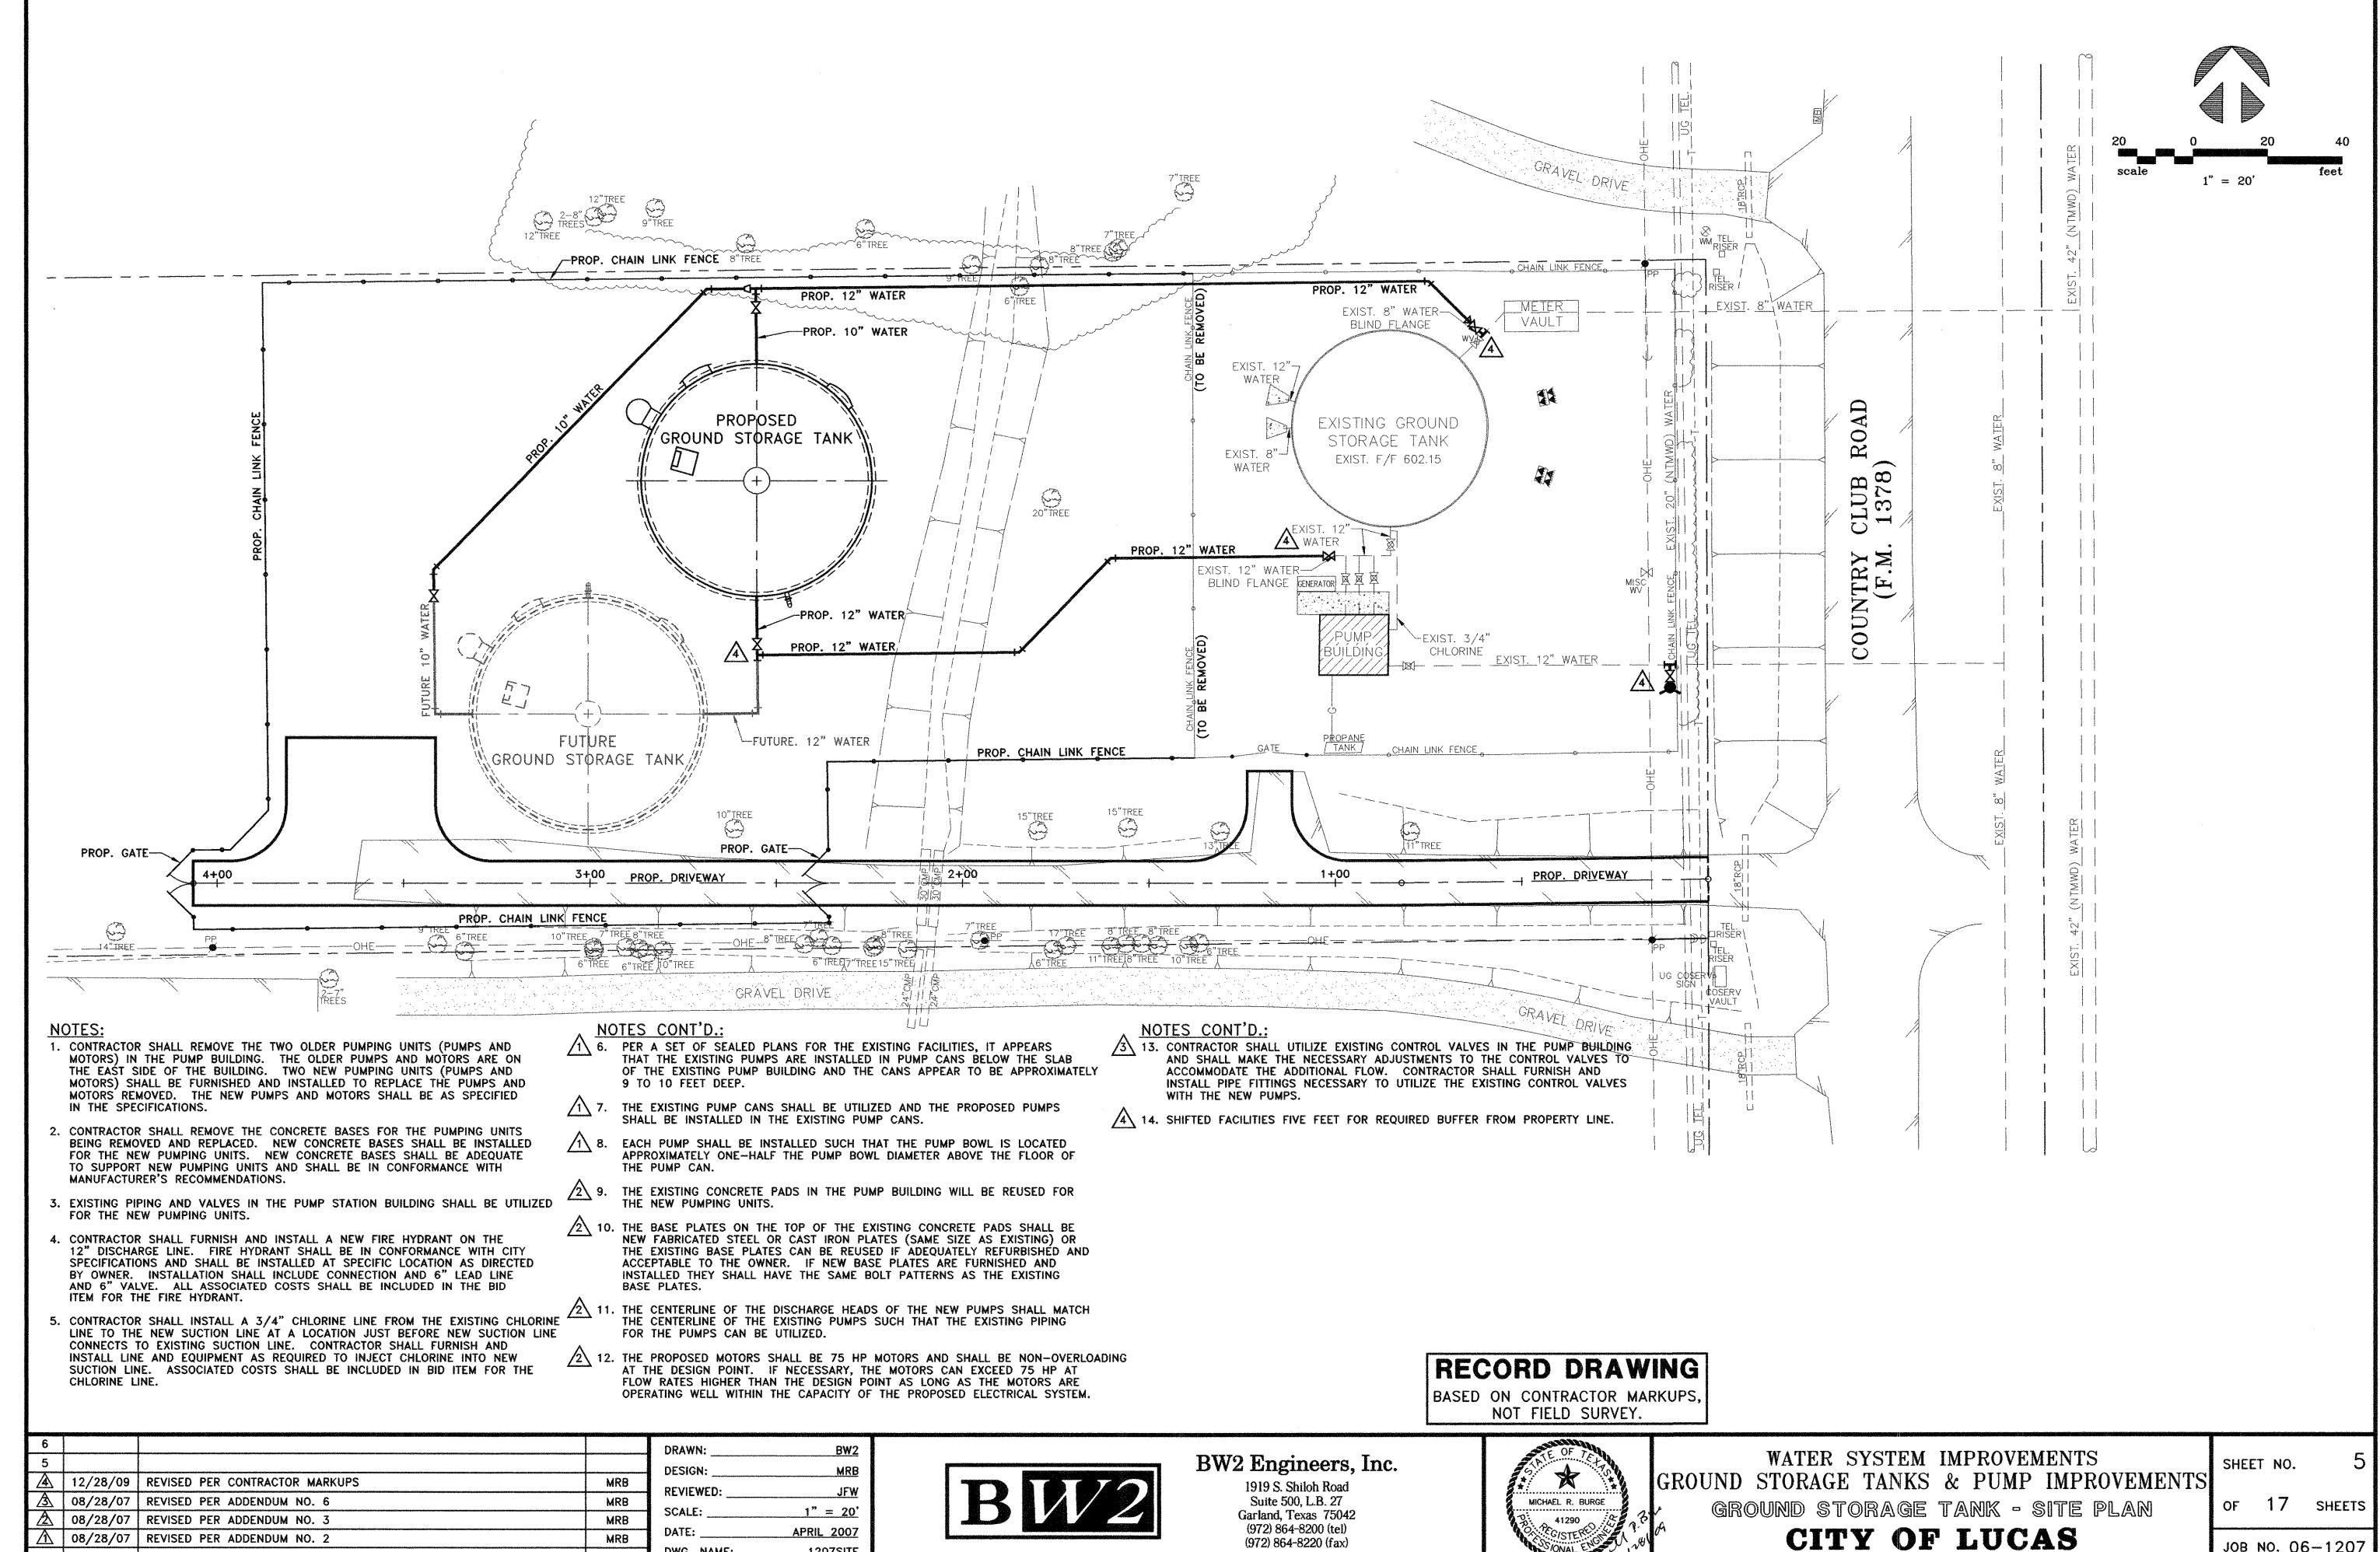


WATER SYSTEM IMPROVEMENTS GROUND STORAGE TANKS & PUMP IMPROVEMENTS HORIZONTAL AND VERTICAL CONTROL PLAN

CITY OF LUCAS

SHEET NO. OF 17 SHEETS



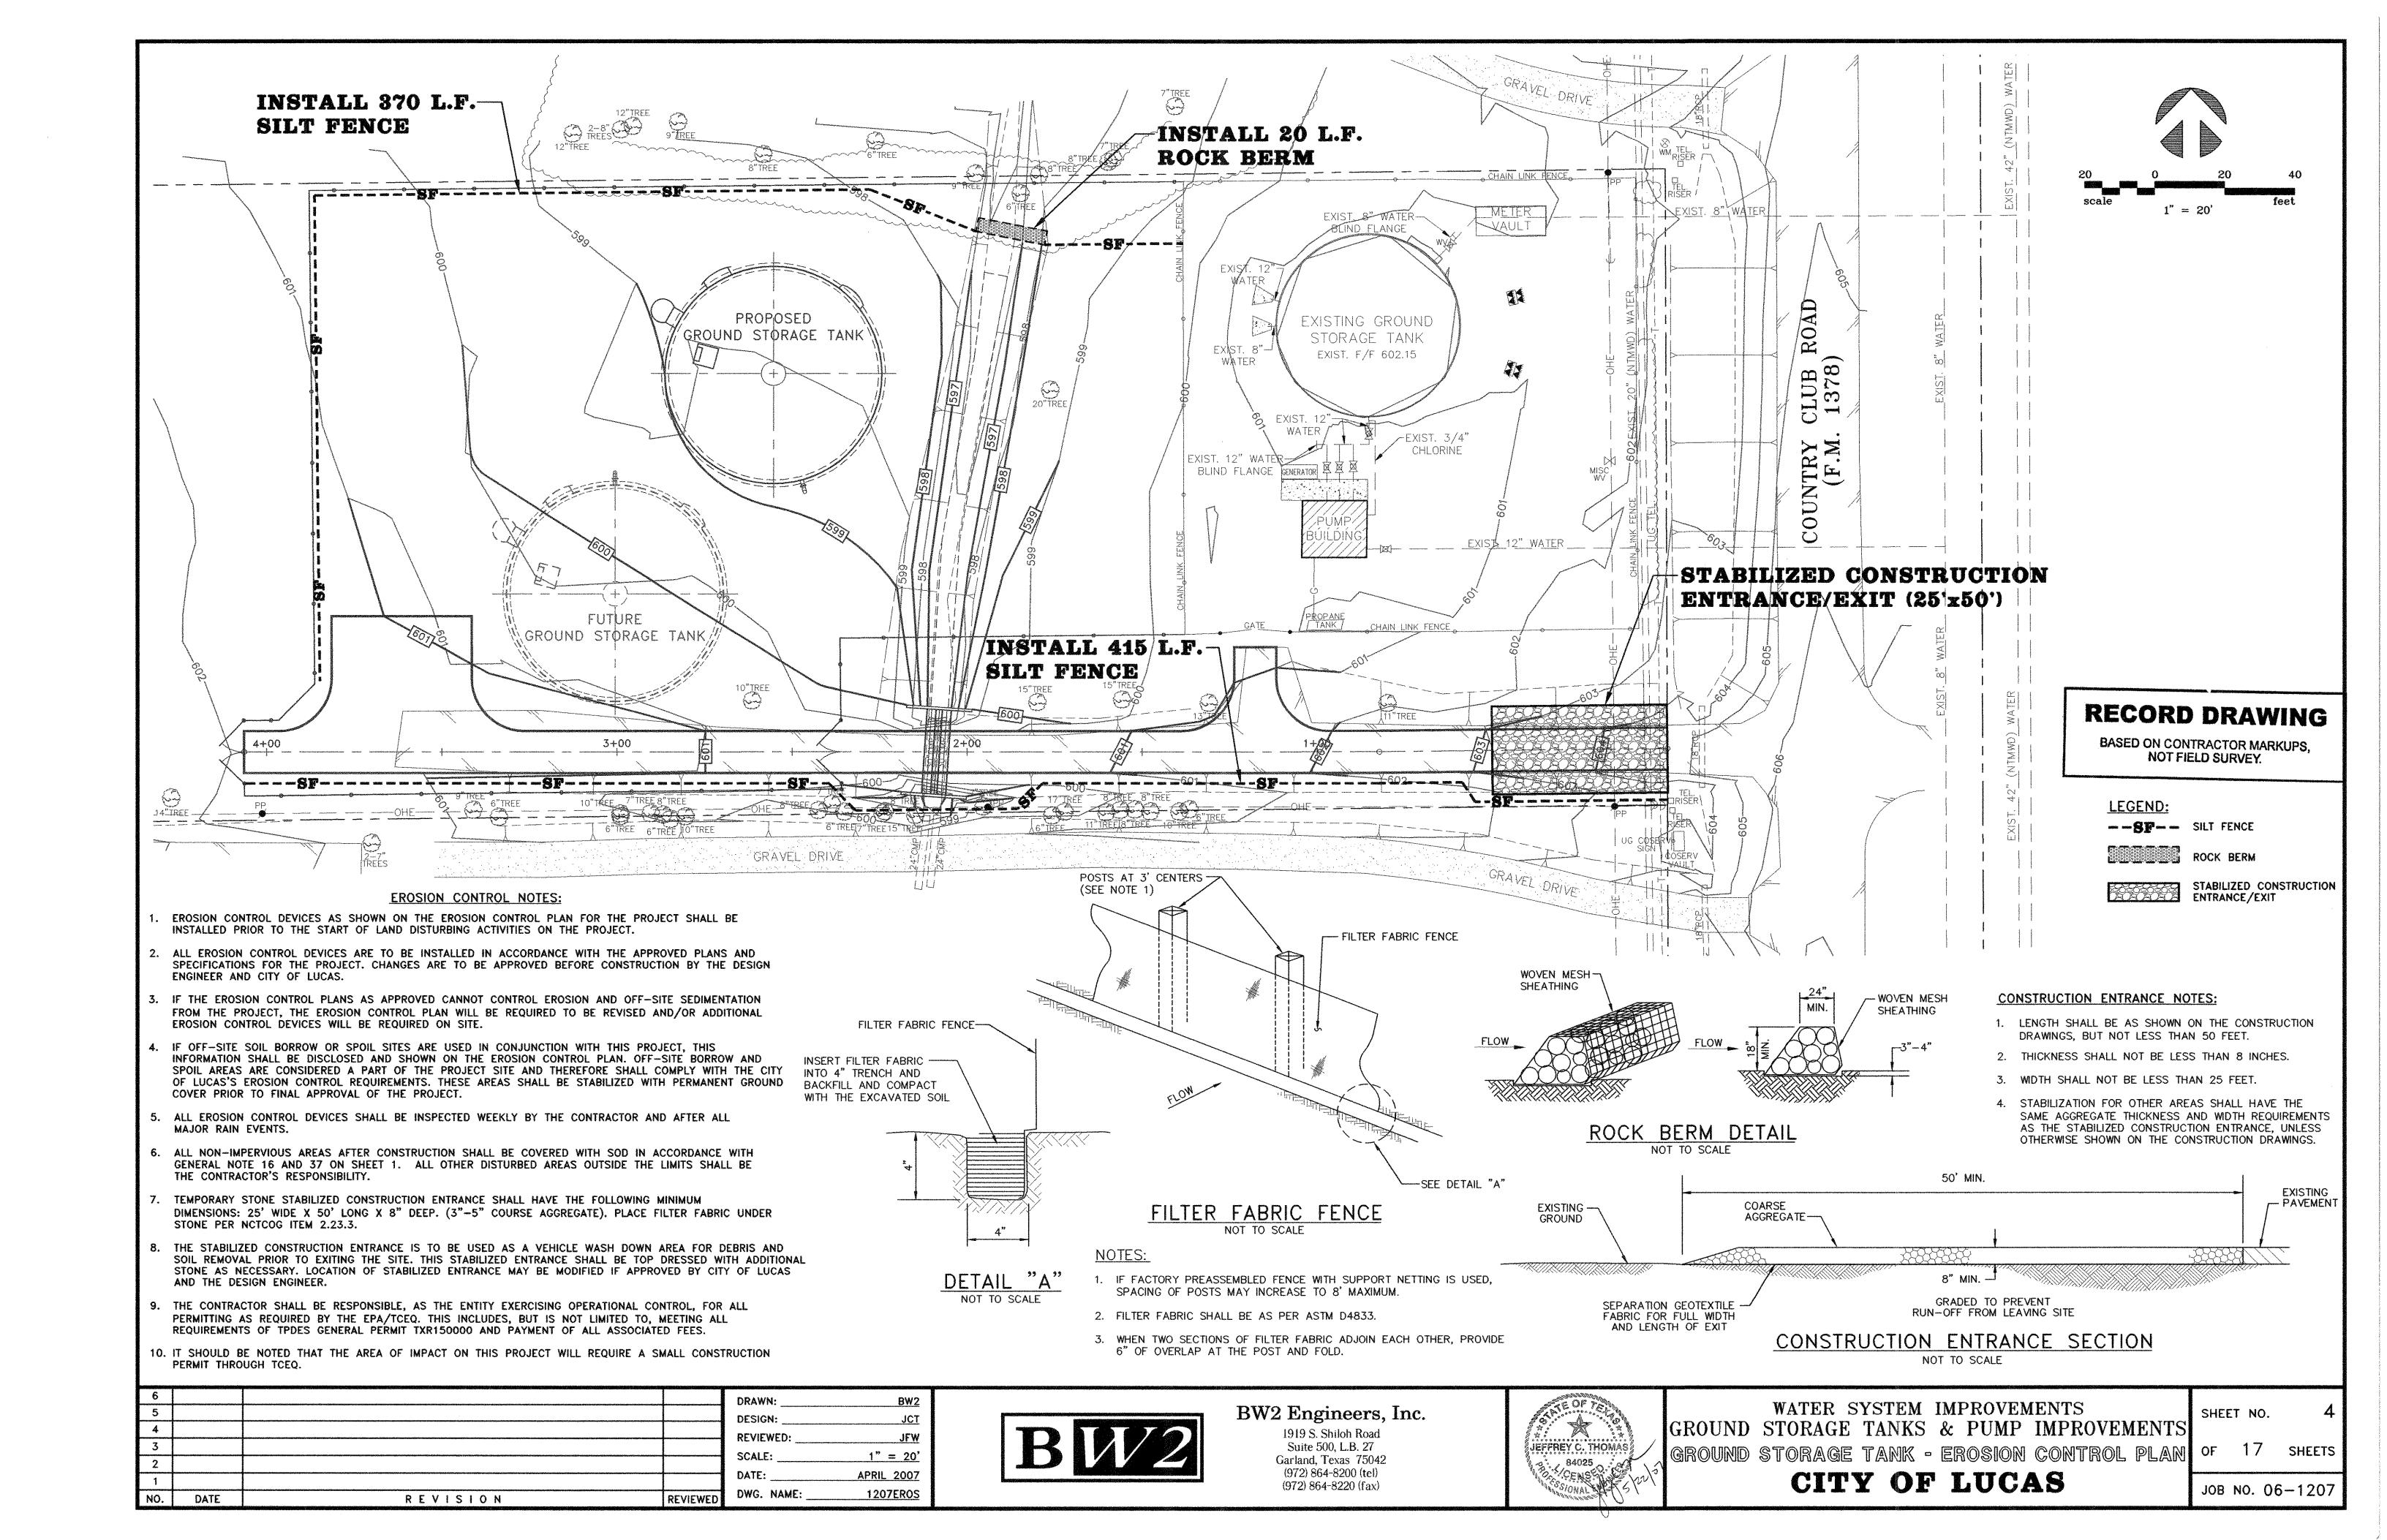

(972) 864-8220 (fax)


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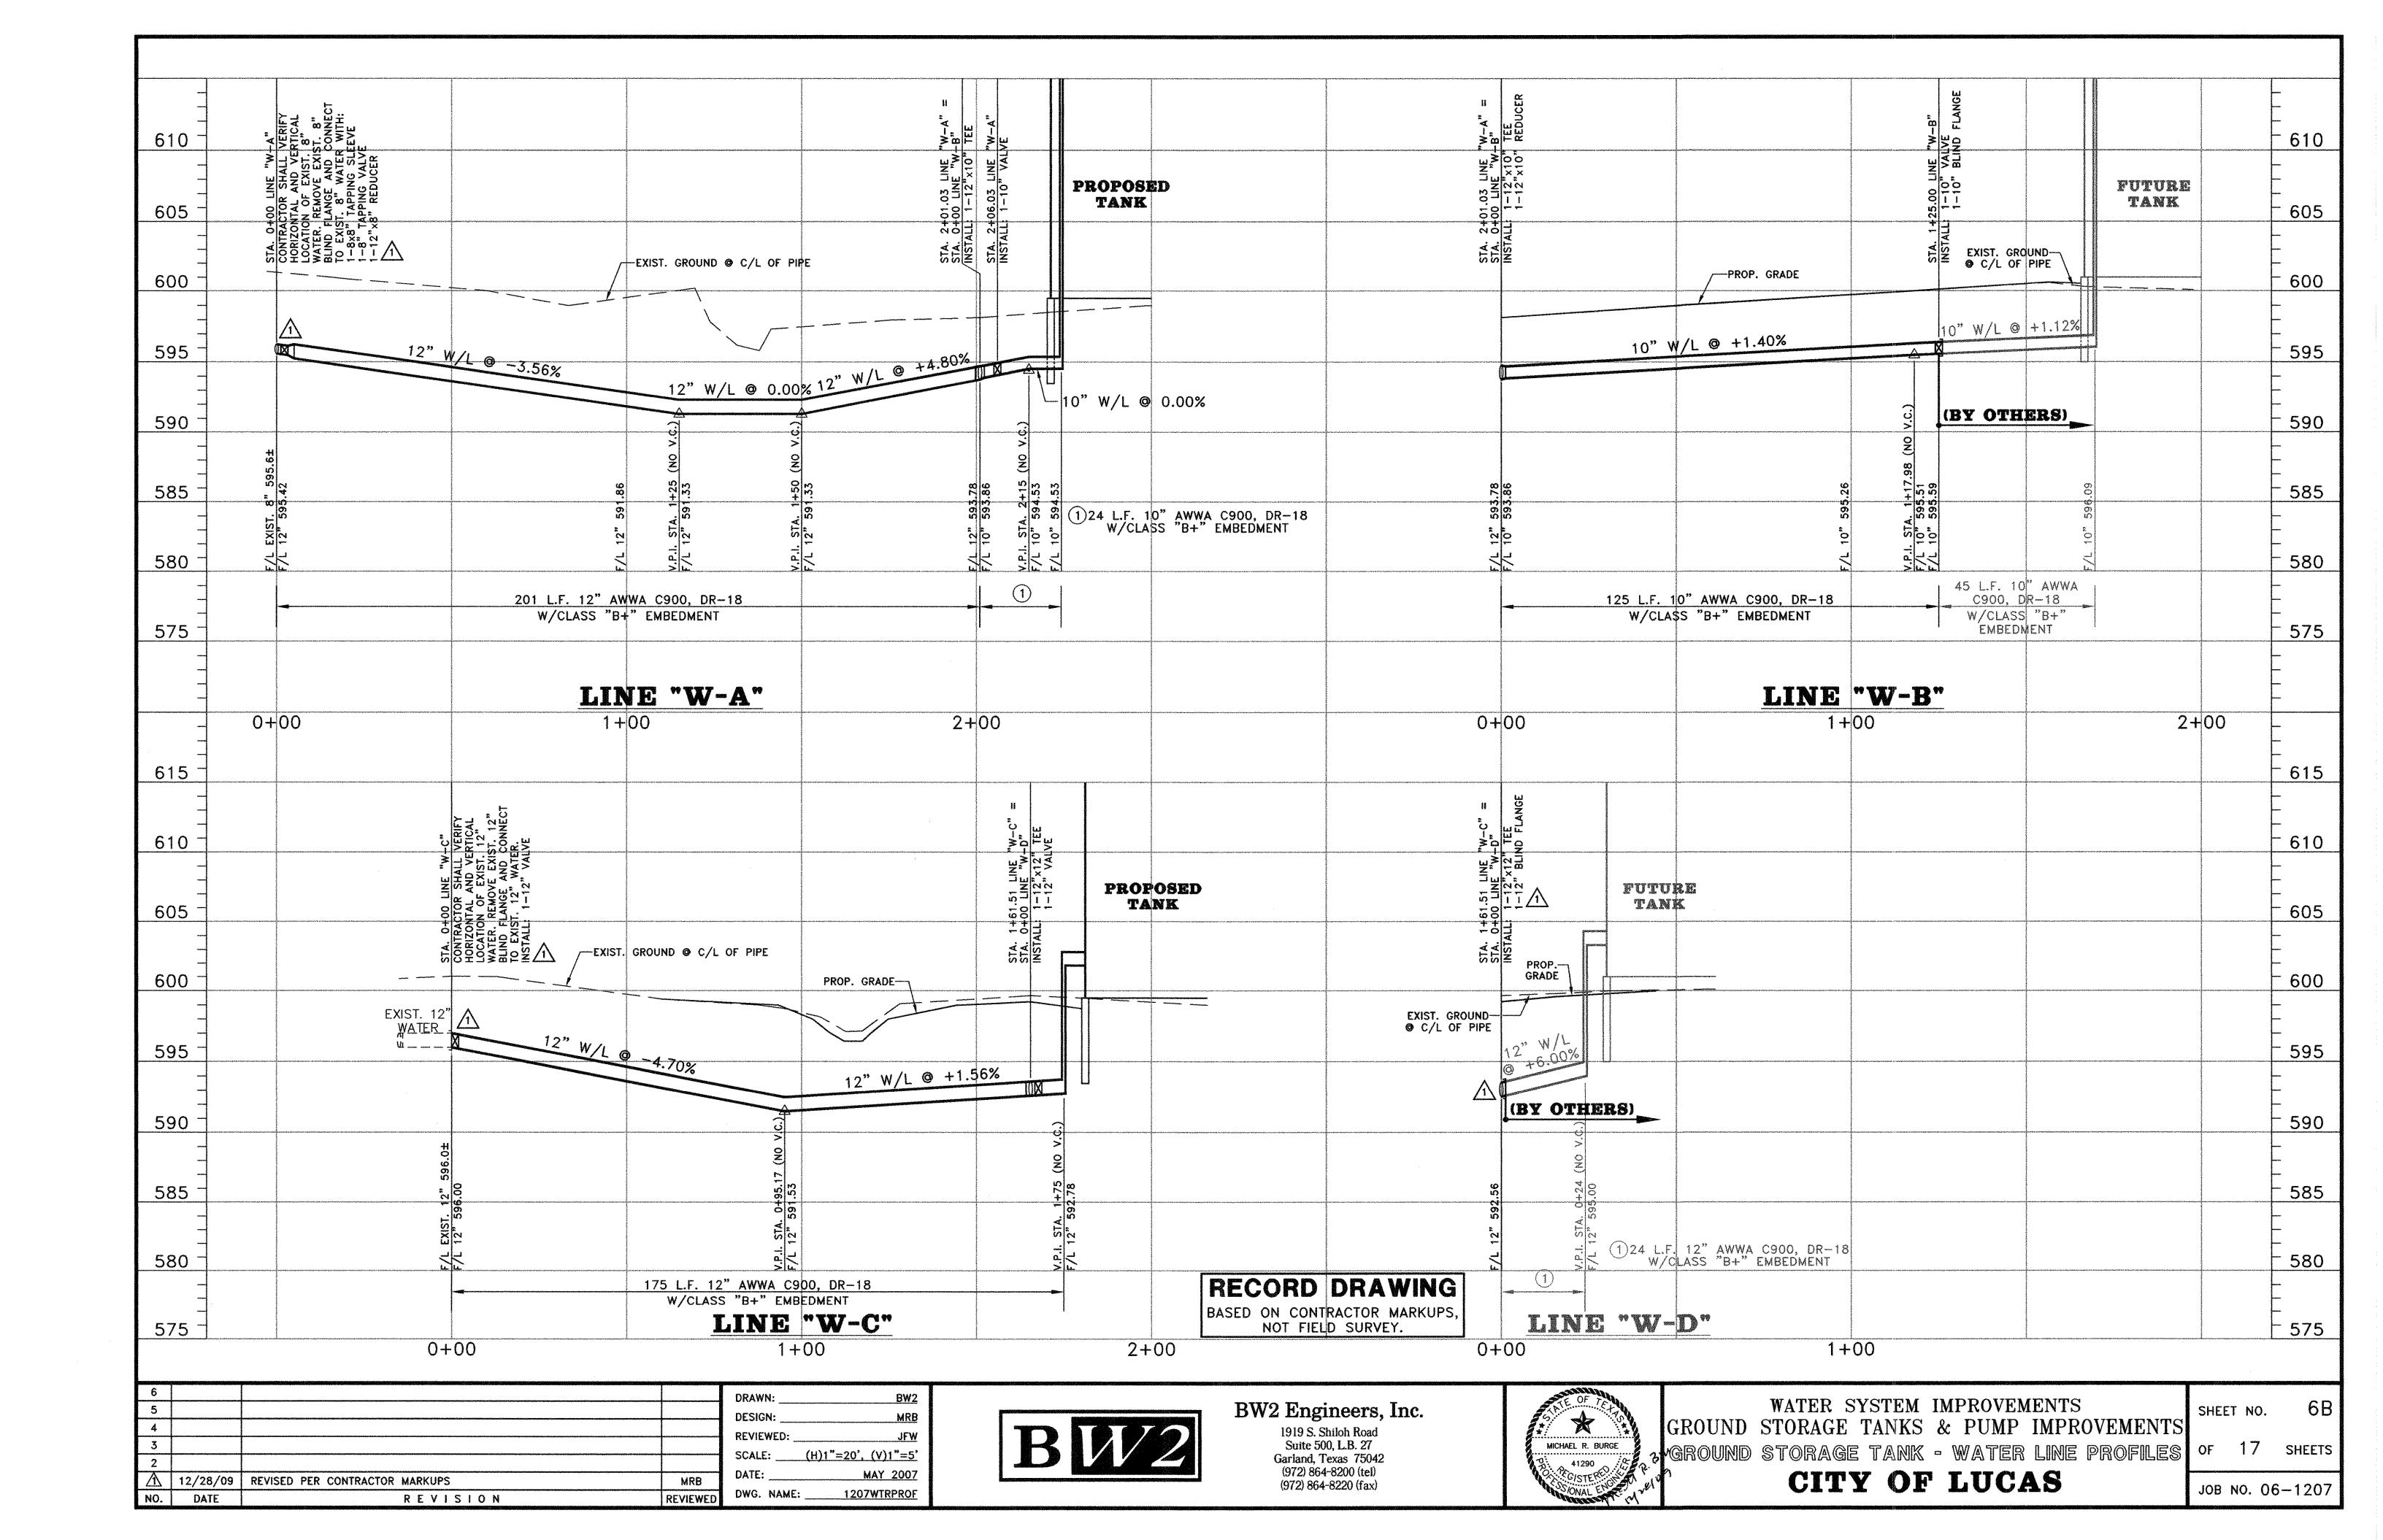
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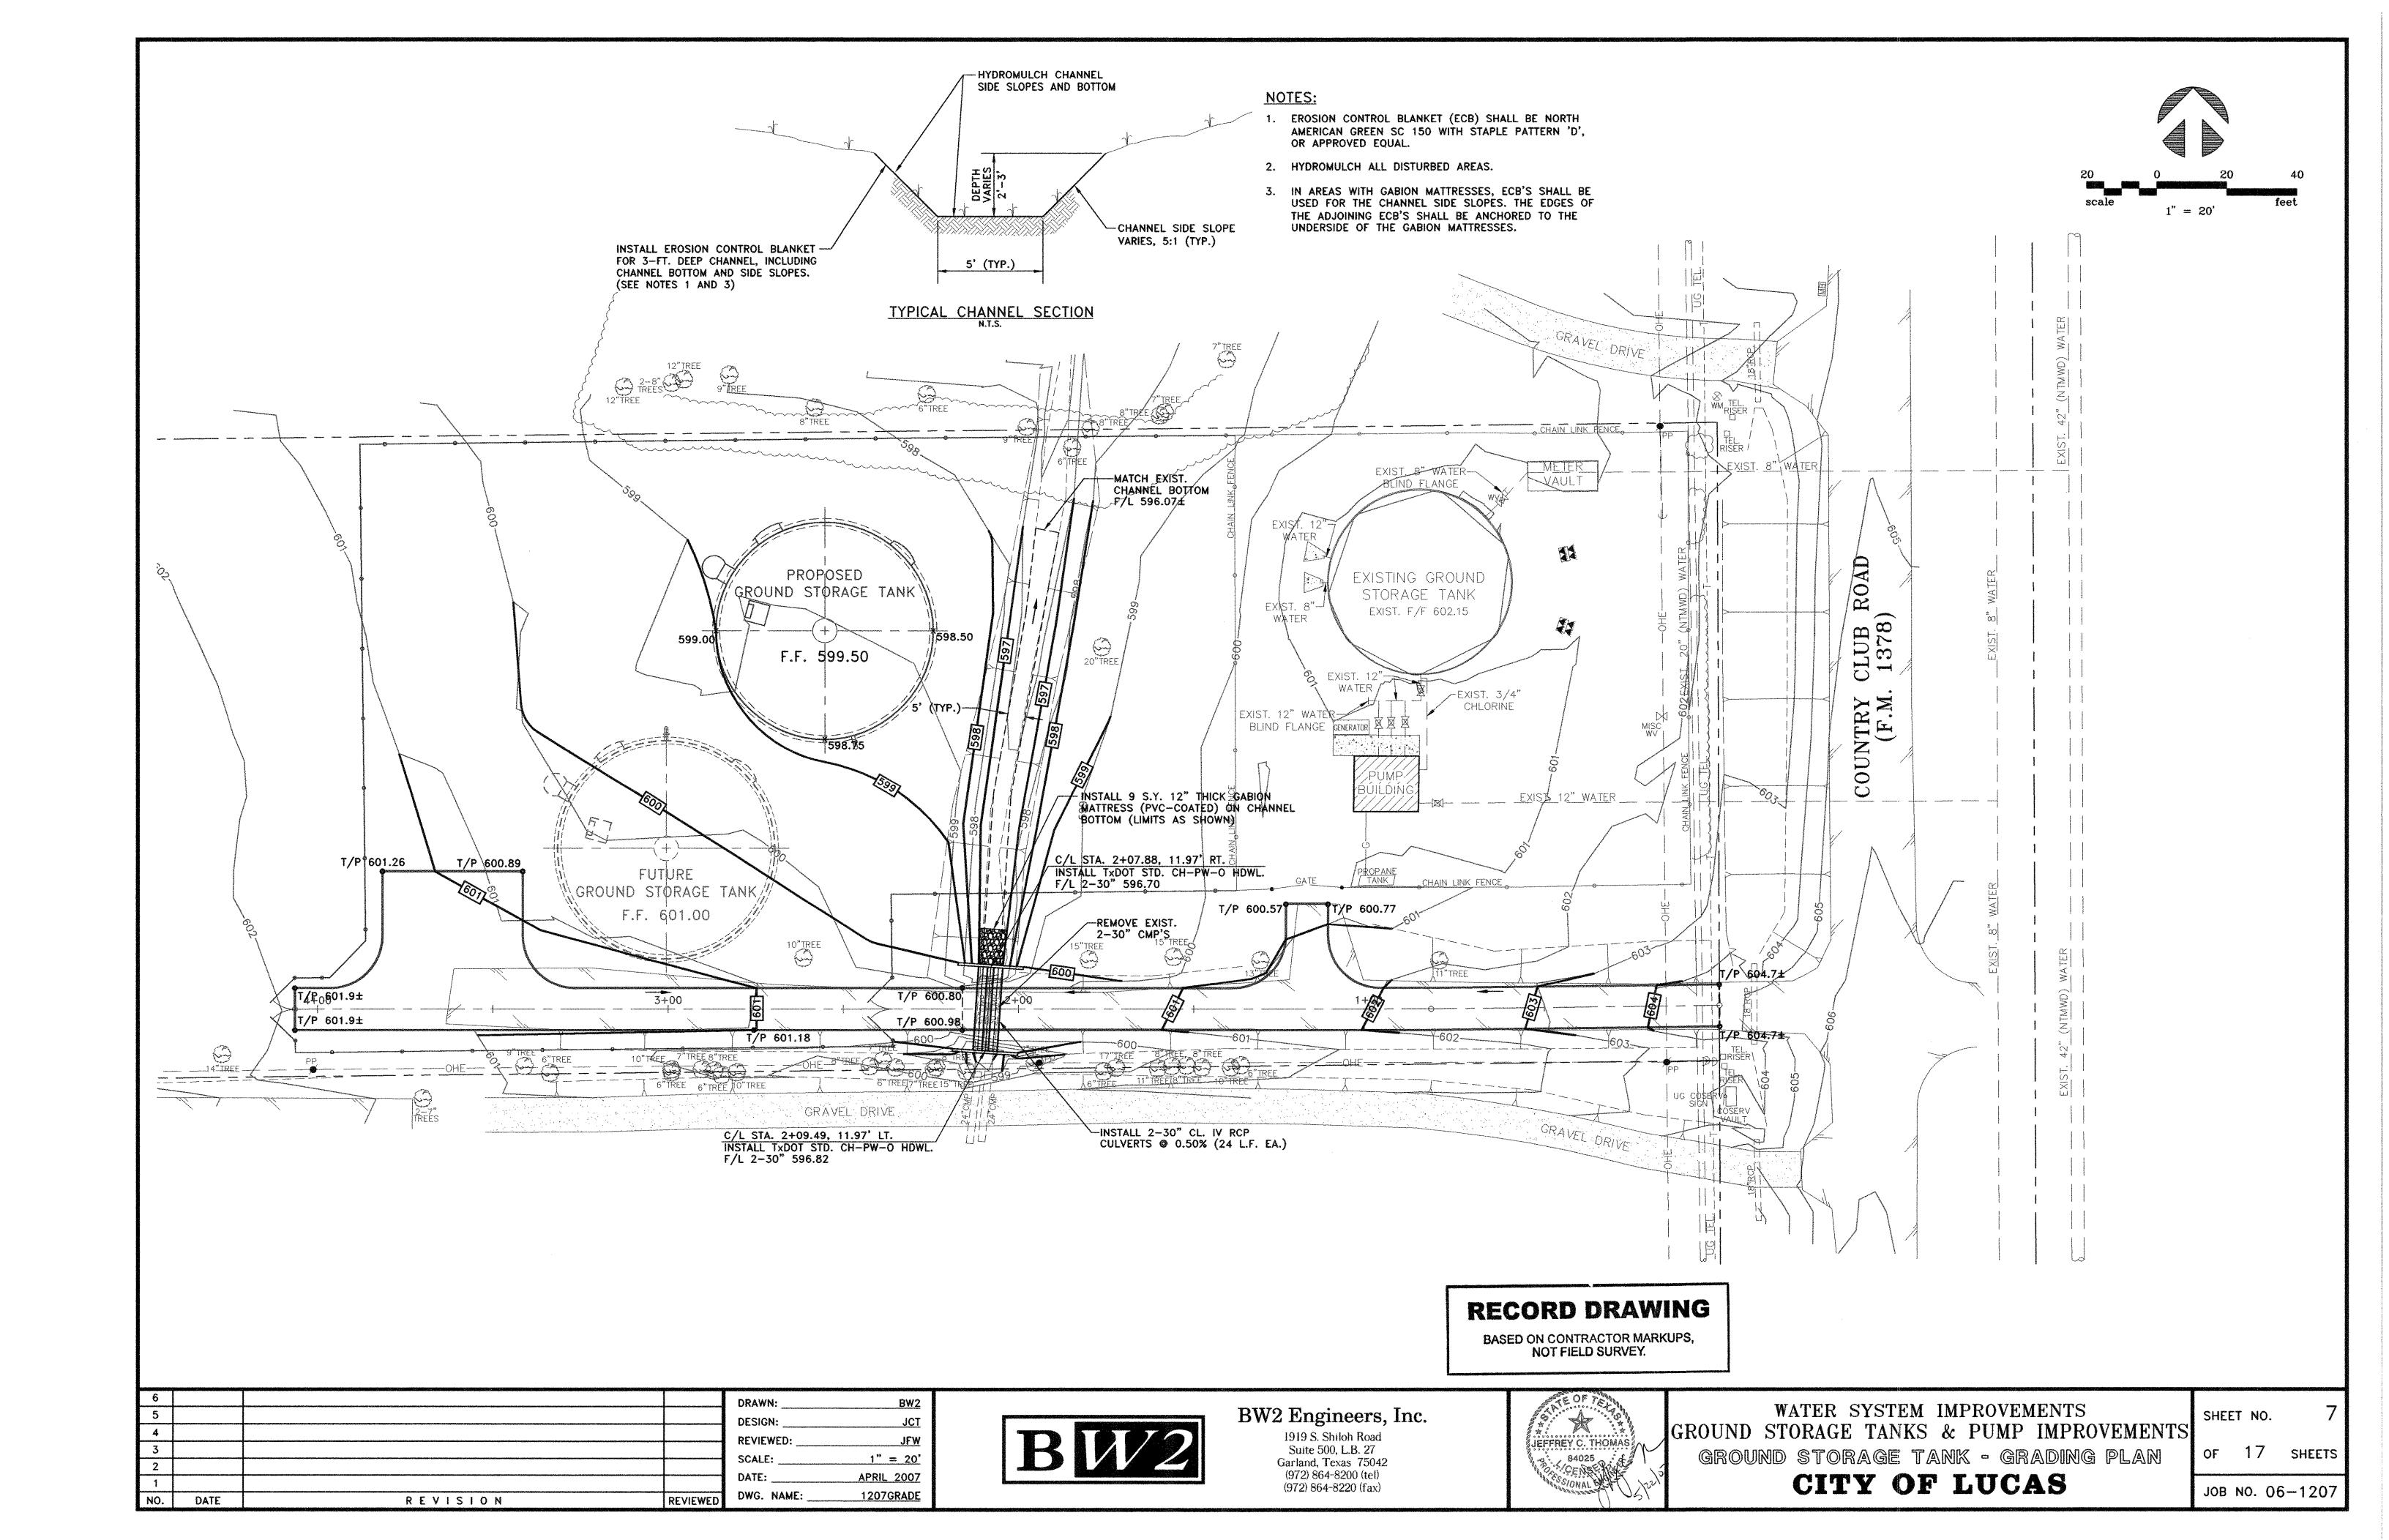
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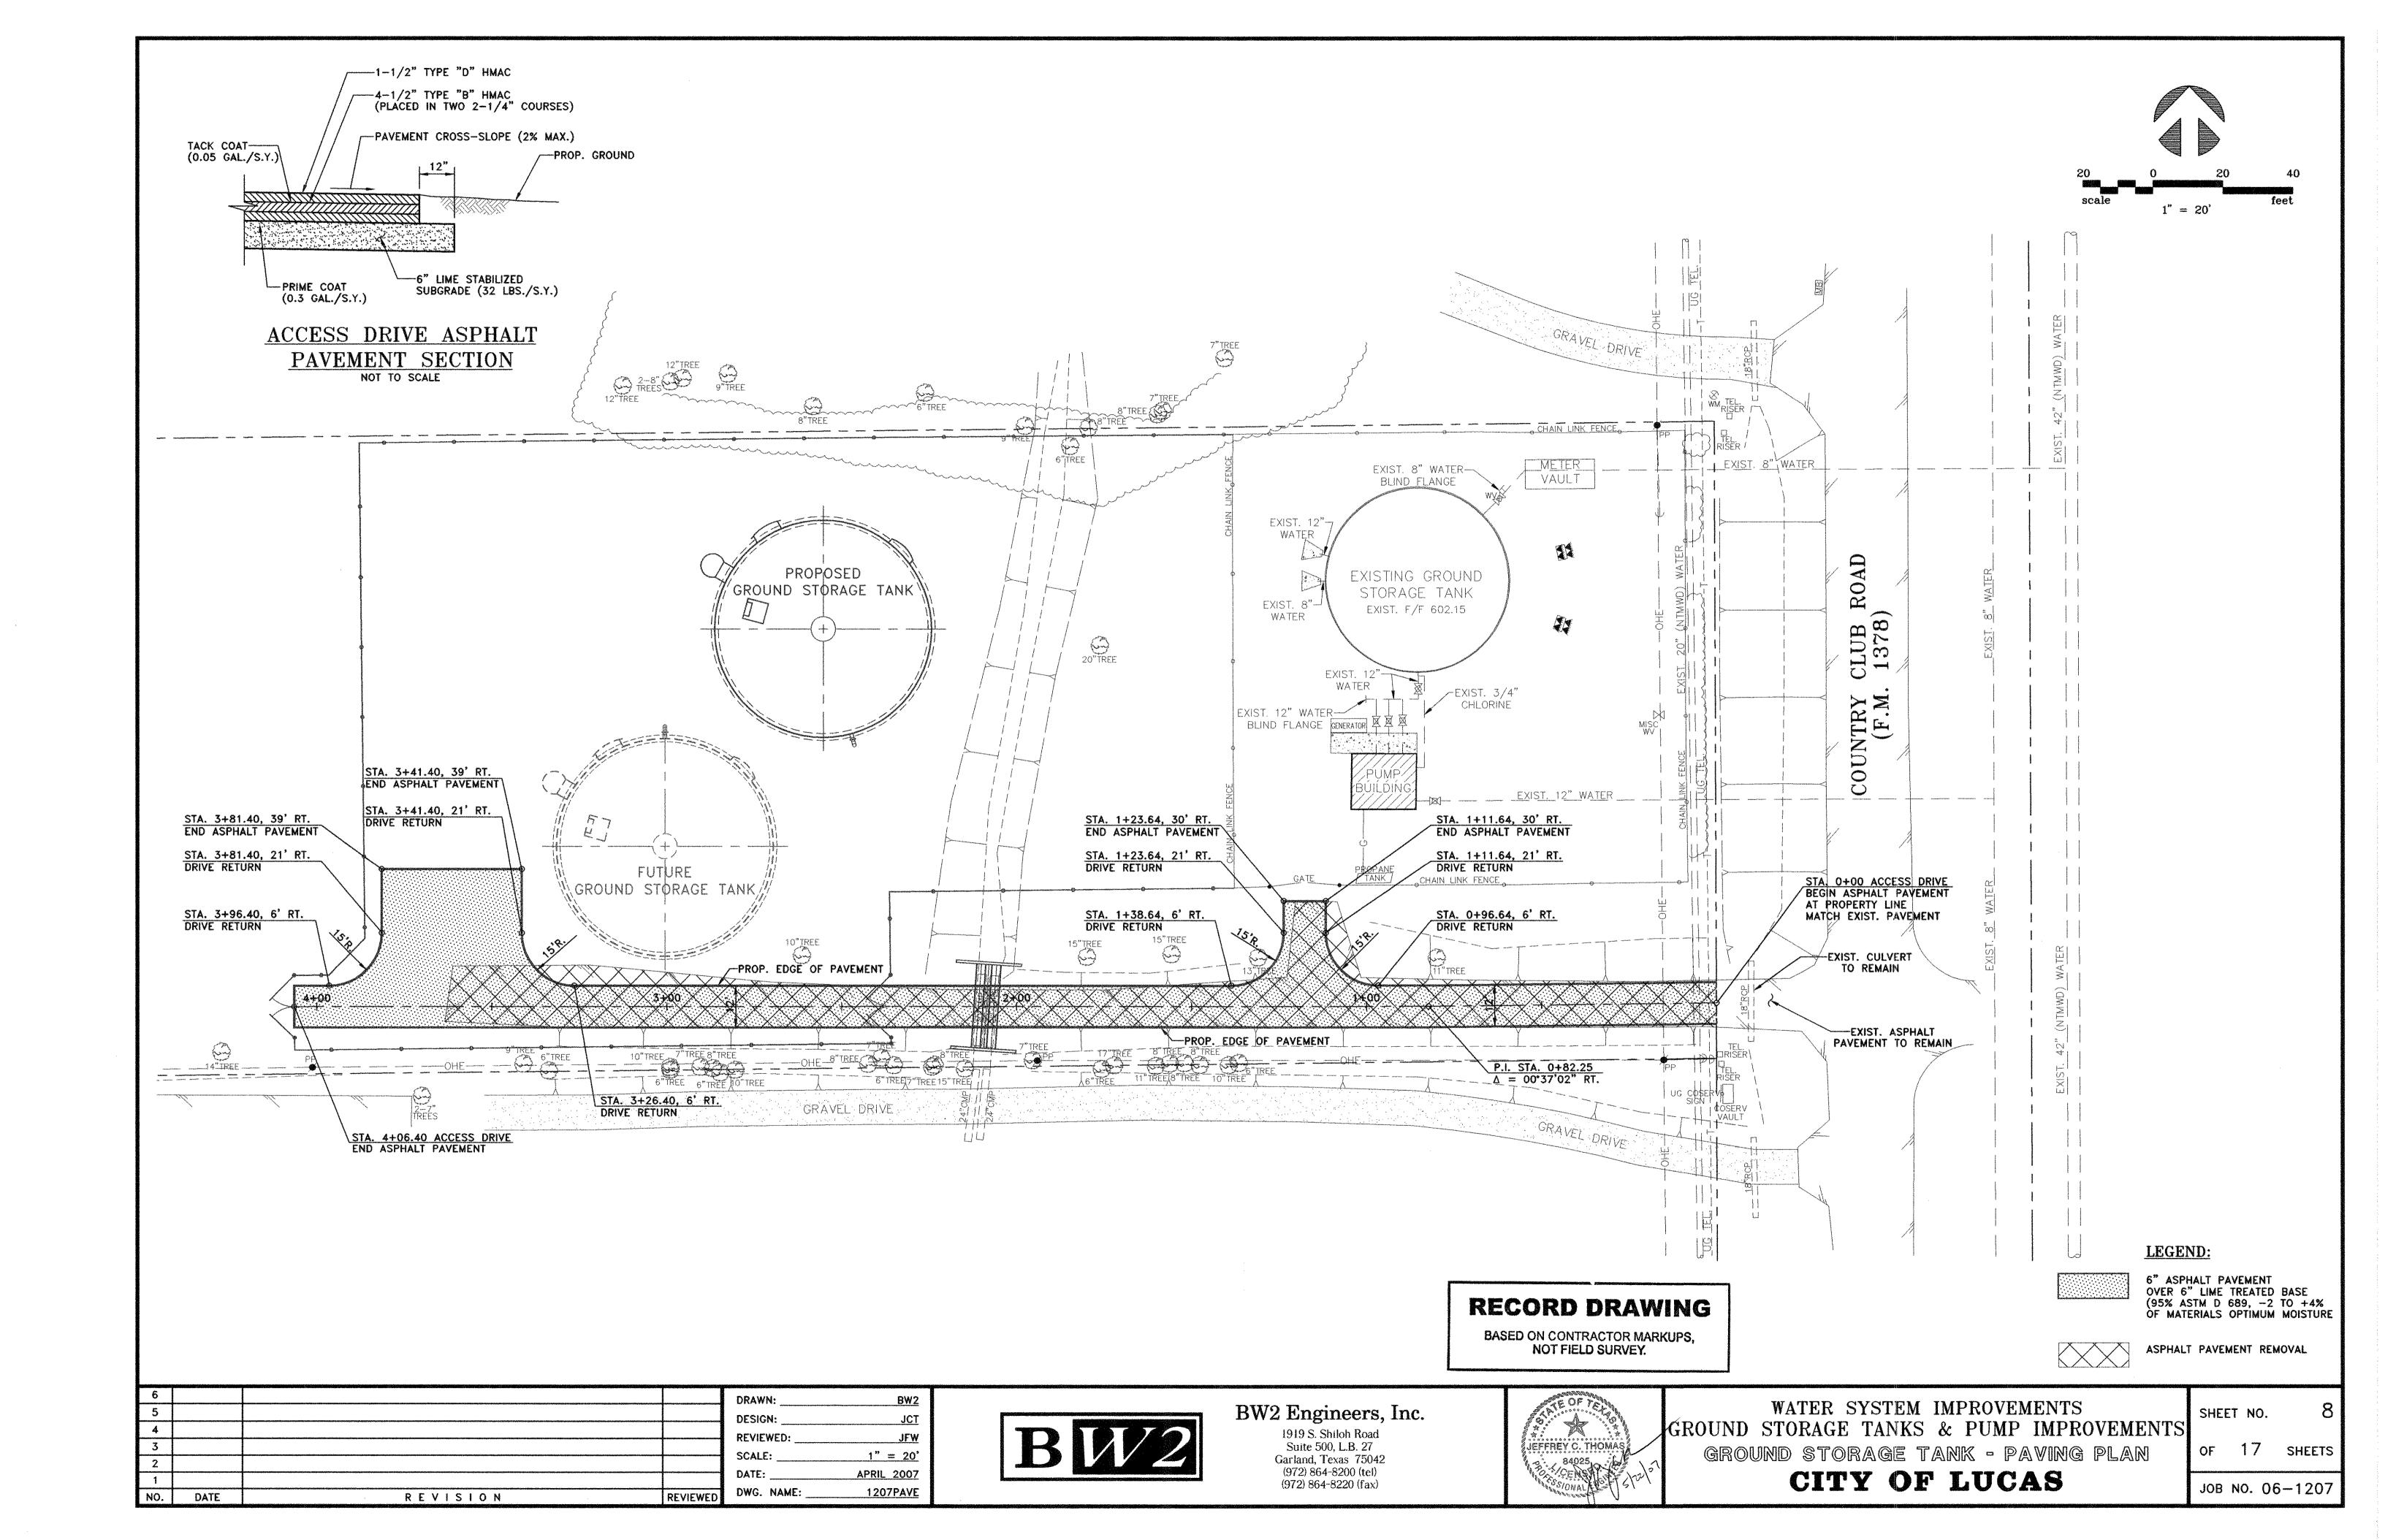
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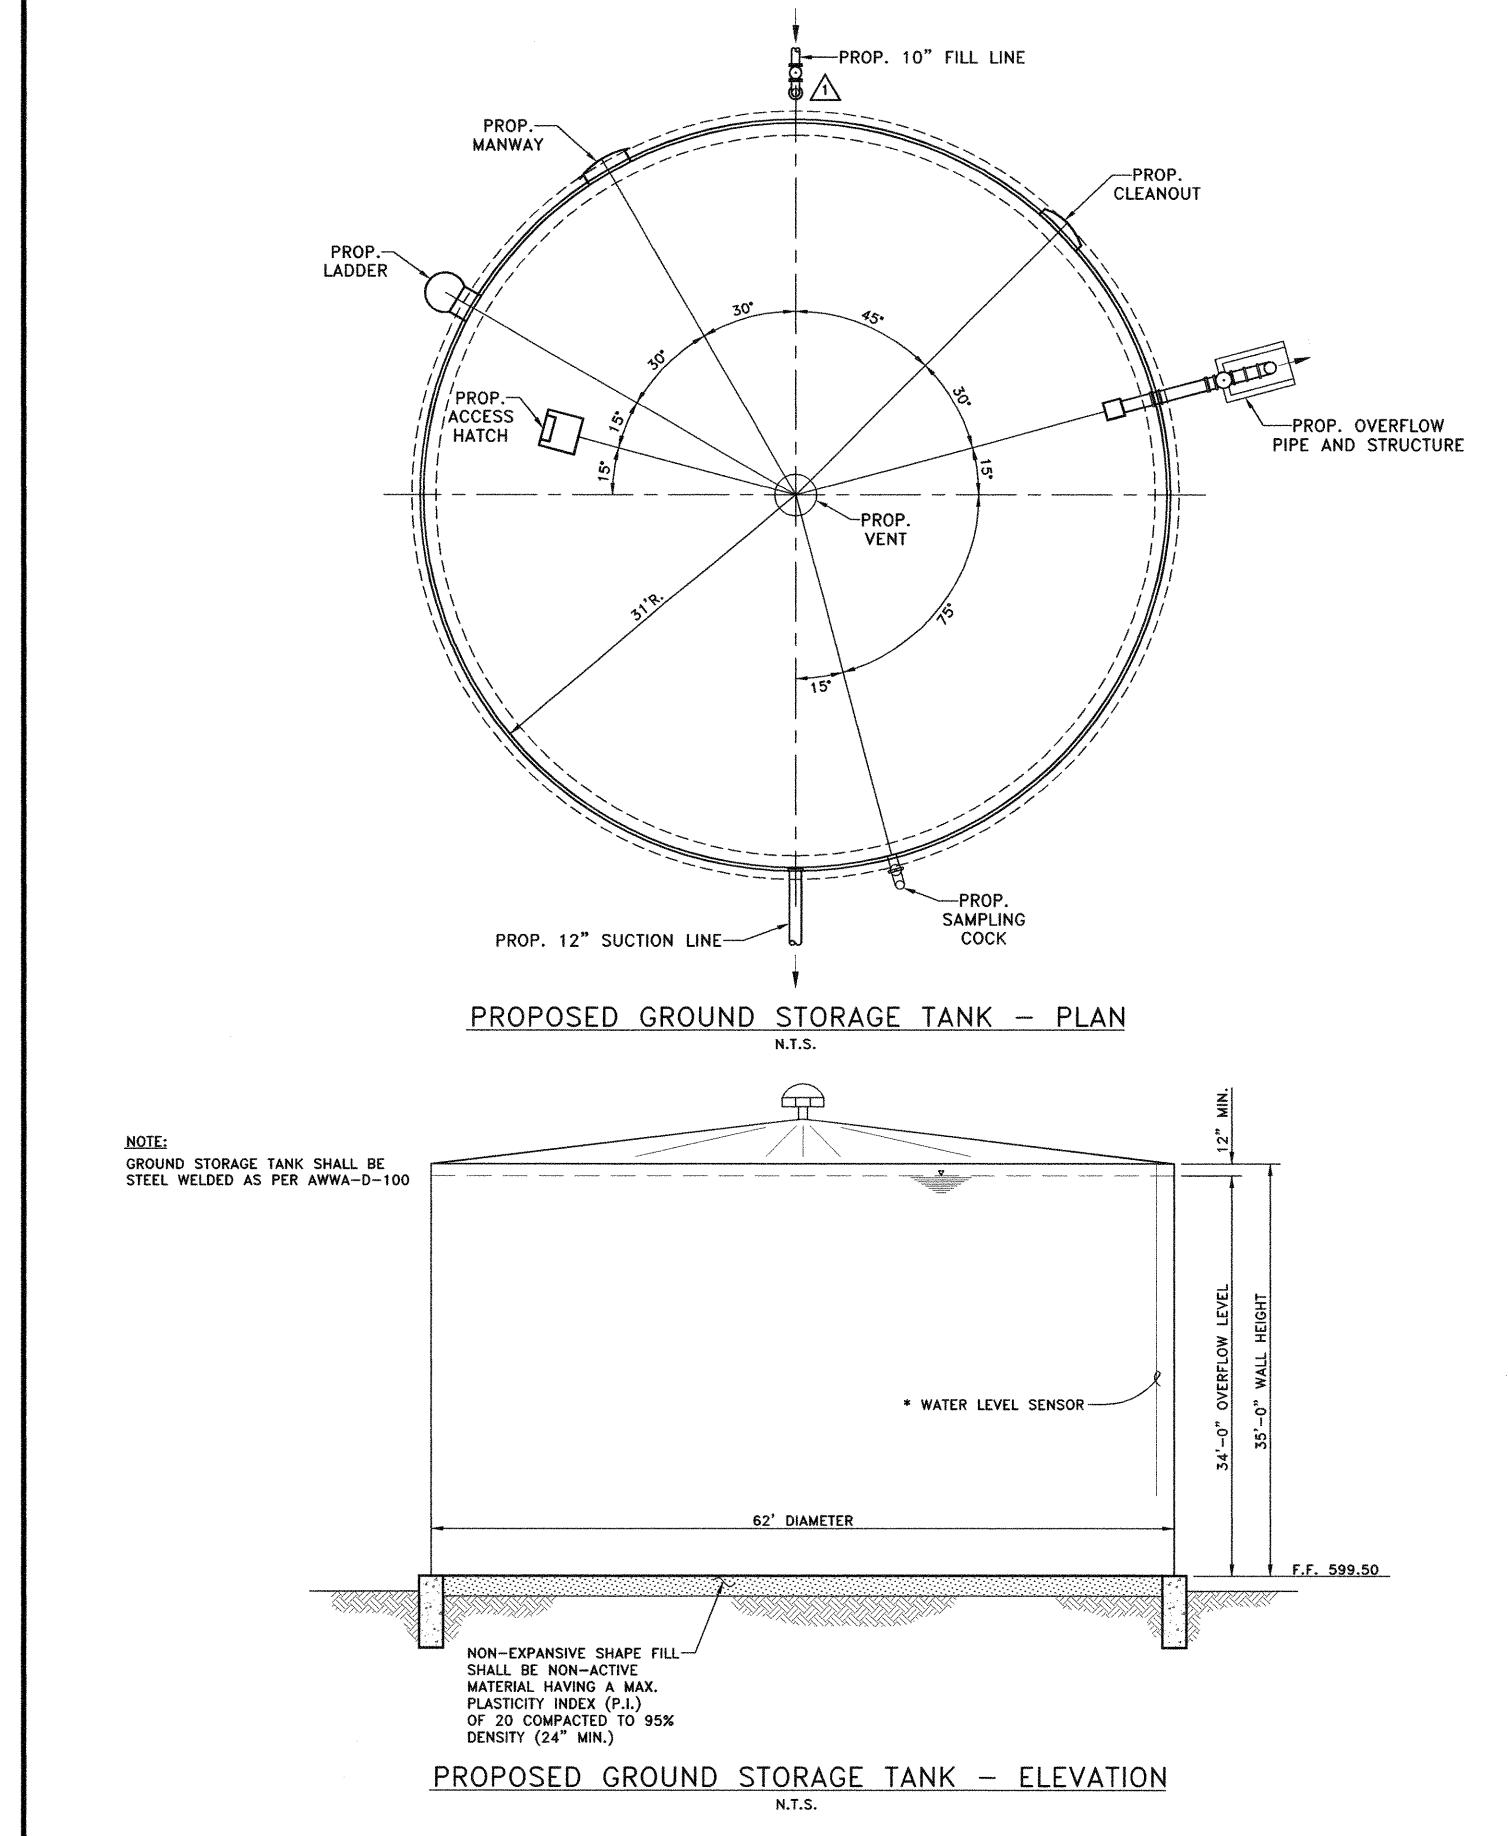
1207SITE









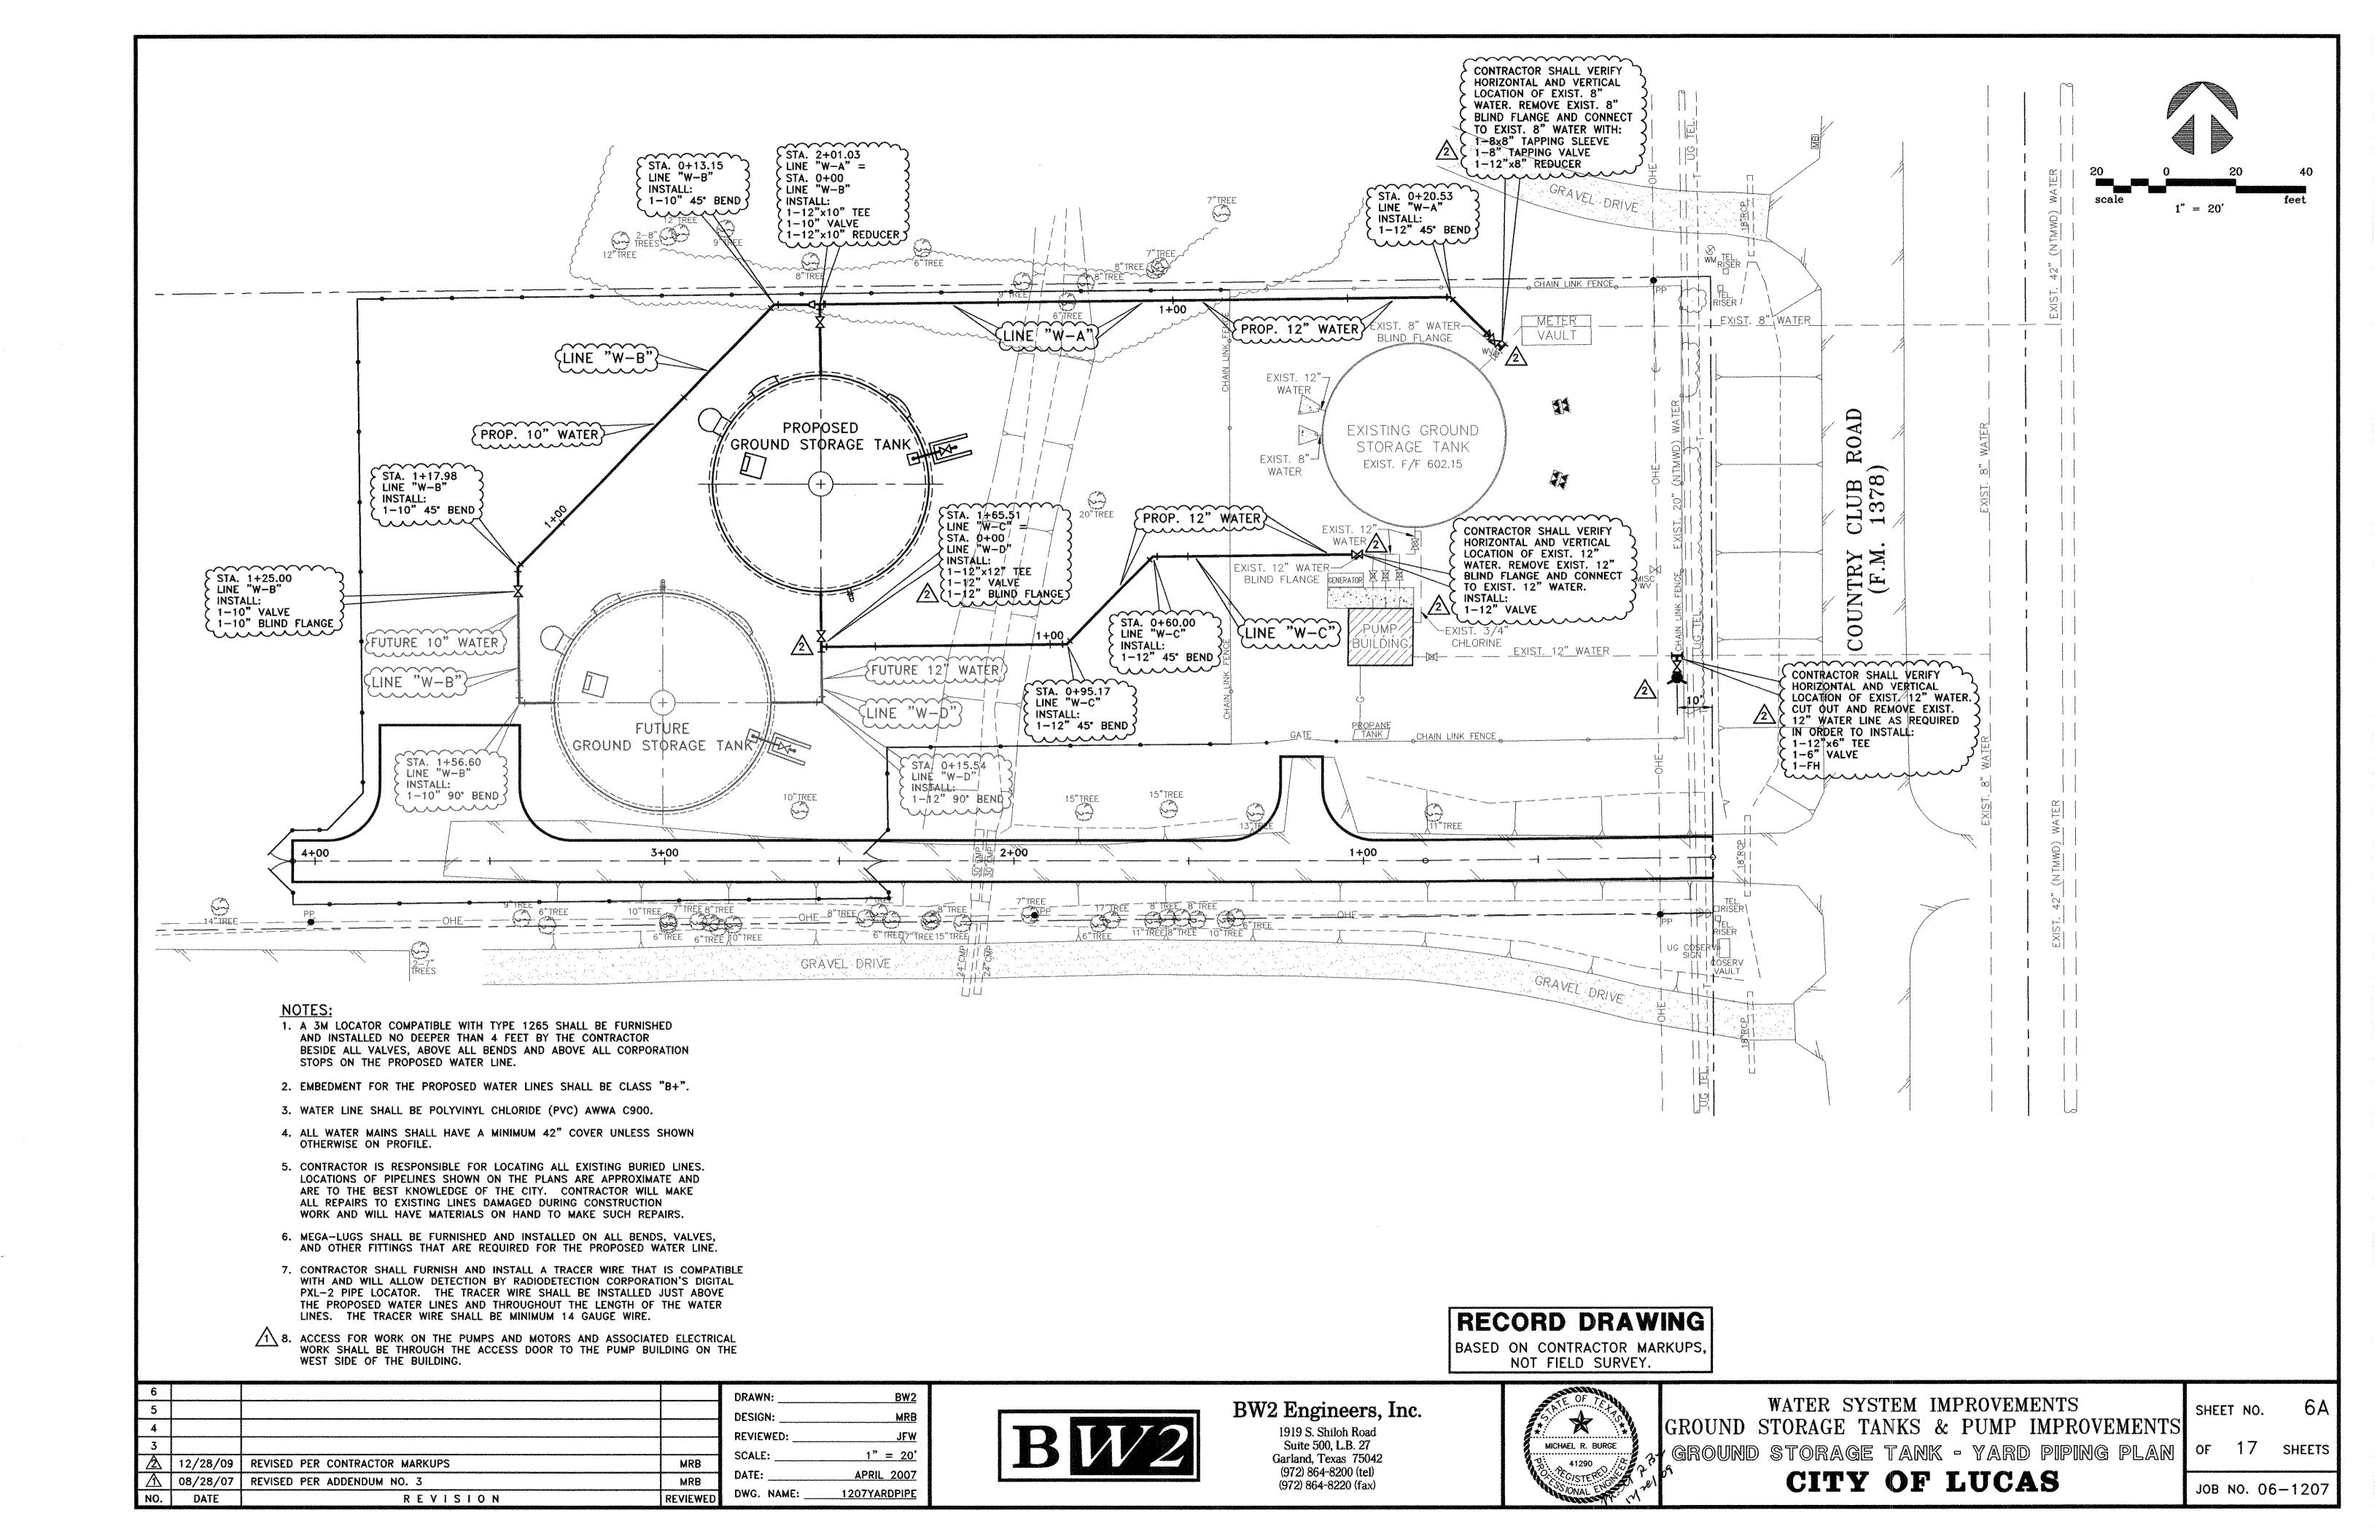

RECORD DRAWING

BASED ON CONTRACTOR MARKUPS, NOT FIELD SURVEY. NOTES:

1. PROPOSED TANK SHALL BE CONSTRUCTED AT ELEVATIONS SHOWN ON THIS SHEET.

2. TANK ACCESSORIES SHALL BE LOCATED ON TANK AS SHOWN ON THIS SHEET.

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BW2 Engineers, Inc.

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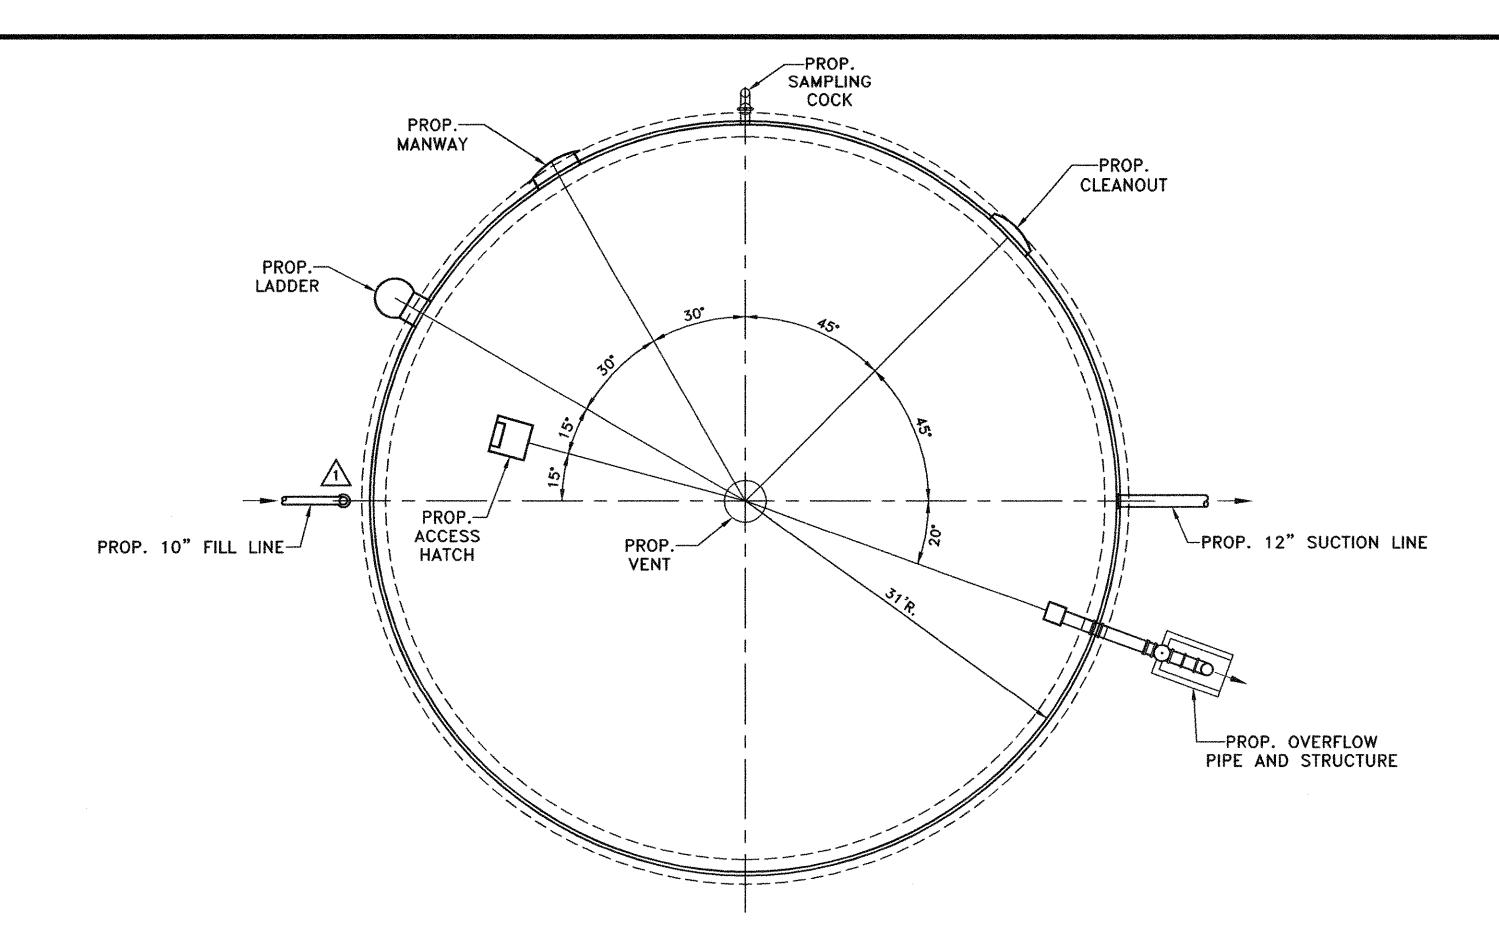


WATER SYSTEM IMPROVEMENTS
GROUND STORAGE TANKS & PUMP IMPROVEMENTS
GROUND STORAGE TANK - PLAN AND ELEVATION


CITY OF LUCAS

OF 17 SHEETS

SHEET NO.



FUTURE GROUND STORAGE TANK - PLAN N.T.S.

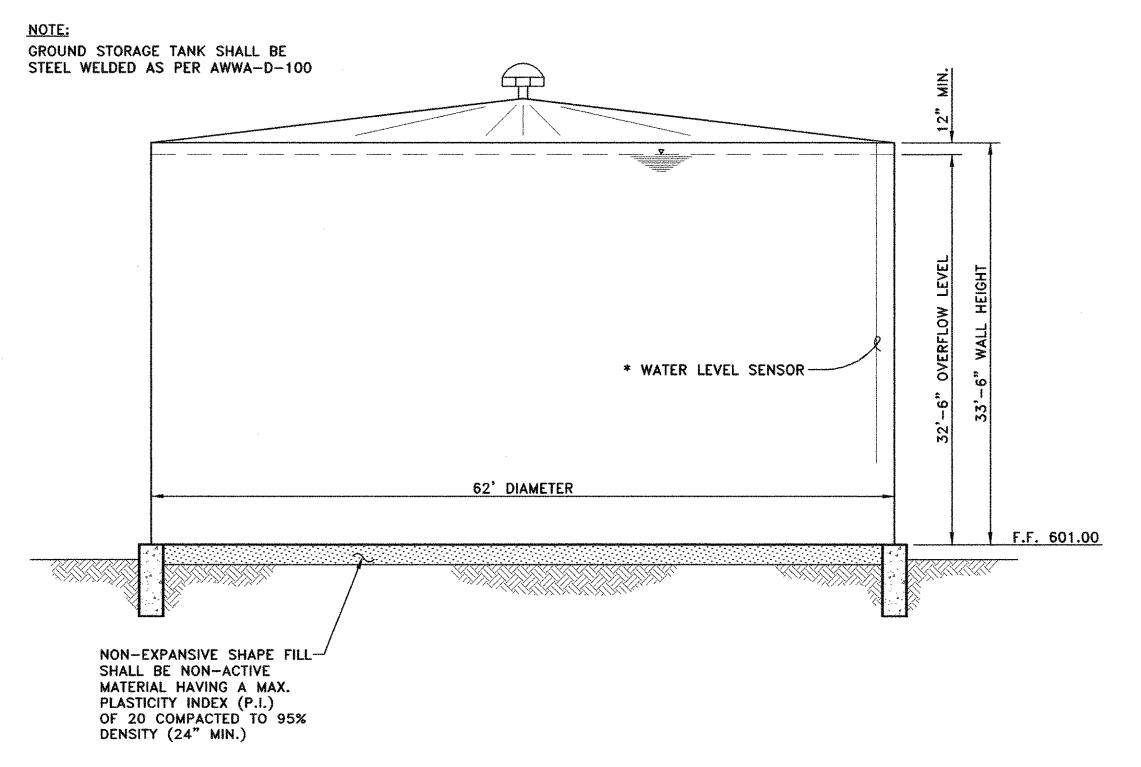


FUTURE GROUND STORAGE TANK - ELEVATION

6 □ DRAWN: BW2 5 □ DESIGN: MRB 4 □ REVIEWED: JFW 3 □ SCALE: N.T.S. 2 □ DATE: APRIL 2007 NO. DATE R E V I S I O N REVIEWED DWG. NAME: 1207TANKPLANFUT



BW2 Engineers, Inc.

1919 S. Shiloh Road Suite 500, L.B. 27 Garland, Texas 75042 (972) 864-8200 (tel) (972) 864-8220 (fax)

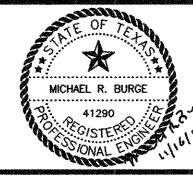

RECORD DRAWING

BASED ON CONTRACTOR MARKUPS, NOT FIELD SURVEY.

NOTES: 1. FUTURE TANK SHALL BE CONSTRUCTED AT ELEVATIONS SHOWN ON THIS SHEET.


2. TANK ACCESSORIES SHALL BE LOCATED ON TANK AS SHOWN ON THIS SHEET.

WATER SYSTEM IMPROVEMENTS
GROUND STORAGE TANKS & PUMP IMPROVEMENTS
FUTURE GROUND STORAGE TANK - PLAN AND ELEVATION


CITY OF LUCAS

SHEET NO. 10

OF 17 SHEETS

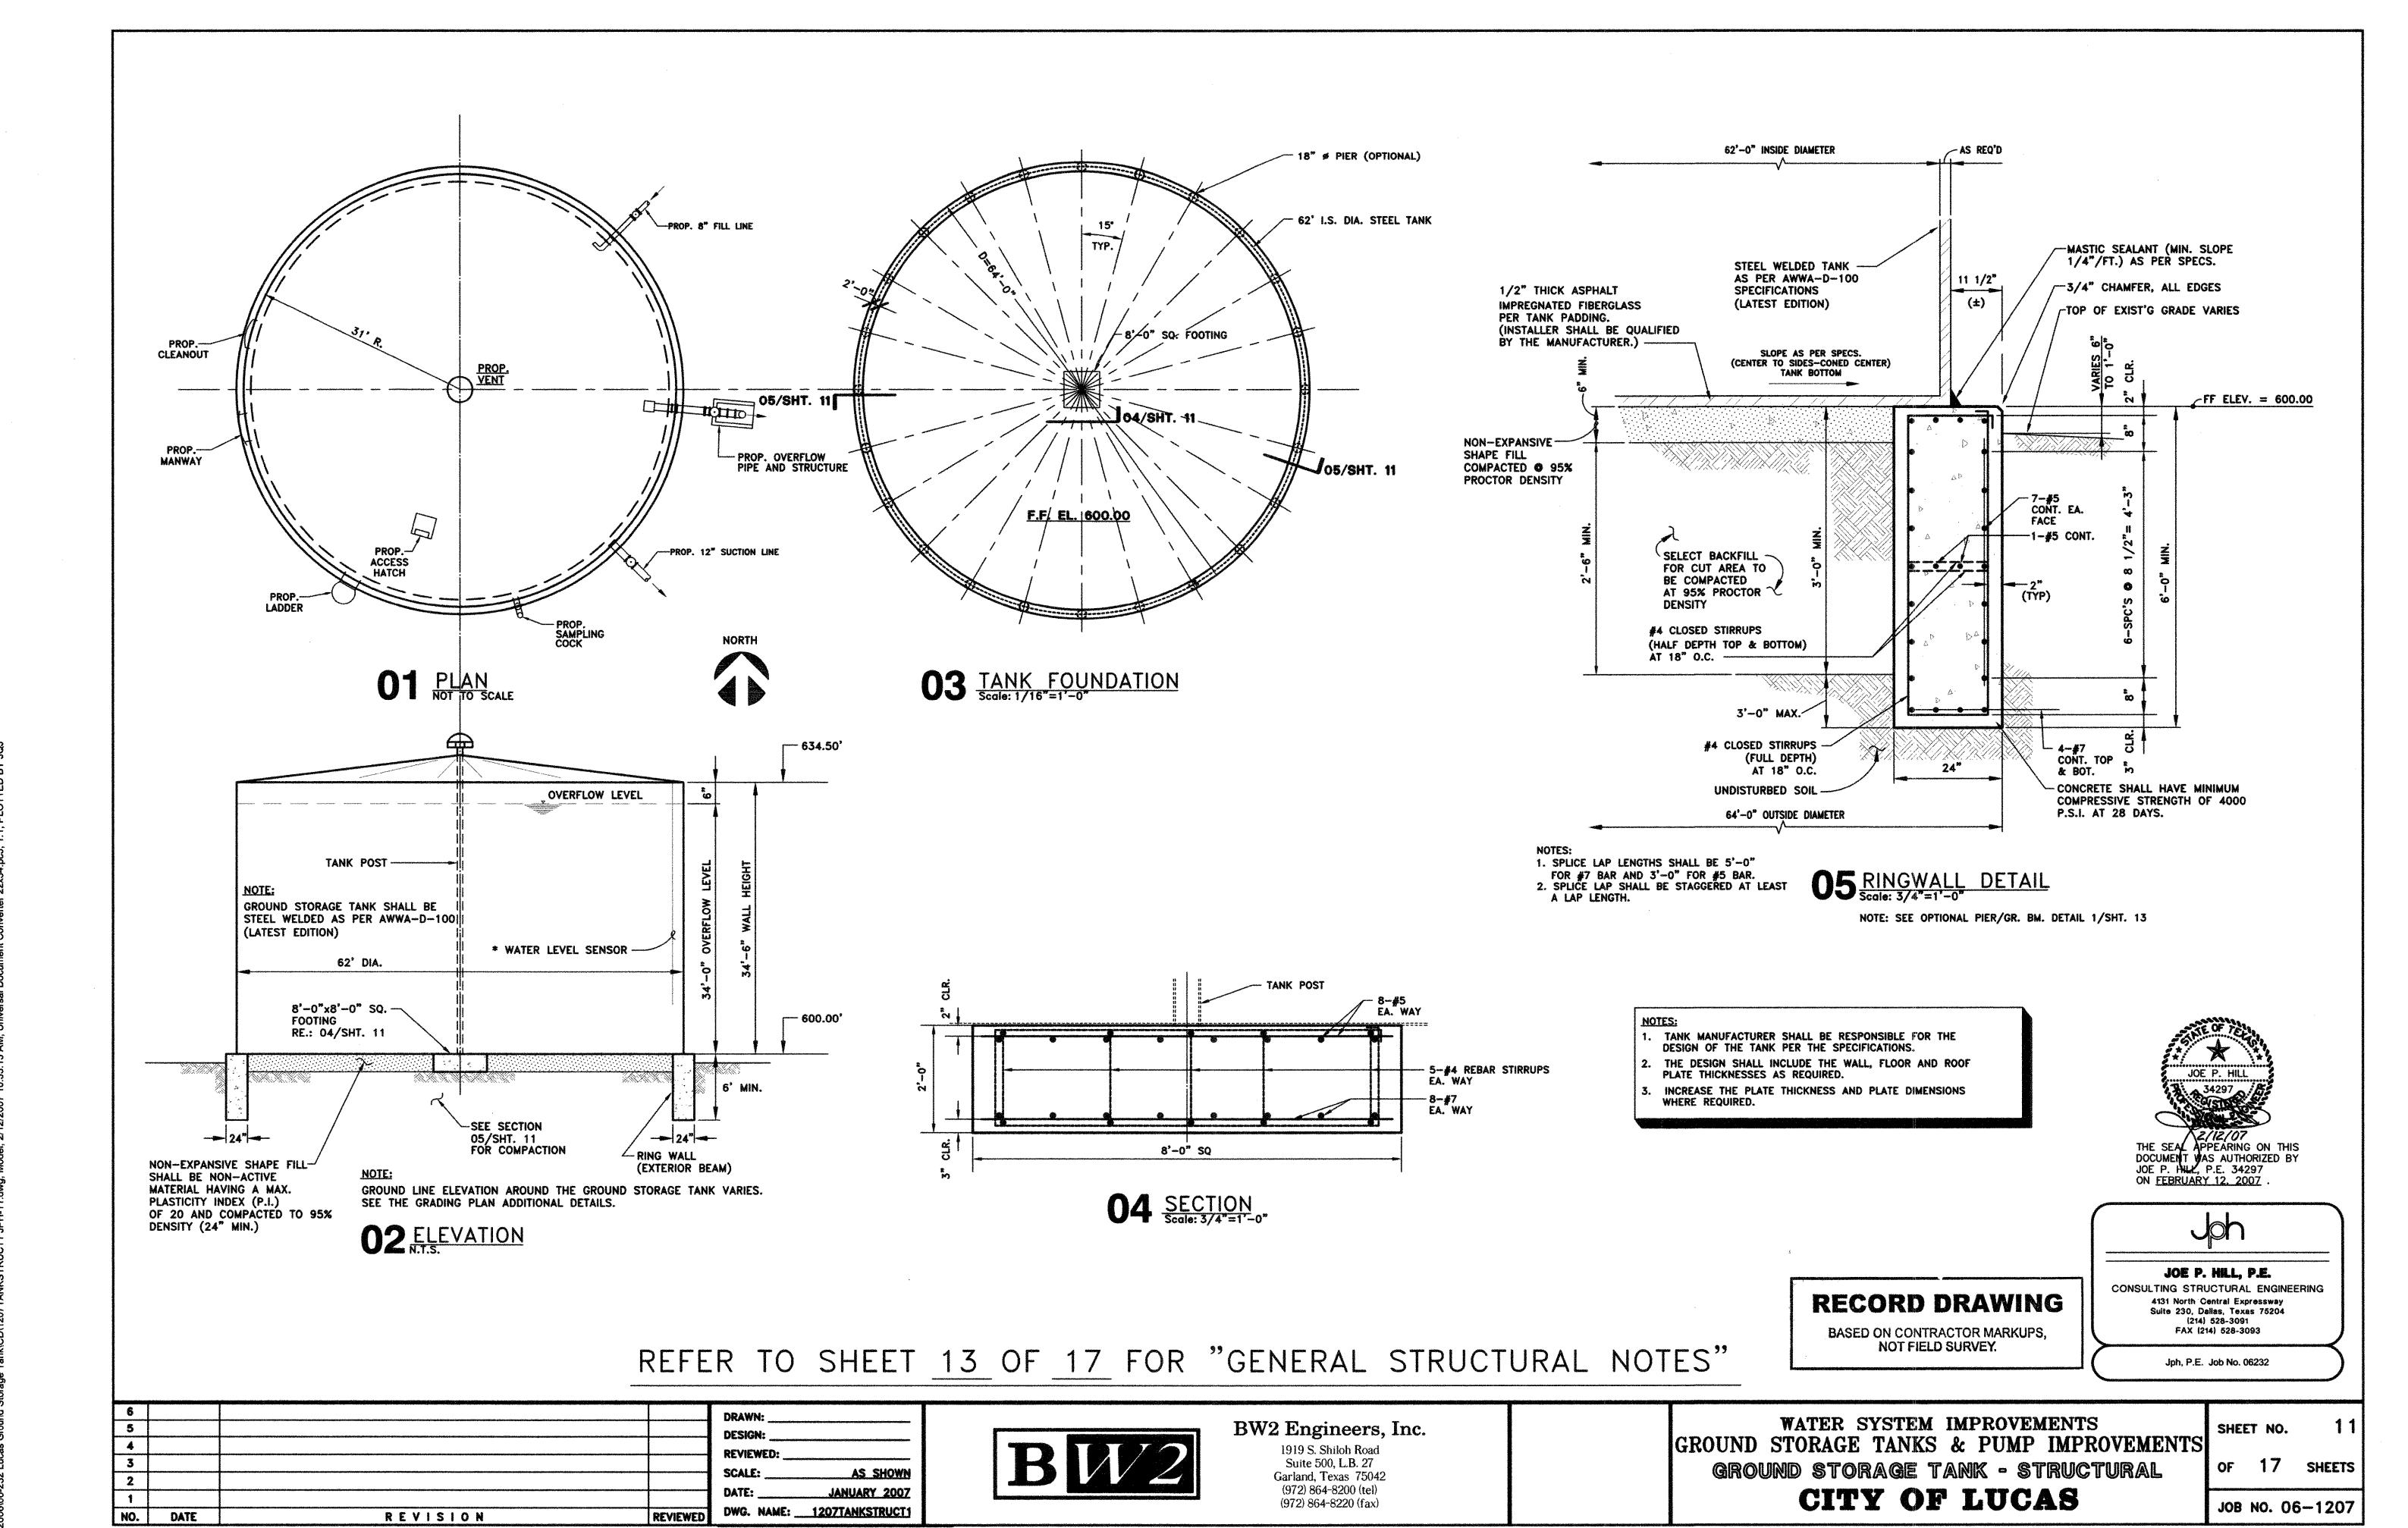

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REVISION

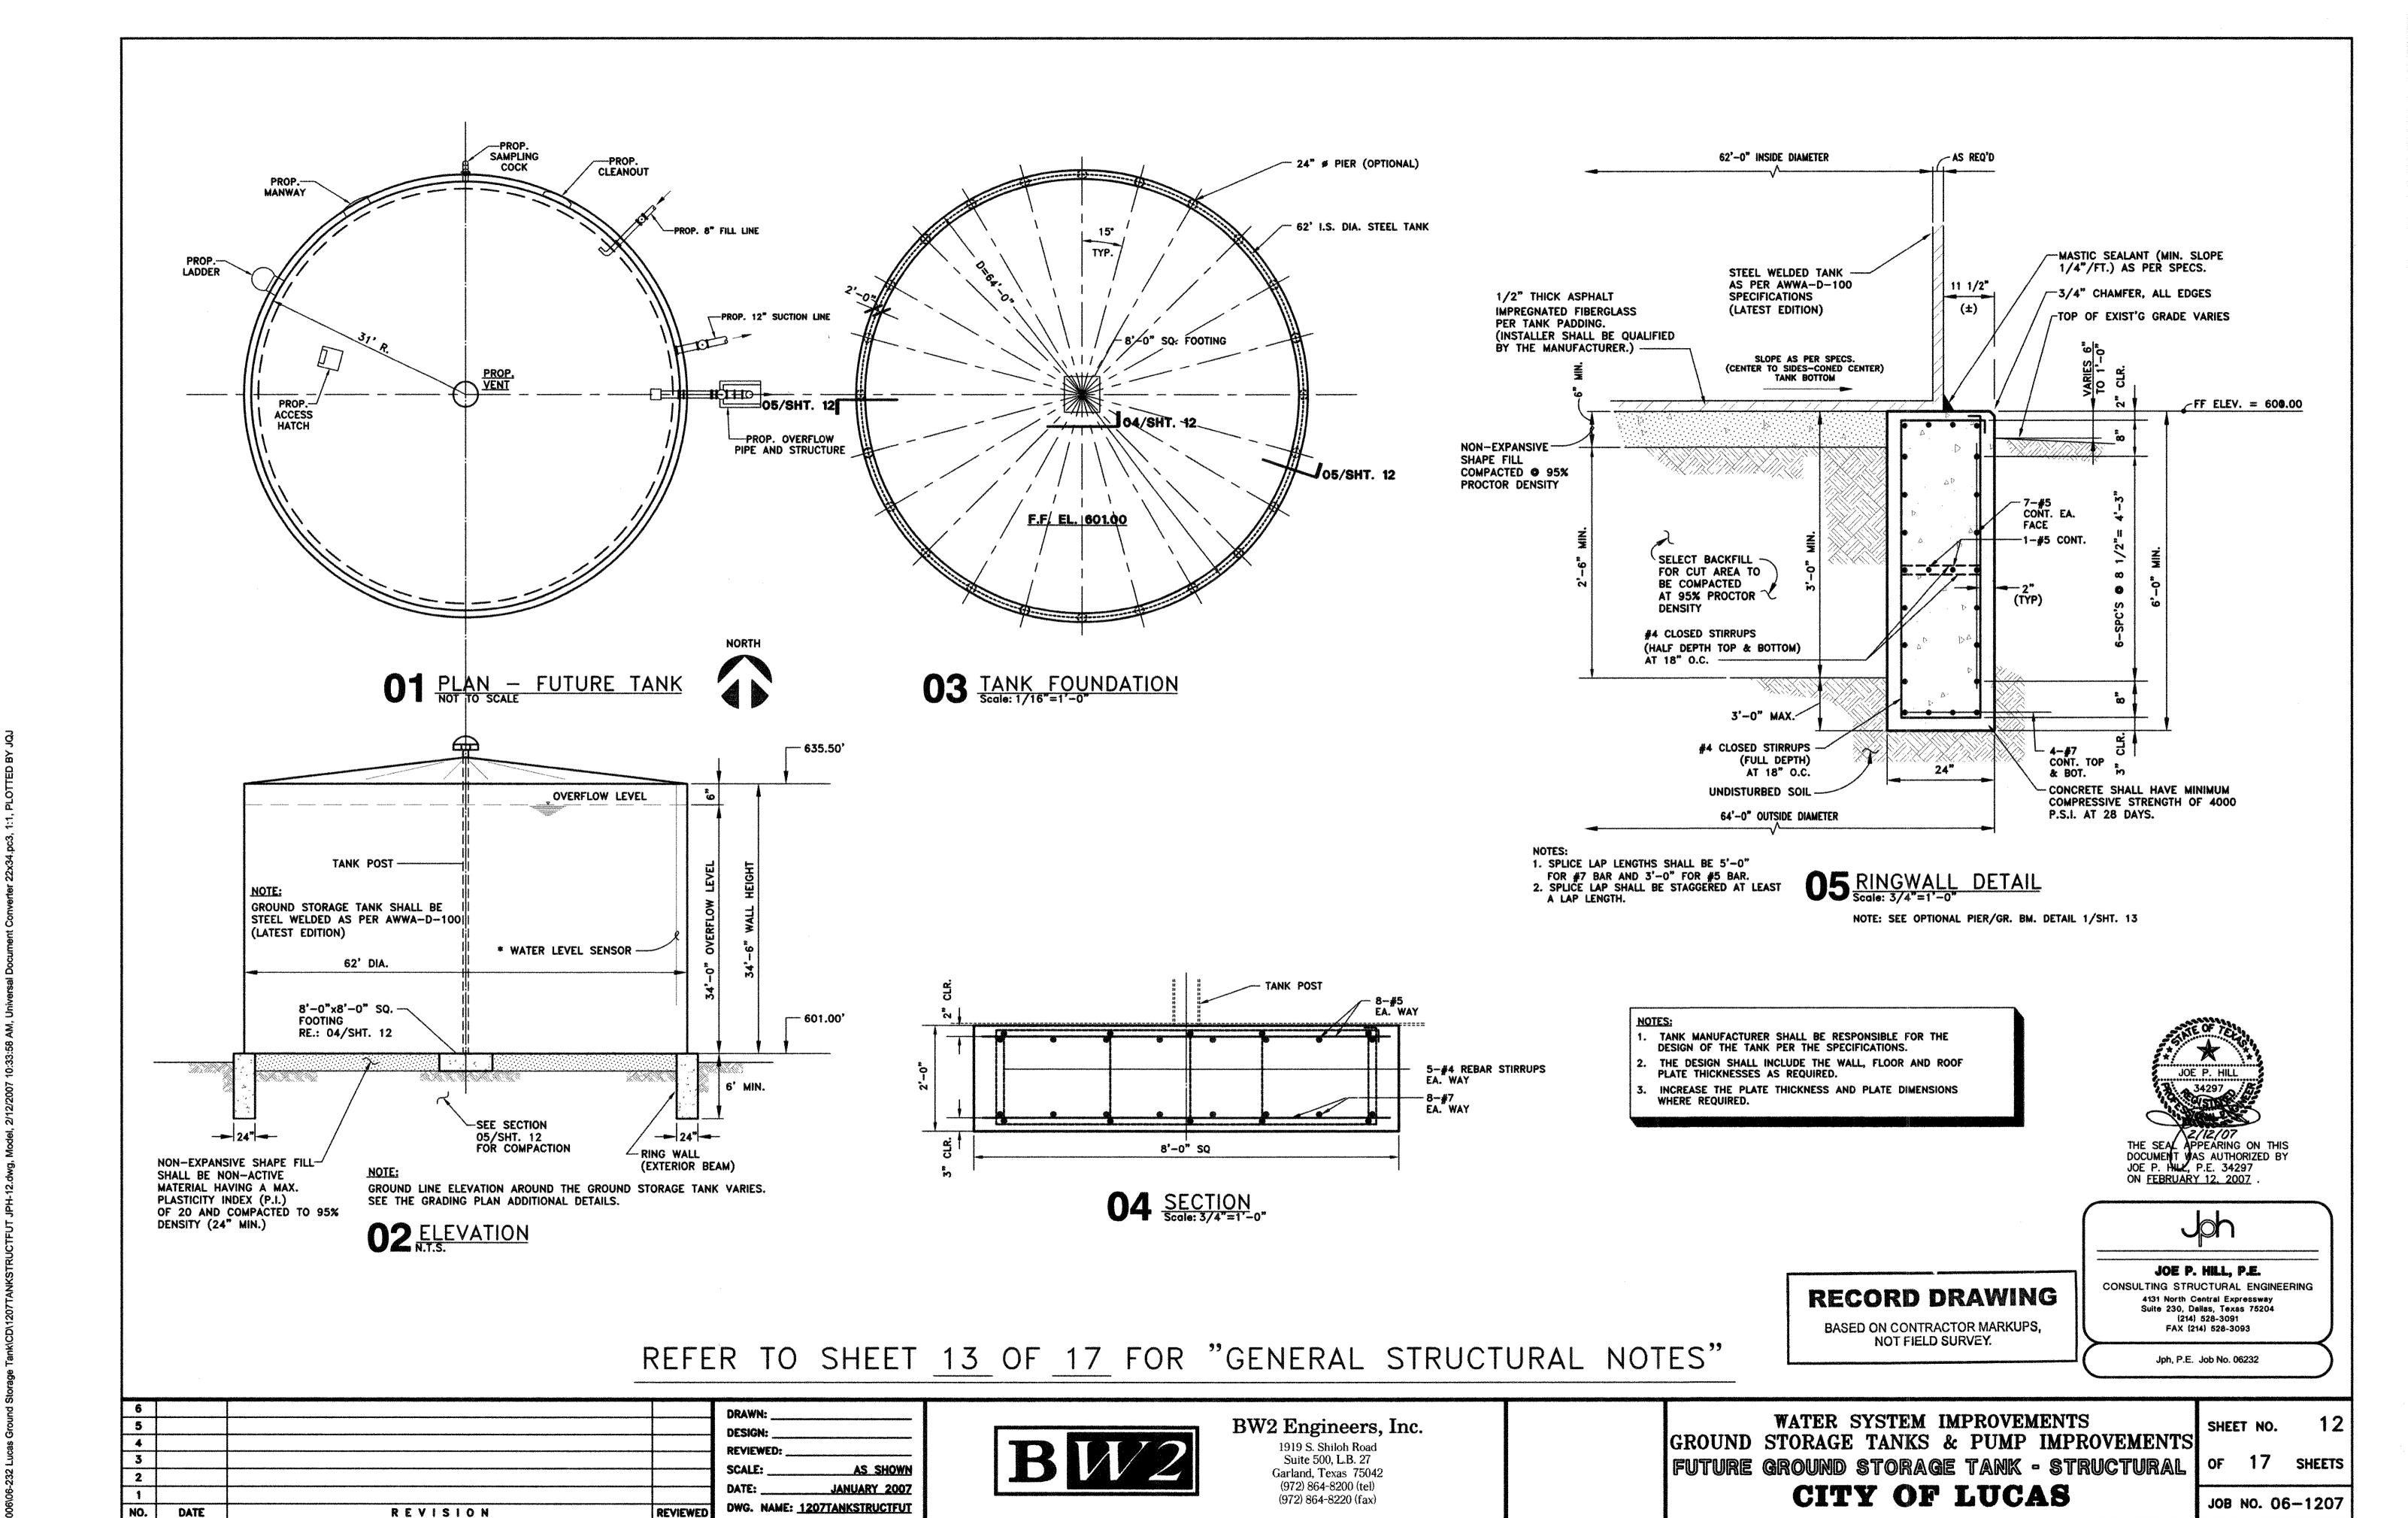REVIEWED

- 3. ANY CONDITION FOUND, PRIOR TO OR DURING CONSTRUCTION, THAT IS DIFFERENT THAN THAT DESCRIBED IN THE SOILS REPORT AND THAT WOULD AFFECT THE FOUNDATIONS AS DESIGNED, SHALL BE BROUGHT TO THE ATTENTION OF BW2 ENGINEERS AND/OR JOE P. HILL, P. E., INC.
- 4. IN NO CASE SHALL CONSTRUCTION PROCEED IF THE PERFORMANCE OF THE FOUNDATIONS, AS DESIGNED, WILL BE COMPROMISED.
- 5. PRIOR TO ANY NEW CONSTRUCTION, THE SITE SHALL BE CLEARED OF ANY AND ALL OBSTRUCTIONS THAT WOULD HINDER THE PROPER PREPARATION OF THE SITE FOR CONSTRUCTION.
- 6. IN THE AREA OF BORING NO. 8, ALL THE EXISTING FILL DEBRIS MATERIAL SHALL BE REMOVED DOWN TO FIRM INSITU CLAY SOILS.
- 7. ALL CLEARED DEBRIS SHALL BE REMOVED AND DISPOSED OF PROPERLY OFFSITE, AND SUITABLE ONSITE SOIL OR ACCEPTABLE FILL BE PLACED.
- 8. MINIMUM PREPARATION OF THE TANK PADS SHALL BE THE COMPLETE REMOVAL OF THE TOP THREE (3) FEET OF SURFICIAL SOILS WITHIN THE TANK AREA AND TO AT LEAST TEN (10) FEET BEYOND THE TANK EDGE.
- 9. AFTER REMOVAL OF THE TOP THREE (3) FEET, THE EXPOSED SUBGRADE SHOULD BE SCARIFIED AND COMPACTED AT OR ABOVE OPTIMUM MOISTURE TO A MINIMUM OF 95 PERCENT OF STANDARD PROCTOR DENSITY (ASTM D 698).
- 10. FILL MATERIALS IN THE DEBRIS REMOVAL AREA THEN SHOULD BE PLACED TO WITHIN THREE (3) FEET OF THE SURFACE USING ONSITE SOILS, COMPACTED TO THE ABOVE STANDARDS.
- 11. THE EXCAVATED AREA FROM GRADE MINUS THREE (3) FEET TO PAD GRADE SHOULD THEN BE BACKFILLED USING SELECT FILL OR A FLEXIBLE BASE MATERIAL MEETING THE REQUIREMENTS OF TXDOT ITEM 247, TYPE A, GRADES 1 OR 2.
- 12. THIS MATERIAL SHOULD BE PLACED IN LIFTS OF APPROXIMATELY SIX (6) INCHES AT A MINIMUM OF MINUS TWO (2) TO PLUS THREE (3) PERCENTAGE POINTS OF THE MATERIAL'S OPTIMUM MOISTURE AT A MINIMUM OF 95 PERCENT OF STANDARD PROCTOR DENSITY (ASTM D 698).
- 13. A LAYER OF COARSE SAND MAY BE PLACED DIRECTLY BELOW THE BOTTOM OF THE TANK TO PROVIDE UNIFORM SUPPORT.
- 14. ANY FILL MATERIAL USED FOR GENERAL SITE FILL SHALL CONSIST OF ON-SITE MATERIALS OR IMPORTED MATERIALS AS APPROVED BY THE SOILS ENGINEERS.
- 15. SITE GRADING OPERATIONS, WHERE REQUIRED, SHALL BE PERFORMED IN ACCORDANCE WITH THE RECOMMENDATIONS PROVIDED IN THE SOILS REPORT.
- 16. SITE GRADING PLANS AND CONSTRUCTION SHALL STRIVE TO ACHIEVE POSITIVE DRAINAGE AROUND ALL SIDES OF THE PROPOSED STRUCTURE.
- 17. INADEQUATE DRAINAGE AROUND STRUCTURES BUILT ON GRADE CAN CAUSE EXCESSIVE VERTICAL DIFFERENTIAL MOVEMENTS TO OCCUR.
- 18. THE GEOTECHNICAL ENGINEER SHALL MONITOR FOUNDATION CONSTRUCTION TO VERIFY CONDITIONS ARE AS ANTICIPATED.
- 19. FOUNDATION EXCAVATION SHALL BE DRY AND FREE OF LOOSE MATERIAL.
- 20. EXCAVATION FOR FOUNDATIONS SHALL BE FILLED WITH CONCRETE BEFORE THE END OF THE WORKDAY OR SOONER IF NECESSARY TO PREVENT DETERIORATION OF THE BEARING SURFACE.
- 21. ALL EXCAVATIONS SHALL BE SLOPED, SHORED OR SHIELDED IN ACCORDANCE WITH OSHA REQUIREMENTS.

CONCRETE:

- 1. CONCRETE WORK SHALL BE EXECUTED IN STRICT ACCORDANCE WITH THE LATEST EDITION OF THE AMERICAN CONCRETE INSTITUTE BUILDING CODE (ACI 381-02).
- 2. CONCRETE AND REINFORCING SPECIFICATIONS AS FOLLOWS:


		28 DAY STRENGTH	SACK CONTENT	AGGREGATE	SLUMP
	Typical	4,000 PSI	6/C.Y.	H.R.	4" TO 6"
	Piers	3,000 PSI	5/C.Y.	H.R.	5" TO 7"

- 3. PORTLAND CEMENT SHALL CONFORM TO ASTM C-33.
- 4. REINFORCING STEEL SHALL CONFORM TO ASTM 615, GRADE 60; GRADE 40 FOR STIRRUPS AND TIES.
- 5. ALL WELDED WIRE FABRIC SHALL CONFORM TO ASTM A82, GRADE 60.
- 6. REINFORCING STEEL SHALL BE DESIGNED, DETAILED, FABRICATED, AND PLACED IN ACCORDANCE WITH THE LATEST ACI "MANUAL OF STANDARD PRACTICE FOR DETAILING REINFORCED CONCRETE STRUCTURES" (ACI 315).
- 7. SLAB REINFORCING SHALL BE LOCATED IN THE SLABS AS NOTED ON THE DRAWINGS.
- 8. ALL GRADE BEAM REINFORCING TO BE AS SHOWN IN SECTIONS ON THE DRAWINGS.
- 9. PROVIDE 2 #5 BARS EACH SIDE OF ALL OPENINGS. EXTEND BARS TWO (2) FEET PAST OPENINGS EACH DIRECTION.
- 10. CORNER REINFORCING BARS SHALL BE USED AT ALL CORNERS AND INTERSECTIONS.
- 11. REINFORCING SPLICES SHALL OCCUR AT POINTS OF MINIMUM STRESS AND LAP THIRTY (30) BAR DIAMETERS UNLESS OTHERWISE NOTED.
- 12. LAP ALL WELDED WIRE FABRIC EIGHT (8) INCHES MINIMUM.
- 13. THE INTERIOR FLOOR AREAS THAT DO NOT RECEIVE RESILIENT FLOORING OR SURFACE MATERIAL SHALL BE SEALED. THE TIMING OF THE APPLICATION OF THIS MATERIAL MUST BE APPROVED BY THE ENGINEER. THE MATERIAL IS TO BE APPLIED IN ACCORDANCE WITH THE MANUFACTURER'S PUBLISHED INSTRUCTIONS. (TWO COATS MINIMUM).
- 14. ALL INTERIOR CONCRETE FLOOR WORK SHALL BE COATED WITH CURING COMPOUND. APPLICATION SHALL BE IN STRICT ACCORDANCE WITH THE MANUFACTURER'S PUBLISHED INSTRUCTIONS.
- 15. ALL EXTERIOR CONCRETE WALKS AND DRIVES SHALL BE CONSTRUCTED USING AIR-ENTRAINED CONCRETE. SUFFICIENT AIR-ENTRAINING AGENT SHALL BE USED TO REDUCE THE WEIGHT OF THE CONCRETE BY 6% TO 8%.
- 16. SEE ARCHITECTURAL AND MECHANICAL PLANS FOR VERIFICATION OF ALL DEPRESSIONS, OPENINGS, CAST-IN-PLACE ACCESSORIES, ETC.

NO SCALE

JANUARY 2007

- 1. THE TANK STRUCTURE SHALL BE DESIGNED BY THE TANK VENDOR.
- 2. SHOP DRAWINGS, INCLUDING THE DESIGN CALCULATIONS, SHALL BE SUBMITTED IN ORDER THAT THE ENCLOSED TANK FOUNDATION DESIGN CAN BE VERIFIED.
- 3. THE SUBMITTED CALCULATIONS SHALL CLEARLY AND SPECIFICALLY DESIGNATE THE VERTICAL AND LATERAL LOADS THAT NEED TO BE RESISTED BY THE TANK SUPPORT
- 4. THE CONTRACTOR SHALL ROUGH GRADE THE AREA AS HE DEEMS NECESSARY TO FACILITATE ACCESS AND PROPER CONSTRUCTION OF THE TANK AND ITS FOUNDATION.
- 5. ANY SLOPE SHAPING AND ROUGH GRADING SHALL BE IN ACCORDANCE WITH ALL PREVAILING OSHA STANDARDS AND REQUIREMENTS.

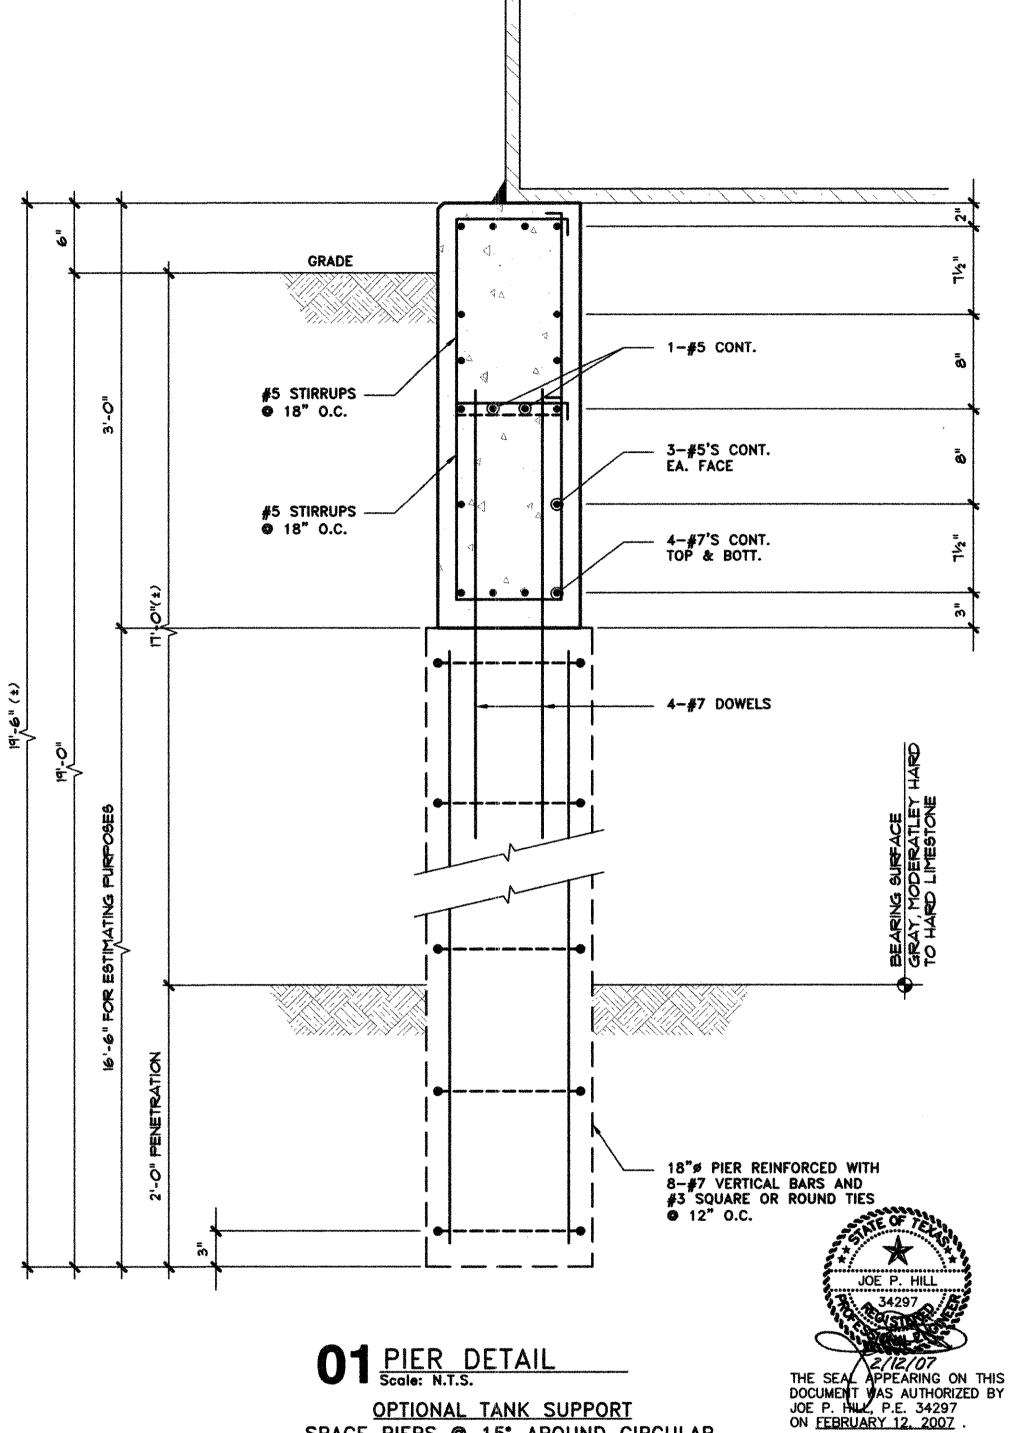

SPACE PIERS @ 15* AROUND CIRCULAR

DOCUMENT WAS AUTHORIZED BY JOE P. HILL, P.E. 34297

RECORD DRAWING

BASED ON CONTRACTOR MARKUPS, NOT FIELD SURVEY.

JOE P. HILL, P.E. CONSULTING STRUCTURAL ENGINEERING 4131 North Central Expressway Suite 230, Dallas, Texas 75204 (214) 528-3091 FAX (214) 528-3093

Jph, P.E. Job No. 06232

DESIGN: **REVIEWED:** DATE: DWG. NAME: 1207STRUCNOTE REVISION DATE





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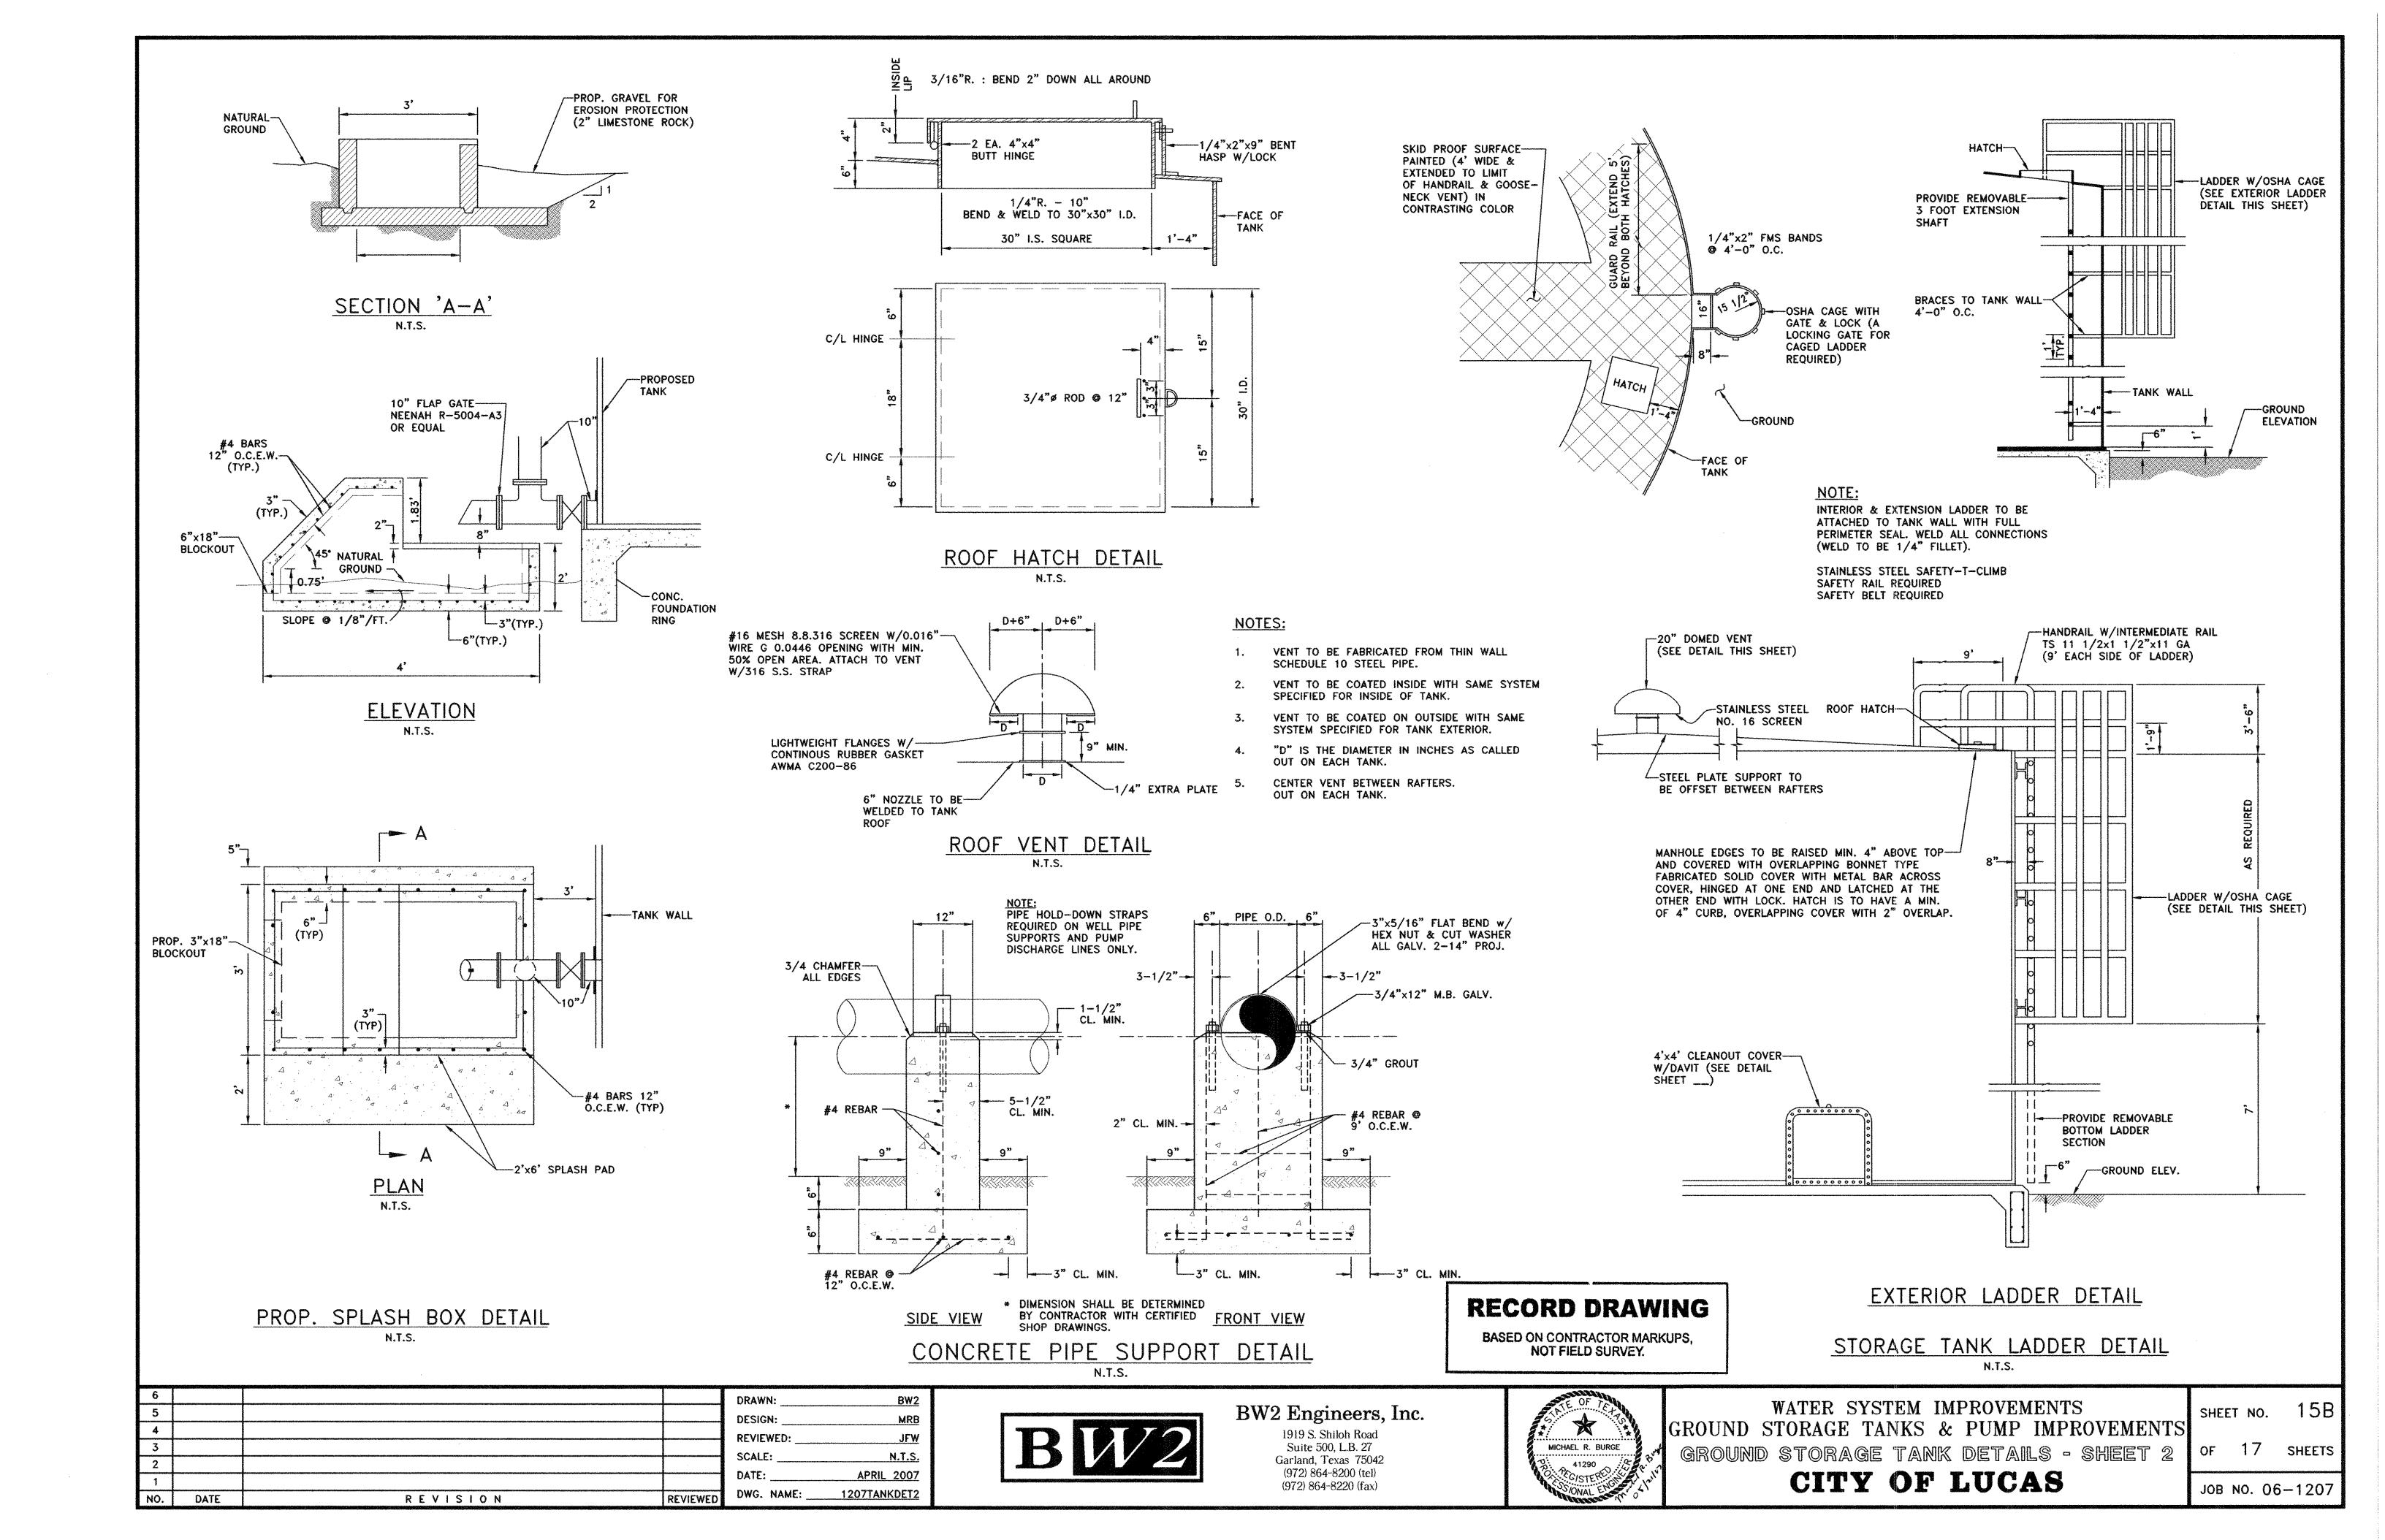
1919 S. Shilloh Road Suite 500, L.B. 27 Garland, Texas 75042 (972) 864-8200 (tel) (972) 864-8220 (fax)


WATER SYSTEM IMPROVEMENTS GROUND STORAGE TANKS & PUMP IMPROVEMENTS GENERAL STRUCTURAL NOTES CITY OF LUCAS


SHEET NO. OF 17 SHEETS



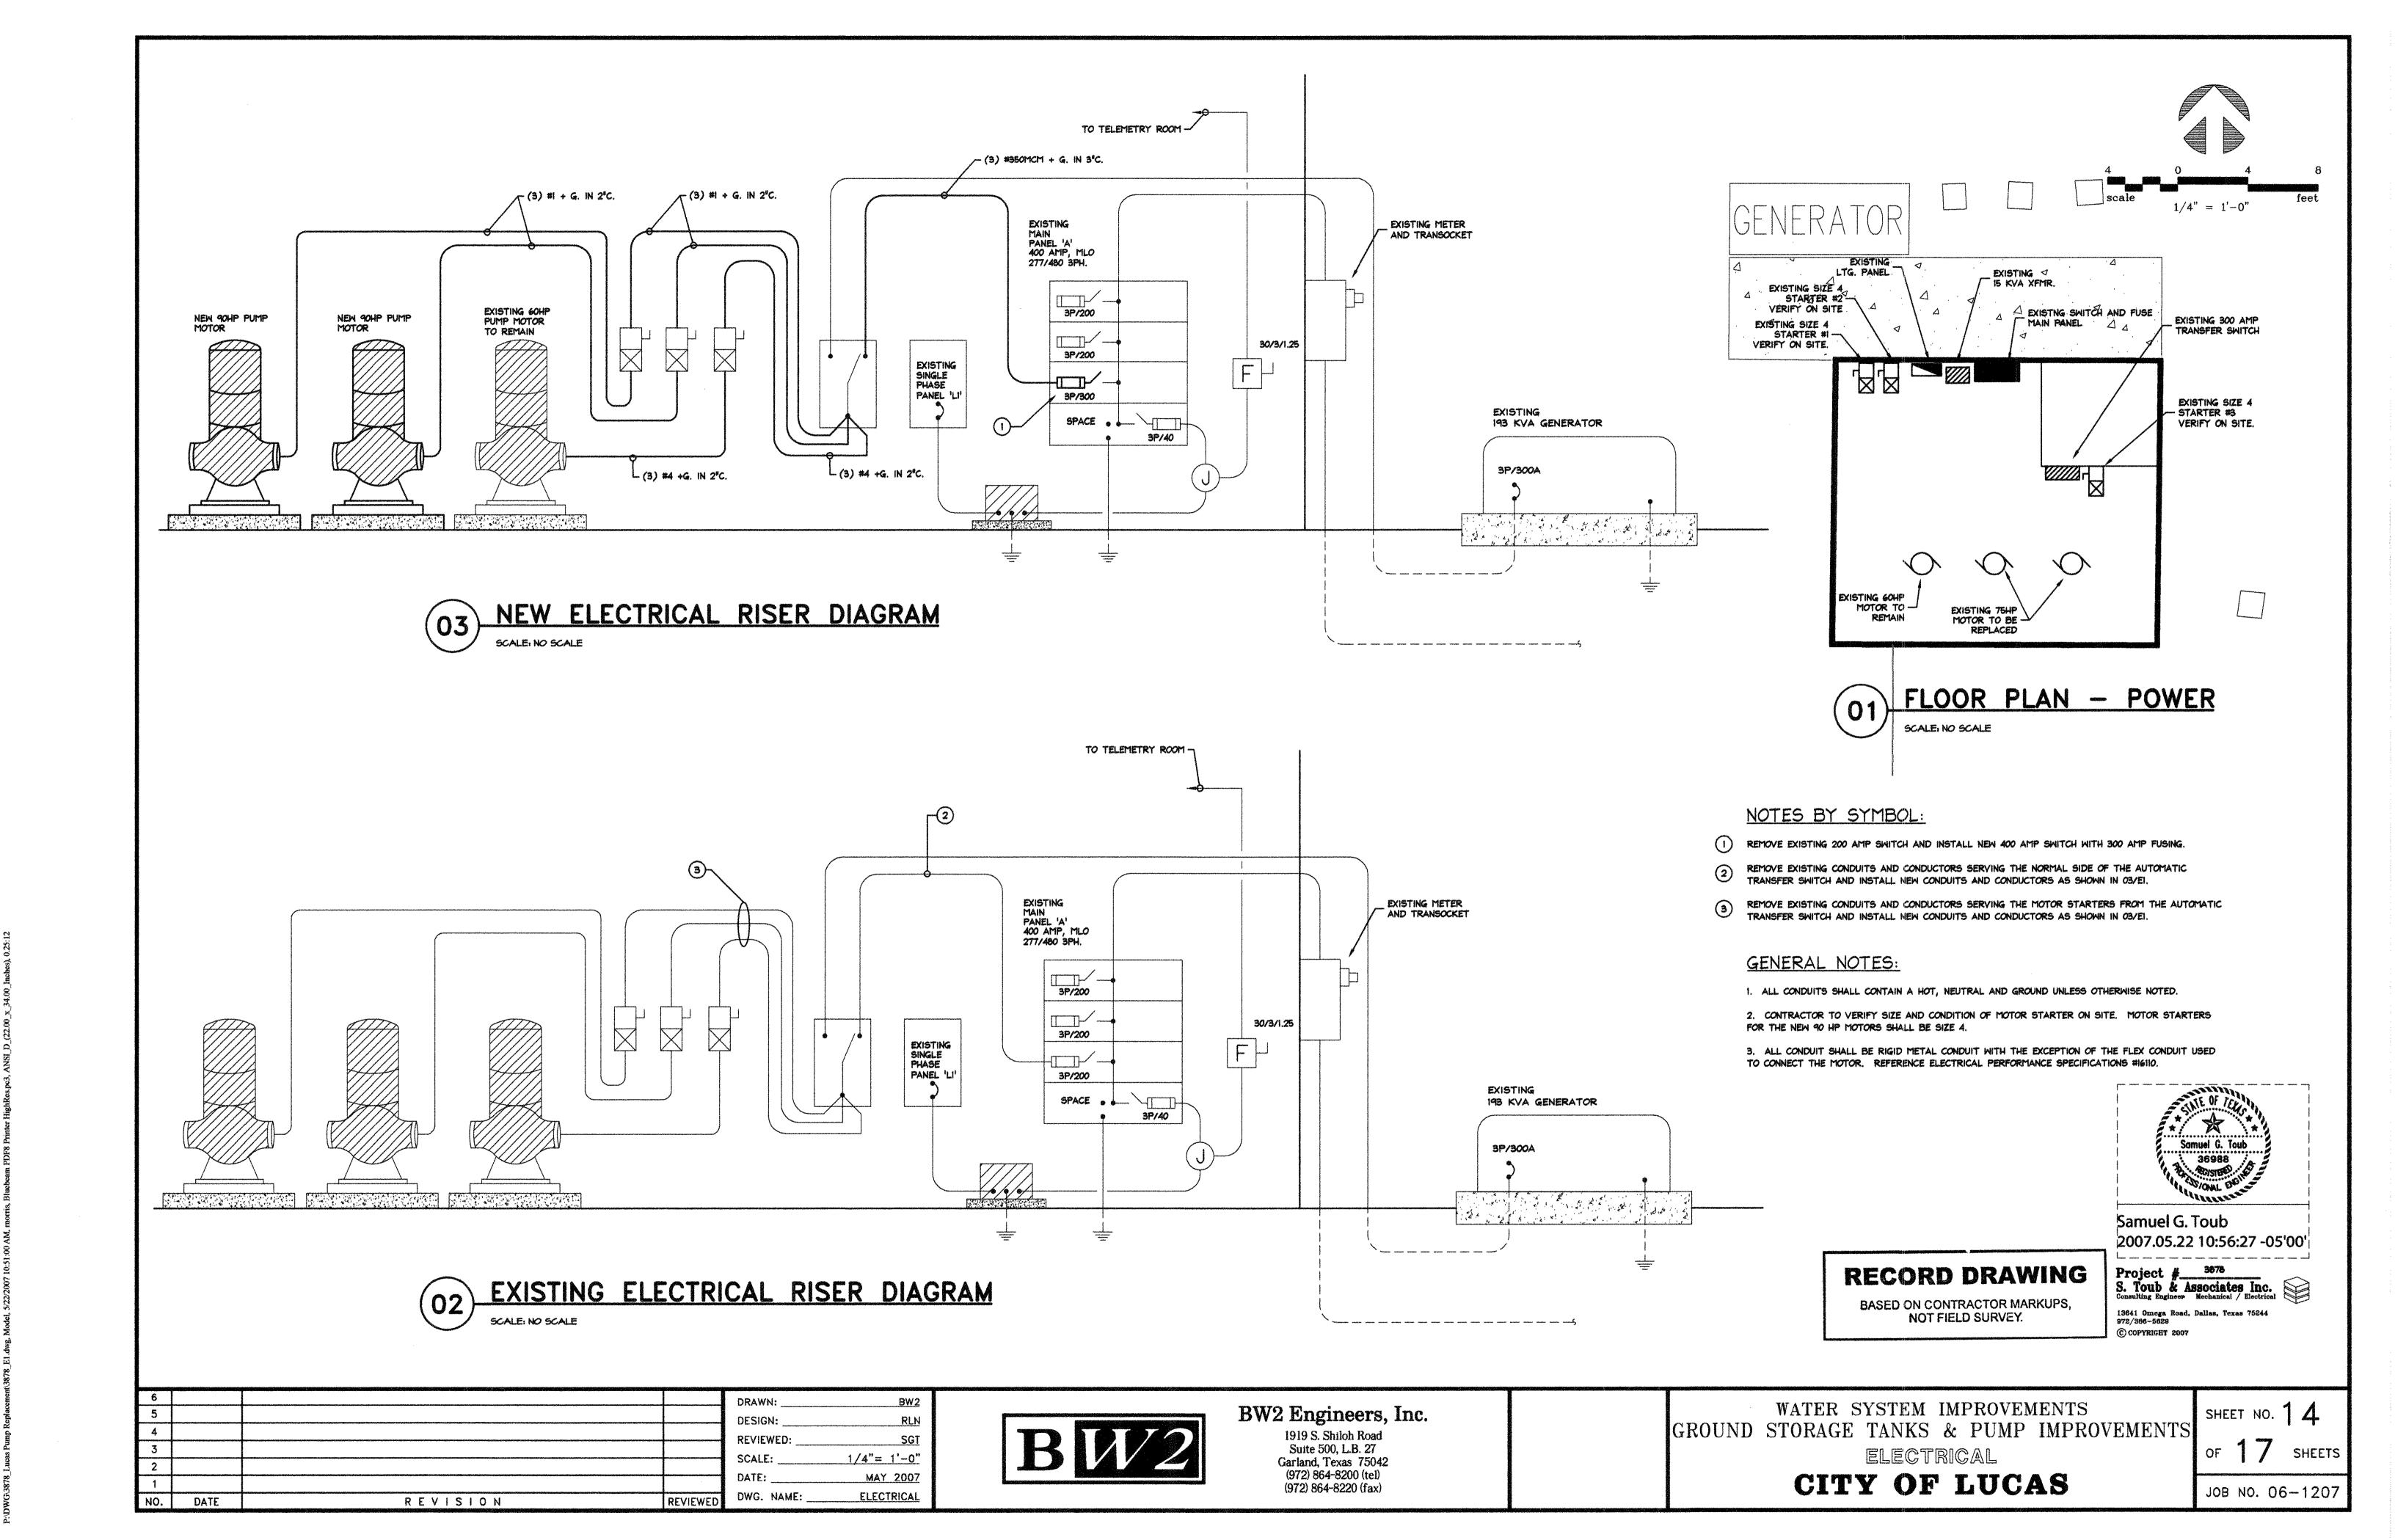


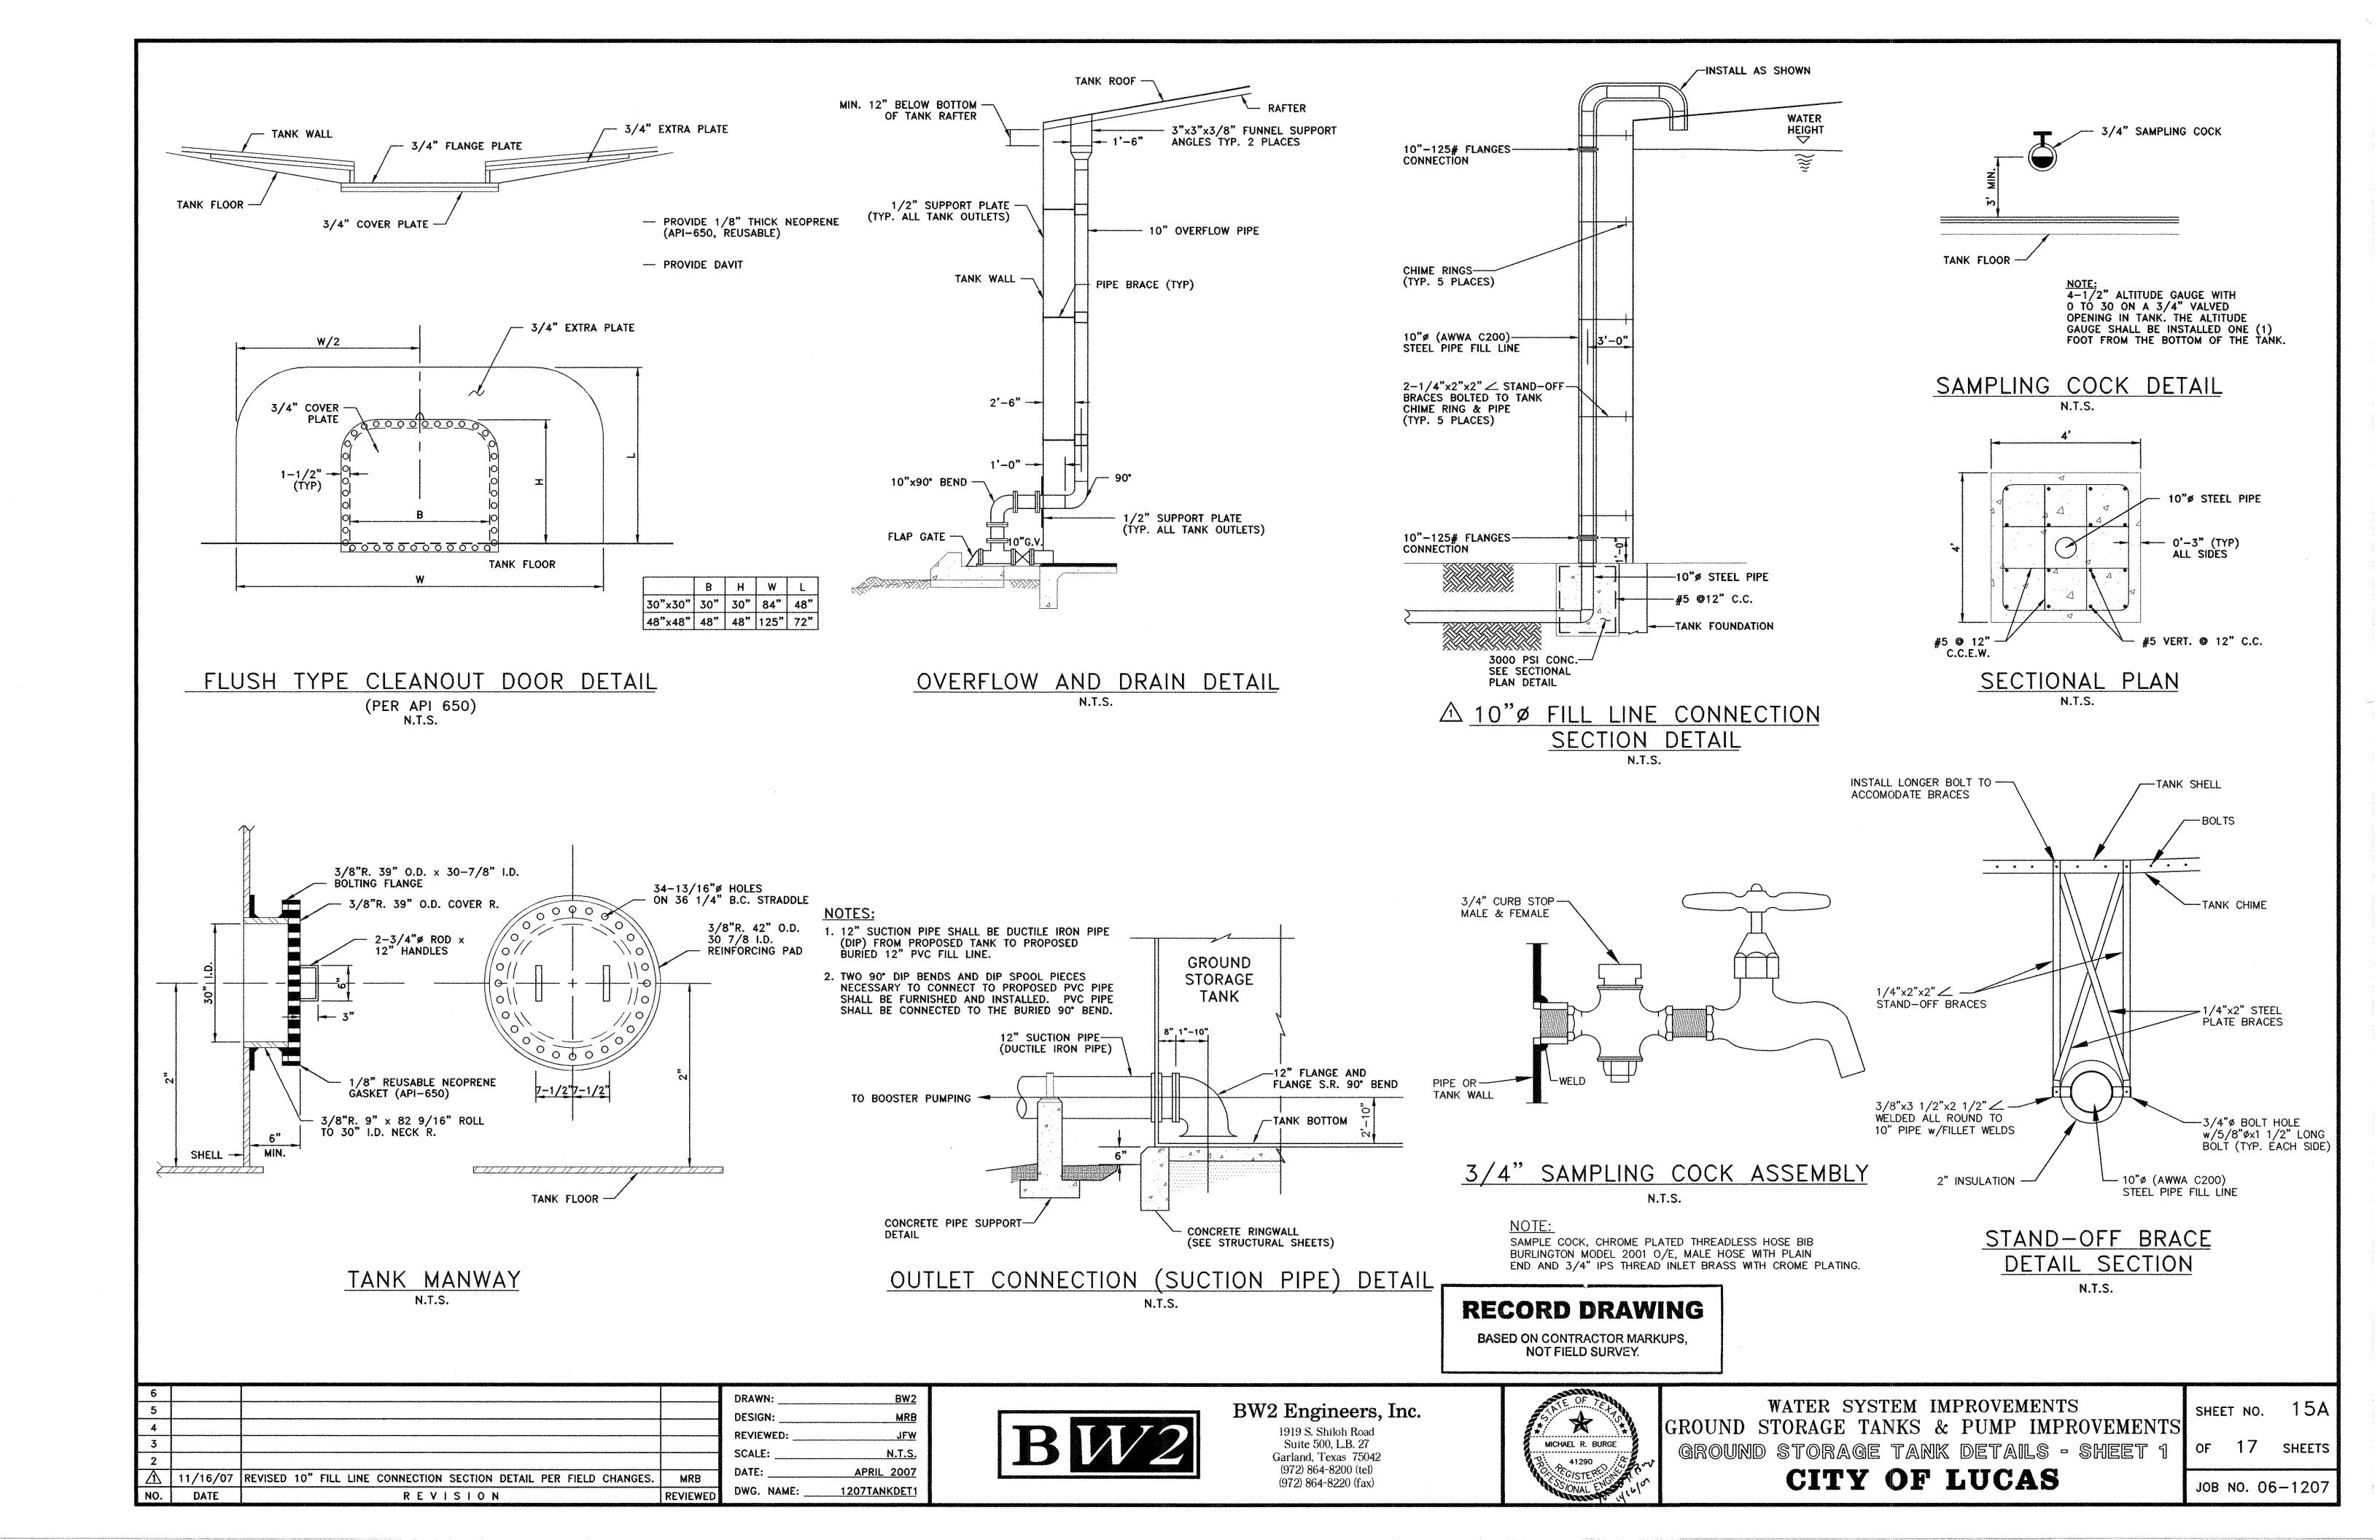

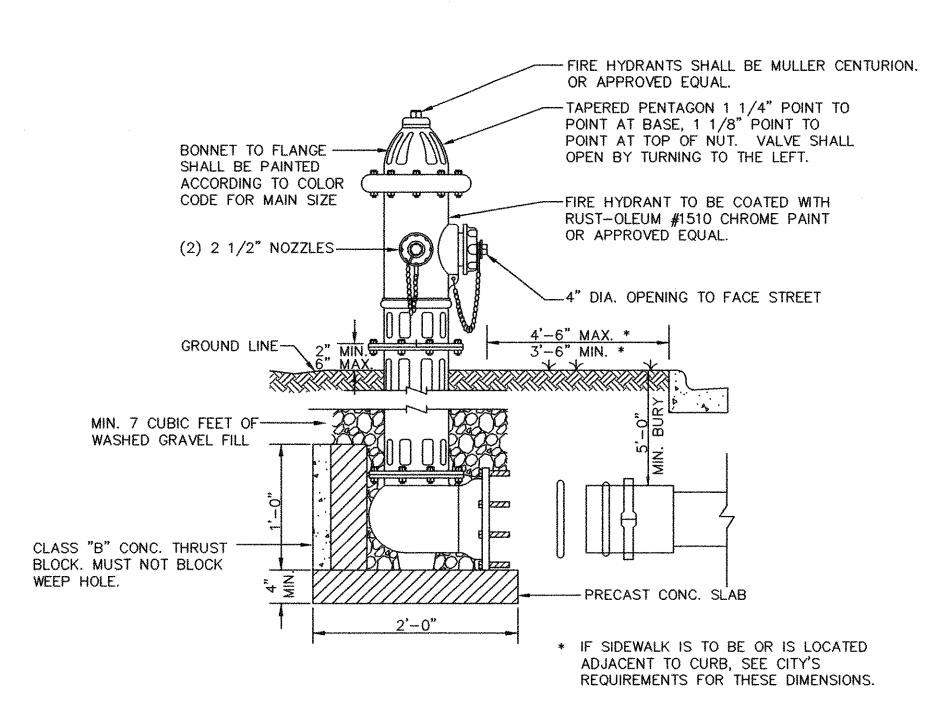

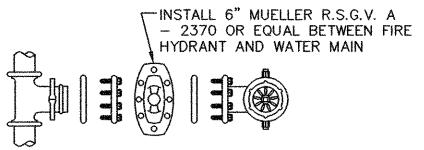


SWIVEL HYDRANT TEE-MJxFLANGE VALVE-FLANGE HYDRANT

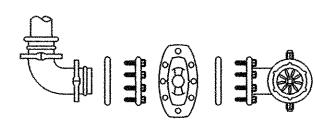

SWIVELXSWIVEL 90° ELL-MJXFLANGE VALVE-FLANGE HYDRANT

FIRE HYDRANT INSTALLATION

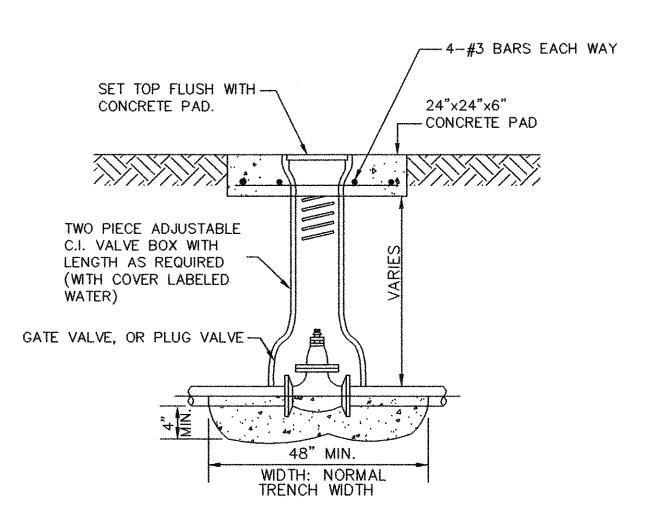

BURIED VALVE DETAIL N.T.S.

DRAWN: BW2 DESIGN: **REVIEWED:** SCALE: N.T.S. DATE: **APRIL 2007** DWG. NAME: 1207DET1 REVISION DATE REVIEWED





BEDDING MATERIAL -

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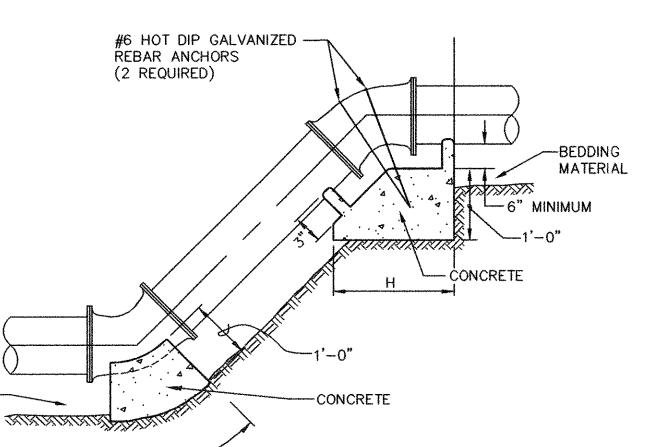
MICHAEL R. BURGE

SHEET NO. or 17 SHEETS

UNDISTURBED SECTION B-B <u>PLAN</u> PLUGS & TEES -UNDISTURBED EARTH TYPICAL FOR 90°, 45°, 22 1/2° AND 11 1/4° BENDS UNDISTURBED SECTION A-A

GENERAL NOTES:

1. ALL ANCHOR BLOCKS SHALL BE FORMED, POURED IN PLACE, CLASS "B" CONCRETE.



ELEVATION - VERTICAL BEND

<u>PLAN</u> **BENDS**

PIPE SIZE	DEGREE OF	MINIMUM CONCRETE ANCHOR BLOCK			E
	BEND	EARTH	(FEET)	ROCK ((FEET)
(INCHES)	(DEGREE)	"L"	"H"	"L"	"H"
C 0	11 1/4	1.0	1.5	1.0	1.0
6, 8 10, 12*	22 1/2	1.5	1.5	1.0	1.0
16 **	45	2.0	2.0	1.5	1.5
I 🗸	90	5.0	1.5	2.0	2.0

- * FOR 12" LINE ADD 1 FOOT TO ALL DIMENSIONS IN THE TABLE.
- ** FOR 16" LINE ADD 2 FEET TO ALL DIMENSIONS IN THE TABLE.

NOTES:


- 1. THE ABOVE TABLE IS BASED ON 2000 PSF SOIL BEARING CAPACITY AND FOR A TEST PRESSURE OF 150 P.S.I.
- 2. CONCRETE FOR THRUST BLOCKING SHALL BE 2000 PSI CONCRETE.
- 3. VERTICAL BEND THRUST BLOCKING SHALL HAVE REINFORCING BARS NO. 4 AT 12" C-C.
- 4. ALL BEARING SURFACES OF THRUST BLOCKS SHALL BE POURED
- AGAINST UNDISTURBED EARTH. 5. ALL THRUST BLOCKING SHALL BE AS INDICATED OR AS PER THE MANUFACTURE'S SPECIFICATIONS.

CONCRETE ANCHOR BLOCKS

WATER SYSTEM IMPROVEMENTS GROUND STORAGE TANKS & PUMP IMPROVEMENTS GENERAL CONSTRUCTION DETAILS - SHEET 1

JOB NO. 06-1207

CITY OF LUCAS

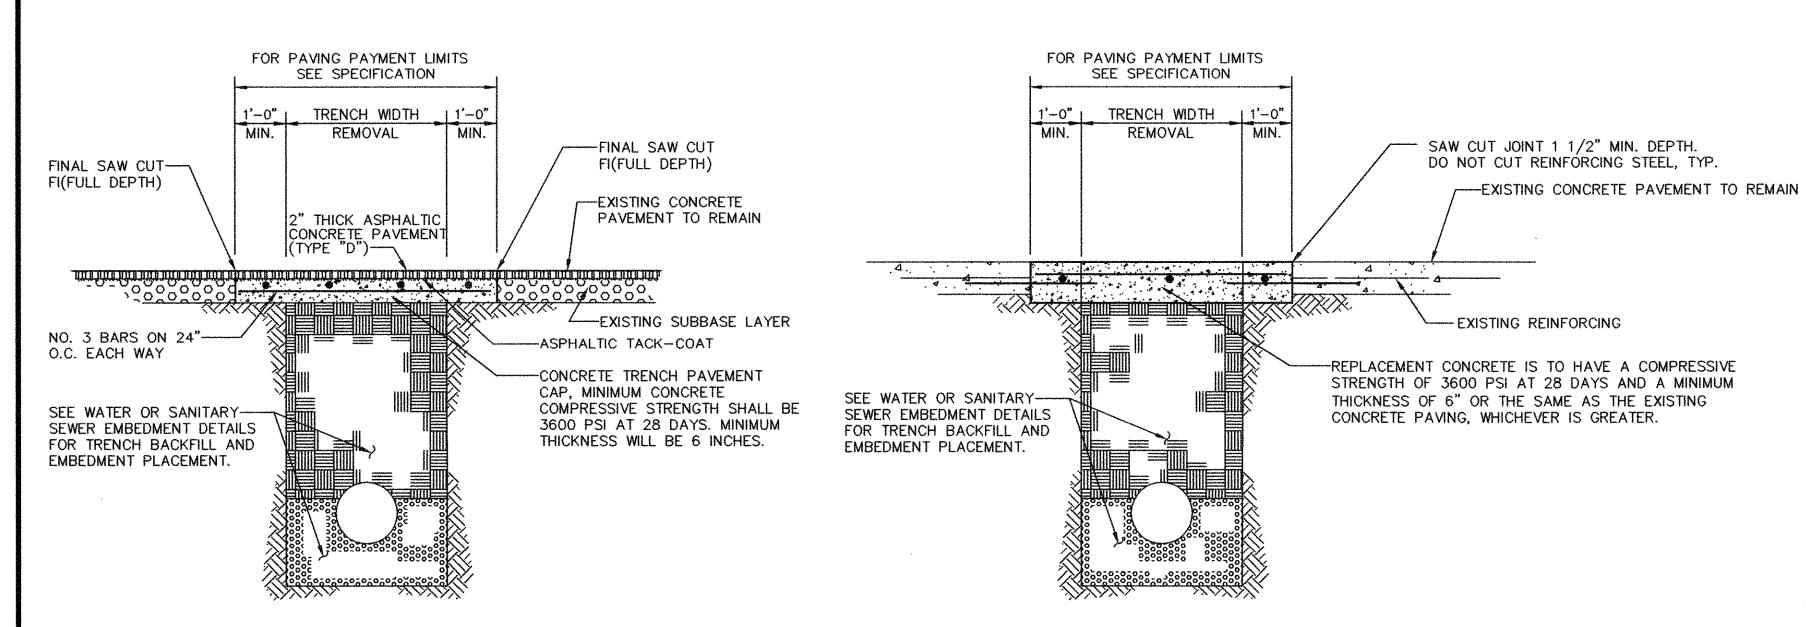

REINFORCED CONCRETE PAVEMENT


SELECT OR GRANULAR ------MATERIAL COMPACTED TO A DENSITY OF 90% Bd = TRENCH WIDTH FOR 6"-30" PIPE Bd = Bc + 16"←CRUSHED STONE, FINE GRADATION

CLASS "B+" EMBEDMENT

TRENCH BACKFILL AND EMBEDMENT NOTES:

- 1. UNLESS OTHERWISE NOTED, TRENCH BACKFILL AND EMBEDMENT SHALL BE AS SPECIFIED IN NTCOG SPECIFICATION ITEMS 2.1.8, 6.2.9, AND 6.2.10.
- 2. ALL TRENCH BACKFILL SHALL BE COMPACTED TO 95% DENSITY WHEN UNDER PAVEMENT.
- 3. SAND SHALL BE FREE FROM LUMPS, STONES, CLAY AND ORGANIC MATTER. ALL PARTICLES MUST PASS A NO. 8 SIEVE.
- 4. GRANULAR MATERIAL SHALL BE DEFINED AS FREE FLOWING RIVER RUN, SANDY MATERIAL, FREE FROM LARGE STONES, CLAY AND ORGANIC MATERIAL. THE EMBEDMENT MATERIAL WILL NOT BE SUCH THAT WHEN WET, THE FINE MATERIAL FORMS MUD OR MUCK. THE EMBEDMENT MATERIAL SHALL BE COMPOSED OF TOUGH DURABLE PARTICLES, REASONABLY FREE FROM THIN, FLAT AND ELONGATED PIECES, AND OF SUITABLE QUALITY TO INSURE PERMANENCE IN THE TRENCH. THE P.I. OF THE FINES SHALL NOT EXCEED 3. LIGHT WEIGHT AGGREGATE IS NOT ACCEPTABLE FOR GRANULAR EMBEDMENT. STONES LARGER THAN 2" IN DIAMETER ARE NOT ALLOWED.
- 5. STONES LAGER THAN 6" ARE NOT ALLOWED IN THE TRENCH BACKFILL.
- 6. THE TOP 12" (MINIMUM) OF ALL TRENCHES SHALL BE TOPSOIL. STONES LARGER THAN 2" ARE NOT ALLOWED.

TYPICAL PAVEMENT REPAIR DETAILS

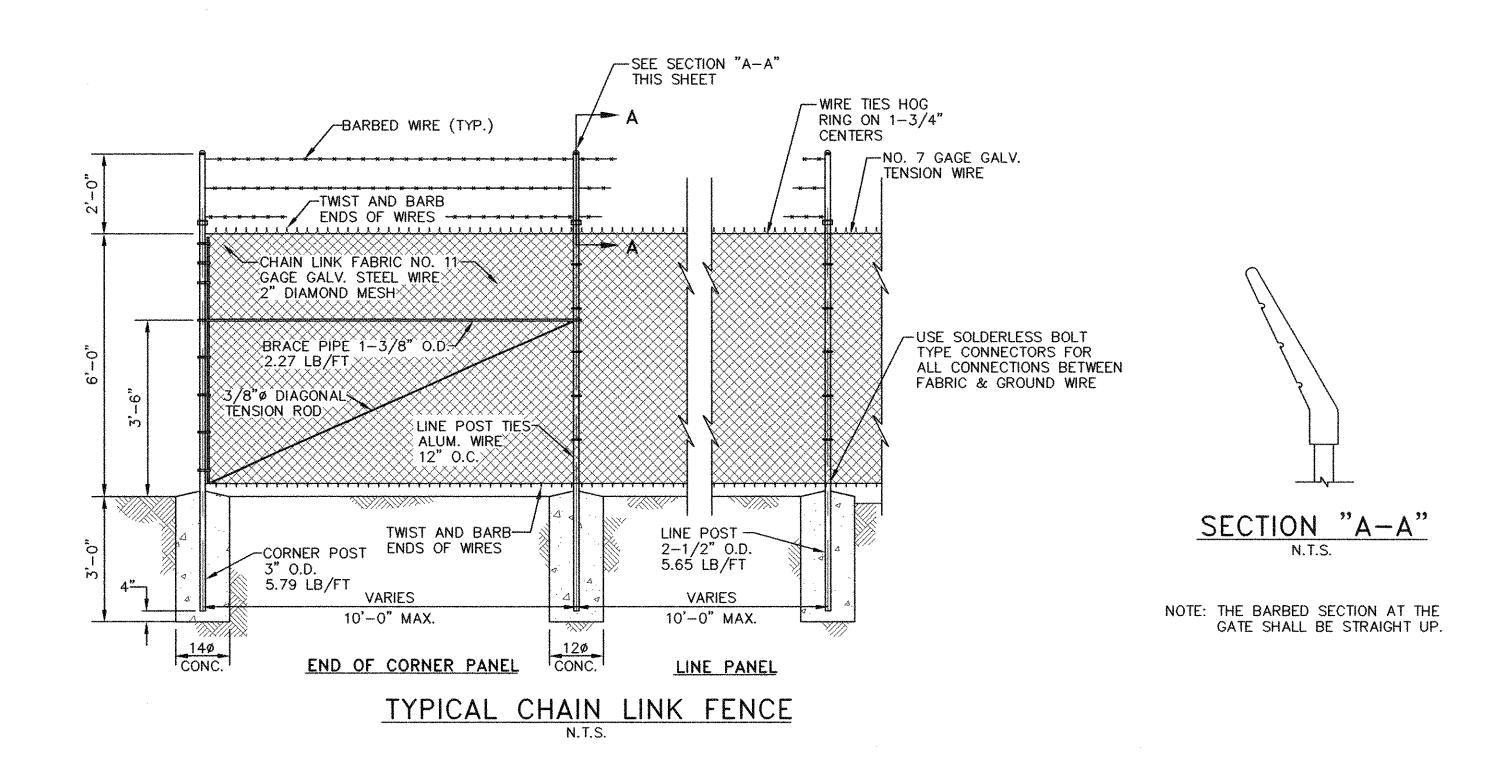

RECORD DRAWING

BASED ON CONTRACTOR MARKUPS, NOT FIELD SURVEY.

DRAWN: BW2 MRB DESIGN: REVIEWED: SCALE: N.T.S. DATE: **APRIL 2007** DWG. NAME: 1207DET2 REVISION DATE REVIEWED

FLEXIBLE BASE AND

ASPHALTIC CONCRETE SURFACE



BW2 Engineers, Inc.

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WATER SYSTEM IMPROVEMENTS GROUND STORAGE TANKS & PUMP IMPROVEMENTS GENERAL CONSTRUCTION DETAILS - SHEET 2

CITY OF LUCAS

SHEET NO. 17 SHEETS OF