

## EIR SUPPLEMENT 04/04/2024

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SHEET NO	SHEET TITLE	ISSUE DATE	REVISED DATE
EIR			
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PROJECT INFORMATION			
PROJECT ADDRESS:	2 PETALUMA BLVD NORTH PETALUMA, CALIFORNIA		
OCCUPANCY TYPE:	A-3 RESTAURANTS R-1 HOTEL GUESTROOMS S-2 PARKING		
APN:			
CONSTRUCTION TYPE:	IA		
NUMBER OF STORIES:	SIX STORIES ABOVE GRADE, ONE ROOFTOP, ONE STORY BELOW GRADE.		
BUILDING HEIGHT ABOVE GRADE:	66' 7" (TOP OF ROOF )		
SITE AREA:	14,256.54 SF		
FAR:	4.78		
PROJECT AREA:		Gross	Net
Basement		13,100	
Parking			9174
Storage			1266
MECP			1062
Ground Floor		12,727	
Restaurant			2308
outdoor seating			901
Kitchen			1832
MEP			1142
trash			176
Hotel			1460
boh			3213
Level 2		12,117	
Guest			6860
Fitness			1283
Balc			508
Terrace			898
Admin			1050
Level 3		12,117	
Guest			9323
Balc			508
Level 4		12,117	
Guest			9323
Balc			508
Level 5		11,502	
Guest			8700
Balc			988
Level 6		4,220	
Event			1372
Pantry			967
Terrace			5514
Total Above Grade Gross (shafts not removed)		64,800	
Land area		14,256	
FAR		4.55	
Site coverage		100%	
Keys		93	
Building Height (max to top of event roof from ave grade)		67'-10"	



# EKN APPELLATION

2 Petaluma Blvd South  
Petaluma, California



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414 Jackson Street, 4th Floor  
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BUEHLER**  
444 Flower St 3800  
Los Angeles, CA  
90071  
323 536 2362

**MEP  
INTERACE ENGINEERING**  
601 South Figueroa St  
Suite 2750  
Los Angeles, CA 90017  
213 694 3408

**LANDSCAPE  
BRIGHTVIEW**  
8 Hughes  
Ste. 150  
Irvine, CA, 4900  
949 238 4900

**CIVIL  
N CONSULTENG**  
4 Park Plz  
Irvine, CA  
92614  
949 396 1161

**FF&E  
DH-COMPANIES**  
7591 Coppermine Drive  
Manassas, VA  
20109  
703 520 1885

**INTERIOR  
SIXTEEN-FIFTY**  
7509 Girard Ave.  
La Jolla, CA  
92037  
858 454 6909


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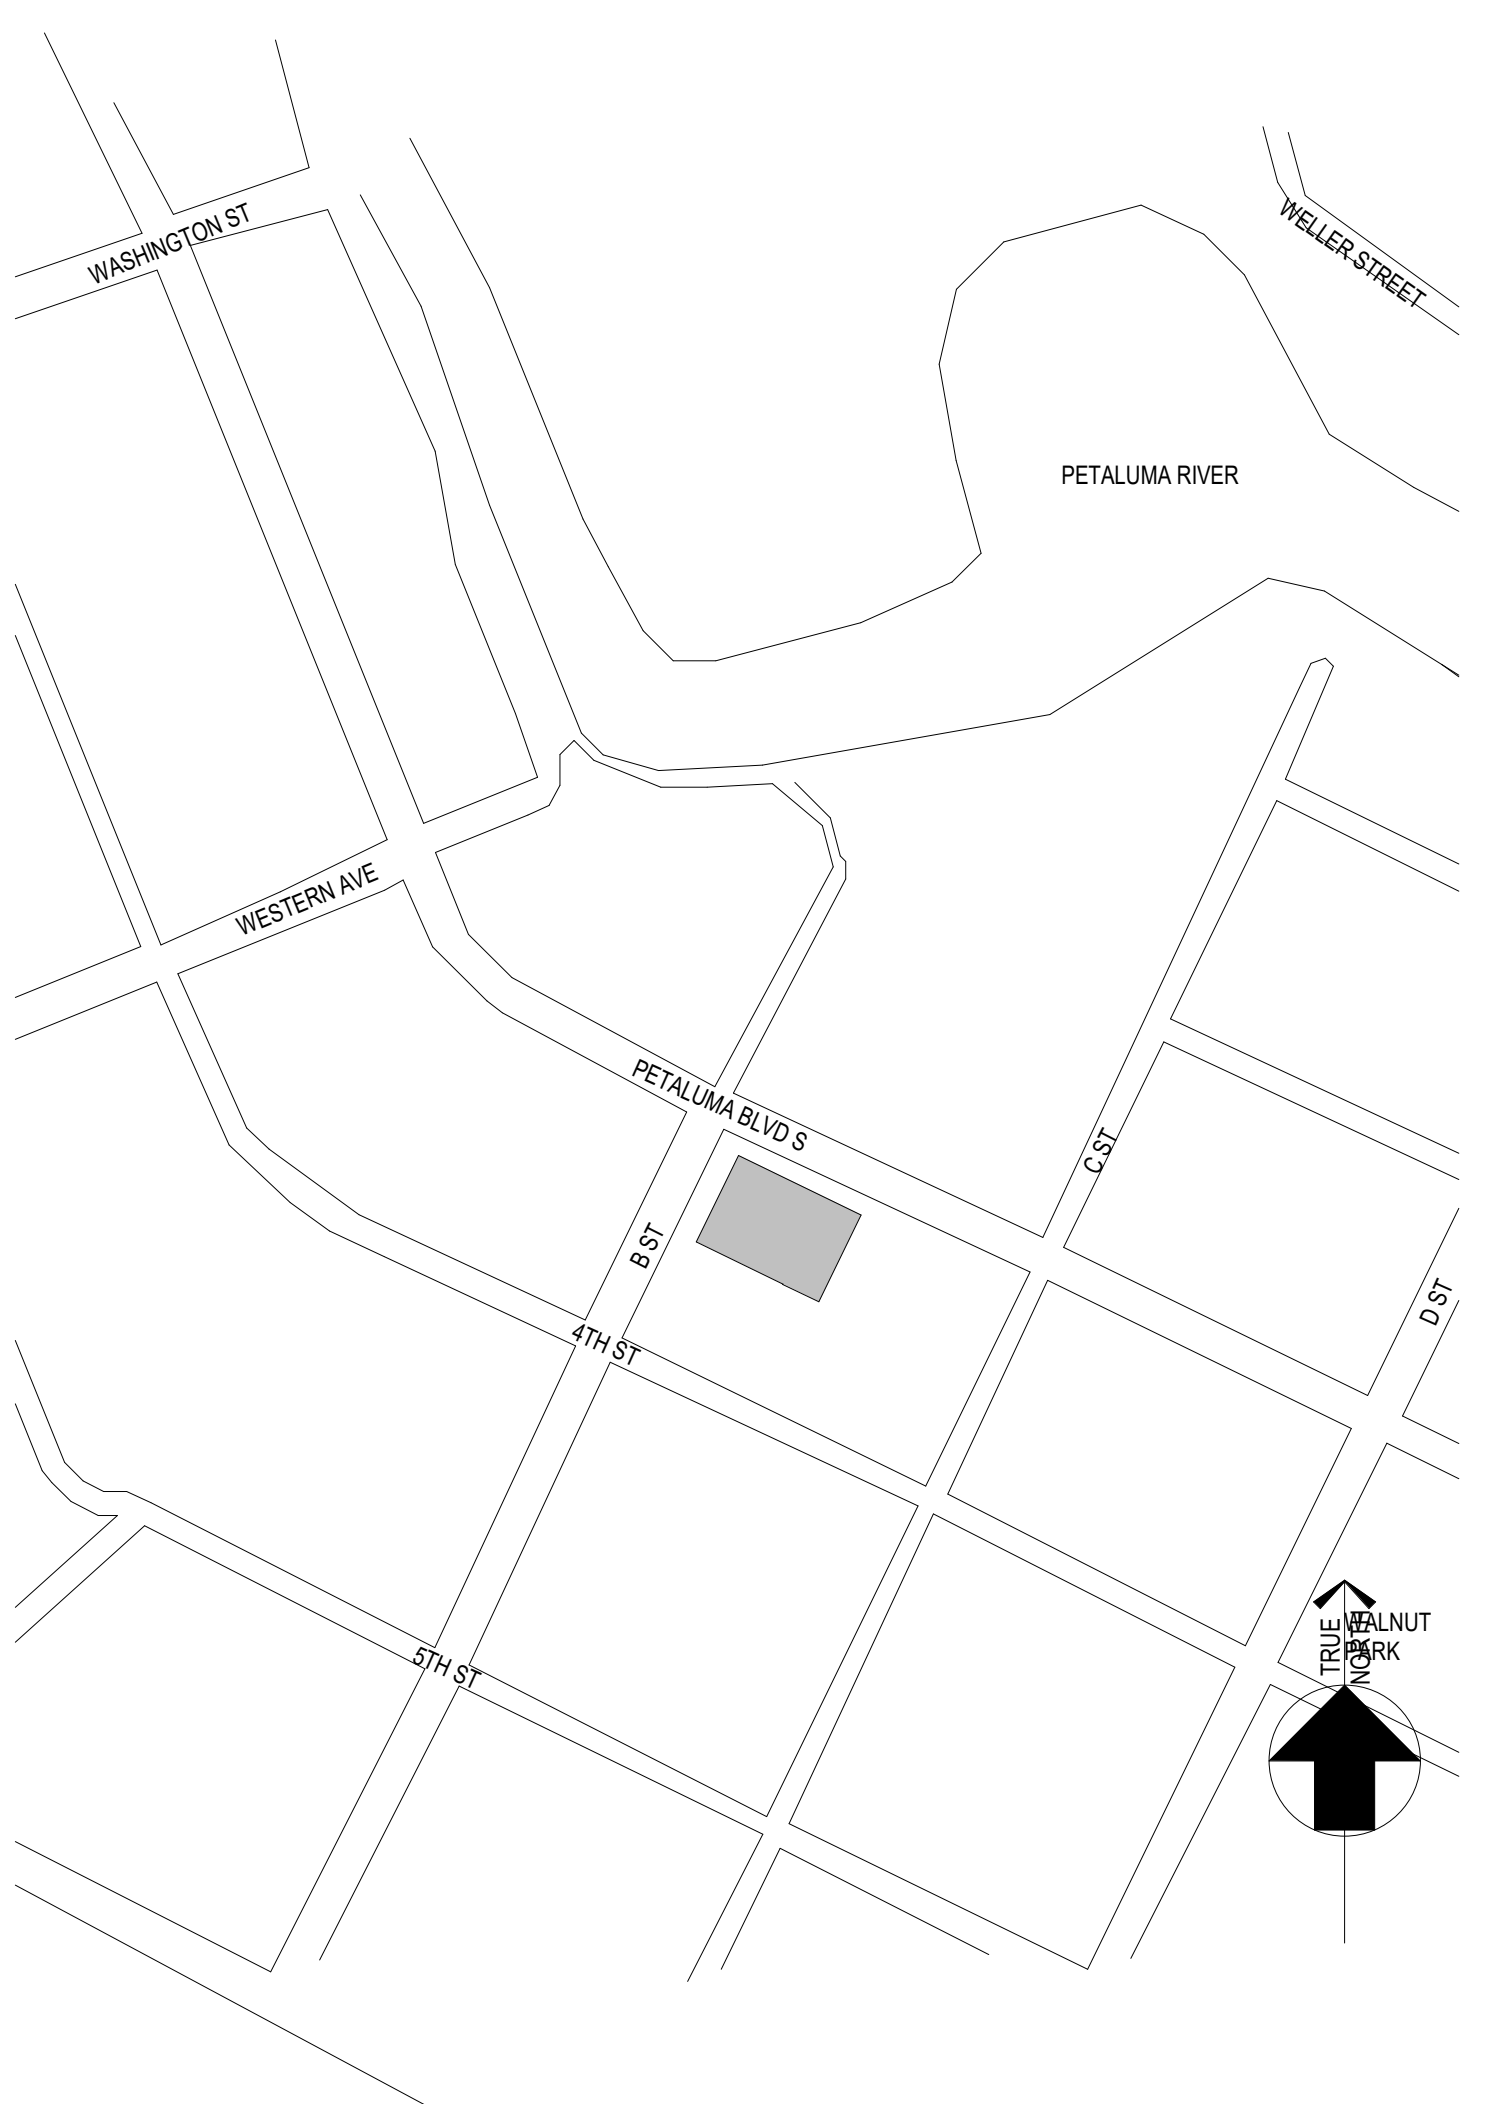


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 601 South Figueroa Street Suite 2750  
 Los Angeles CA 90017  
 323 536 2362  
 LANDSCAPE ARCHITECTURE  
 1645 Grant Street  
 Denver, Colorado 80203  
 Address Line 3  
 949 238 4900  
 STRUCTURE BUEHLER ENGINEERING  
 Suite 1125  
 San Francisco, CA 94103  
 213 694 3408  
 FF&E DH-COMPANIES  
 7591 Coppermine Drive  
 Manassas, VA, 20109  
 INTERIORS SIXTEEN FIFTY  
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 La Jolla, CA  
 92037  
 858 454 0009  
 CIVIL N CONSULTING ENGINEERS  
 4 Park Plz  
 Irvine, CA  
 92614  
 949 369 1161



1 ARCHITECTURAL - SITE  
 SCALE: 1/16" = 1'-0"

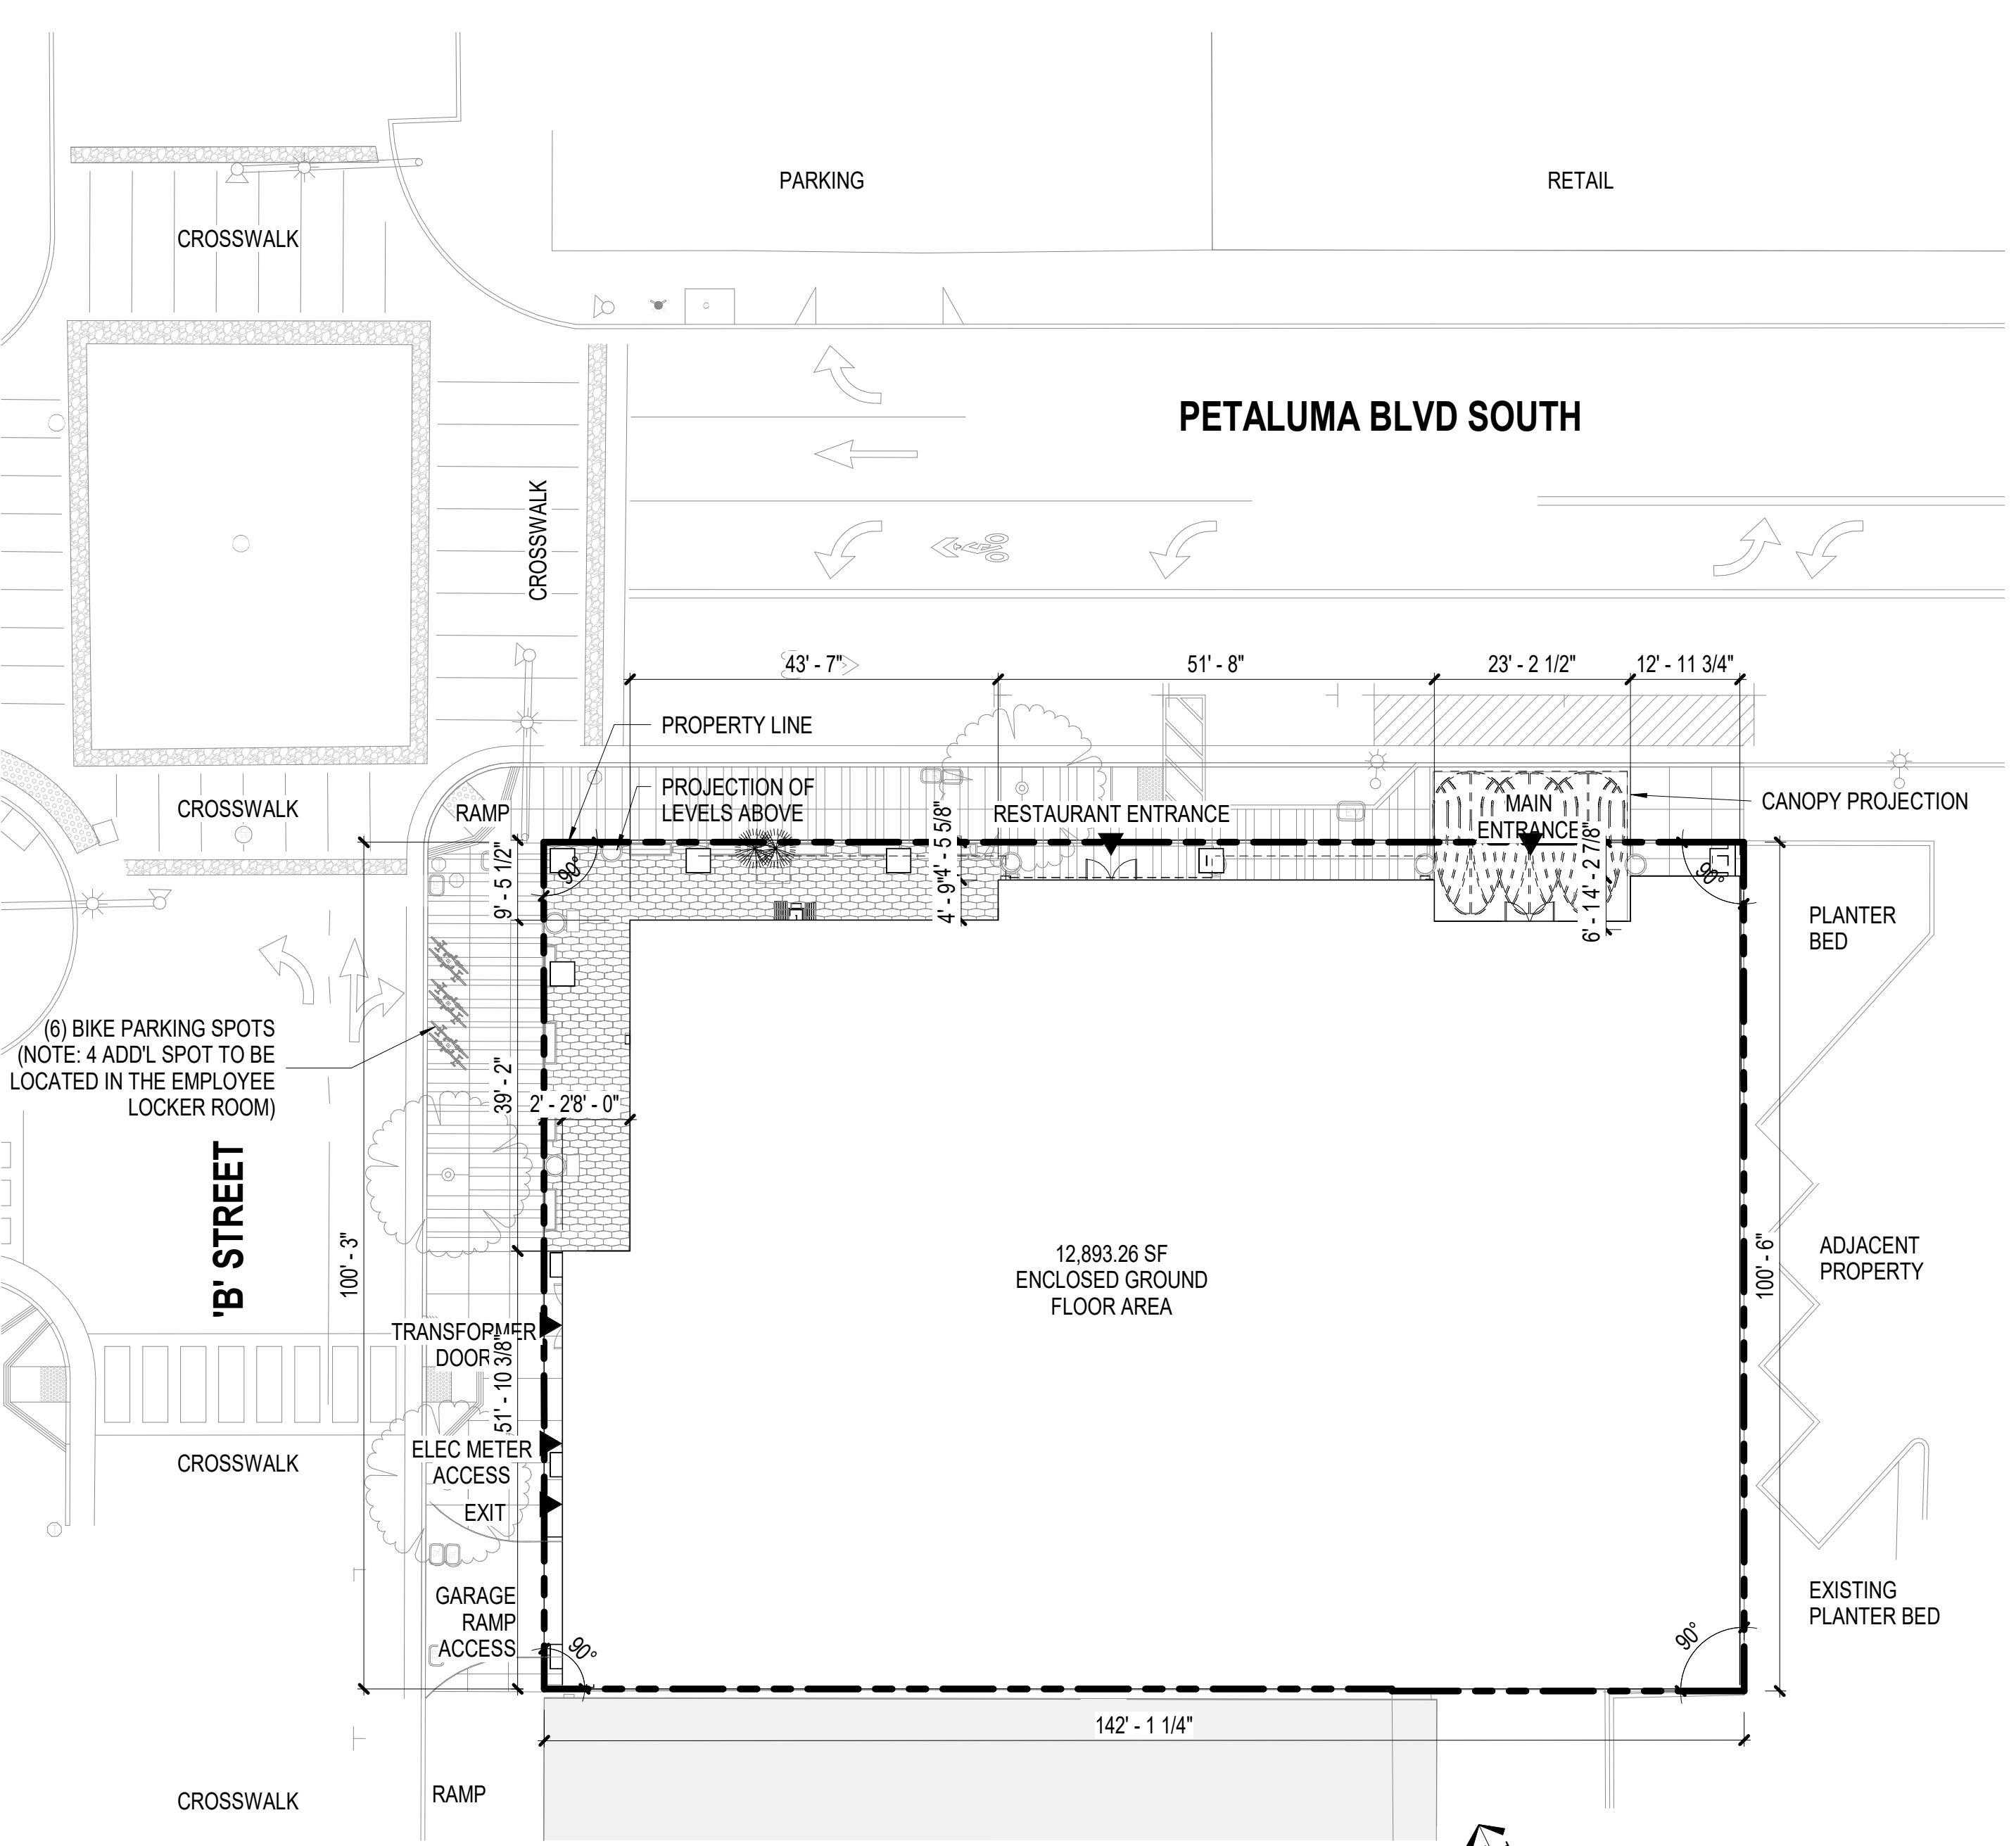


1 VICINITY MAP 1  
 SCALE: 1" = 200'-0"




2 SITE - PHOTOS 1  
 SCALE: 1" = 160'-0"

PROGRAM OUTSIDE OF PARKING DISTRICT:

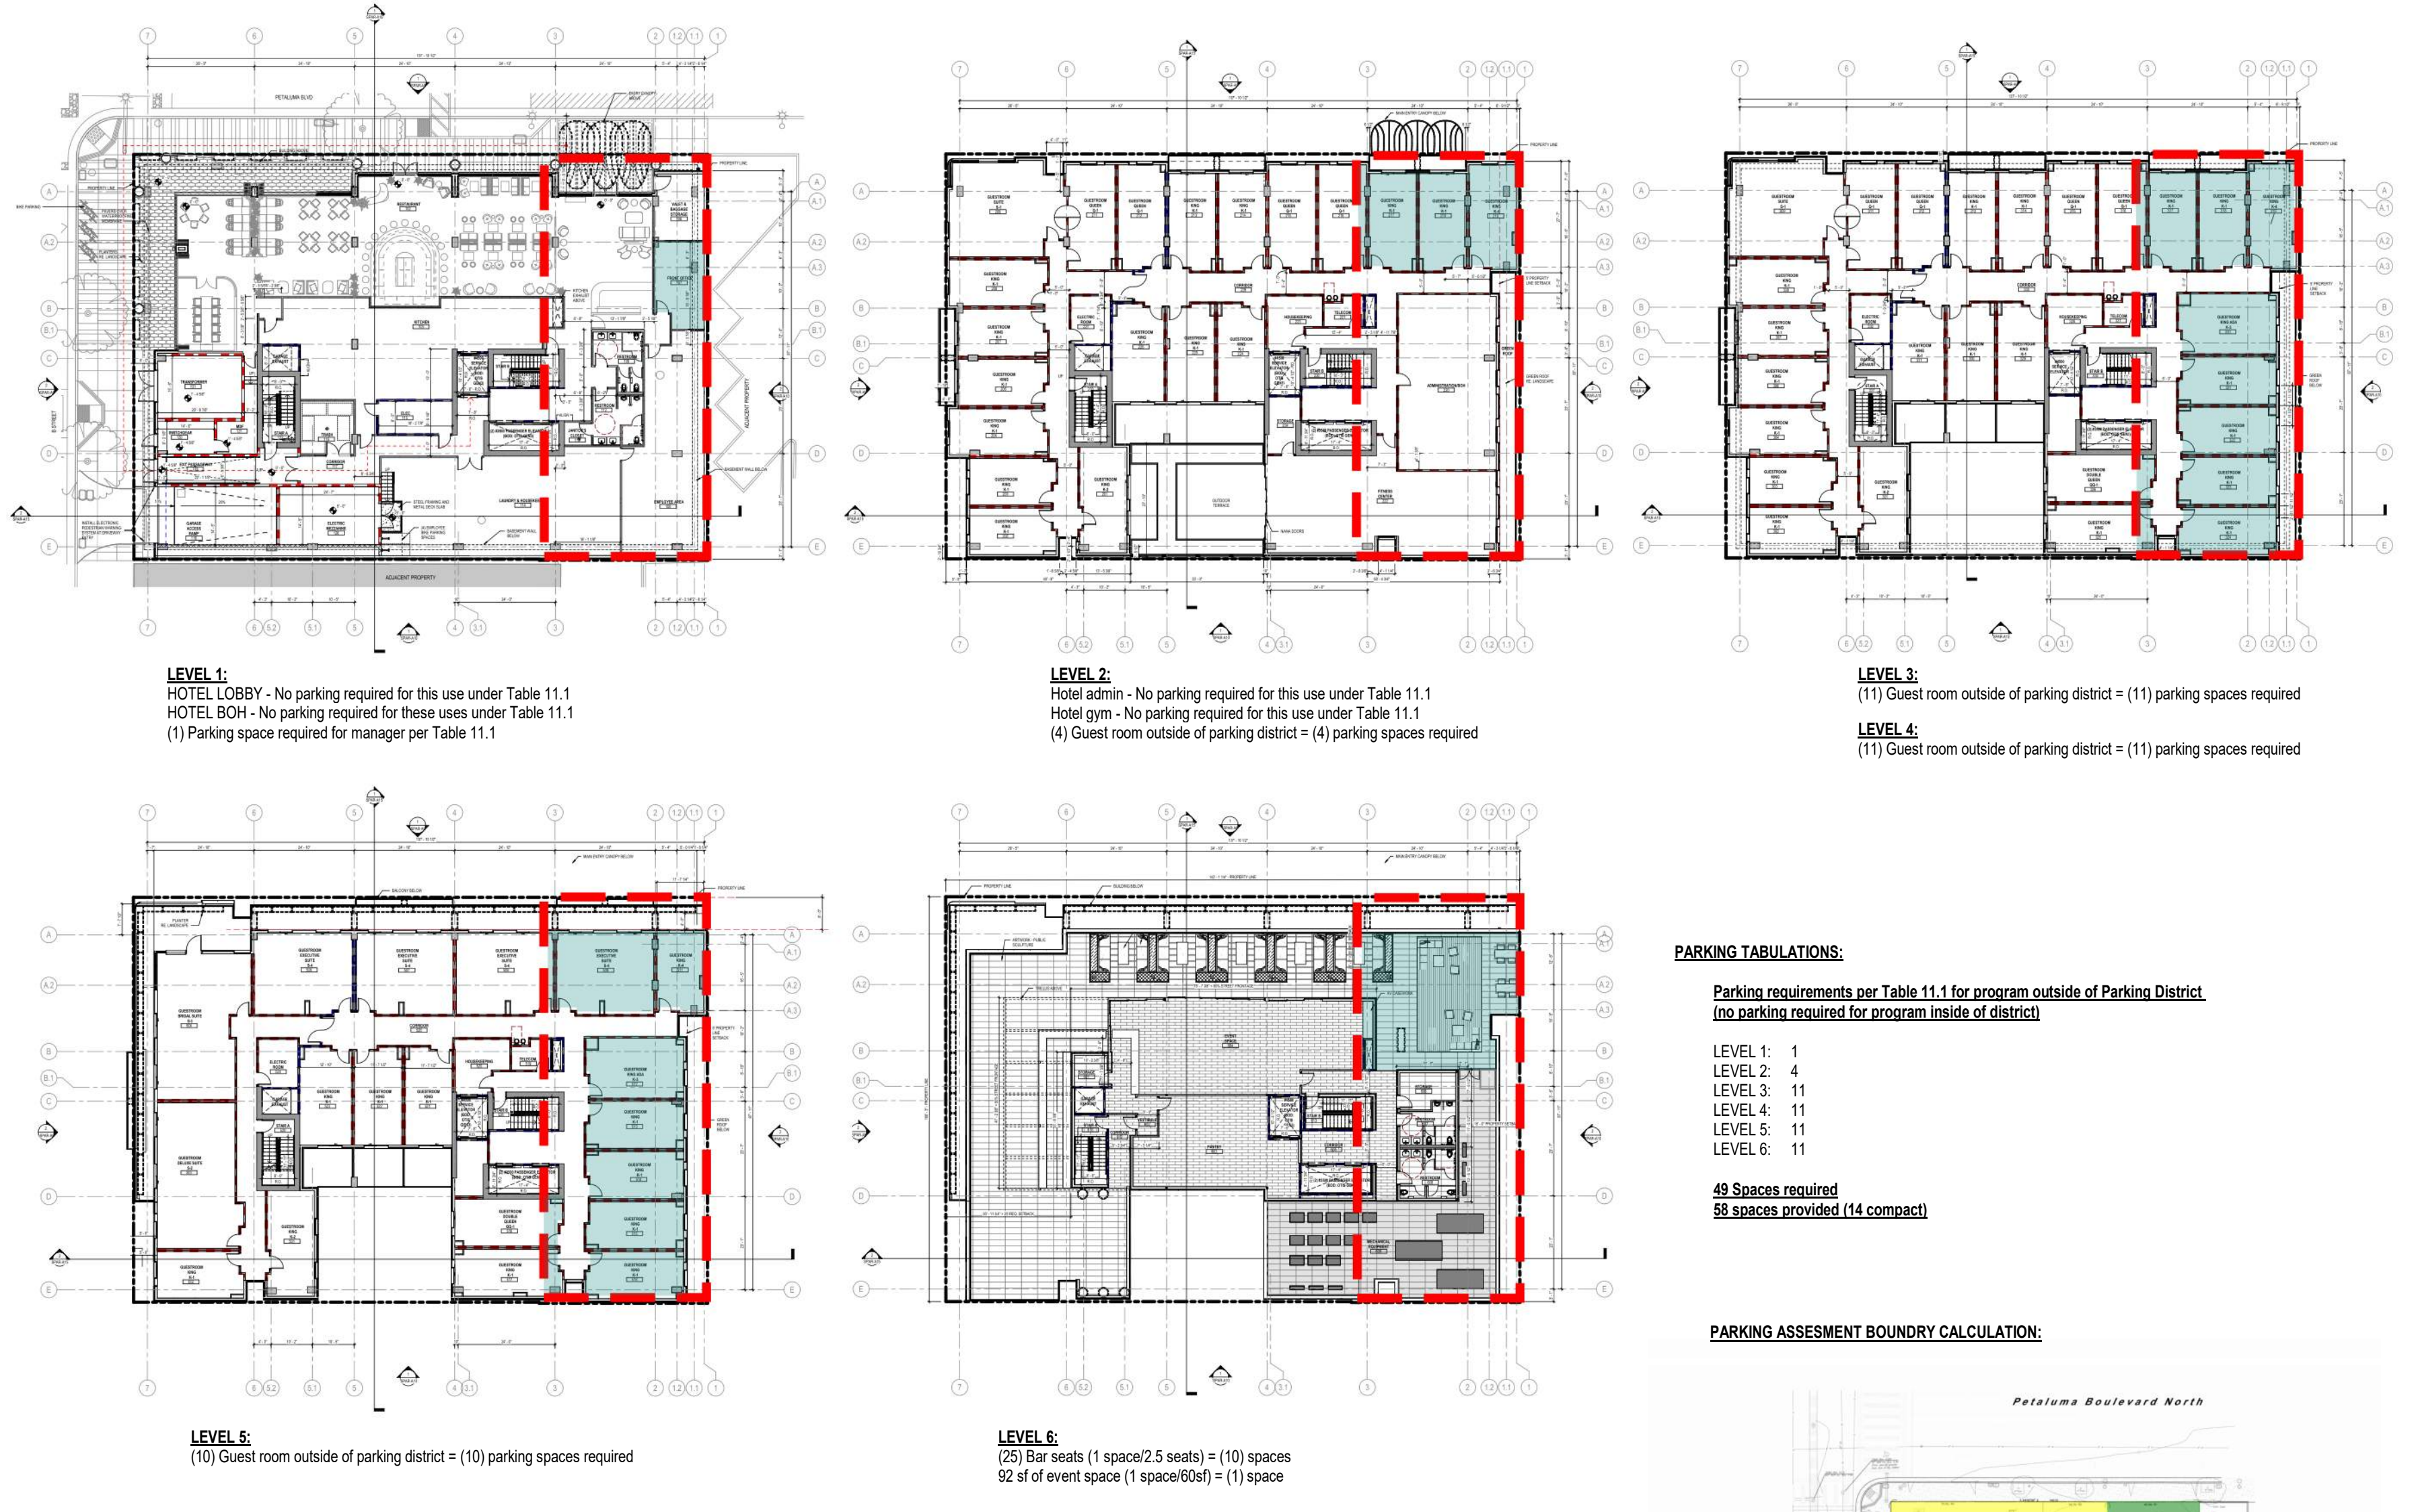

PARKING TABULATIONS:  
 Parking requirements per Table 11.1 for program outside of Parking District  
 (no parking required for program inside of district)


LEVEL 1:	1
LEVEL 2:	4
LEVEL 3:	11
LEVEL 4:	11
LEVEL 5:	11
LEVEL 6:	11
<b>49 Spaces required</b>	
<b>58 spaces provided (14 compact)</b>	

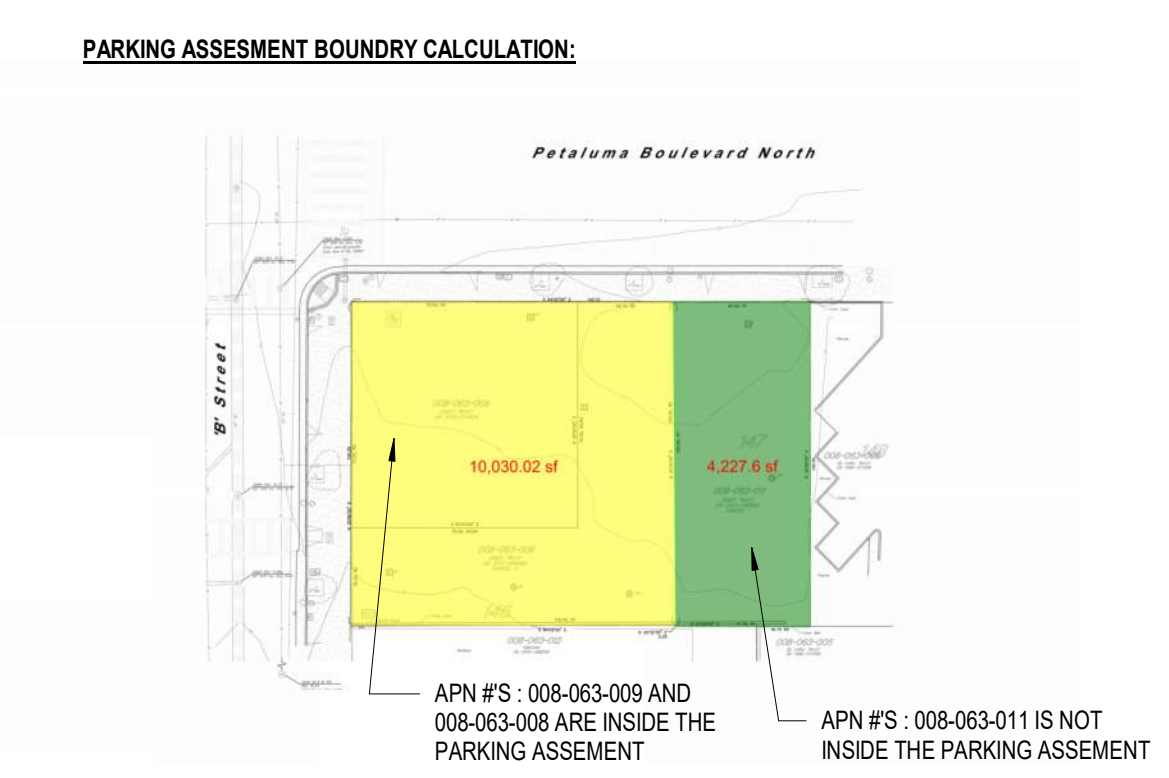


SPEC SHEET PARKPLUS DP003 DOUBLE STACKER

8-444-PARKPLUS

PARKPLUSINC.COM

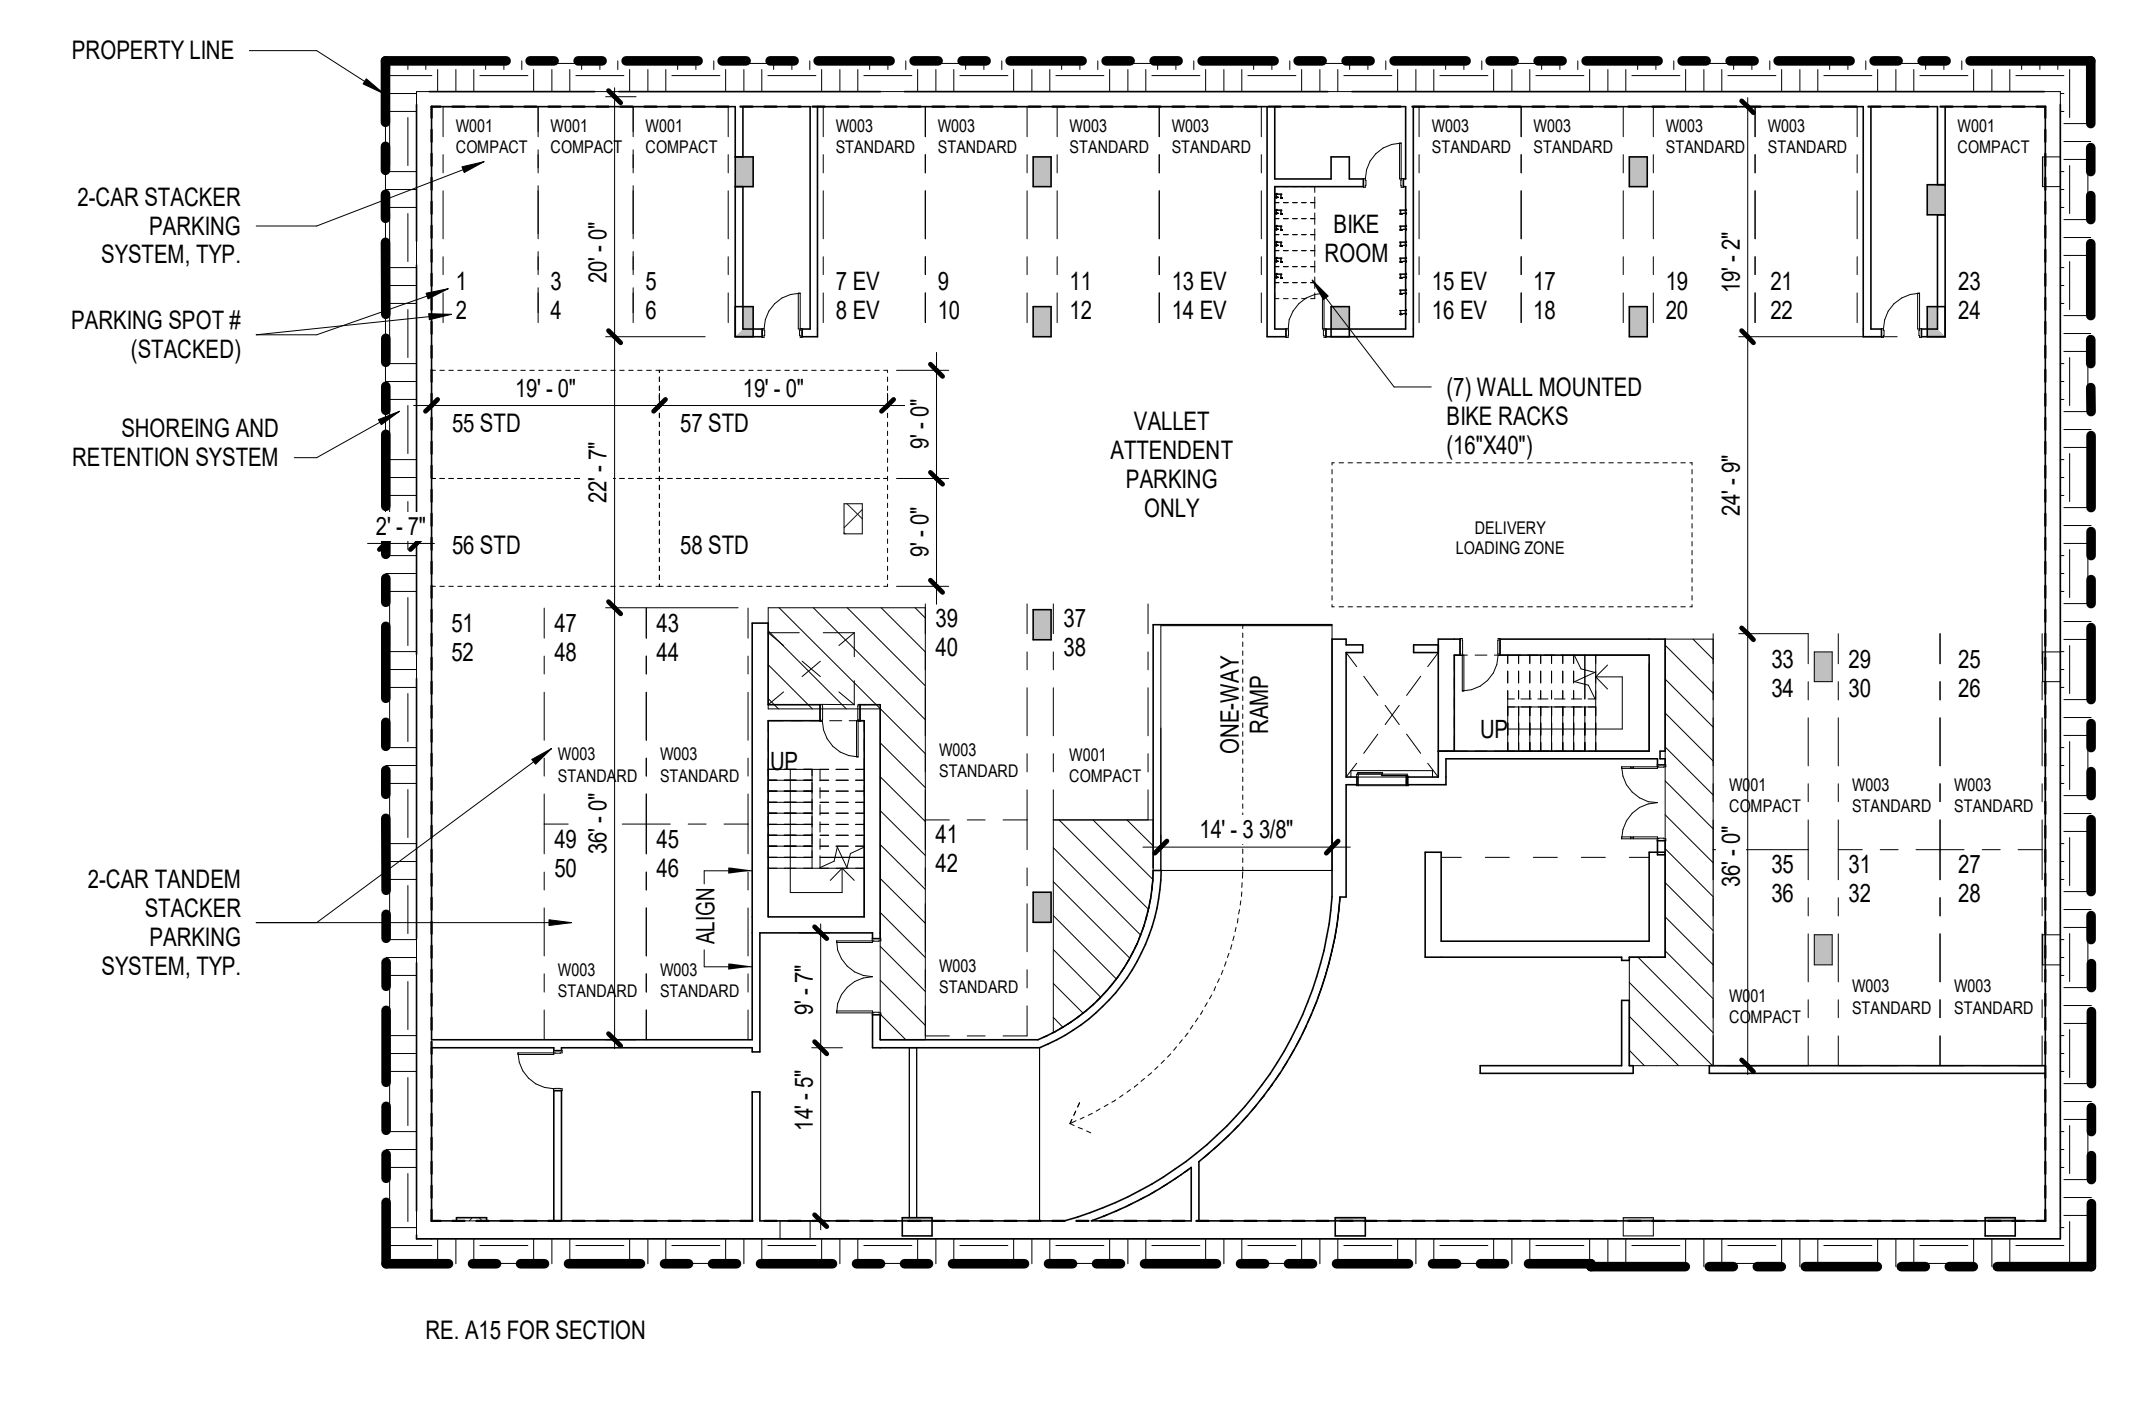

3 PARKING SUMMARY 1  
 SCALE: 1/16" = 1'-0"

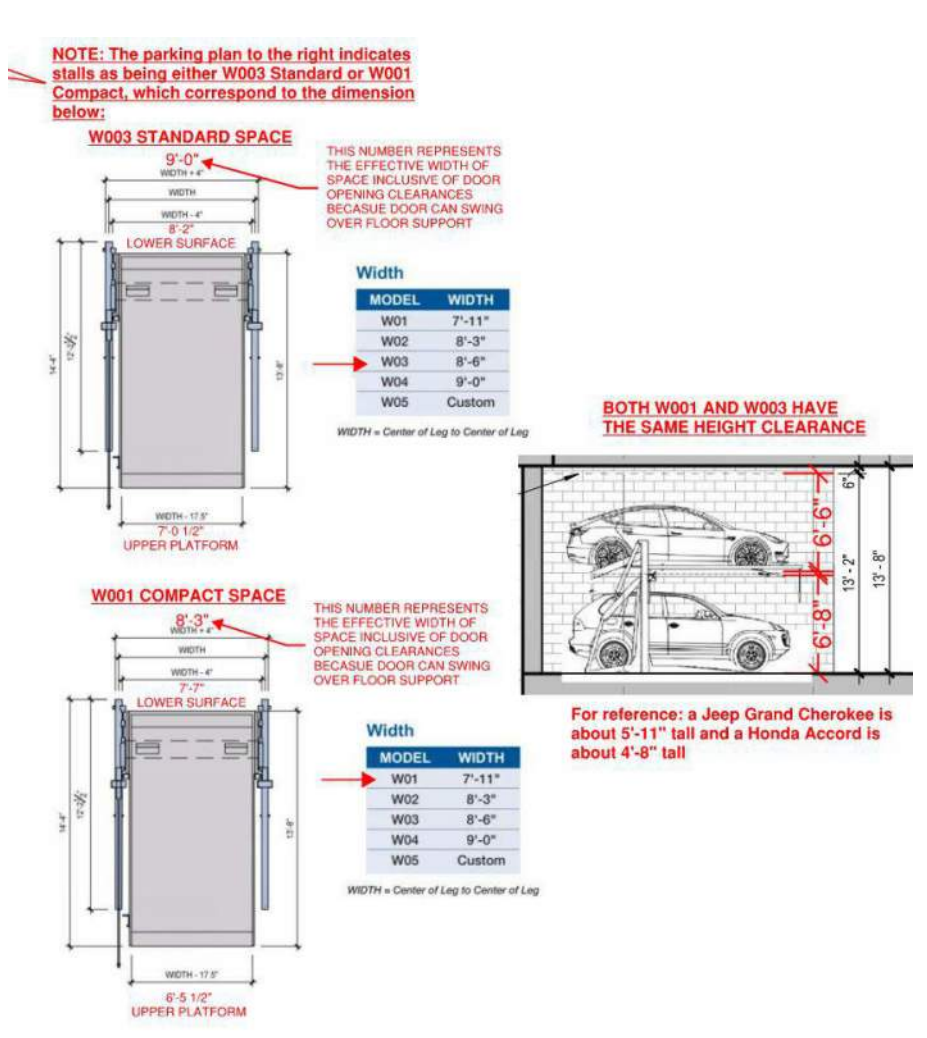

REVISION HISTORY

NO.	DESCRIPTION	DATE

PROFESSIONAL SEALS

INTERIM REVIEW

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ARCHITECTURAL - SITE PLAN

DRAWN BY: \_\_\_\_\_ CHECKED BY: \_\_\_\_\_

PROJECT NUMBER: 621010 PROJECT ABBREVIATION: PH

ORIGINAL ISSUE DATE: \_\_\_\_\_ DATE: 04 APRIL 2024



EIR SUPPLEMENT

EIR-1.2  
 SHEET NUMBER

EKN Petaluma LLC  
 EKN APPELLATION  
 2 Petaluma Blvd South  
 Petaluma, California

FILE PATH: Autodesk Docs://621010-Petaluma Hotel/621010-A-Petaluma-R23-CENTRAL.rvt  
 USER NAME: DATE TIME: 4/4/2024 3:19:17 PM



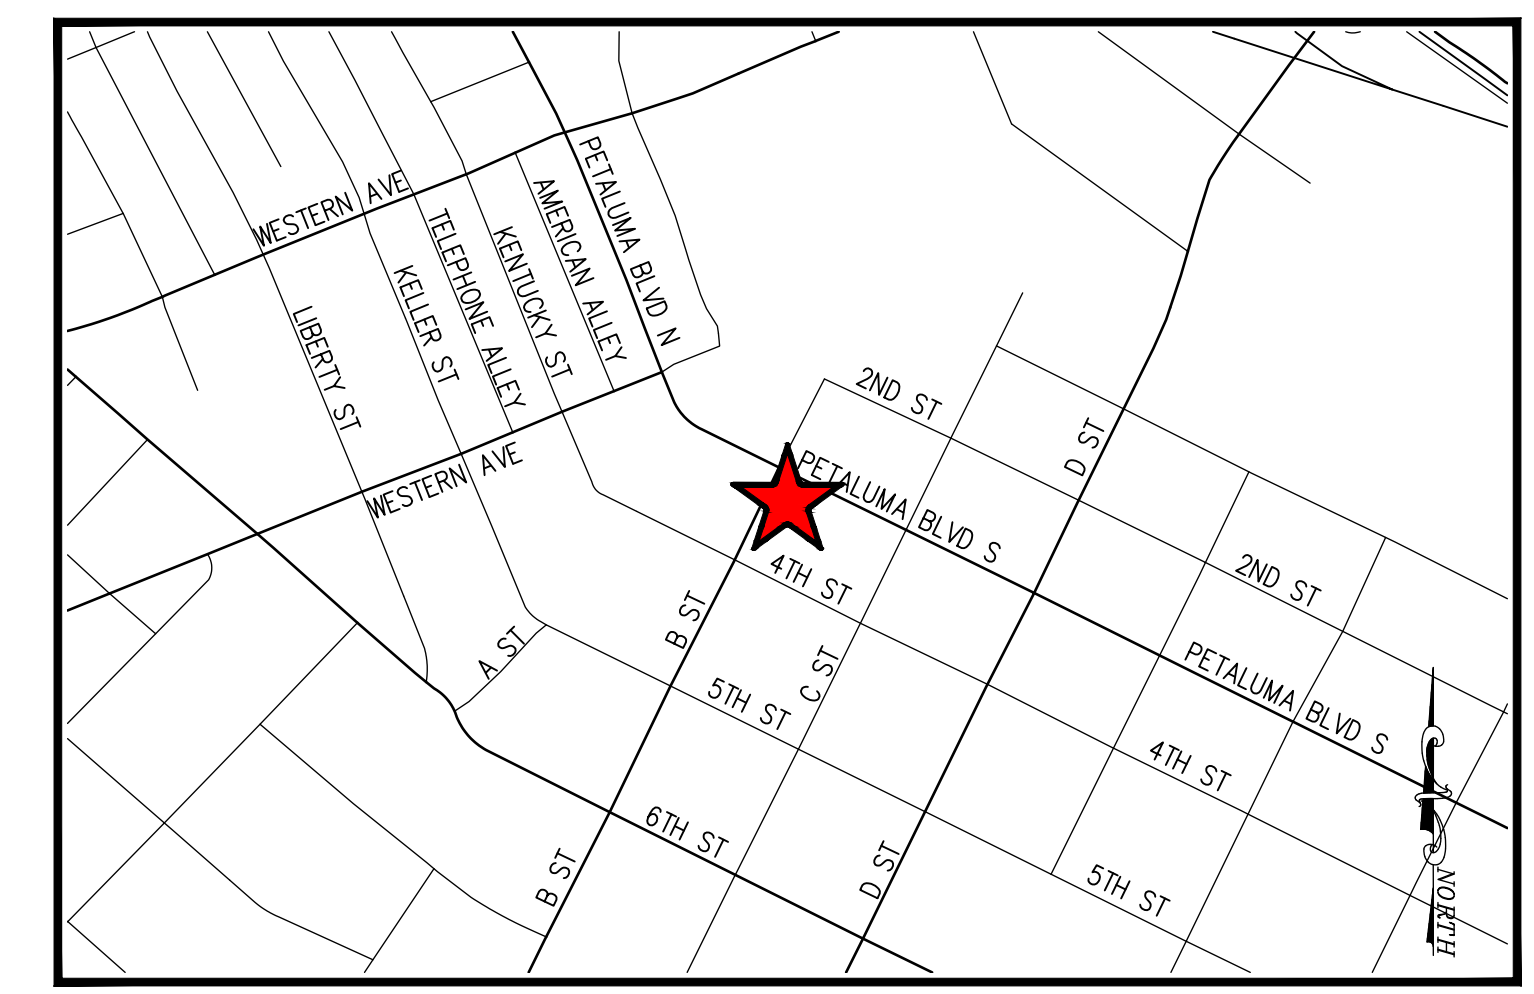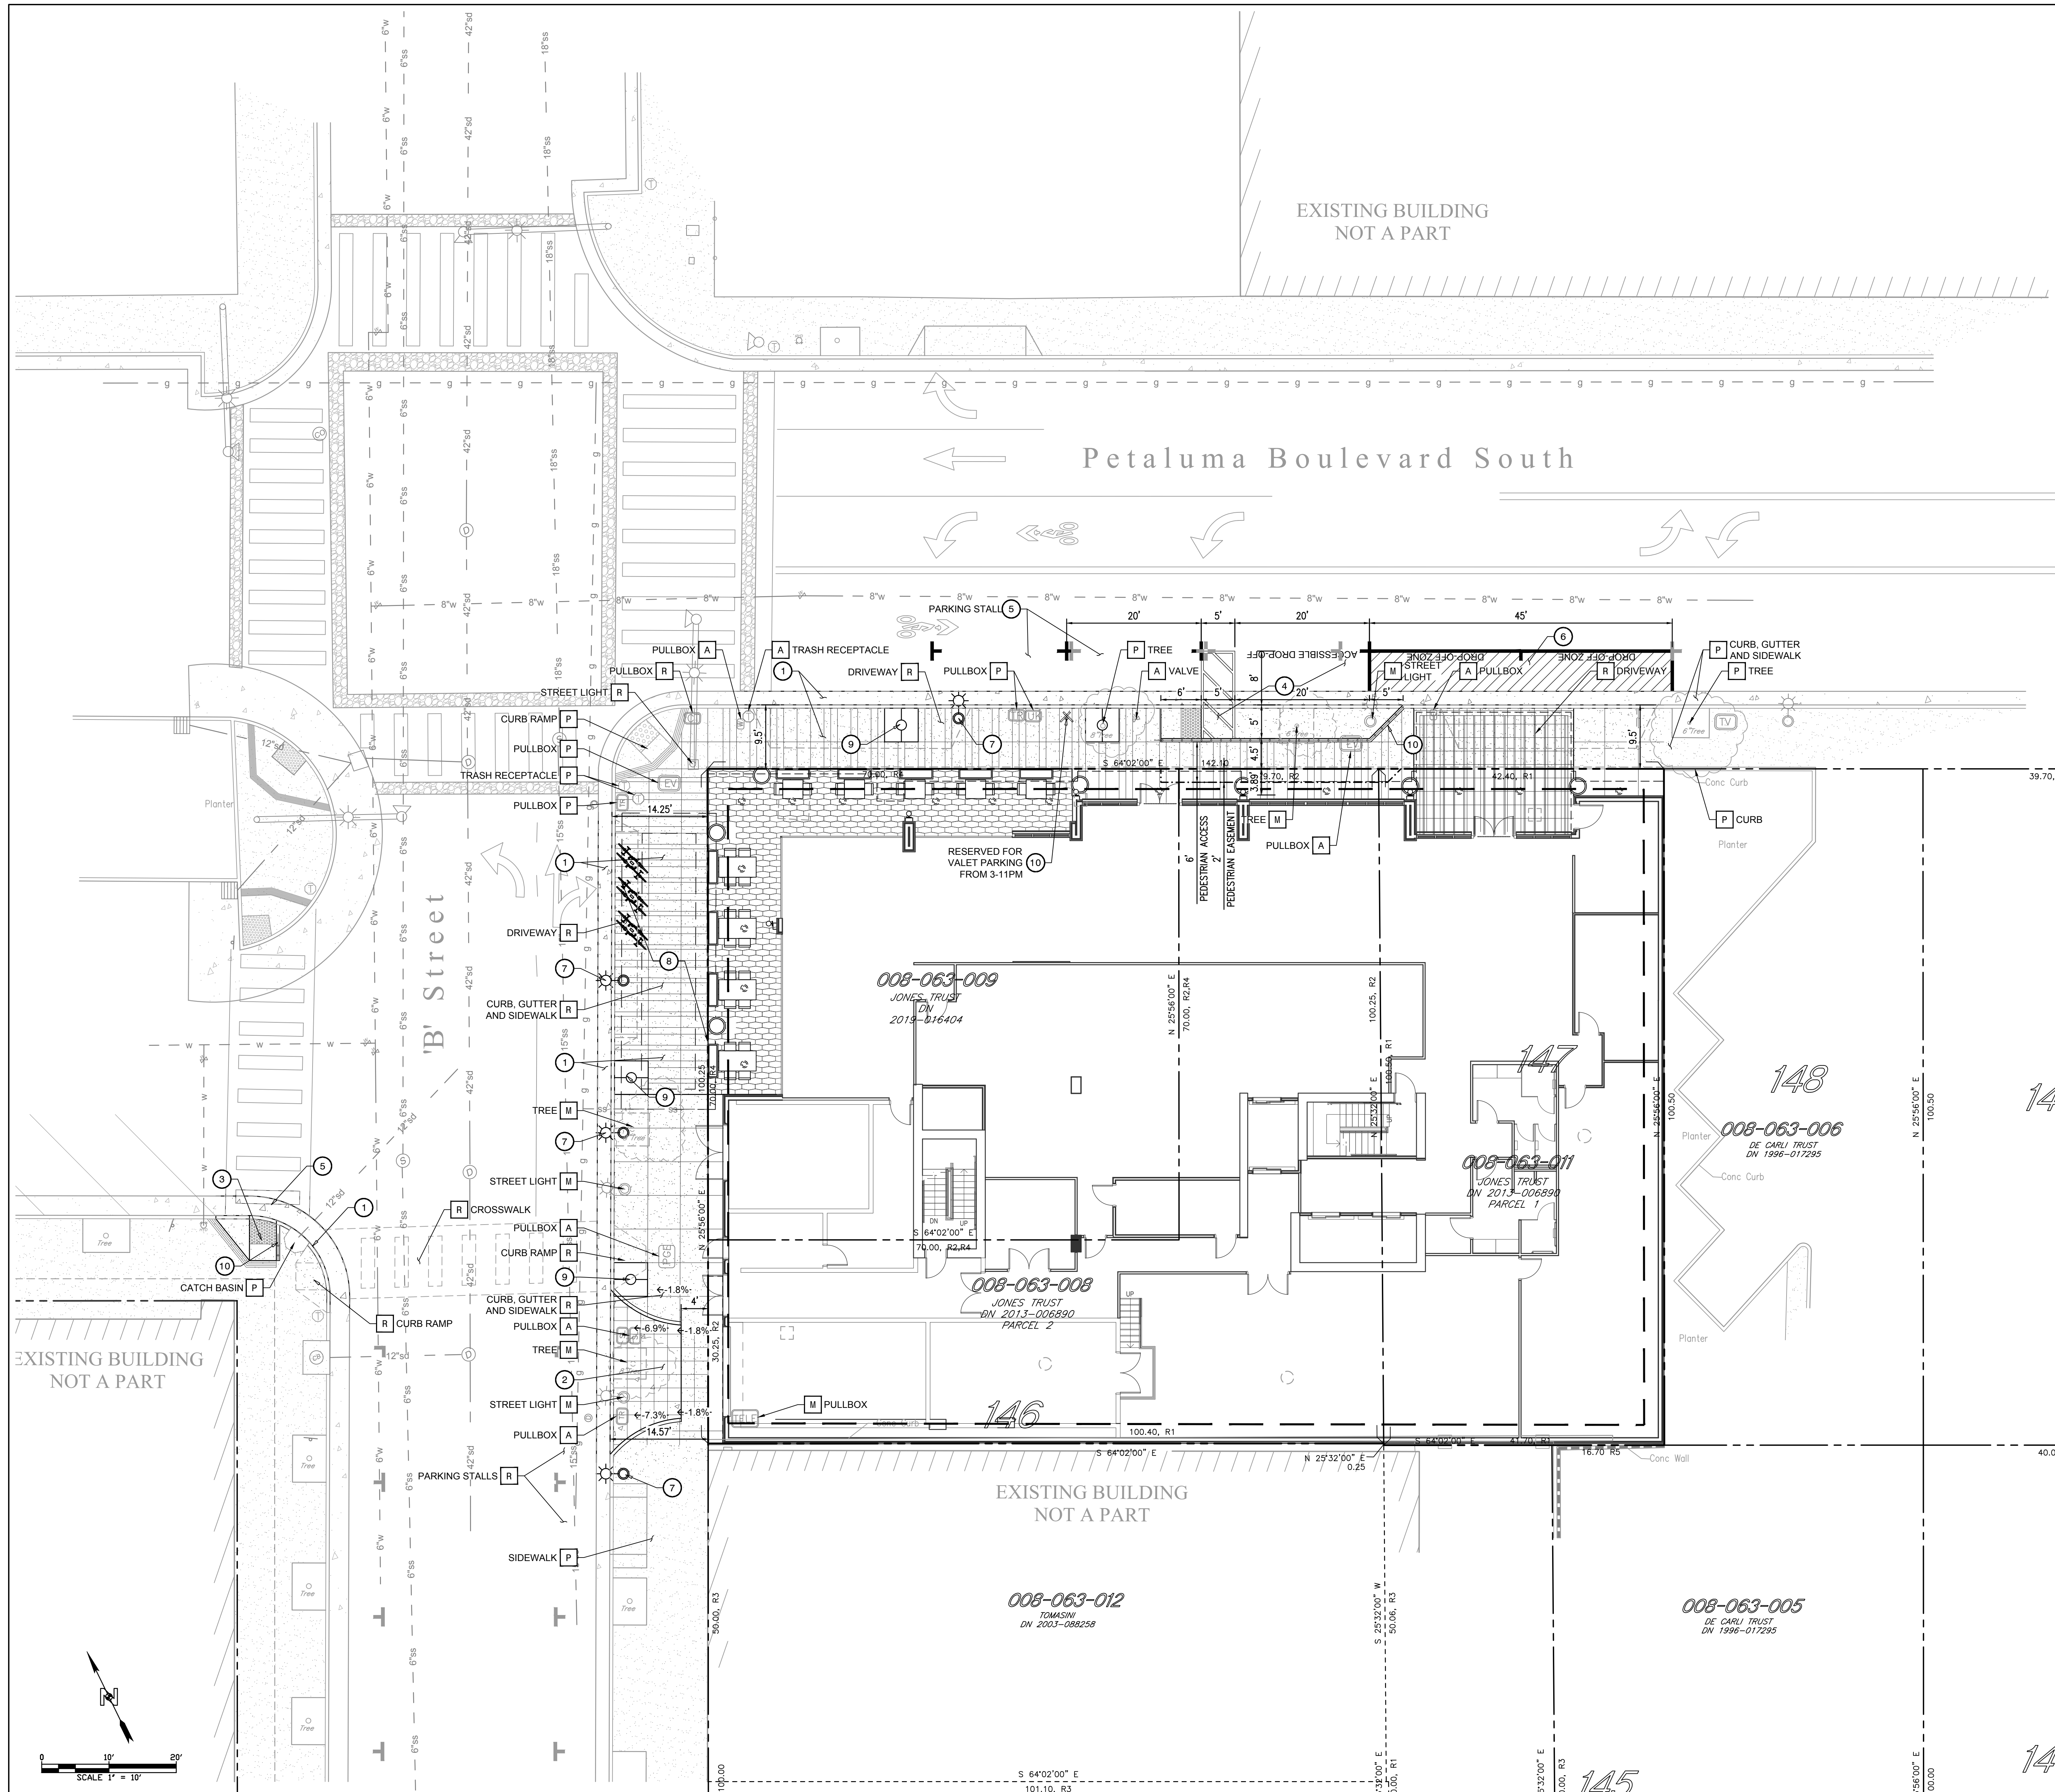

**VICINITY MAP**  
SCALE: 1" = 500'

<b>PROJECT TEAM</b>	
<b>OWNER / DEVELOPER</b> EKN DEVELOPMENT GROUP 220 NEWPORT CENTER DRIVE, SUITE 11-262 NEWPORT BEACH, CA 92660 CONTACT: MIKE JOLLY PHONE: 310.776.0621	<b>ARCHITECT</b> PAGE SOUTHERLAND PAGE, INC 414 JACKSON STREET, 4TH FLOOR SAN FRANCISCO, CA 94111 CONTACT: SAM GELFAND PHONE: 415.249.0130
<b>CIVIL ENGINEER</b> N CONSULTING ENGINEERS, INC. 4 PARK PLAZA, SUITE 1750 IRVINE, CA 92614 CONTACT: DEREK KARIMOTO P.E., QSD PHONE: 714.514.8858	<b>LANDSCAPE ARCHITECT</b> BRIGHTVIEW 8 HUGHES, STE. 150 IRVINE, CA 92614 CONTACT: MATT DUNCAN PHONE: 949.396.1161
<b>STRUCTURAL</b> BUEHLER 444 FLOWER ST 3800 LOS ANGELES, CA 90071 CONTACT: PHONE: 323.536.2362	<b>MEP</b> INTERFACE ENGINEERING, INC 100 SOUTH FIGUEROA STREET, SUITE 2750 LOS ANGELES, CA 90017 CONTACT: EUGENE DE SOUZA PHONE: 213.694.3408

PROJECT DATA	
APN(S)	008-063-008, 008-063-009, 008-063-011
ADDRESS	2 PETALUMA BLVD S, PETALUMA, CA 94952
ZONING DESIGNATION	MIXED USE 2 (MU2)
OVERLAY DISTRICT(S)	PARKING ASSESSMENT DISTRICT, THEATER DISTRICT, HISTORIC COMBINING DISTRICT
EXISTING LAND USE	ROUGH GRADED SITE - VACANT LOT
AREA	14,256 SF [0.327 ACRES]

DEMOLITION NOTES	
[A] ADJUST TO GRADE.	EA
[M] MOVE OR RELOCATE.	EA
[P] PROTECT IN PLACE.	EA
[R] REMOVE AND DISPOSE OF OFF-SITE.	EA

CONSTRUCTION NOTES	
1. CONSTRUCT CURB, GUTTER AND SIDEWALK PER CITY OF PETALUMA STANDARD DETAILS 202 AND 203. SEE LANDSCAPE PLAN FOR PATTERN AND COLOR.	LF
2. CONSTRUCT DRIVEWAY PER CITY OF PETALUMA STANDARD DETAIL 203.	EA
3. CONSTRUCT CURB RAMP "CASE A" PER CALTRANS STANDARD PLAN A88A.	EA
4. CONSTRUCT ACCESSIBLE DROP-OFF PER CALTRANS STANDARD PLAN A90B.	EA
5. STRIPE IN-KIND.	LF
6. PAINT 4" WIDE WHITE PAINTED STRIPE (TWO COATS) 45" @ 3" O.C., TYP. STENCIL "DROP-OFF ZONE" IN 12" HIGH LETTERING.	LF
7. INSTALL RELOCATED STREET LIGHT PER CITY OF PETALUMA STANDARD DETAIL 611.	EA
8. INSTALL STORM WATER DETENTION SYSTEM.	EA
9. CONSTRUCT TREE WELL PER LANDSCAPE PLANS.	EA
10. INSTALL HANDRAIL.	LF
11. INSTALL SIGN POST AND SIGNAGE.	EA

LEGEND	
---	PROPERTY LINE
---	EXCAVATION LIMITS
---	SAWCUT LINE
g	EXISTING GAS
sd	EXISTING STORM DRAIN
ss	EXISTING SANITARY SEWER
w	EXISTING WATER
---	PEDESTRIAN EASEMENT

EARTHWORK:	
CUT:	7136 C.Y.
FILL:	0 C.Y.
IMPORT:	0 C.Y.
EXPORT:	7136 C.Y.

EARTH WORK QUANTITIES ARE RAW ESTIMATES ONLY. NO MATERIAL SHRINKAGE OR EXPANSION FACTOR IS INCLUDED IN THIS ESTIMATE AND DOES NOT REFLECT SUBSIDENCE, OR ANY MATERIAL GENERATED BY UTILITY TRENCHING AND BUILDING FOOTINGS.

CIVIL - CONCEPTUAL SITE PLAN	
DRAWN BY	CHECKED BY
PROJECT NUMBER 621010	PROJECT ABBREVIATION PH
ORIGINAL ISSUE	DATE
EIR SUPPLEMENT	04 APRIL 2024
<b>EIR-1.3</b>	
SHEET NUMBER	

NO.	DATE	REVISION DESCRIPTION	BY	DATE

**DIGALERT**  
DIAL TOLL FREE  
**811**  
AT LEAST TWO DAYS BEFORE YOU DIG  
UNDERGROUND SERVICE ALERT OF SOUTHERN CALIFORNIA

**NOTICE TO CONTRACTOR:**

- THE LOCATIONS OF EXISTING UTILITY INSTALLATIONS AS SHOWN ON THIS PLAN ARE APPROXIMATE. THERE MAY BE OTHER UNDERGROUND UTILITY INSTALLATIONS WITHIN THE PROJECT AREA THAT ARE NOT SHOWN.
- N CONSULTING ASSUMES NO RESPONSIBILITY FOR DAMAGES, LIABILITY OR COSTS RESULTING FROM CHANGES OR ALTERATIONS MADE TO THIS PLAN WITHOUT THE EXPRESSED WRITTEN CONSENT OF N CONSULTING.

**BENCH MARK**  
FOUND 3" BRASS DISK SET IN THE TOP OF A SANDSTONE WALL AT THE FOURTH STREET POST OFFICE, 0.3' ABOVE THE GROUND, STAMPED "12.045 JJ 107 1932", ELEVATION=15.20', NAVD88 DATUM (PER NGS DATASHEET). A CONVERSION FACTOR OF -2.795 SHOULD BE USED TO CONVERT NAVD88 ELEVATIONS TO NGVD29 ELEVATION.

**BASIS OF BEARINGS**  
192 MAPS 26, SCR.

**N CONSULTING ENGINEERS**  
17780 Fitch  
Irvine, CA 92614  
PHONE: 949.396.1161  
www.nconsulting.com

DEREK H. KARIMOTO  
DATE

**REGISTERED PROFESSIONAL ENGINEER**  
DEREK H. KARIMOTO  
No. 42356  
Exp. 3/31/24  
CIVIL  
STATE OF CALIFORNIA


PROJECT ADDRESS: 2 PETALUMA BLVD PETALUMA, CA 94952	SITE: APPELLATION HOTEL
CLIENT: EKN DEVELOPMENT GROUP 220 NEWPORT CENTER DRIVE, SUITE 11-262 NEWPORT BEACH, CA 92660	TITLE: CONCEPTUAL SITE PLAN
ISSUE: SPAR APPLICATION SUBMITTAL - 2022-08-26	DRAWN BY: S.S.
	DATE: 3/30/2023
	PROJECT NO.:
	21-002
	CHECKED: D.H.K.
	REV. COUNT: 1 OF 1 SHEETS
	SHEET: SPAR C1

P:\21-002 EKN Petaluma Hotel\Drawings\Prelim\21002C10-CSP.rvtg Mar 30, 2023 5:23pm




**LEGEND**

— CA —	EXISTING UNDERGROUND CABLE
— C —	EXISTING UNDERGROUND COMMUNICATION
— E —	EXISTING UNDERGROUND POWER
— G —	EXISTING NATURAL GAS
— IR —	EXISTING IRRIGATION
— SD —	EXISTING STORM DRAIN
— SS —	EXISTING SANITARY SEWER
— T —	EXISTING TELEPHONE
— UT —	EXISTING GENERAL UTILITIES
— W —	EXISTING WATER
— CA —	PROPOSED UNDERGROUND CABLE
— C —	PROPOSED UNDERGROUND COMMUNICATION
— E —	PROPOSED UNDERGROUND POWER
— G —	PROPOSED NATURAL GAS
— IR —	PROPOSED IRRIGATION
— SD —	PROPOSED STORM DRAIN
— SS —	PROPOSED SANITARY SEWER
— T —	PROPOSED TELEPHONE
— UT —	PROPOSED GENERAL UTILITIES
— W —	PROPOSED WATER

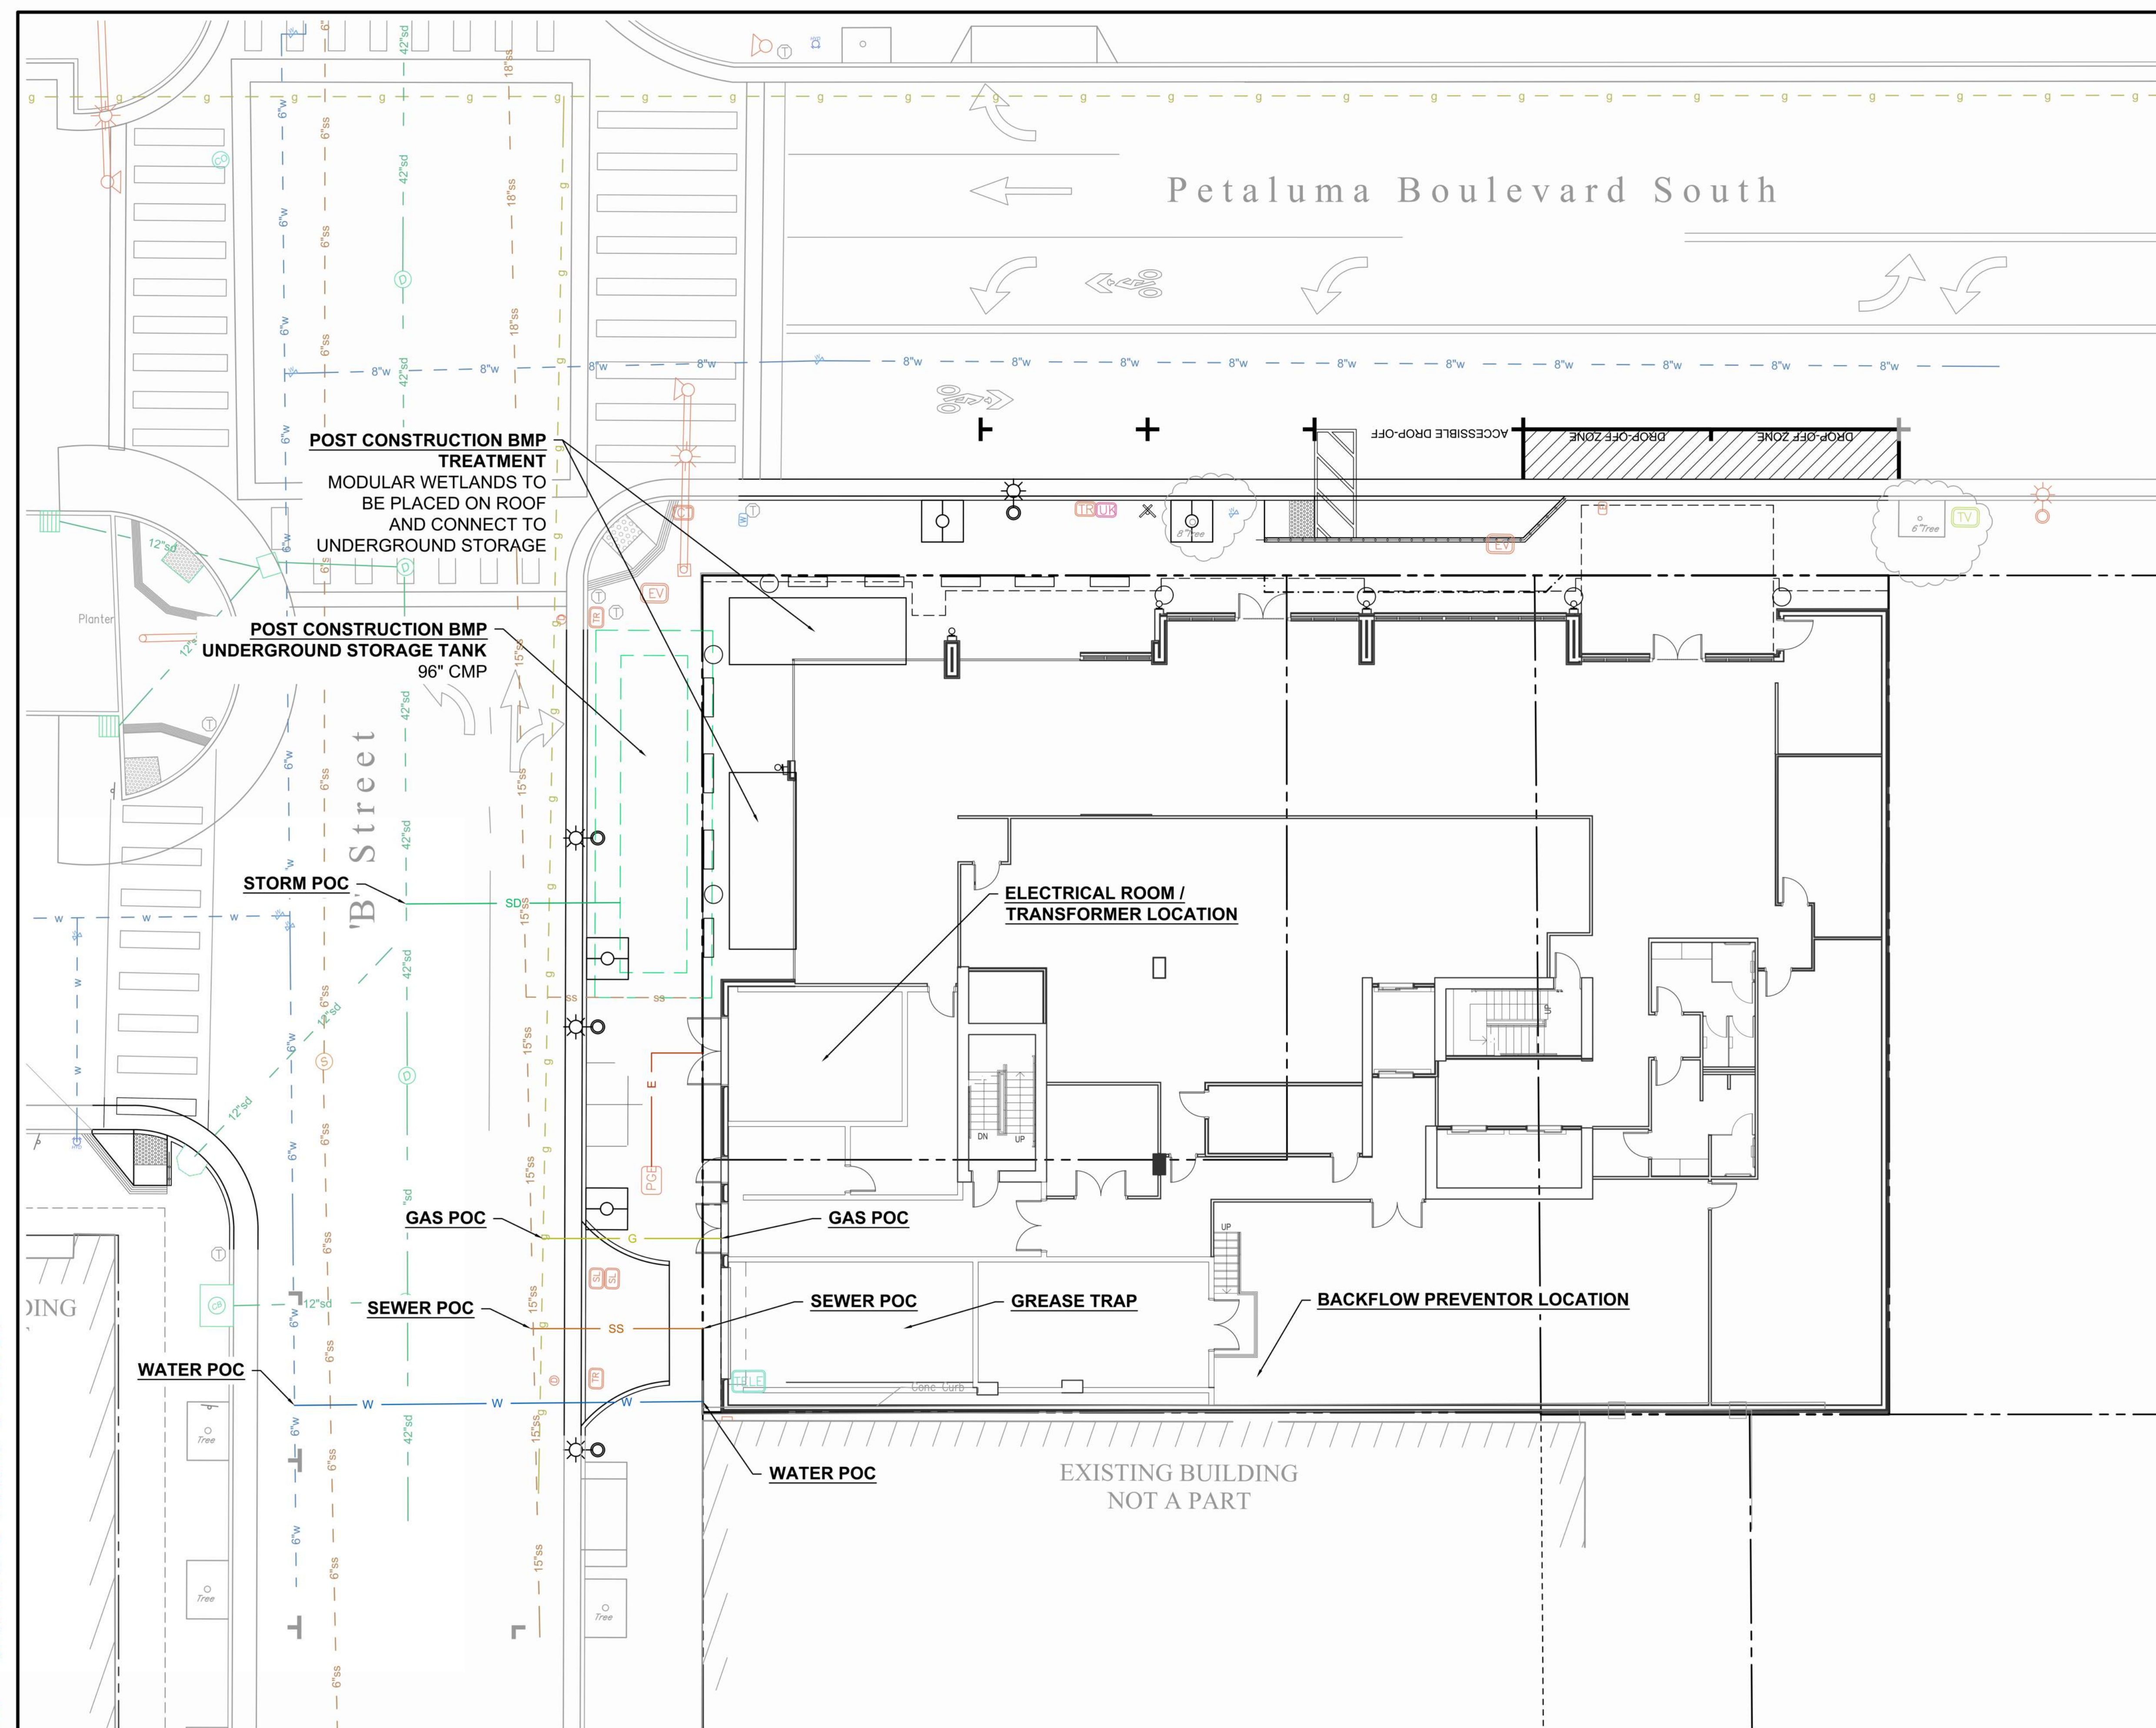

**NOT FOR CONSTRUCTION**

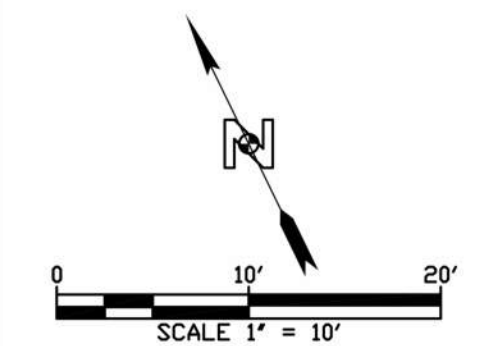

NO.	DATE	REVISION DESCRIPTION	BY	DATE

**DIGALERT**  
DIAL TOLL FREE  
**811**  
AT LEAST TWO DAYS  
BEFORE YOU DIG  
UNDERGROUND SERVICE ALERT OF SOUTHERN CALIFORNIA

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**SURVEYOR'S BENCHMARK:**  
FOUND 3" BRASS DISK SET IN THE TOP OF A SANDSTONE WALL AT THE FOURTH STREET POST OFFICE, 0.3' ABOVE THE GROUND, STAMPED "12 045 JJ 107 1932", ELEVATION=15.20', NAVD88 DATUM (PER NGS DATASHEET). A CONVERSION FACTOR OF -2.795 SHOULD BE USED TO CONVERT NAVD88 ELEVATIONS TO NGVD29 ELEVATION.  
**BASIS OF BEARINGS:**  
192 MAPS 26, SCR.

**N CONSULTING ENGINEERS**  
17780 Fitch  
Irvine, CA 92614  
PHONE: 949.396.1161  
www.nconsulting.com

ISSUE: \_\_\_\_\_  
PROJECT ADDRESS: 2 PETALUMA BLVD  
PETALUMA, CA 94952  
CLIENT: EKN DEVELOPMENT GROUP  
220 NEWPORT CENTER DRIVE, SUITE 11-262  
NEWPORT BEACH, CA 92660

SITE: EKN PETALUMA			
TITLE: CONCEPTUAL UTILITY PLAN			
DRAWN: S.S.	SCALE AT D: 1" = 10'	DATE: 9/15/2023	PROJECT NO: 21-002
CHECKED: D.H.K.	REV: _____	COUNT: 1 OF 1 SHEETS	SHEET: EXH11

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CIVIL - CONCEPTUAL UTILITY PLAN

DRAWN BY	CHECKED BY
PROJECT NUMBER: 621010	PROJECT ABBREVIATION: PH
ORIGINAL ISSUE	DATE: 04 APRIL 2024

**EIR-1.4**  
SHEET NUMBER















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La Jolla, CA  
92037  
858 454 6909

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N CONSULTING ENGINEERS  
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Irvine, CA  
92614  
949 399 1161

EKN Petaluma LLC  
EKN APPELLATION  
2 Petaluma Blvd South  
Petaluma, California

NOTES

1. ALL PLANT MATERIALS TO BE IN ACCORDANCE WITH THE AMERICAN STANDARD FOR NURSERY STOCK ANSI Z60.1.
2. ALL PLANT SIZES NOTED ON THE PLANT SCHEDULE ARE MINIMUM SPECIFICATIONS, AND ARE TO BE INCREASED IF NECESSARY TO CONFORM TO PLANT SIZE AND SPECIFICATIONS.
3. ALL LANDSCAPED AREAS TO RECEIVE ORGANIC SOIL PREPARATION WITH COMPOST AT THE RATE OF 4 CU. YD. / 1,000 SF AND INCORPORATED TO A DEPTH OF SIX INCHES. SOIL AMENDMENTS TO BE INCORPORATED ACCORDING TO RECOMMENDATIONS OF THE REQUIRED SOILS REPORT AND AS APPROPRIATE FOR THE SPECIFIC PLANTS SPECIFIED.
4. A MINIMUM THREE-INCH LAYER OF MULCH TO BE APPLIED ON ALL EXPOSED SOIL SURFACES OF PLANTING AREAS EXCEPT IN TURF AREAS, CREEPING OR ROOTING GROUNDCOVERS, OR AS NOTED ON PLANS.
5. ALL LANDSCAPED AREAS AND PLANT MATERIALS TO BE WATERED BY AN AUTOMATIC UNDERGROUND IRRIGATION SYSTEM. IRRIGATION SYSTEM DESIGN, INSTALLATION, OPERATION AND MAINTENANCE TO CONFORM TO REQUIREMENTS FOUND IN THE MUNICIPAL CODE CHAPTER 15.17 - WATER CONSERVATION REGULATIONS.
6. ALL LANDSCAPING SHALL BE MAINTAINED IN HEALTHY GROWING CONDITION BY THE PERMIT HOLDER FOR A PERIOD OF 90 DAYS AFTER RECEIVING AN OCCUPANCY PERMIT. SUCH MAINTENANCE SHALL INCLUDE, WHERE APPROPRIATE, PRUNING, MOWING, WEEDING, CLEANING OF DEBRIS AND TRASH, FERTILIZING AND REGULAR WATERING. WHENEVER NECESSARY, PLANTING SHALL BE REPLACED WITH OTHER PLANT MATERIALS TO ENSURE CONTINUED COMPLIANCE WITH APPLICABLE LANDSCAPING REQUIREMENTS. REQUIRED IRRIGATION SYSTEMS SHALL BE FULLY MAINTAINED IN SOUND OPERATING CONDITION WITH HEADS PERIODICALLY CLEANED AND REPLACED WHEN MISSING TO ENSURE CONTINUED REGULAR WATERING OF LANDSCAPE AREAS, AND HEALTH AND VIABILITY OF LANDSCAPE MATERIALS.
7. HERBICIDES/PESTICIDES SHALL NOT BE APPLIED IN AREAS USED BY PEDESTRIANS/BICYCLISTS WITHIN THE PROJECT WITHOUT FIRST PROVIDING APPROPRIATE SIGNS WARNING OF THE USE OF CHEMICALS. THE PROJECT SHALL UTILIZE BEST MANAGEMENT PRACTICES (BMP'S) REGARDING PESTICIDE/HERBICIDE USE AND AS WELL AS INTEGRATED PEST MANAGEMENT TECHNIQUES FOR THE PROTECTION OF BICYCLISTS AND PEDESTRIANS.
8. ALL TREE STAKES AND TIES SHALL BE REMOVED WITHIN ONE YEAR FOLLOWING INSTALLATION OR AS SOON AS TREES ARE ABLE TO STAND ERECT WITHOUT SUPPORT.
9. PRIOR TO PUBLIC IMPROVEMENT PLAN APPROVAL, REGARDING STREET TREES, THE PLAN SET SHALL:
  - 1) PROVIDE STRUCTURAL SOILS WITHIN ALL TREE WELLS, AND UNDER THE SIDEWALKS FOR A SIX-FOOT MINIMUM DISTANCE BEYOND ANY TREE WELL, FOR A 24-INCH MINIMUM DEPTH, AND FOR A LENGTH OF AT LEAST 8 FEET CENTERED ON EACH STREET TREE, AND
  - 2) NOTE IRRIGATION, WALK-ON MULCH, AND ROOT BARRIERS WHERE APPROPRIATE.

IRRIGATION SYSTEM INTENT

THE PRIMARY GOAL OF THE DESIGN OF THE IRRIGATION SYSTEM IS FOR A SYSTEM THAT WILL IRRIGATE THE PLANT MATERIALS WITH FOCUS ON WATER CONSERVATION TECHNOLOGIES AND SYSTEM EFFICIENCY TO GIVE THE OWNER A SYSTEM THAT MINIMIZES WATER CONSUMPTION AND MINIMAL MAINTENANCE COST, WHILE STILL PRELIMINARY IN NATURE AND AS YET NOT DESIGNED. THE SYSTEM WILL BE DESIGNED PER CITY OF PETALUMA STANDARDS AND REGULATIONS AND WILL FEATURE THE FOLLOWING:


1. POINT OF CONNECTION IS EXPECTED TO BE FROM A CITY WATER MAINLINE LOCATED IN EITHER PETALUMA BOULEVARD OR B STREET, WITH A PIPING INFRASTRUCTURE THAT WILL BE DESIGNED TO SUPPLY WATER TO ALL PLANTING AREAS THAT WILL REQUIRE IRRIGATION.
2. THE AUTOMATIC IRRIGATION CONTROLLER WILL BE AN ET BASED CENTRAL CONTROL SYSTEM THAT WILL UTILIZE EVAPOTRANSPIRATION OR SOIL MOISTURE SENSOR DATA AND UTILIZE A RAIN SENSOR.
3. PRESSURE REGULATORS WILL BE INSTALLED TO ENSURE DYNAMIC PRESSURE OF THE SYSTEM IS WITHIN MANUFACTURER'S RECOMMENDED PRESSURE RANGE.
4. MANUAL SHUT-OFF VALVES WILL BE INSTALLED AS CLOSE AS POSSIBLE TO THE POINT OF CONNECTION, TO MINIMIZE WATER LOSS IN CASE OF AN EMERGENCY, SUCH AS A MAINLINE BREAK, OR ROUTINE REPAIR.
5. A BACKFLOW PREVENTION DEVICE WILL BE INSTALLED TO PROTECT THE WATER SUPPLY FROM CONTAMINATION BY THE IRRIGATION SYSTEM.
6. FLOW SENSORS WILL BE INSTALLED, TO ALLOW DETECTION OF HIGH FLOW CONDITIONS CREATED BY SYSTEM DAMAGE OR MALFUNCTIONS.
7. ALL IRRIGATION EMISSION DEVICES WILL MEET THE REQUIREMENTS PER ANSI STANDARD ASABE/ICC 802-2014 "LANDSCAPE IRRIGATION SPRINKLER AND EMITTER STANDARD".
8. THE DESIGN OF THE IRRIGATION SYSTEM WILL UTILIZE HYDROZONES PER THE LANDSCAPE PLAN.
9. ALL PLANTING AREAS LOCATED WITHIN ABOVE GRADE PLANTERS AT BOTH THE STREET LEVEL AND THE AMENITY DECKS WILL BE IRRIGATED WITH A SUB-SURFACE DRIP SYSTEM. TREES LOCATED WITHIN THESE PLANTERS MAY ALSO FEATURE A BUBBLE OR DRIP TREE-RING SYSTEM, IF NECESSARY TO SUPPLEMENT WATER TO THE TREES.
10. TREES LOCATED AT THE STREET EDGE WITHIN TREE GRATES WILL BE IRRIGATED WITH EITHER A BUBBLE OR DRIP TREE-RING SYSTEM.

SITE LEGEND (THIS SHEET)

CODE	DESCRIPTION
<b>PAVING</b>	
(P4)	PRECAST CONCRETE PAVEMENT - TYPE 3 (ACCENT, SQUARE, ON PEDESTAL)
(P7)	PRECAST CONCRETE PAVEMENT - TYPE 5 (FIELD, RECTANGULAR, ON PEDESTAL)
(P8)	WOOD TILE PAVEMENT (ACCENT, RECTANGULAR, ON PEDESTAL)
<b>PLANTERS</b>	
(PL1)	FREESTANDING PLANTER - TYPE 1 (METAL, RECTANGULAR)
(PL2)	FREESTANDING PLANTER - TYPE 2 (FIBERGLASS, ROUND)
(PL3)	BUILT-IN PLANTER (METAL, RECTANGULAR)
<b>SITE LIGHTING</b>	
(L1)	BOLLARD
(L2)	UPLIGHT



PRELIMINARY WATER CALCULATIONS

Hydrozone # / Planting descriptions	Plant Factor (PF)	Irrigation Method	Irrigation Efficiency (IE)	ETAF (PF/IE)	Landscape Area (Sq. Ft.)	ETAF x Area	Estimated Total Water Use (ETWU)
<b>Regular Landscape Area</b>							
LOW	0.3	Drip	0.81	0.37	1,363	505	12,394
MED/ML	0.5	Drip	0.81	0.62	190	99	2,425
HIGH	0.7	Drip	0.81	0.86	-	-	-
Regular Landscape Area Totals:						1,523	604
<b>Special Landscape Area</b>							
Special Landscape Area Totals:						0	0
<b>ETWU Total:</b>						1,523	14,819
<b>Maximum Allowed Water Allowance (MAWA)</b>							
<b>Over All Landscape Area Totals:</b>						1,523	16,827

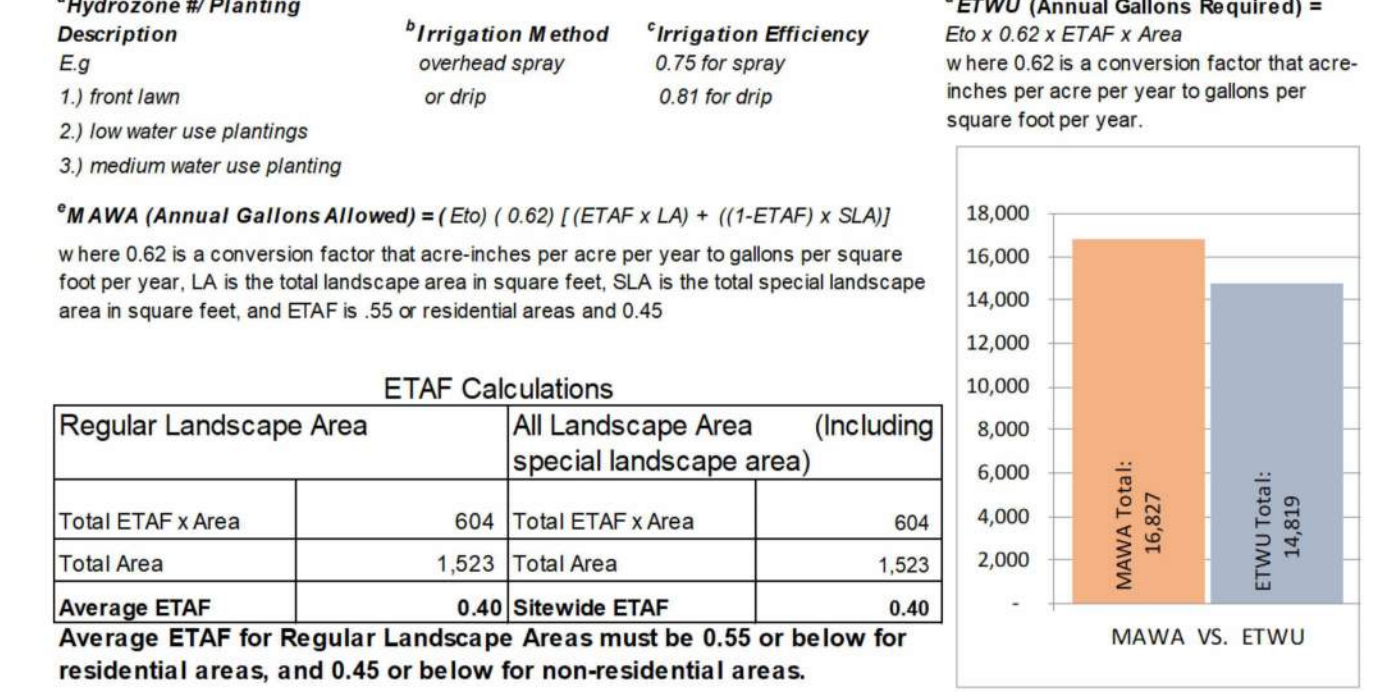

PLANT SCHEDULE (THIS SHEET)

TREES	CODE	QTY	BOTANICAL / COMMON NAME	SIZE	WATER USE
(LA)	LA	4	LUMA APICULATA CHILEAN MYRTLE	15 GAL.	MED
<b>SHRUB AREAS</b>					
(ADE)	ADE	23	AEONIUUM DECORUM PINWHEEL	1 GAL.	LOW
(CPE)	CPE	30	CRASSULA PERFORATA STRING-OF-BUTTONS	1 GAL.	LOW
(DPU)	DPU	30	DUDLEYA PULVERULENTA CHALK LETTUCE	1 GAL.	LOW
(STE)	STE	120	SEMPERVIVUM TECTORUM HEN-AND-CHICKS	1 GAL.	LOW
(SRO)	SRO	15	SENECIO ROWLEYANUS STRING OF BEADS	1 GAL.	LOW
(SSE)	SSE	23	SENECIO SERPENS BLUE CHALKSTICKS	1 GAL.	LOW
(ABG)	ABG	5	AGAVE X 'BLUE GLOW' BLUE GLOW AGAVE	1 GAL.	LOW
(SMA)	SMA	15	SENECIO MANDRALISCAE BLUE FINGERS	1 GAL.	LOW
(SRA)	SRA	15	SENECIO RADICANS STRING OF BANANAS	1 GAL.	LOW
<b>PLANTER MIX</b>					
(AYG)	AYG	21	ANIGOZANTHOS X 'YELLOW GEM' YELLOW GEM KANGAROO PAW	1 GAL.	LOW
(KUV)	KUV	21	KNIPHOFIA UVARIA RED HOT POKER	1 GAL.	LOW
(PDD)	PDD	10	PHORMIUM X 'DARK DELIGHT' DARK DELIGHT PURPLE FLAX	5 GAL.	LOW
(PTW)	PTW	10	PITTIOSPORUM TOBIIRA 'WHEELER'S DWARF' WHEELER'S DWARF PITTIOSPORUM	5 GAL.	LOW
(WFR)	WFR	10	WESTRINGIA FRUTICOSA 'WES05' TM MUNDI COAST ROSEMARY	5 GAL.	LOW

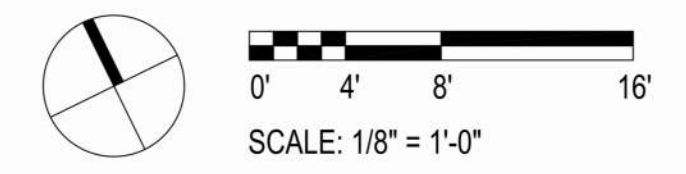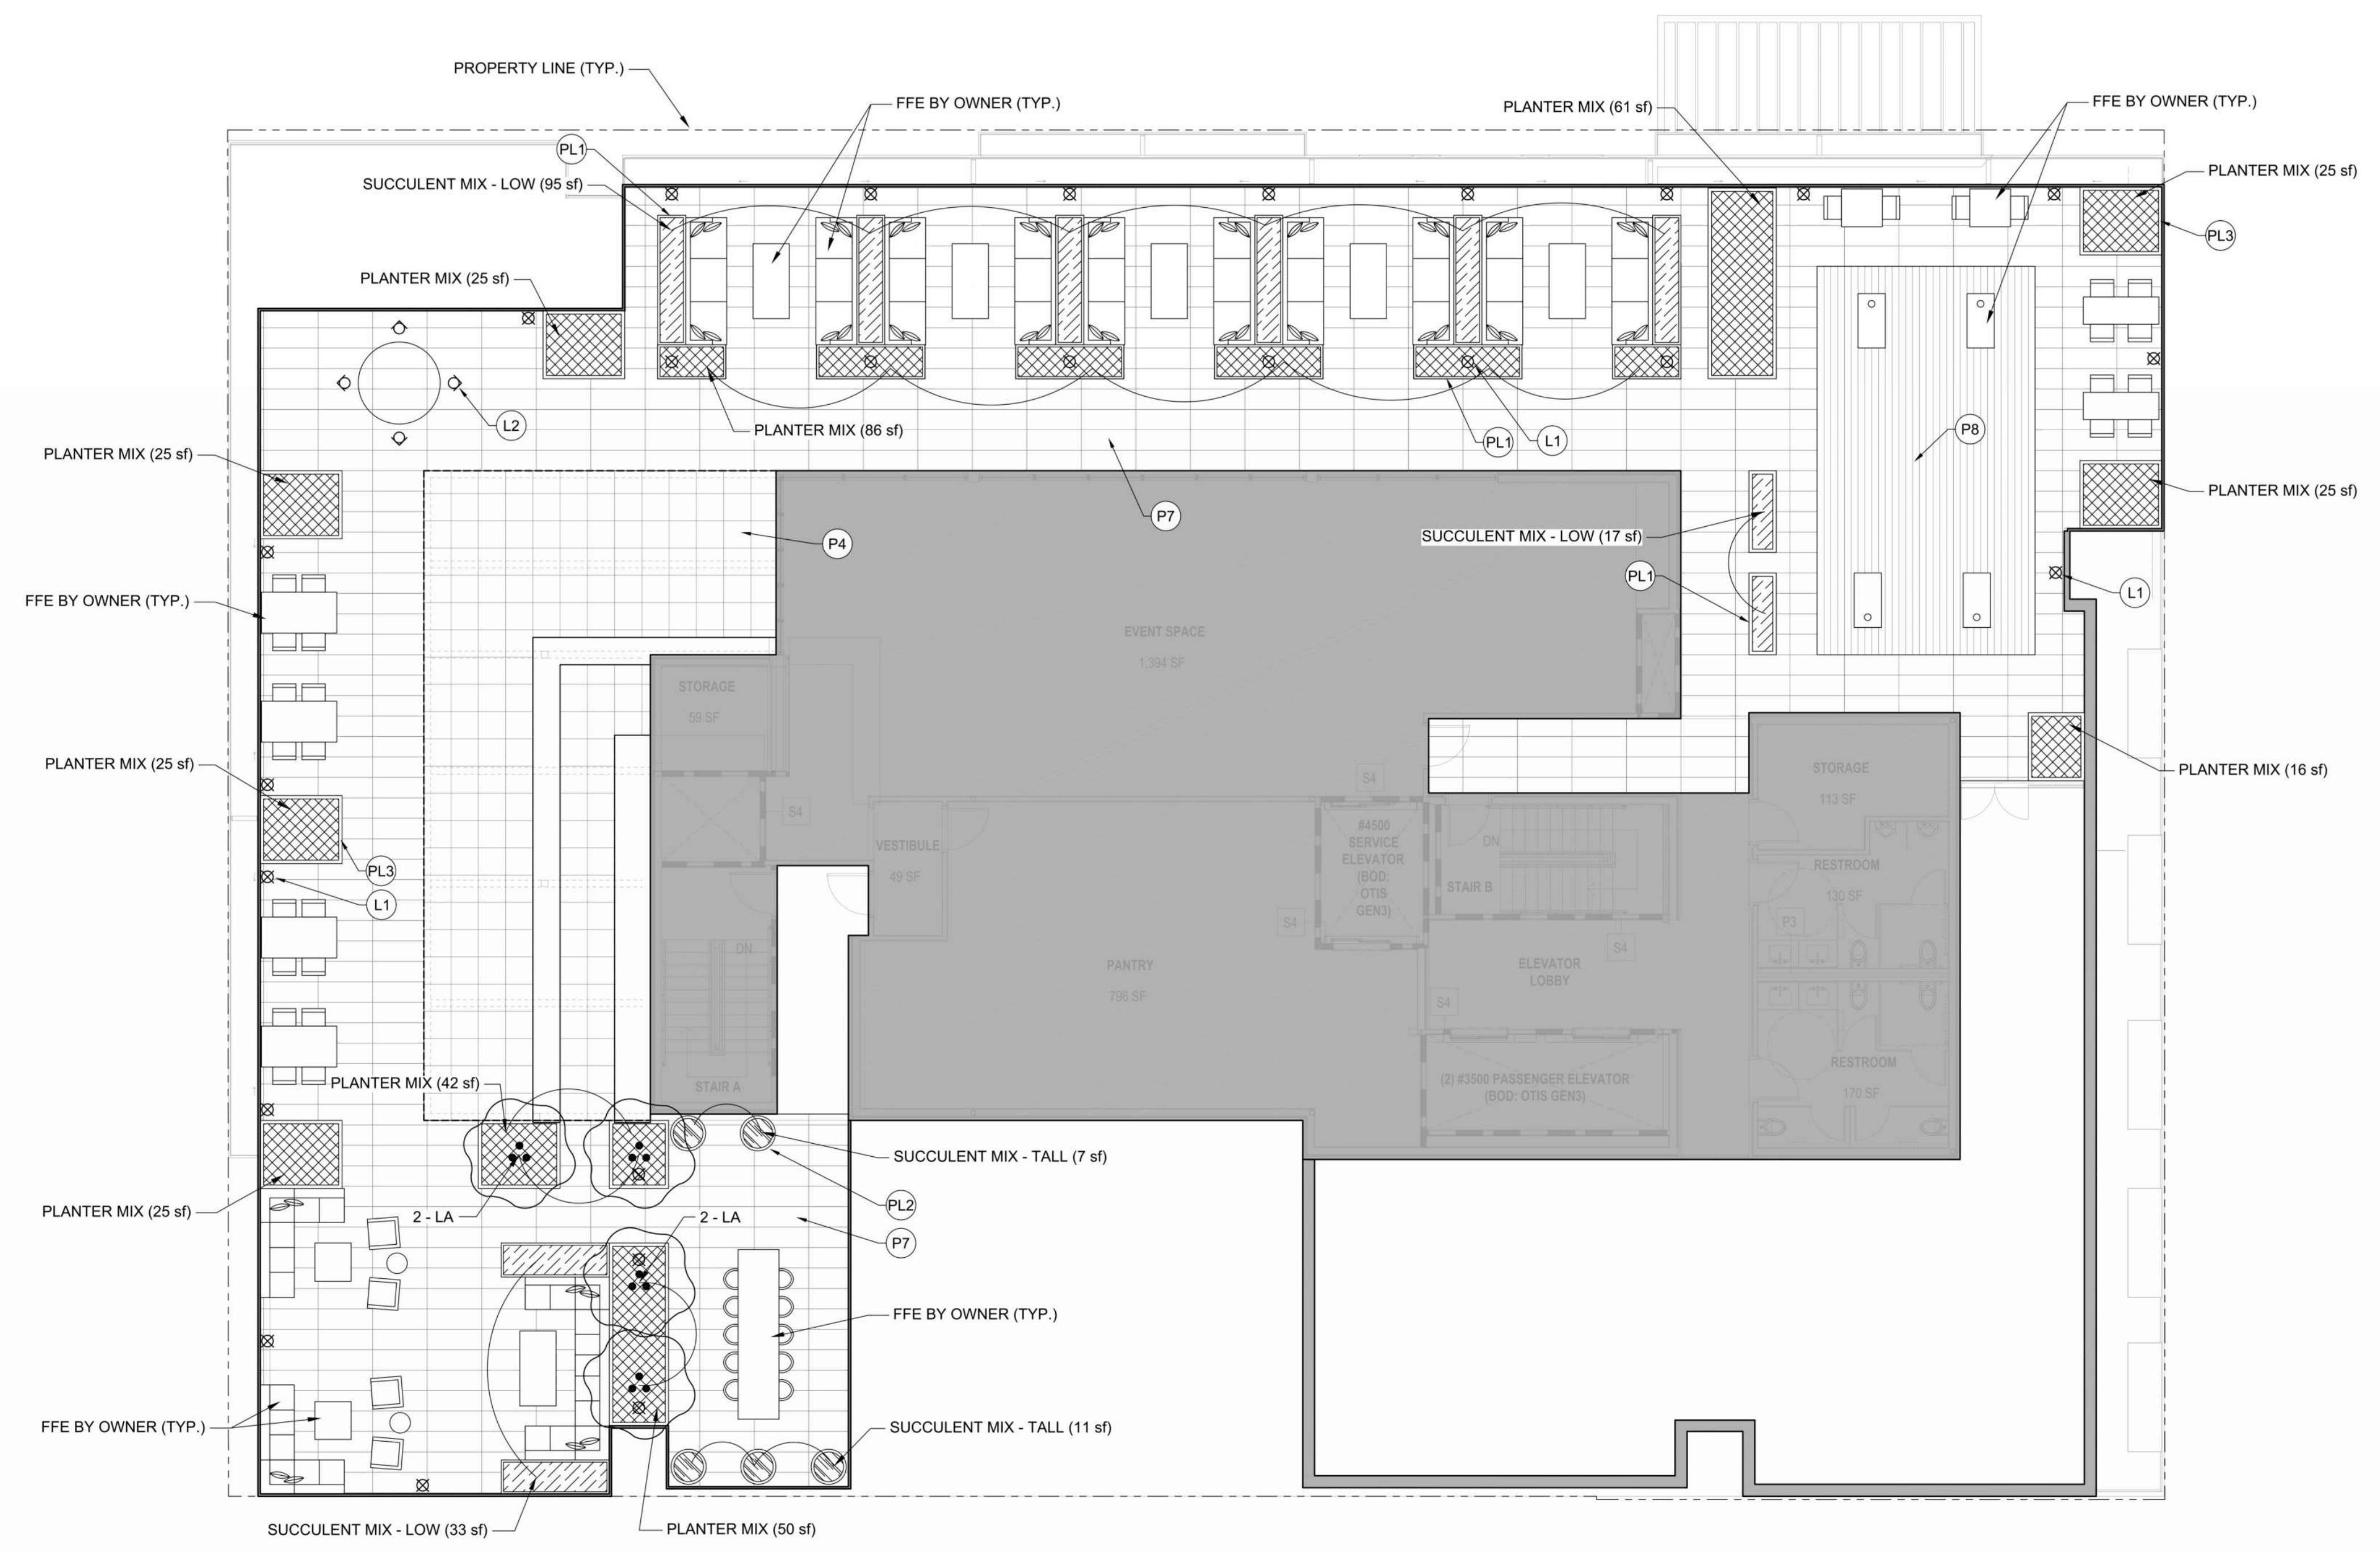

REVISION HISTORY

REVISION	DESCRIPTION	DATE
1	INTERIM REVIEW	

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SITE LANDSCAPE PLAN - LEVEL 06

DRAWN BY	CHECKED BY
PROJECT NUMBER: 621010	PROJECT ABBREVIATION: PH
ORIGINAL ISSUE: EIR SUPPLEMENT	DATE: 04 APRIL 2024

EIR-1.8  
SHEET NUMBER











**EKN Petaluma LLC**  
**EKN APPELLATION**  
 2 Petaluma Blvd South  
 Petaluma, California

**EXTERIOR GENERAL NOTES**

- FOR ALL EXTERIOR MATERIALS SEE MATERIALS BOARD.
- ALL MATERIALS NEED TO BE APPROVED.

**KEYED NOTES**


NUMBER	DESCRIPTION
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**WINDOW TYPE LEYEND**

- TYPE 01: FIXED WINDOWS
  - TYPE 02: STOREFRONT.
  - TYPE 03: STACKING OPERABLE PANELS IN STOREFRONT.
  - TYPE 04: SLIDING OPERABLE PANELS IN STOREFRONT.
  - TYPE 05: FULL HEIGHT ONE SLIDING PANEL.
  - TYPE 06: SLIDING OPERABLE WALL.
- \*ALL WINDOWS TO BE IN CLEAR GLASS AND DARK BRONZE METAL.

**EXTERIOR ELEVATION LEGEND**


- CLADDING - DECORATIVE TILE 01 - DIMENSIONAL CONCRETE TILE - DARK GRAY
- CLADDING - DECORATIVE TILE 02 - DIMENSIONAL ANGLED TRIANGLE TILE - TWO TONE
- CLADDING - PORCELANOSA - MAKER ROPE
- CLADDING - PORCELANOSA - MAKER SMOKE
- GLASS - CLEAR
- CUSTOM CUT METAL PANEL - BRONZE
- CLADDING - PORCELANOSA MANHATTAN COGNAC
- METAL - DARK BRONZE
- STUCCO - COLOR TO MATCH PORCELANOSA MAKER ROPE
- DECORATIVE CORNICE TILE
- RAILING - STRUCTURAL GLASS
- DA - LIGHTING FIXTURE SCONCE - BLUE RENZO
- DB - LIGHTING FIXTURE OUTDOOR SCONCE
- CLADDING - ALUMINUM WOODGRAIN

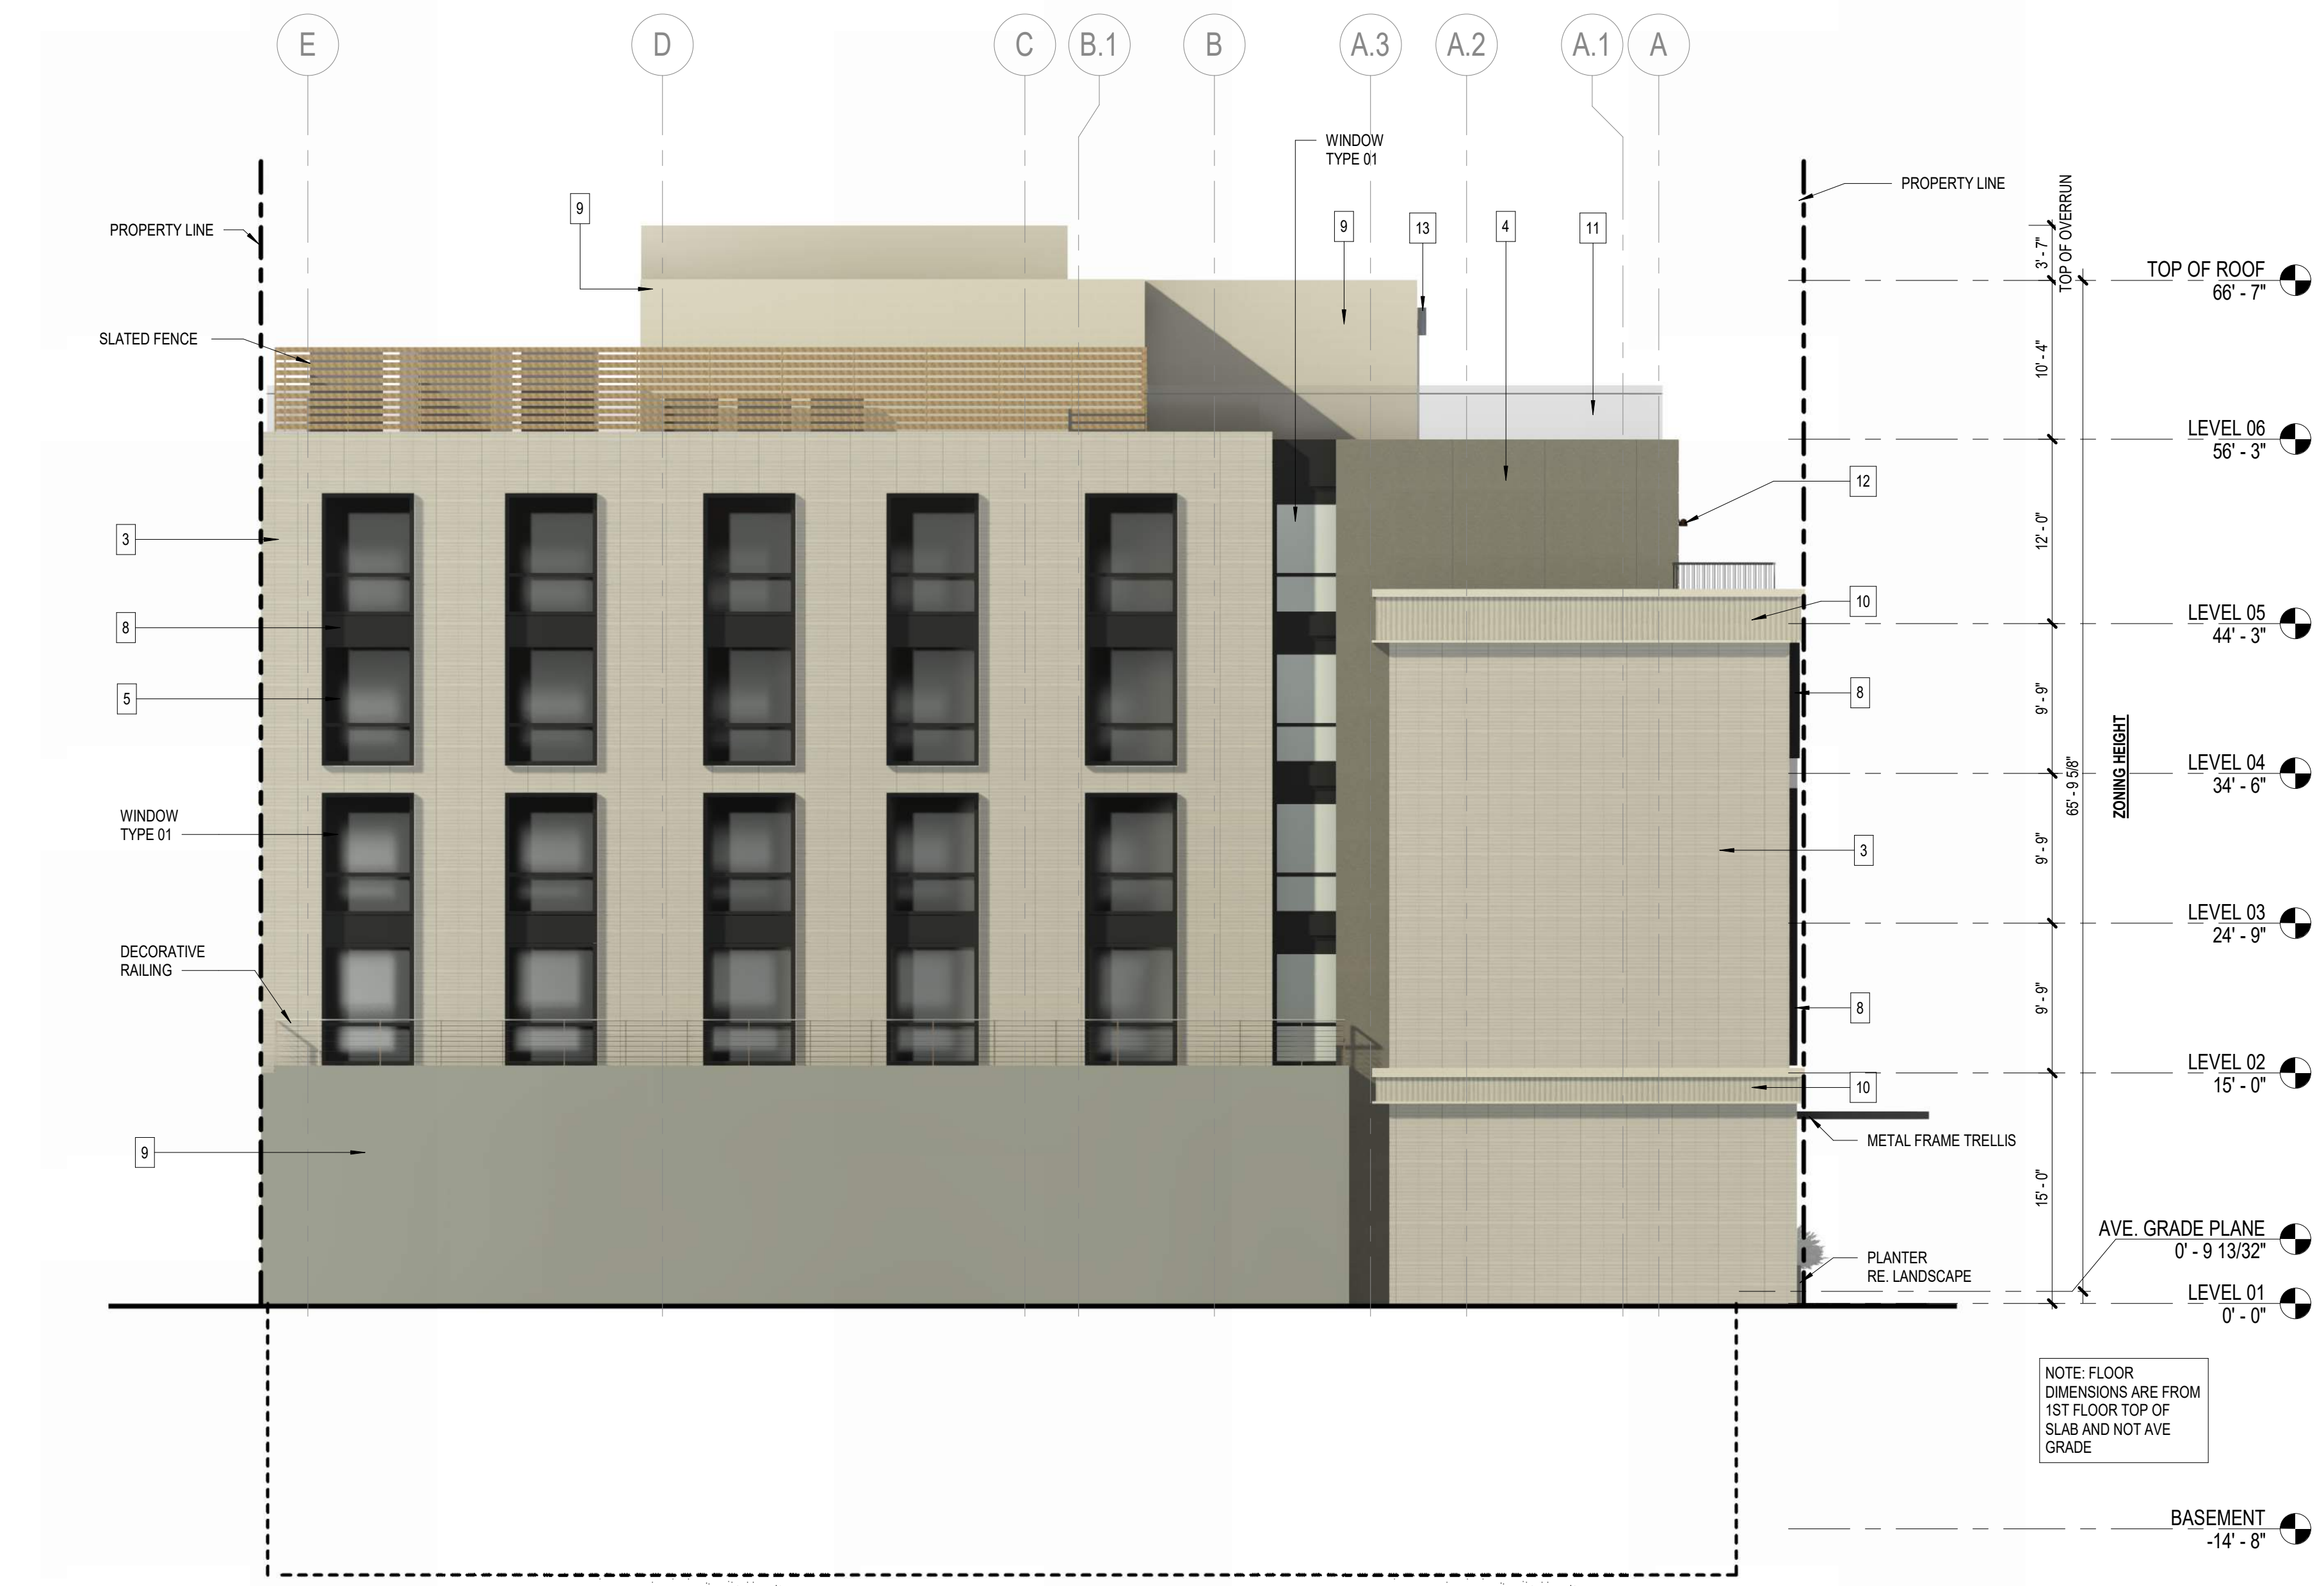

**1 ARCHITECTURAL - EAST ELEVATION**  
 SCALE: 1/8" = 1'-0"



**2 ARCHITECTURAL - SOUTH ELEVATION**  
 SCALE: 1/8" = 1'-0"

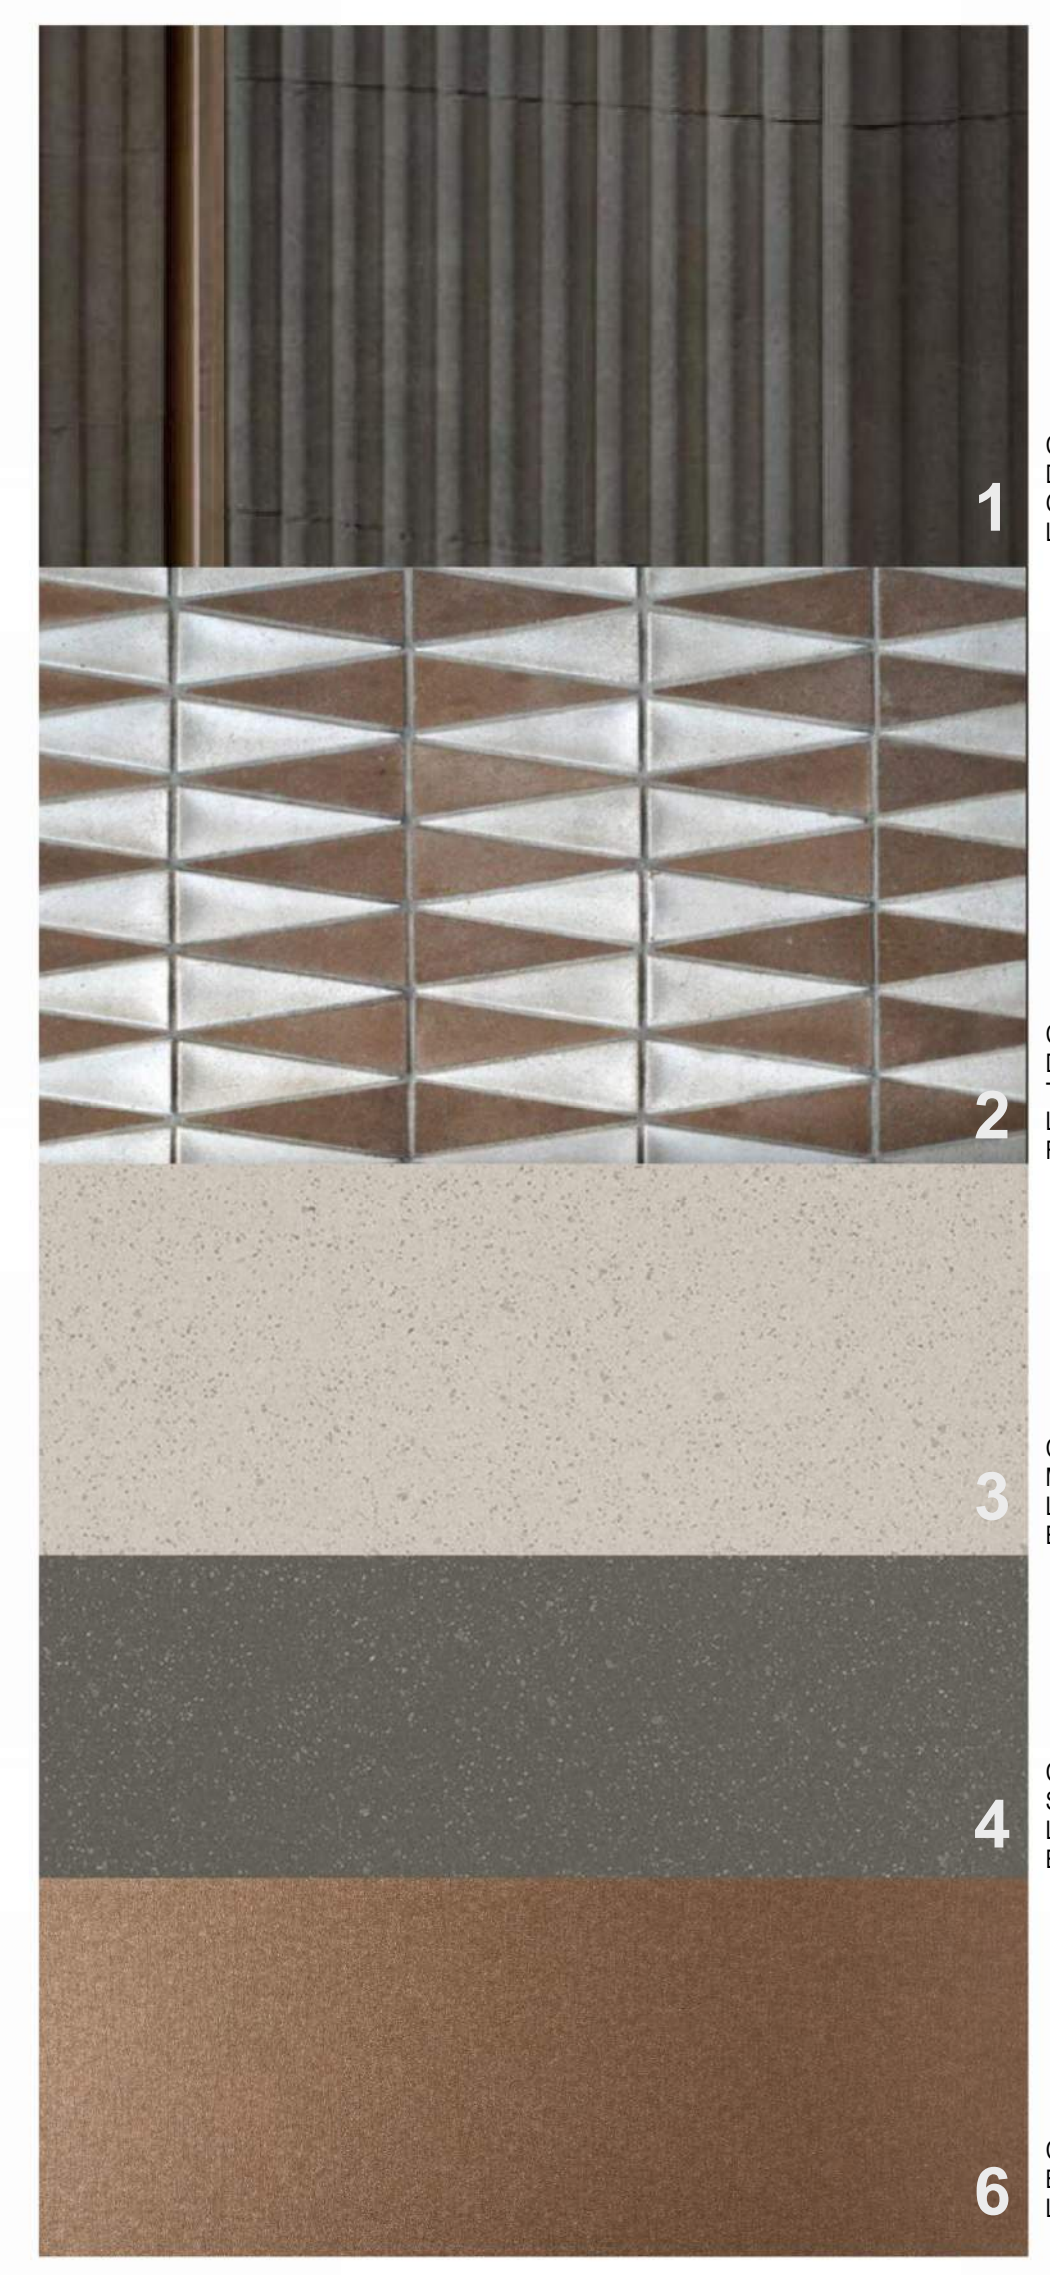

1



2



3



4



6



7



8



9



10



11



13 - DB



12 - DA

14

14

14

REVISION HISTORY

REVISION	DESCRIPTION	DATE

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ARCHITECTURAL - EXTERIOR ELEVATIONS

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