# PETALUMA FIRE STATION NO. 1 BUILDING RENOVATION PROJECT

198 D Street, Petaluma, California 94952


# PRELIMINARY DESIGN PACKAGE HISTORIC SPAR STUDY SESSION



-DOCKET-CALIF-1677-D5-

PETALUMA FIRE STATION "


PETALUMA CALIF

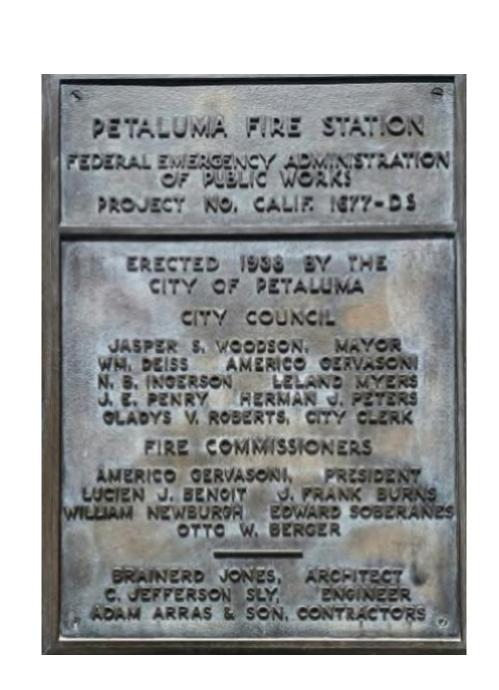

Architects MA

MARK ALBERTSON ARCHITECT

1676 CALLE RANCHERO
PETALUMA, CA 94954
TELEPHONE (707) 763-1580

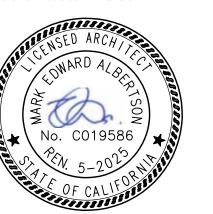



UMA FIRE STATION NO. 1 3 Renovation Project

ARCHITECT'S PROJECT 1

DRAWING STATUS:

CHECK SET: JUNE 20
PERMIT SET:
BID SET:
CONSTRUCTION SET:

REVISIONS:


SHEET NO.


© Copyright 2024 Architects MA


# PETALUMA FIRE STATION NO. 1 BUILDING RENOVATION PROJECT


198 D Street, Petaluma, California 94952


# PRELIMINARY DESIGN PACKAGE HISTORIC SPAR STUDY SESSION

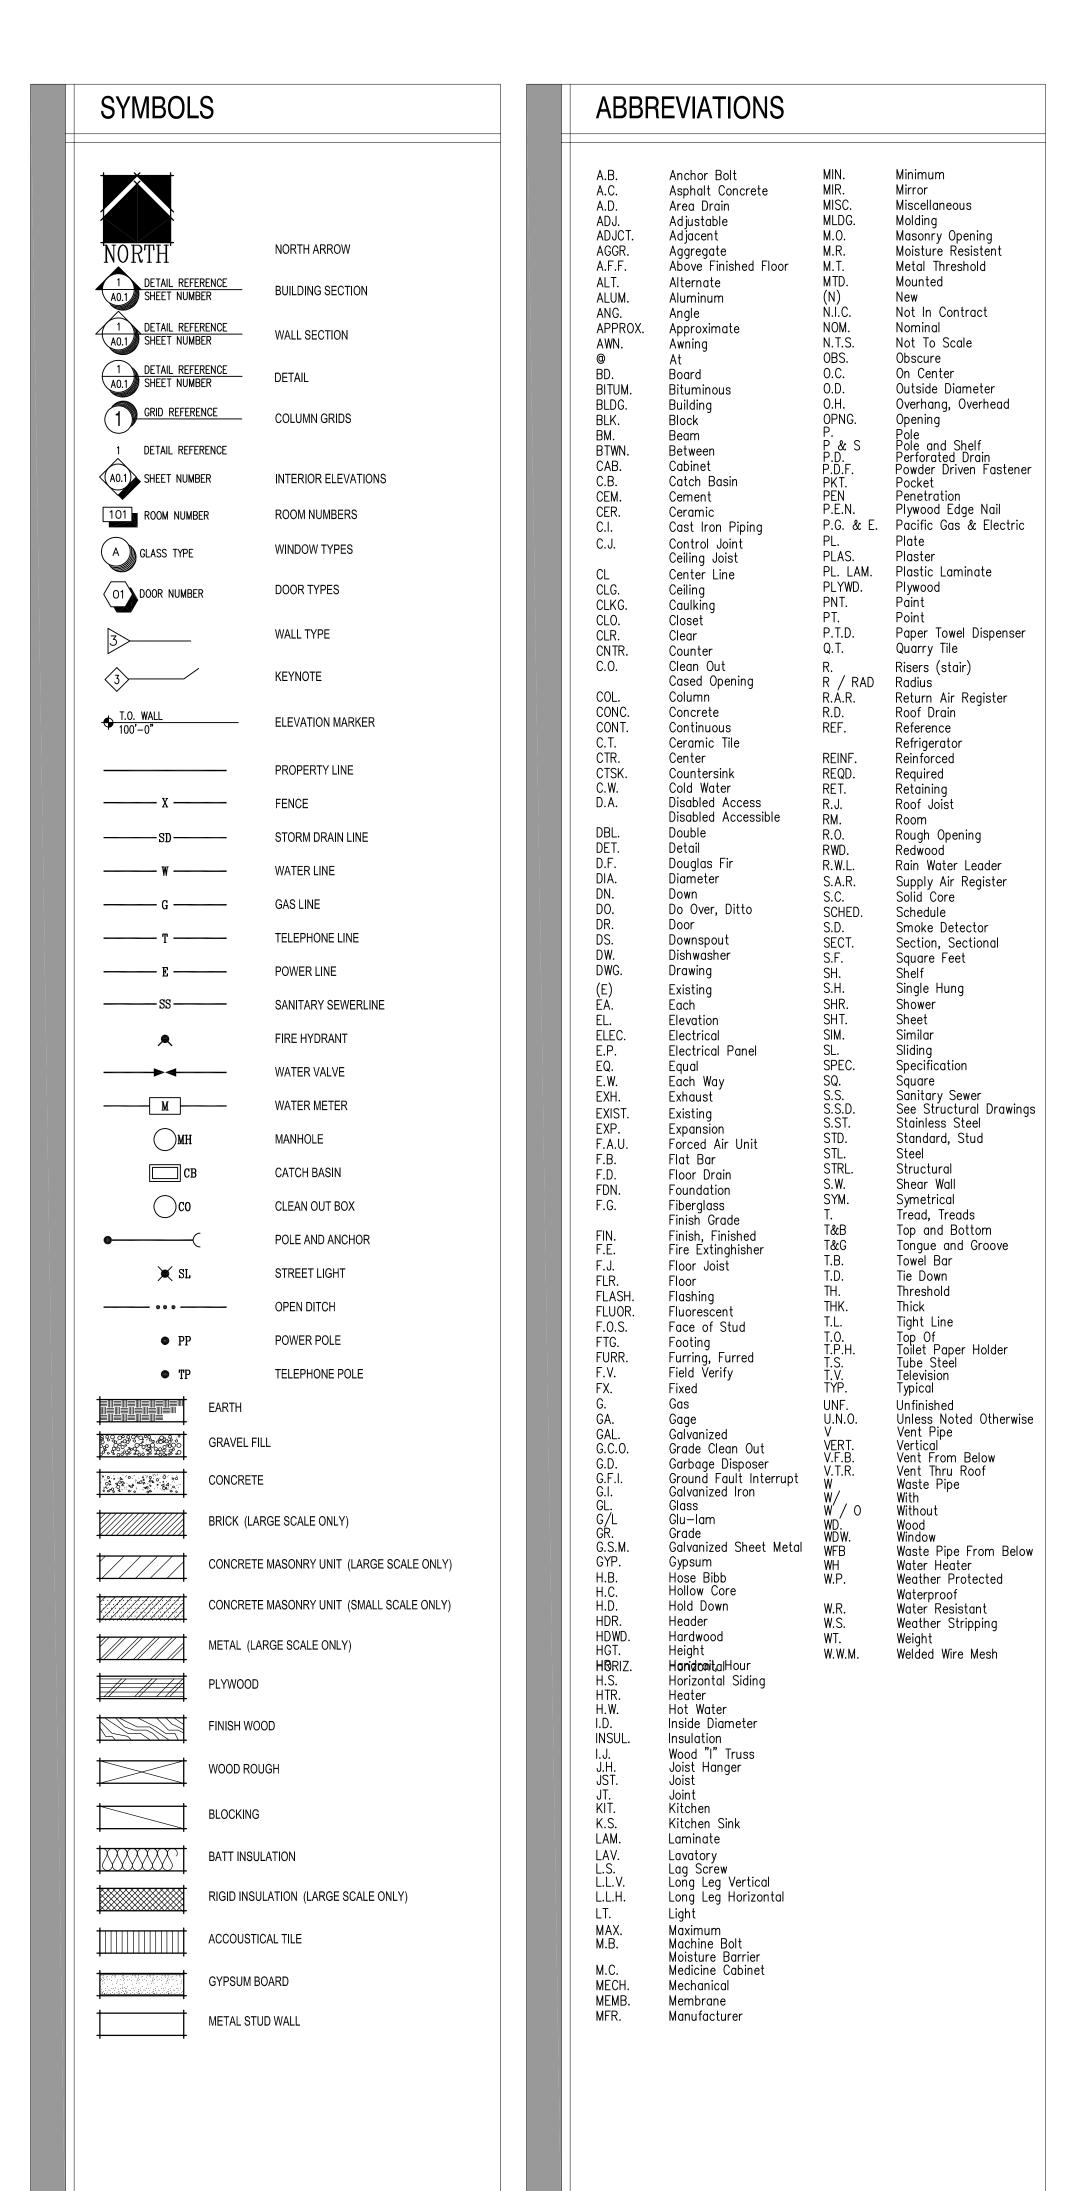


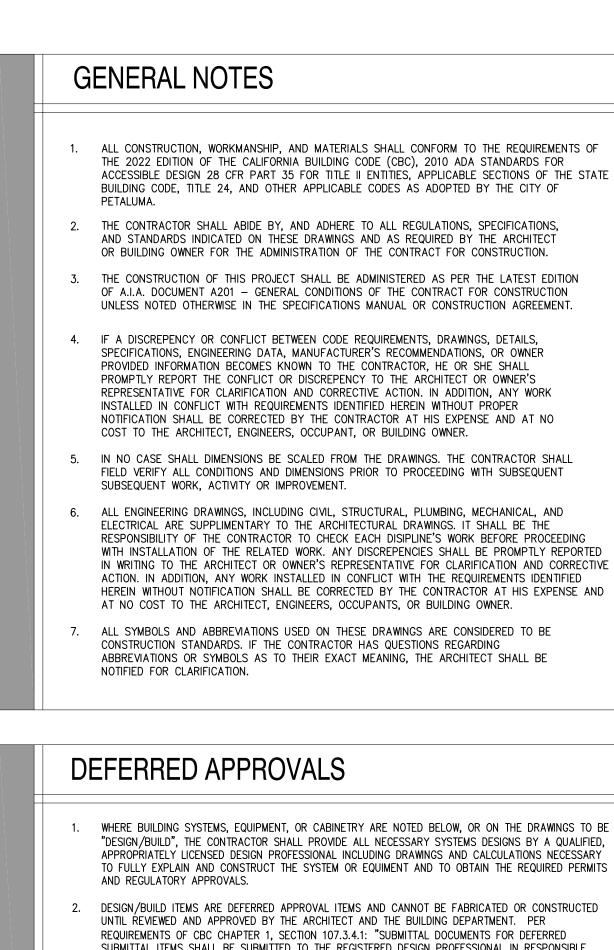


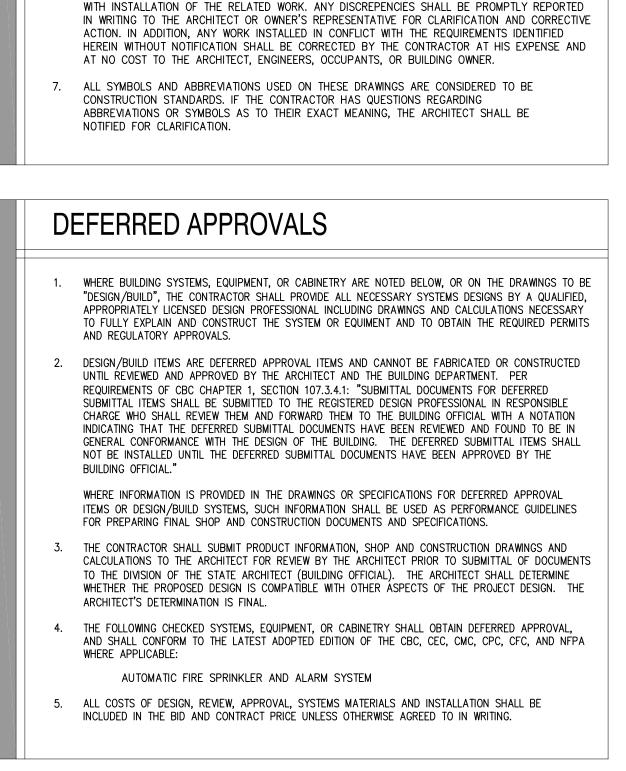

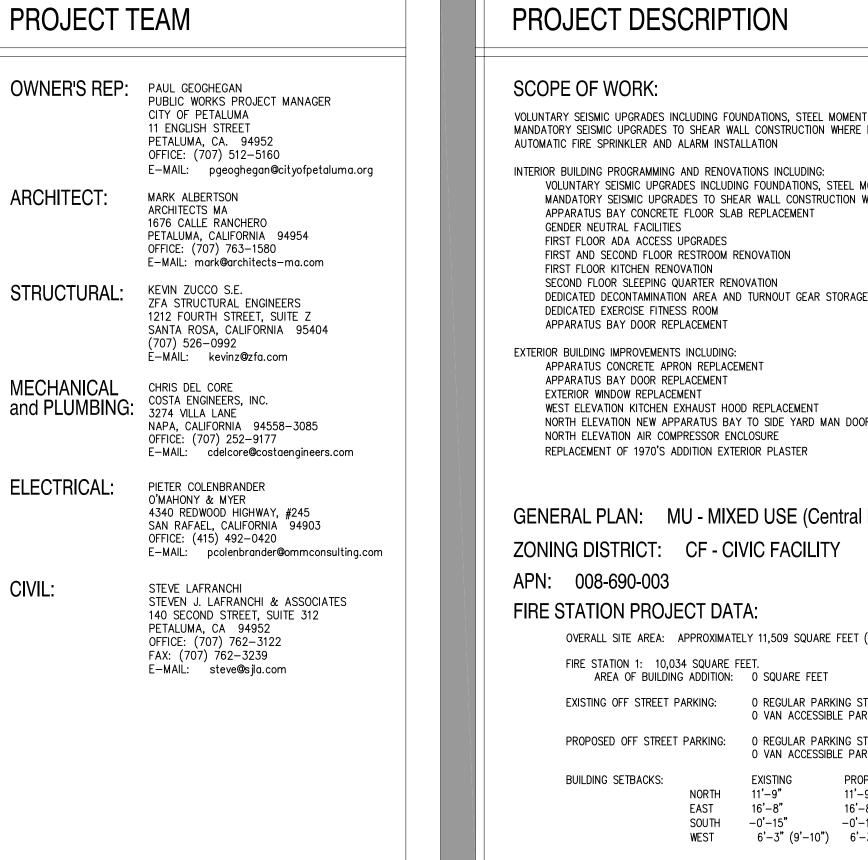


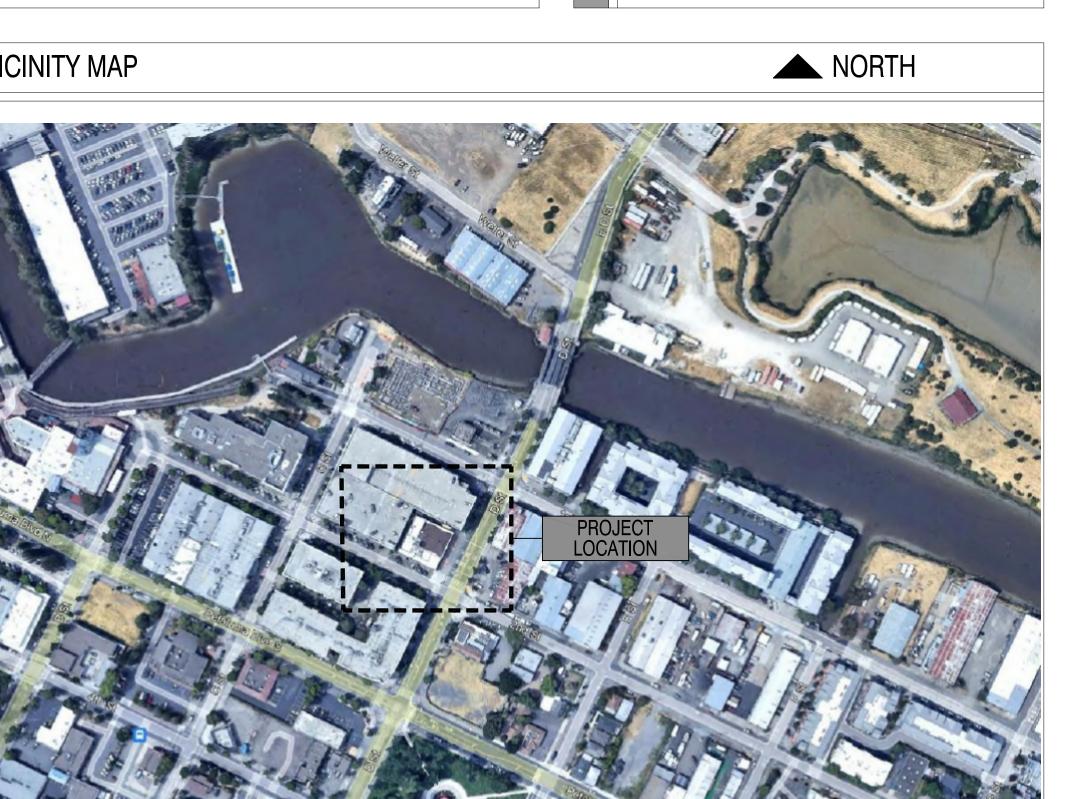

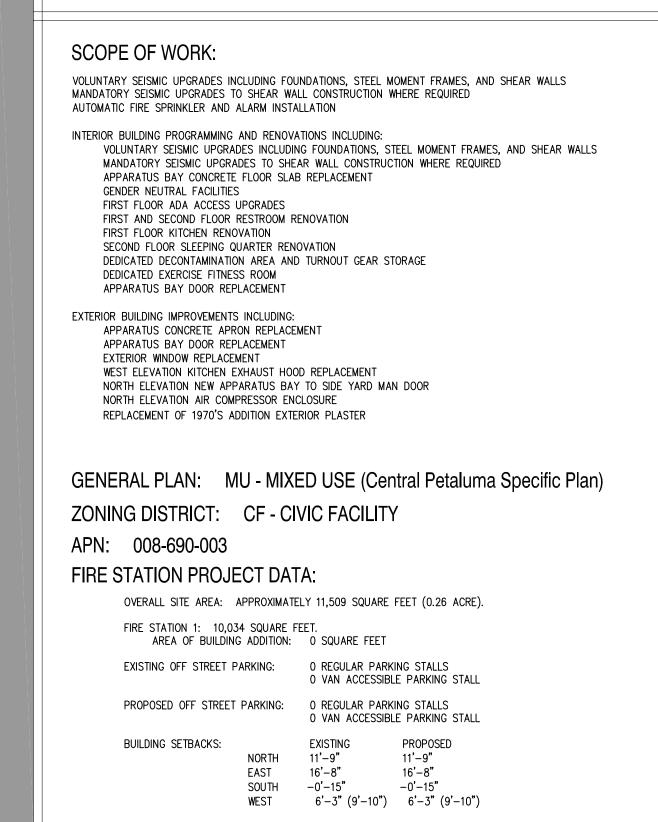

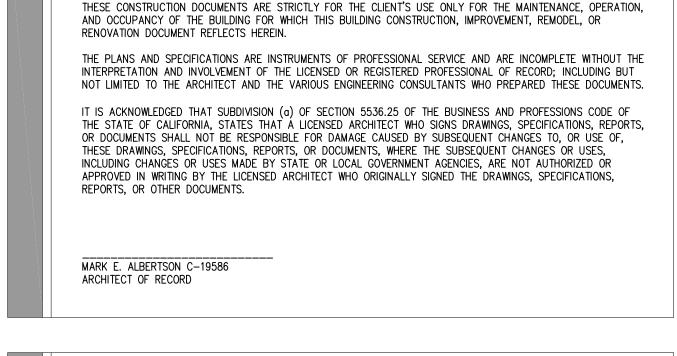

**DECLARATION** 

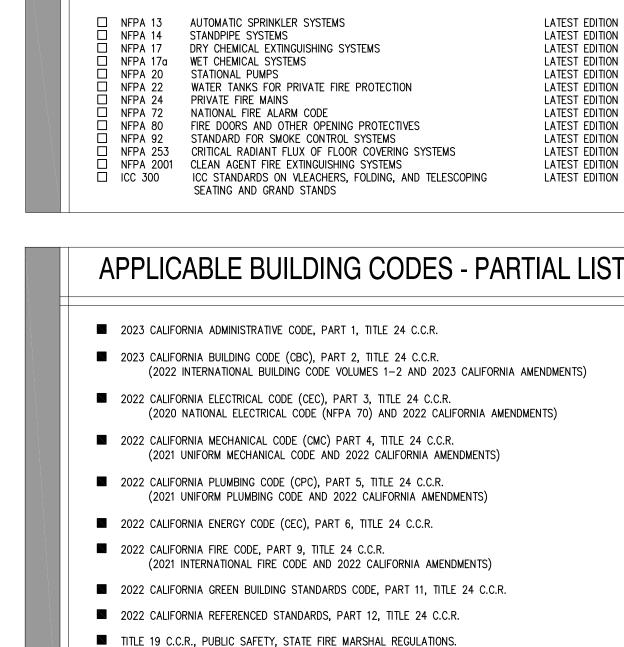


□ 2022 ASME A17.1 (with A17.1a/CSA B44a-08 ADDENDA) SAFETY CODE FOR ELEVATORS AND

☐ 2022 CALIFORNIA HEALTH AND SAFETY CODE

APPLICABLE BUILDING STANDARDS

#### **DRAWING INDEX** TO.0 COVER SHEET TO.2 PROJECT DESCRIPTION, DATA, NOTES, and DIRECTORIES TOPOGRAPHIC MAP **ARCHITECTURAL:** A0.1 EXISTING CONDITIONS and DEMOLITION SITE PLAN A0.2 NEW CONSTRUCTION SITE PLAN A1.1 EXISTING FIRST FLOOR DEMOLITION PLAN A1.2 EXISTING SECOND FLOOR DEMOLITION PLAN A1.3 PROPOSED FIRST FLOOR PLAN A1.4 PROPOSED SECOND FLOOR PLAN A2.1 EXISTING and PROPOSED EAST BUILDING ELEVATIONS A2.2 EXISTING and PROPOSED SOUTH BUILDING ELEVATIONS A2.3 EXISTING and PROPOSED WEST BUILDING ELEVATIONS A2.4 EXISTING and PROPOSED NORTH BUILDING ELEVATIONS A3.1 BUILDING SECTIONS A6.1 EXISTING TOWER AND ROOF PLAN A7.1 DOOR and WINDOW ELEVATIONS and DETAILS

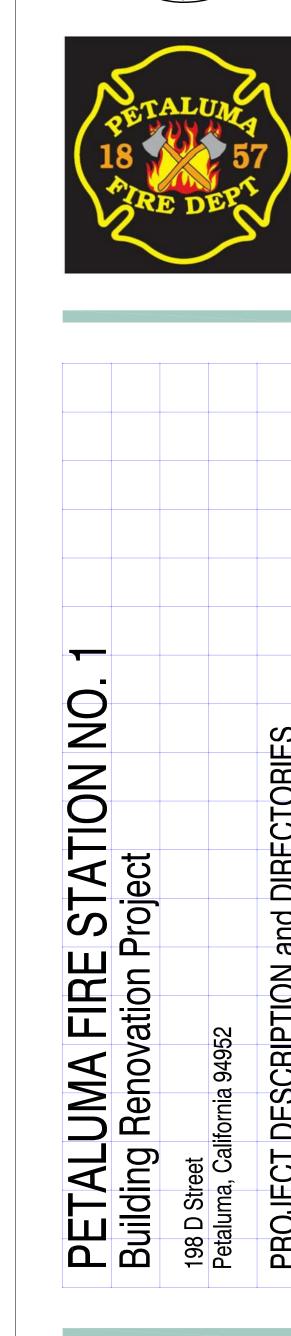

MARK ALBERTSON

1676 CALLE RANCHERO PETALUMA, CA 94954

mark@architects-ma.com

TELEPHONE (707) 763-1580

**ARCHITECT** 



PERMIT SET: CONSTRUCTION SET:

DRAWING STATUS:

ARCHITECT'S PROJECT NO:

REVISIONS:

#### **DRAWING SET**


└── PRINT DATE:


ARCHITECT CHECK SET - HISTORIC SPAR STUDY SESSION REVIEW PRINT DATE: JULY 08, 2024


PRINT DATE: CONTRACTOR BID SET V1 — SUBJECT TO PERMIT APPROVAL


CONSTRUCTION CONTRACT SET — FOR CONSTRUCTION

PERMIT SUBMITTAL SET V1 - FOR APPROVAL

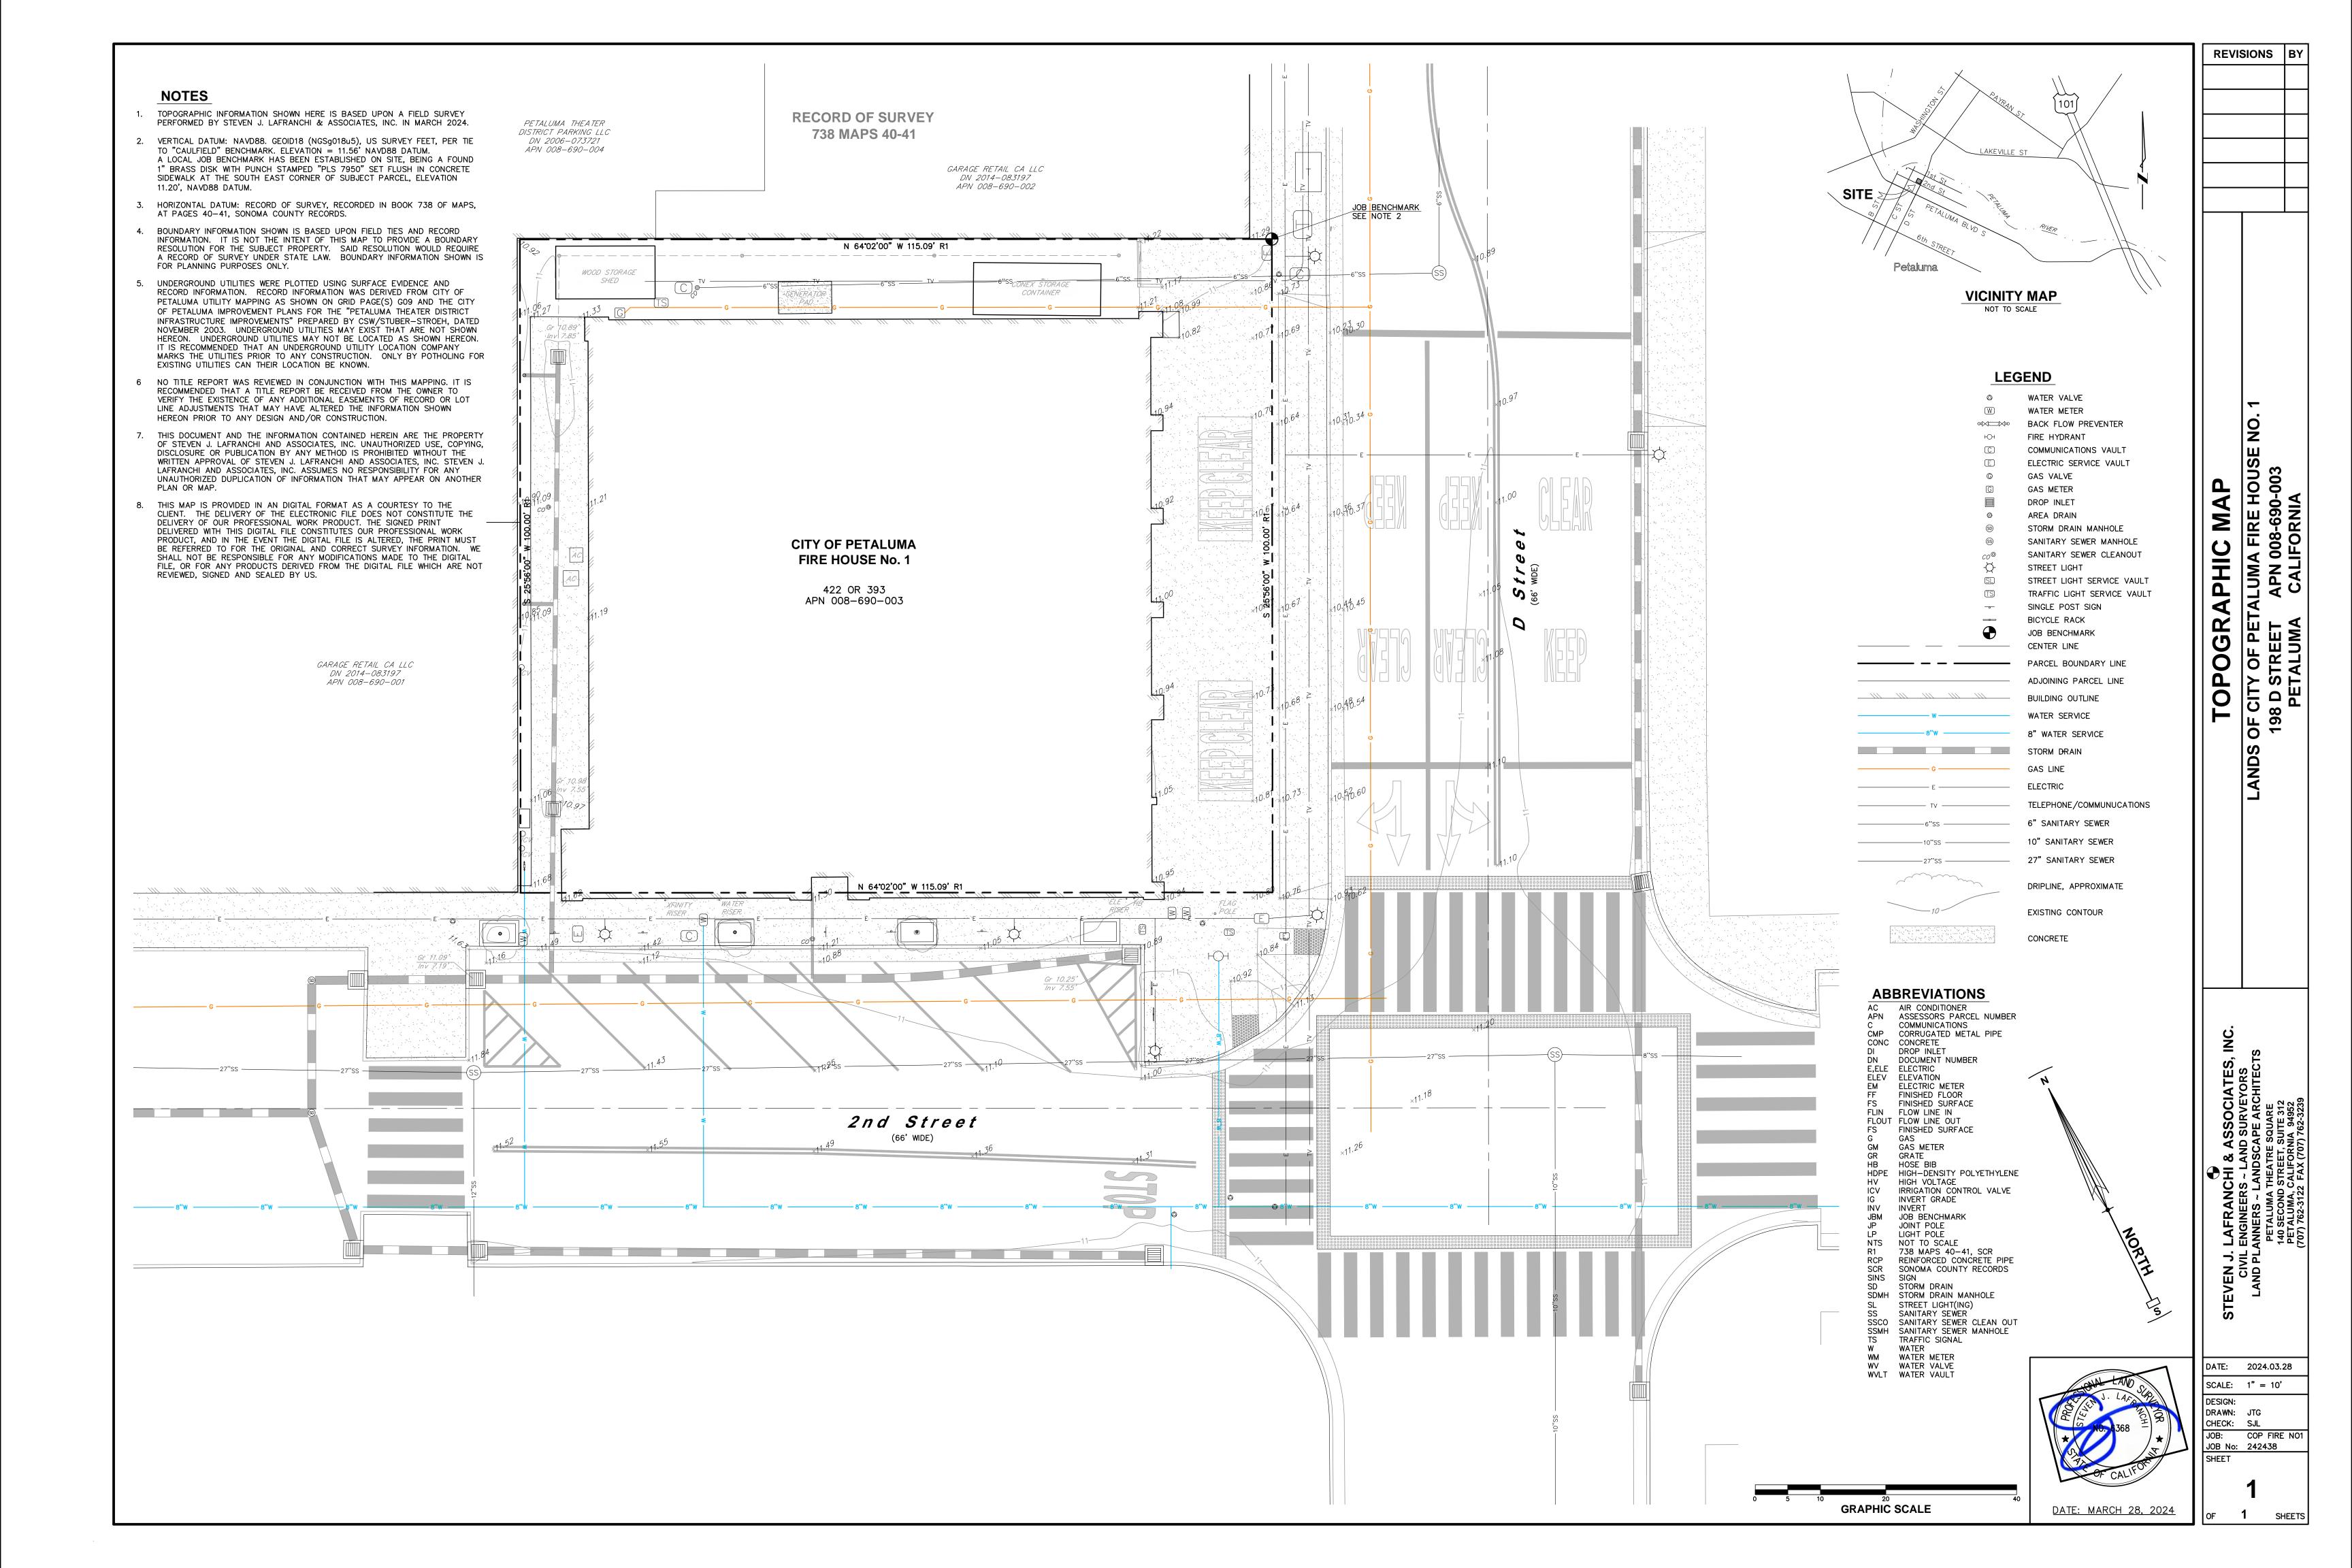

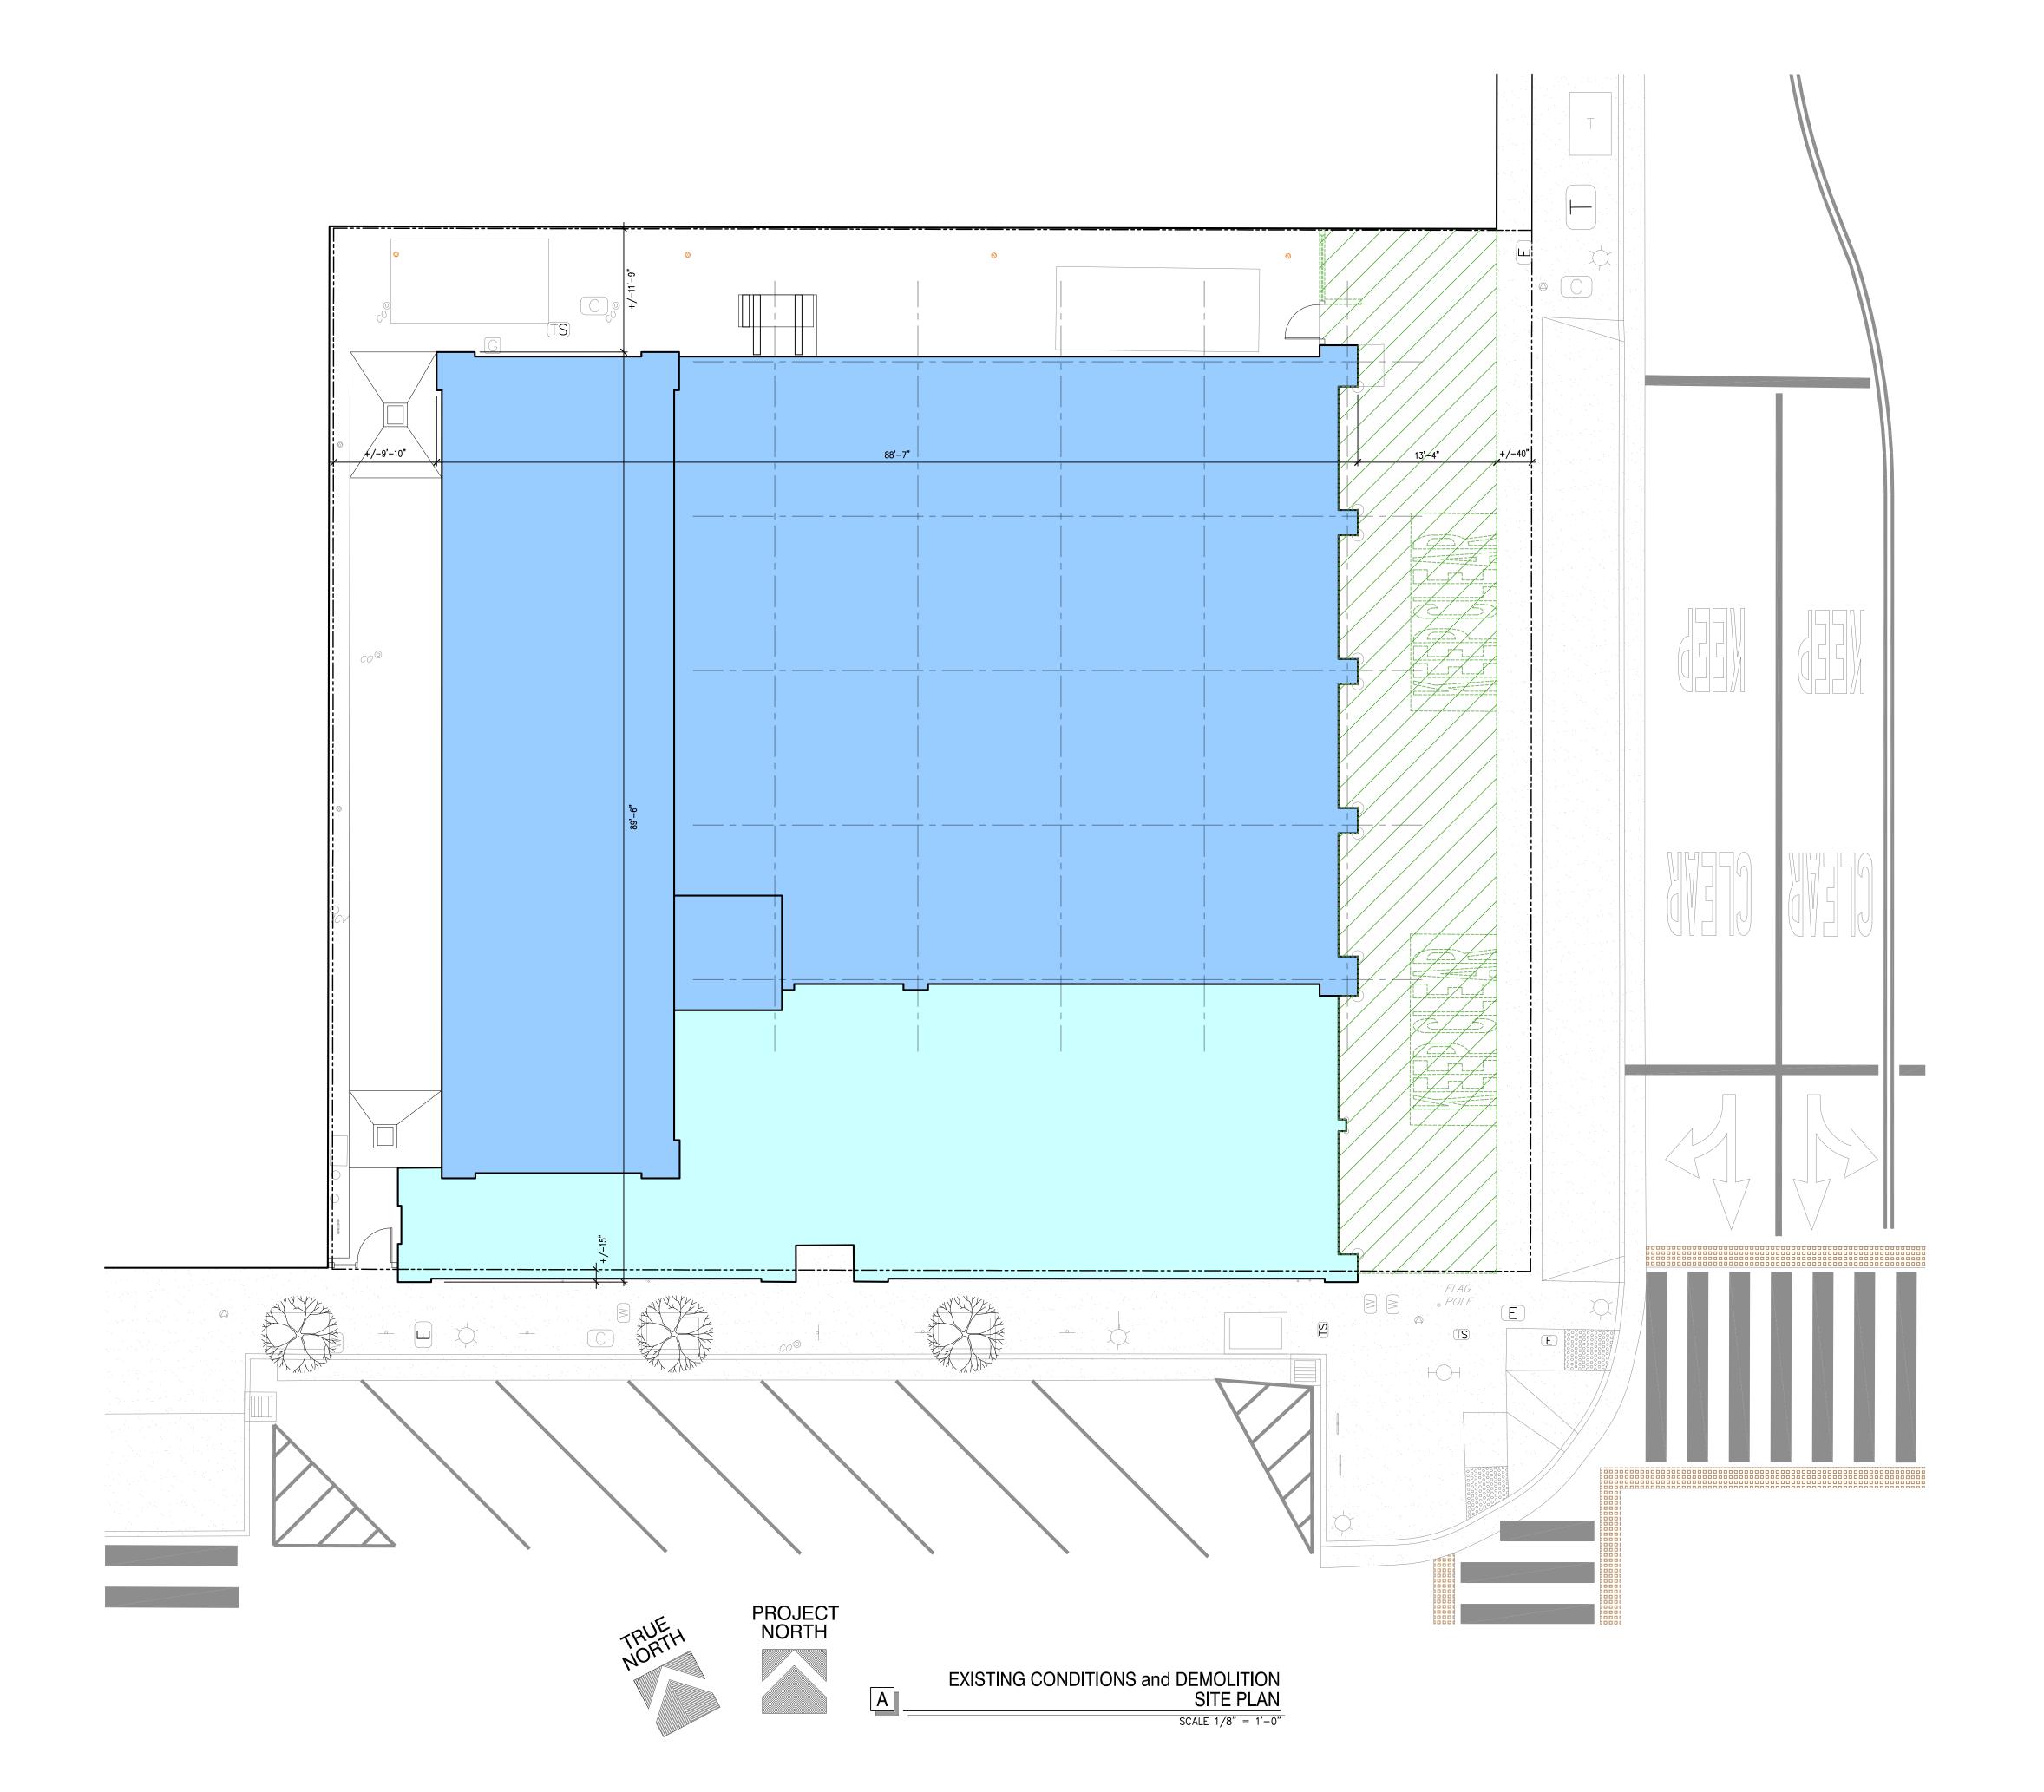

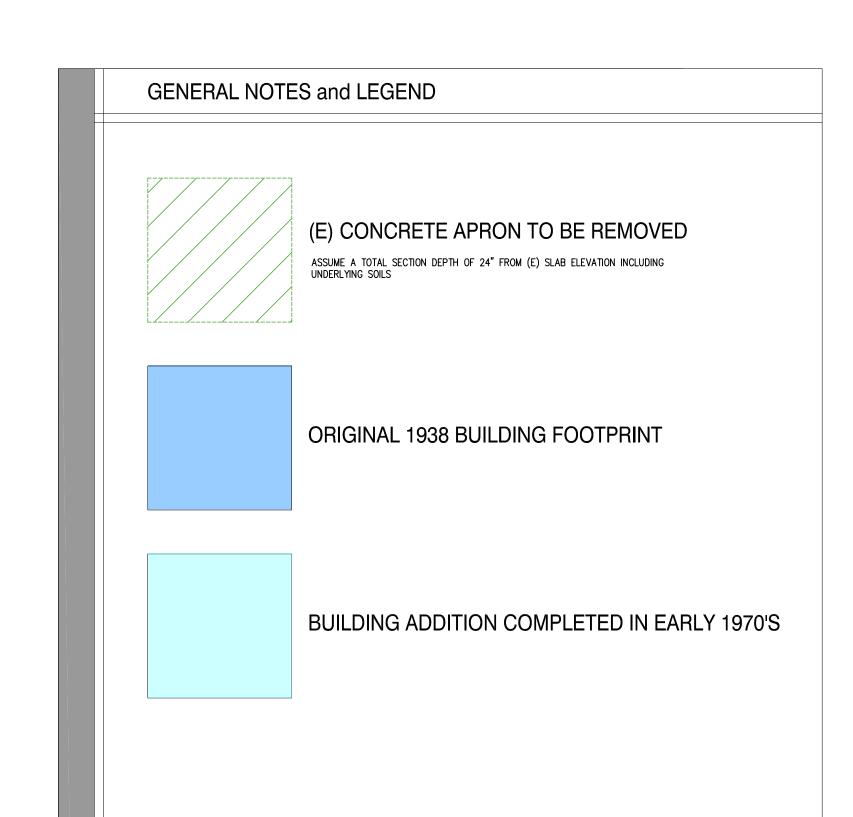

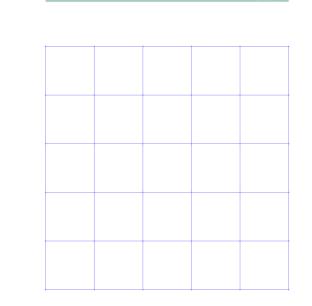

MARK ALBERTSON ARCHITECT

1676 CALLE RANCHERO PETALUMA, CA 94954 TELEPHONE (707) 763—1580 mark@architects—ma.com





PETALUMA FIRE STATION NO. 1
Building Renovation Project

198 D Street
Petaluma, California 94952


EXISTING CONDITIONS and DEMOLITION SITE PLAN


ARCHITECT'S PROJECT NO:

DRAWING STATUS:


CHECK SET: ,
PERMIT SET:
BID SET:
CONSTRUCTION SET:

REVISIONS:

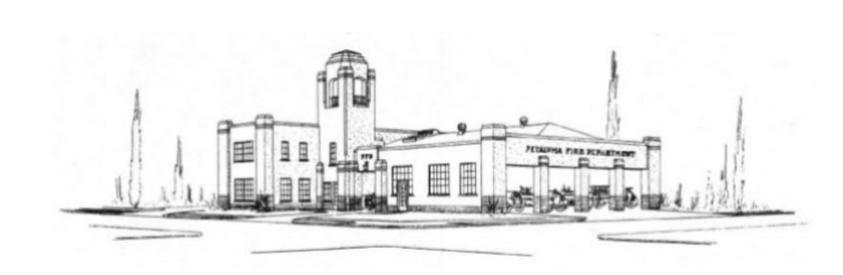

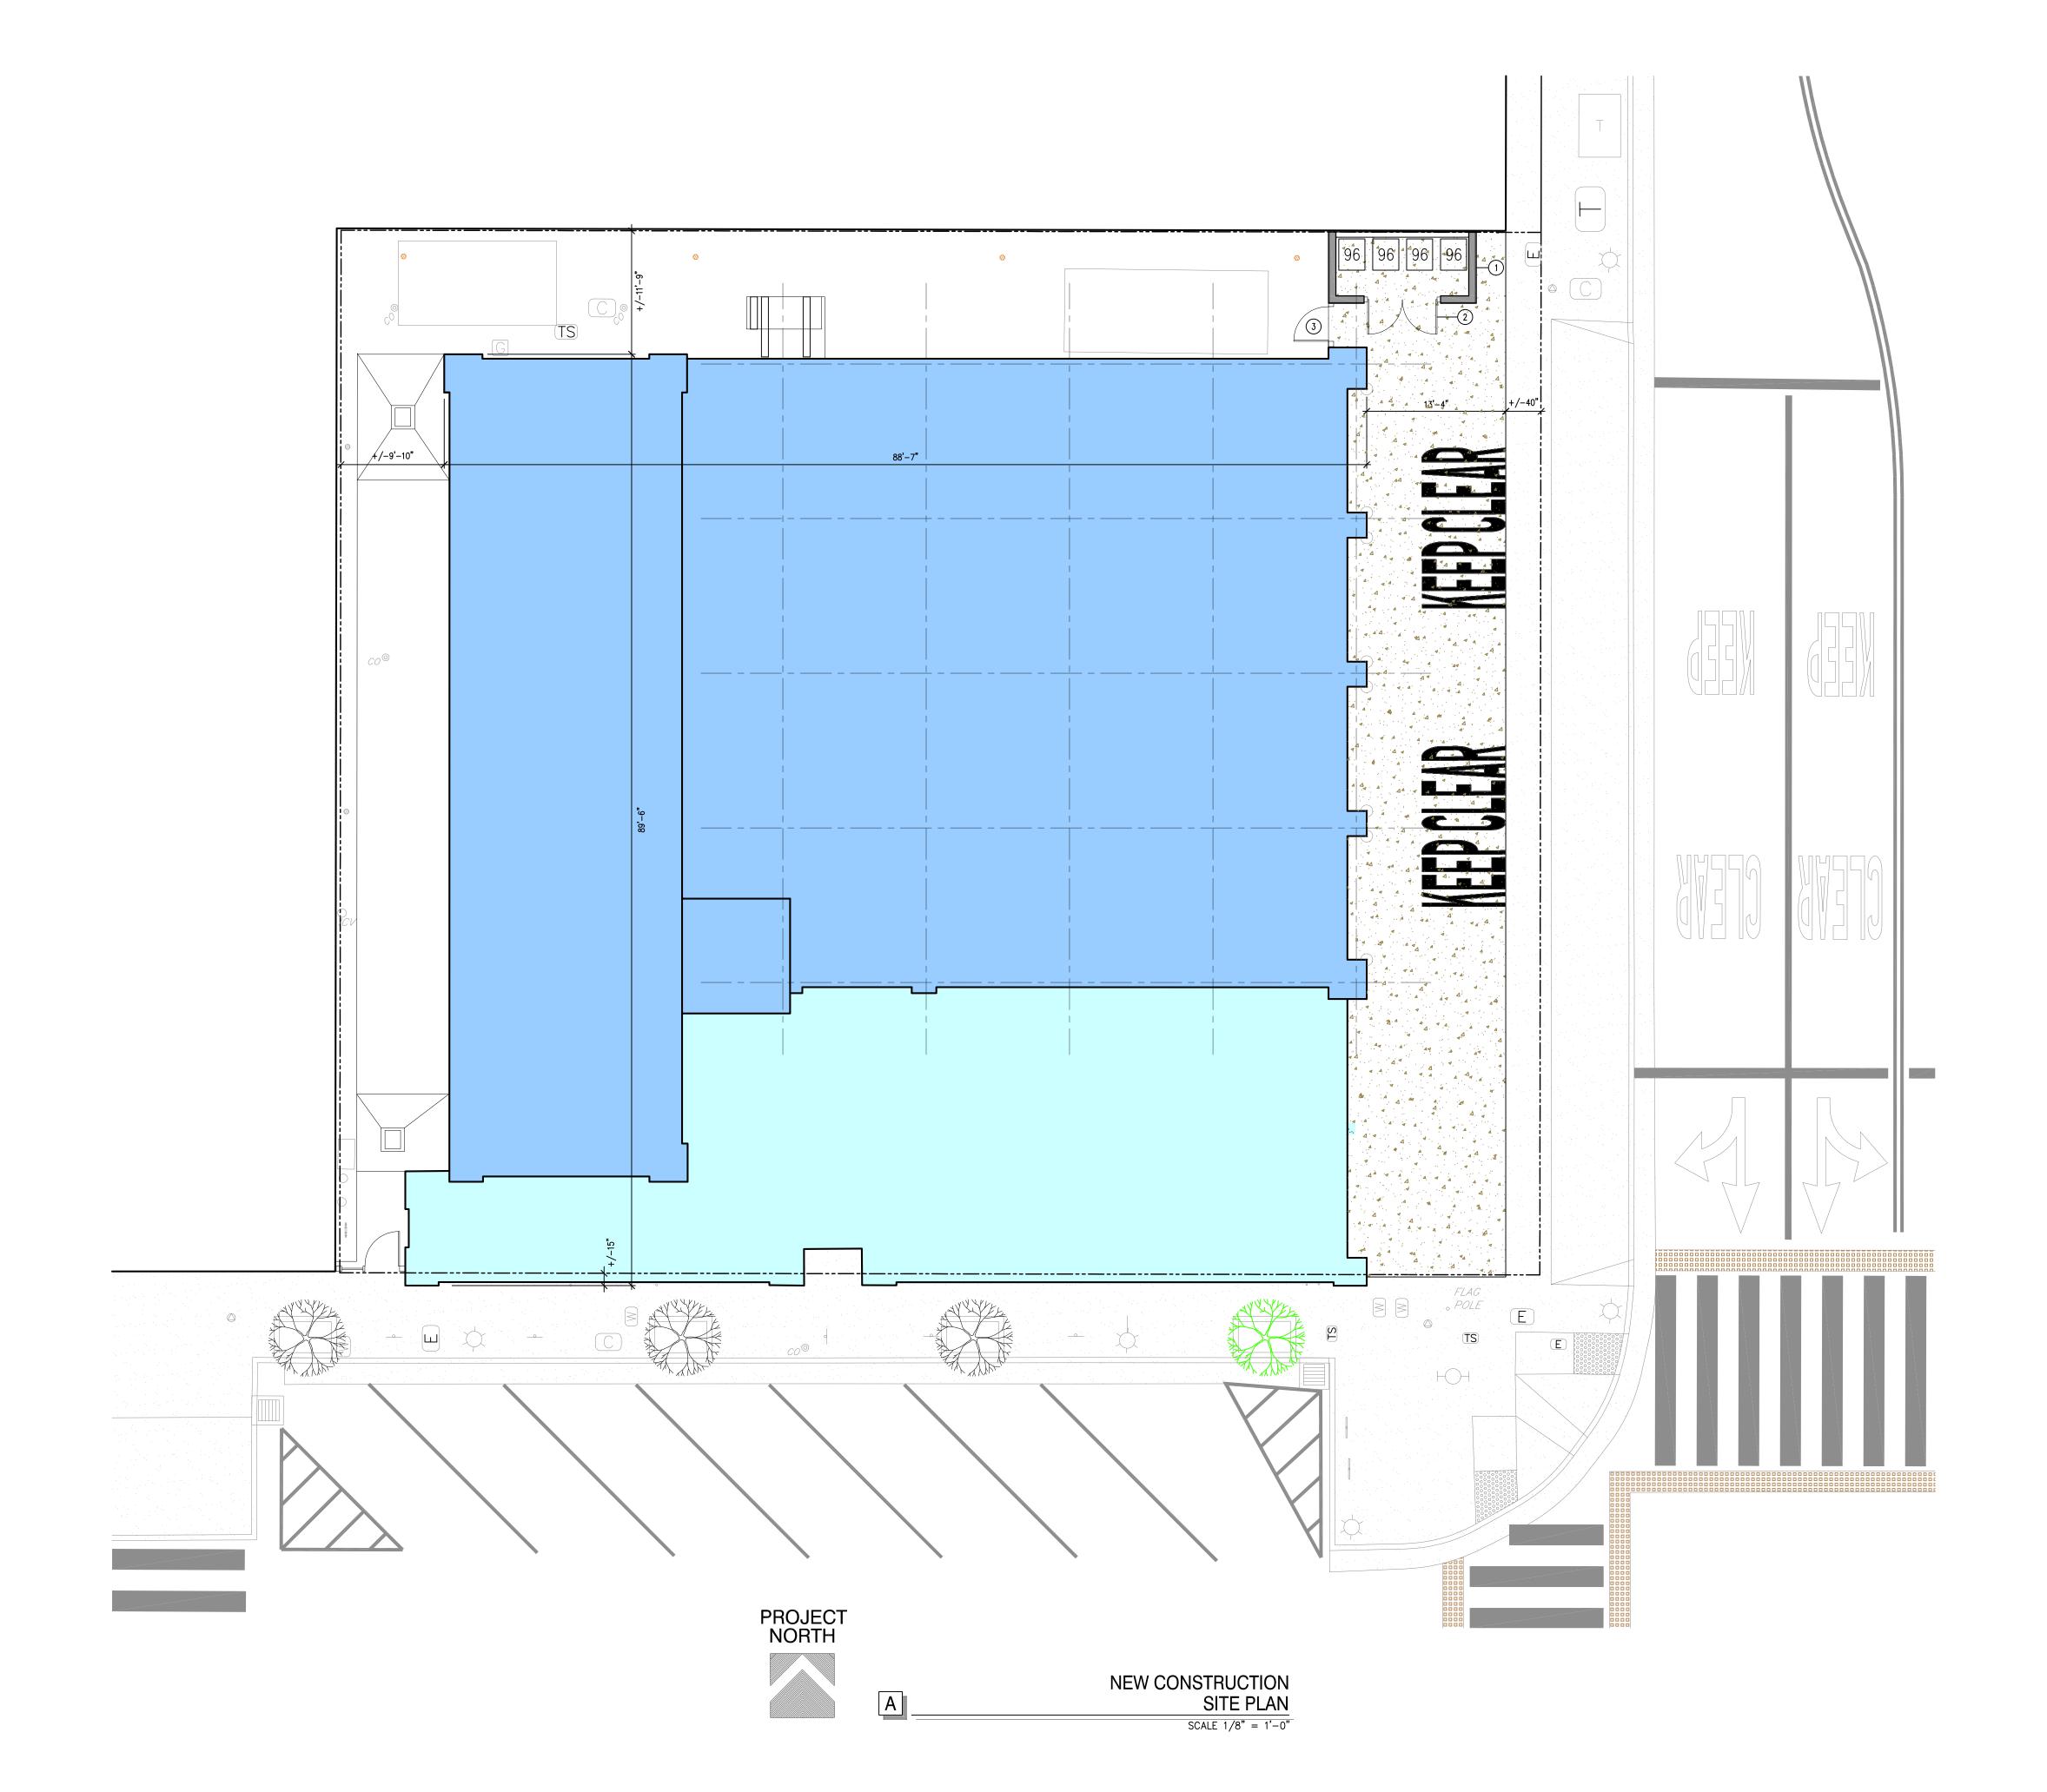



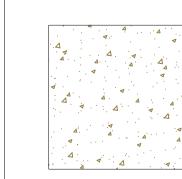

(N) CONCRETE APRON TO BE INSTALLED ASSUME A TOTAL SECTION DEPTH OF 24" FROM (E) SLAB ELEVATION INCLUDING UNDERLYING SOILS



ORIGINAL 1938 BUILDING FOOTPRINT




BUILDING ADDITION COMPLETED IN EARLY 1970'S




NEW BOULEVARD TREE PER CITY STANDARDS

#### NEW CONSTRUCTION REFERENCE NOTES

(N) 6'-0" HIGH CMU MASONRY WALLS WITH (N) DASH FINISH PLASTER TO MATCH (E) BUILDING PLASTER. PROVIDE (N) PAINT FINISH. (N) PR. WROUGHT IRON GATES TO MATCH (E) GATE DESIGN AND FINISH.

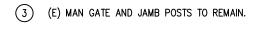

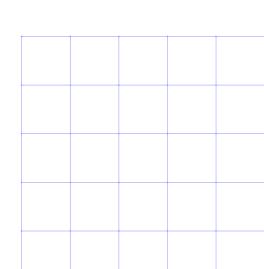

MARK ALBERTSON ARCHITECT

1676 CALLE RANCHERO PETALUMA, CA 94954
TELEPHONE (707) 763—1580
mark@architects—ma.com








NEW CONSTRUCTION SITE PLAN 198 D Street Petaluma, Calif


ARCHITECT'S PROJECT NO:


DRAWING STATUS:


CHECK SET:
PERMIT SET:
BID SET:
CONSTRUCTION SET:

REVISIONS:

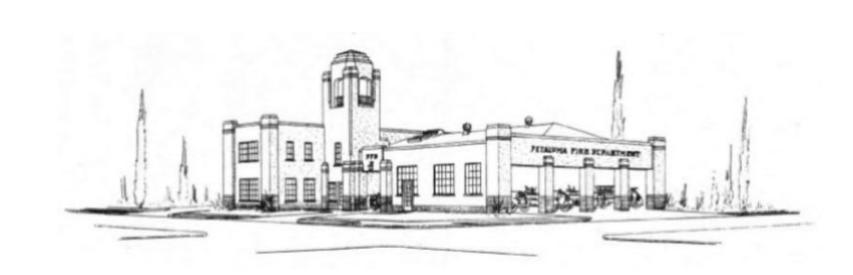

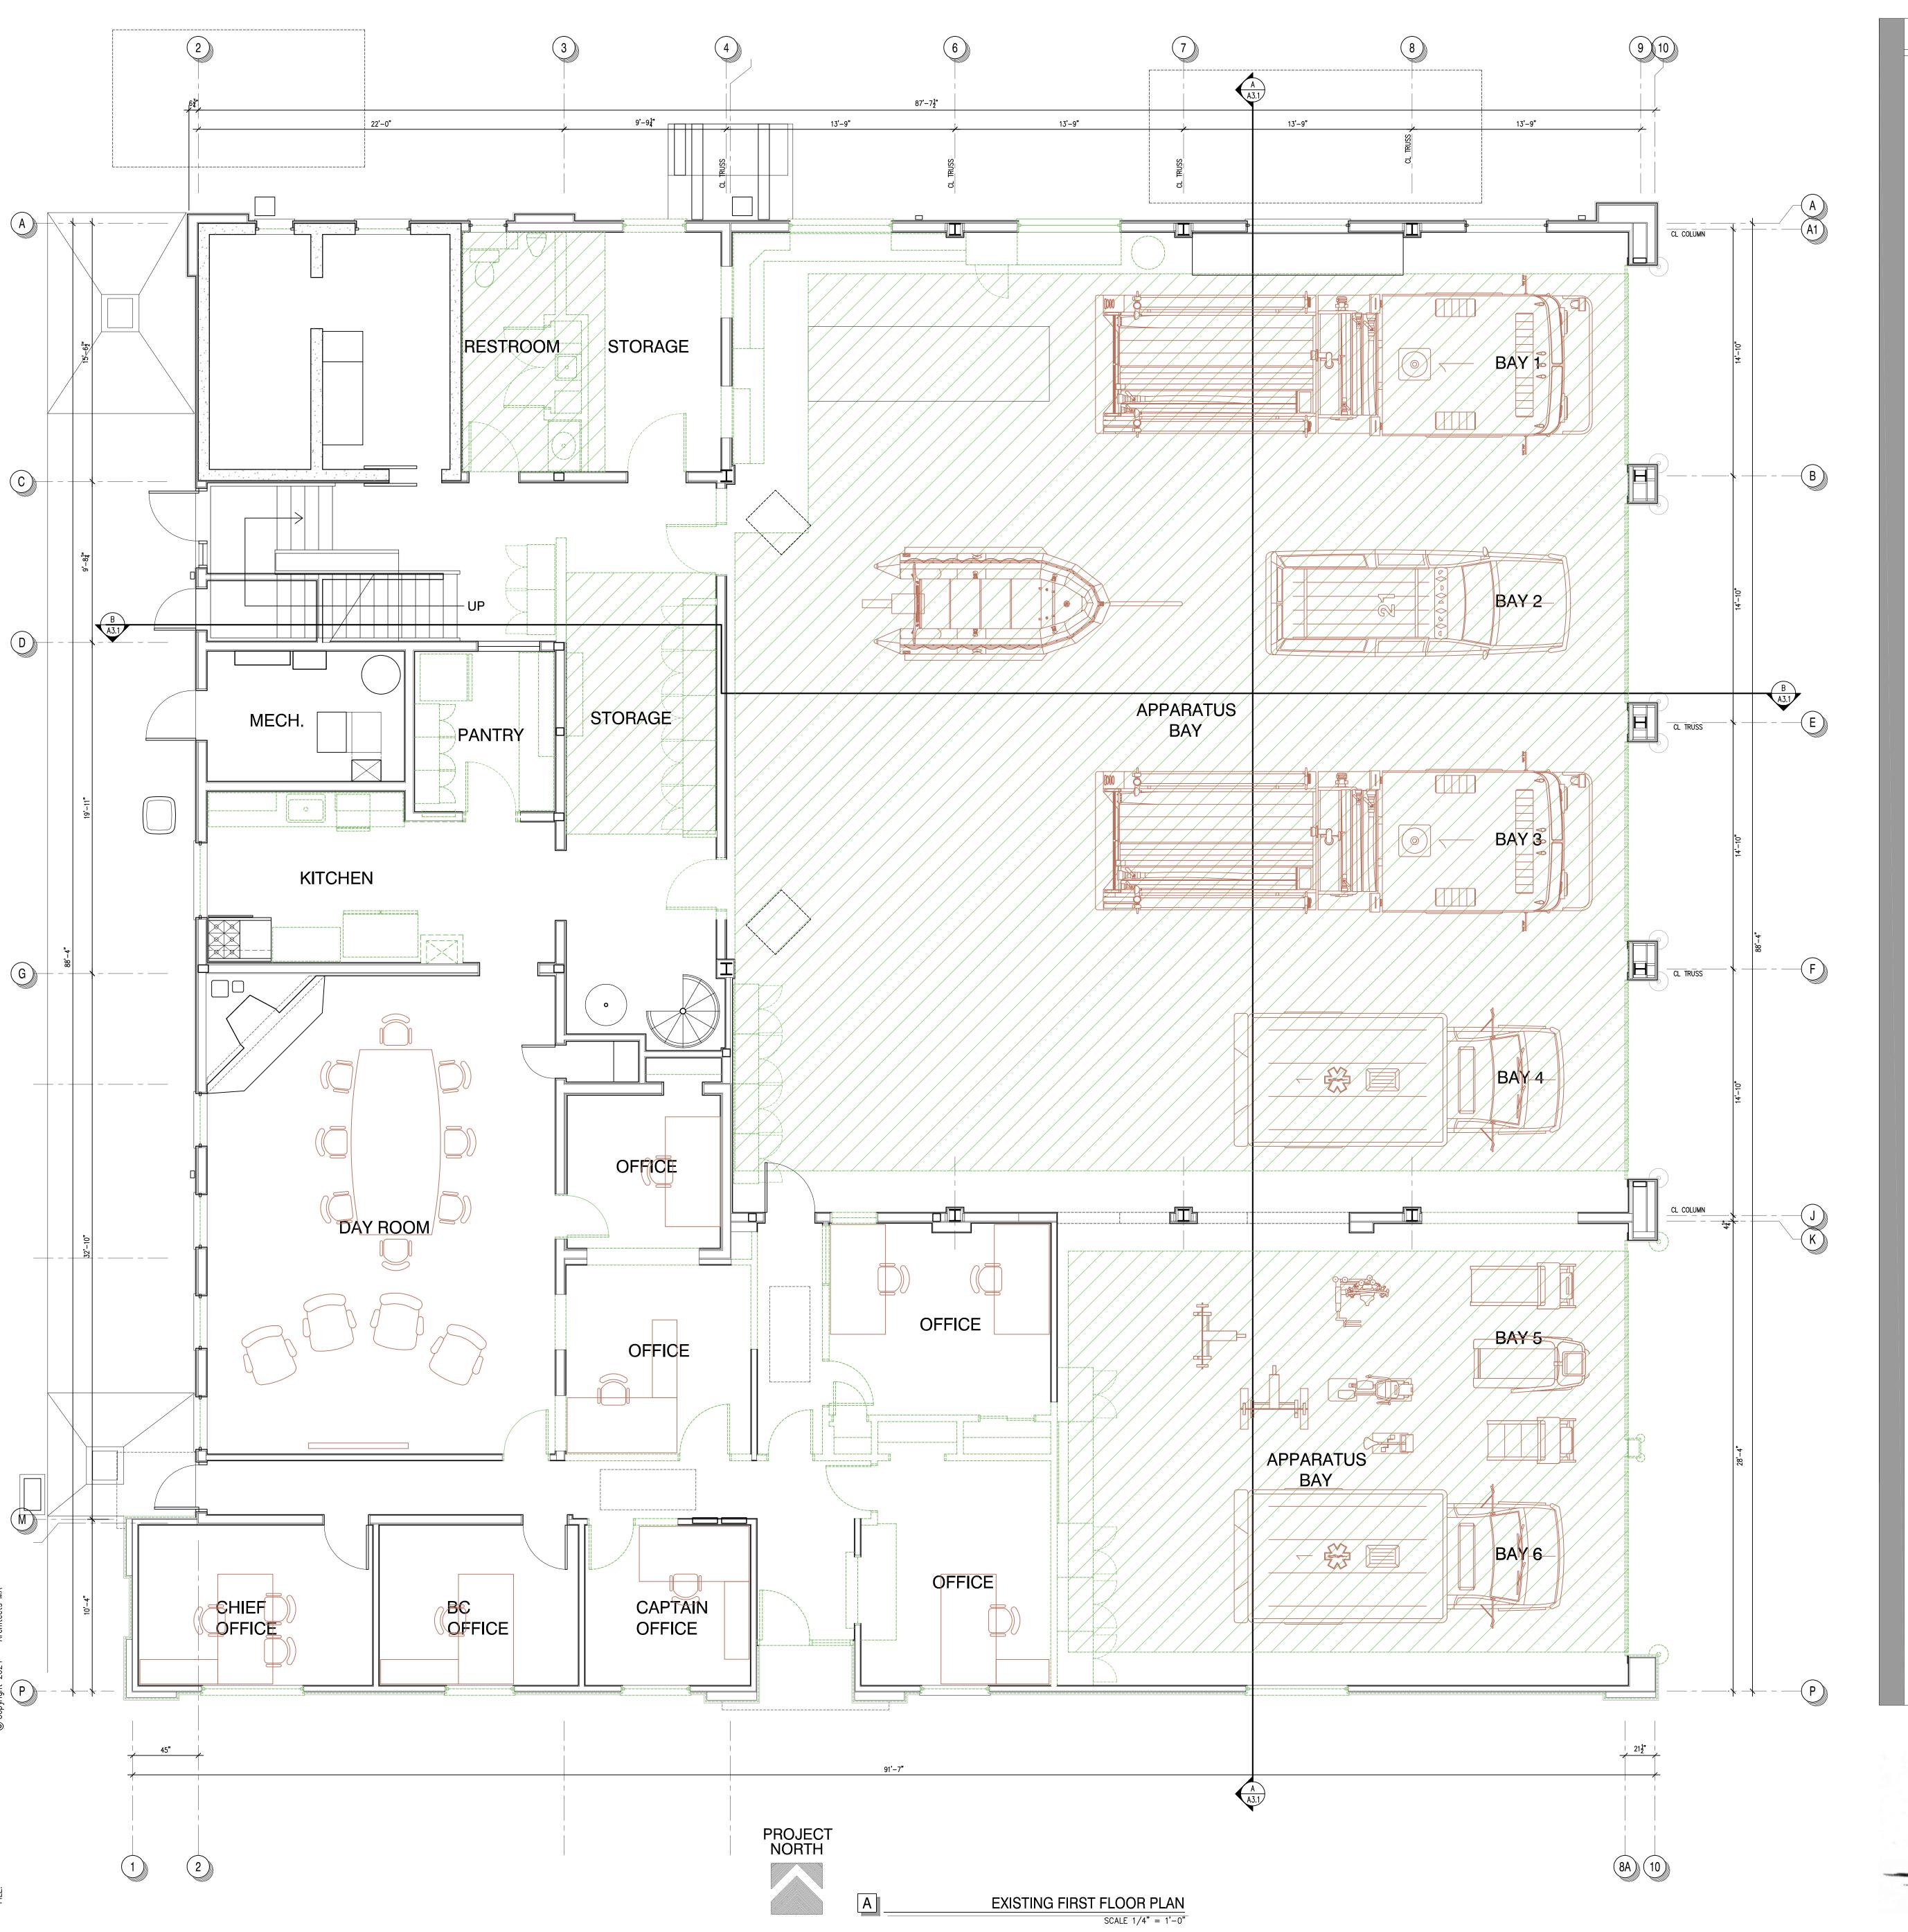


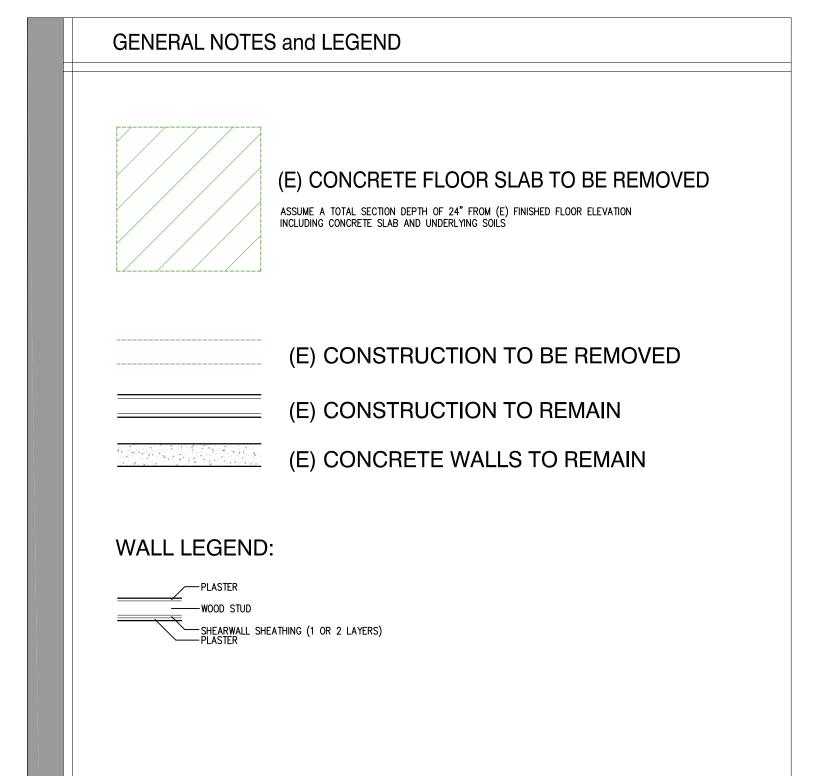

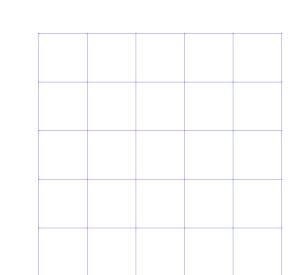

MARK ALBERTSON ARCHITECT

1676 CALLE RANCHERO
PETALUMA, CA 94954
TELEPHONE (707) 763—1580
mark@architects—ma.com

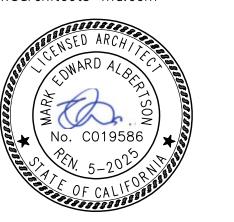



Vation Project

Petaluma, California 94952


CHITECT'S PROJECT NO 24.301


DRAWING STATUS:


CHECK SET: JUNE 20
PERMIT SET:
BID SET:
CONSTRUCTION SET:

REVISIONS:



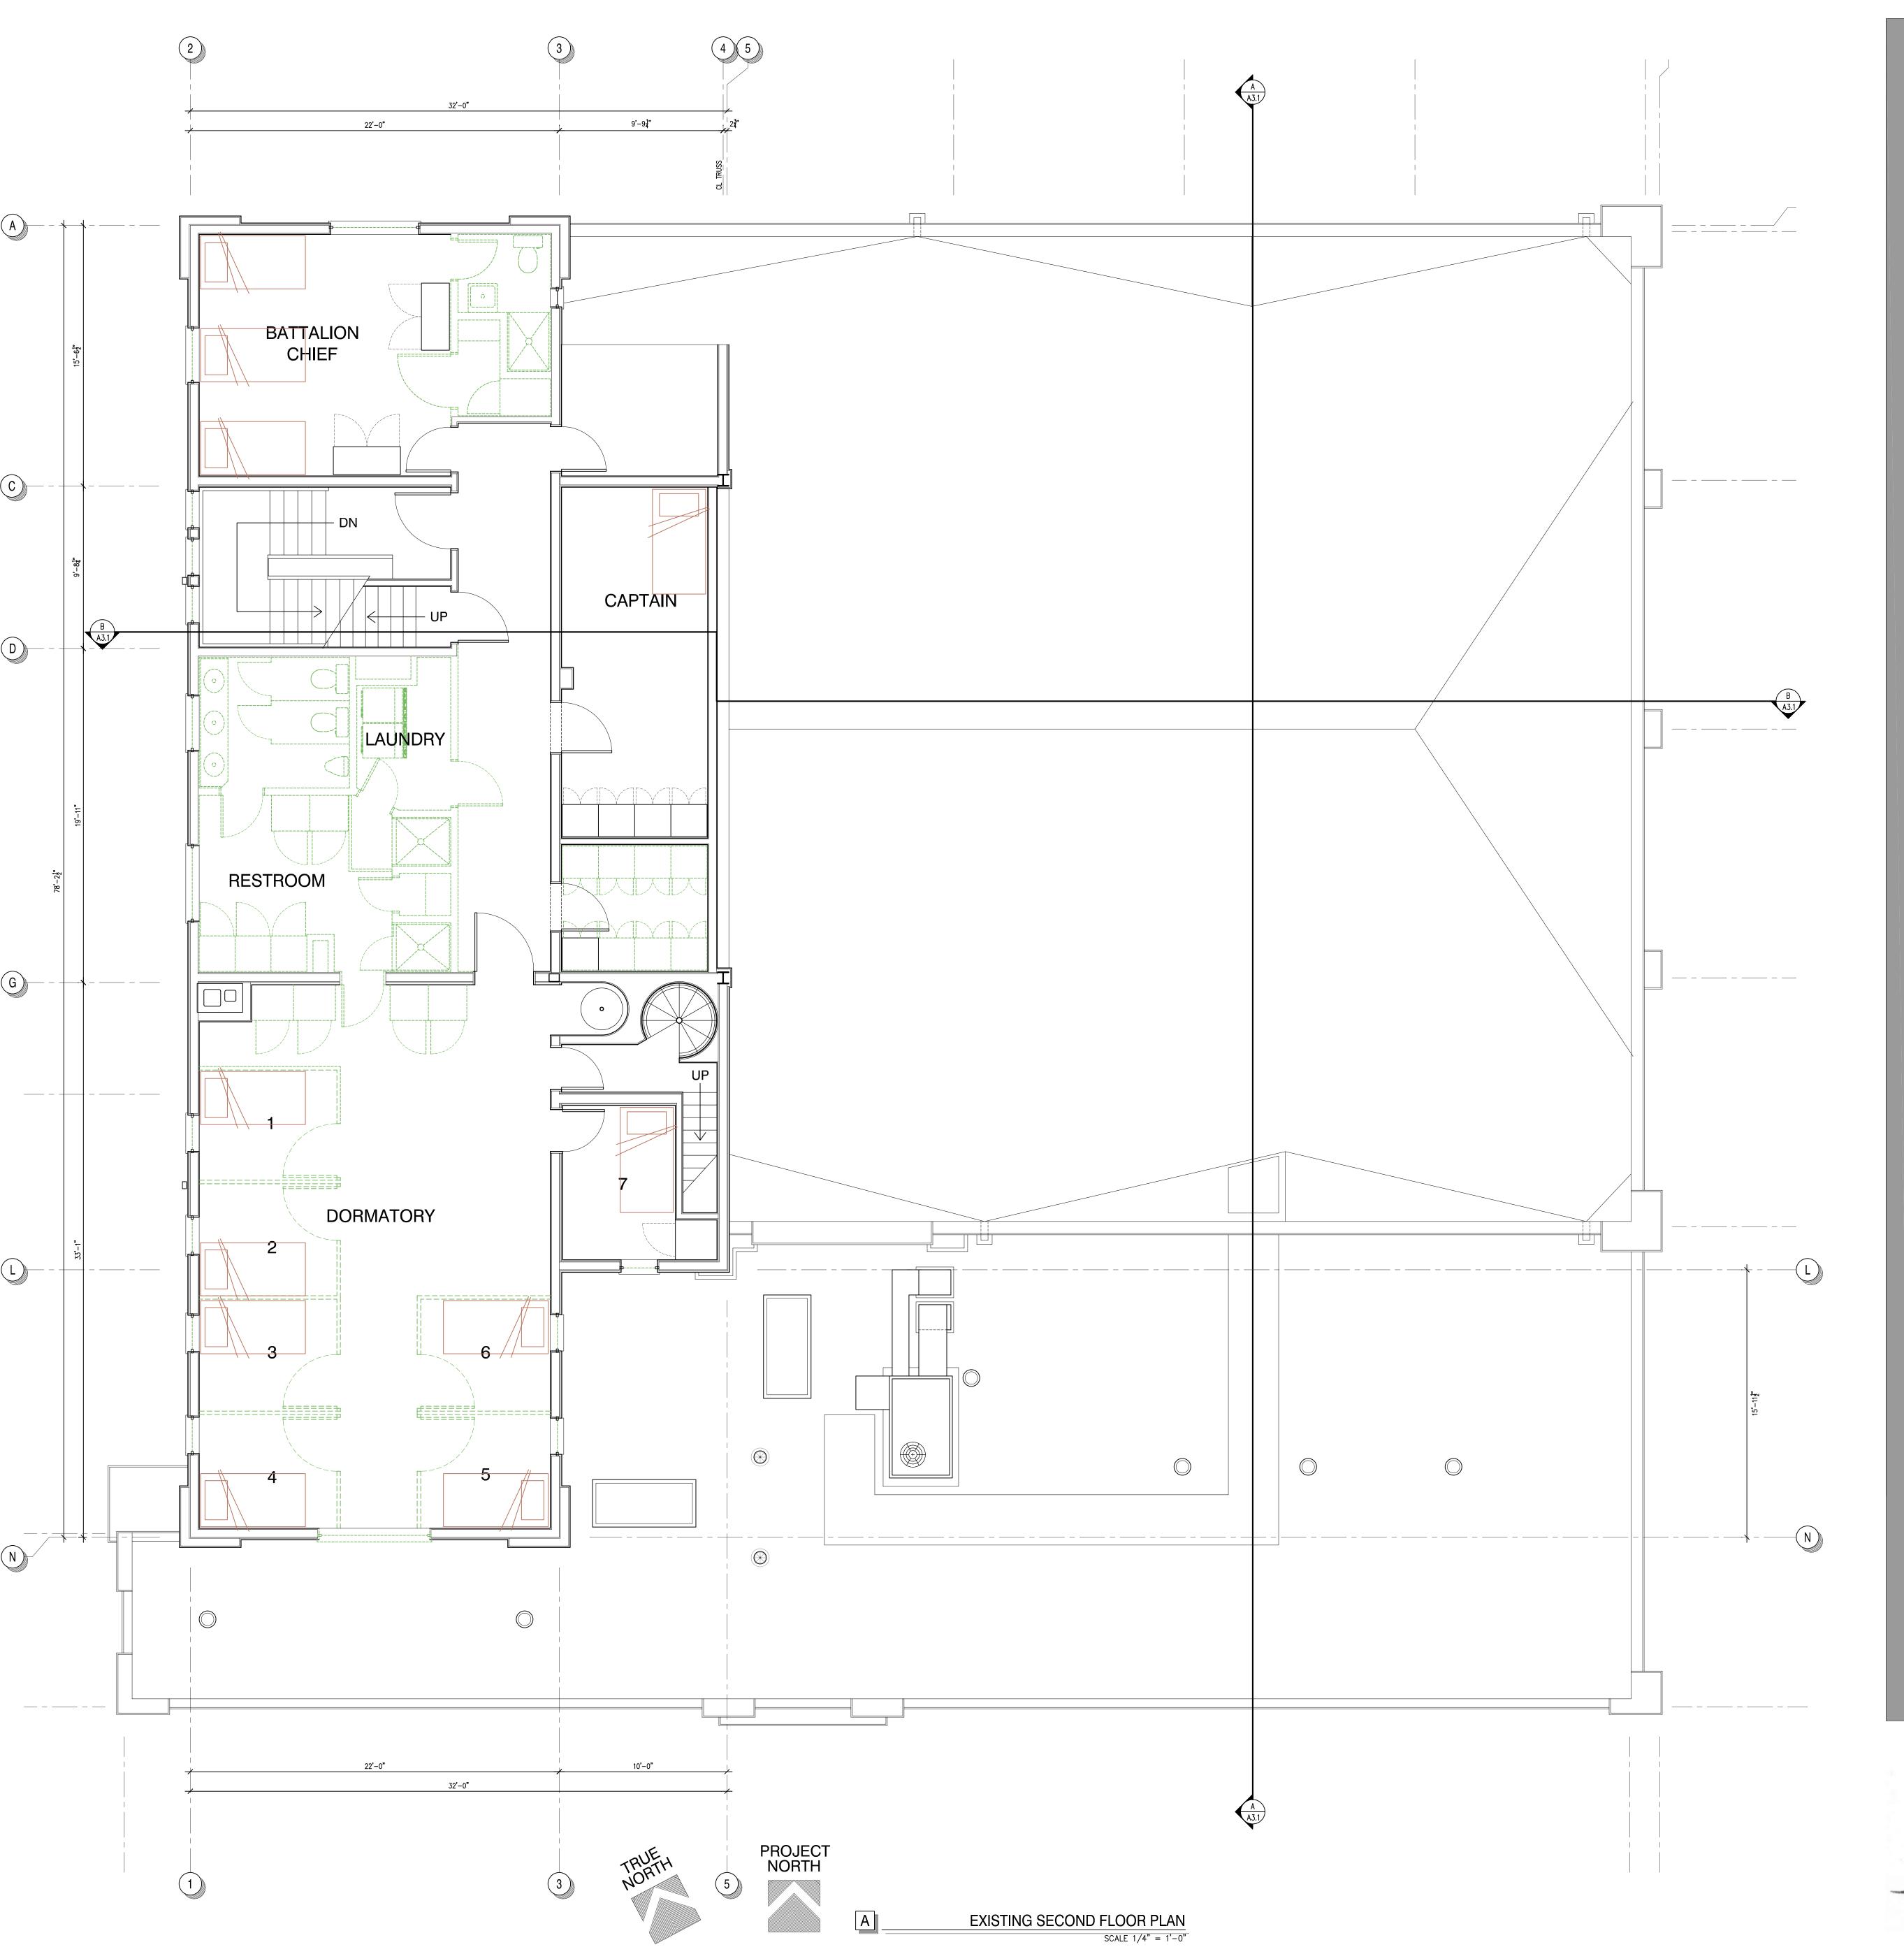


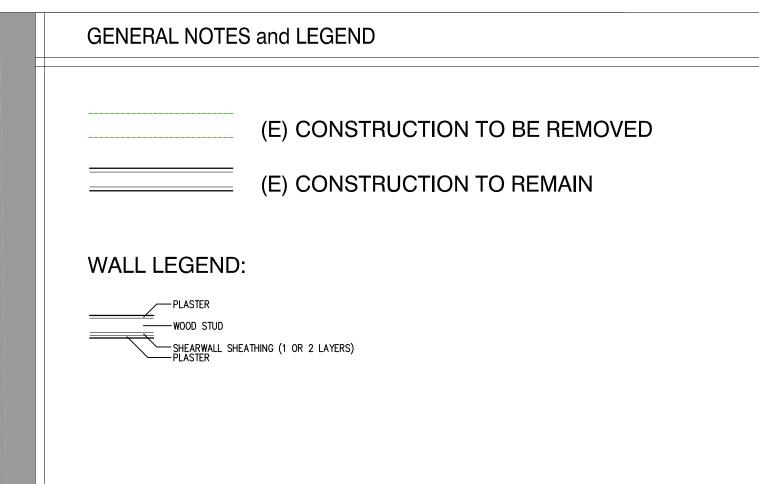

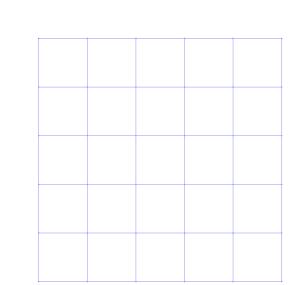


MARK ALBERTSON ARCHITECT

1676 CALLE RANCHERO PETALUMA, CA 94954 TELEPHONE (707) 763—1580 mark@architects—ma.com

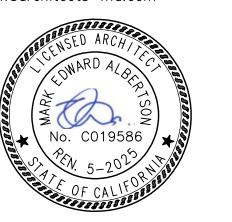



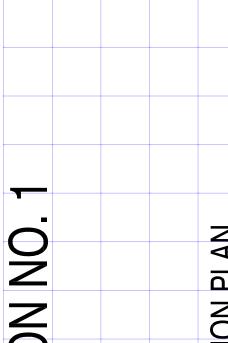

enovation Project

ia 94952
COND FLOOR DEMOLITION

198 [ Petal

MA24.301

DRAWING STATUS:


CHECK SET: JUNE 202
PERMIT SET:
BID SET:
CONSTRUCTION SET:


REVISIONS:




SHEET NO.

A1 2

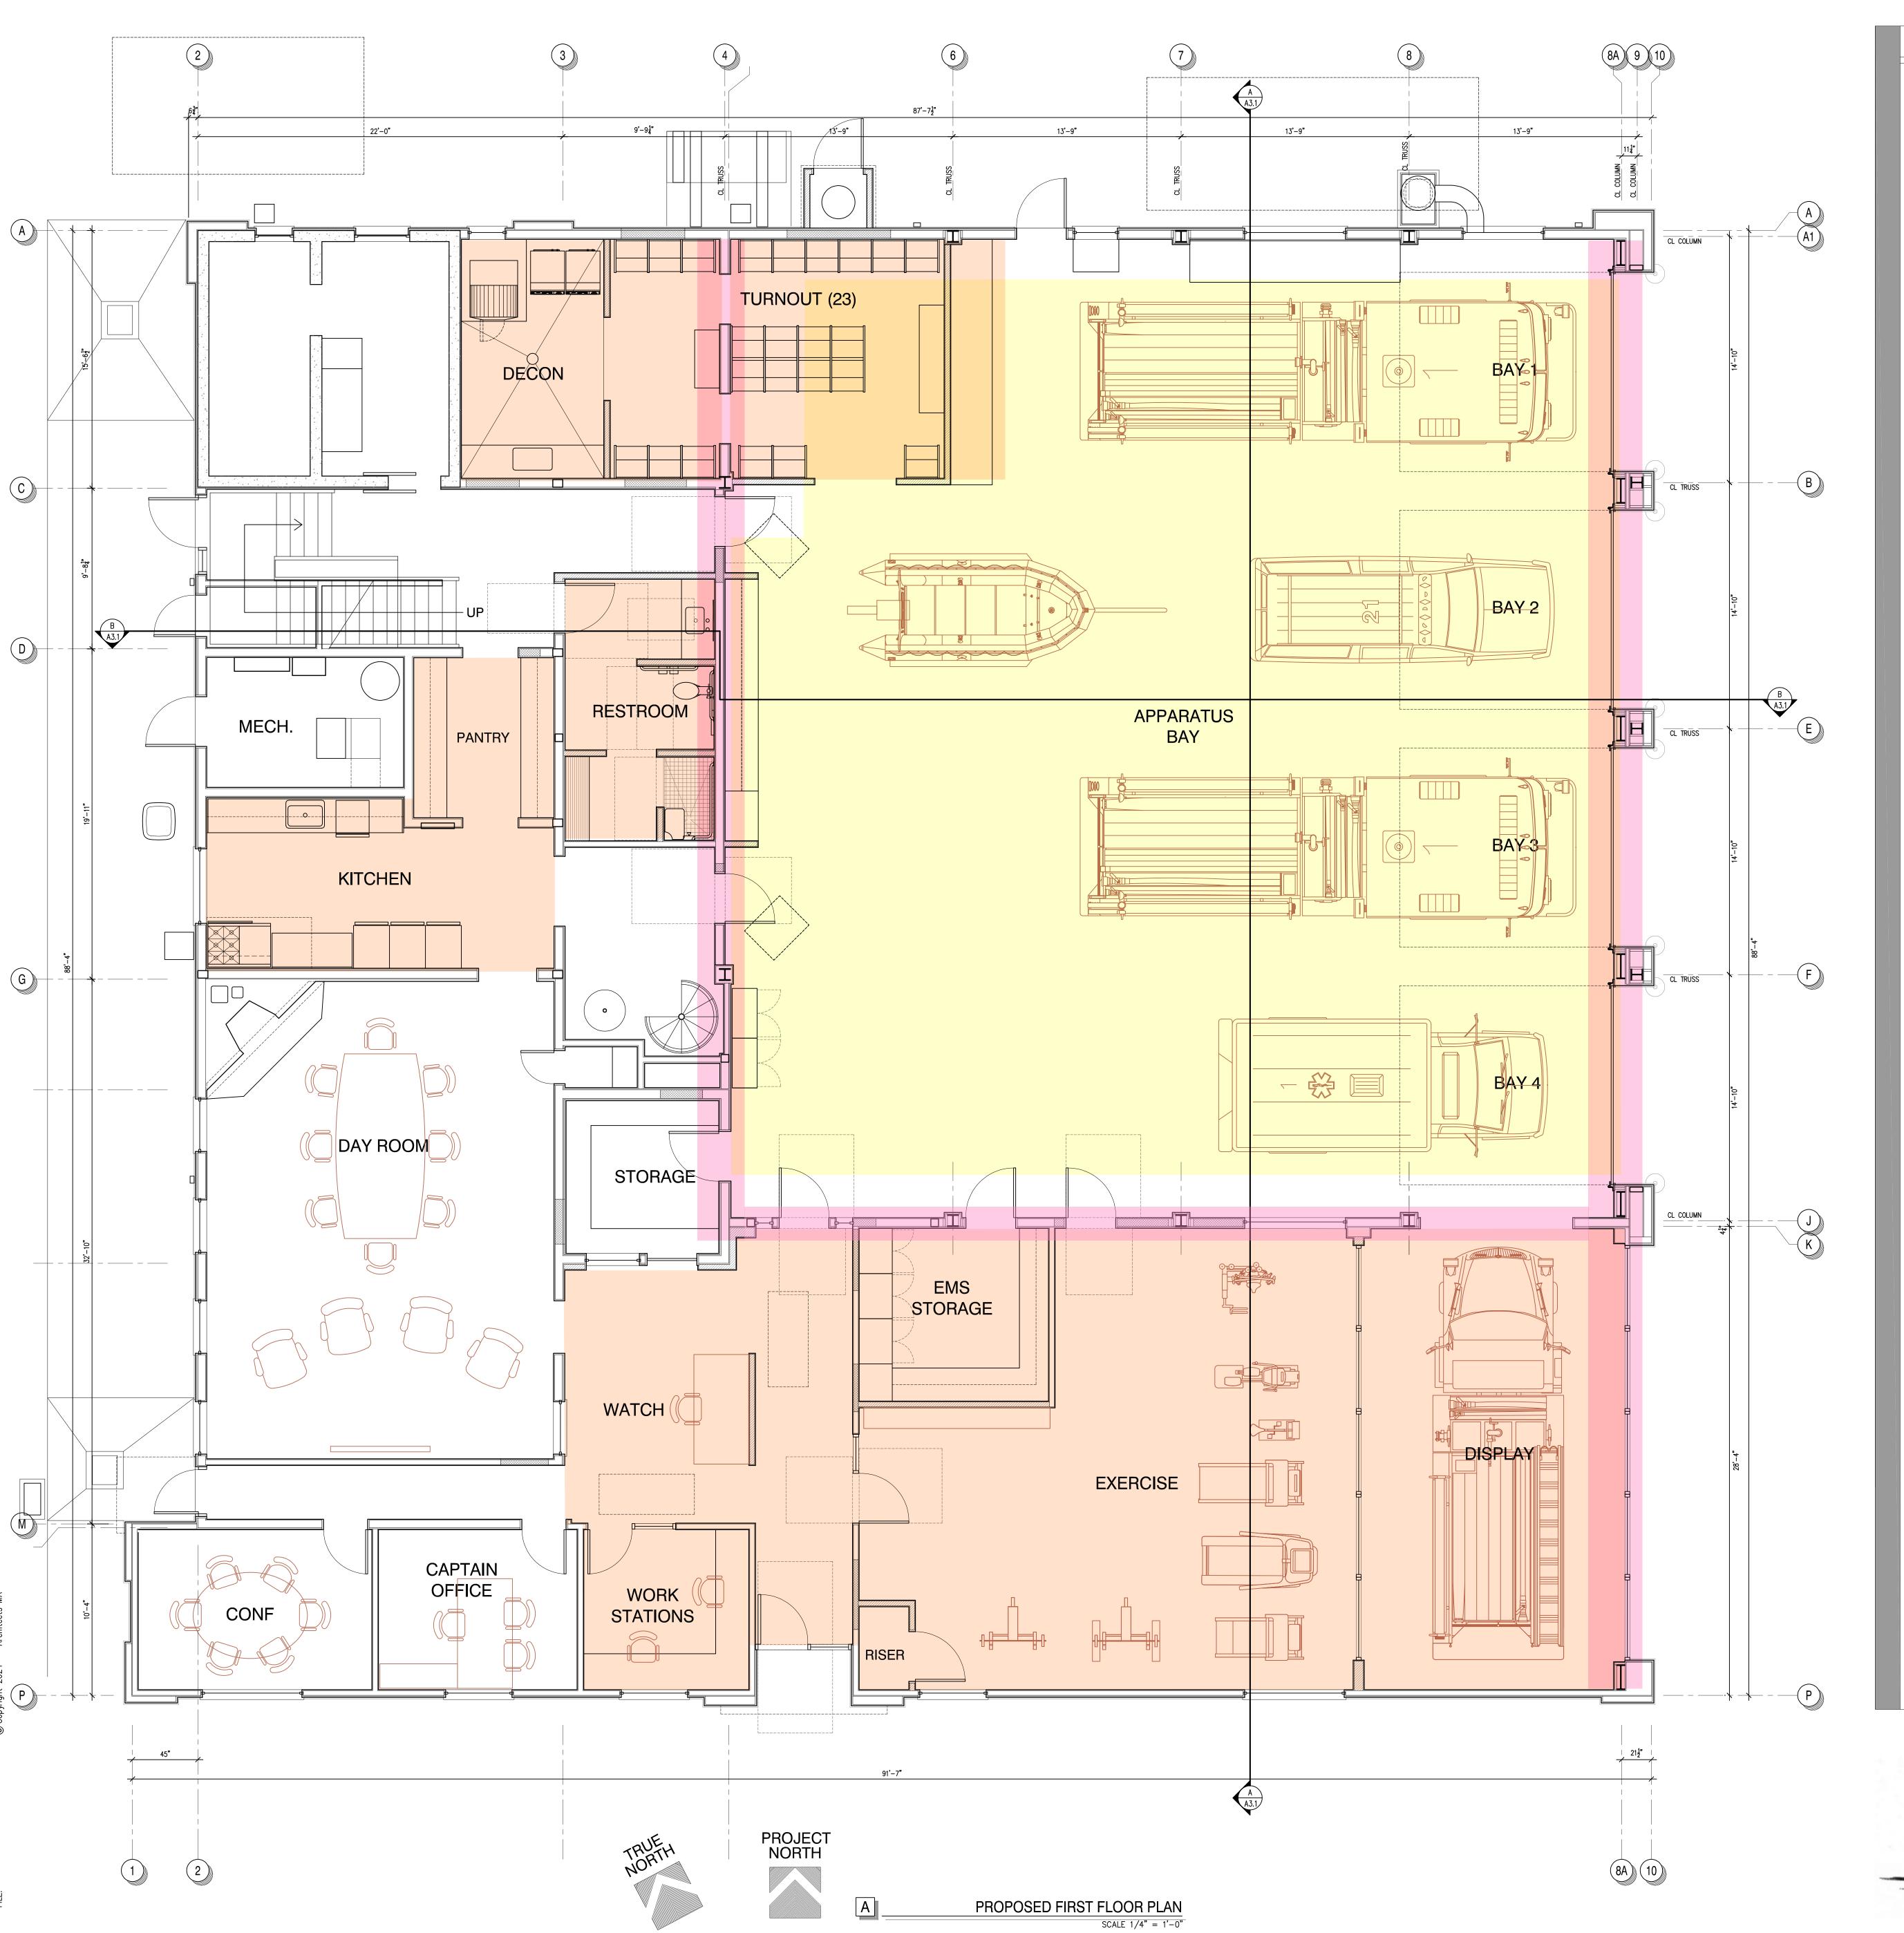

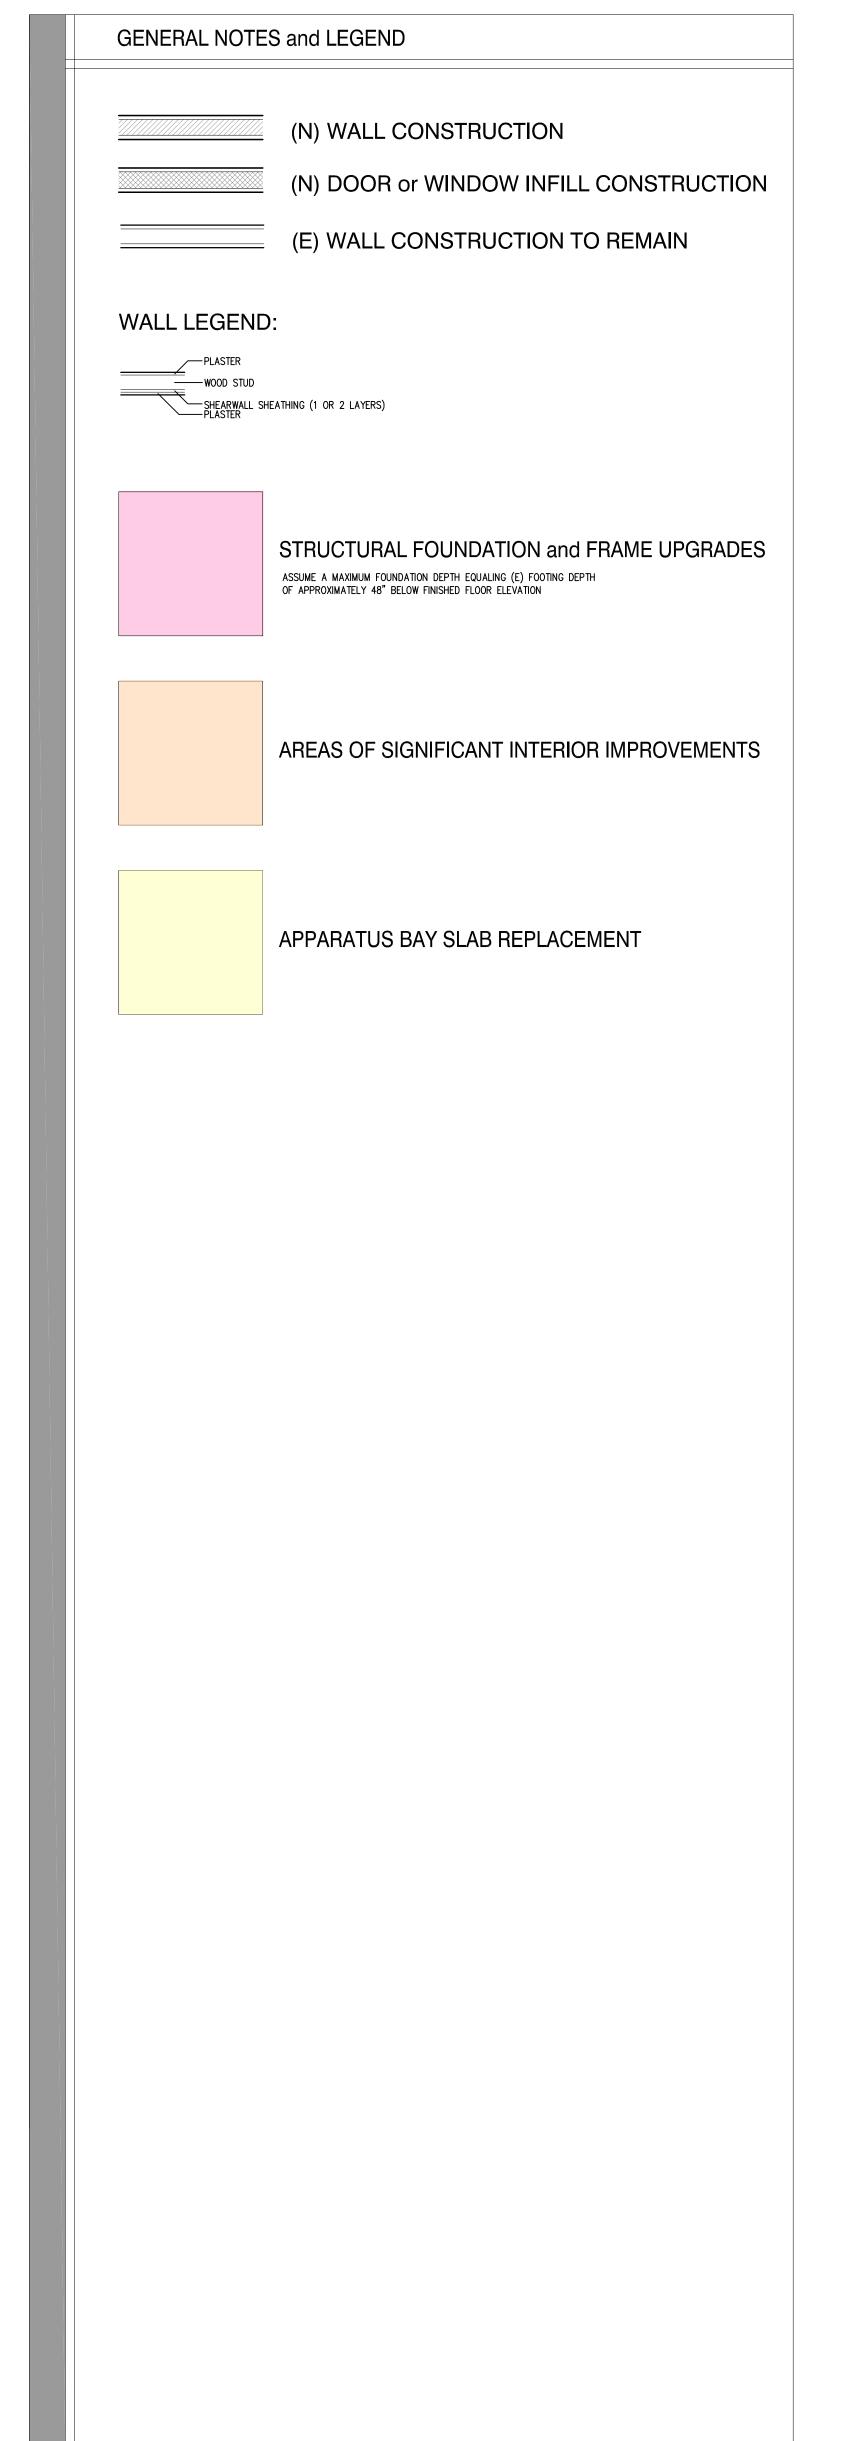

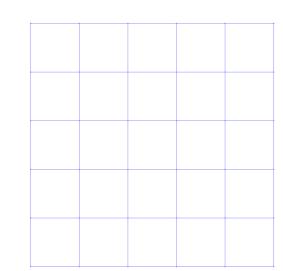

MARK ALBERTSON ARCHITECT

1676 CALLE RANCHERO PETALUMA, CA 94954 TELEPHONE (707) 763-1580 mark@architects-ma.com





Vation Project

198 D Street
Petaluma, Ca

CHITECT'S PROJECT NO 24.301


DRAWING STATUS:


CHECK SET: JUNE 20.
PERMIT SET:
BID SET:
CONSTRUCTION SET:

REVISIONS:






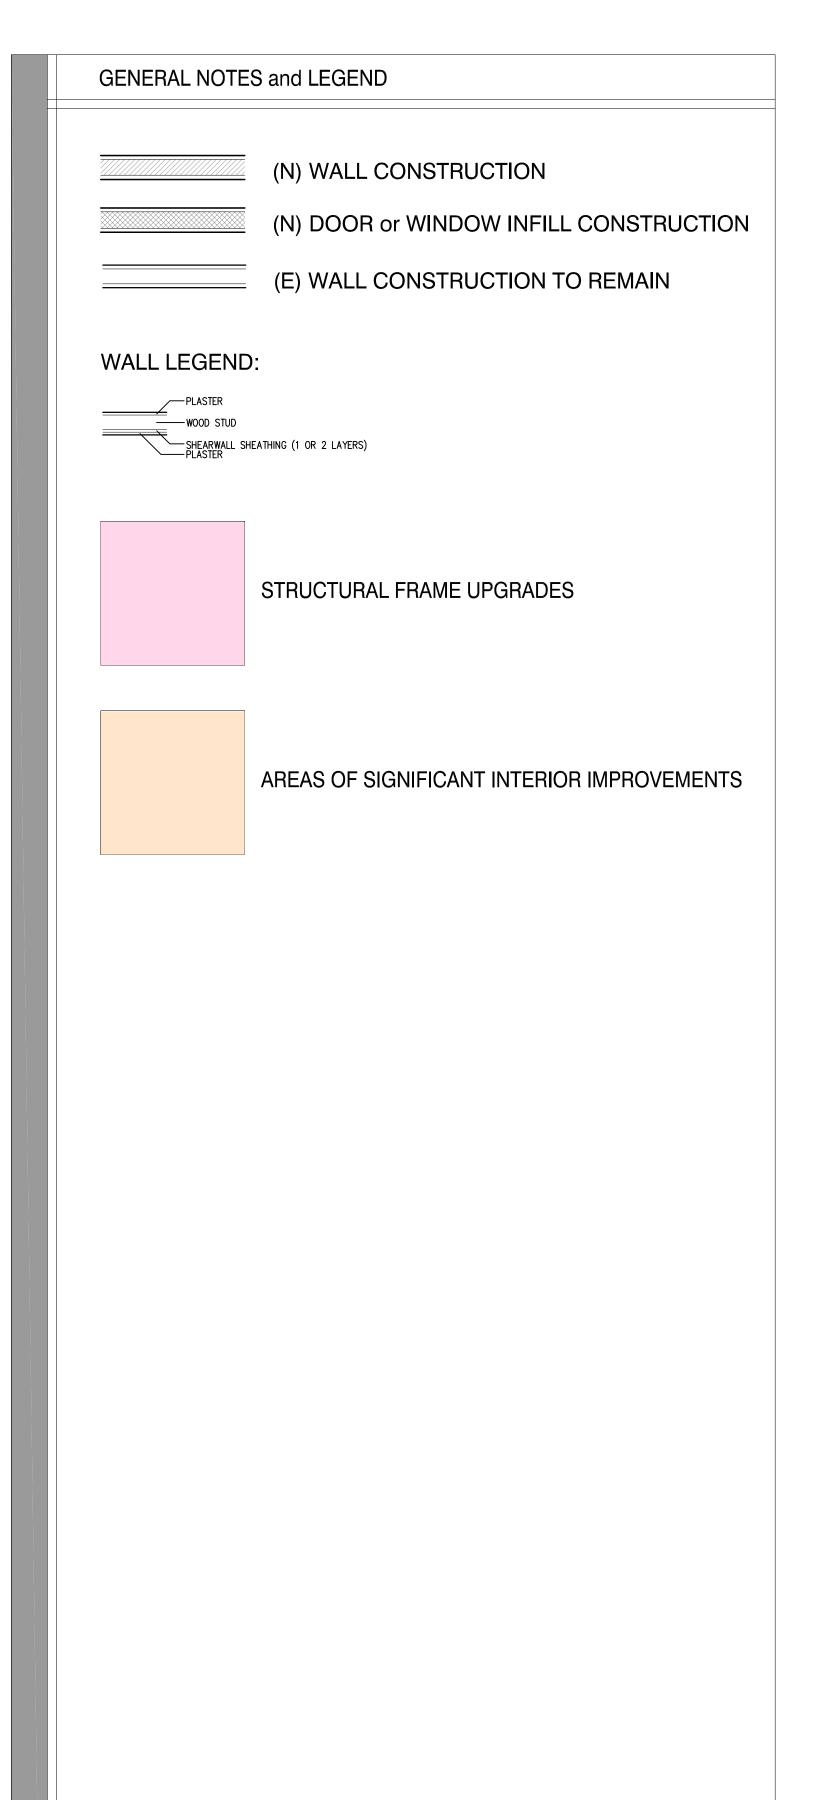

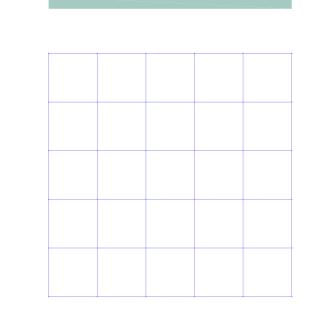

MARK ALBERTSON ARCHITECT

1676 CALLE RANCHERO PETALUMA, CA 94954 TELEPHONE (707) 763—1580 mark@architects—ma.com

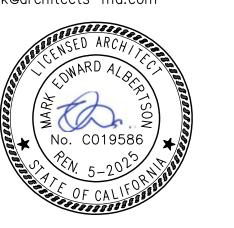



Project NO. 1


198 D Stree Petaluma, C


ARCHITECT'S PROJECT N MA24.301


DRAWING STATUS:

CHECK SET: JUNE 20
PERMIT SET:
BID SET:
CONSTRUCTION SET:

REVISIONS:

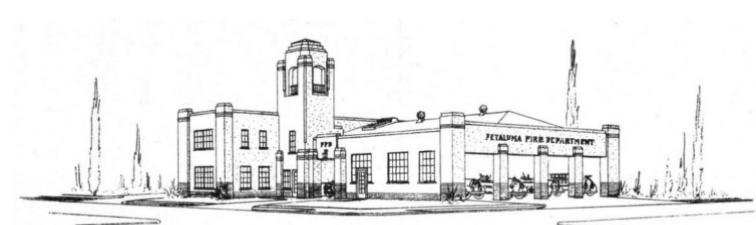


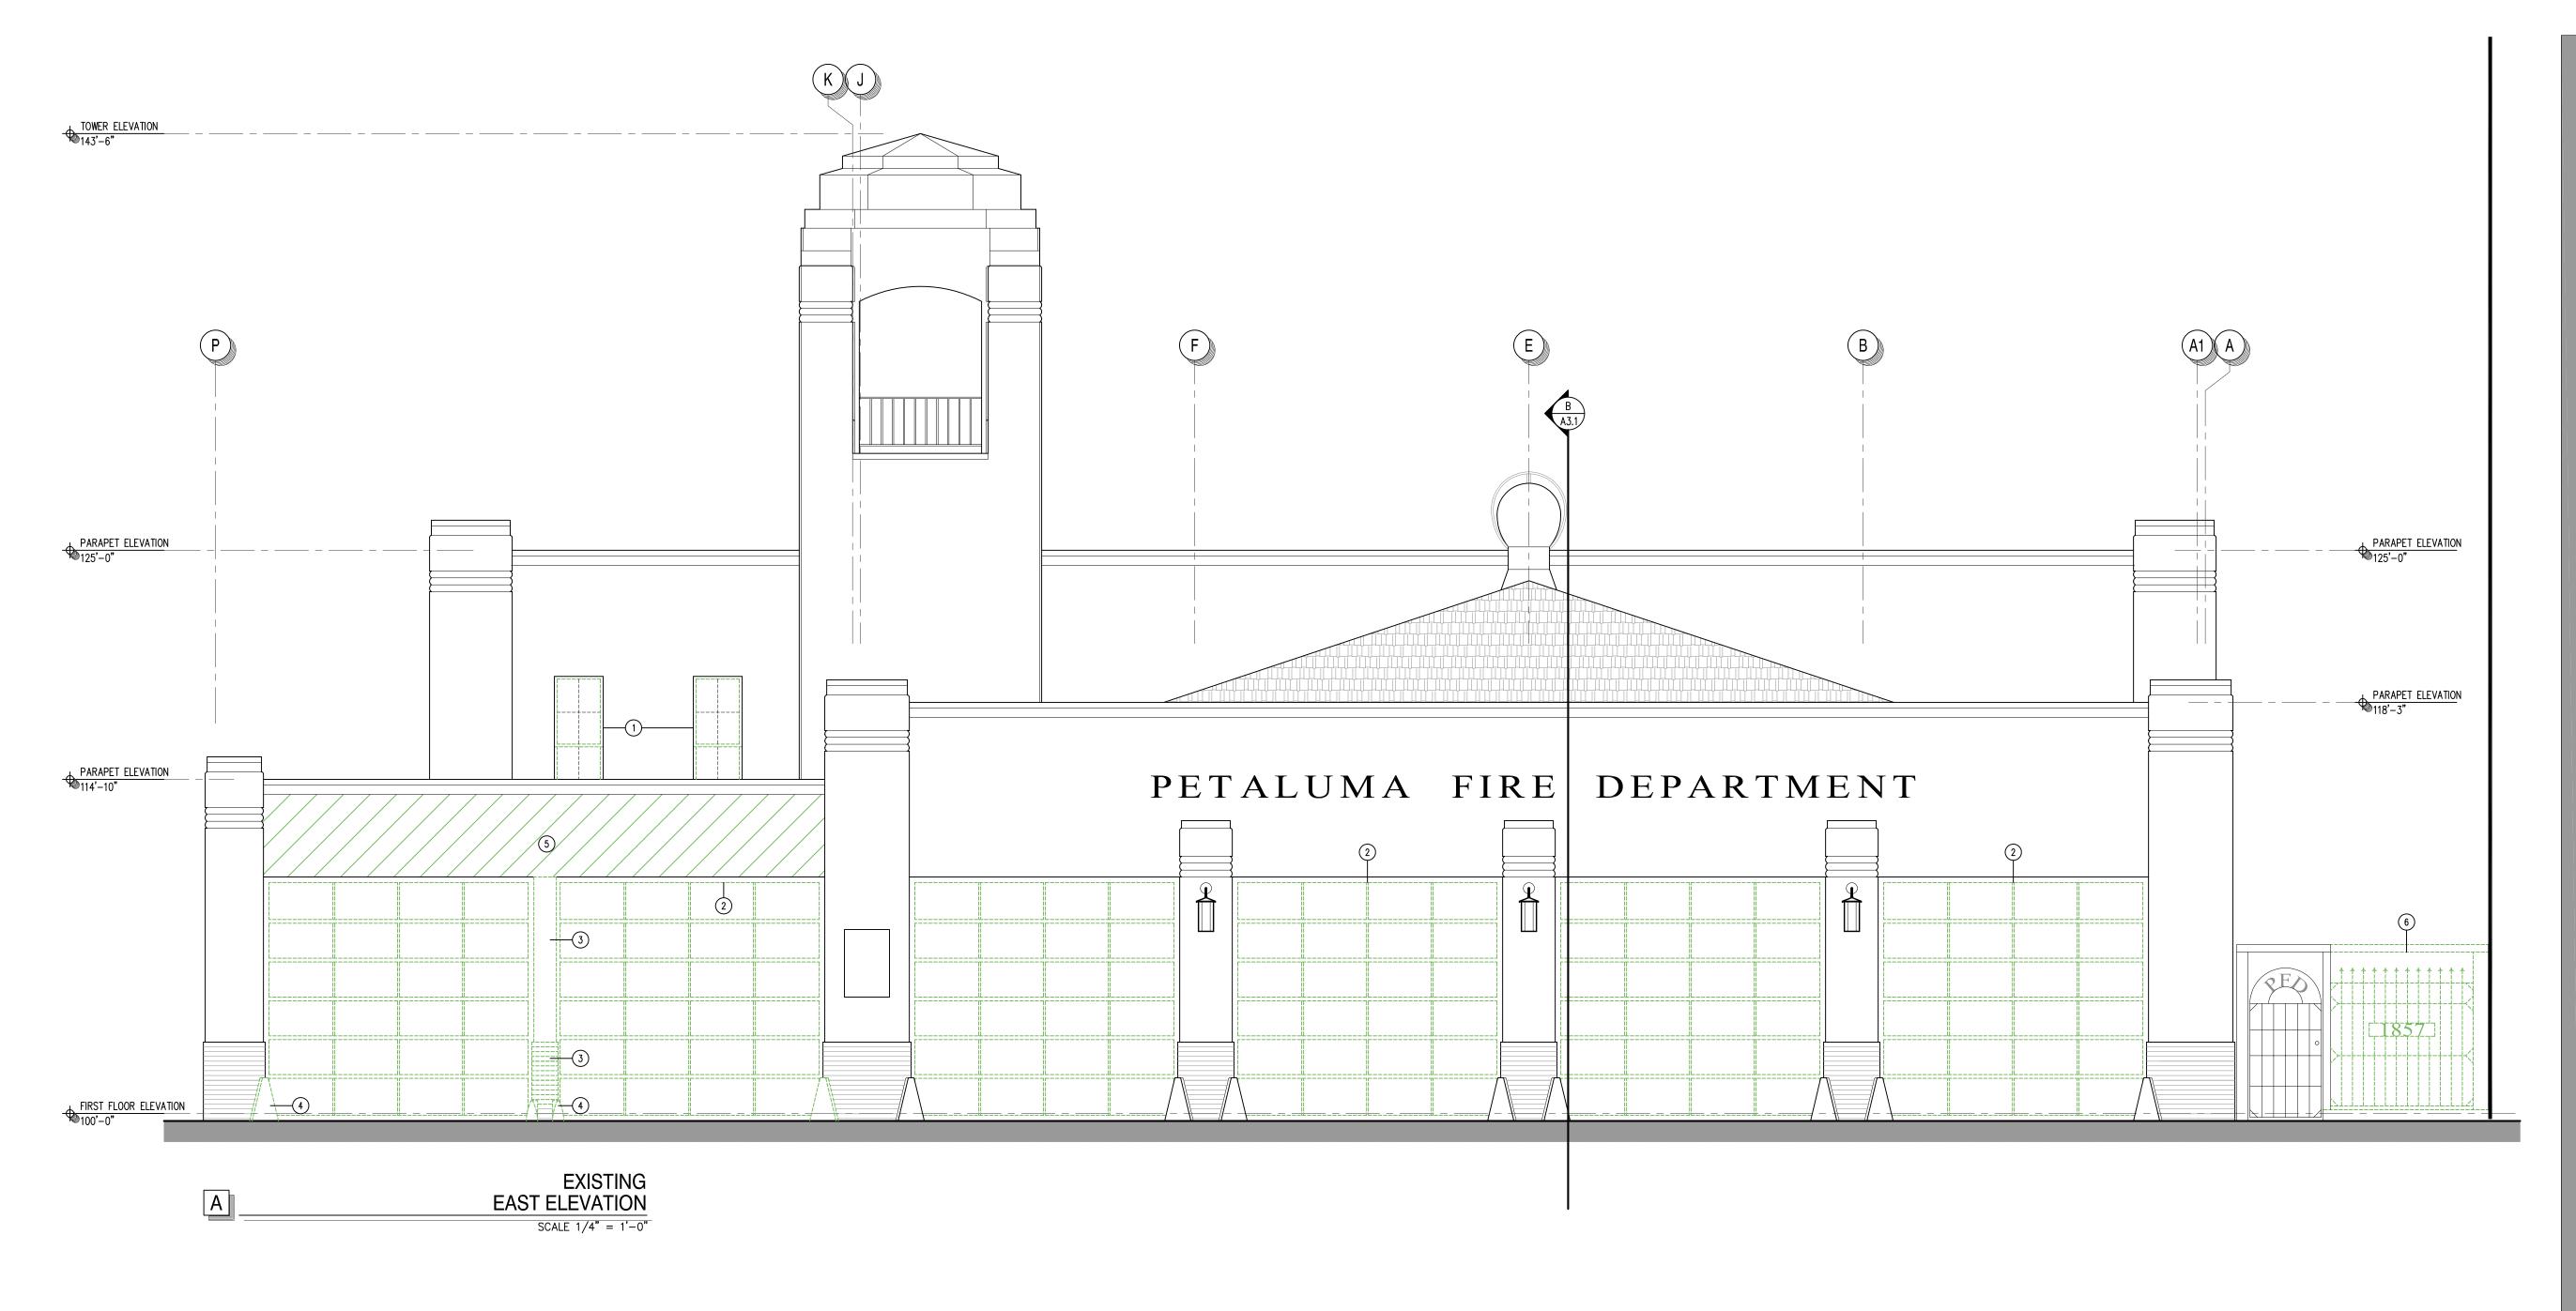

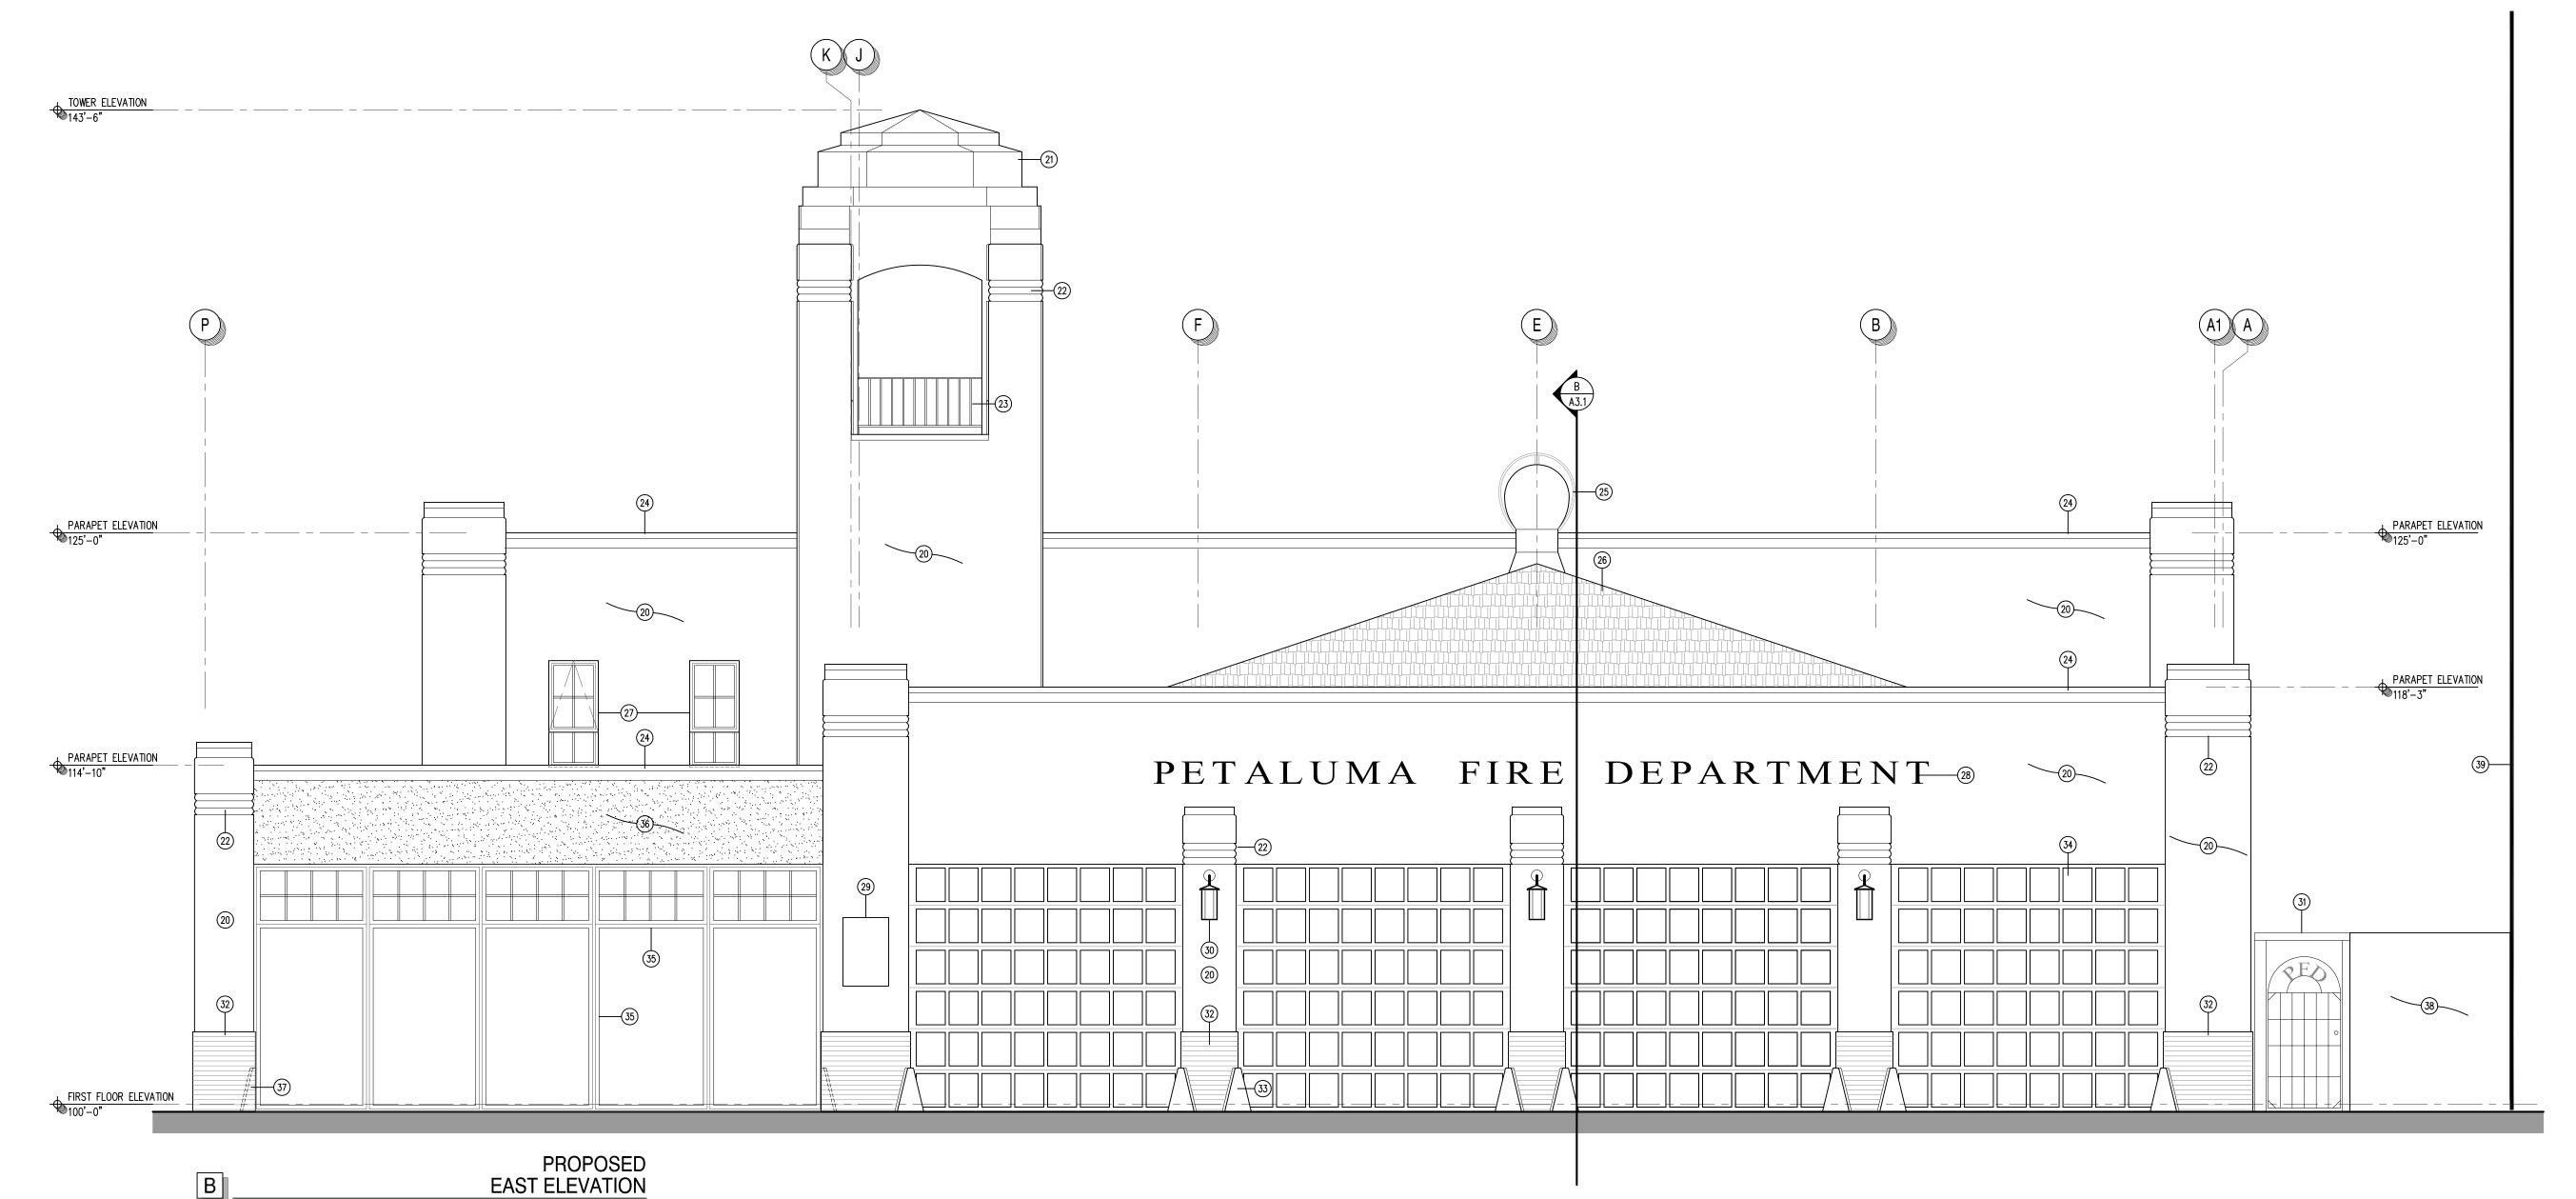


#### GENERAL NOTES and LEGEND

ALL EXISTING CONSTRUCTION IS TO REMAIN AND PROTECTED IN PLACE UNLESS NOTED OTHERWISE IN DEMOLITION REFERENCE NOTES. SEE NEW CONSTRUCTON NOTES FOR ADDITIONAL INFORMATION.

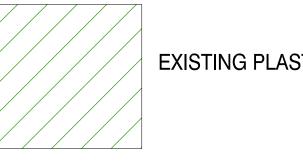

EXISTING PLASTER REMOVAL

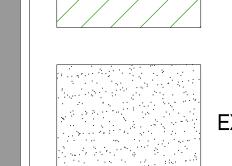


EXISTING PLASTER REPAIR OR REPLACEMENT


#### DEMOLITION REFERENCE NOTES

- 1 CUT AND REMOVE (E) STEEL WINDOW FRAME MEMBERS BACK FLUSH WITH PERIMETER STEEL FRAME. (E) STEEL WINDOW FRAME AND PERIMETER PLASTER FINISH TO REMAIN. TYPICAL FOR 2 LOCATIONS THIS ELEVATION. SEE DETAIL.
- 2 REMOVE (E) ALUMINUM APPARATUS BAY DOORS (TYPICAL OF 6) INCLUDING DOOR, TRACK, OPERATOR, AND HARDWARE.
- (3) REMOVE PLASTER JAMB AND PILLAR, INCLUDING BRICK VENEER AT BASE, WALL PLASTER, AND WOOD FRAMING. PREP OPENING TO RECEIVE
- (4) REMOVE (E) APPARATUS BAY DOOR STEEL BOLLARDS (TYPICAL OF 4).
- (5) REMOVE (E) PLASTER WALL FINISH. PROTECT WOOD FRAMING IN PLACE. PREP WALL TO RECEIVE (N) PLASTER FINISH.
- 6 REMOVE (E) WROUGHT IRON FENCE AND FRAME. STORE ONSITE FOR OWNER USE.

#### NEW CONSTRUCTION REFERENCE NOTES


- (20) (E) EXTERIOR PLASTER WITH DASH FINISH TO REMAIN. PROVIDE (N) PAINT FINISH.
- (21) (E) SHEET METAL FLASHING AND ROOFING AT TOWER ROOF. PREP AND PROVIDE (N) PAINT FINISH.
- (22) (E) PLASTER RIB DETAILING TO REMAIN. TYPICAL THROUGHOUT, PROVIDE (N) PAINT FINISH.
- (23) (E) STEEL RAILING AT TOWER TO REMAIN. STRIP AND REMOVE ALL (E) PAINT FINISH, PREP AND PROVIDE (N) PAINT FINISH.
- (E) SHEET METAL COPING AND FLASHING AT PARAPET WALLS TO REMAIN. PREP AND PROVIDE (N) PAINT FINISH. (E) TURBINE EXHAUST VENTS TO REMAIN. PREP AND PROVIDE (N) PAINT FINISH.
- (26) (E) ASPHALT SHINGLE ROOFING TO REMAIN. PROTECT IN PLACE.
- (N) ALUMINUM FRAME WINDOWS, WITH DIVIDED LITE PROFILE MATCHING ORIGINAL STEEL WINDOWS, SET INTO (E) STEEL WINDOW FRAMES. WINDOW OPERATION AS NOTED. GLAZE ALL OPENINGS WITH LOW-E INSULATED GLASS. WINDOW FRAMES AND DIVIDED LITES TO HAVE
- POWDER-COATED PAINT FINISH. (28) (E) FIRE DEPARTMENT LETTERING TO REMAIN. PROTECT IN PLACE. DO NOT PAINT.
- (29) (E) BRONZE DEDICATION PLAQUE TO REMAIN. PROTECT IN PLACE. DO NOT PAINT.
- (E) WALL-MOUNTED WROUGHT IRON DECORATIVE LIGHTS TO REMAIN. REMOVE (E) LIGHTS, PROTECT AND STORE ONSITE DURING COURSE OF CONSTRUCTION. SERVICE AND REINSTALL LIGHTS TO THEIR ORIGINAL LOCATIONS UPON COMPLETION OF ALL OTHER WORK. (TYPICAL OF 4 TO
- (E) WROUGHT IRON AND STEEL GATE AND FRAME TO REMAIN. PROTECT IN PLACE.
- (E) BRICK VENEER AT BASE OF BUILDING. STRIP AND REMOVE ALL (E) PAINT (MULTIPLE LAYERS). PREP ORIGINAL SURFACE AND PROVIDE (N) PAINT FINISH. TYPICAL ALL BRICK VENEER WALL SURFACES, JAMBS, ETC.
- (E) STEEL BOLLARDS. TYPICAL OF 2 AT EACH APPARATUS BAY DOOR. STRIP AND REMOVE ALL (E) PAINT (MULTIPLE LAYERS). PREP SURFACE AND PROVIDE (N) PAINT FINISH.
- (N) CUSTOM FABRICATED ALUMINUM FRAME APPARATUS BAY DOORS TO REPLICATE ORIGINAL 1938 CONSTRUCTION. DOORS TO HAVE SIX PANELS AND EIGHT DIVIDED LITES PER PANEL AS SHOWN. DIVIDED LITES TO BE GLAZED WITH SINGLE-PANE LAMINATED GLASS. FRAMES TO HAVE POWDER-COATED PAINT FINISH.
- (N) ALUMINUM FRAME FIXED WINDOWS WITH STEEL REINFORCED MULLIONS AND DIVIDED LITE LAYOUT. GLAZE ALL OPENINGS WITH LOW-E INSULATED GLASS. WINDOW FRAMES TO HAVE POWDER-COATED PAINT FINISH.
- (N) LATH AND PLASTER OVER (E) FRAMING AD WALL SHEATHING. (N) PLASTER FINISH TO MATCH (E) SAND TROWEL FINISH OF 1970'S CONSTRUCTION.
- (37) RESTORE OR REPLACE BRICK VENEER TO MATCH (E) BRICK VENEER WHERE STEEL STEEL BOLLARDS WERE REMOVED.
- (8) (N) TRASH ENCLOSURE WALL WITH DASH FINISH PLASTER TO MATCH (E) WALL CONSTRUCTION. PROVIDE PAINT FINISH.

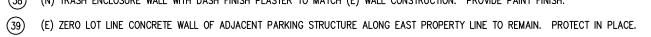

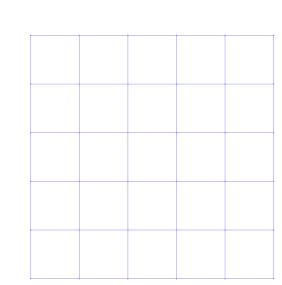

MARK ALBERTSON **ARCHITECT** 

1676 CALLE RANCHERO PETALUMA, CA 94954 TELEPHONE (707) 763-1580 mark@architects-ma.com

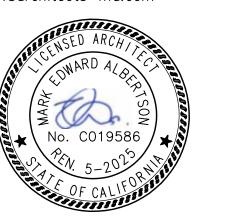



ARCHITECT'S PROJECT NO:

DRAWING STATUS:


CHECK SET: PERMIT SET: BID SET: CONSTRUCTION SET:


**REVISIONS:** 



SHEET NO.


SCALE 1/4" = 1'-0"

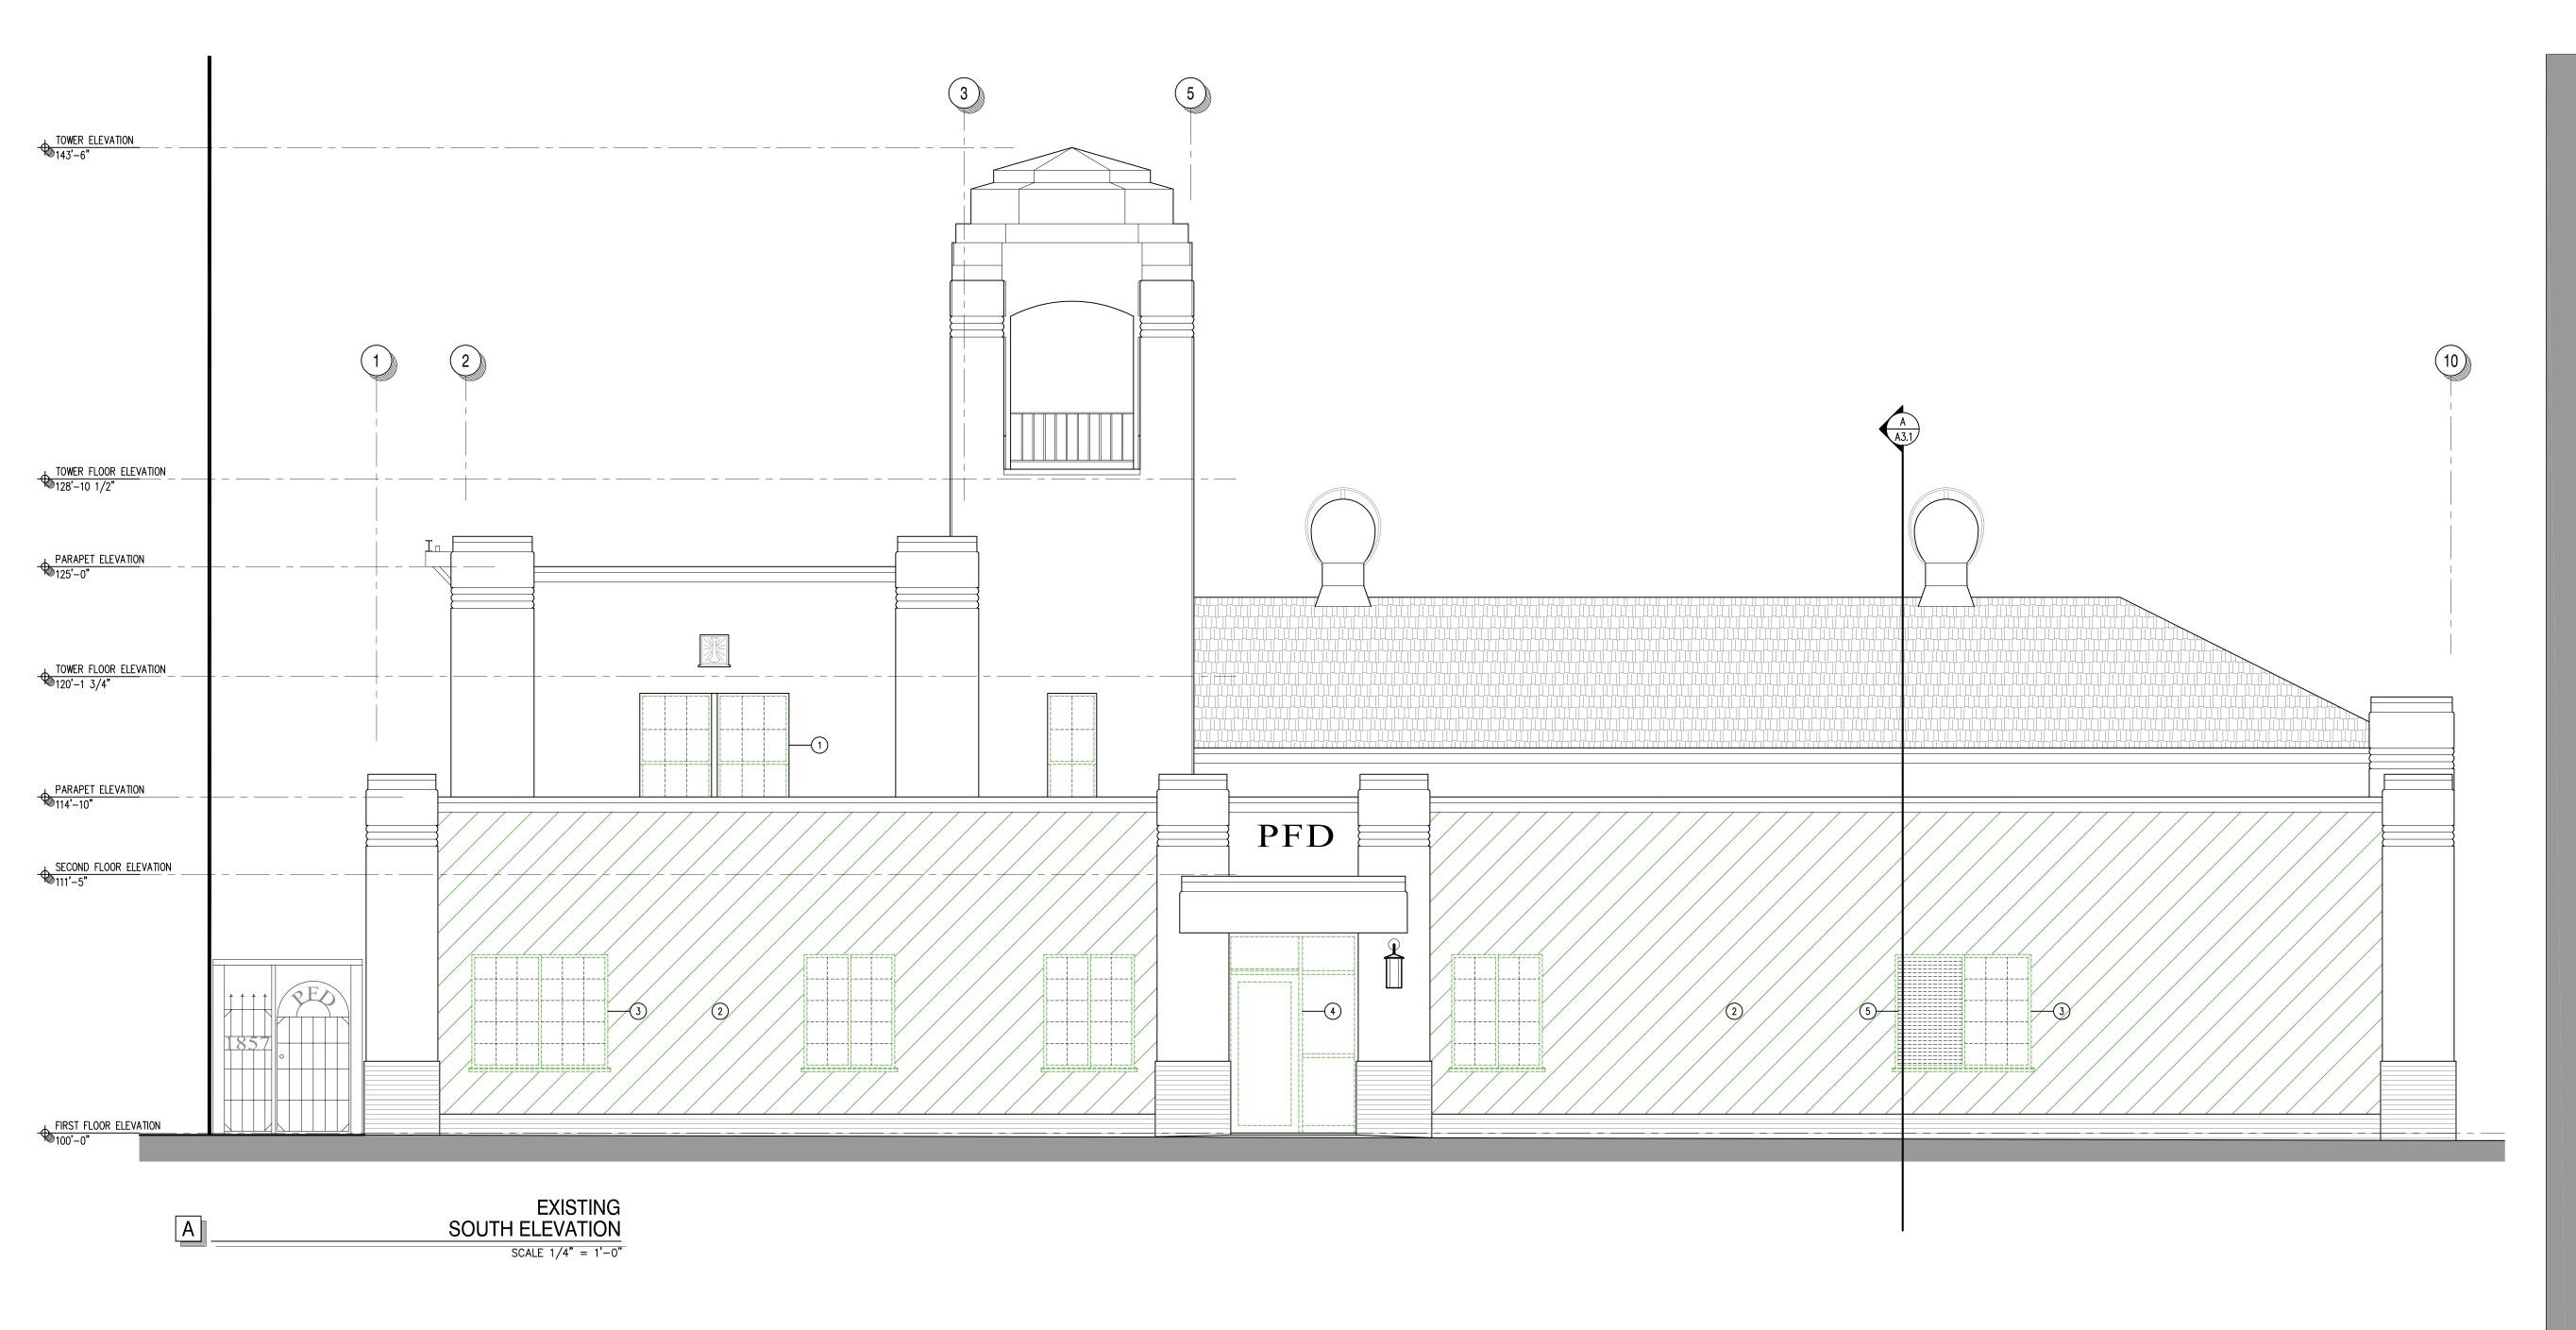


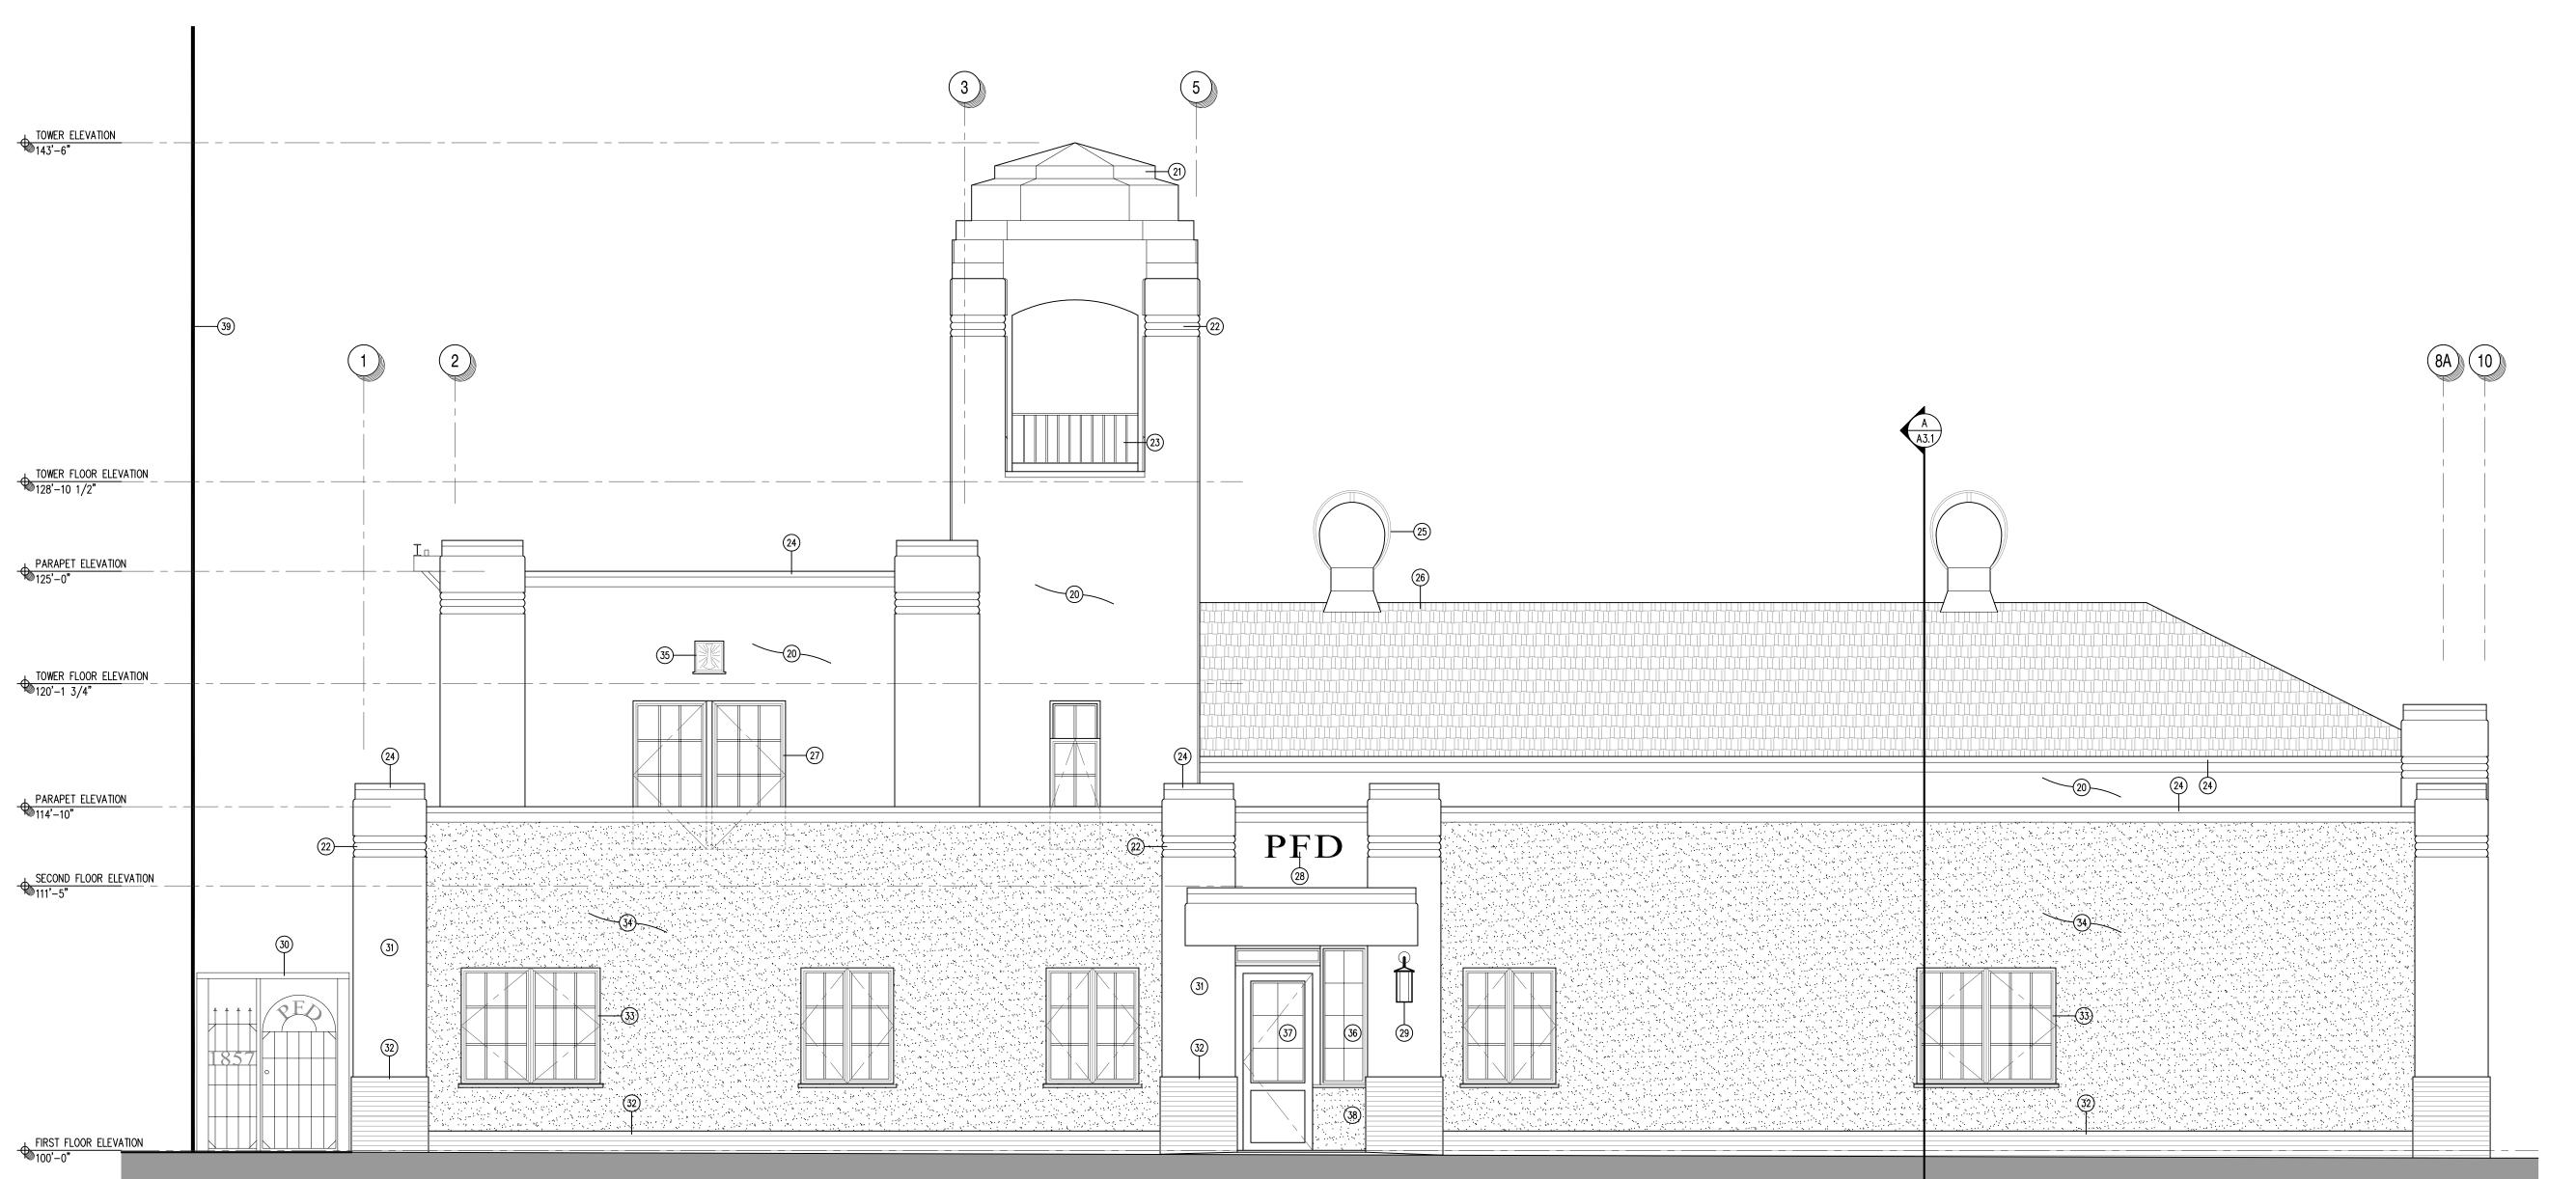

#### GENERAL NOTES and LEGEND

1. ALL EXISTING CONSTRUCTION IS TO REMAIN AND PROTECTED IN PLACE UNLESS NOTED OTHERWISE IN DEMOLITION REFERENCE NOTES. SEE NEW CONSTRUCTON NOTES FOR ADDITIONAL INFORMATION.

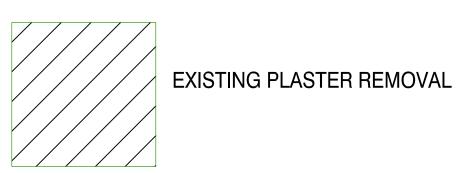

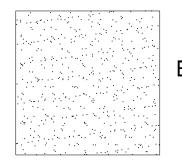

EXISTING PLASTER REPAIR OR REPLACEMENT

#### DEMOLITION REFERENCE NOTES

- CUT AND REMOVE (E) STEEL WINDOW FRAME MEMBERS BACK FLUSH WITH PERIMETER STEEL FRAME. (E) STEEL WINDOW FRAME AND PERIMETER PLASTER FINISH TO REMAIN. TYPICAL FOR 2 LOCATIONS THIS ELEVATION. SEE DETAIL.
- 2 REMOVE (E) PLASTER WALL FINISH. PROTECT WOOD FRAMING IN PLACE. PREP WALL TO RECEIVE (N) PLASTER FINISH.
- REMOVE (E) ALUMINUM HORIZONTAL SLIDING WINDOWS WITH NAIL FLANGE, COMPLETE WITH WOOD SILL. TYPICAL FOR 5 LOCATIONS THIS ELEVATION.
- 4 REMOVE (E) STOREFRONT WINDOW SYSTEM AND ENTRANCE DOOR.
- 5 REMOVE (E) STEEL GRILL.

#### NEW CONSTRUCTION REFERENCE NOTES


- (E) EXTERIOR PLASTER WITH DASH FINISH TO REMAIN. PROVIDE (N) PAINT FINISH.
- (E) SHEET METAL FLASHING AND ROOFING AT TOWER ROOF. PREP AND PROVIDE (N) PAINT FINISH.
- (E) PLASTER RIB DETAILING TO REMAIN. TYPICAL THROUGHOUT, PROVIDE (N) PAINT FINISH.
- (23) (E) STEEL RAILING AT TOWER TO REMAIN. STRIP AND REMOVE ALL (E) PAINT FINISH, PREP AND PROVIDE (N) PAINT FINISH.

  (E) SHEET METAL COPING AND FLASHING AT PARAPET WALLS TO REMAIN. PREP AND PROVIDE (N) PAINT FINISH.
- (E) TURBINE EXHAUST VENTS TO REMAIN. PREP AND PROVIDE (N) PAINT FINISH.
- (E) ASPHALT SHINGLE ROOFING TO REMAIN. PROTECT IN PLACE.
- (N) ALUMINUM FRAME WINDOWS, WITH DIVIDED LITE PROFILE MATCHING ORIGINAL STEEL WINDOWS, SET INTO (E) STEEL WINDOW FRAMES. WINDOW OPERATION AS NOTED. GLAZE ALL OPENINGS WITH LOW-E INSULATED GLASS. WINDOW FRAMES AND DIVIDED LITES TO HAVE POWDER-COATED PAINT FINISH.
- (28) (E) FIRE DEPARTMENT LETTERING TO REMAIN. PROTECT IN PLACE. DO NOT PAINT.
- (E) WALL-MOUNTED WROUGHT IRON DECORATIVE LIGHT TO REMAIN. REMOVE (E) LIGHT, PROTECT AND STORE ONSITE DURING COURSE OF CONSTRUCTION. SERVICE AND REINSTALL LIGHTS TO ITS ORIGINAL LOCATIONS UPON COMPLETION OF ALL OTHER WORK.
- (E) WROUGHT IRON AND STEEL FENCE ENCLOSURE TO REMAIN. PROTECT IN PLACE.
- (31) (E) EXTERIOR PLASTER WITH SAND TROWEL FINISH TO REMAIN. PROVIDE (N) PAINT FINISH.
- (E) BRICK VENEER AT BASE OF BUILDING. STRIP AND REMOVE ALL (E) PAINT (MULTIPLE LAYERS). PREP ORIGINAL SURFACE AND PROVIDE (N) PAINT FINISH. TYPICAL ALL BRICK VENEER WALL SURFACES, JAMBS, ETC.
- (N) ALUMINUM FRAME CASEMENT WINDOWS WITH DIVIDED LITE LAYOUT. GLAZE ALL OPENINGS WITH LOW-E INSULATED GLASS. WINDOW FRAMES TO HAVE POWDER-COATED PAINT FINISH.
- (N) LATH AND PLASTER OVER (E) FRAMING AD WALL SHEATHING. (N) PLASTER FINISH TO MATCH (E) SAND TROWEL FINISH OF 1970'S CONSTRUCTION.

(E) ZERO LOT LINE CONCRETE WALL OF ADJACENT PARKING STRUCTURE ALONG EAST PROPERTY LINE TO REMAIN. PROTECT IN PLACE.

- DECORATIVE WROUGHT IRON ATTIC VENT TO REMAIN. STRIP AND REMOVE ALL (E) PAINT FINISH, PREP AND PROVIDE (N) PAINT FINISH.


  (N) ALUMINUM FRAME FIXED WINDOWS WITH DIVIDED LITE LAYOUT
- (N) CUSTOM FABRICATED ALUMINUM ENTRANCE DOOR WITH ELEVATION DETAILS AS SHOWN.
- (N) LATH AND PLASTER WITH FINISH TO MATCH (E) SAND TROWEL FINISH OF 1970'S CONSTRUCTION.

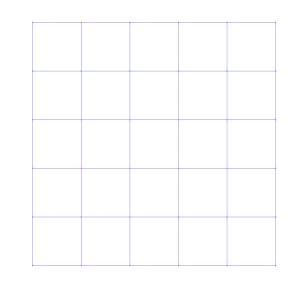

Architects MA

MARK ALBERTSON ARCHITECT

1676 CALLE RANCHERO PETALUMA, CA 94954 TELEPHONE (707) 763—1580 mark@architects—ma.com

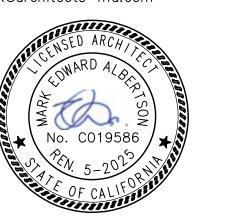



LUMA FIRE STATION NO. 1

Ig Renovation Project

California 94952

G and PROPOSED SOUTH BUILDING ELEVATIONS

ARCHITECT'S PROJECT NO:

DRAWING STATUS:

CHECK SET: JUNE 2024
PERMIT SET:
BID SET:
CONSTRUCTION SET:

REVISIONS:




SHEET NO.

PROPOSED SOUTH ELEVATION

SCALE 1/4" = 1'-0"



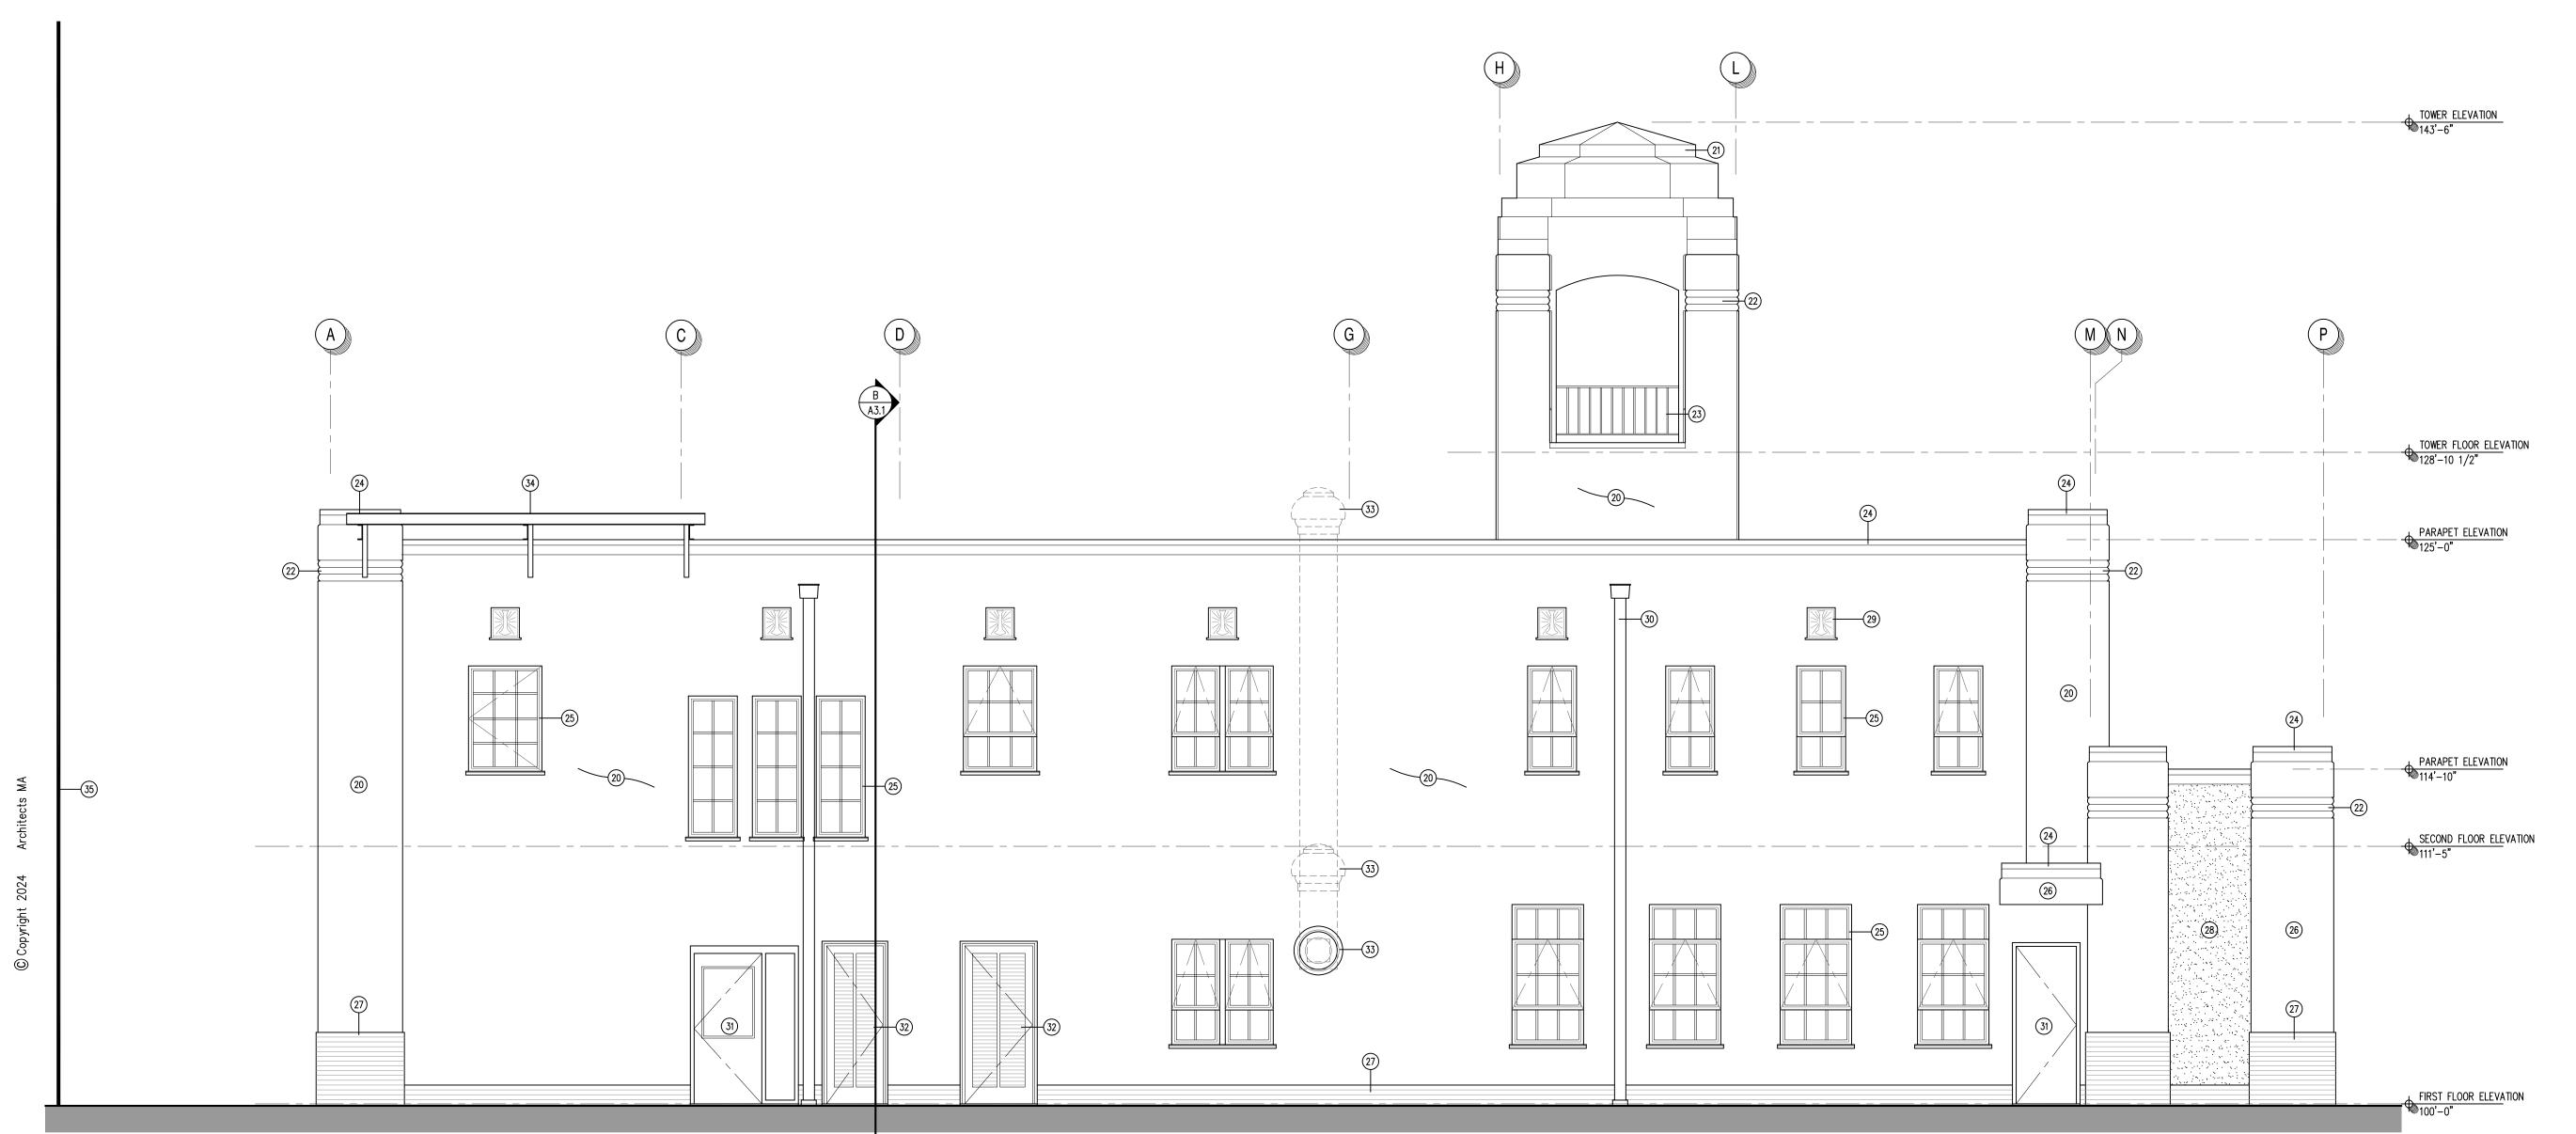

PROPOSED WEST ELEVATION


SCALE 1/4" = 1'-0"



1. ALL EXISTING CONSTRUCTION IS TO REMAIN AND PROTECTED IN PLACE UNLESS NOTED OTHERWISE IN DEMOLITION REFERENCE NOTES. SEE NEW CONSTRUCTON NOTES FOR ADDITIONAL INFORMATION.



EXISTING PLASTER REMOVAL

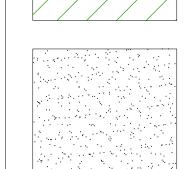

EXISTING PLASTER REPAIR OR REPLACEMENT

#### DEMOLITION REFERENCE NOTES


- 1 CUT AND REMOVE (E) STEEL WINDOW FRAME MEMBERS BACK FLUSH WITH PERIMETER STEEL FRAME. (E) STEEL WINDOW FRAME AND PERIMETER PLASTER FINISH TO REMAIN. TYPICAL FOR ALL 15 LOCATIONS THIS ELEVATION. SEE DETAIL.
- (2) REMOVE (E) PLASTER WALL FINISH. PROTECT WOOD FRAMING IN PLACE. PREP WALL TO RECEIVE (N) PLASTER FINISH.
- 3 REMOVE (E) WALL-MOUNTED EXHAUST FAN AND SHEET METAL. PREP TO RECEIVE (N) CONSTRUCTION.
- (4) REMOVE (E) LOUVERED DOOR AND FRAME. PREP OPENING TO RECEIVE (N) CONSTRUCTION.

#### NEW CONSTRUCTION REFERENCE NOTES

- (E) EXTERIOR PLASTER WITH DASH FINISH TO REMAIN. PROVIDE (N) PAINT FINISH.
- (E) SHEET METAL FLASHING AND ROOFING AT TOWER ROOF. PREP AND PROVIDE (N) PAINT FINISH.
- (2) (E) PLASTER RIB DETAILING TO REMAIN. TYPICAL THROUGHOUT, PROVIDE (N) PAINT FINISH.
- (E) STEEL RAILING AT TOWER TO REMAIN. STRIP AND REMOVE ALL (E) PAINT FINISH, PREP AND PROVIDE (N) PAINT FINISH.

  (E) SHEET METAL COPING AND FLASHING AT PARAPET WALLS TO REMAIN. PREP AND PROVIDE (N) PAINT FINISH.
- (N) ALUMINUM FRAME WINDOWS, WITH DIVIDED LITE PROFILE MATCHING ORIGINAL STEEL WINDOWS, SET INTO (E) STEEL WINDOW FRAMES. WINDOW OPERATION AS NOTED. GLAZE ALL OPENINGS WITH LOW-E INSULATED GLASS. WINDOW FRAMES AND DIVIDED LITES TO HAVE POWDER-COATED PAINT FINISH.
- (E) EXTERIOR PLASTER WITH SAND TROWEL FINISH TO REMAIN. PROVIDE (N) PAINT FINISH.
- (E) BRICK VENEER AT BASE OF BUILDING. STRIP AND REMOVE ALL (E) PAINT (MULTIPLE LAYERS). PREP ORIGINAL SURFACE AND PROVIDE (N) PAINT FINISH. TYPICAL ALL BRICK VENEER WALL SURFACES, JAMBS, ETC.
- (N) LATH AND PLASTER OVER (E) FRAMING AD WALL SHEATHING. (N) PLASTER FINISH TO MATCH (E) SAND TROWEL FINISH OF 1970'S CONSTRUCTION.
- (29) DECORATIVE WROUGHT IRON ATTIC VENT TO REMAIN. TYPICAL OF 6 THIS ELEVATION. STRIP AND REMOVE ALL (E) PAINT FINISH, PREP AND
- PROVIDE (N) PAINT FINISH.


  (30) (E) SHEET METAL DOWNSPOUT TO REMAIN. TYPICAL OF 2 THIS ELEVATION. PROVIDE (N) PAINT FINISH.
- (E) HOLLOW METAL DOOR, SIDE LITE, AND FRAME TO REMAIN. PROVIDE (N) PAINT FINISH.
- (E) HOLLOW METAL LOUVERED DOOR AND WOOD FRAME TO BE REPLACED WITH (N) DOOR AND FRAME TO MATCH. PROVIDE (N) PAINT FINISH.
- (33) (N) WALL-MOUNTED KITCHEN HOOD EXHAUST FAN AND DUCTS. EXACT CONFIGURATION TO BE DETERMINED AS SHOWN.
- (E) PARAPET-MOUNTED HOSE DRYING RACK TO REMAIN. PROTECT IN PLACE. PROVIDE (N) PAINT FINISH.
- (E) ZERO LOT LINE CONCRETE WALL OF ADJACENT PARKING STRUCTURE ALONG EAST PROPERTY LINE TO REMAIN. PROTECT IN PLACE.

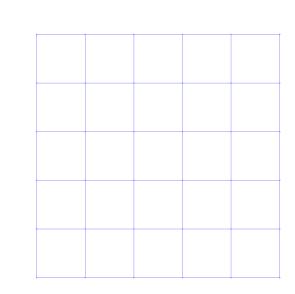

Architects MA

MARK ALBERTSON ARCHITECT

1676 CALLE RANCHERO PETALUMA, CA 94954 TELEPHONE (707) 763—1580 mark@architects—ma.com

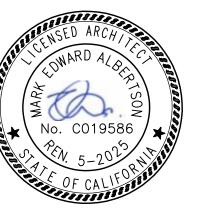



LUMA FIRE STATION NO. 1

Ig Renovation Project

Salifornia 94952

ARCHITECT'S PROJECT NO:

DRAWING STATUS:


CHECK SET: JUNE 2024
PERMIT SET:
BID SET:
CONSTRUCTION SET:


REVISIONS:



SHEET NO.

12.3

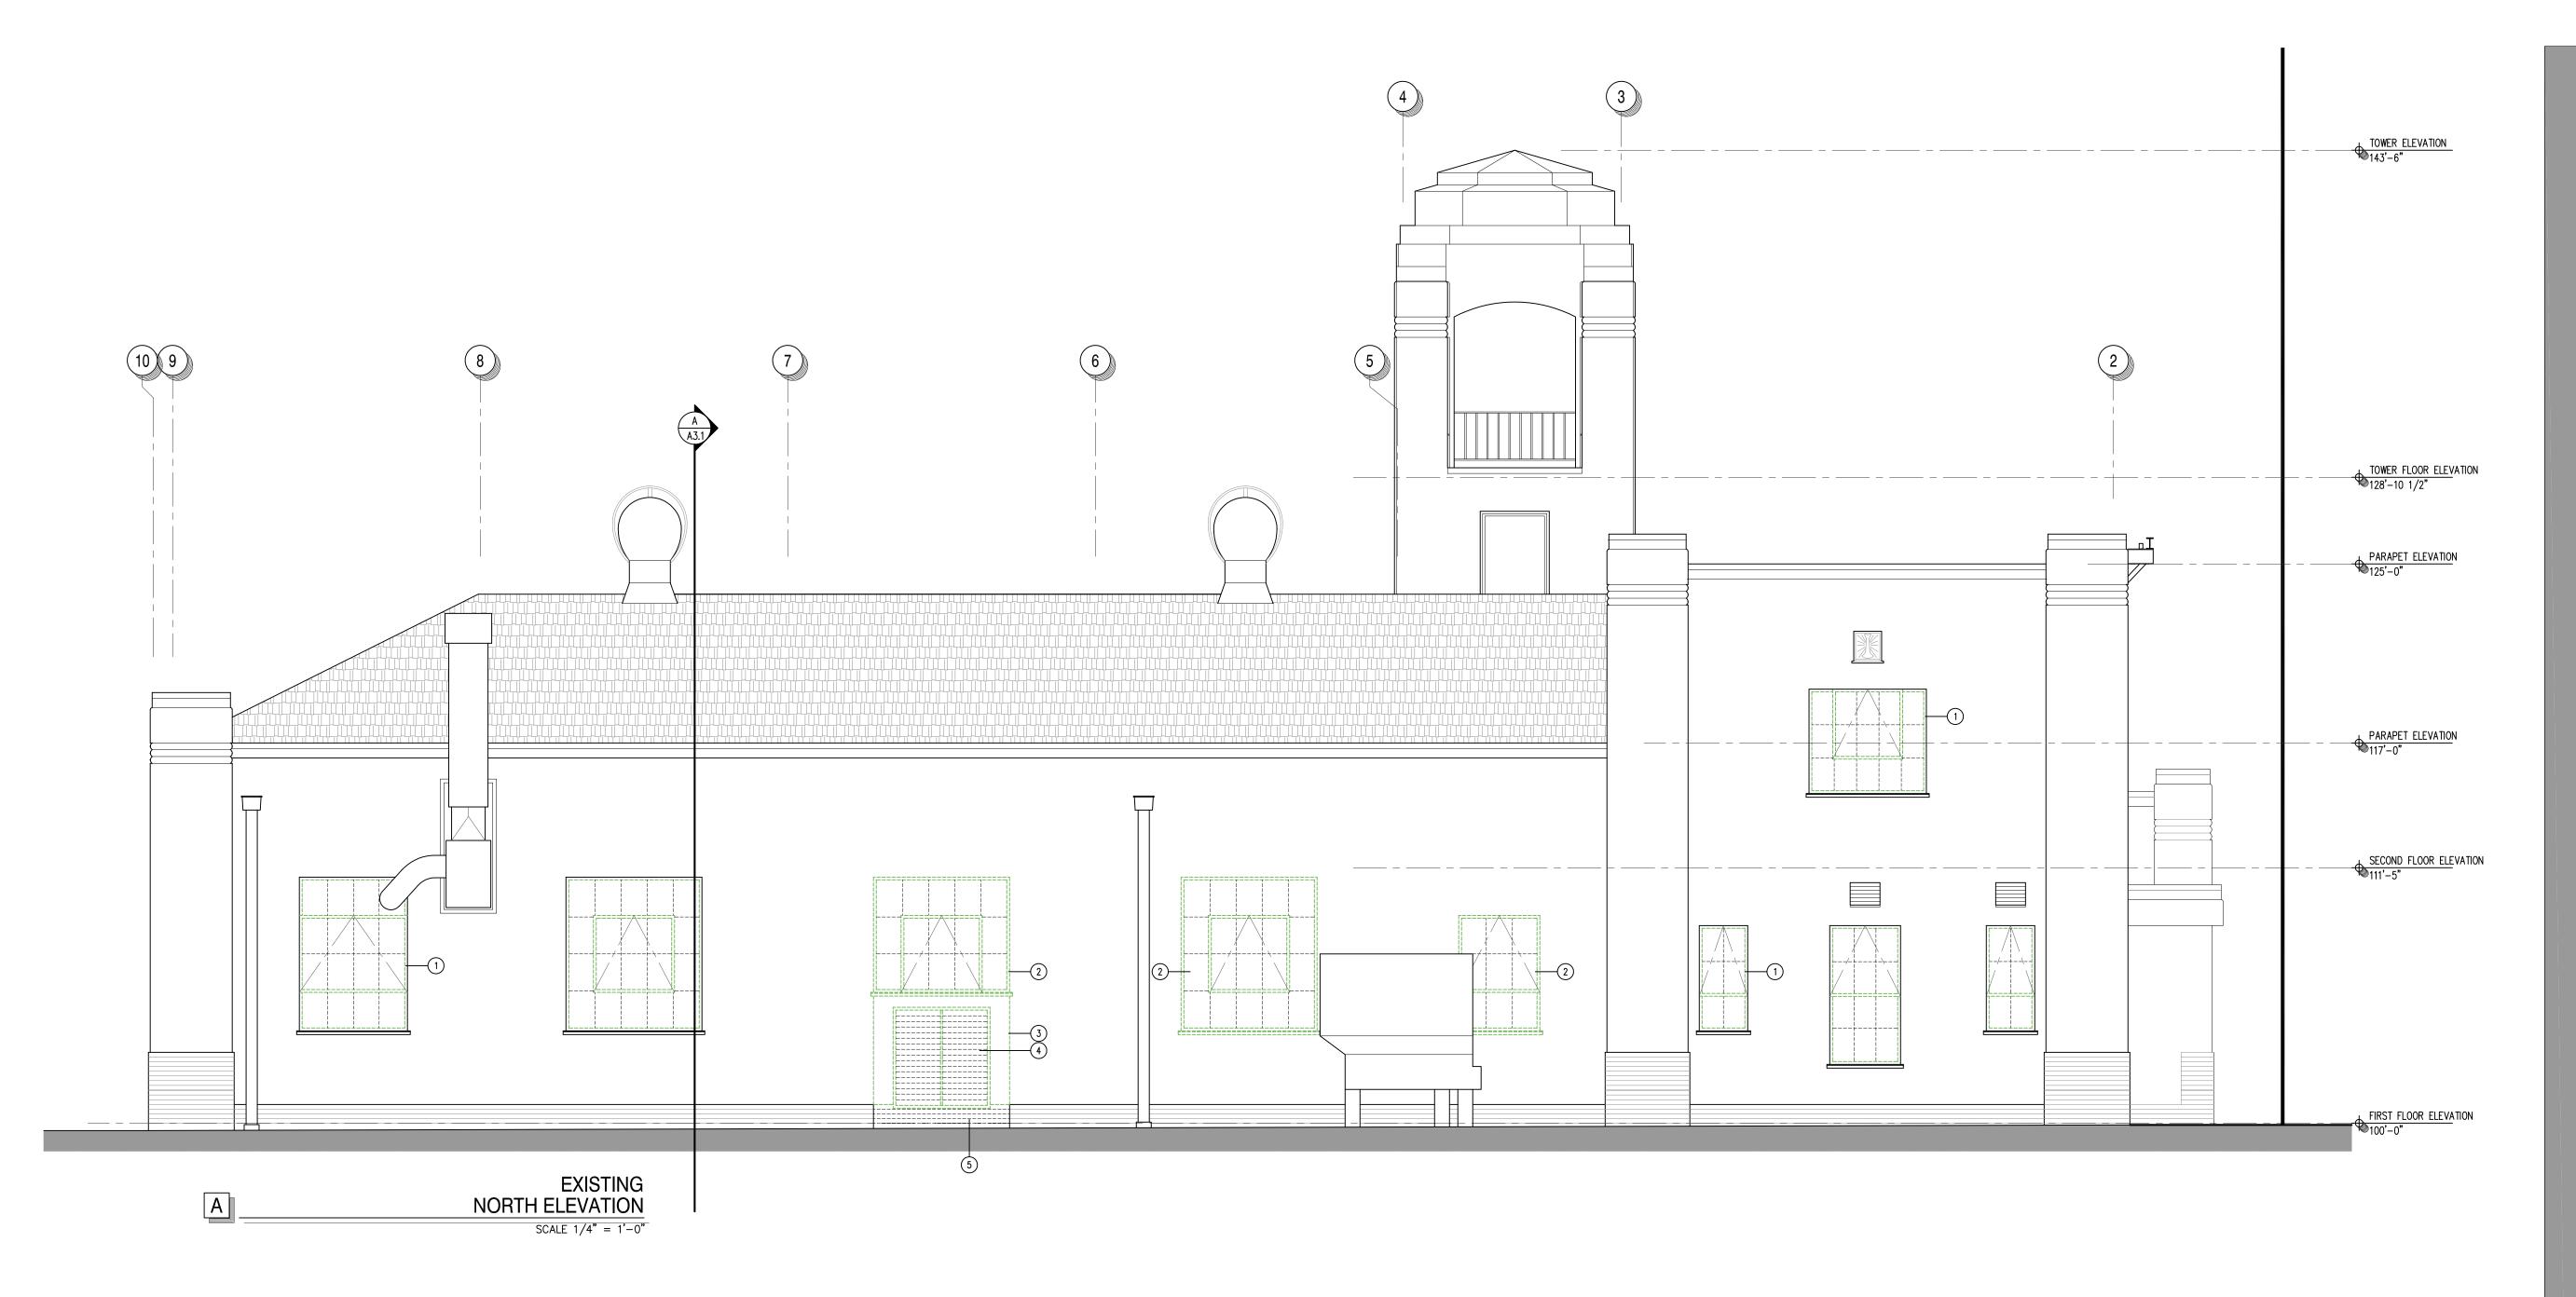

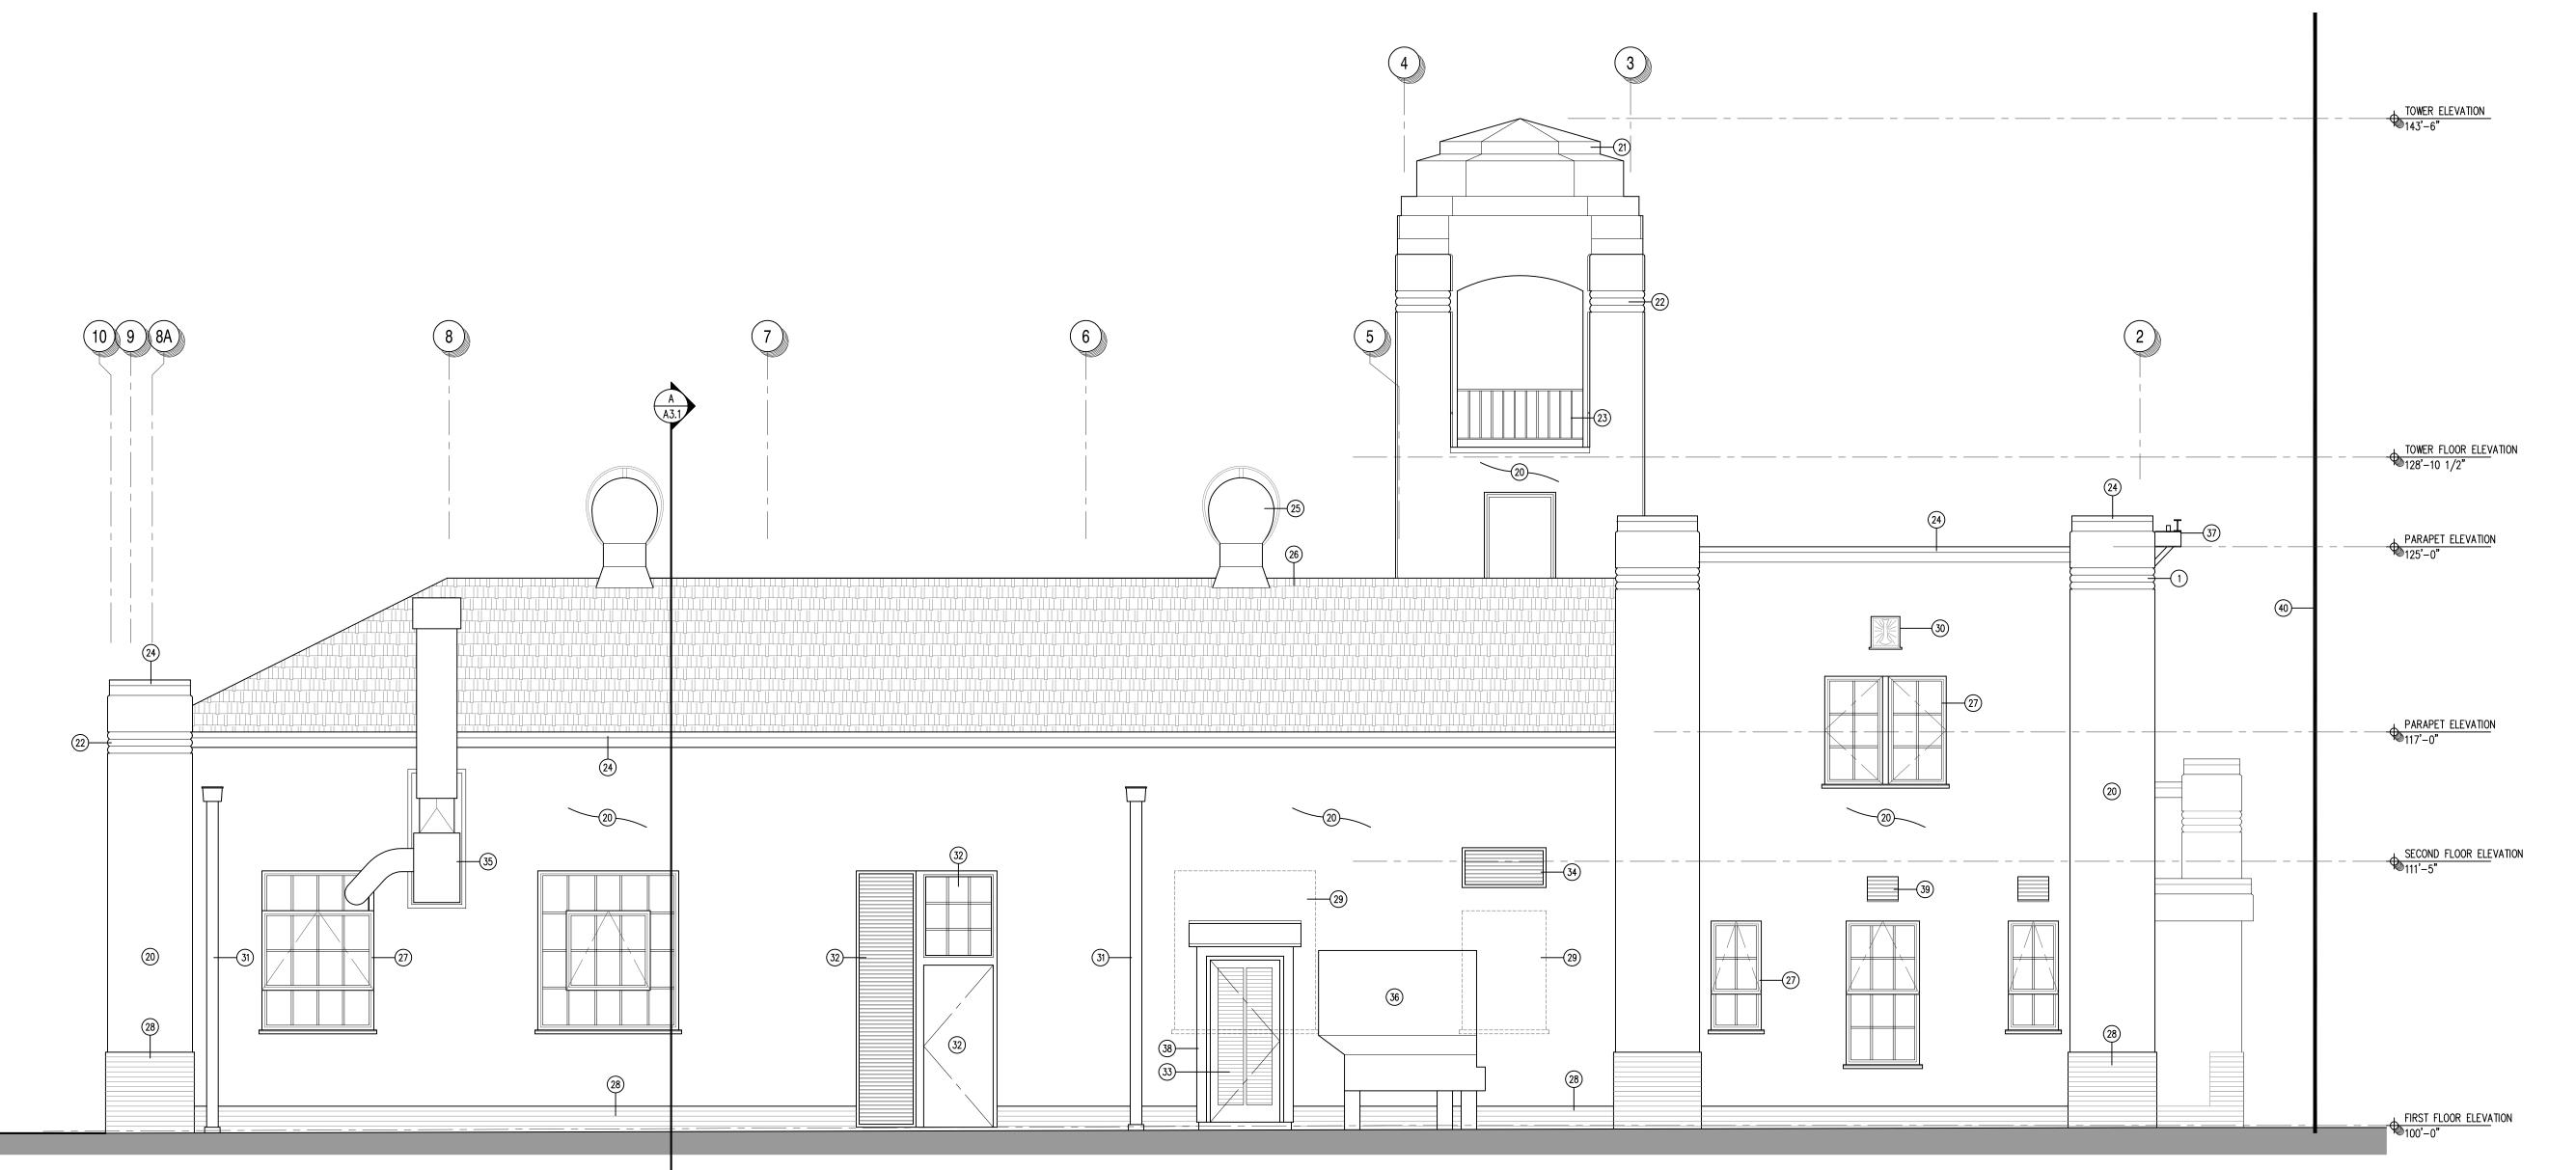

#### GENERAL NOTES and LEGEND

. ALL EXISTING CONSTRUCTION IS TO REMAIN AND PROTECTED IN PLACE UNLESS NOTED OTHERWISE IN DEMOLITION REFERENCE NOTES. SEE NEW CONSTRUCTON NOTES FOR ADDITIONAL INFORMATION.

#### DEMOLITION REFERENCE NOTES

- CUT AND REMOVE (E) STEEL WINDOW FRAME MEMBERS BACK FLUSH WITH PERIMETER STEEL FRAME. (E) STEEL WINDOW FRAME AND PERIMETER PLASTER FINISH TO REMAIN. TYPICAL FOR 6 LOCATIONS THIS ELEVATION. SEE DETAIL.
- 2 REMOVE ENTIRE (E) STEEL WINDOW INCLUDING FRAME AND SILL. TYPICAL FOR 3 LOCATIONS THIS ELEVATION.
- 3 REMOVE (E) PLASTER WALL FINISH AND WOOD FRAMING TO ACCOMMODATE (N) DOOR FRAME AND OPENING.
- (4) REMOVE (E) THRU-WALL EXHAUST FAN LOUVER. PREP TO RECEIVE (N) CONSTRUCTION.
- 5 REMOVE (E) BRICK VENEER.

#### NEW CONSTRUCTION REFERENCE NOTES


- (20) (E) EXTERIOR PLASTER WITH DASH FINISH TO REMAIN. PROVIDE (N) PAINT FINISH.
- (E) SHEET METAL FLASHING AND ROOFING AT TOWER ROOF. PREP AND PROVIDE (N) PAINT FINISH.
- (22) (E) PLASTER RIB DETAILING TO REMAIN. TYPICAL THROUGHOUT, PROVIDE (N) PAINT FINISH. (E) STEEL RAILING AT TOWER TO REMAIN. STRIP AND REMOVE ALL (E) PAINT FINISH, PREP AND PROVIDE (N) PAINT FINISH.
- (24) (E) SHEET METAL COPING AND FLASHING AT PARAPET WALLS TO REMAIN. PREP AND PROVIDE (N) PAINT FINISH.
- (25) (E) TURBINE EXHAUST VENTS TO REMAIN. PREP AND PROVIDE (N) PAINT FINISH.

(26) (E) ASPHALT SHINGLE ROOFING TO REMAIN. PROTECT IN PLACE.

- (N) ALUMINUM FRAME WINDOWS, WITH DIVIDED LITE PROFILE MATCHING ORIGINAL STEEL WINDOWS, SET INTO (E) STEEL WINDOW FRAMES. WINDOW OPERATION AS NOTED. GLAZE ALL OPENINGS WITH LOW-E INSULATED GLASS. WINDOW FRAMES AND DIVIDED LITES TO HAVE POWDER-COATED PAINT FINISH.
- (E) BRICK VENEER AT BASE OF BUILDING. STRIP AND REMOVE ALL (E) PAINT (MULTIPLE LAYERS). PREP ORIGINAL SURFACE AND PROVIDE (N) PAINT FINISH. TYPICAL ALL BRICK VENEER WALL SURFACES, JAMBS, ETC.
- (N) LATH AND PLASTER INFILL AT REMOVED WINDOW WITH DASH PLASTER FINISH TO MATCH (E). PROVIDE PAINT FINISH.
- (30) DECORATIVE WROUGHT IRON ATTIC VENT TO REMAIN. TYPICAL OF 6 THIS ELEVATION. STRIP AND REMOVE ALL (E) PAINT FINISH, PREP AND PROVIDE (N) PAINT FINISH. (31) (E) SHEET METAL DOWNSPOUT TO REMAIN. TYPICAL OF 2 THIS ELEVATION. PROVIDE (N) PAINT FINISH.
- (N) HOLLOW METAL DOOR, FRAME, LOUVER, AND DIVIDED-LITE WINDOW. PROVIDE PAINT FINISH.
- (33) (N) HOLLOW METAL LOUVERED DOOR AND FRAME. PROVIDE PAINT FINISH.
- (34) (N) THRU-WALL EXHAUST FAN LOUVER. PROVIDE PAINT FINISH.
- (35) (E) WALL-MOUNTED EXHAUST FAN AND SHEET METAL DUCT TO REMAIN. COORDINATE WITH (N) WINDOW INSTALLATION. (36) (E) GROUND-MOUNTED EMERGENCY GENERATOR TO REMAIN. PROTECT IN PLACE.
- (37) (E) PARAPET-MOUNTED HOSE DRYING RACK TO REMAIN. PROTECT IN PLACE. PROVIDE (N) PAINT FINISH.

(39) (E) SHEET METAL LOUVER TO REMAIN. TYPICAL OF 2 THIS ELEVATION. PROVIDE (N) PAINT FINISH.

- (N) WOOD FRAMED AIR COMPRESSOR ENCLOSURE WITH (N) DASH PLASTER FINISH TO MATCH (E). ROOF WITH ASPHALT SHINGLES TO MATCH (E) ROOF.
- (E) ZERO LOT LINE CONCRETE WALL OF ADJACENT PARKING STRUCTURE ALONG EAST PROPERTY LINE TO REMAIN. PROTECT IN PLACE.

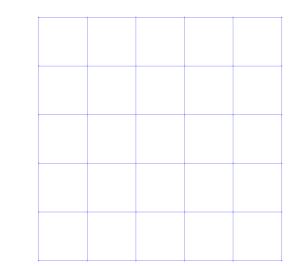

#### MARK ALBERTSON **ARCHITECT**

1676 CALLE RANCHERO PETALUMA, CA 94954 TELEPHONÉ (707) 763-1580 mark@architects-ma.com





# Nation Project **EXISTING** and PROP

ARCHITECT'S PROJECT NO:

DRAWING STATUS:

CHECK SET:
PERMIT SET:
BID SET:
CONSTRUCTION SET:


REVISIONS:




SHEET NO.

PROPOSED NORTH ELEVATION


SCALE 1/4" = 1'-0"

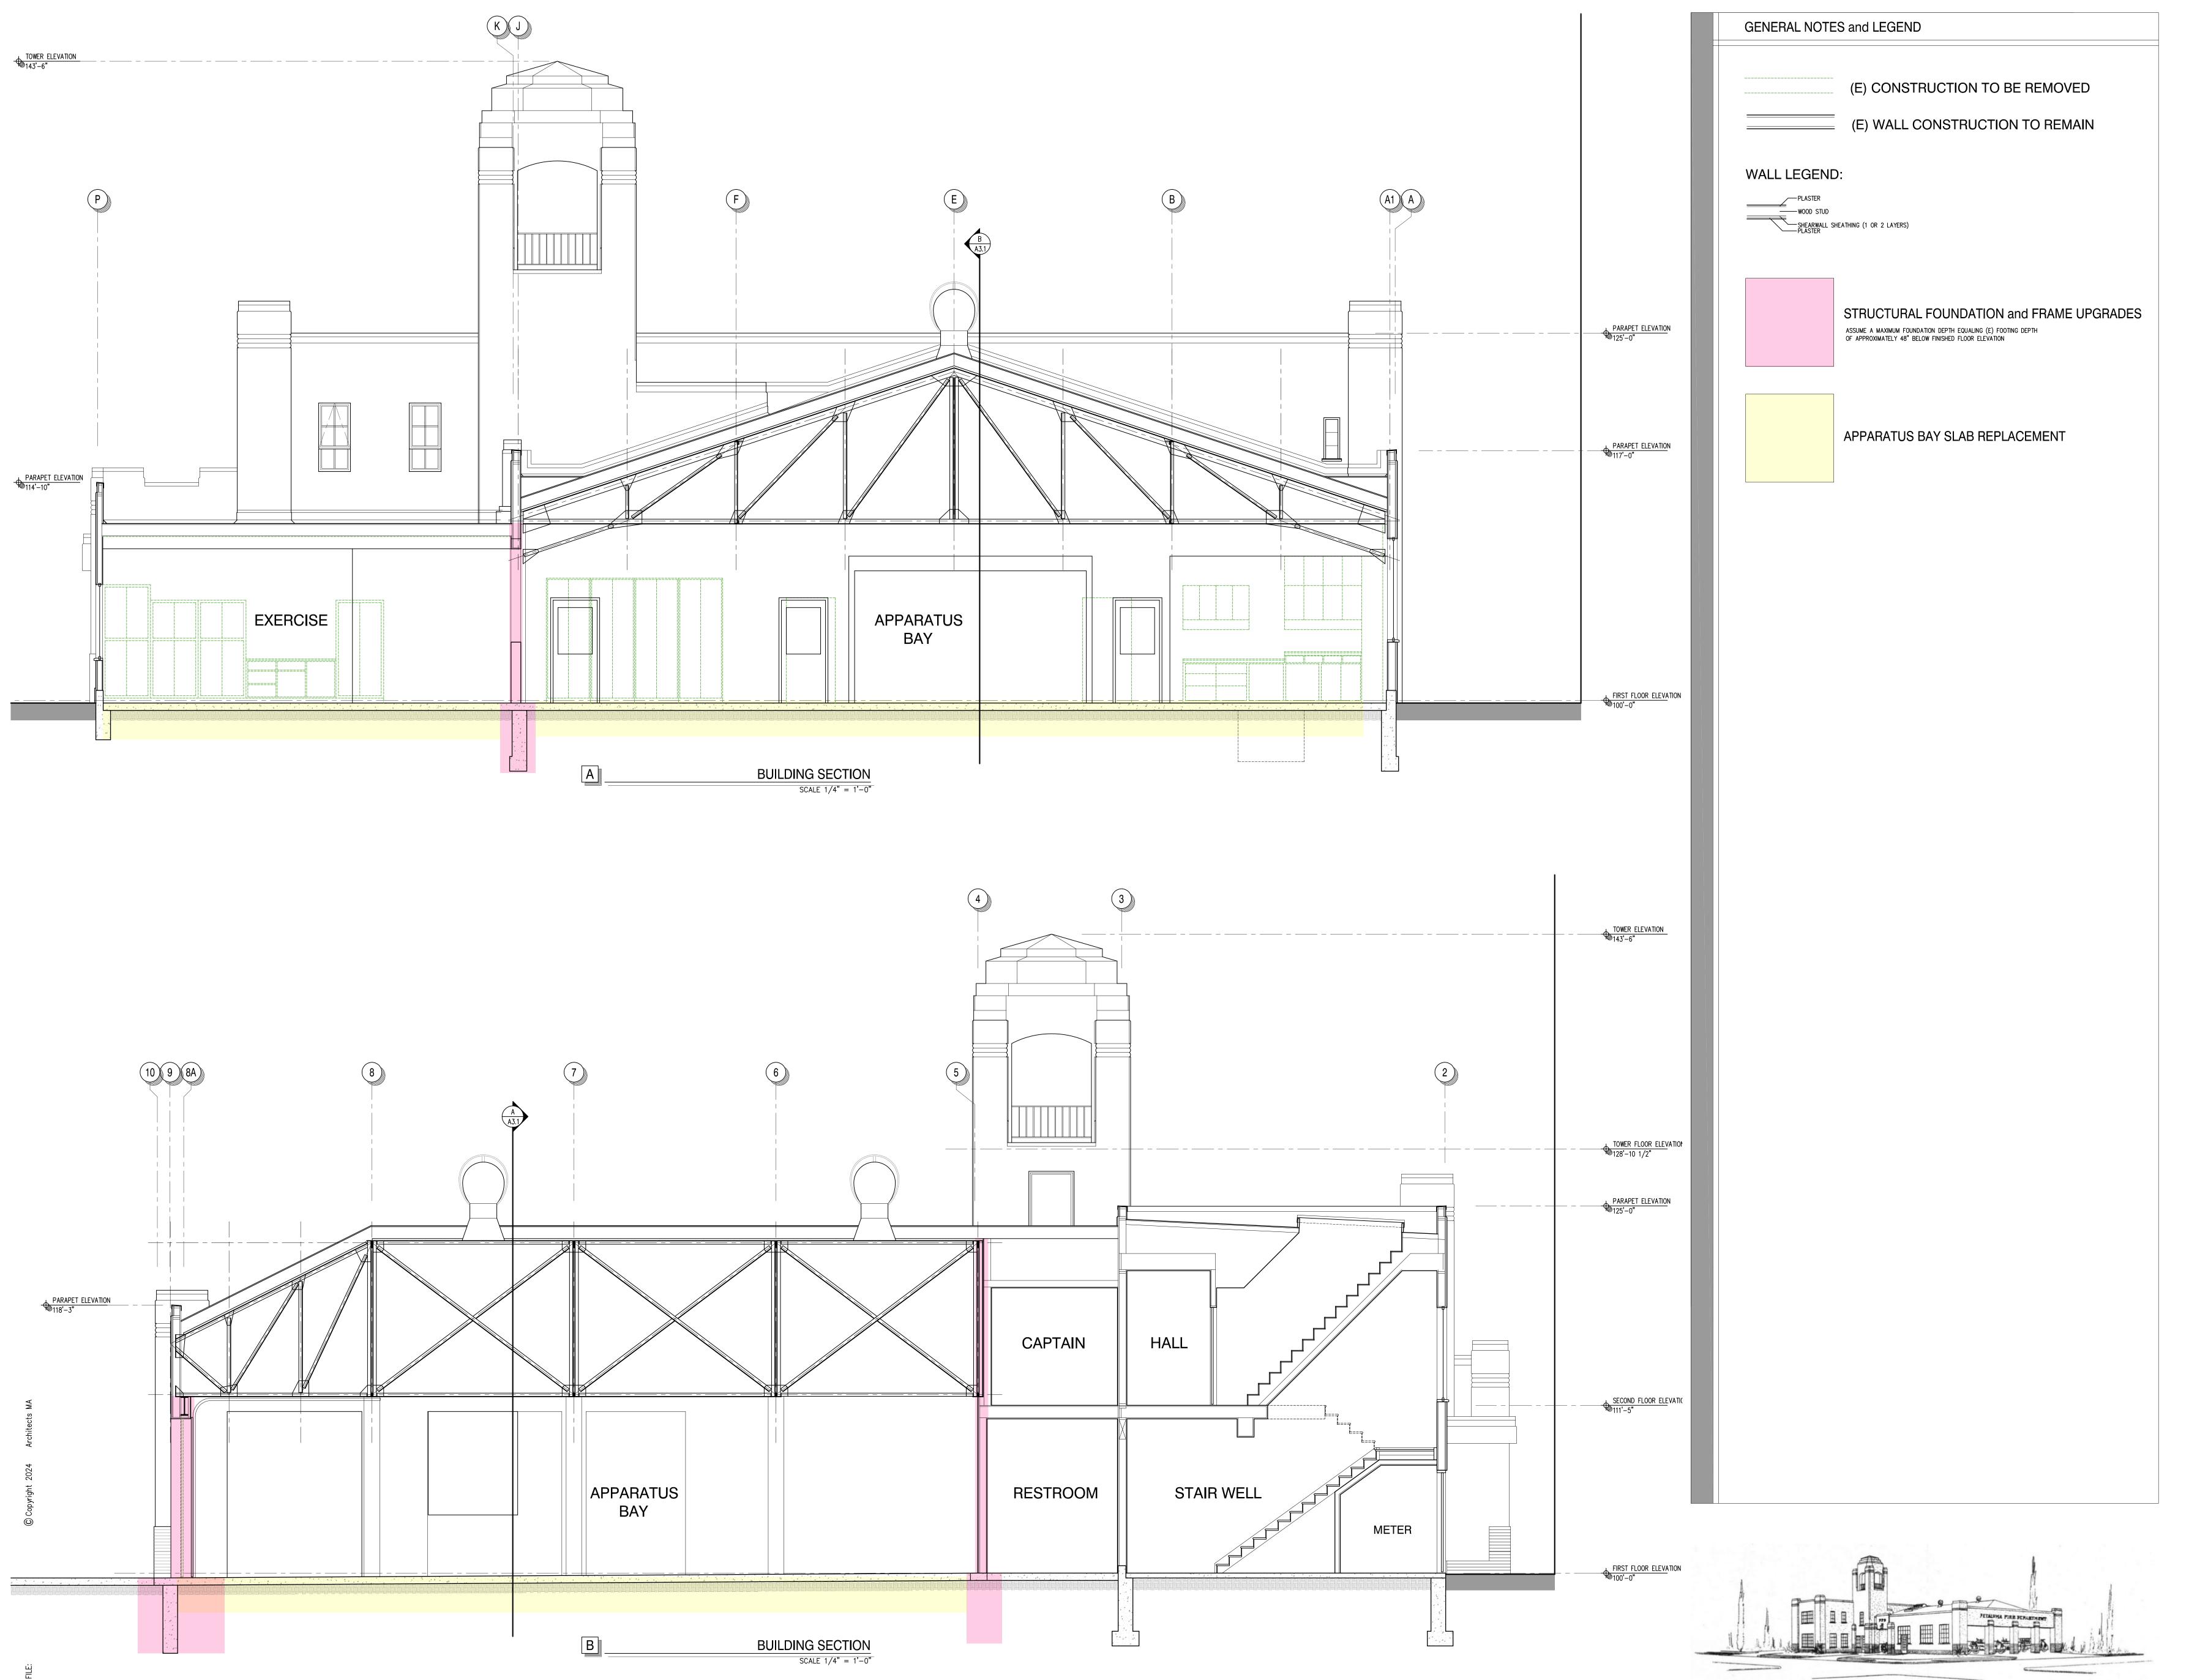

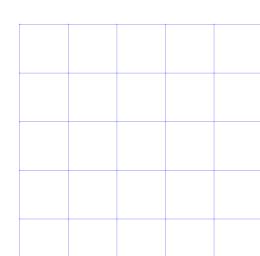

MARK ALBERTSON ARCHITECT

1676 CALLE RANCHERO
PETALUMA, CA 94954
TELEPHONE (707) 763—1580
mark@architects—ma.com

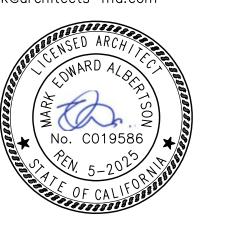



PETALUMA FIRE STATION NO. 1
Building Renovation Project


8 D Street taluma, California 94952 JILDING SECTIONS


ARCHITECT'S PROJECT NO:

DRAWING STATUS:

CHECK SET: JUNE 20
PERMIT SET:
BID SET:
CONSTRUCTION SET:


REVISIONS:

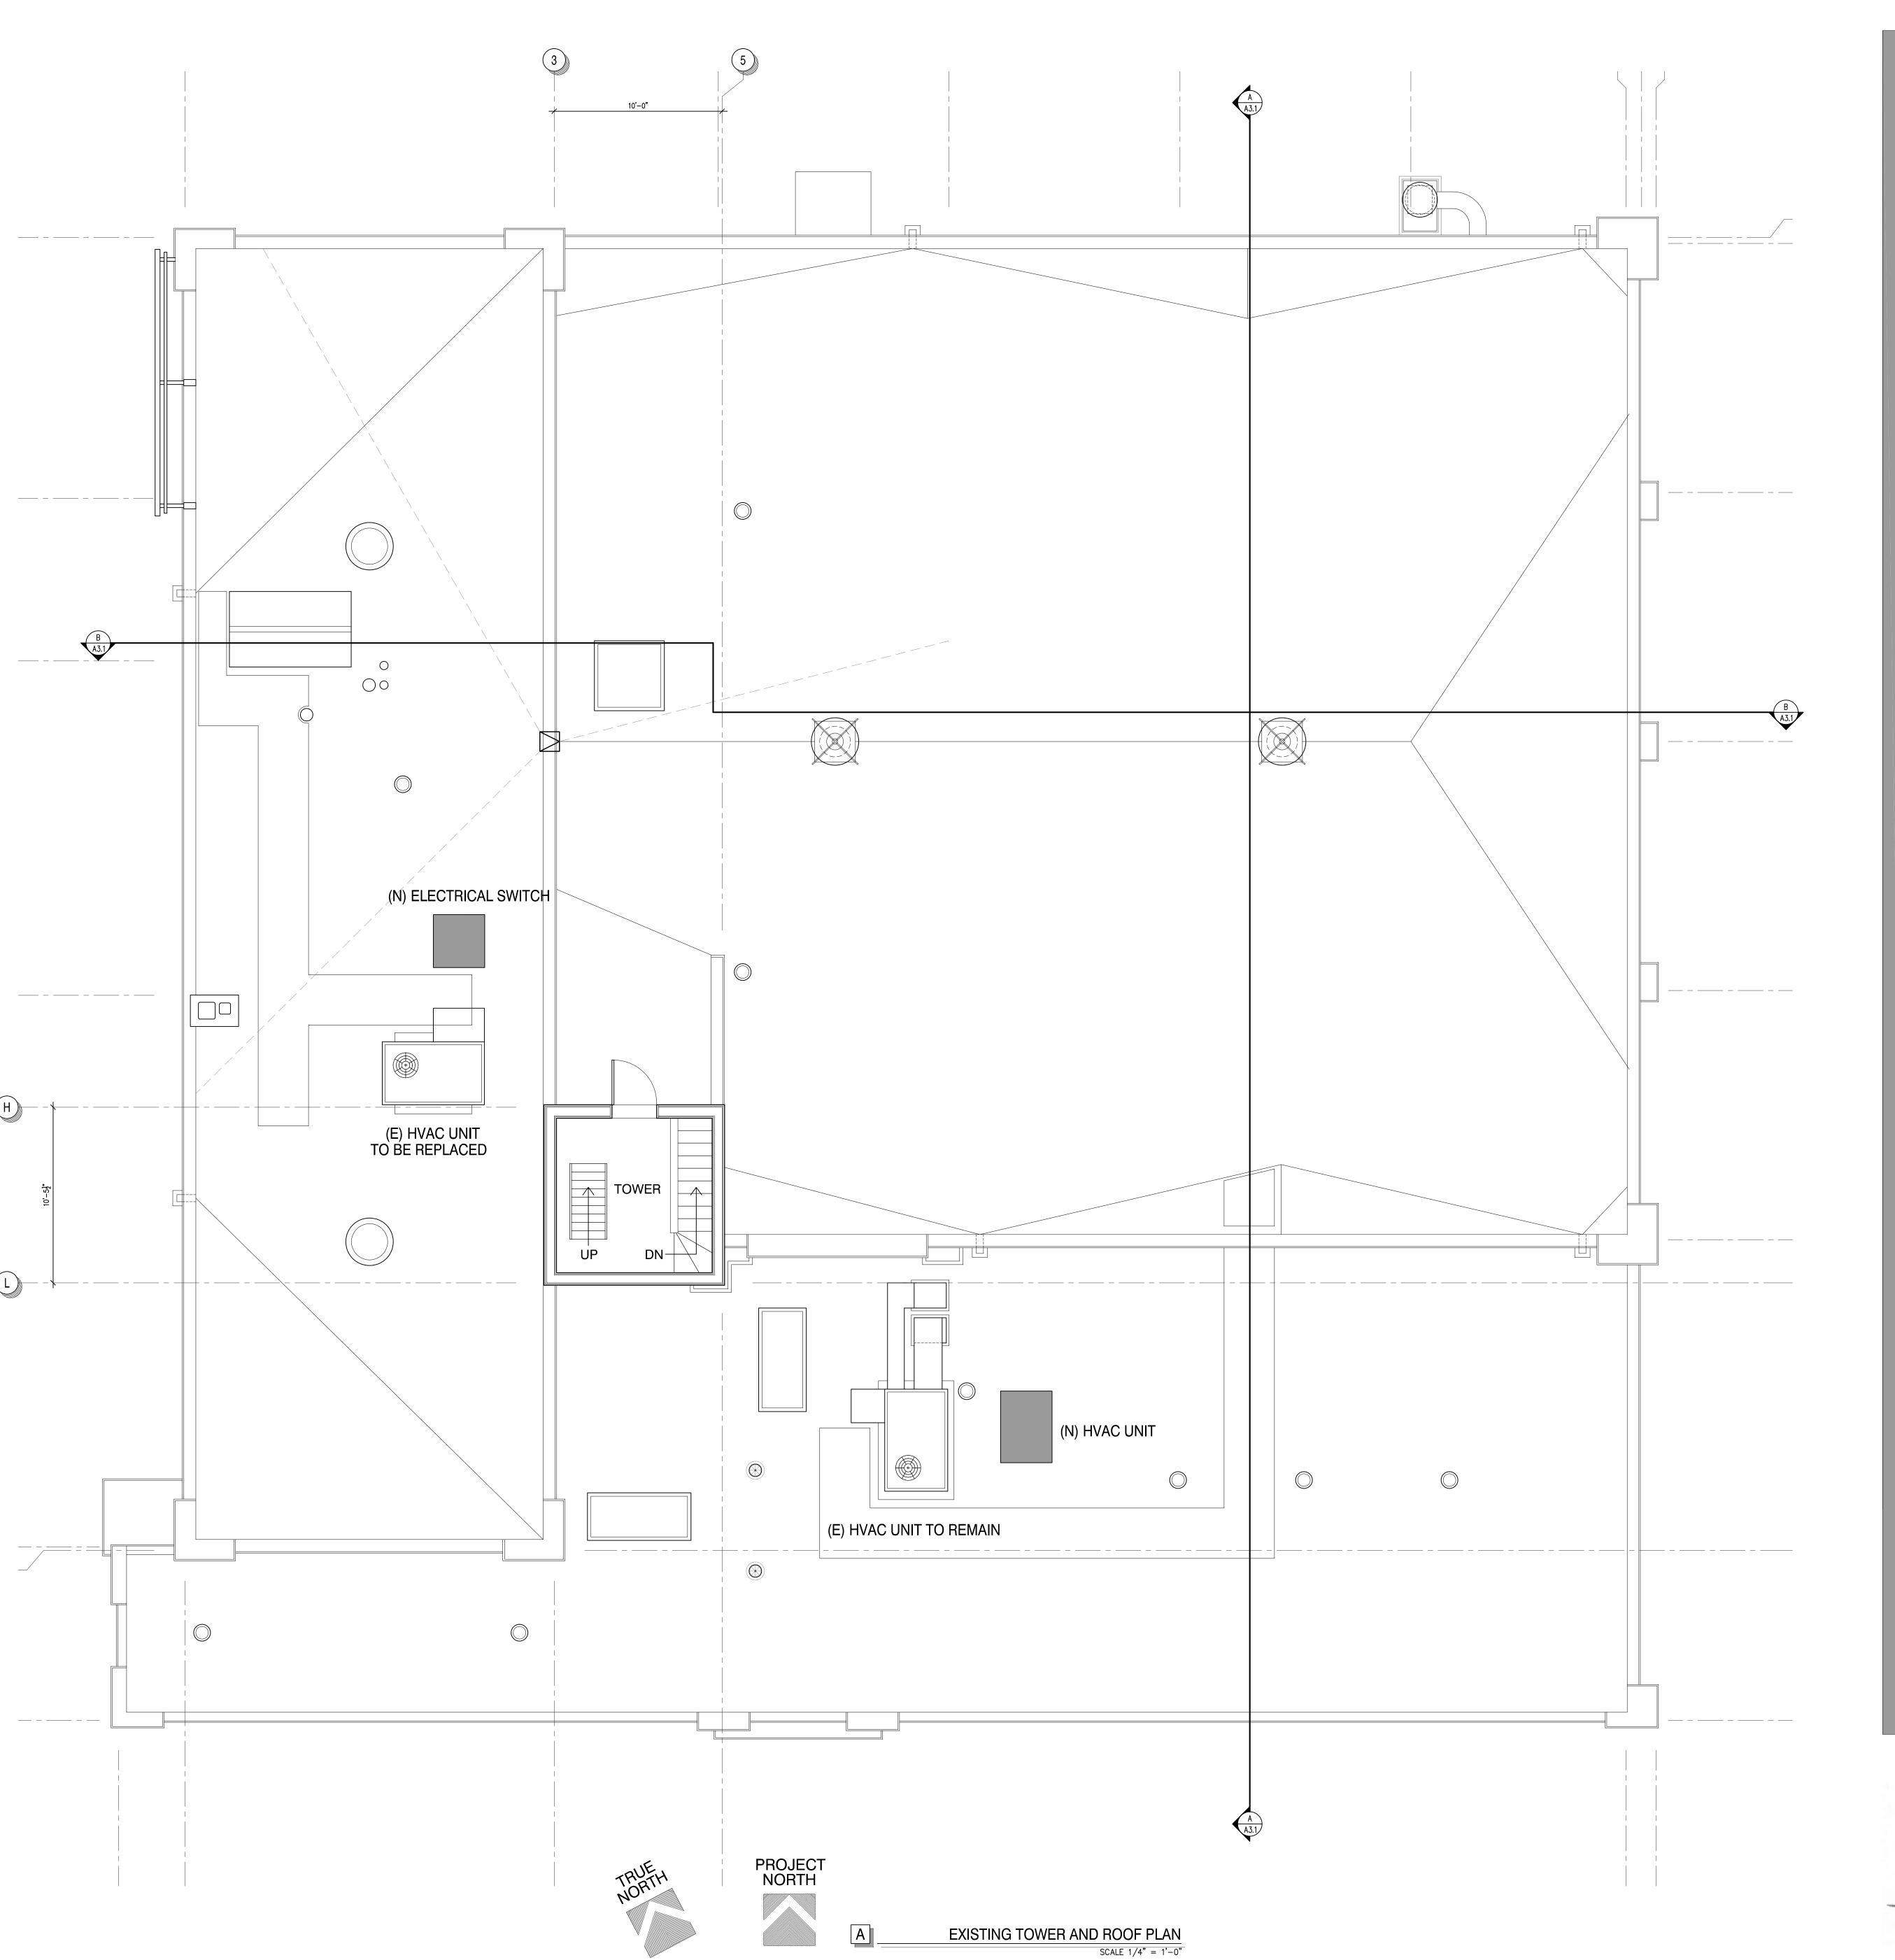

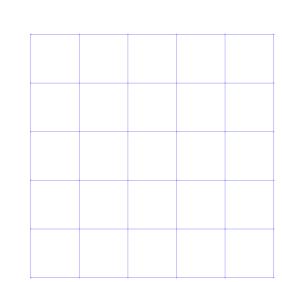

#### MARK ALBERTSON ARCHITECT

1676 CALLE RANCHERO PETALUMA, CA 94954 TELEPHONE (707) 763—1580 mark@architects—ma.com

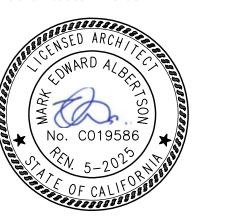



LUMA FIRE STATION NO.

In Renovation Project


California 94952


ARCHITECT'S PROJECT 1


DRAWING STATUS:


CHECK SET: JUNE 202
PERMIT SET:
BID SET:
CONSTRUCTION SET:

REVISIONS:

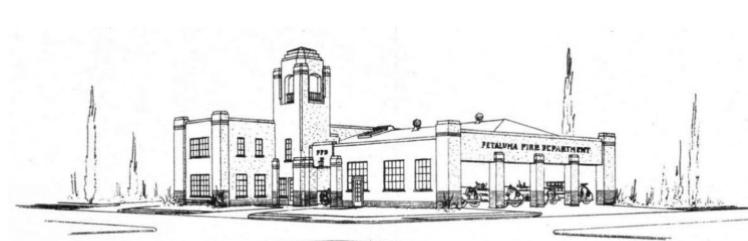

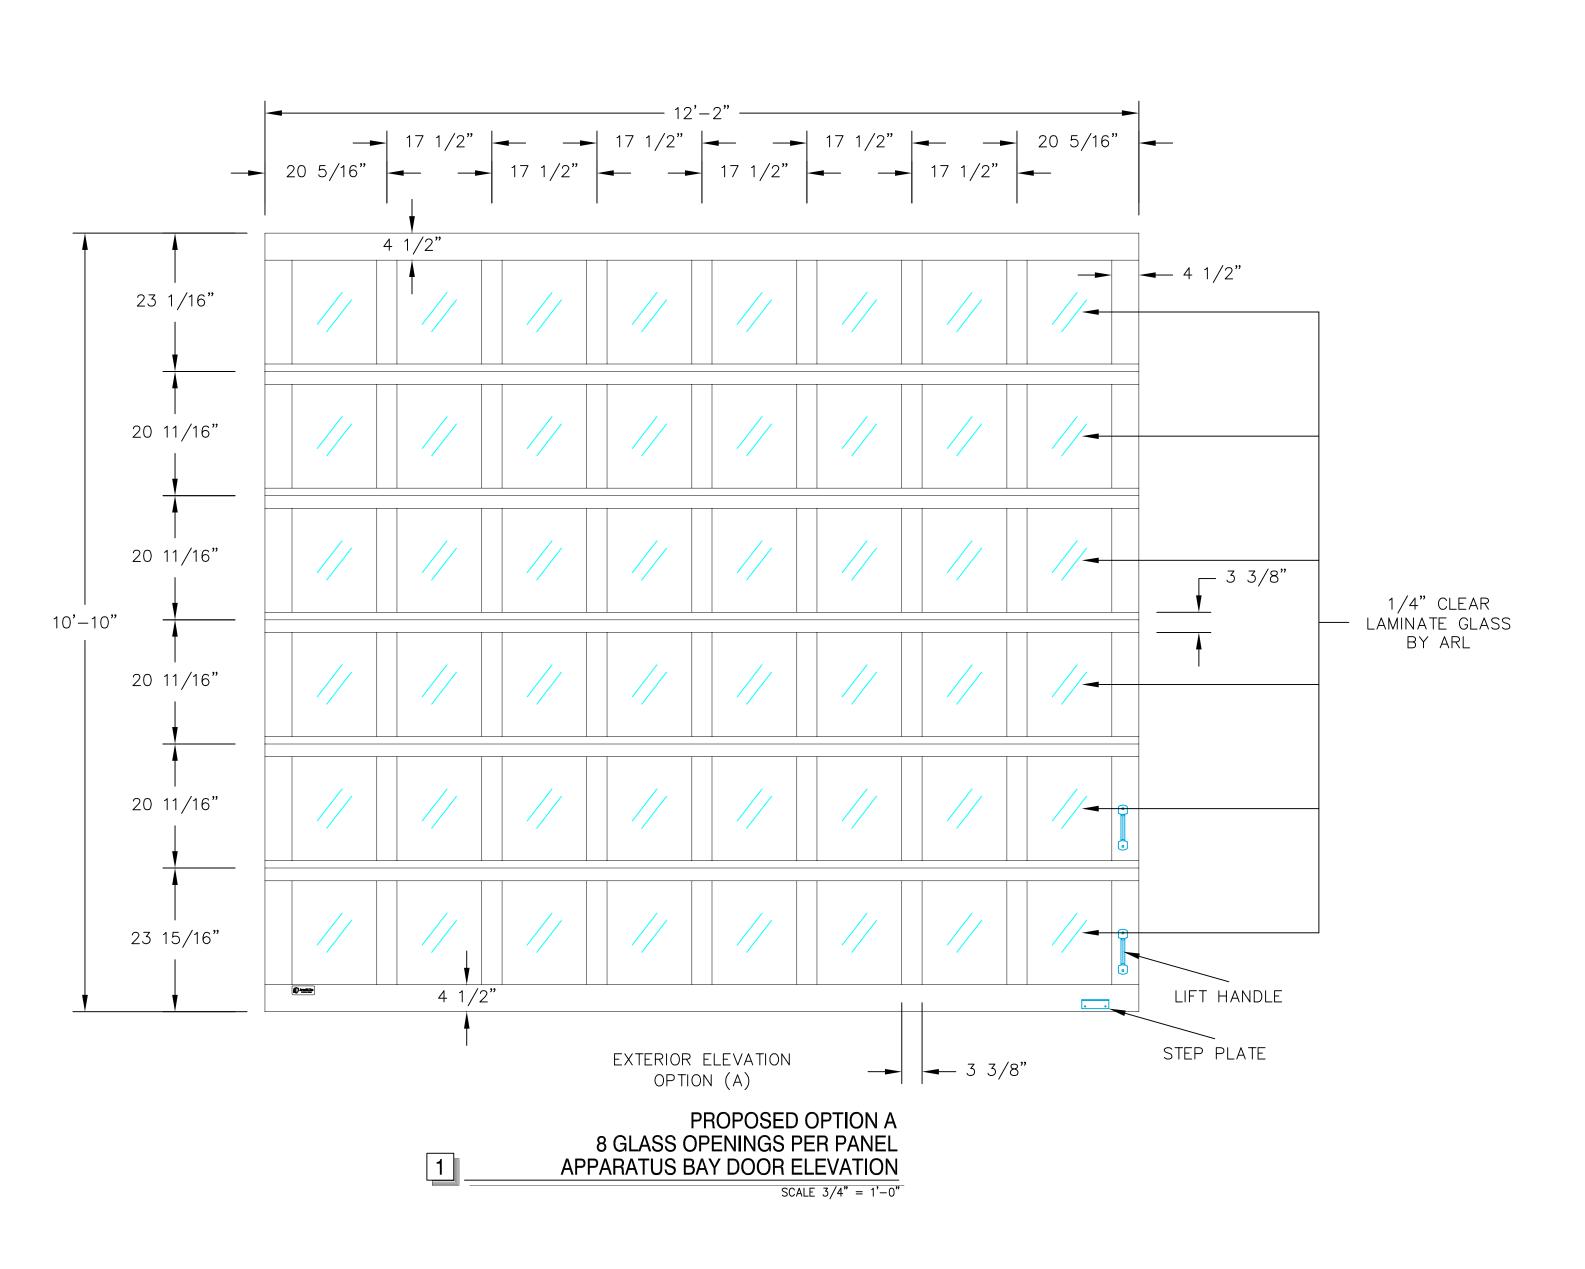

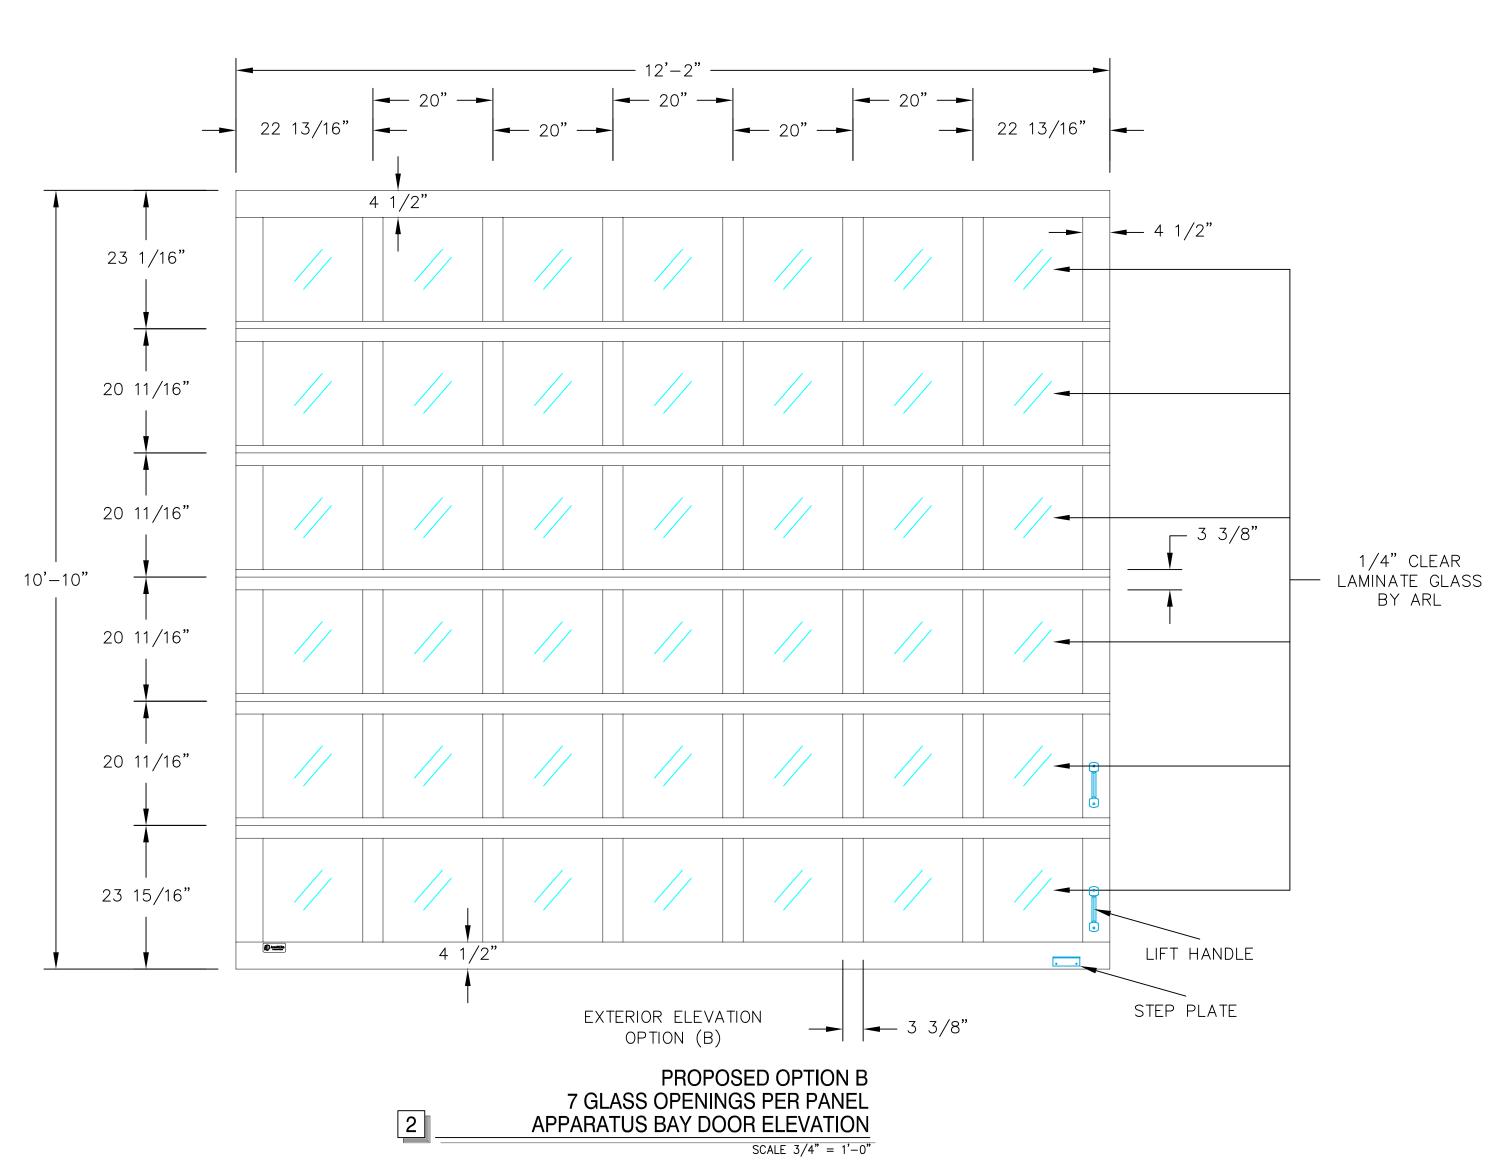

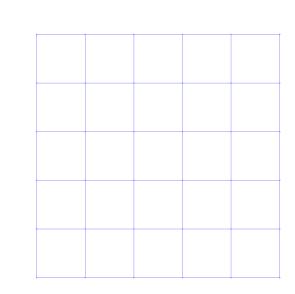

## MARK ALBERTSON ARCHITECT

1676 CALLE RANCHERO PETALUMA, CA 94954 TELEPHONE (707) 763—1580 mark@architects—ma.com





# DOOR and WINDOW ELEVATIONS and DETAILS PETALUMA FIRE STATION NO. Building Renovation Project

# 198 D Street Petaluma, Ca

ARCHITECT'S PROJECT NO:

DRAWING STATUS:

CHECK SET: ,
PERMIT SET:
BID SET:
CONSTRUCTION SET: JUNE 2024

**REVISIONS:** 

