
CREEKWOOD

SB 330 APPLICATION DEVELOPMENT

59 UNIT CONDOMINIUM PROJECT SPAR & VESTING TENTATIVE PARCEL MAP PRELIMINARY LANDSCAPE PLANS

270 & 280 CASA GRANDE ROAD APN 017-040-051 & 016 PETALUMA, CALIFORNIA

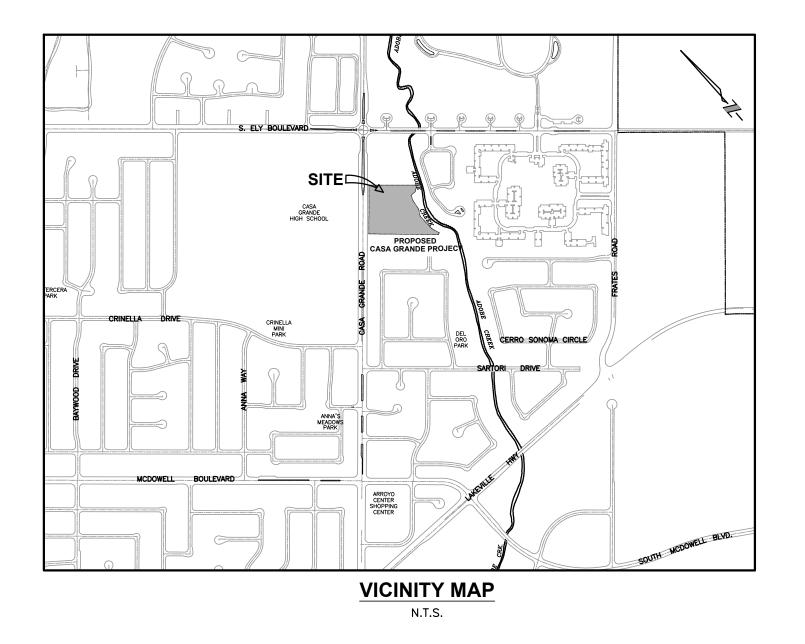

CONSULTANTS

PROJECT DATA

270 & 280 CASA GRANDE ROAD APN 017-040-051 & 016

MEDIUM DENSITY RESIDENTIAL (MDR)

MEDIUM DENSITY RESIDENTIAL (MDR)

5.198 ACRES (226,415 S.F.)

(8.1 TO 18.0 UNITS/ACRE)

(8.1 TO 18.0 UNITS/ACRE)

5.198 ACRES (226,415 S.F.)

4.561 ACRES (198,661 S.F.)*

4.072 ACRES (177,356 S.F.)**

59 CONDOMINIUM UNITS

14.49 UNITS/ACRE

* EXCLUDES DESIGNATED REMAINDER (NOT A PART OF PROJECT)

RESIDENTIAL 4 (R4)

RESIDENTIAL 4 (R4)

60% MAXUMUM

PROPERTY DATA:

SITE GROSS AREA:

EXISTING ZONING:

PROJECT ZONING:

PROJECT LAND USE:

PROJECT NET AREA:

PROJECT DENSITY:

PROJECT UNITS (TOTAL)

TOTAL SITE GROSS AREA:

PROJECT SITE GROSS AREA:

PROJECT COVERAGE (TOTAL): 32.61%

**EXCLUDES PUBLIC VEHICULAR ACCESS

COVERAGE:

EXISTING LAND USE:

PROJECT ZONING AND LAND USE:

ZONING AND LAND USE:

SITE ADDRESS:

CIVIL ENGINEER

STEVEN J. LAFRANCHI & ASSOCIATES, INC. STEVEN LAFRANCHI

LAND SURVEYOR

LANDSCAPE
ARCHITECT

STEVEN J. LAFRANCHI & ASSOCIATES, INC. STEVEN LAFRANCHI

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MONTROSE ENVIRONMENTAL GROUP
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jescholl@montrose-env.com

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11440 W. BERNARDO CT., SUITE 360

SAN DIEGO, CALIFORNIA 92127 858.487.9378 VOICE dsmith@westconsultants.com

ARBORIST

URBAN FORESTRY ASSOCIATES, INC.
8 WILLOW STREET
SAN RAFAEL, CALIFORNIA 94901
415.4544212 VOICE

W-TRANS 490 MENDOCINO AVENUE, SUITE 201

490 MENDOCINO AVENUE, SUITE 201 SANTA ROSA, CALIFORNIA 95401 707.542.9500 VOICE dwhitlock@w—trans.com

zac@urbanforestryassociates.com

AIR QUALITY ILLINGWORTH & RODKIN, INC.

NOISE 429 EAST COTATI AVE

COTATI CA 94931

COTATI, CA 94931 707.794.0400 VOICE fsvinth@illingworthrodkin.com



SITE DIAGRAM
SCALE: 1"=200'

OWNERS

MALNATI & PEDRANI TRUST RON MALNATI 270 CASA GRANDE ROAD PETALUMA, CALIFORNIA 94954 707-328-8559 VOICE rlvka@yahoo.com

FALCON POINT—MCG,LLC c/o DRG Builders 3496 BUSKIRK AVENUE #104 PLEASANT HILL, CALIFORNIA 94523 925—939—3473 VOICE doyle@drgbuilders.com

APPLICANT

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PLEASANT HILL, CALIFORNIA 94523
925-939-3473 VOICE
doyle@drgbuilders.com

UTILITES

FIRE PROTECTION CITY OF PETALUMA
WATER CITY OF PETALUMA
SANITARY SEWER CITY OF PETALUMA
STORM DRAIN CITY OF PETALUMA

LANDSCAPE PLANS SHEET INDEX

_-0 COVER SHEET

L-1 PRELIMINARY LANDSCAPE PLAN

-2 TYPICAL LANDSCAPE

L-2.1 RENDERED TYPICAL LANDSCAPE


L-3 PRELIMINARY FENCE PLAN AND DETAILS

L-4 LANDSCAPE PALETTE

L-5 TREE REMOVAL, PRESERVATION AND REPLACEMENT PLAN

L-5.1 TREE REMOVAL, PRESERVATION AND REPLACEMENT PLAN - ENLARGED VIEWS - OUTFALLS

PHOTO DATE: 2021 SOURCE: GOOGLE EARTH

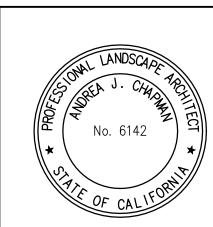

DATE: 2025.01.13

SCALE: AS SHOWN

DESIGN: SJL,CRK,AJC


DRAWN: CRK


CHECK: SJL


JOB: CREEKWOOD

JOB No: 192119

L-0

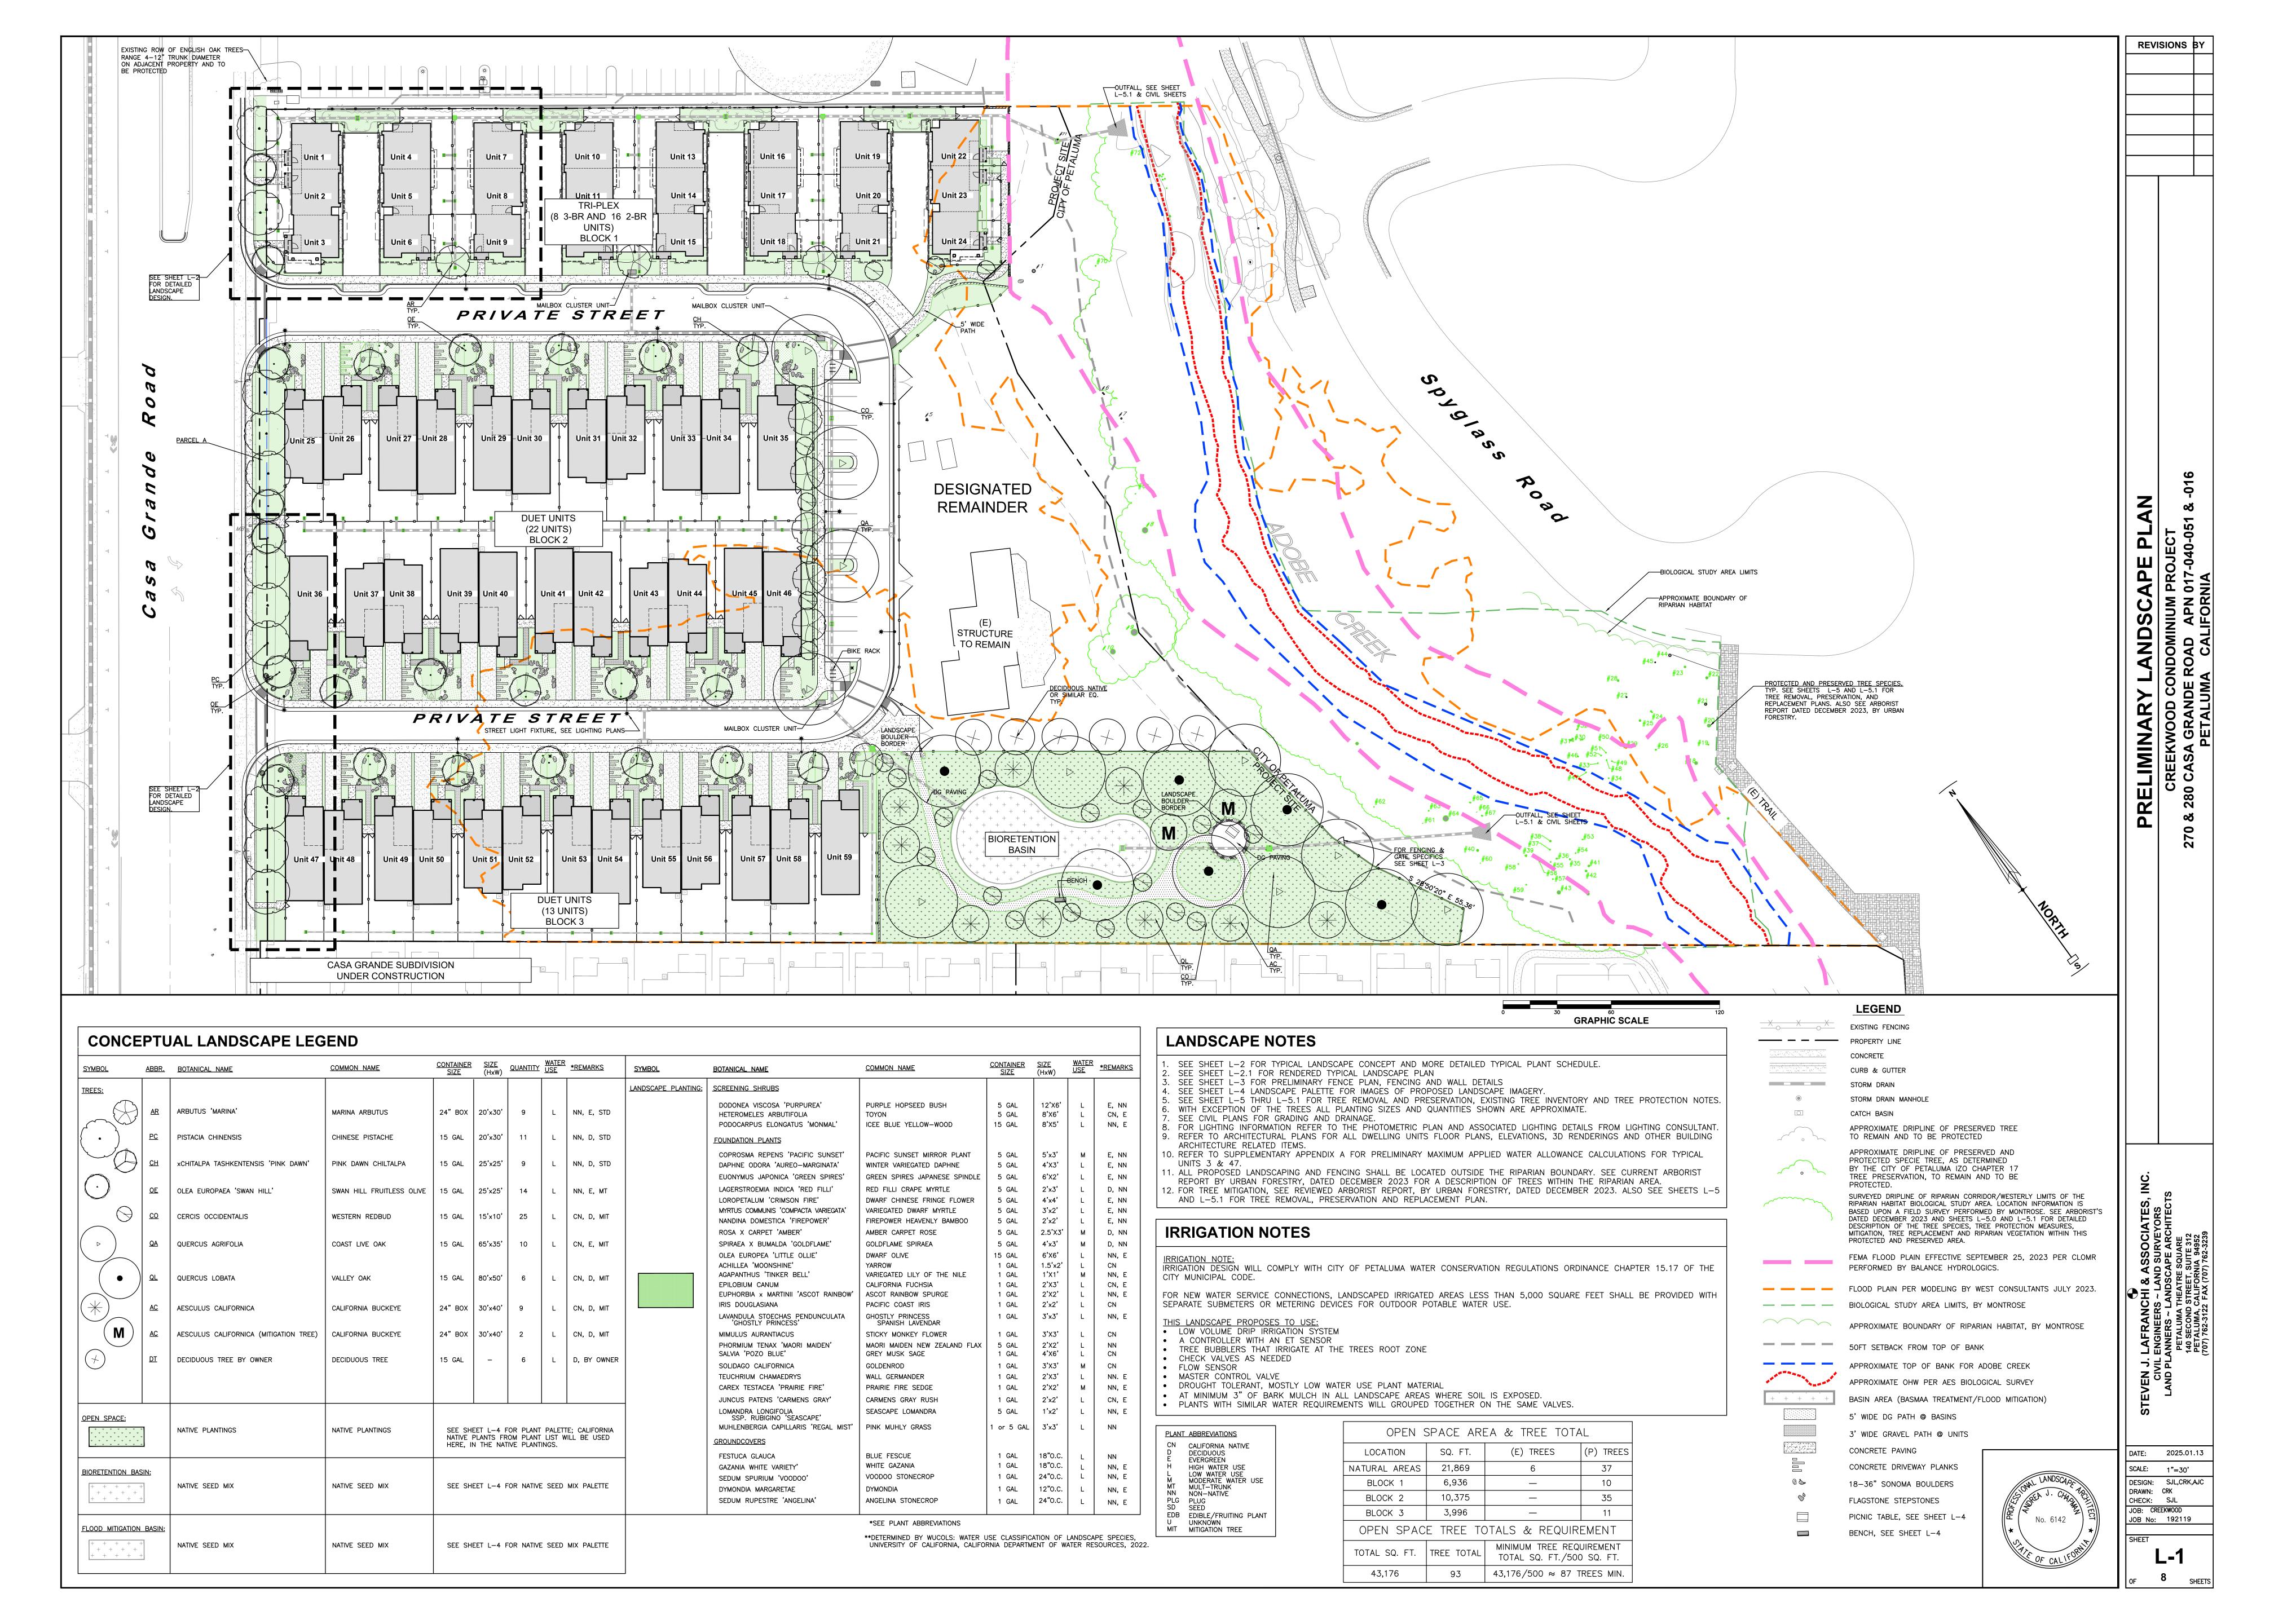

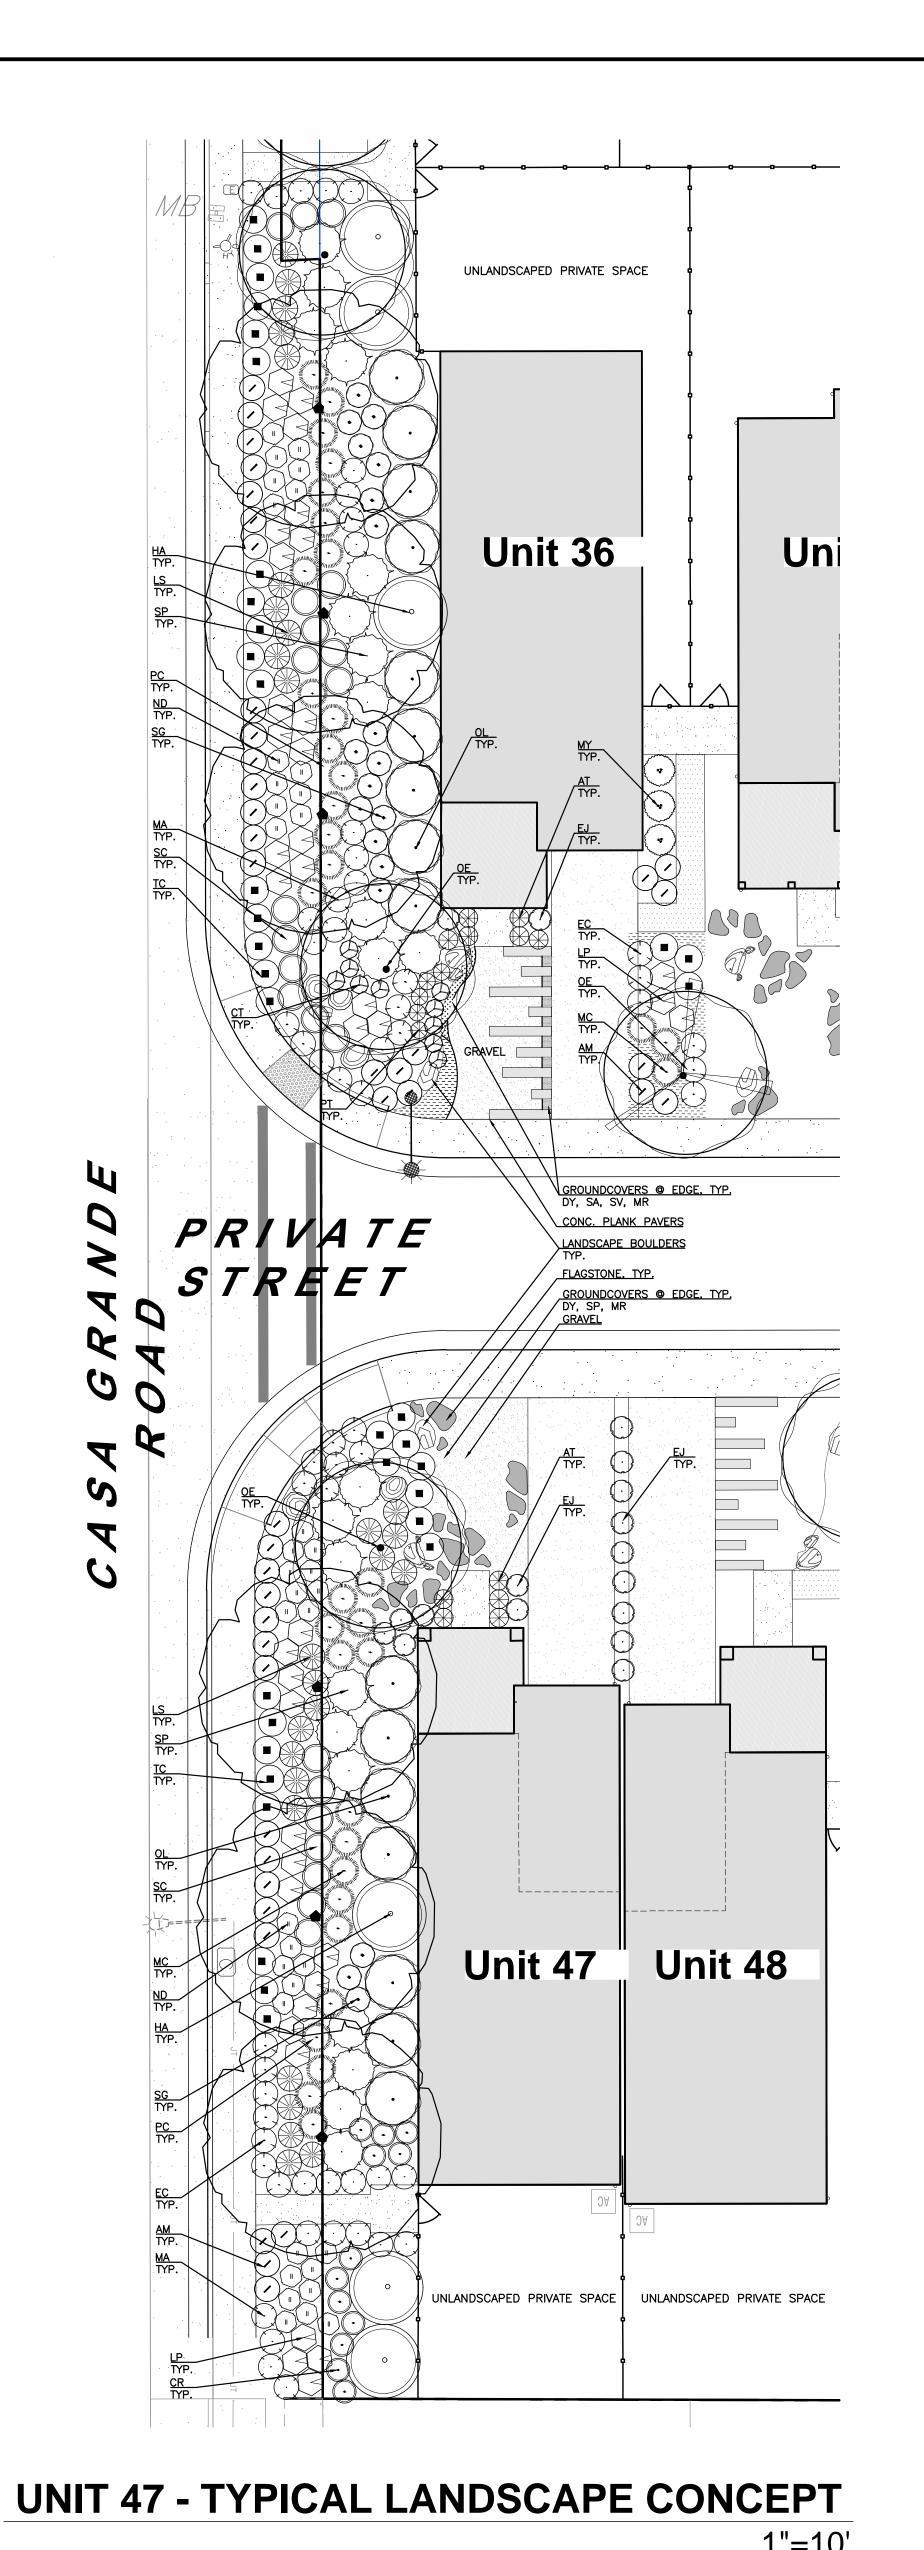

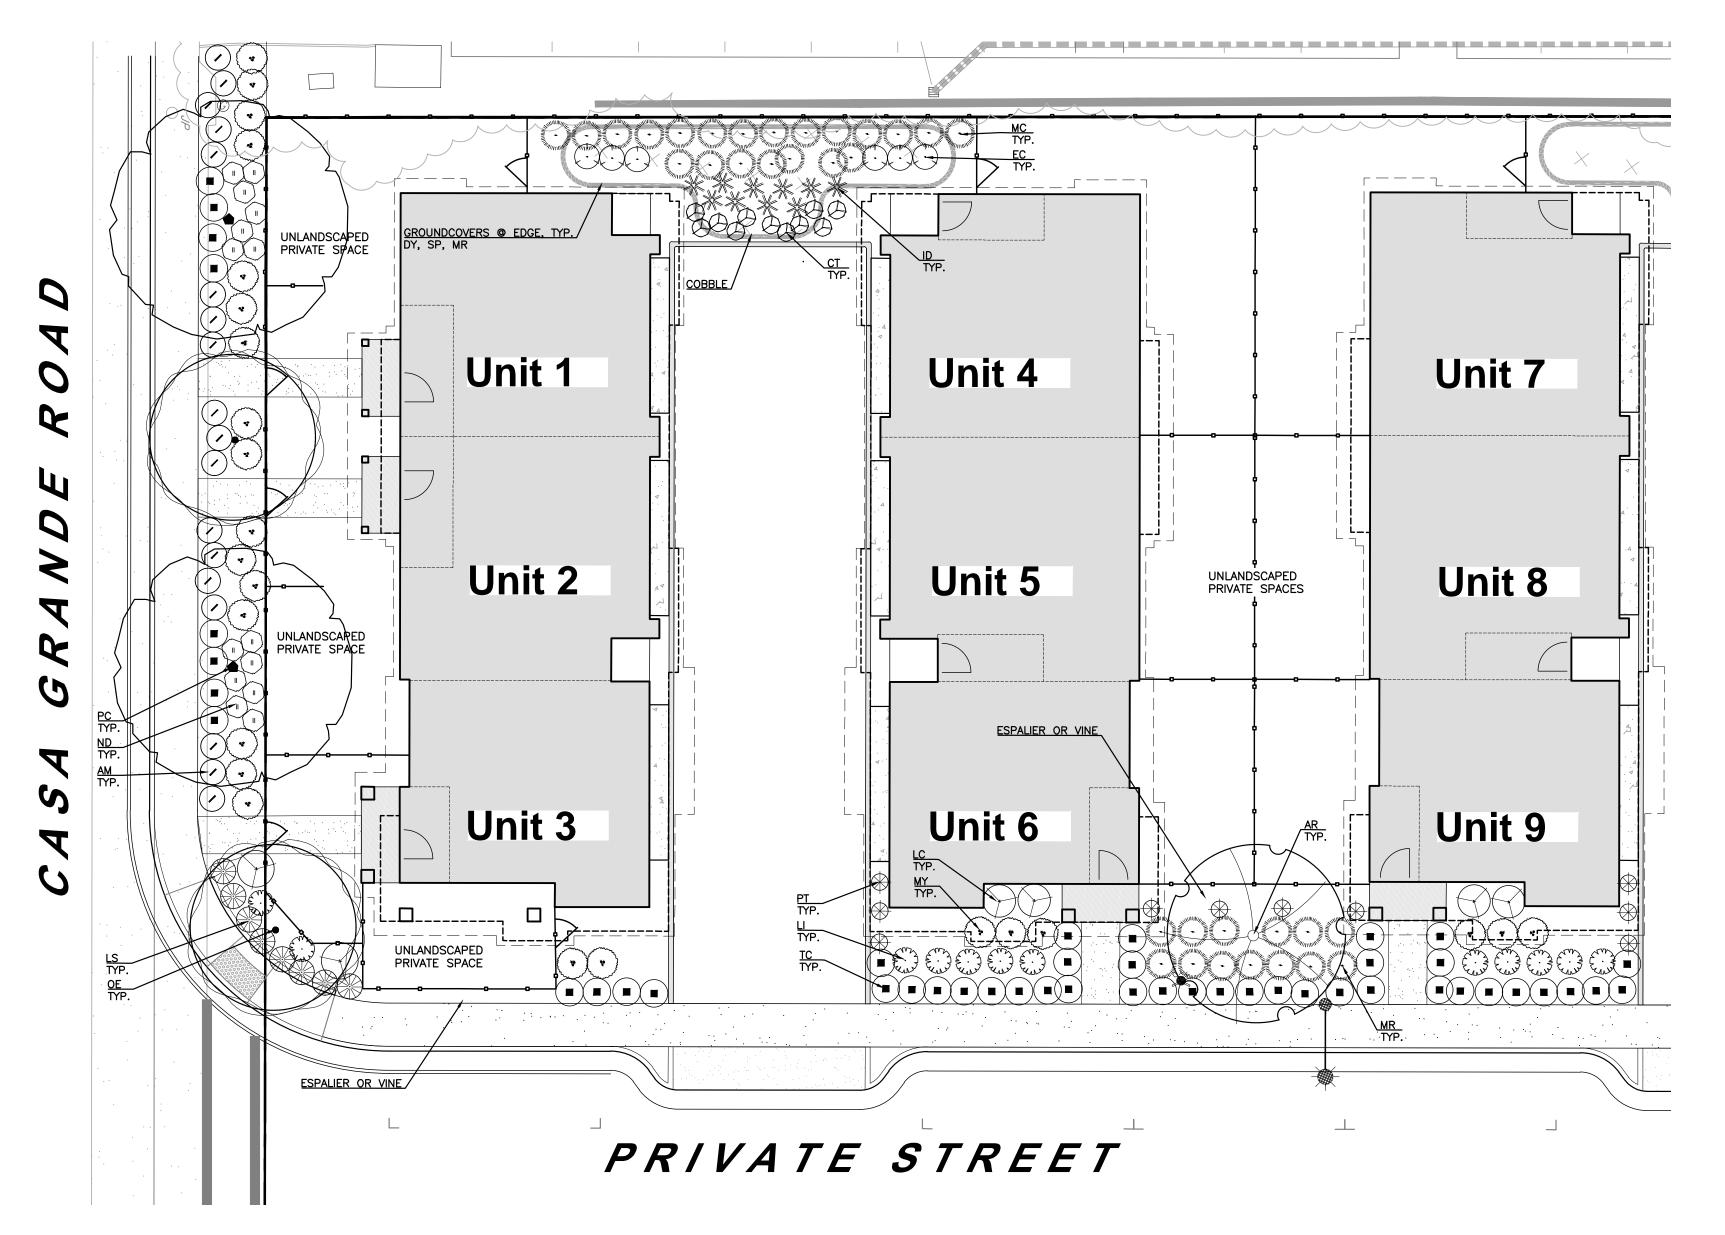

TRIPLEX UNITS 1 THRU 9 - TYPICAL LANDSCAPE CONCEPT

1"=10'

PLANT LEGEND

SYMBOL PL	ANT I	KEY BOTANICAL NAME	COMMON NAME CO	NTAINER SIZE	SIZE (HxW)	WATER USE	REMARKS
TREES:							
	AR	ARBUTUS 'MARINA'	MARINA ARBUTUS	24" BOX	20'x30'	L	NN, E, S
(\cdot)	<u>PC</u>	PISTACIA CHINENSIS	CHINESE PISTACHE	24" BOX	20'x30'	L	NN, D, S
) сн	xCHITALPA TASHKENTENSIS 'PINK DAWN'	PINK DAWN CHILTALPA	15 GAL	25'x25'	L	NN, D, S
\bigcirc	<u>ОЕ</u>	OLEA EUROPAEA 'SWAN HILL'	SWAN HILL FRUITLESS OLIVE	15 GAL	25'x25'	L	NN, E, M
SHRUBS:							
\bigcirc (\cdot)	<u>DV</u>	DODONEA VISCOSA 'PURPUREA'	PURPLE HOPSEED BUSH	5 GAL	12'X6'	L	E, NN
	HA DO	HETEROMELES ARBUTIFOLIA	TOYON	5 GAL	8'X6'	<u> </u>	CN, E
	<u>P0</u>	PODOCARPUS ELONGATUS 'MONMAL'	ICEE BLUE YELLOW-WOOD	15 GAL	8'X5'		NN, E
\odot	<u>CR</u>	COPROSMA REPENS 'PACIFIC SUNSET'	PACIFIC SUNSET MIRROR PLANT	5 GAL	5'x3'	м	E, NN
(\cdot)	<u>DO</u>	DAPHNE ODORA 'AUREO-MARGINATA'	WINTER VARIEGATED DAPHNE	5 GAL	4'X3'	L	E, NN
	<u>EJ</u>	EUONYMUS JAPONICA 'GREEN SPIRES'	GREEN SPIRES JAPANESE SPINDLE	5 GAL	6'X2'	L	E, NN
A STANKY	<u>LI</u>	LAGERSTROEMIA INDICA 'RED FILLI'	RED FILLI CRAPE MYRTLE	5 GAL	2'x3'	L	D, NN
() ~ · ·	<u>LR</u>	LOROPETALUM 'CRIMSON FIRE'	DWARF CHINESE FRINGE FLOWER	5 GAL	4'x4'	[E, NN
\sim	<u>MY</u>	MYRTUS COMMUNIS 'COMPACTA VARIEGATA'	VARIEGATED DWARF MYRTLE	5 GAL	3'x2'	L	E, NN
	<u>ND</u>	NANDINA DOMESTICA 'FIREPOWER'	FIREPOWER HEAVENLY BAMBOO	5 GAL	2'x2'	L	E, NN
	<u>RC</u>	ROSA X CARPET 'AMBER'	AMBER CARPET ROSE	5 GAL	2.5'X3'	м	D, NN
(\cdot)	<u>SG</u>	SPIRAEA X BUMALDA 'GOLDFLAME'	GOLDFLAME SPIRAEA	5 GAL	4'x3'	м	D, NN
$\overline{}$	<u>OL</u>	OLEA EUROPEA 'LITTLE OLLIE'	DWARF OLIVE	15 GAL	6'X6'	L	NN, E
PERENNIALS	<u>S:</u>						
\bigcirc	<u>AM</u>	ACHILLEA 'MOONSHINE'	YARROW	1 GAL	1.5'x2'		NN -
	<u>AT</u>	AGAPANTHUS 'TINKER BELL'	VARIEGATED LILY OF THE NILE	1 GAL	1'X1'	M	NN, E
\bigcirc	EC EM	EPILOBIUM CANUM EUPHORBIA x MARTINII 'ASCOT RAINBOW'	CALIFORNIA FUCHSIA ASCOT RAINBOW SPURGE	1 GAL 1 GAL	2'X3' 2'X2'		CN, E
\ /	<u>EM</u> <u>ID</u>	IRIS DOUGLASIANA	PACIFIC COAST IRIS	1 GAL 1 GAL	2 X2 2'x2'		NN, E CN
*	LP	LAVANDULA STOECHAS PENDUNCULATA	GHOSTLY PRINCESS	1 GAL	3'x3'	L	NN, E
		'GHOSTLY PRINCESS'	SPANISH LAVENDAR				
	MA DT	MIMULUS AURANTIACUS	STICKY MONKEY FLOWER	1 GAL	3'X3'	L	CN
	PT SP	PHORMIUM TENAX 'MAORI MAIDEN' SALVIA 'POZO BLUE'	MAORI MAIDEN NEW ZEALAND FLAX GREY MUSK SAGE	5 GAL 1 GAL	2'X2' 4'X6'	L	NN CN
\sim ()	<u>SC</u>	SOLIDAGO CALIFORNICA	GOLDENROD	1 GAL	3'X3'	м	CN
	<u>TC</u>	TEUCHRIUM CHAMAEDRYS	WALL GERMANDER	1 GAL	2'X3'	L	NN. E
GRASSES:	<u>CT</u>	CAREX TESTACEA 'PRAIRIE FIRE'	PRAIRIE FIRE SEDGE	1 GAL	2'X2'	м	NN, E
ZW.	<u>JP</u>	JUNCUS PATENS 'CARMENS GRAY'	CARMENS GRAY RUSH	1 GAL	2'x2'	L	CN, E
	<u>LS</u>	LOMANDRA LONGIFOLIA SSP. RUBIGINO 'SEASCAPE'	SEASCAPE LOMANDRA	5 GAL	1'x2'	L	NN, E
	<u>MC</u>	MUHLENBERGIA CAPILLARIS 'REGAL MIST'	PINK MUHLY GRASS	1 or 5 GAL	3'x3'	L	NN
GROUNDCO	VERS/	VINES:					
	<u>FG</u>	FESTUCA GLAUCA	BLUE FESCUE	1 GAL	18"O.C.	L	NN
	<u>GK</u>	GAZANIA WHITE VARIETY'	WHITE GAZANIA	1 GAL	18"O.C.	L	NN, E
	<u>SP</u>	SEDUM SPURIUM 'VOODOO'	VOODOO STONECROP	1 GAL	24"O.C.	L	NN, E
	<u>FG</u>	DYMONDIA MARGARETAE	DYMONDIA	1 GAL	12"O.C.	L	NN, E,
	<u>SP</u>	SEDUM RUPESTRE 'ANGELINA'	ANGELINA STONECROP	1 GAL	24"O.C.	[NN, E,
	ESP/	ALIER OR VINE TBD		5 GAL	-	L	

**DETERMINED BY WUCOLS: WATER USE CLASSIFICATION OF LANDSCAPE SPECIES, UNIVERSITY OF CALIFORNIA, CALIFORNIA DEPARTMENT OF WATER RESOURCES, 2022.

*SEE PLANT ABBREVIATIONS

LANDSCAPE NOTES

- . SEE SHEET L-1 FOR PRELIMINARY OVERALL LANDSCAPE PLAN. 2. SEE EXHIBIT 1 FOR RENDERED TYPICAL LANDSCAPE PLAN FOR DUET. 3. SEE SHEET L-3 FOR FENCING PLAN AND FENCING DETAILS.
- 4. SEE SHEET L-4 FOR LANDSCAPE PALETTE FOR IMAGES OF PROPOSED LANDSCAPE IMAGERY. 5. SEE SHEET L-5 FOR TREE REMOVAL, PRESERVATION AND MITIGATION.
 6. WITH EXCEPTION OF THE TREES ALL PLANTING SIZES AND QUANTITIES SHOWN ARE APPROXIMATE.
- 7. SEE CIVIL PLANS FOR GRADING AND DRAINAGE. B. FOR LIGHTING INFORMATION SEE SHEET L-4 FOR IMAGE OF PROPOSED STREET LIGHTING.
- REFER TO THE PHOTOMETRIC PLAN BY OTHERS AND ASSOCIATED LIGHTING DETAILS FOR FURTHER INFORMATION.
- . REFER TO ARCHITECTURAL PLANS FOR ALL DWELLING UNITS FLOOR PLANS, ELEVATIONS, 3D RENDERINGS AND OTHER BUILDING ARCHITECTURE RELATED ITEMS.). REFER TO SUPPLEMENTARY APPENDIX A FOR PRELIMINARY MAXIMUM APPLIED WATER ALLOWANCE
- CALCULATIONS FOR TYPICAL UNITS 3 & 47. 1. ALL PROPOSED LANDSCAPING AND FENCING SHALL BE LOCATED OUTSIDE THE RIPARIAN BOUNDARY. SEE CURRENT ARBORIST REPORT BY URBAN FORESTRY FOR A DESCRIPTION OF TREES WITHIN THE

IRRIGATION NOTES


RIPARIAN AREA.


IRRIGATION NOTE:
IRRIGATION DESIGN WILL COMPLY WITH CITY OF PETALUMA WATER CONSERVATION REGULATIONS
ORDINANCE CHAPTER 15.17 OF THE CITY MUNICIPAL CODE.

- THIS LANDSCAPE PROPOSES TO USE:

 LOW VOLUME DRIP IRRIGATION SYSTEM
- A CONTROLLER WITH AN ET SENSOR TREE BUBBLERS THAT IRRIGATE AT THE TREES ROOT ZONE
- CHECK VALVES AS NEEDED
- FLOW SENSOR
- MASTER CONTROL VALVE DROUGHT TOLERANT, MOSTLY LOW WATER USE PLANT MATERIAL AT MINIMUM 3" OF BARK MULCH IN ALL LANDSCAPE AREAS WHERE SOIL IS EXPOSED.
- PLANTS WITH SIMILAR WATER REQUIREMENTS WILL GROUPED TOGETHER ON THE SAME VALVES.

PLANT ABBREVIATIONS CALIFORNIA NATIVE EVERGREEN
HIGH WATER USE
LOW WATER USE
MODERATE WATER USE
MULT—TRUNK
NON—NATIVE PLUG SEED EDIBLE/FRUITING PLANT STANDARD

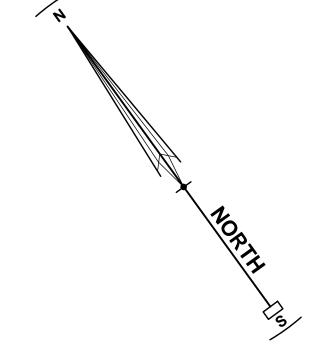


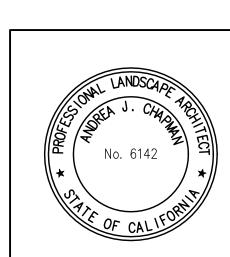



REVISIONS BY


DRAWN: CRK CHECK: SJL JOB: CREEKWOOD JOB No: 192119

REVISIONS BY

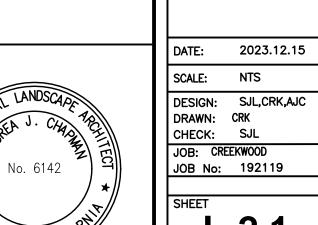

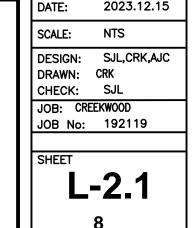

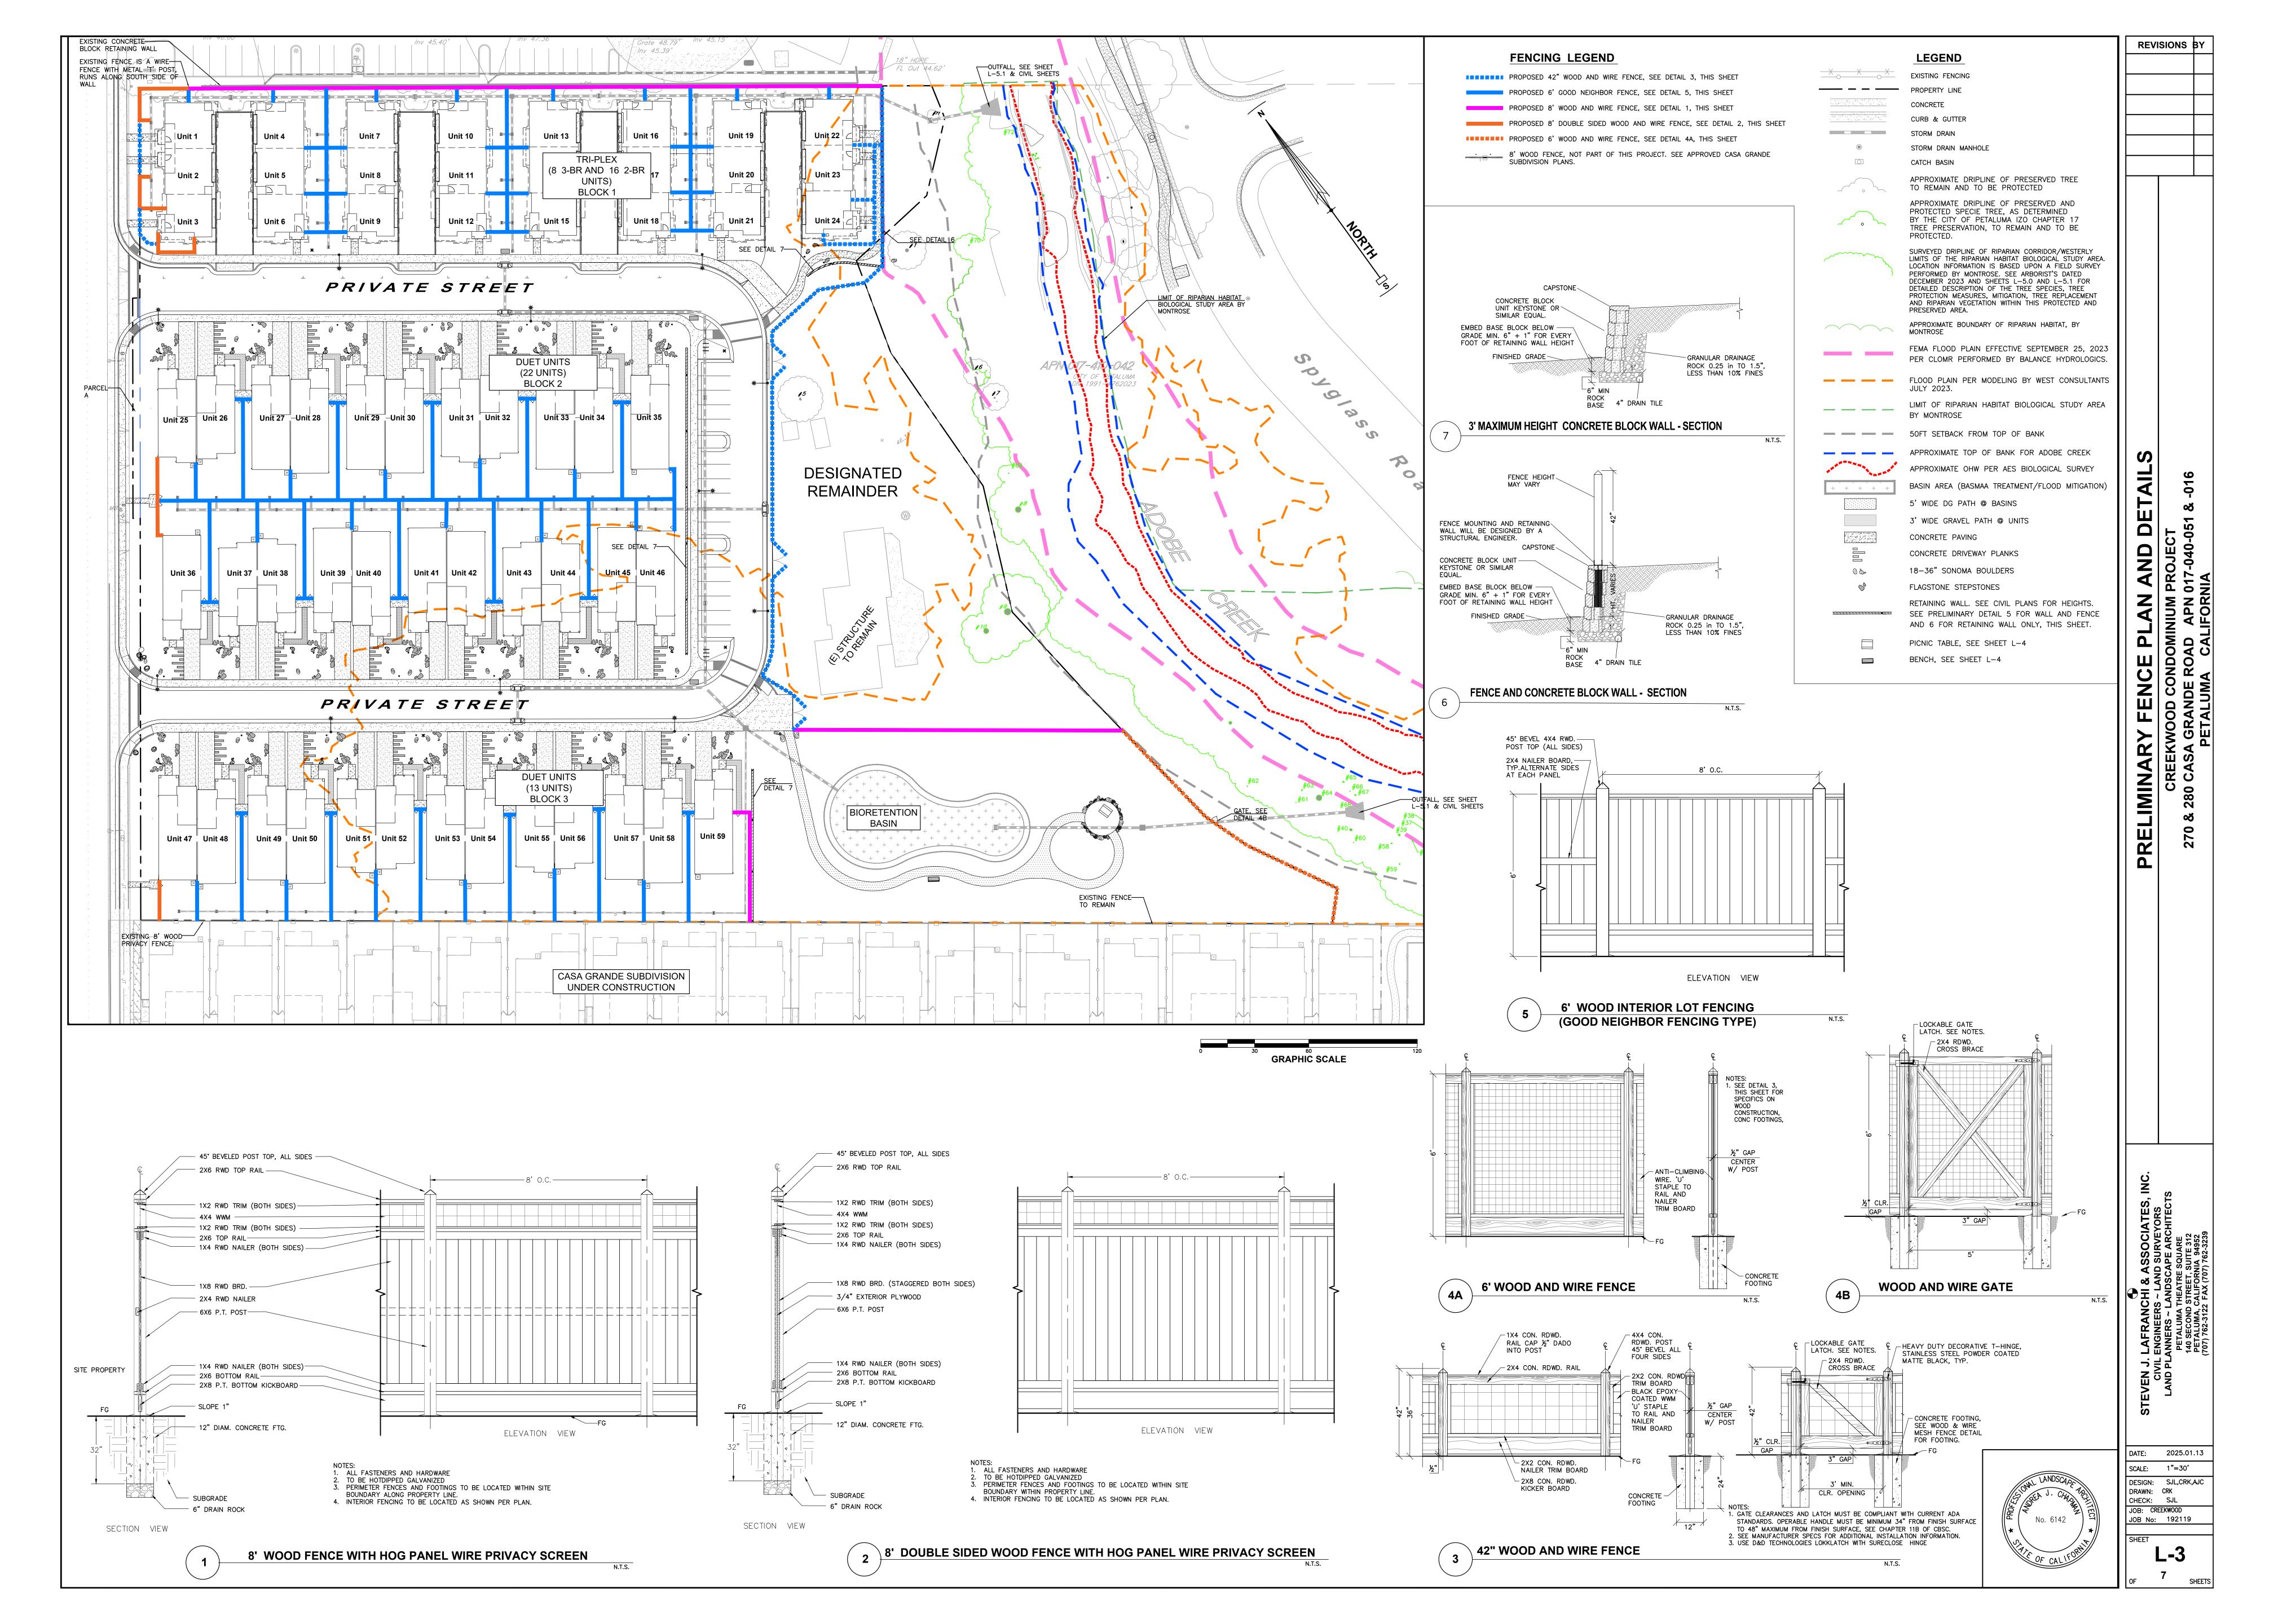

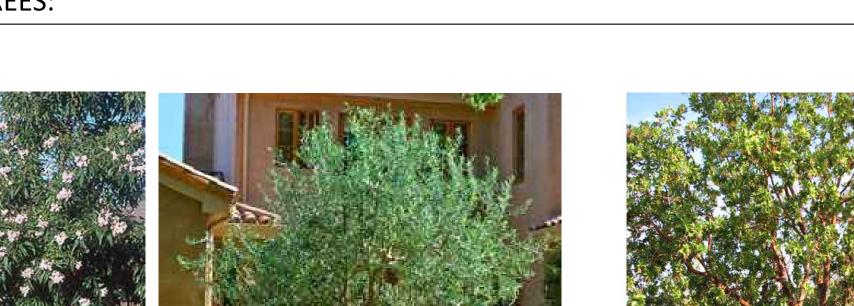

















XCHITALPA TASHKETENSIS XCHITALPA



DWARF VARIEGATED MYRTLE



FIREPOWER HEAVENLY BAMBOO














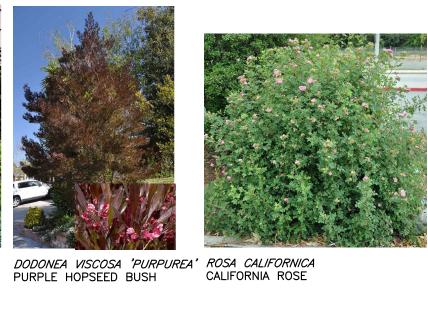





DAPHNE ODORA 'AUREO-MARGINATA' WINTER VARIEGATED DAPHNE

GRASSES:


JUNCUS PATENS 'CARMENS GRAY'
CARMENS GRAY JUNCUS



LOMANDRA CONFERTIFOLIA SSP, RUBIGINO 'SEASCAPE' SEASCAPE MAT RUSH





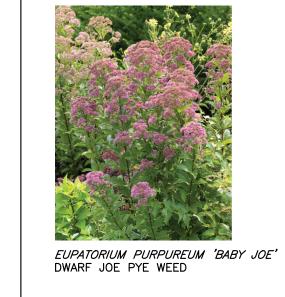

LANTANA 'RADIATION' LANTANA

PERENNIALS:





LAVANDULA STOECHAS PENDUNCULATA 'GHOSTLY

PRINCESS'
GHOSTLY PRINCESS
SPANISH LAVENDAR



MIMULUS AURANTICUS' STICKY MONKEY FLOWER



STACHYS BYZANTINA 'BIG EARS' BIG EARS LAMBS EARS





SALVIA 'POZO BLUE' GREY MUSK SAGE



MUELENBERGIA RIGENS DEER GRASS

PANICUM VIRGATUM 'HEAVY METAL' HEAVY METAL BLUE SWITCH GRASS

GROUNDCOVERS:













SEED FOR BIORETENTION BASIN:

TEUCHRIUM CHAMAEDRYS GERMANDER




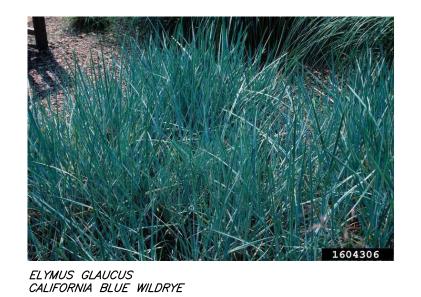

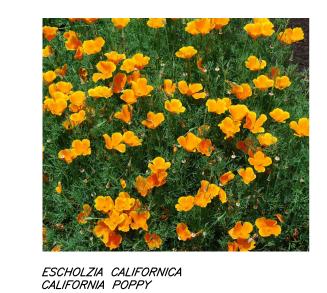



LANDSCAPE MATERIALS

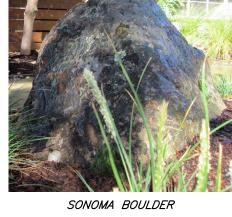

BROWN COLOR MULCH

RIVER COBBLE MULCH






PAVING MATERIALS ALTERNATIVE PARKING MATERIAL

MULTI-BLEND FLAGSTONE EMBEDDED IN GRAVEL



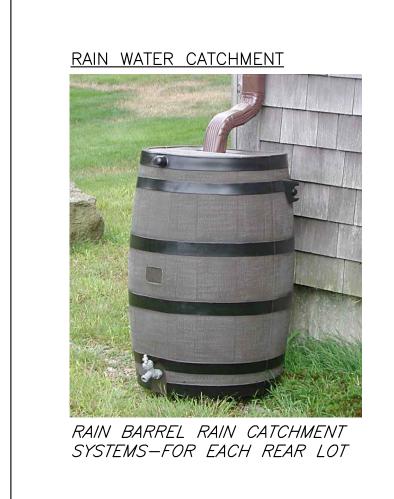








SITE FURNISHINGS



6' PICNIC TABLE AT PARK





COLOR: TAN SLATS & BLACK PROSHEILD FINISH FRAME

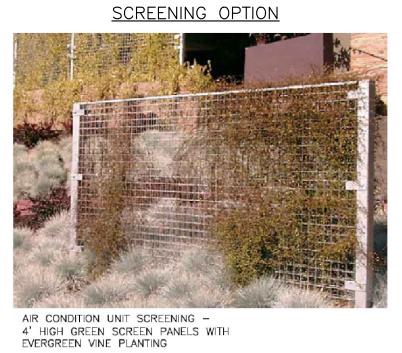

DATE: 2025.01.13 SCALE: NONE DESIGN: SJL,CRK,AJC
DRAWN: CRK
CHECK: SJL
JOB: CREEKWOOD JOB No: 192119

SALVIA SPATHACEA HUMMINGBIRD SAGE

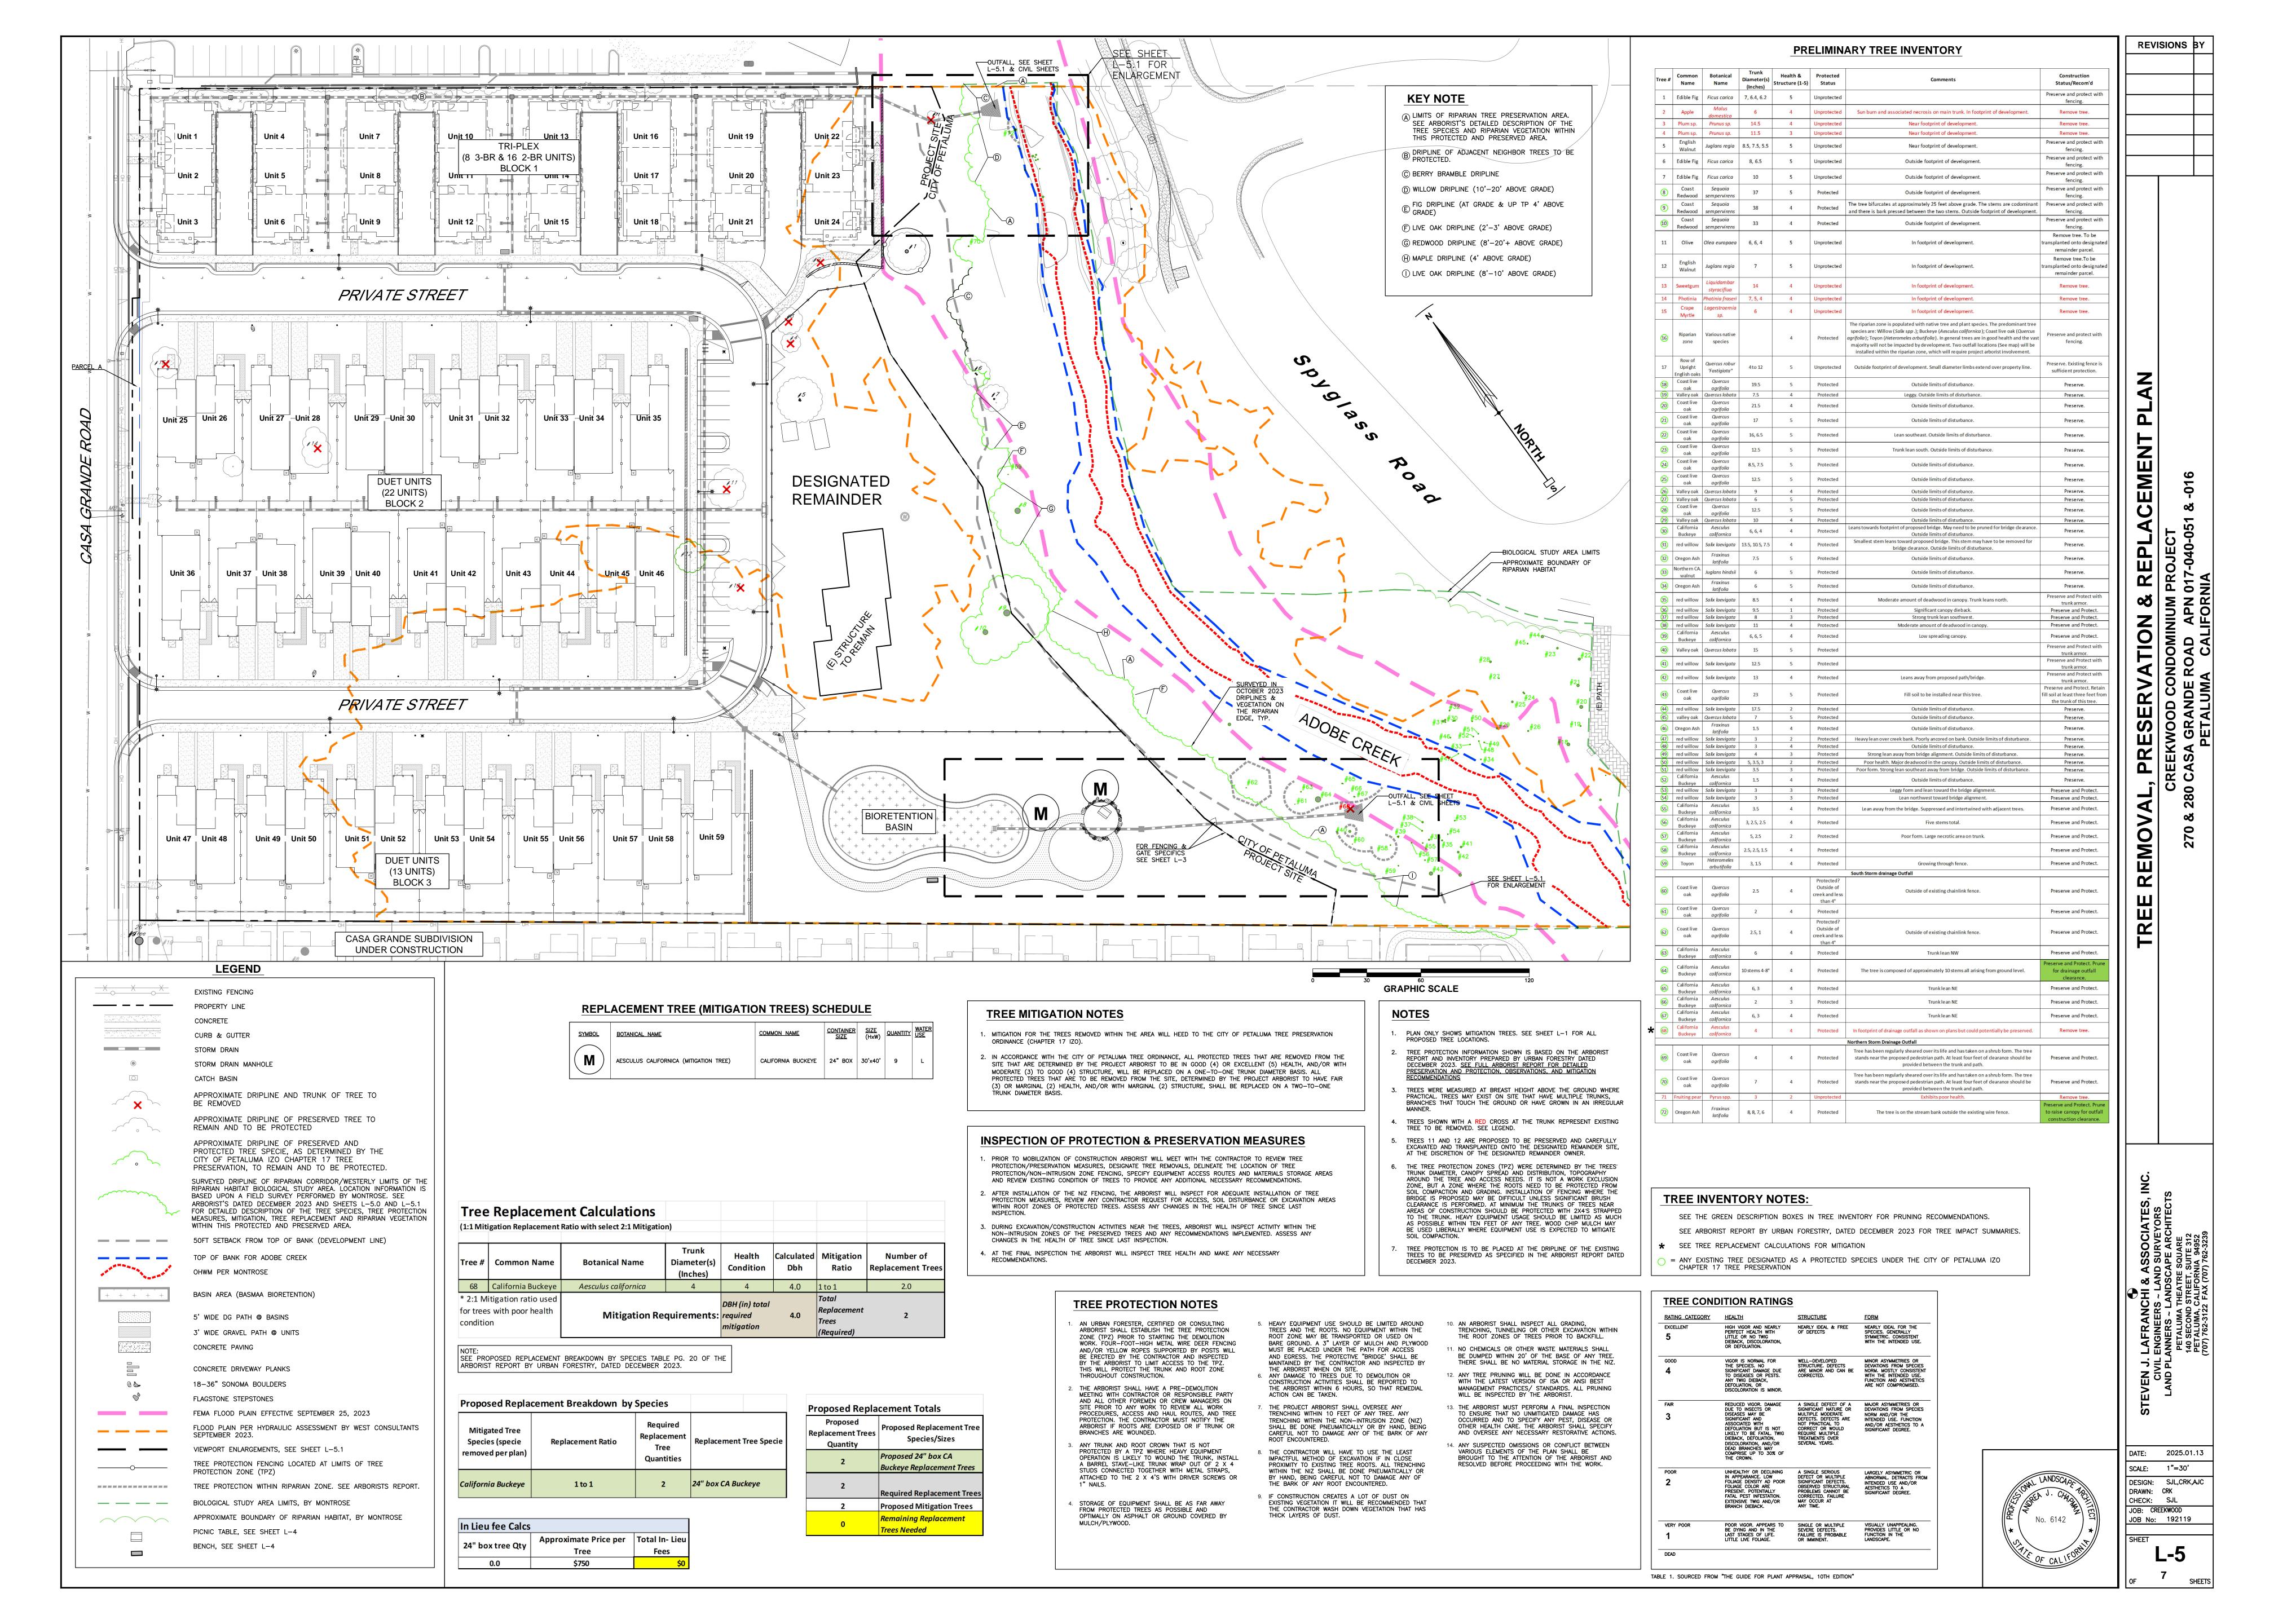

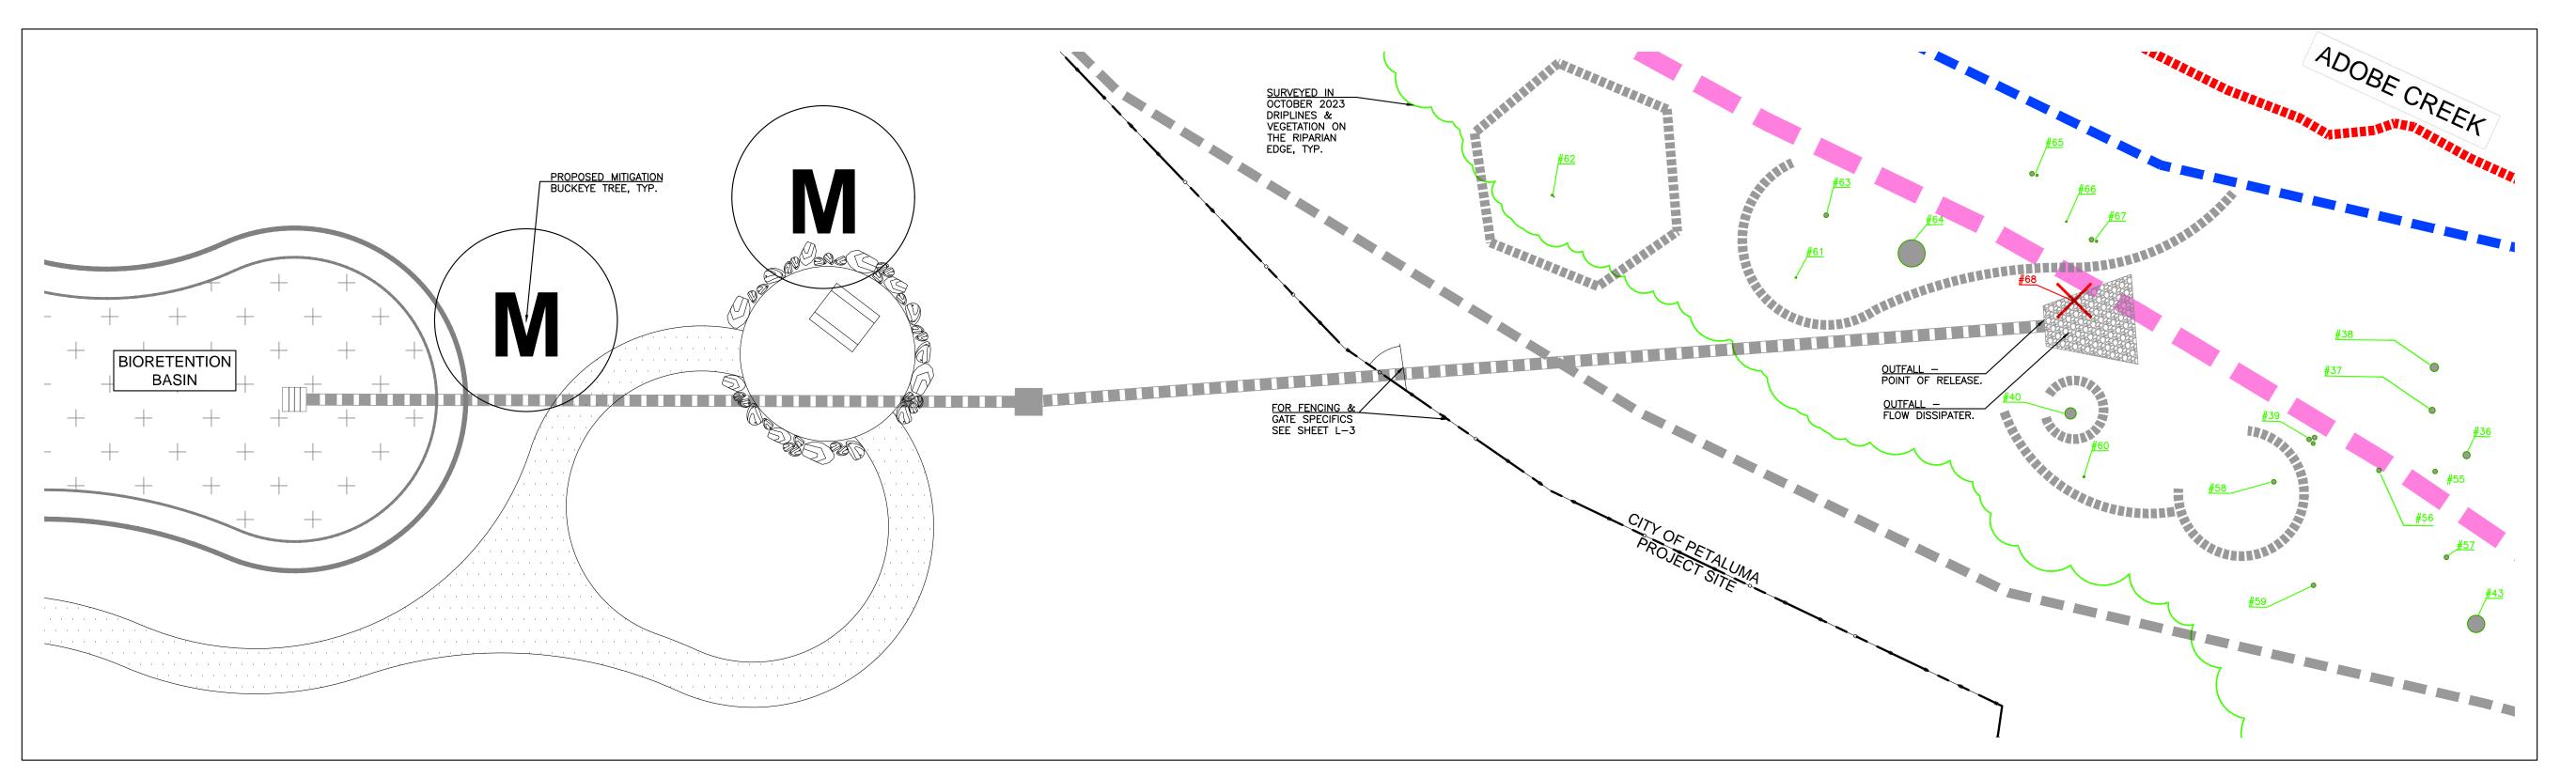

SOUTH OUTFALL


SCALE: 1"=10'

TREE INVENTORY - SOUTH OUTFALL LOCATION

Tree #	Common Name	Botanical Name	Trunk Diameter(s) (Inches)	Health & Structure (1-5)	Protected Status	Comments	Construction Status/Recom'd
36	red willow	Salix laevigata	9.5	1	Protected	Significant canopy dieback.	Preserve and Protect.
37	red willow	Salix laevigata	8	3	Protected	Strong trunk lean southwest.	Preserve and Protect.
38	red willow	Salix laevigata	11	4	Protected	Moderate amount of deadwood in canopy.	Preserve and Protect.
39	California Buckeye	Aesculus californica	6, 6, 5	4	Protected	Low spreading canopy.	Preserve and Protect.
40	Valley oak	Quercus lobata	15	5	Protected		Preserve and Protect with trunk armor.
43	Coast live oak	Quercus agrifolia	23	5	Protected	Fill soil to be installed near this tree.	Preserve and Protect. Retain fill soil at least three feet from the trunk of this tree.
55	California Buckeye	Aesculus californica	3.5	4	Protected	Lean away from the bridge. Suppressed and intertwined with adjacent trees.	Preserve and Protect.
56	California Buckeye	Aesculus californica	3, 2.5, 2.5	4	Protected	Five stems total.	Preserve and Protect.
57	California Buckeye	Aesculus californica	5, 2.5	2	Protected	Poor form. Large necrotic area on trunk.	Preserve and Protect.
58	California Buckeye	Aesculus californica	2.5, 2.5, 1.5	4	Protected		Preserve and Protect.
59	Toyon	Heteromeles arbutifolia	3, 1.5	4	Protected	Growing through fence.	Preserve and Protect.
						South Storm drainage Outfall	
60	Coast live oak	Quercus agrifolia	2.5	4	Protected? Outside of creek and less than 4"	Outside of existing chainlink fence.	Preserve and Protect.
61	Coast live oak	Quercus agrifolia	2	4	Protected		Preserve and Protect.
62	Coast live oak	Quercus agrifolia	2.5, 1	4	Protected? Outside of creek and less than 4"	Outside of existing chainlink fence.	Preserve and Protect.
63	California Buckeye	Aesculus californica	6	4	Protected	Trunk lean NW	Preserve and Protect.
64	California Buckeye	Aesculus californica	10 stems 4-8"	4	Protected	The tree is composed of approximately 10 stems all arising from ground level.	Preserve and Protect. Prune for drainage outfall clearance.
65	California Buckeye	Aesculus californica	6, 3	4	Protected	Trunk lean NE	Preserve and Protect.
66	California Buckeye	Aesculus californica	2	3	Protected	Trunk lean NE Preserve a	
67	California Buckeye	Aesculus californica	6, 3	4	Protected	Trunk lean NE	Preserve and Protect.
68	California Buckeye	Aesculus californica	4	4	Protected	In footprint of drainage outfall as shown on plans but could potentially be preserved.	Remove tree.

TREE INVENTORY NOTE:

SEE THE GREEN DESCRIPTION BOXES IN TREE INVENTORY FOR PRUNING RECOMMENDATIONS.

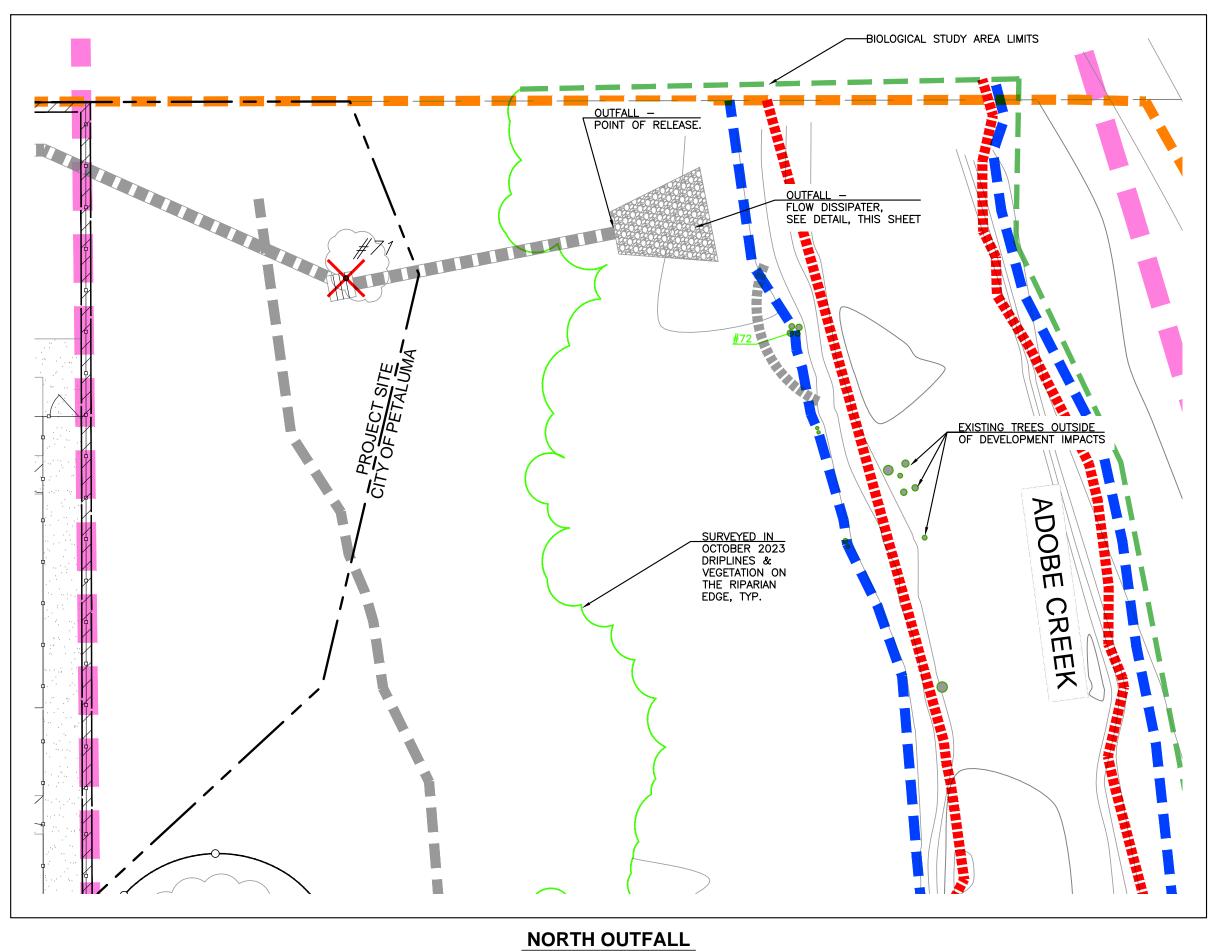


TREE INVENTORY - NORTH OUTFALL LOCATION

SCALE: 1"=10'

Tree #	Common Name	Botanical Name	Trunk Diameter(s) (Inches)	Health & Structure (1-5)	Protected Status	Comments	Construction Status/Recom'd
71	Fruiting pear	Pyrus spp.	3	2	Unprotected	Exhibits poor health.	Remove tree.
72	Oregon Ash	Fraxinus latifolia	8, 8, 7, 6	4	Protected	The tree is on the stream bank outside the existing wire fence.	Preserve and Protect. Prune to raise canopy for outfall construction clearance.


TREE INVENTORY NOTE:


SEE THE GREEN DESCRIPTION BOXES IN TREE INVENTORY FOR PRUNING RECOMMENDATIONS.

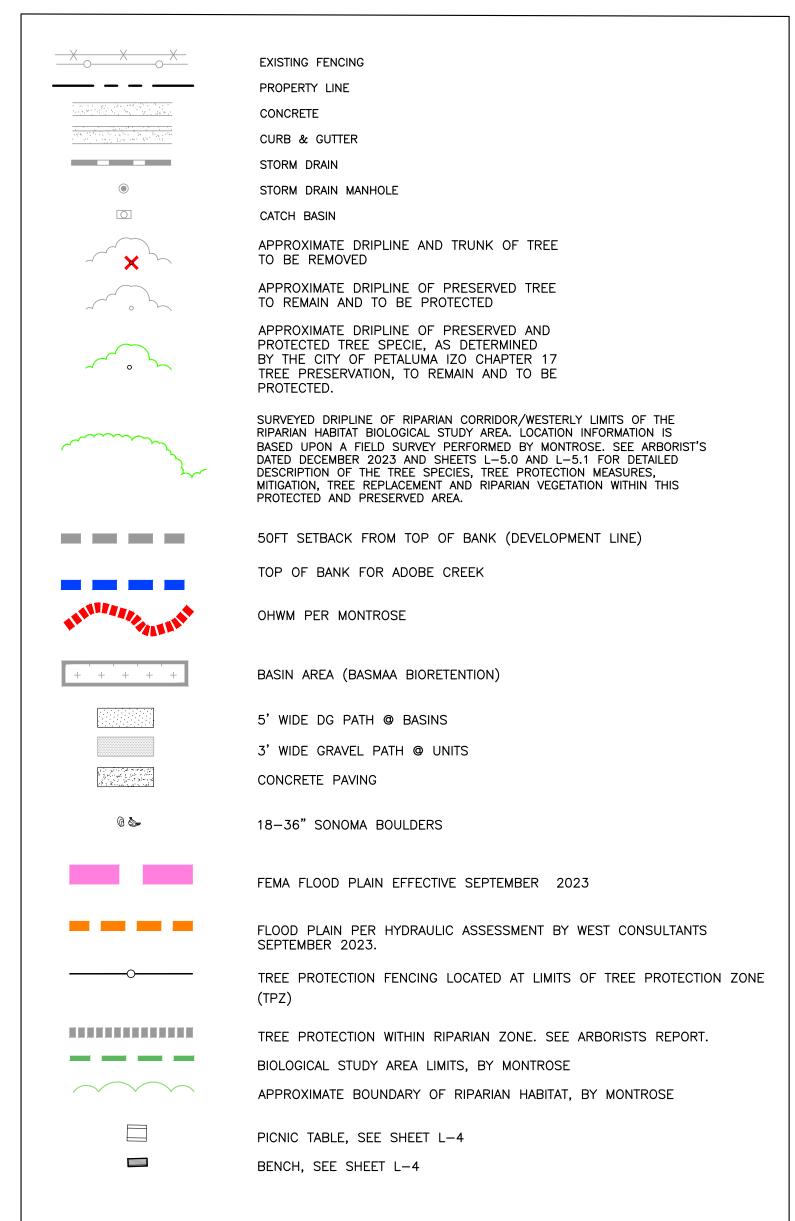

LEGEND

- FOR MITIGATION SUMMARY & TREE REPLACEMENT LOCATION, SEE SHEET L-5. 2. SEE ARBORIST REPORT BY URBAN FORESTRY, DATED DECEMBER 2023 FOR MORE
- PROVIDE TREE PROTECTION AT THE DRIPLINES AS DETERMINED BY THE ARBORIST IN THE FIELD. SEE PLAN FOR RECOMMENDED
 PROTECTION MEASURES. TREE PROTECTION
 MAY BE ADJUSTED AS NEEDED FOR CERTAIN CONSTRUCTION ACCESS WITH OVERSIGHT OF THE MONITORING ARBORIST. ADDITIONAL TREE PROTECTION MEASURES MAY BE APPLIED PER THE ARBORIST RECOMMENDATIONS.

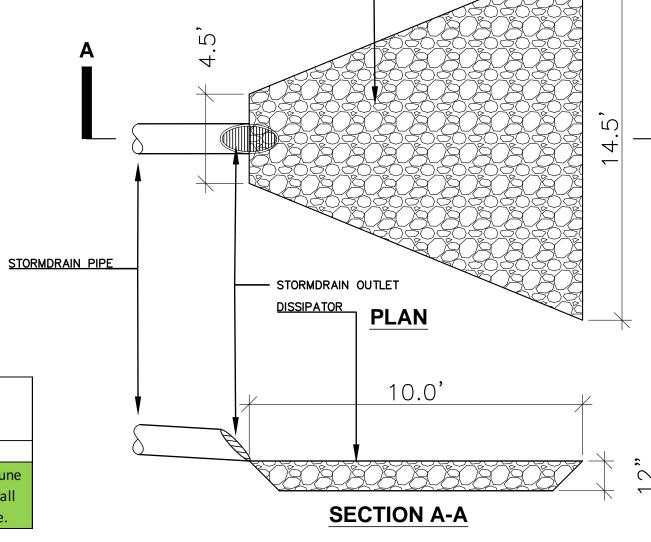

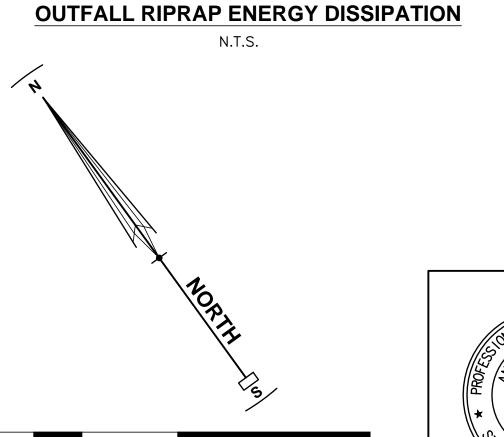

STEVEN J. LAFRANCHI & ASSOC CIVIL ENGINEERS ~ LAND SURVE LAND PLANNERS ~ LANDSCAPE ARC PETALUMA THEATRE SQUARE 140 SECOND STREET, SUITE 312	
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REVISIONS BY

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OUTF,

ARGED

CEMENT

REMOV/

RO V