LAKEVILLE RESIDENCE

315 LAKEVILLE STREET PATALUMA, CA APN: 007-154-013

PROJECT INFORMATION

A THREE STORY BUILDING WITH 4 ATTACHED DWELLING AND 9 OFF-STREET PARKING SPACES.

ZONING: MUIA

APN: 007-154-013 EXISTING SITE: 7,963 SF FAR: 2.5

AR: 2.5

UNIT I A:
LEVELS: 3UNIT I B:
LEVELS: 3BEDROOMS:2BEDROOMS:3

BATHROOMS:2 FULL-2 HALF BATHROOMS:2 FULL-2 HALF

AREA: 2,607 SF AREA: 2,607 SF

UNIT I C: LEVELS: 3 BEDROOMS:2 UNIT 1D: LEVELS: 3 BEDROOMS:2

BATHROOMS:2 FULL-2 HALF BATHROOMS:2 FULL-2 HALF

AREA: 2,490 SF

LEVELS: 2,484 SF

 FAR
 MAXIMUM
 PROPOSED

 2.5
 1.78

 19,907 SF
 14,157 SF

LOT COVERAGE

MAXIMUM 2.5 FAR PROPOSED 5,713 SF (71.7%)

AREA CALCULATION	<u> </u>
UNIT A:	2,607 SF
UNIT B:	2,607 SF
UNIT C:	2,490 SF
UNIT D:	2,484 SF
TOTAL:	10,188 SF
LANDSCAPE AREA	CALCULATION
UNIT A:	393 SF
UNIT B:	389 SF
UNIT C:	248 SF
UNIT D:	128 SF
TOTAL:	1,158 SF

SETBACKS:	REQUIRED	PROPOSED
LAKEVILLE ST.	0'-0"	7'-7 1/2"
ERWIN ST.	0'-0"	7'-7 1/4"
LEFT	0'-0"	5'-0"
RIGHT	0'-0"	5'-0"
HEIGHT:	REQUIRED	PROPOSED
MAX. HT	30'-0"	30'-0"
PARKING:	REQUIRED	PROPOSED
	9 COVERED	9 COVERED

VICINITY MAP



CONSULTANTS

STRUCTURAL: Munselle Civil Engineering 5 | 2 Center Street Healdsburg, CA 95448 (707) 775-8986

ACCESSIBILITY:
Pacific Access Consulting

1421 Guerneville Road, Suite 230Santa Rosa, CA 95403(707) 479-3872

LANDSCAPING: Regina Design - Regina Rollin 23030 S Central ave, Sonoma, CA 95476 (707) 694-7922

ACOUSTIC: Illingwortg & Rodkin, Inc.

I Willowbrrok Court, Suite 120 Petaluma, CA 94954 (707) 794-0405

ACOUSTICAL INFORMATION

-PROJECT-SPECIFIC ACOUSTICAL ANALYSES SHOULD BE CONDUCTED TO INSURE THAT INTERIOR NOISE LEVELS WILL BE REDUCED TO 45 DBA CNEL OR LESS.
RESULTS OF THE ANALYSIS, INCLUDING THE DESCRIPTION OF THE NECESSARY NOISE CONTROL TREATMENTS, WILL BE SUBMITTED TO THE CITY ALONG WITH THE BUILDING PLANS AND APPROVED PRIOR TO ISSUANCE OF A BUILDING PERMIT. WINDOWS AND DOORS WITH STC RATINGS OF 3 I OR GREATER WOULD BE NEEDED TO REDUCE INTERIOR NOISE LEVELS TO 45 DBA CNEL OR LESS TO AND MEET SECTION 10.2 OF THE CITY OF PETALUMA'S GENERAL PLAN.

-ALL PROJECT UNITS SHALL INCLUDE FRESH AIR MECHANICAL VENTILATION, SO THAT WINDOWS MAY BE KEPT CLOSED AT THE OCCUPANT'S DISCRETION TO CONTROL NOISE.

-MECHANICAL EQUIPMENT TO BE LOCATED IN THE CENTER OF THE BUILDING ROOFTOP.

-USE NO MORE THAN EIGHT HVAC UNITS WITH SOUND RATINGS OF 80 DBA LEQ AT A DISTANCE OF 5 FEET.

-IF HVAC UNITS ARE RATED TO GENERATE SOUND LEVELS GREATER THAN 80 DBA LEQ AT A DISTANCE OF 5 FEET, A BARRIER SYSTEM SHOULD BE INSTALLED TO ATTENUATE NOISE TO 60 DBA LEQ AT THE NEARBY RESIDENTIAL RECEPTORS.

DRAWING INDEX

AO.O COVER SHEET

ENGINEERING - EXISTING CONDITIONS

2 ENGINEERING - PROPOSED CONDITIONS

A I .O VICINITY MAP / EXISTING SITE PLAN / SITE SECTIONS

AI.I SITE PLAN SKETCH

A1.2 SITE IMAGES

A2.0 ROOF PLAN

A2.1 PROPOSED LOWER FLOOR

A2.2 PROPOSED LEVEL 2

A2.3 PROPOSED LEVEL 3

A2.4 ACCESSIBILITY PLANS

A3.0 BUILDING ELEVATIONS

A3.1 BUILDING ELEVATIONS

A4.0 BUILDING SECTIONS

A5.0 RENDERINGS

AG.O MATERIALS BOARD

LI LANDSCAPE - LAYOUT PLAN

L2 LANDSCAPE - PLANTING PLAN

L3 LANDSCAPE - EXISTING TREES AND TREE REMOVAL NOTES

L4 LANDSCAPE - DETAILS AND NOTES

L5 LANDSCAPE - IRRIGATION PLAN

L6 LANDSCAPE - IRRIGATION AND PLANTING DETAILS AND NOTES

L7 LANDSCAPE - HYDROZONE PLAN

NICKLEE CONTACT:

NICHOLAS LEE 807 HAIGHT AVE. ALAMEDA, CA 94501 PH: 415.378.4337 nickleearchitecture.com

LAKEVILLE RESIDENCE

No.	Description	Date

COVER SHEET		
Date Drawn by	09.07.17	A0.0
,		Scale

USE PERMIT APPLICATION EXHIBIT

315 LAKEVILLE STREET

PETALUMA, CA APN 007-154-013

OWNER


JMS IRON RIVER LLC 109 G STREET PETALUMA, CA 94952

CONTACT

MUNSELLE CIVIL ENGINEERING/DVC GROUP DAN HUGHES 513 CENTER STREET HEALDSBURG, CA 95448 (707) 395-0968


DRAWING INDEX

LOCATION AND EXISTING EXHIBITS PROPOSED SITE AND UTILITY PLAN

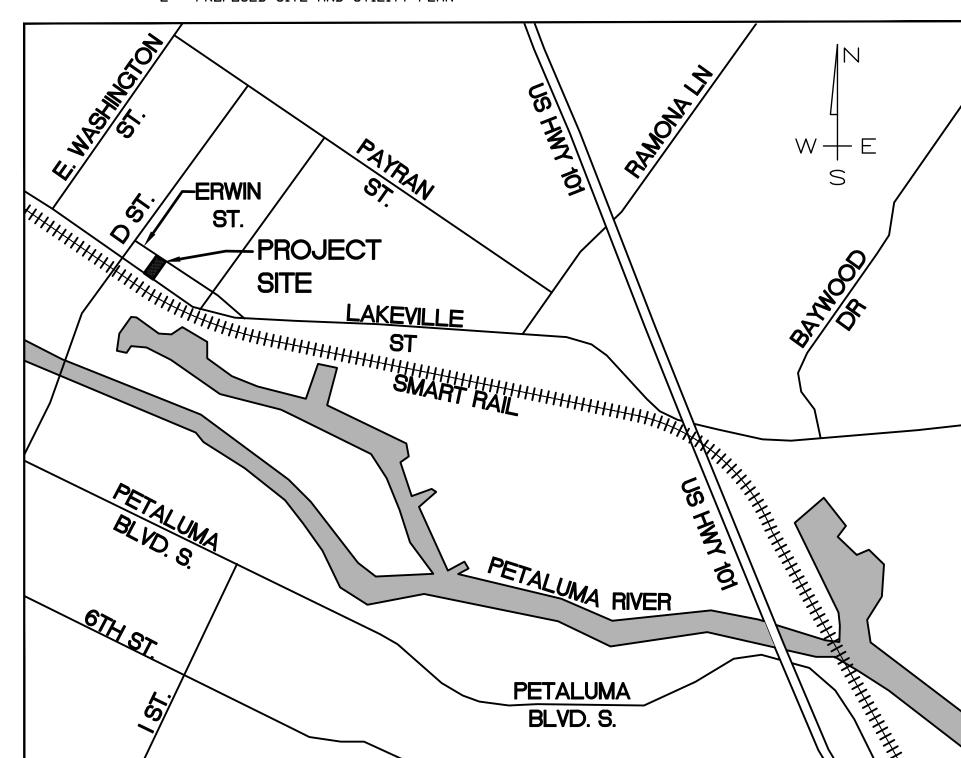


VICINITY MAP

ND SCALE

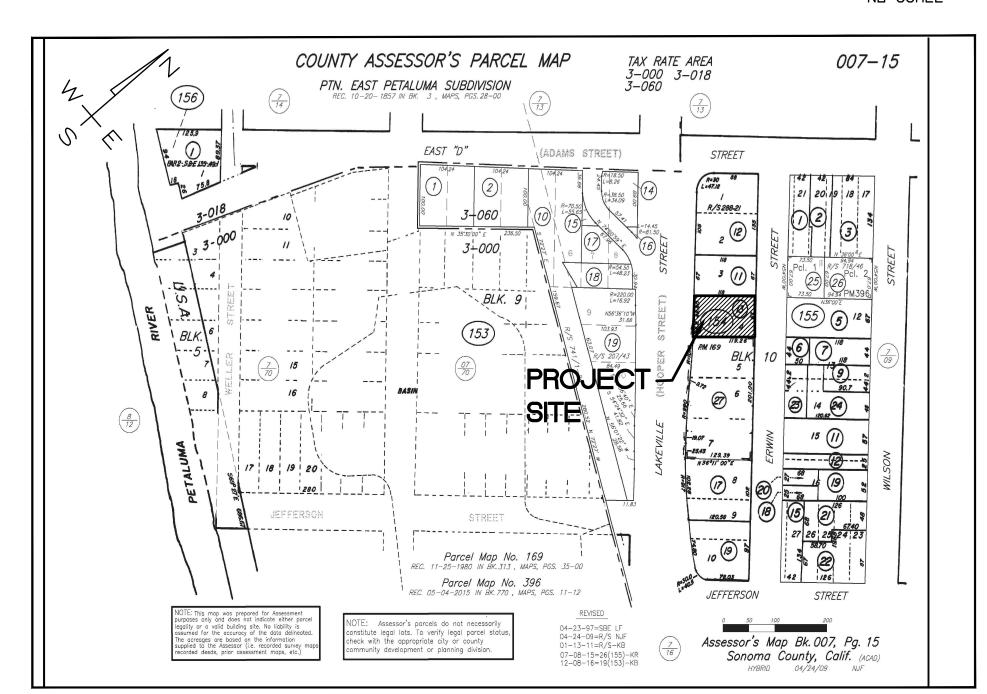


PARCEL MAP

NO SCALE

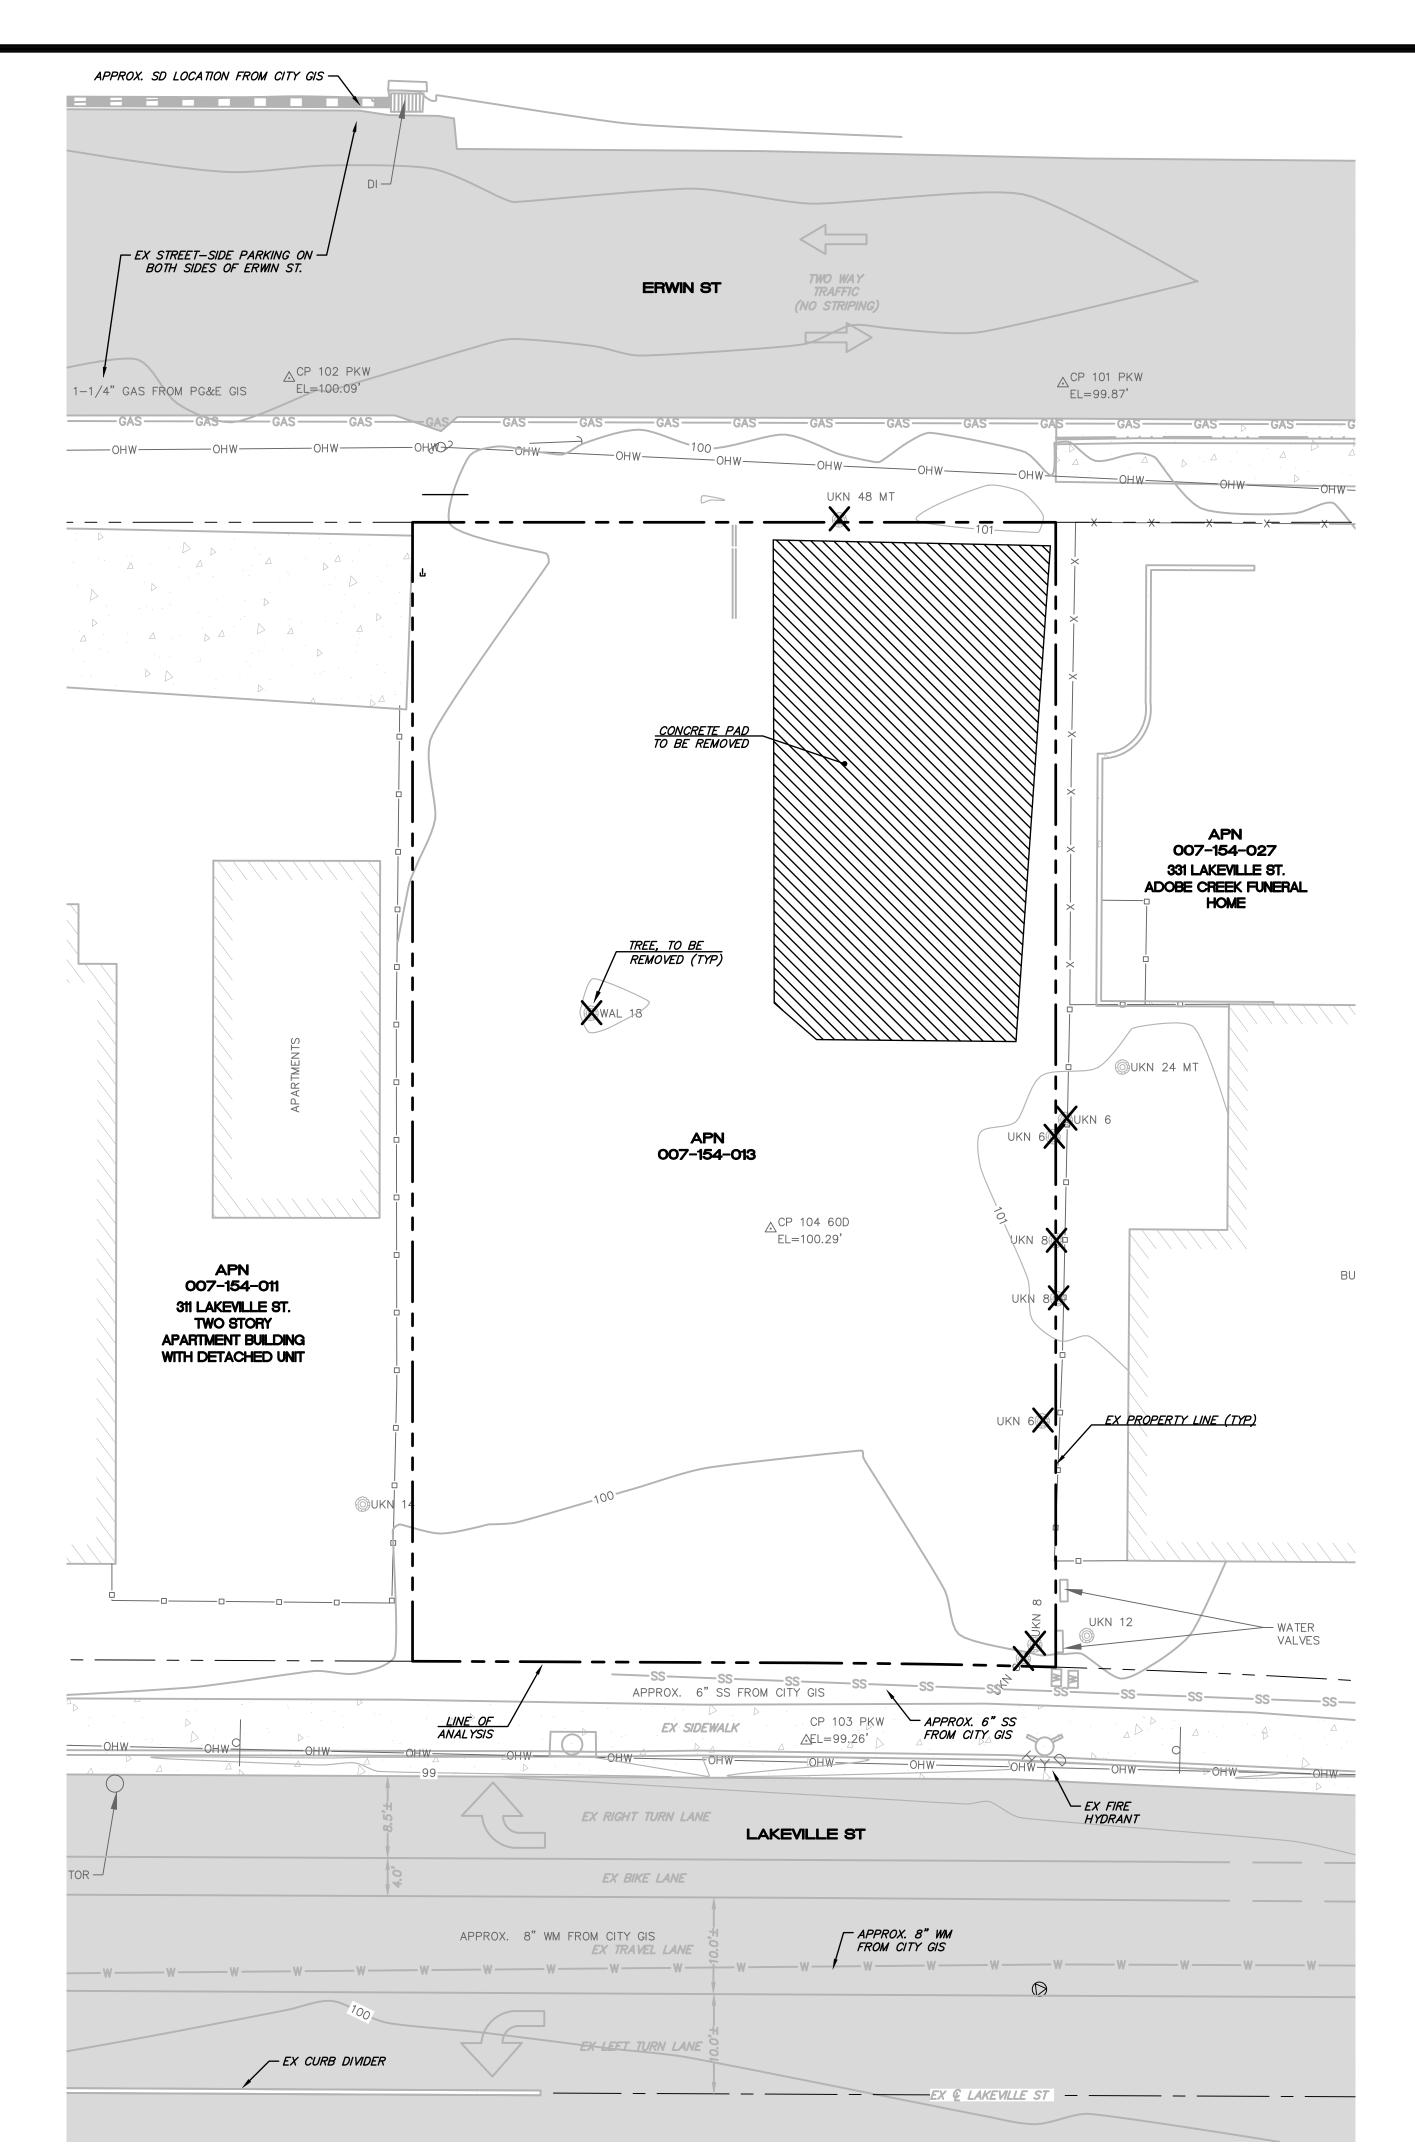

LEGEND

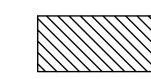

TO BE REMOVED



TO BE REMOVED



TREE TO BE SAVED



TREE TO BE REMOVED

GENERAL NOTES

BOUNDARY LINES SHOWN HEREON ARE DELINEATED FROM RECORD DATA ONLY AND DOES NOT CONSTITUTE A BOUNDARY SURVEY.

UTILITIES SHOWN HEREON ARE BASED UPON PHYSICAL FEATURES OBSERVED AT THE TIME OF THE SURVEY. LOCATION OF UNDERGROUND UTILITIES SHALL BE PERFORMED BY A SUBSURFACE UTILITY LOCATING COMPANY (IF DESIRED).

BASIS OF BEARINGS:N27°56′51″W
BETWEEN A FOUND NAIL MONUMENT AND A FOUND 1/2″
IRON PIPE MONUMENT AS SHOWN ON RECORD OF SURVEY
RECORDED IN BOOK 313 OF MAPS AT PAGE 35, SONOMA
COUNTY RECORDS.

ELEVATIONS SHOWN HEREON ARE ON AN ASSUMED DATUM.
BENCHMARK CONTROL POINT #100 SET 60D CONTROL POINT.
ELEVATION = 100.00'

NOTE:

1. DEMOLITION WORK IS NOT COVERED UNDER GRADING PERMIT AND MAY REQUIRE SEPARATE PERMITS.

ISION DESCRIPTION BY DATE

SELLE CIVIL ENGINEERIN Engineering Land Plannin Enter street DSBURG, CA 95448

CIVIL ENGINE STATE STATE

DATE

| CONT. | CONT.

DANIEL JOHN HUGHES DATE


KISTING CONDITIONS
APN 007-154-013
315 LAKEVILLE STREET

SEPTEMBER 07, 2017
JOB NO.

SHEET NO.


OF 2 SHEET

OBS\2017\22-17 315 LAKEVILLE ST SURVEY\DWGS\22-17 USE PERMIT.DWG

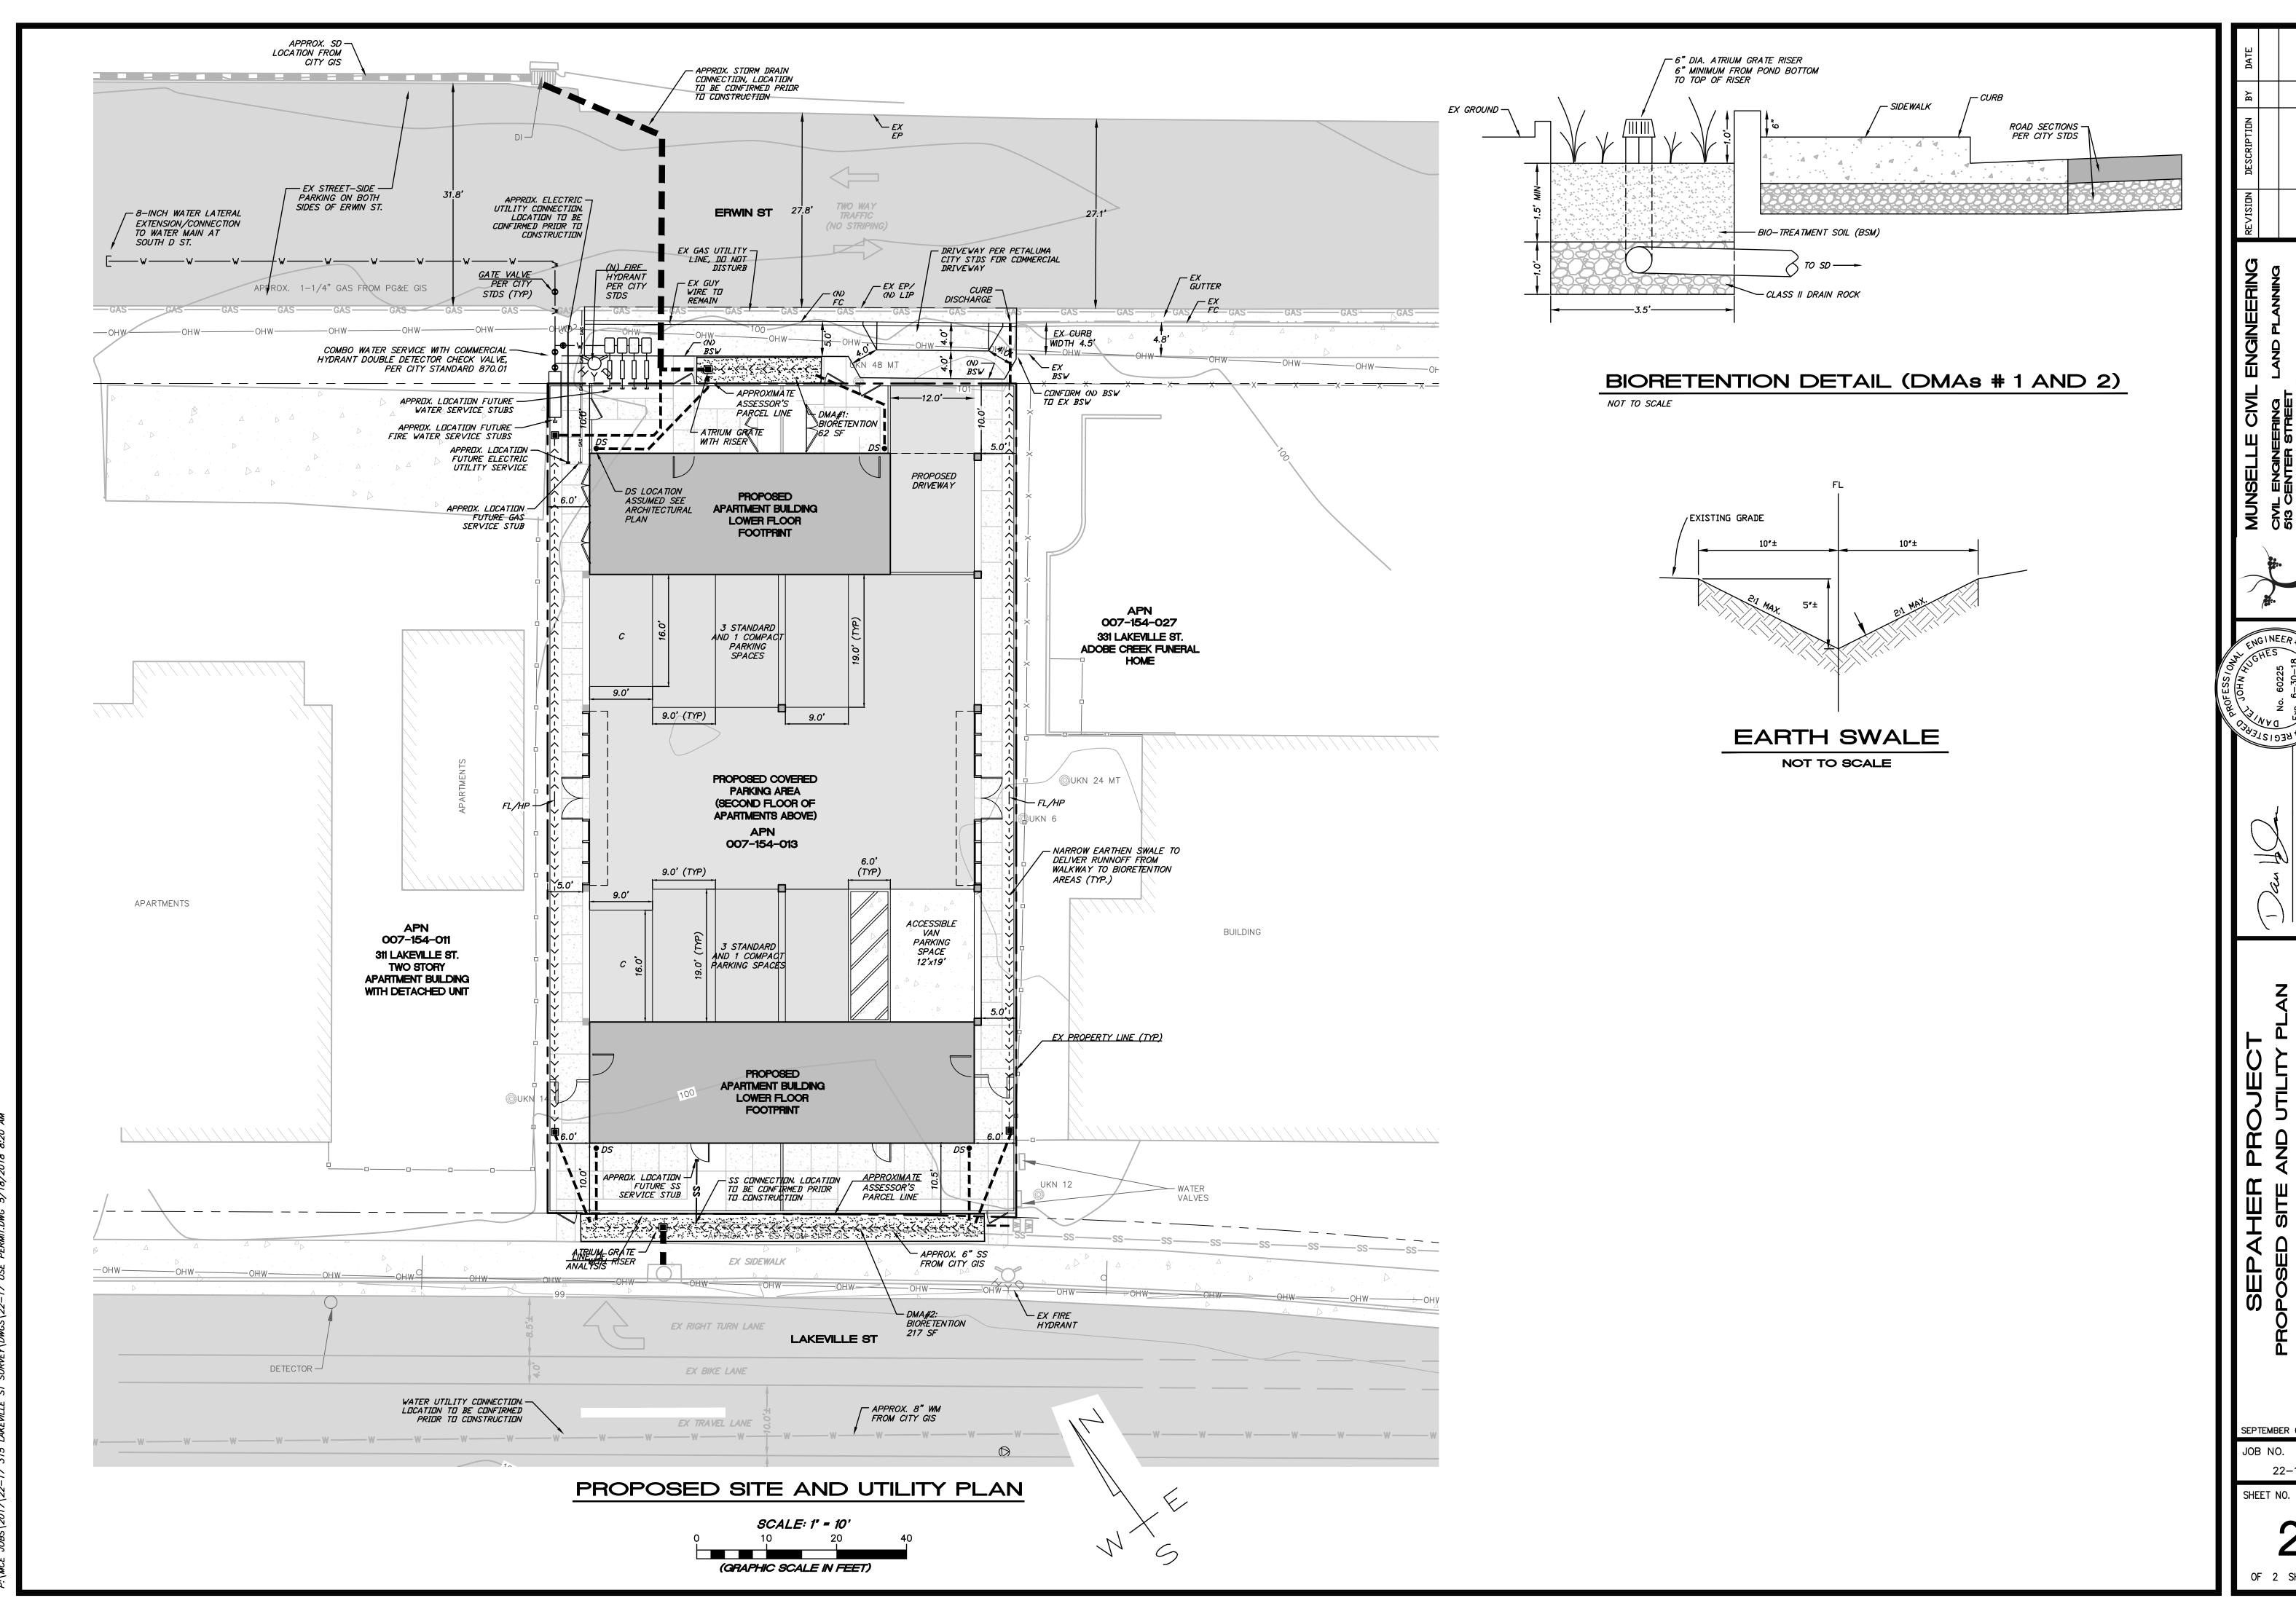

SEPTEMBER 07, 2017

22-17

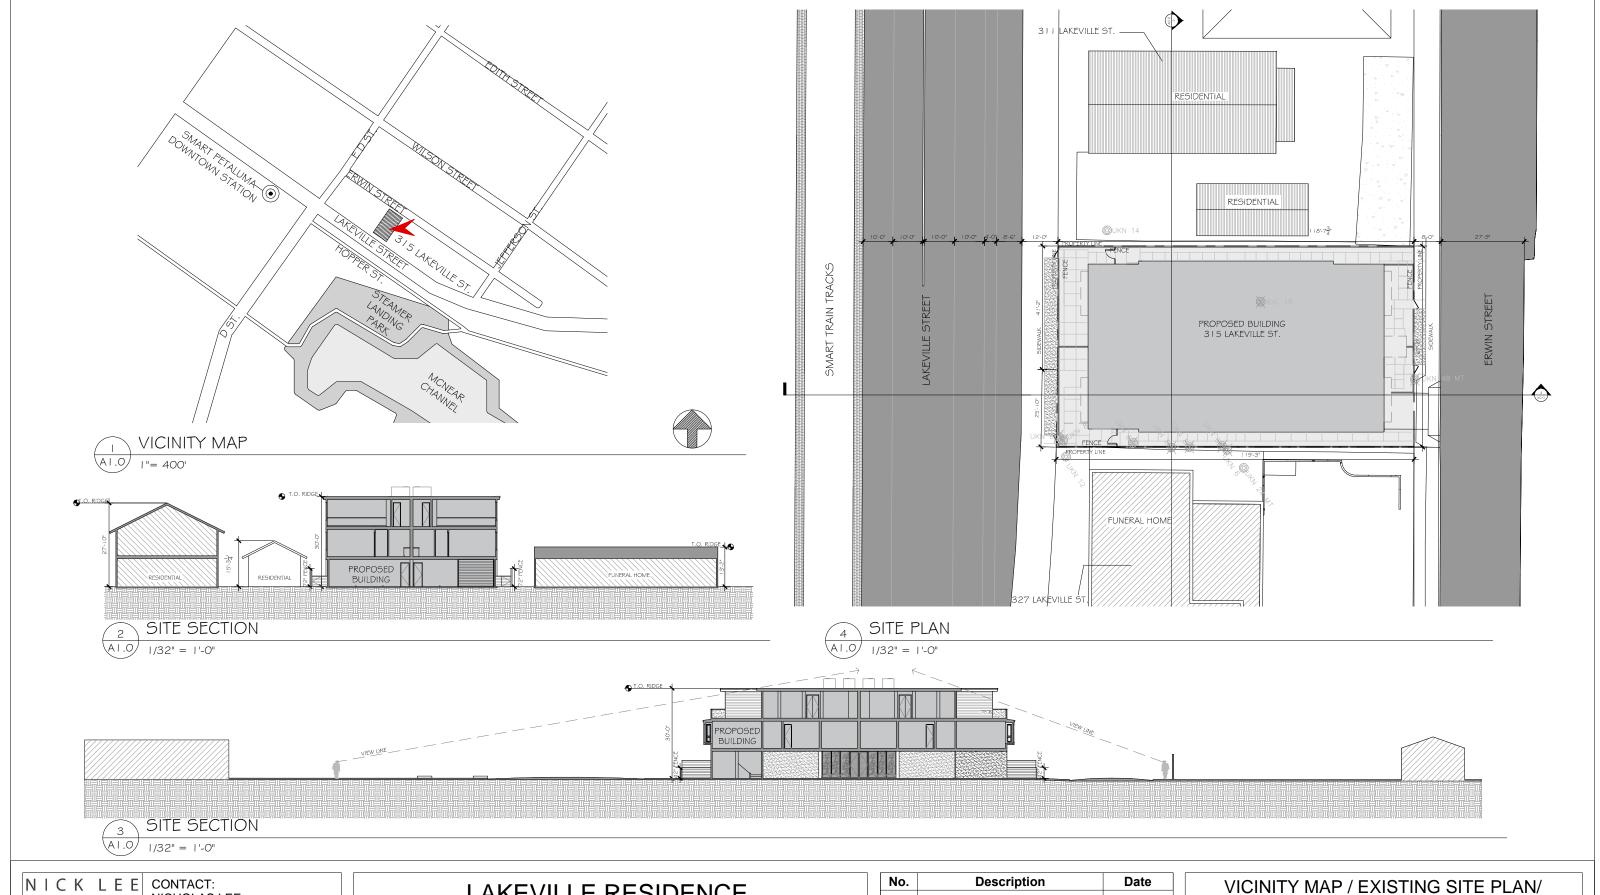

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807 HAIGHT AVE.
ALAMEDA, CA 294501 PH: 415.378.4337 nickleearchitecture.com

LAKEVILLE RESIDENCE

315 LAKEVILLE STREET PETALUMA, CA APN: 007-154-013

No.	Description	Date

VICINITY MAP / EXISTING SITE PLAN/		
SITE SECTIONS		

09.07.17 Date Drawn by

Scale AS NOTED



I - VIEW WEST TO SITE FROM LAKEVILLE STREET



4- VIEW NORTH TO SITE FROM ERWIN STREET



7- VIEW EAST FROM SITE (ERWIN STREET)



2- VIEW SOUTH TO SITE FROM LAKEVILLE STREET



5- VIEW WEST FROM SITE (LAKEVILLE STREET)




8- VIEW NORTH FROM SITE (ERWIN STREET)



3- VIEW EAST TO SITE FROM ERWIN STREET



6- VIEW SOUTH FROM SITE (LAKEVILLE STREET)

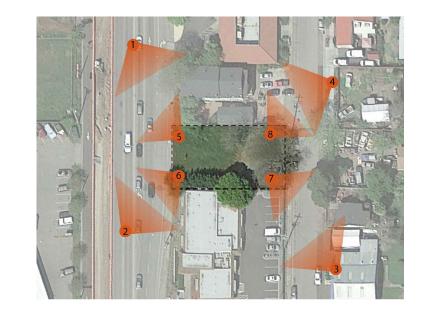


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LAKEVILLE RESIDENCE

No.	Description	Date

SITE IMAGES		
Date Drawn by	09.07.17	A1.2
		Scale



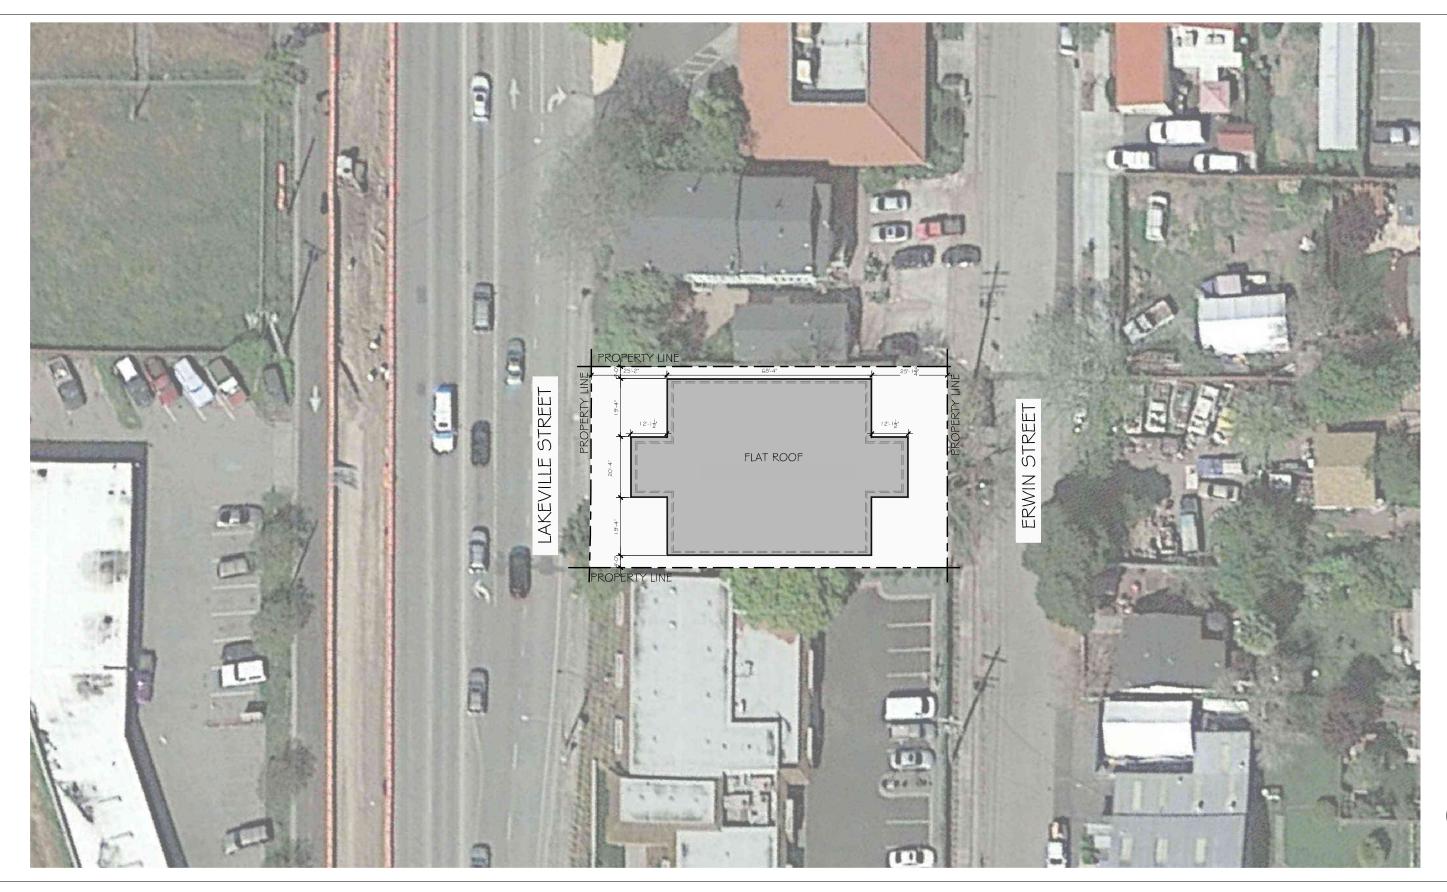


NICKLEE
ARCHITECTURE

CONTACT:
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807 HAIGHT AVE.
ALAMEDA, CA 94501
PH: 415.378.4337
nickleearchitecture.com

LAKEVILLE RESIDENCE

No.	Description	Date

SITE PLAN SKETCH		
Date Drawn by	09.07.17	A1.1
		Scale 1/32" = 1'-0"

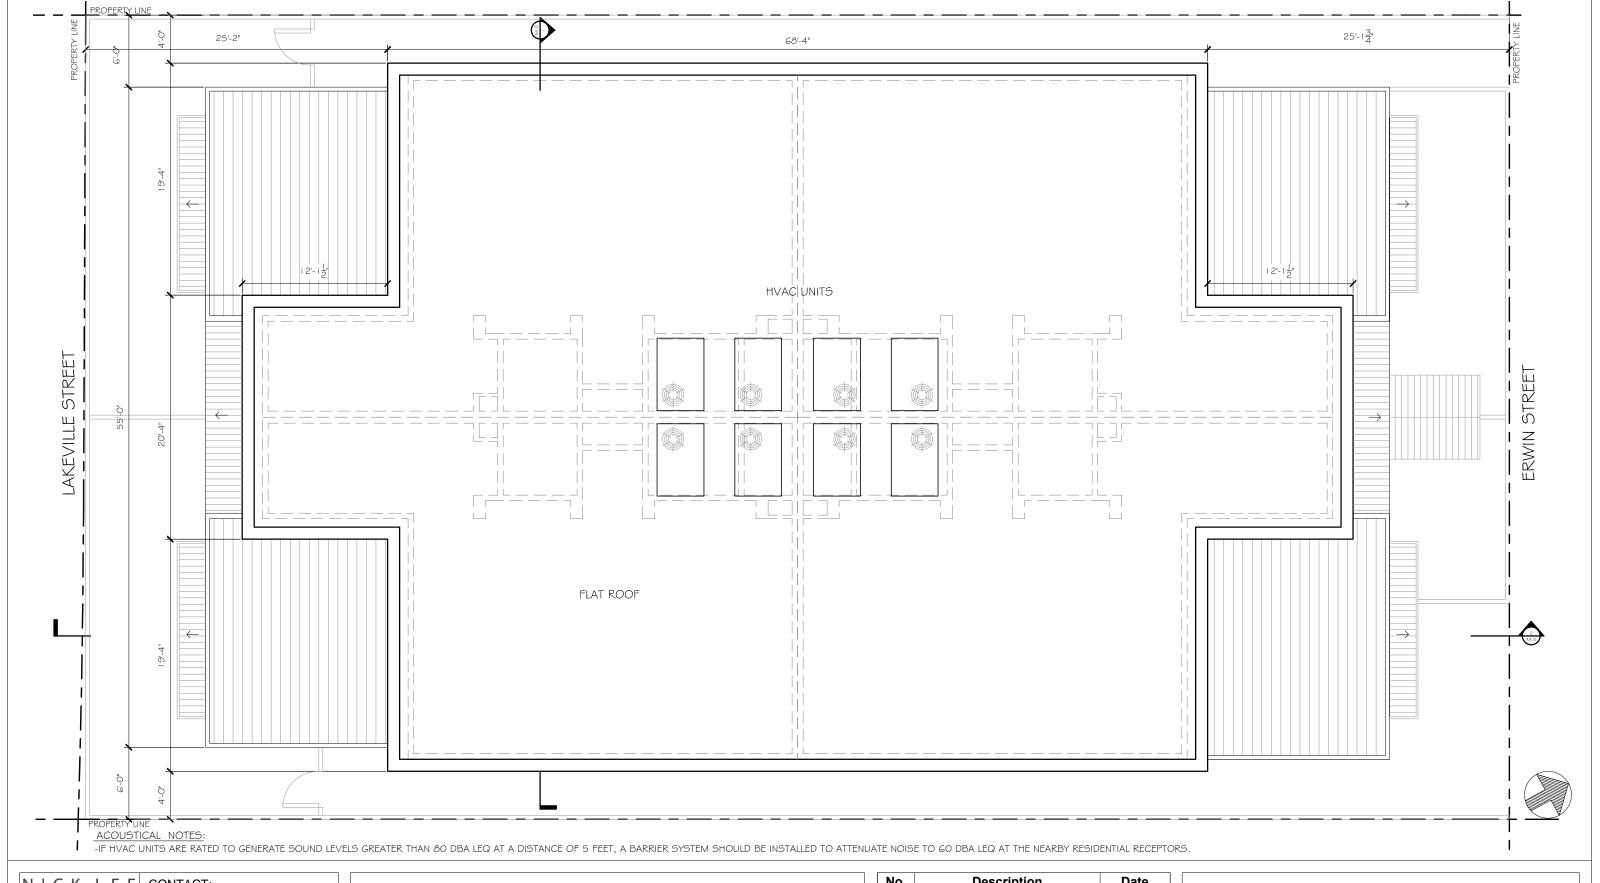

N I C K L E E
ARCHITECTURE


ARCHITECTURE


CONTACT:
NICHOLAS LEE
807 HAIGHT AVE.
ALAMEDA, CA 94501
PH: 415.378.4337
nickleearchitecture.com

LAKEVILLE RESIDENCE

No.	Description	Date

ROOF PLAN		
Date 09.07.17 A2.0		
*		Scale 1/8" = 1'-0"

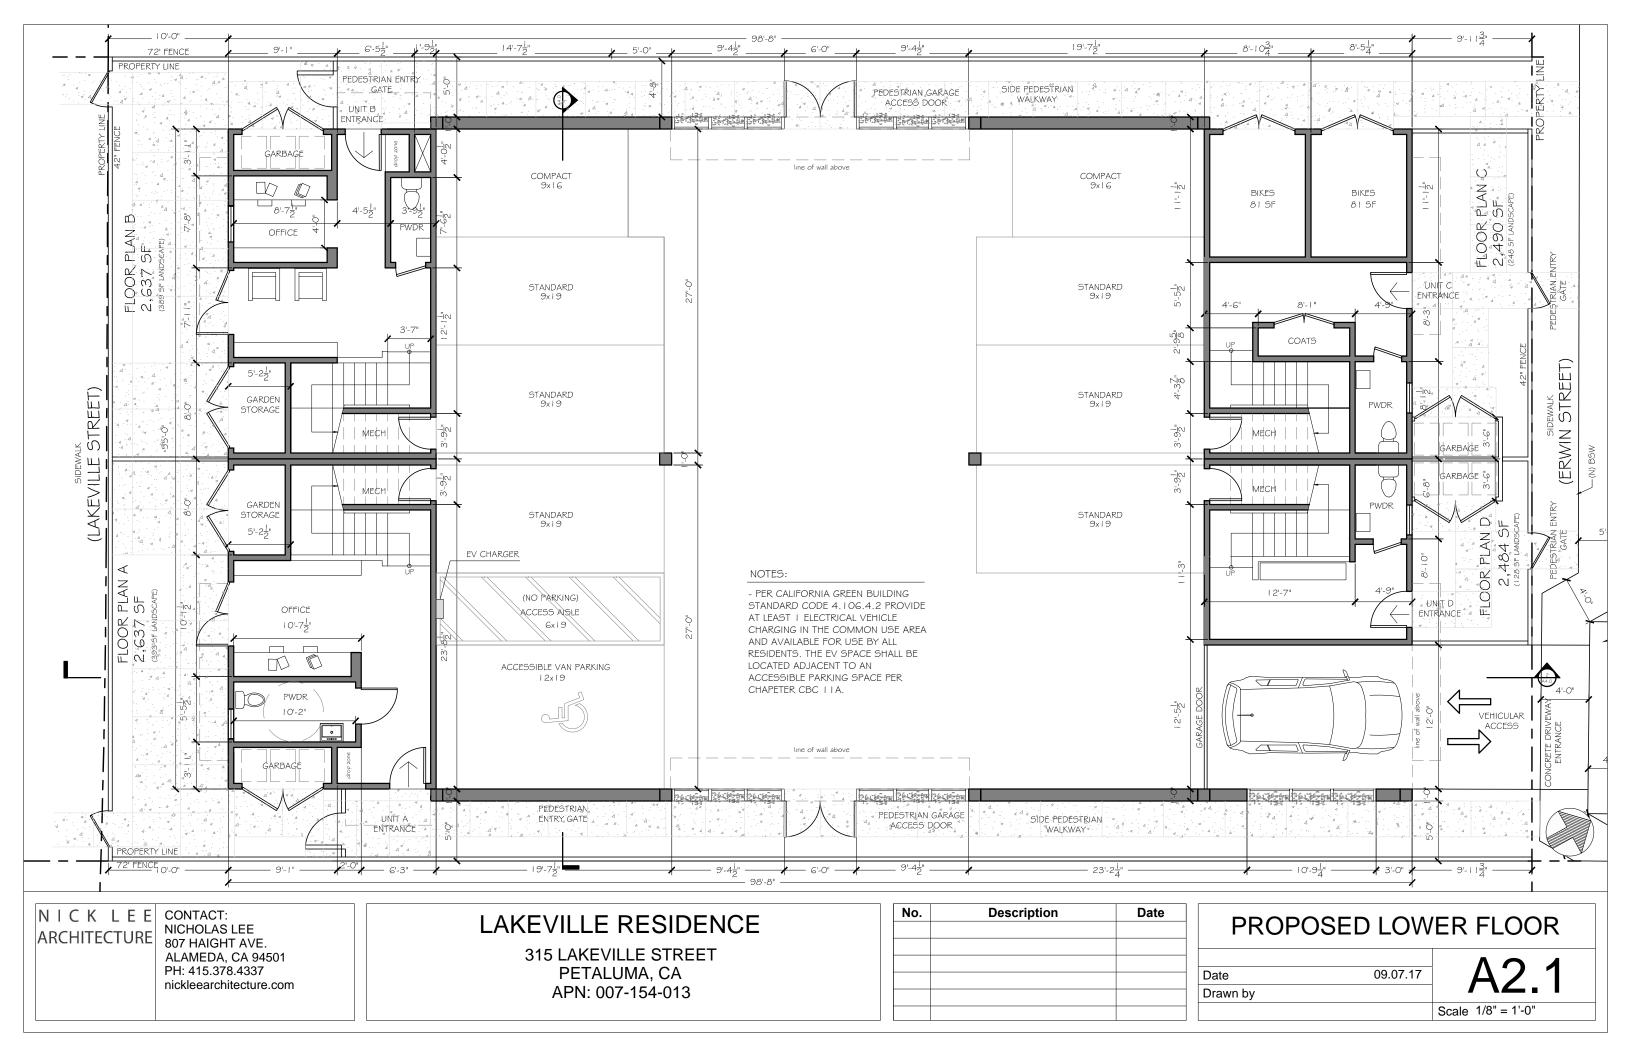

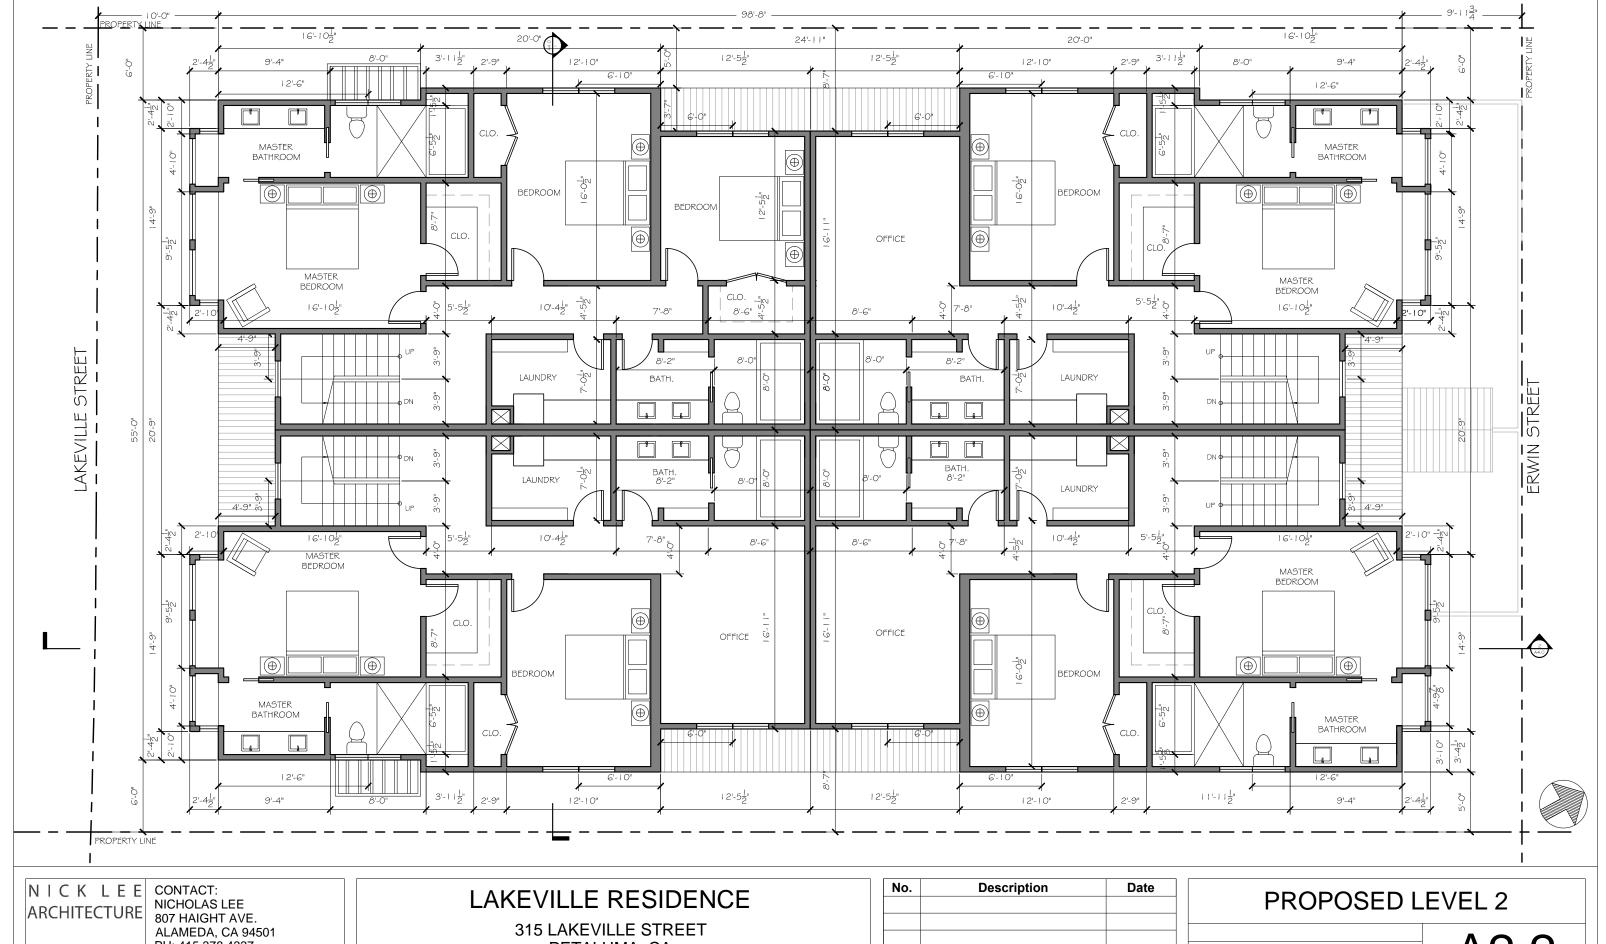



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PETALUMA, CA APN: 007-154-013

No.	Description	Date	
			Г
			F
	NO.	NO. Description	No. Description Date

	PROPOSED LEVEL 2		
ate	09.07.17	Δ22	
rawn by		/ \	
		Scale 1/8" = 1'-0"	



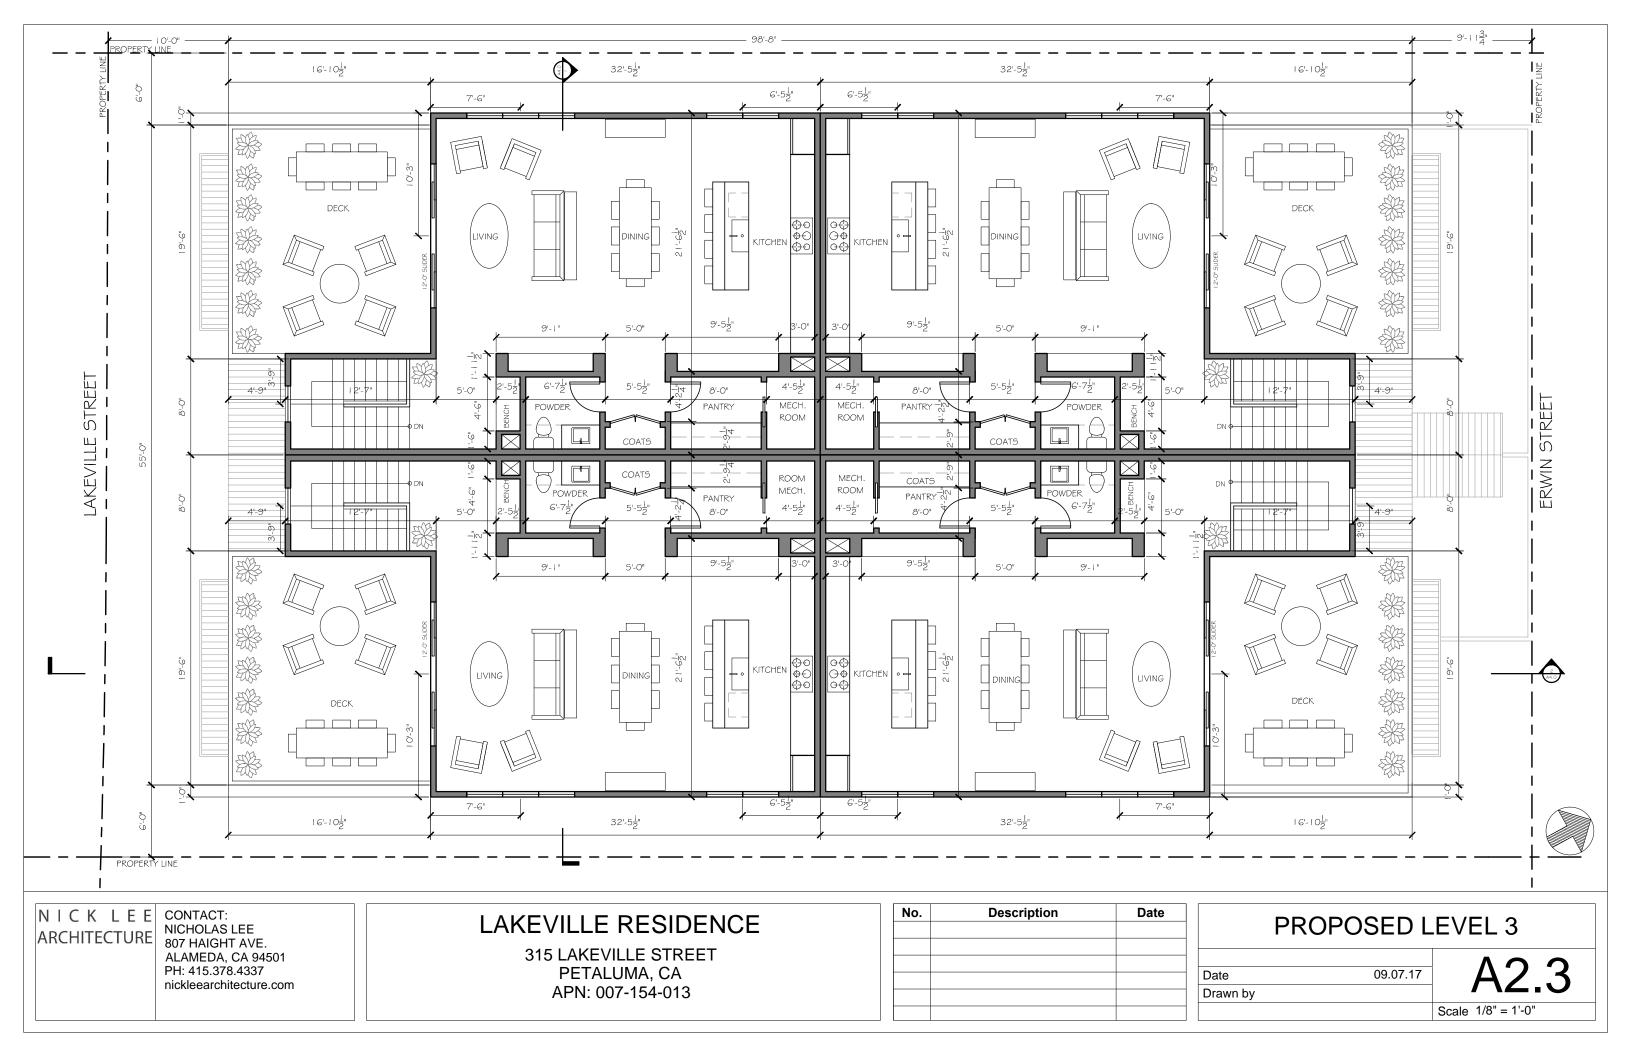

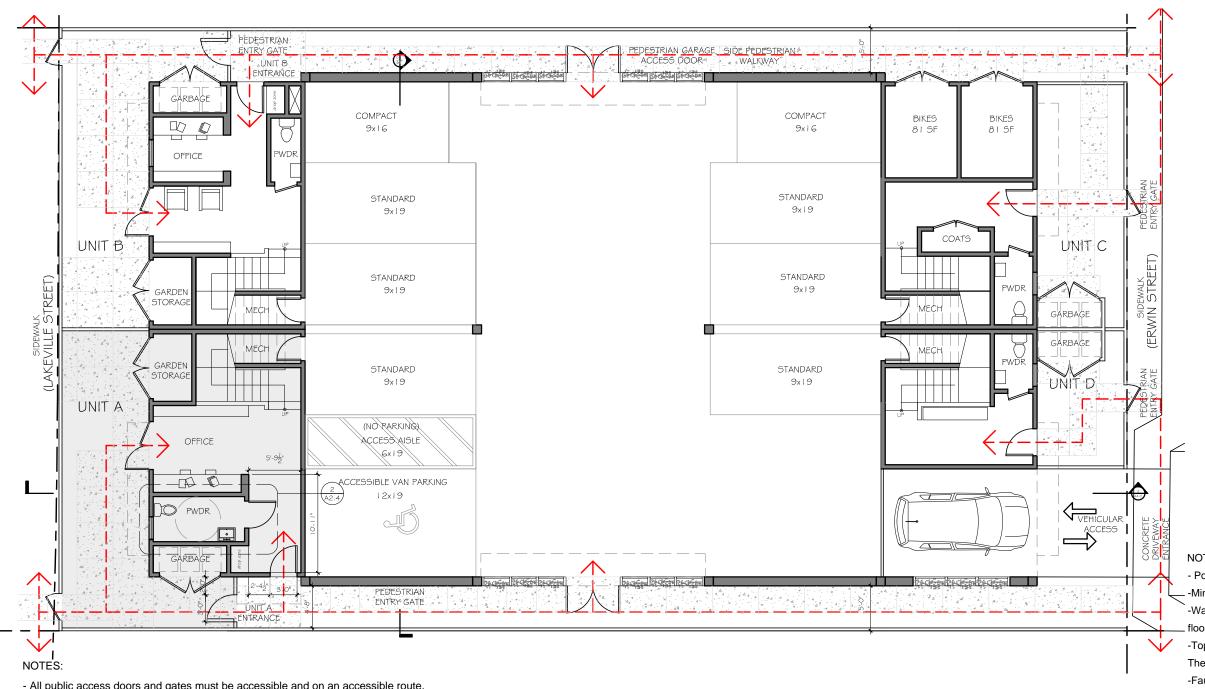Reinforcing for grab bars per 1134A.7 ıtem 2 **POWDER** ROOM 3'-0"

NOTES:

- Powder room to comply with CAC 1134A and 1136A
- -Minimum height of water closet seats shall be 15 inches above the floor. -Water closet controls shall be mounted no more than 44 inches above the
- -Top of lavatory shall be a maximum of 34 inches above the finished floor. The space beneath the lavatory shall be left clear and unobstructed.
- -Faucet controls and operation mechanisms shall be operable with one hand and shall not require tight grasping, pinching or twisting of the wrist.
- -Electrical receptacle outlets shall be located no more than 48 inches measured from the top of the receptacle outlet box nor less than 15 inches measured from the bottom of the receptacle outlet box to the level of the finished floor.


- All public access doors and gates must be accessible and on an accessible route.
- Unit A to be adaptable and shall comply with CAC 1104.A.3.1
- Per 1132A Swinging doors shall provide a net clear opening width of not less than 32 inches measured with the door or doors positioned at an angle of 90 degrees from the closed position.
- Maneuvering clearances at interior doors shall provide a minimum length on both sides of the door of at least 42 inches measured at a right angle to the plane of the door in its closed position.

ACCESSIBLE ROUTE

ADAPTABLE UNIT

ACCESSIBLE ROUTE OF TRAVEL

A2.4 3/32" = 1'-0"

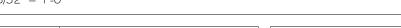

NICK LEE CONTACT: ARCHITECTURE

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LAKEVILLE RESIDENCE

No.	Description	Date

2	POWDER ROOM AT ADAPTABLE UNIT
A2.4/	3/8" = '-0"

	ACCESSIBILITY PLANS		
Date Drawn by	09.07.17	A2.4	
		Scale AS NOTED	



FLOOR PLAN A 409 SF 1.258 SF 940 SF 2,607 SF 323 SF 393 SF LANDSCAPE: **UNCONDITIONED:** 68 SF

409 SF 1,258 SF 940 SF 2,607 SF 323 SF LANDSCAPE: 389 SF **UNCONDITIONED:** 68 SF

292 SF 1.258 SF 940 SF 2,490 SF 323 SF LANDSCAPE: 248 SF 26 SF **UNCONDITIONED:**

FLOOR PLAN D 269 SF 1,275 SF 940 SF 2,484 SF 340 SF LANDSCAPE: 128 SF **UNCONDITIONED:** 26 SF

ARCHITECTURE

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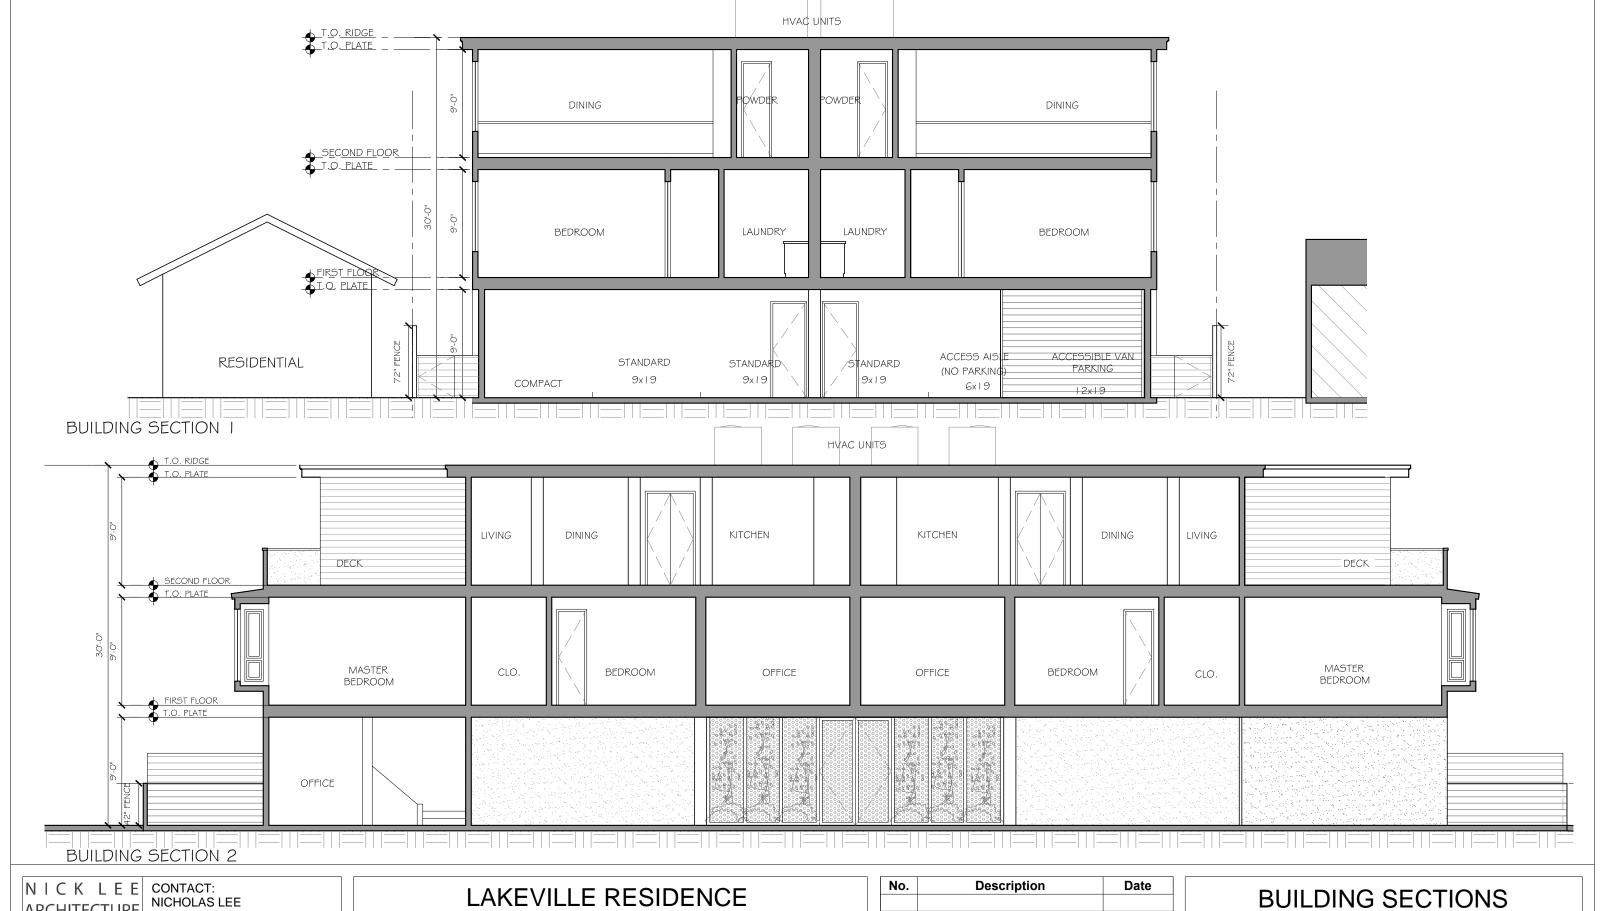
315 LAKEVILLE STREET PETALUMA, CA APN: 007-154-013

NO.	Description	Date

BUILDING ELEVATIONS

		A O O
Date	09.07.17	\perp Δ \prec ()
Drawn by		710.0
		Scale 1/8" = 1'-0"





ARCHITECTURE 807 HAIGHT AVE. ALAMEDA, CA 94501 PH: 415.378.4337 nickleearchitecture.com

Date]	Date	Description	No.
]			
	Date			

BUILDING SECTIONS		
Date Drawn by	09.07.17	A4.0
		Scale 1/8" = 1'-0"





VIEW FROM LAKEVILLE STREET

VIEW FROM ERWIN STREET

NICKLEE
ARCHITECTURE

ARCHITECTURE


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ALAMEDA, CA 94501
PH: 415.378.4337
nickleearchitecture.com

LAKEVILLE RESIDENCE

No.	Description	Date

	RENDERINGS		
Date Drawn by	09.07.17	A5.0	
		Scale	



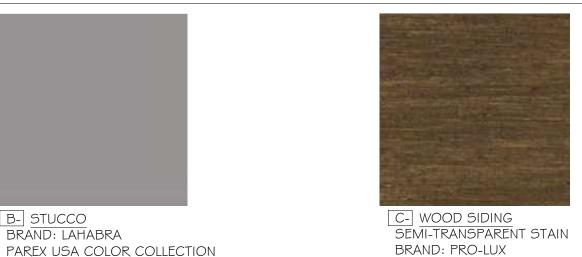



D- EXTERIOR WINDOWS AND DOORS ALUMINUM CLAD BRAND: ANDERSEN OR EQUAL COLOR: DARK BRONZE

COLOR: HICKORY COLOR: BASALT 3015L (29) HVAC UNITS G С D В D Α B Н LAKEVILLE ELEVATION



E- WOOD BUMP-OUT SEMI-TRANSPARENT STAIN BRAND: PRO-LUX COLOR: HICKORY



F- CONCRETE EXTERIOR FLOORS BRAND: DAVIS COLORS COLOR: OUTBACK



G- TUBE ARCHITECTURAL- LED WALL MOUNT LIGHT BRAND: WAC LIGHTING COLOR: GRAPHITE

H- LED GARDEN AND PATHWAY LUMINAIRE BRAND: LUMENS COLOR: GRAPHITE

NICK LEE CONTACT: ARCHITECTURE

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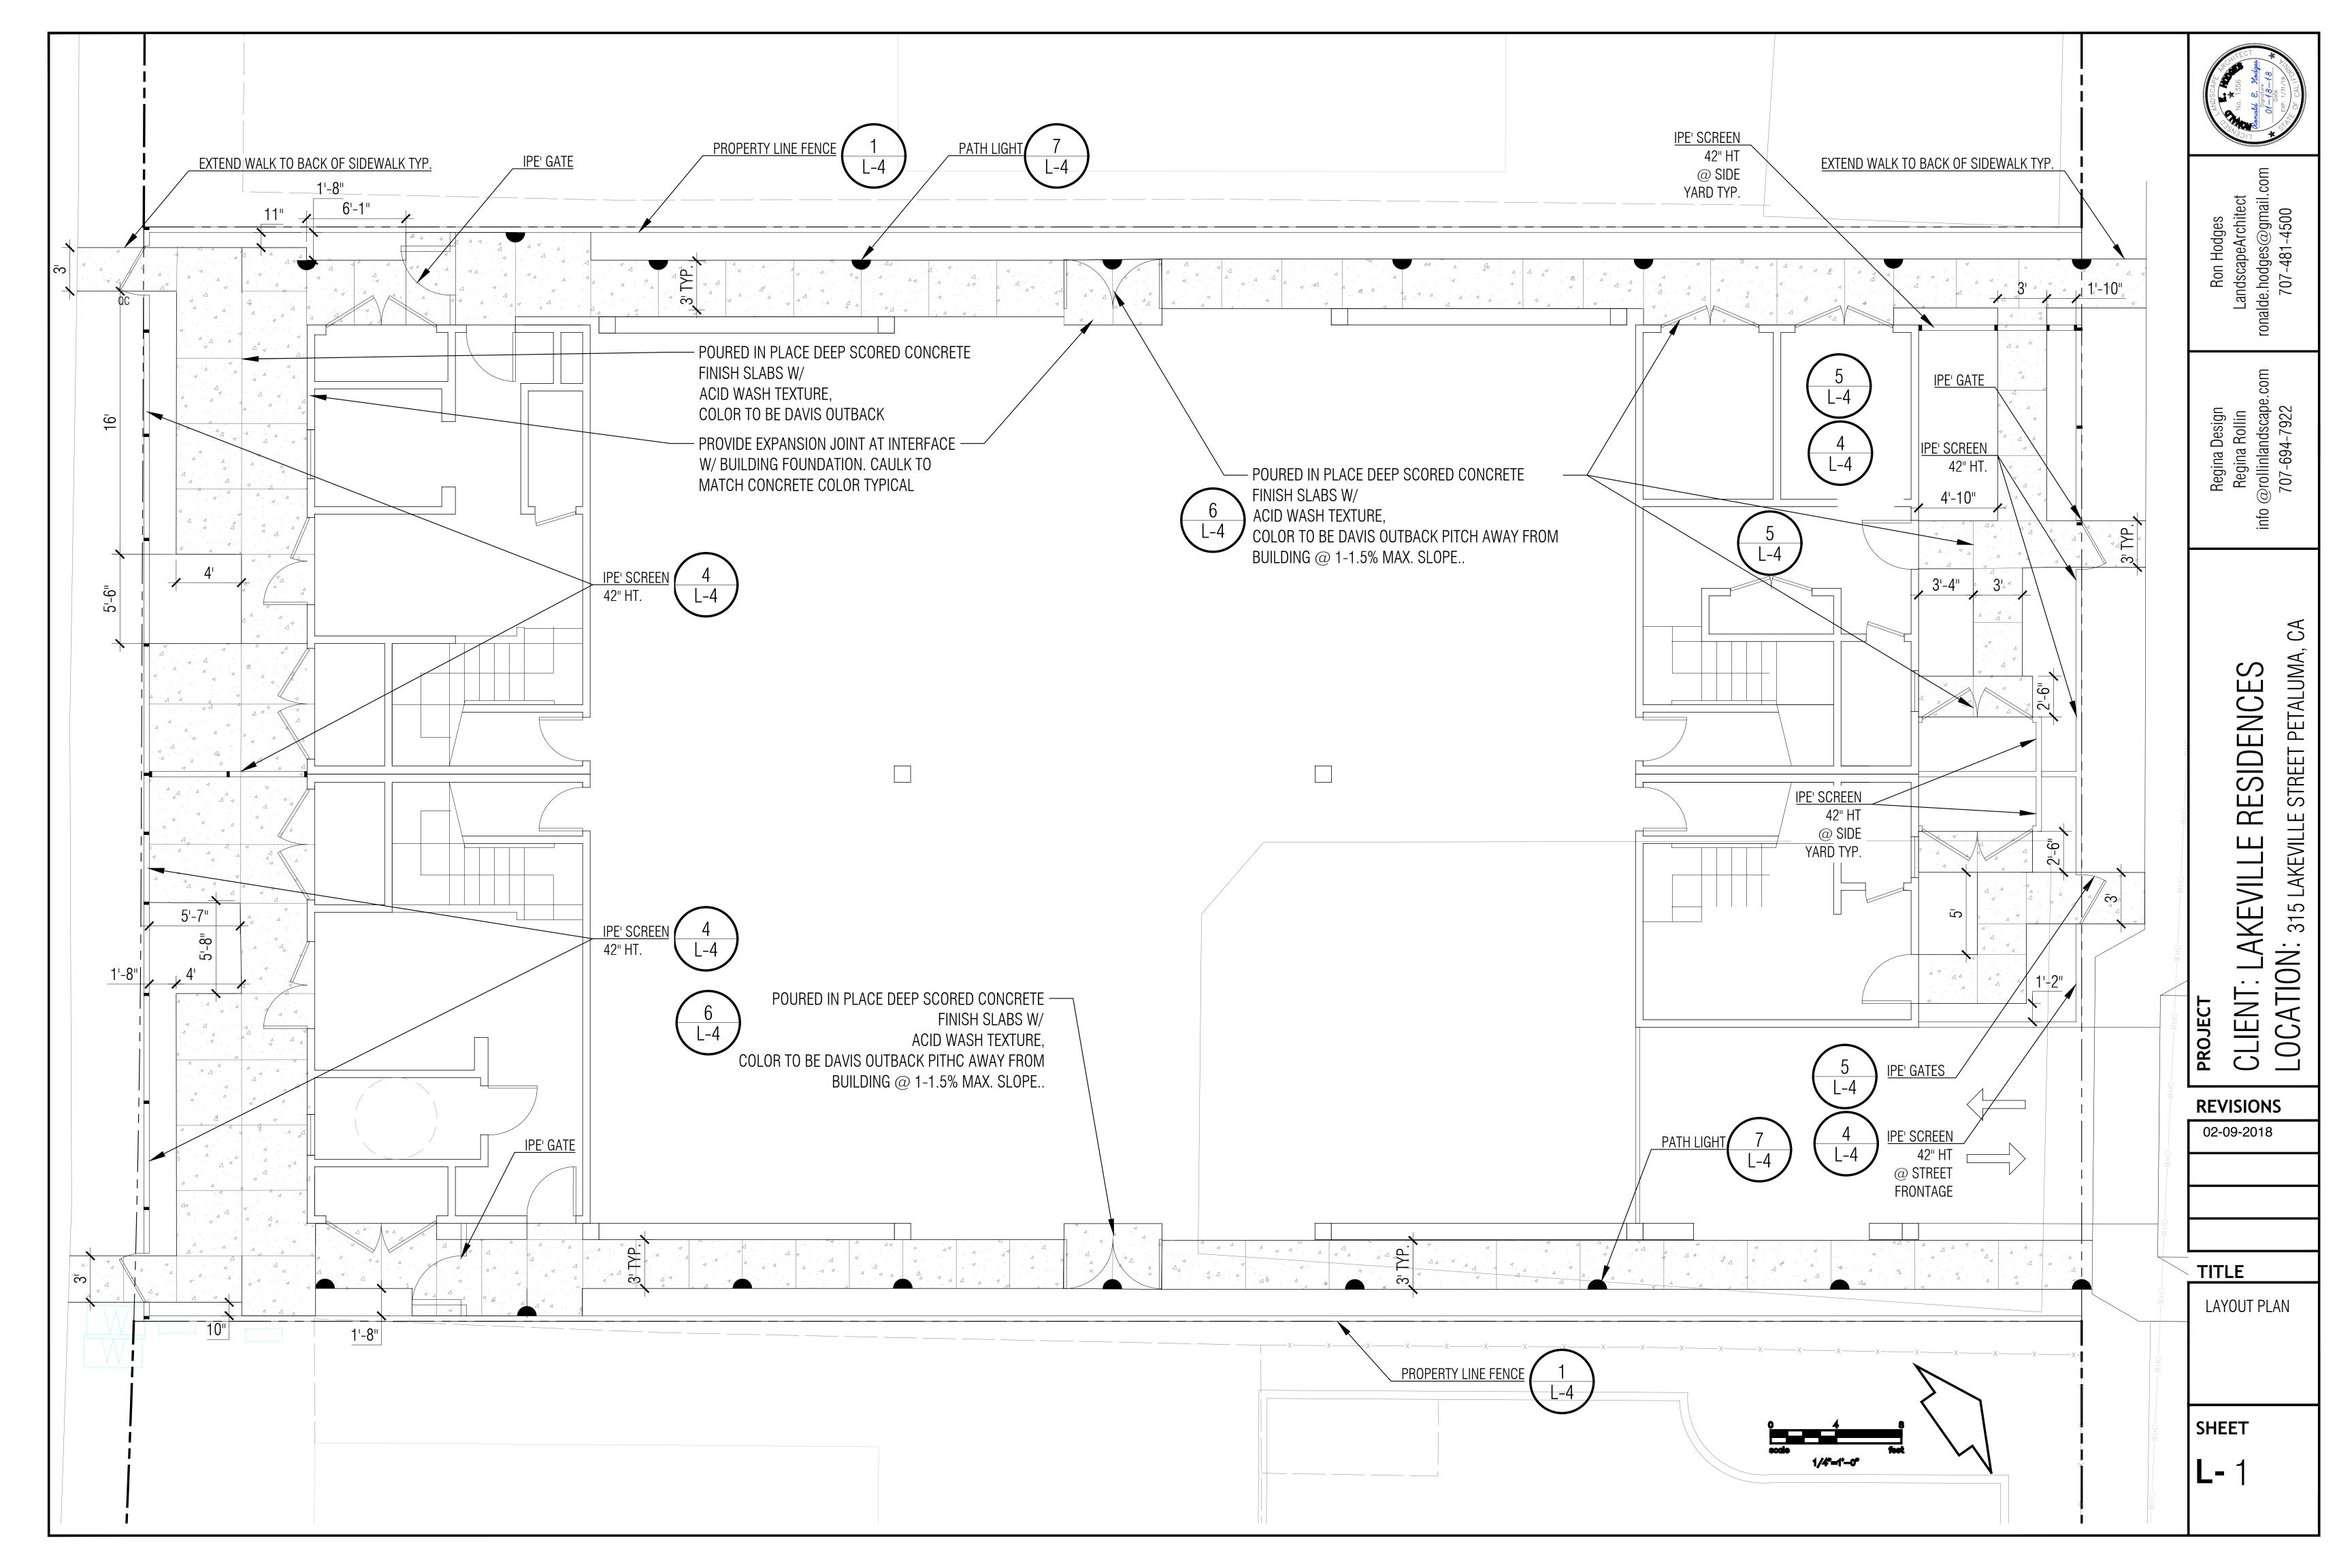
LAKEVILLE RESIDENCE


315 LAKEVILLE STREET PETALUMA, CA APN: 007-154-013


No.	Description	Date


MATERIALS BOARD		
Date	09.07.17	A6.0
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Scale 3/32" = 1'-0"





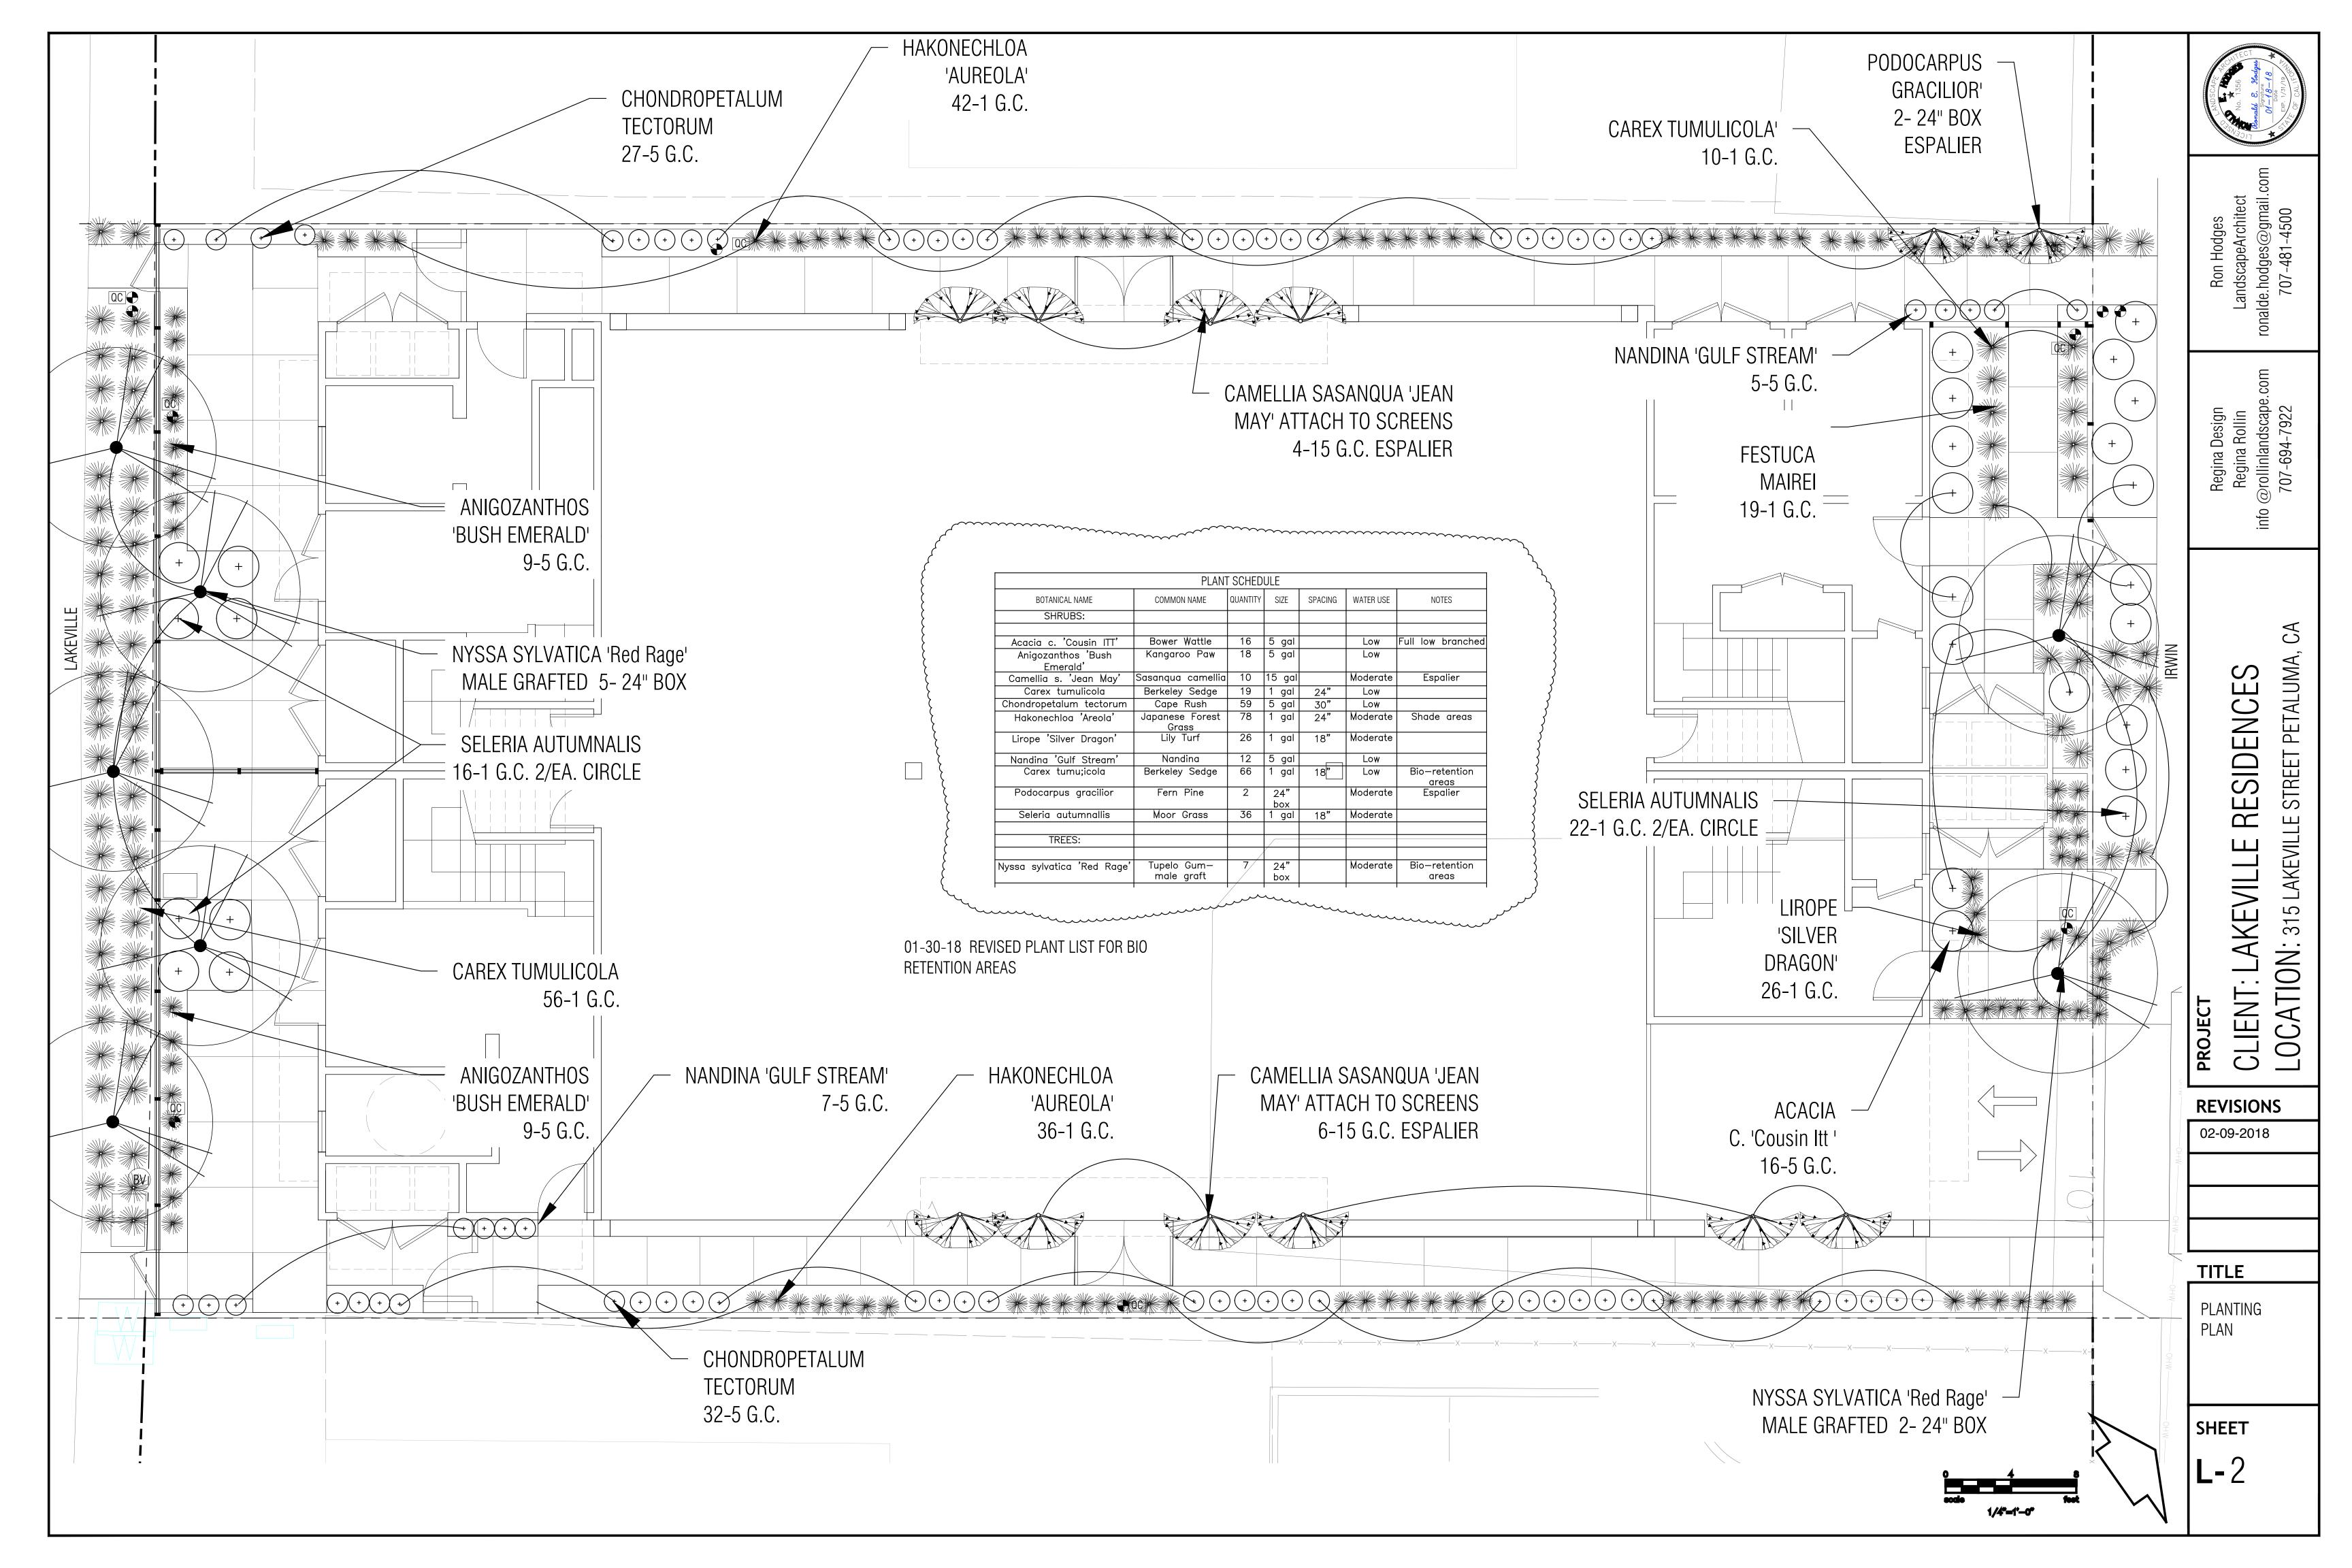


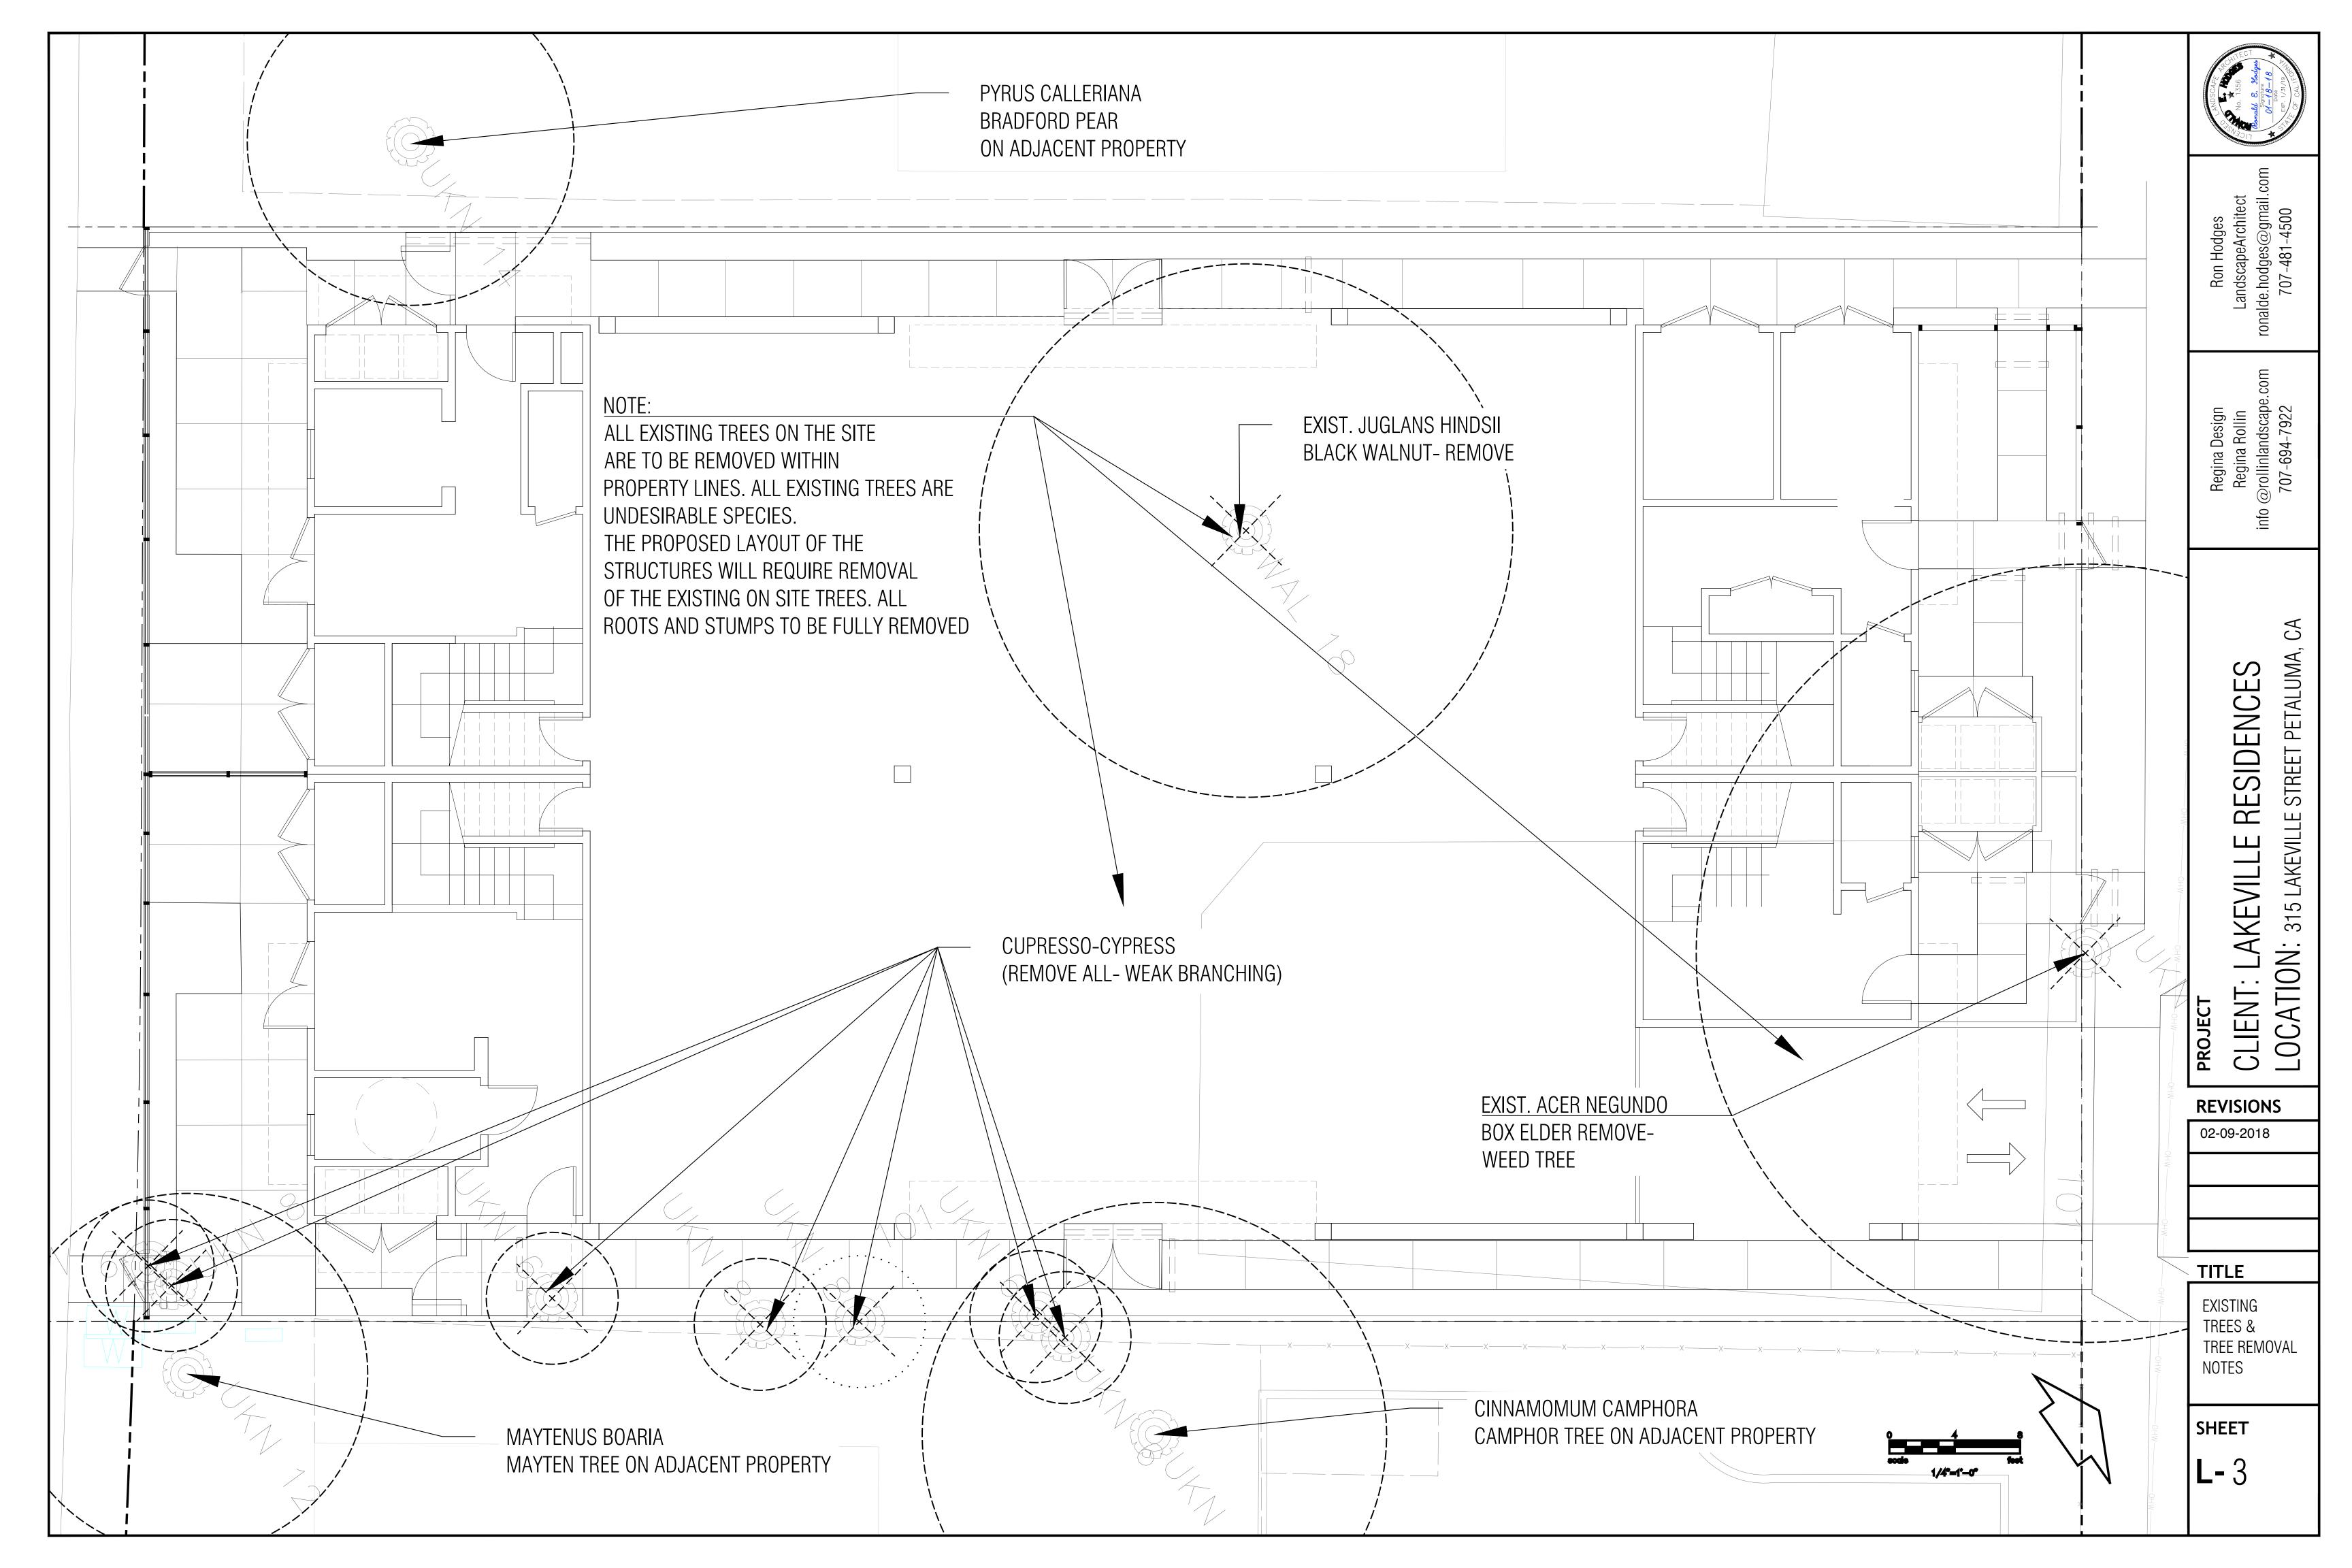


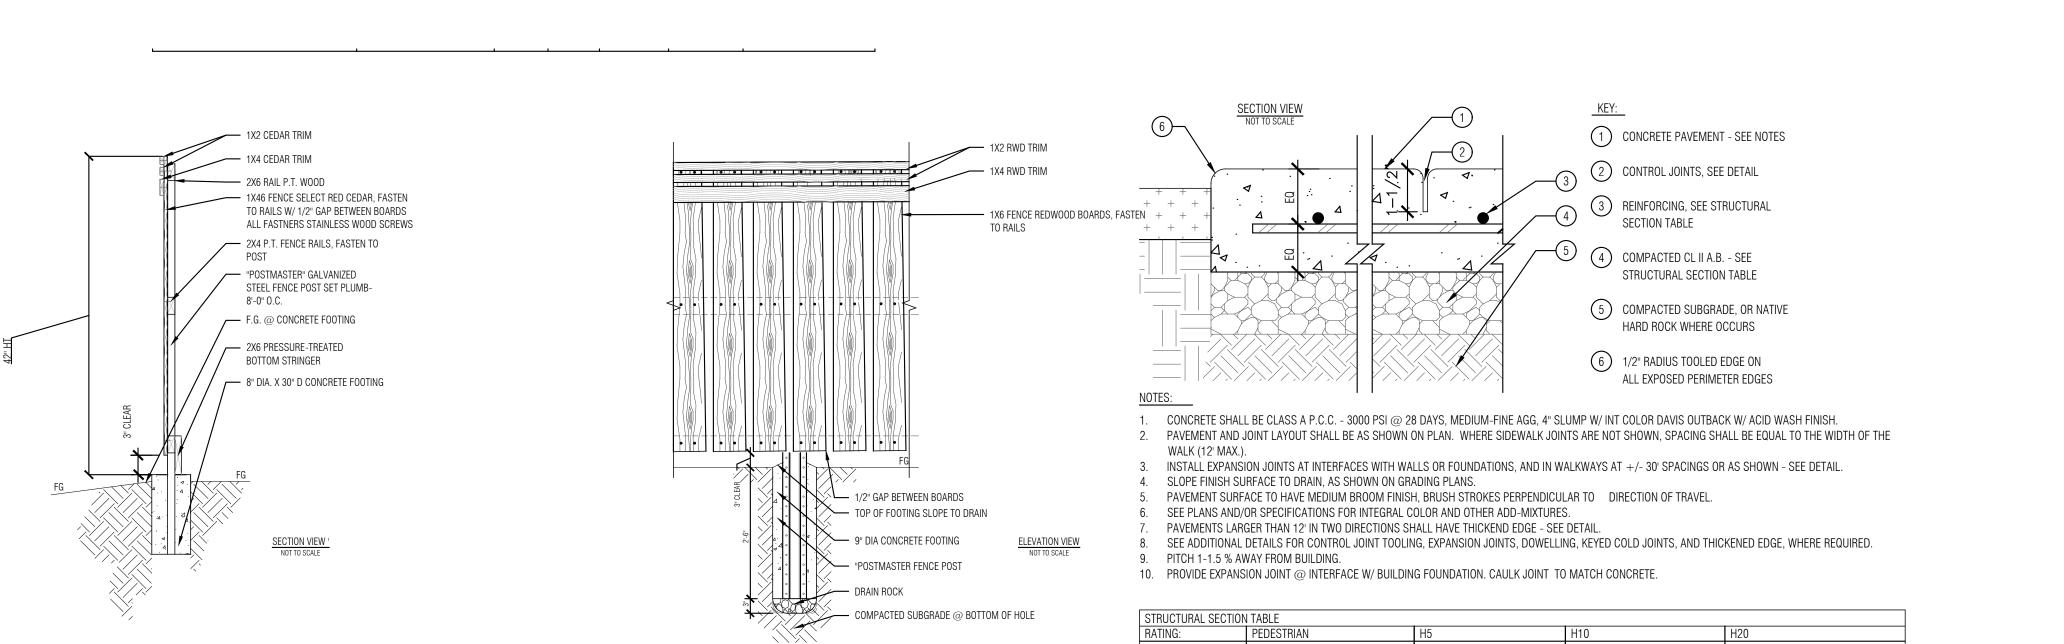*FOR WALKWAYS 6' WIDE AND LESS, INSTALL REBAR IN LONG DIRECTION ONLY

E PAVING

Lumens.com

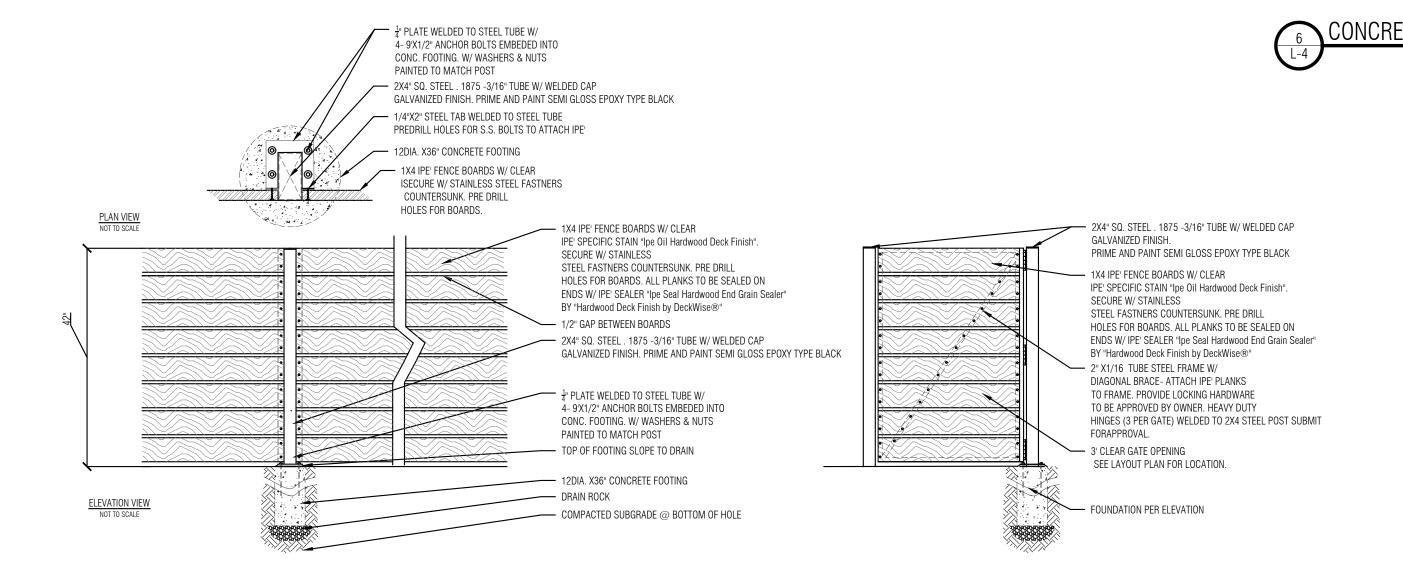

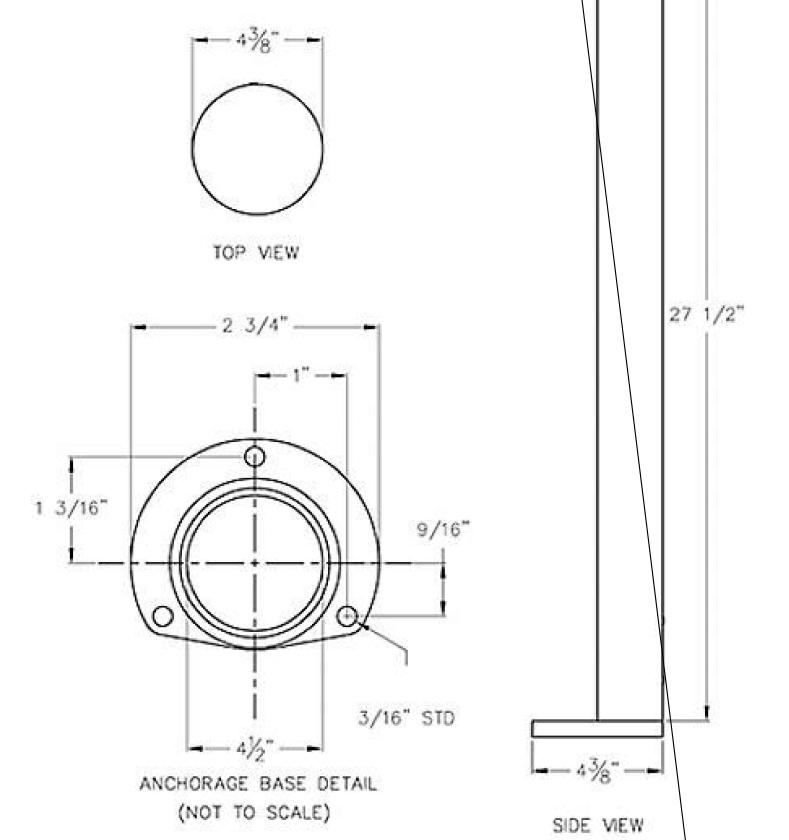

LED Garden and Pathway Luminaire - 7263/7264

By BEGA AVAL. FROM https://www.lumens.com

FINISH GRAPHITE. LOW VOLTAGE LIGHT W/

12 V. TRANFORMER REQUIRED, SURFACE MOUNT ON WALKWAY

CONCRETE

PROJECT

CLIENT: LAKEVILLE RESIDENCE
LOCATION: 315 LAKEVILLE STREET PETALU

REVISIONS


02-09-2018


TITLE

DETAILS & NOTES

SHEET

L- 4

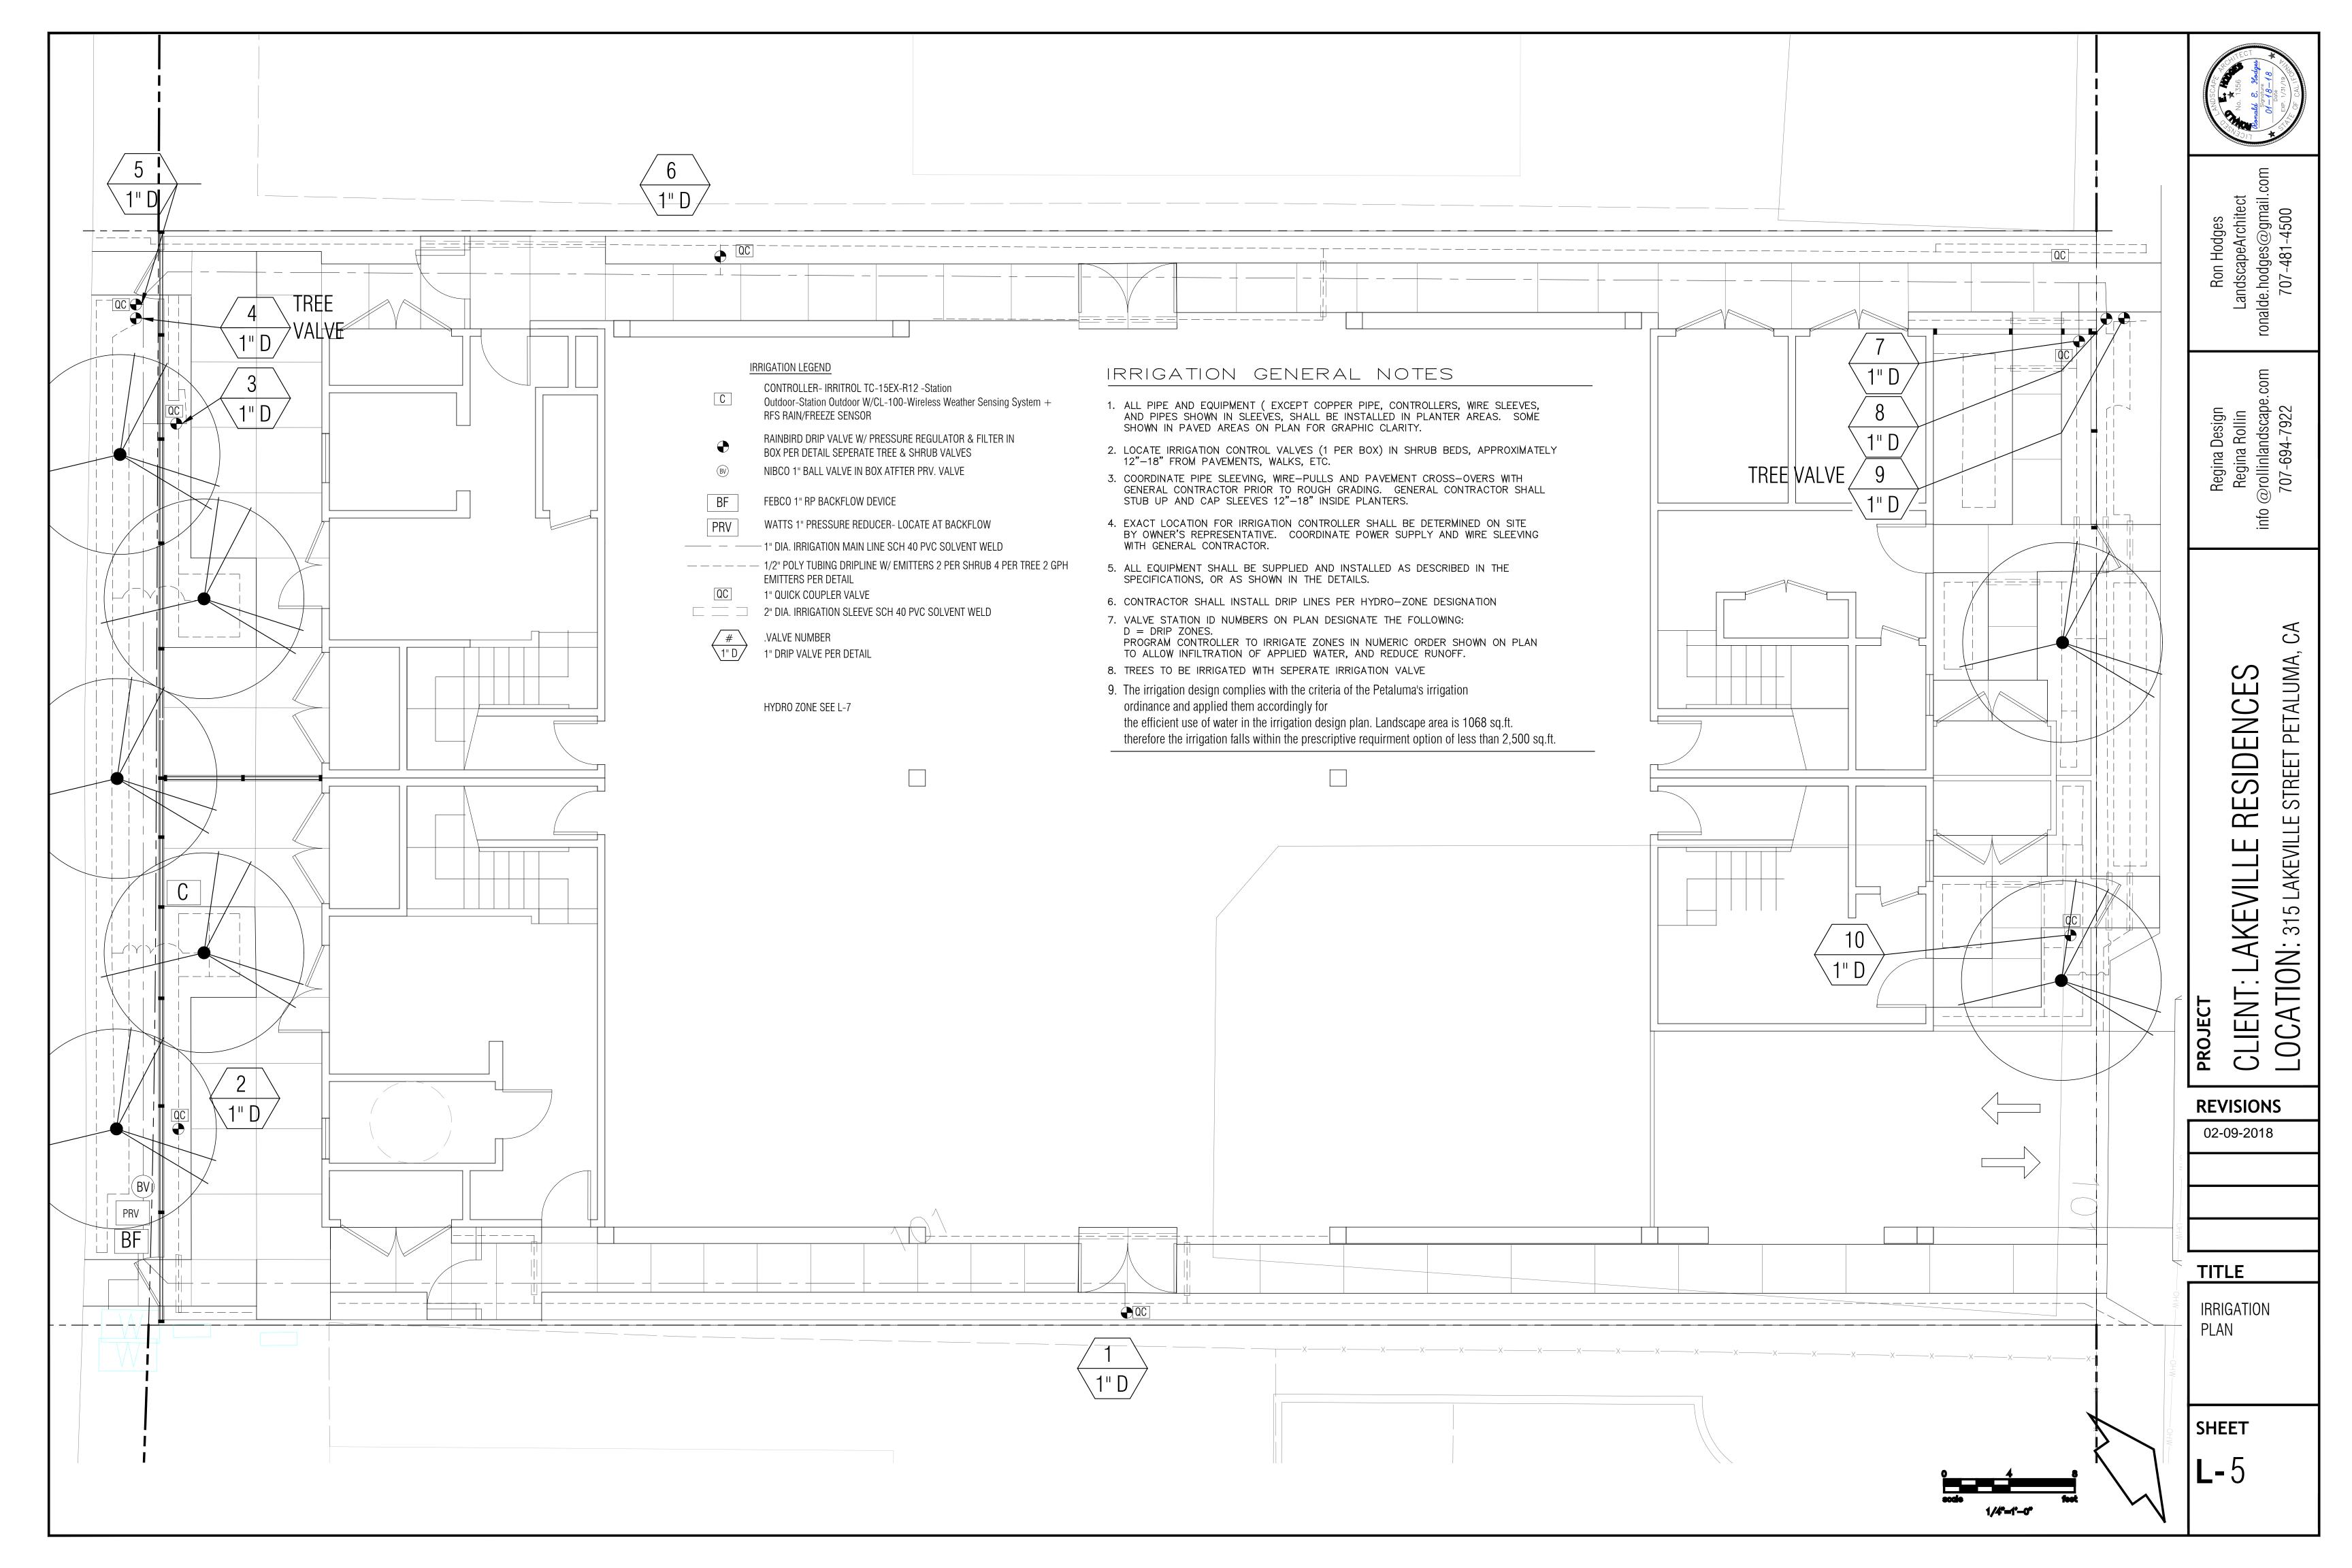

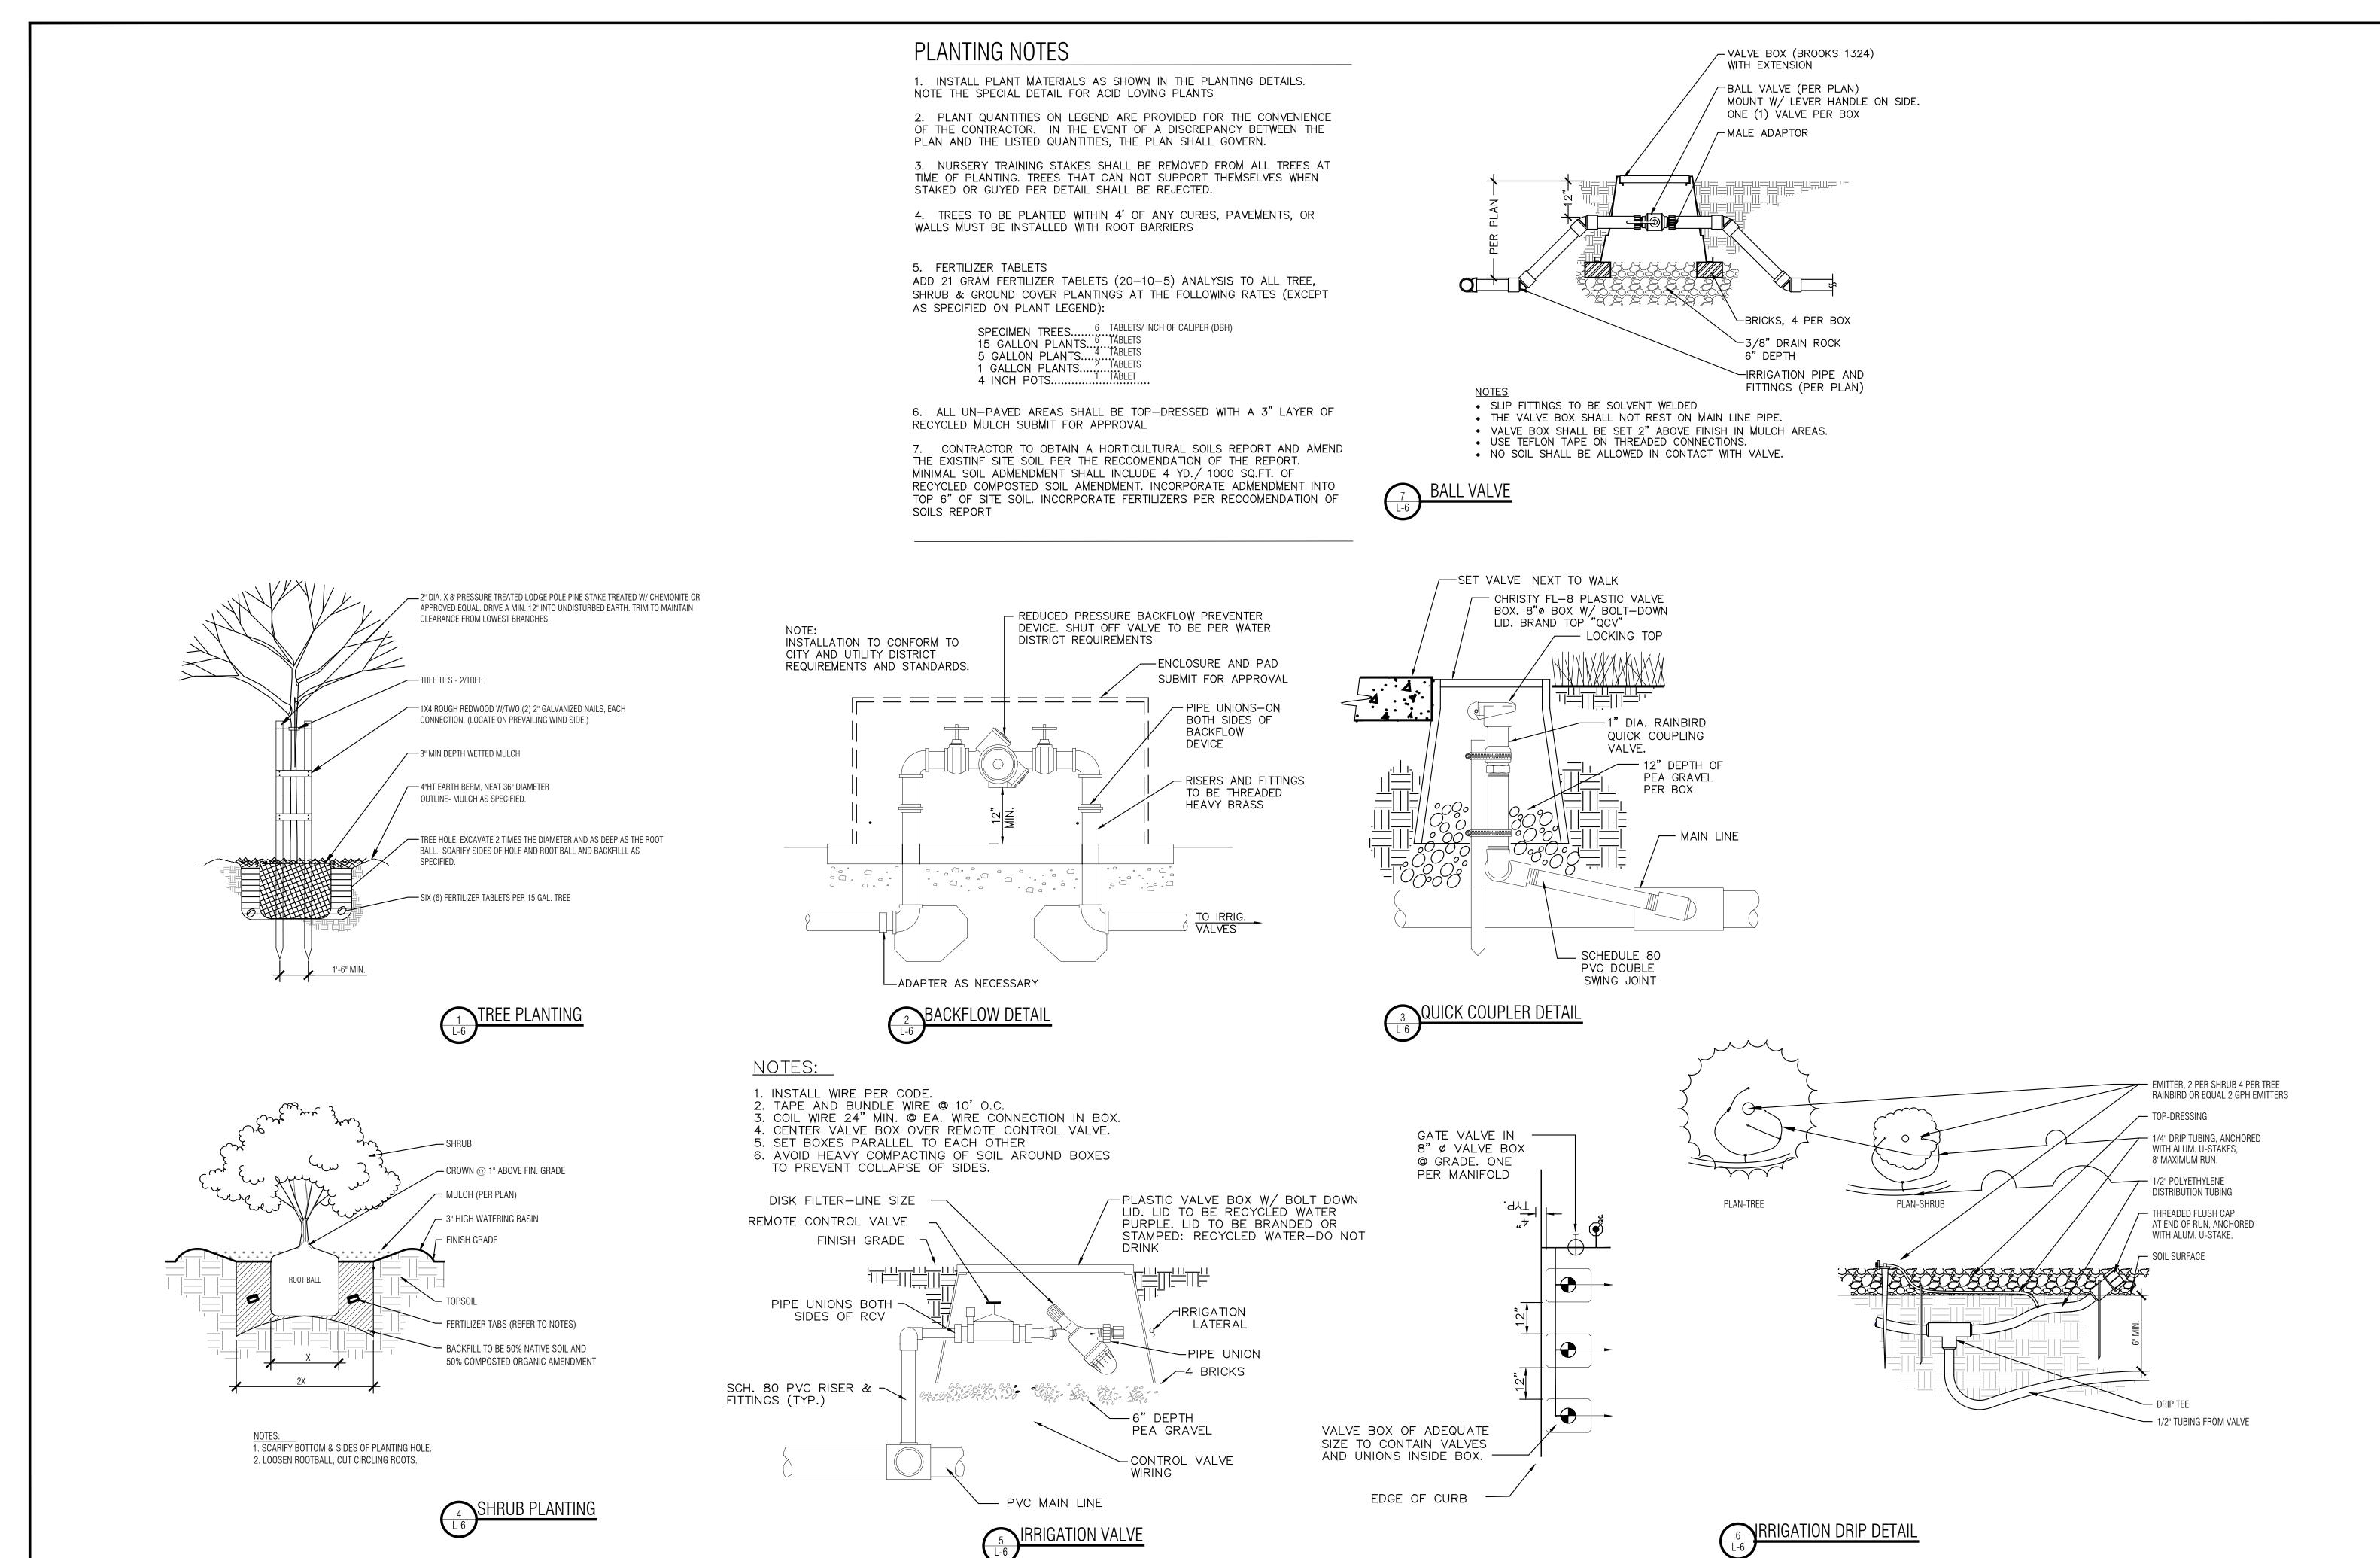

RNDSCAPE

RNDSCAPE

ROLL

Ronald E. Modgas

Signature

O'Signature

O'

Ron Hodges LandscapeArchitect onalde.hodges@gmail.cor 707-481-4500

Regina Design Regina Rollin nfo @rollinlandscape.con 707-694-7922

CA

CLIENT: LAKEVILLE RESIDENCES LOCATION: 315 LAKEVILLE STREET PETALUMA,

REVISIONS

02-09-2018

02 03 2010

TITLE

IDDIOA

IRRIGATION & PLANTING DETAILS & NOTES

SHEET

L-6

