

U S HWY 101

TOTAL NUMBER OF EVCS AT A FACILITY	MIN. NUMBER (by type) OF EVCS REQ'D TO COMPLY WITH SECTION 11B-812	STUD. ACCESSIBLE	AMBULATORY
1 to 4	1	0	0
5 to 25	1	1	0
26 to 50	1	1	1
51 to 75	1	2	2
76 to 100	1	3	3
101 and over	1, plus 1 for each 300, or fraction thereof, over 100	3, plus 1 for each 60, or fraction thereof, over 100	3, plus 1 for each 50, or fraction thereof, over 100

ELECTRIC VEHICLE (EV) CHARGING SPACE CALCULATION
(PER 2016 CBC TABLE 5.106.5.3.3)

TOTAL NUMBER OF ACTUAL PARKING SPACES	NUMBER OF REQUIRED SPACES
0 to 9	0
10 to 25	1
26 to 50	2
51 to 75	4
76 to 100	5
101 to 150	7
151 to 200	10
201 and over	6 PERCENT OF TOTAL*

* CALCULATIONS SHALL BE ROUNDED UP TO THE NEAREST WHOLE NUMBER.

DESIGNATED PARKING FOR CLEAN AIR VEHICLES
(PER 2016 CBC TABLE 5.106.5.2)

TOTAL NUMBER OF PARKING SPACES	NUMBER OF REQUIRED SPACES
0 to 9	0
10 to 25	1
26 to 50	3
51 to 75	6
76 to 100	8
101 to 150	11
151 to 200	16
201 and over	AT LEAST 8 PERCENT OF TOTAL

ELECTRIC VEHICLE CHARGING ANALYSIS:

TOTAL NUMBER OF ACTUAL PARKING SPACES: 140
 NUMBER OF REQUIRED EV CHARGING SPACES: 140
 (PER TABLE 5.106.5.3.3 CBC 2016)

NOTE: ALL SIGNAGE AND REQUIREMENTS OF 11B-812 SHALL APPLY. CONTRACTOR SHALL VERIFY ALL STRIPING AND SIGNAGE REQUIREMENTS PRIOR TO CONSTRUCTION.

BUILDING DATA:

HOTEL BUILDING: CONSTRUCTION TYPE: V-A HOUR FULLY SPRINKLERED
 AUTOMATIC SPRINKLER SYSTEM: NFPA 13 WITH ATTIC SPRINKLERED

POOL BUILDING: CONSTRUCTION TYPE: V-B NON-SPRINKLERED
 AUTOMATIC SPRINKLER SYSTEM: NONE

BUILDING AREA:

TOTAL AREA: 84,940 S.F.
 (Combined Floors)

PORTE COCHERE: 798 S.F.

POOL BLDG.: 104 S.F.

TOTAL AREA: 85,802 S.F.

HOTEL PARKING ANALYSIS:

PARKING REQUIRED: 140
 1 SPACE FOR OWNER/MANAGER: 1
 TOTAL PARKING SPACES REQUIRED: 141

TOTAL PARKING SPACES PROVIDED: 141
 ACCESSIBLE PARKING SPACES REQUIRED: 5

LOT COVERAGE:

PROPOSED HOTEL BUILDING:
 BUILDING FOOTPRINT (1ST FLOOR + PORTE COCHERE + POOL BLDG.) 22,097 S.F.
 LOT COVERAGE = 22,097 / 356,756.4 = 6.19%

EXISTING SYNERGY BUILDING:
 BUILDING FOOTPRINT: 41,000 S.F.
 LOT COVERAGE = 41,000 / 356,756.4 = 11.49%

COMBINED BUILDINGS:
 LOT COVERAGE = 6.19 + 11.49 = 17.68%

FLOOR AREA RATIO:

EXISTING SYNERGY BUILDING AREA: 41,000 SQ. FT.
 PROPOSED HOTEL BUILDING AREA: 85,802 SQ. FT.
 TOTAL BUILDING AREA: 126,802 SQ. FT.

TOTAL SITE AREA: 8.19 AC
 F.A.R. = 126,802 / 356,756.4 = 356

PROJECT INFO

PROJECT DESCRIPTION:

4 STORY, WOOD FRAMED HOTEL CONSTRUCTED OVER SLAB ON GRADE WITH SHUT UP ROOF AND STUCCO EXTERIOR. 140 TOTAL GUEST ROOMS WITH POOL AND PATIO FOR PATRONS ONLY.

BUILDING CONSTRUCTION:

ADDRESS: 1205 REDWOOD WAY, PETALUMA, CA 94954
 CONSTRUCTION TYPE: Y-4
 OCCUPANCY CLASSIFICATION: R-1

CLIENT

OWNER: Basin Street Properties
 POC: Frank Marinello
 basin-street.com
 P: 530-343-0963

TEAM

ARCHITECT:

PK ARCHITECTS
 POC: Scott Kuitunen
 4515 S. McClintock Dr, Suite 206
 TEMPE, ARIZONA 85282
 P: 602-283-1620
 F: 602-283-1621
 EMAIL: scott@pkarchitects.net

CIVIL ENGINEER:


BKF ENGINEERS/SURVEYORS/PLANNERS
 POC: Martin B Parissenti
 1650 Technology Dr, Suite 650
 SAN JOSE, CALIFORNIA 95110
 P: 408-467-9100
 F: 408-467-9199
 EMAIL: mparissenti@BKF.com

LANDSCAPE ARCHITECT:

BRIAN POWELL & ASSOCIATES
 POC: Brian Powell
 10 H Street
 SAN RAFAEL, CALIFORNIA 94901
 P: 415-491-4480
 C: 415-602-0511
 EMAIL: brian@brianpowelldesign.com


VICINITY MAP

AERIAL CONTEXT

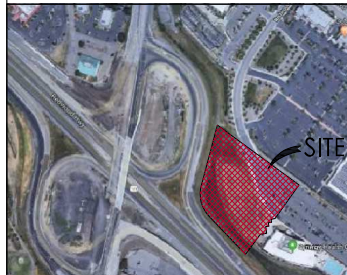

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SHEET A1.2	SITE PHOTOS
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SHEET A3.1	BUILDING ELEVATIONS
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SHEET C4	CIVIL GRADING PLAN & SITE SECTION
SHEET C5	CIVIL UTILITY PLAN
SHEET C6	CIVIL STORM WATER CONTROL PLAN

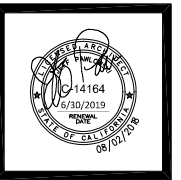

pk ARCHITECTS

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 4515 S. McCLINTOCK DRIVE, #206
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 PHONE: (602) 283-1620
 FAX: (602) 283-1621

HOME 2 SUITES BY HILTON

1205 REDWOOD WAY
 PETALUMA, CA 94954

REVISION: DATE: COMMENTS:

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PROJECT NO: 18305


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CHECKED BY: _____

SHEET TITLE:
ARCHITECTURAL SITE LAYOUT PLAN

SHEET NUMBER:
A1.0



SITE PLAN
 SCALE: 1" = 20'-0"
 NORTH
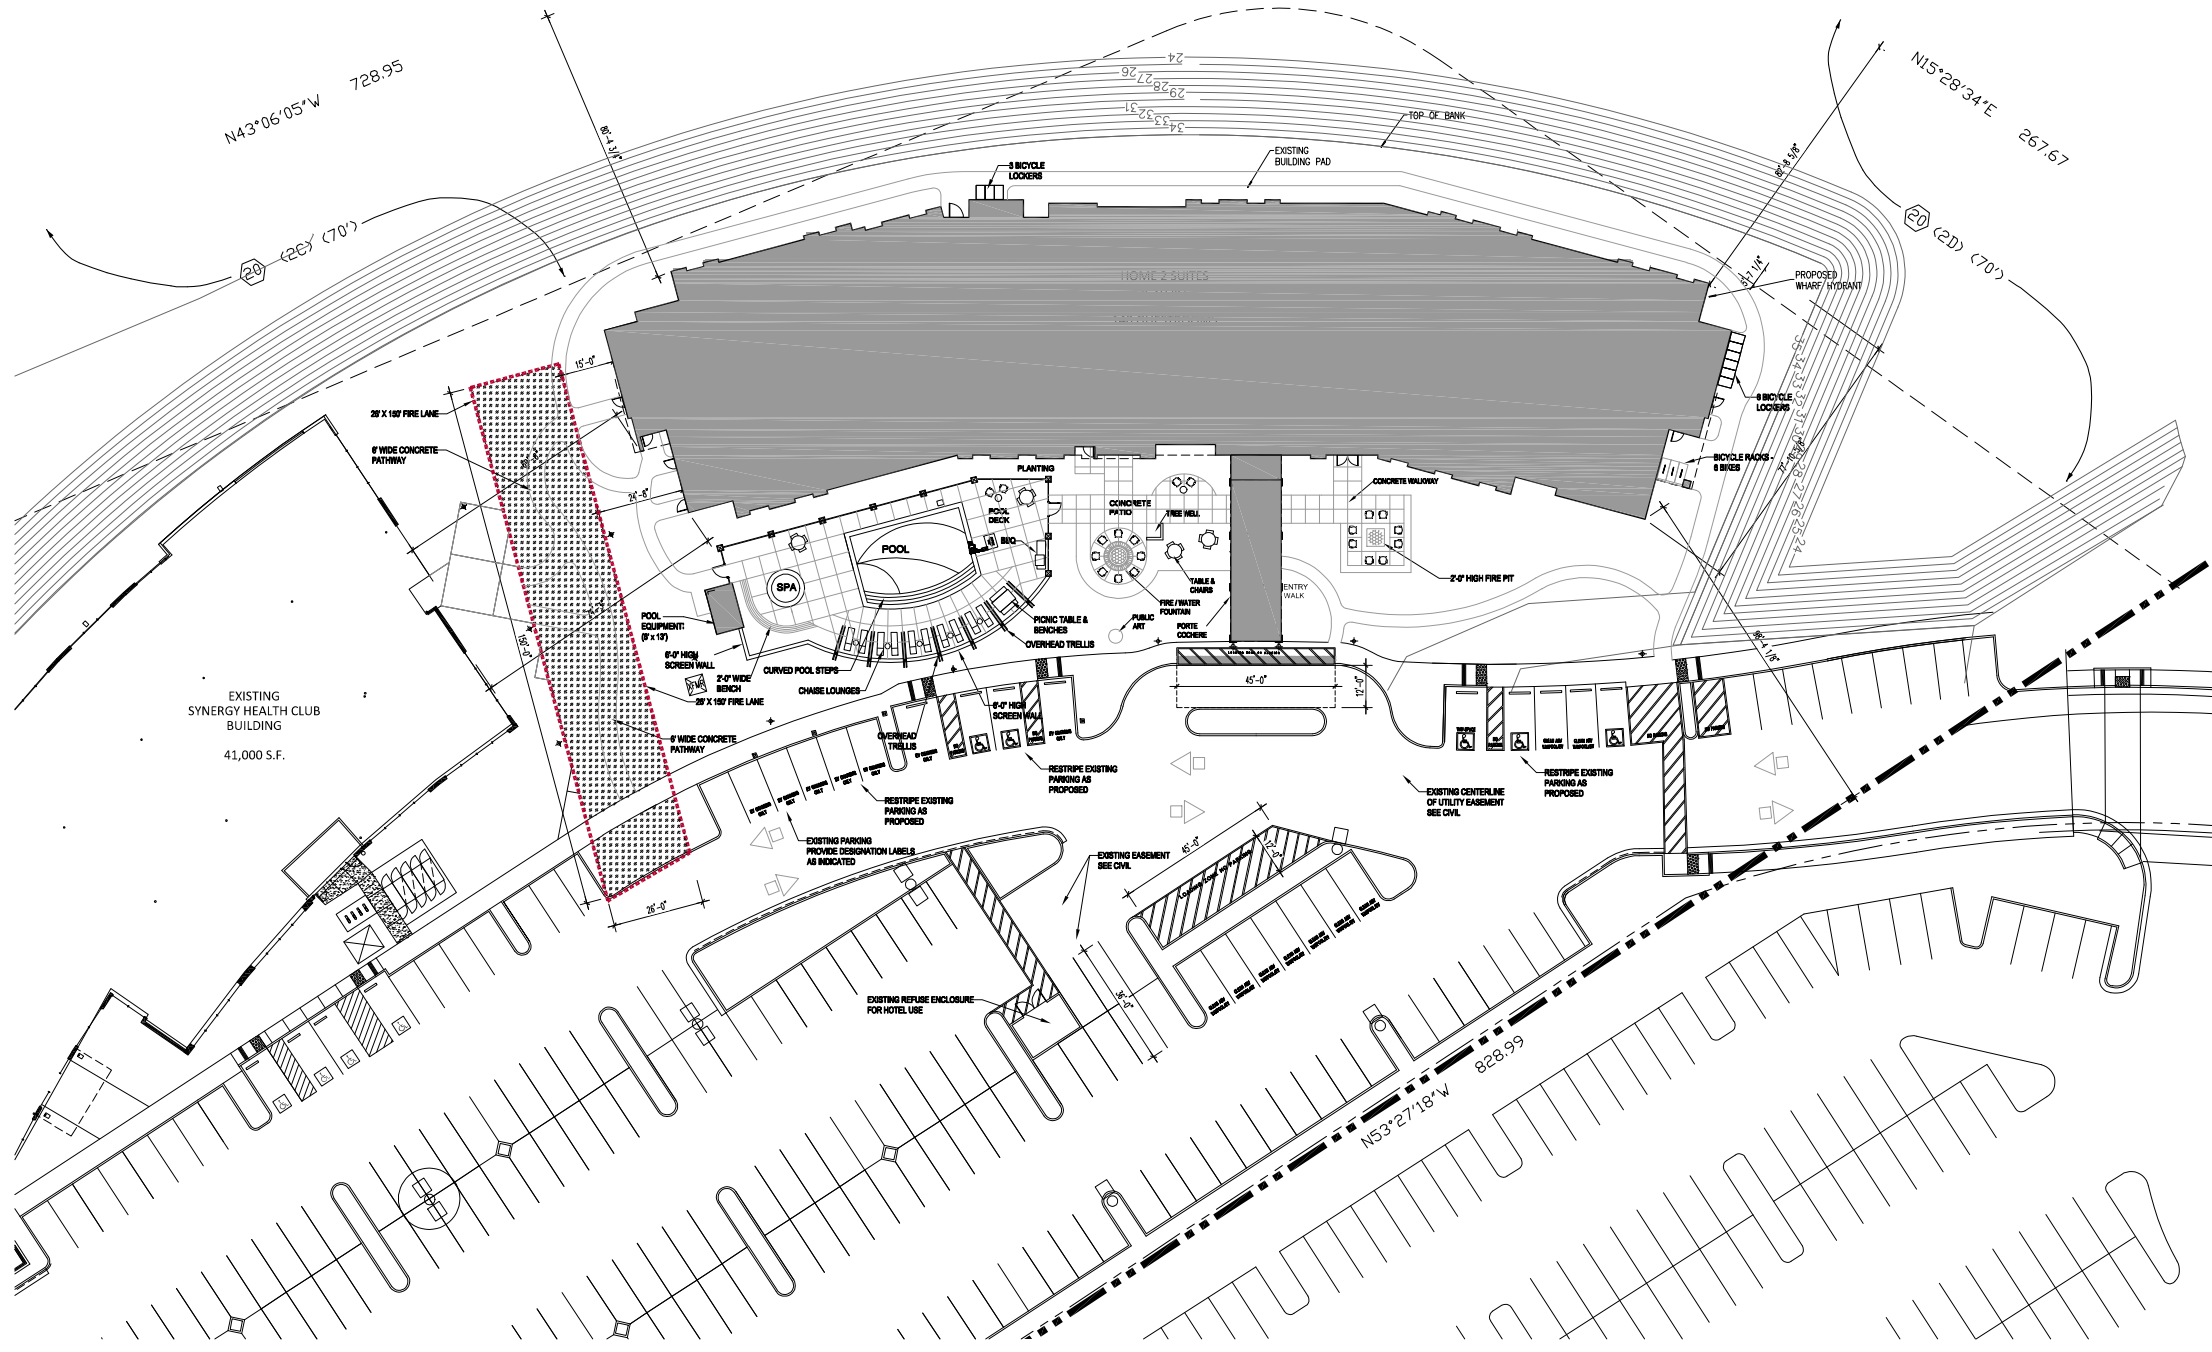
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PROJECT INFO

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 4 STORY, WOOD FRAMED HOTEL, CONSTRUCTED OVER SLAB ON GRADE WITH BUILT UP ROOF AND STUCCO EXTERIOR. 140 TOTAL GUEST ROOMS WITH POOL AND PATIO FOR PATRONS ONLY.

BUILDING CONSTRUCTION:
 ADDRESS: 1205 REDWOOD WAY, PETALUMA, CA 94954
 CONSTRUCTION TYPE: V-A
 OCCUPANCY CLASSIFICATION: R-1

BUILDING DATA:

HOTEL BUILDING:
 CONSTRUCTION TYPE: V-A HOUR FULLY SPRINKLERED
 AUTOMATIC SPRINKLER SYSTEM: NFPA 13 WITH ATTIC SPRINKLERED

POOL BUILDING:
 CONSTRUCTION TYPE: VB NON-SPRINKLERED
 AUTOMATIC SPRINKLER SYSTEM: NONE

BUILDING AREA:

TOTAL AREA: 84,840 S.F.
 (Combined Floors)
 PORTE COCHERE: 758 S.F.
 POOL BLDG.: 104 S.F.
 TOTAL AREA: 85,802 S.F.

LOT COVERAGE:

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 F.A.R. = 126,802 / 356,756.4 = .356

NOTE: ONE ELEVATOR TO BE CONSTRUCTED AND HAVE SIGNAGE IN ACCORDANCE WITH THE REQUIREMENTS OF CBC 3002.4 FOR EMERGENCY MEDICAL SERVICE ELEVATORS

26'X150' TURF CELL FIRE LANE TO BE DESIGNED TO SUPPORT A CITY OF PETALUMA FIRE TRUCK WITH A WEIGHT OF 75,000 LBS.

6' WIDE CONC. SIDEWALK

LADDER TRUCK 9351 TURNING RADIUS, TYP. (96' OUTSIDE, 70.5' INSIDE)

KOHL'S BUILDING

EXISTING KOHL'S PARKING LOT

REDWOOD WAY

ACCESS TO N. MCDOWELL BLVD.

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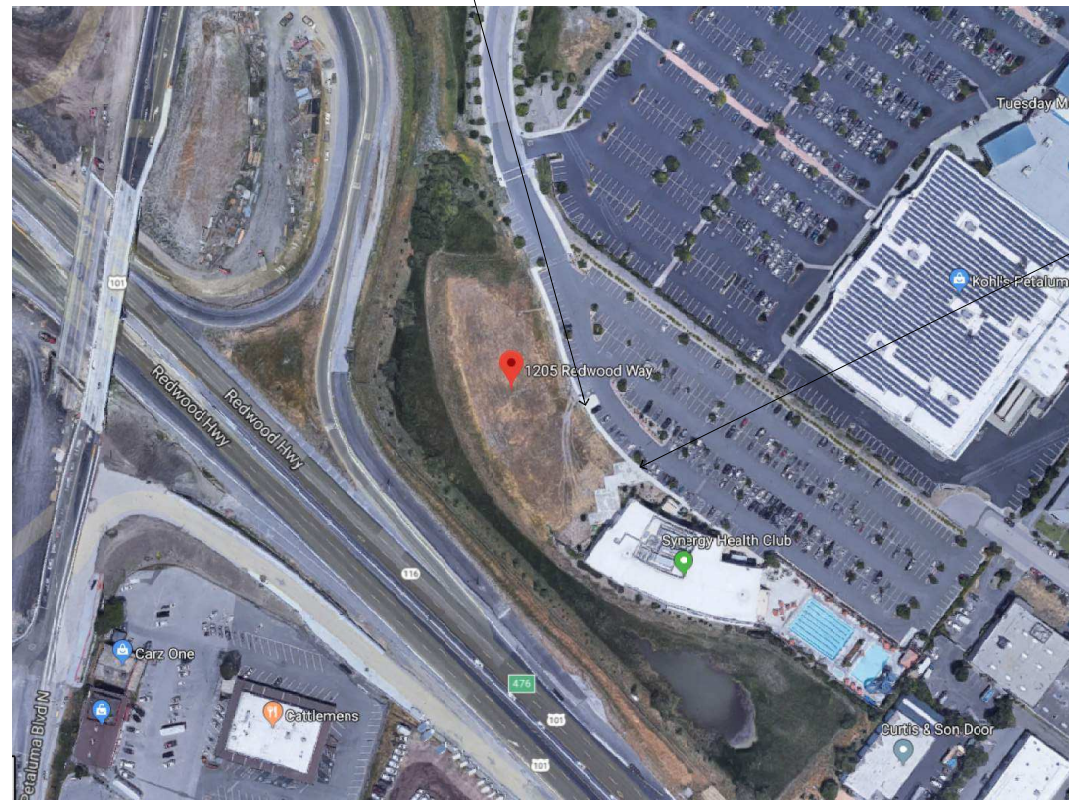
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SHEET TITLE:
 FIRE / LIFE SAFETY SITE PLAN

SHEET NUMBER:
A1.1

CITY SPAR SUBMITTAL 12-13-18

SITE PLAN
 SCALE: 1" = 30'-0"
 NORTH



SITE AERIAL PHOTO EXHIBIT

PHOTO 'A'



PHOTO 'A'

PHOTO 'B'



PHOTO 'B'

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BY HILTON

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PROJECT NO: 18305

DATE: _____

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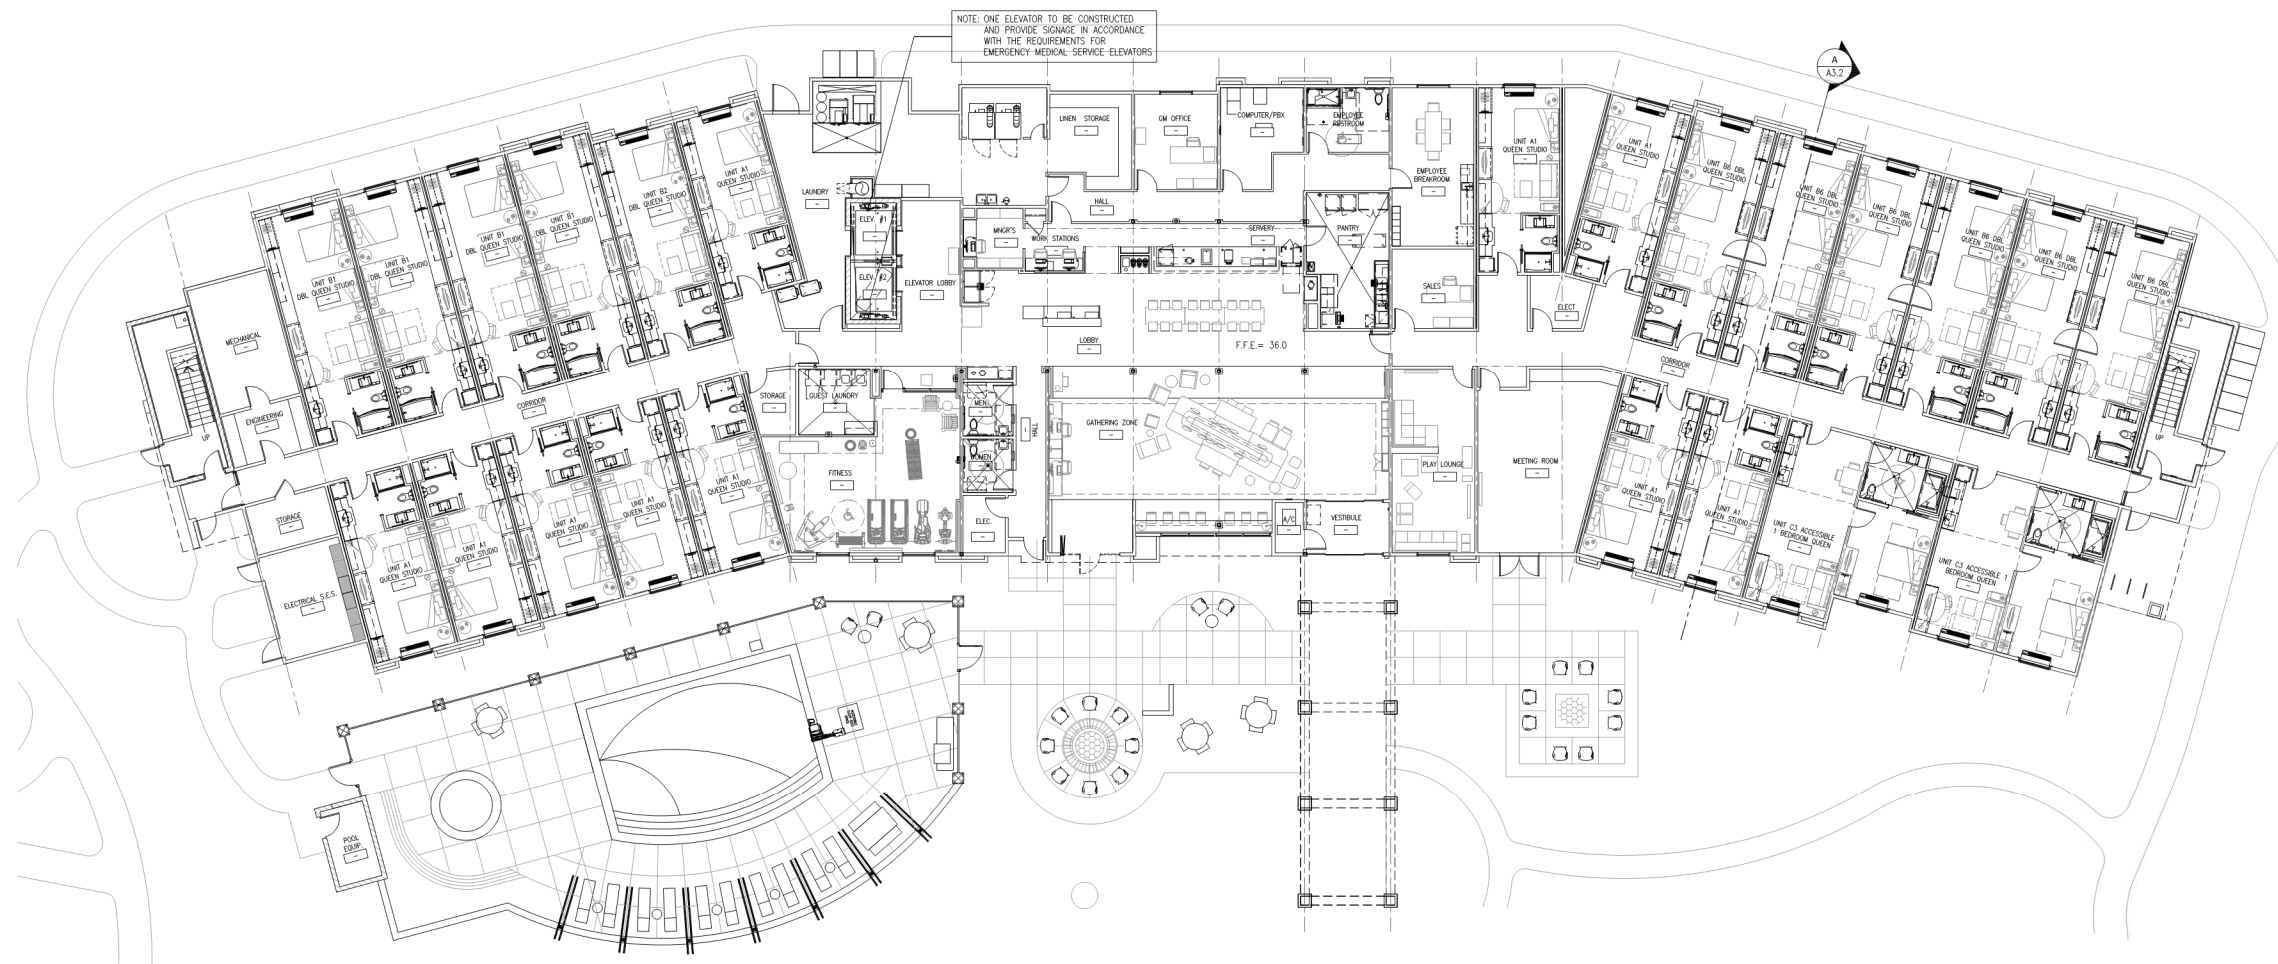
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SHEET TITLE:

SITE
PHOTOS

SHEET NUMBER:


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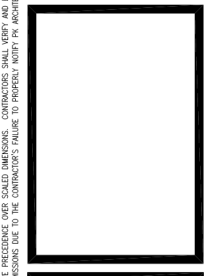
1ST FLOOR - FLOOR PLAN
SCALE: 3/32" = 1'-0"
NORTH



2ND FLOOR - FLOOR PLAN
SCALE: 3/32" = 1'-0"
NORTH



pk
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PETALUMA, CA 94954
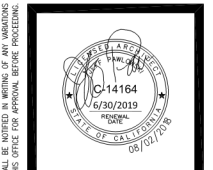
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SHEET TITLE:
1ST & 2ND FLOOR PLAN

SHEET NUMBER:
A2.1

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
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


3RD FLOOR - FLOOR PLAN
SCALE: 3/32" = 1'-0"
NORTH




4TH FLOOR - FLOOR PLAN
SCALE: 3/32" = 1'-0"
NORTH





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SHEET TITLE:


3RD & 4TH FLOOR FLOOR PLANS

SHEET NUMBER:

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ROOF PLAN
SCALE: 3/32" = 1'-0"

SHEET NUMBER:
A2.3

PROJECT NO: 18305
DATE: _____
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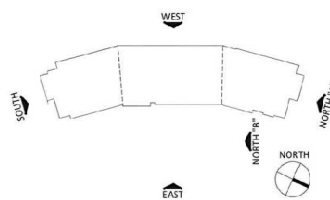
PK ARCHITECTS, PC
4515 S. MCCLINTOCK DRIVE, #209
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CITY SPAR SUBMITTAL 12-13-18

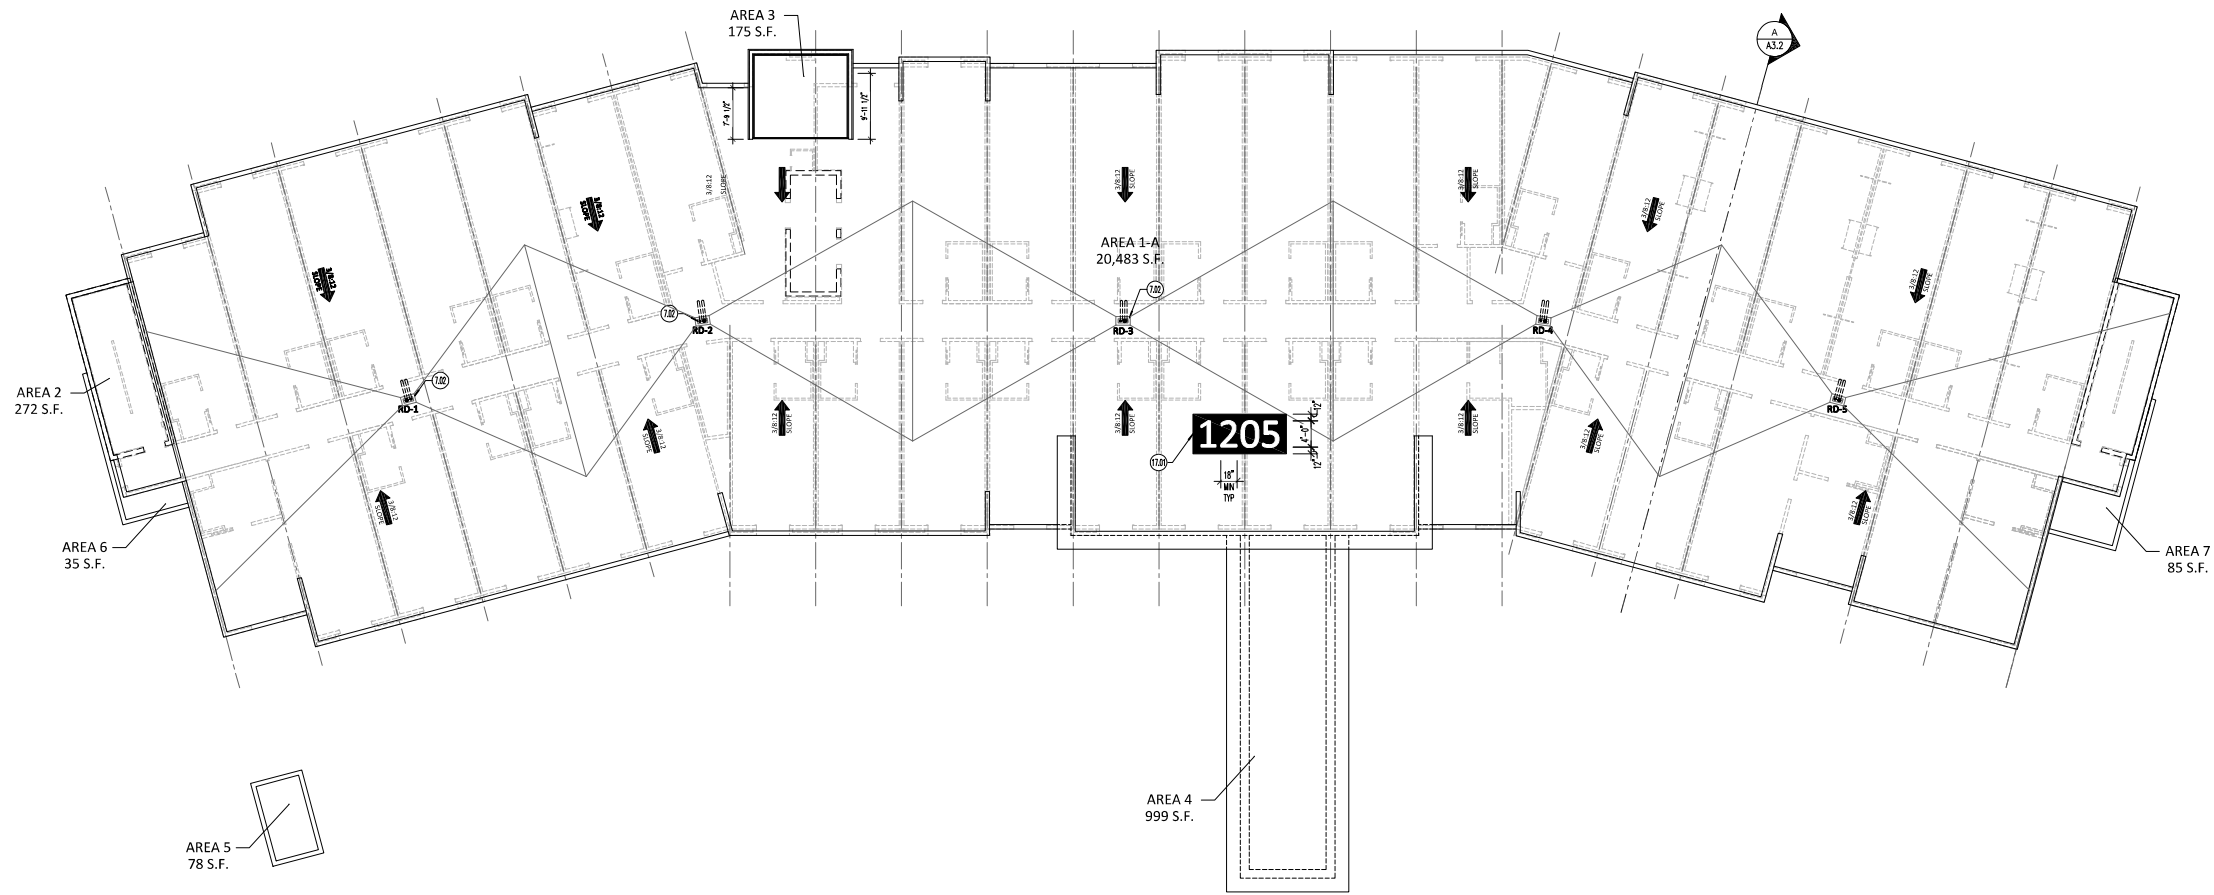KEY PLAN



MATERIAL & LEGEND

EXTERIOR COLORS:

- 1A FINE GRAN (DE6213) EPS: SANDBLAST NTX FINISH
- 1B TEA DAG (DE6062) EPS: SANDBLAST NTX FINISH
- 1C WHOLE WHEAT (DE6124) EPS: SANDBLAST NTX FINISH
- 1D LIMELIGHT (DE5516) EPS: SANDBLAST NTX FINISH

EXTERIOR TILE:

- 1A CROSSVILLE TILE - COLOR: TED

WINDOWS & DOORS:

- 1A ALUMINUM F-TAC, WINDOWS, AND STOREFRONT. CLEAR ANODIZED

- 1B PAINTED HOLLOW METAL DOORS AND FRAMES - MATCH ADJACENT EPS COLOR

METALS:

- 1A MATCH COLOR OF EXTERIOR FINISH "1B" DUNN EDWARDS COLOR "DE6462" (TRELIS GRAN, METAL, FENCE, GATE)

KEY NOTES:

- 37 THERMAL & MOISTURE PROTECTION EPS EXTERIOR FINISH SYSTEM OVER 2" MIN. EPS- THESE AREAS LABELED "+3"- ADDITIONAL PROTECTION CREATED BY UP TO 2" MORE EPS OR FRAMING- SEE FLOOR PLANS, SECTIONS, AND SPECIFICATIONS FOR CLARIFICATION
- 7.01 EPS CONTROL JOINT - SEE DETAILS 17/A8.3 & 18/A8.3
- 7.02 24 GAUGE ROLLERS METAL CAP #7 KYNAR 500 FINISH MATCH ADJACENT SURFACES - SEE DETAIL 17/A8.3
- 15 MECHANICAL WALL (LIVER PAINT TO MATCH SURROUNDING WALL/MATERIAL COLOR - SEE MECHANICAL DRAWINGS TOP SIZE
- 15.01 MECHANICAL UNIT BEYOND - COORDINATE PARAPET SCREENING W/ EQUIPMENT MANUFACTURER PROOF 'C' CONSTRUCTION
- 17 MISCELLANEOUS PROPOSED HOTEL SIGNS ARE SHOWN FOR REFERENCE ONLY ALL SIGNS SHALL BE REVIEWED AND INSTALLED UNDER SEPARATE APPLICATION AND PERMIT
- 17.01
- 17.02 OPAQUE LAMINATED GLASS REASON ELEMENT

EXTERIOR FINISH NOTES:


- CURABLE WINDOWS AND ALUMINUM STOREFRONT COMPONENTS TO CLEAR ANODIZED FINISH
- SQUARE ALL EPS CORNERS
- ALL EPS TO BE INTEGRALLY COLORED U.I.K.D
- ALL PAINT TO BE DUNN EDWARDS
- WALL TILE TO BE CROWN PER ELEVATION AND SET PER MANUFACTURER DIMENSIONS AND DETAILS.

GENERAL NOTES:

- 1. ALL ROOF MOUNTED MECHANICAL EQUIPMENT SHALL BE FULLY SCREENED BY PARAPET WALLS EQUAL TO, OR GREATER THAN, THE HIGHEST POINT ON THE MECHANICAL EQUIPMENT. ALL EXTERNALLY MOUNTED MECHANICAL EQUIPMENT SHALL BE SCREENED BY SOLID MASONRY WALLS AND GATES EQUAL TO, OR GREATER THAN, THE HIGHEST POINT ON THE MECHANICAL EQUIPMENT. COMPLY WITH ALL VIEW ANGLES.



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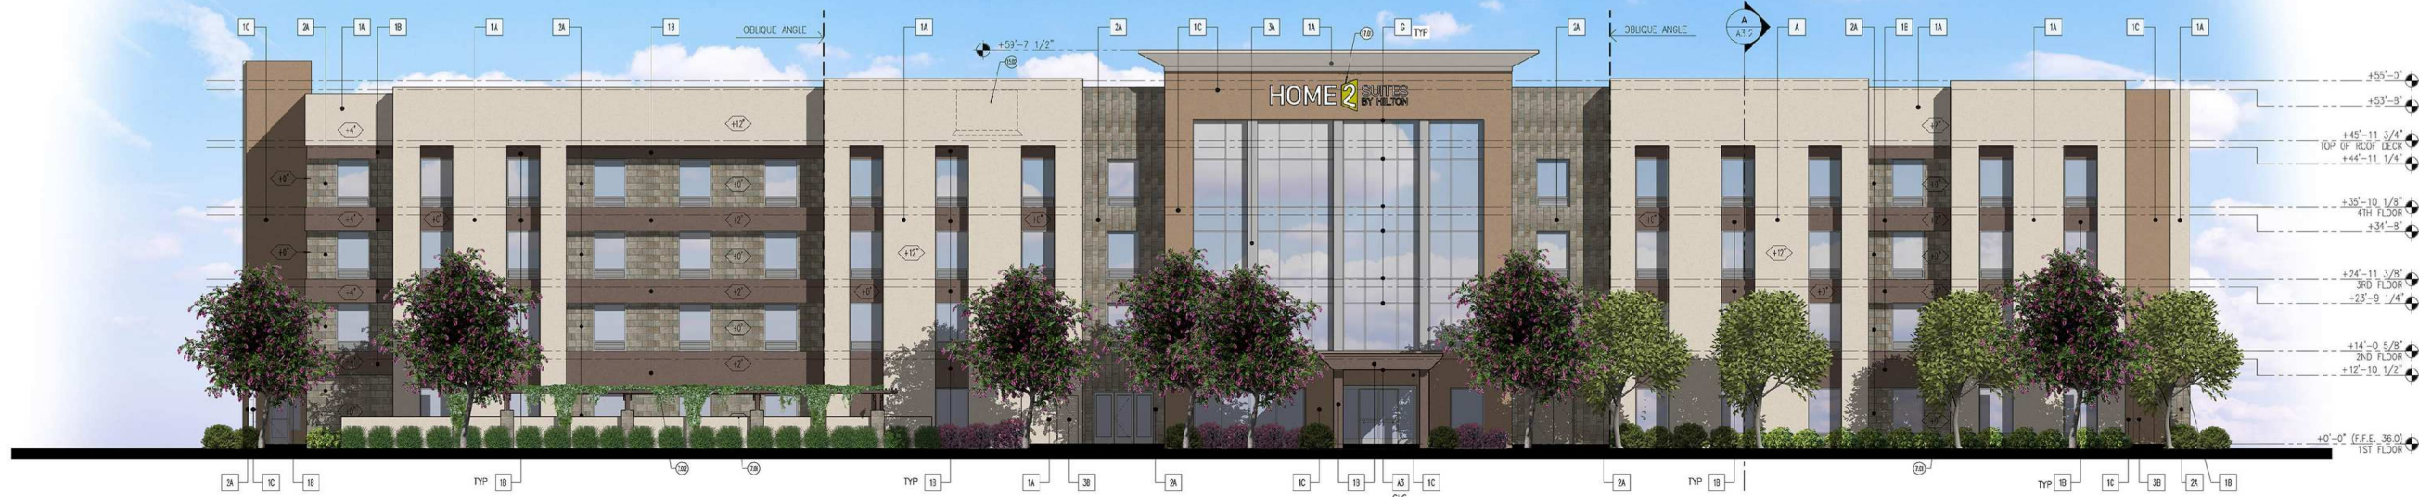
HOME 2 SUITES BY HILTON
1 2 0 5 R E D W O O D W A Y
P E T A L U M A , C A 9 4 9 5 4

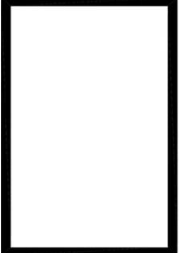REVISION	DATE	COMMENTS

PROJECT NO:	18305
DATE:	
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SHEET TITLE:
EXTERIOR ELEVATIONS


SHEET NUMBER:
A3.1



EAST ELEVATION 1
SCALE: 3/32" = 1'-0"




SOUTH ELEVATION 4
SCALE: 3/32" = 1'-0"

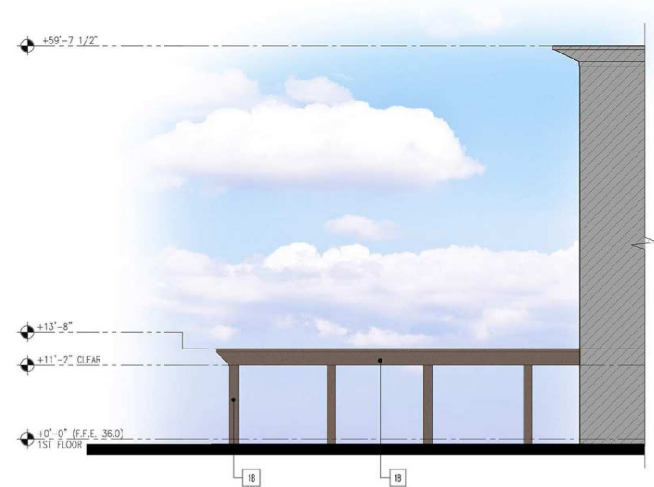


NORTH "B" ELEVATION 8
SCALE: 3/32" = 1'-0"




NORTH "A" ELEVATION 2
SCALE: 3/32" = 1'-0"

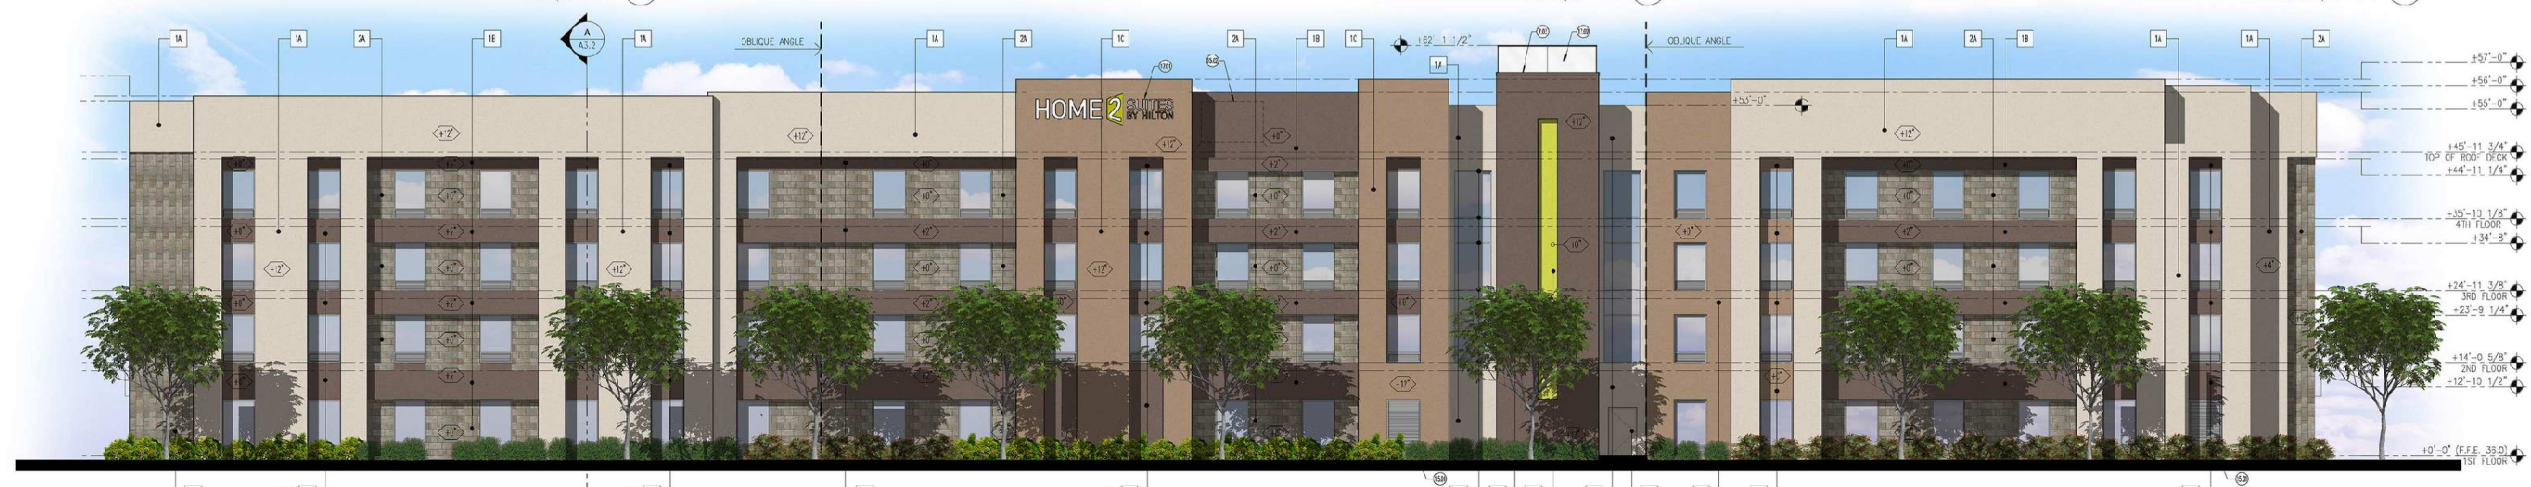


WEST ELEVATION 5
SCALE: 3/32" = 1'-0"

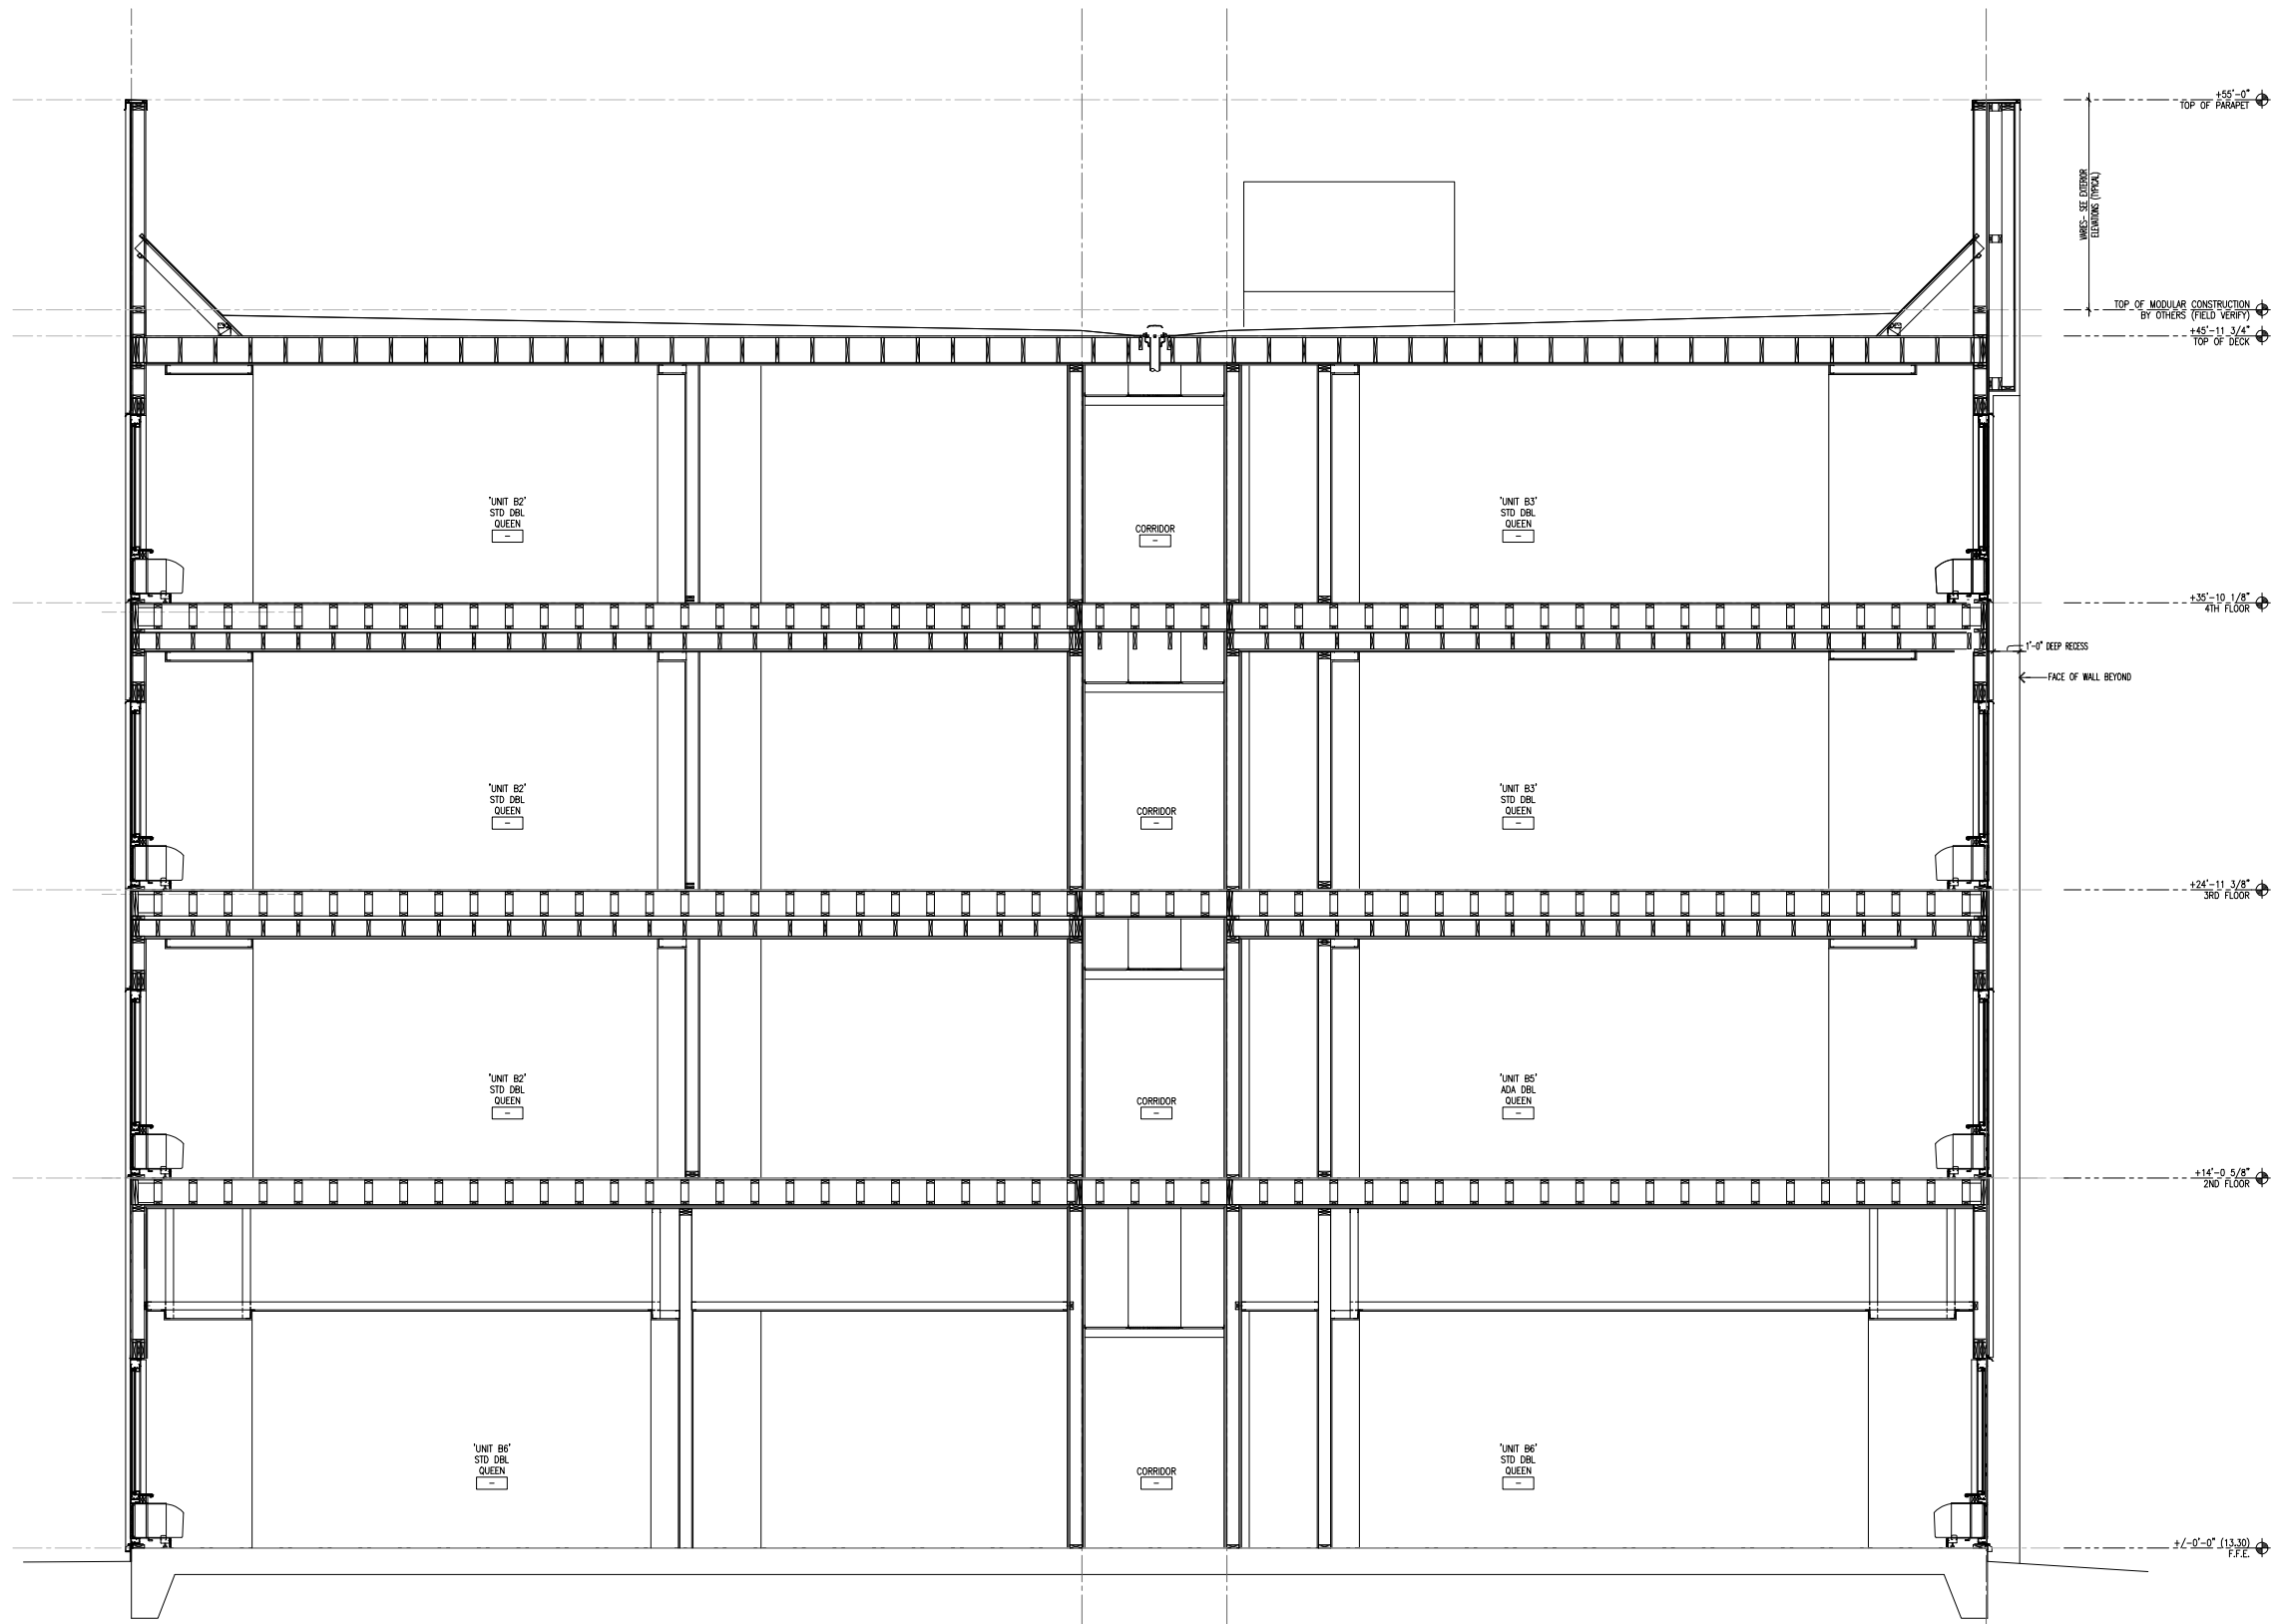


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 PHONE: (602) 283-1633
 FAX: (602) 283-1621



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REVISION:	DATE:	COMMENTS:

PROJECT NO:	18305
DATE:	
DRAWN BY:	
CHECKED BY:	

SHEET TITLE:

BUILDING SECTION

SHEET NUMBER:

A3.2

BUILDING SECTION
 SCALE: 3/8" = 1'-0"

CITY SPAR SUBMITTAL 12-13-18

GENERAL NOTES

- 1. ALL MATERIAL AND WORKMANSHIP SHALL FULLY CONFORM WITH THE SPECIFICATIONS, STANDARDS, AND ORDINANCES OF THE CITY OF PETALUMA...

DEMOLITION

- 1. ANY EXISTING WOOD OR CONCRETE STRUCTURES, PIPES, CABLE, OR OTHER FEATURES NOT REMOVED DURING DEMOLITION OR ROUGH GRADING...

DEWATERING

- 1. PRIOR TO THE PLACEMENT OF ANY FILL, AREAS COVERED WITH STANDING WATER SHALL BE DEWATERED...

UTILITIES

- 1. A MINIMUM OF TWELVE (12") INCHES VERTICAL CLEARANCE SHALL BE PROVIDED BETWEEN ADJACENT UTILITY PIPES AT ALL UTILITY CROSSINGS...

FOR SERVICE WITH A CORPORATION STOP AND SERVICE SADDLE, TURN OFF THE CORPORATION STOP AND CHECK FOR LEAKS...

FOR A SERVICE WITH A CORPORATION STOP WITH NO SERVICE SADDLE, NOTIFY ALL EFFECTED WATER CUSTOMERS OF THE SERVICE INTERRUPTION...

- 1. CONTRACTOR SHALL KEEP UP-TO-DATE A COMPLETE RECORD SET OF PRINTS OF THE CONTRACT DRAWINGS SHOWING EVERY CHANGE FROM THE ORIGINAL DRAWINGS...

RECORD DRAWINGS

- 1. CONTRACTOR SHALL KEEP ACCURATE RECORD DRAWINGS WHICH SHOW THE FINAL LOCATION, ELEVATION, AND DESCRIPTION OF ALL WORK...

WATER SYSTEM NOTES

- 1. PROVIDE THRUST BLOCKS OR COMPARABLE RESTRAINTS PER CITY STDS.

FIRE PROTECTION NOTES

- 1. THE UNDERGROUND FIRE PROTECTION SYSTEM SHOWN ON THIS DRAWING IS SCHEMATIC AND IS NOT INTENDED TO BE AN INSTALLATION DRAWING...

FIRE PROTECTION NOTES (CONT)

- 10. BUILDINGS OF THREE OR MORE STORIES REQUIRE INSTALLATION OF STANDPIPES IN THE STAIRWELLS FOR FIRE DEPARTMENT USE.

GRADING AND PAVING NOTES

- 1. PAVEMENT EXCAVATION SHALL INCLUDE REMOVAL AND DISPOSAL OF EXISTING A.C. PAVEMENT AND PCC CURB REQUIRED FOR THE CONSTRUCTION OF NEW SURFACE IMPROVEMENTS...

Table with columns: PAVEMENT SUBGRADE, HORIZONTAL, VERTICAL, COMPACTION. Includes rows for prime coat of SC-70 liquid asphalt and various asphalt emulsions.


GENERAL NOTES (FOR COMPLIANCE WITH CITY STANDARDS)

- 1. CONTRACTOR SHALL KEEP UP-TO-DATE A COMPLETE RECORD SET OF PRINTS OF THE CONTRACT DRAWINGS SHOWING EVERY CHANGE FROM THE ORIGINAL DRAWINGS...


GENERAL NOTES (FOR COMPLIANCE WITH CITY STANDARDS) (CONT)

- 15. THE EXISTING UTILITIES CROSSING OF THE NEW PIPELINE ARE SHOWN ACCORDING TO THE BEST AVAILABLE INFORMATION...

SYMBOL DESCRIPTION

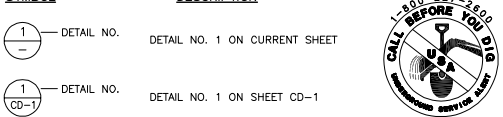

LEGEND

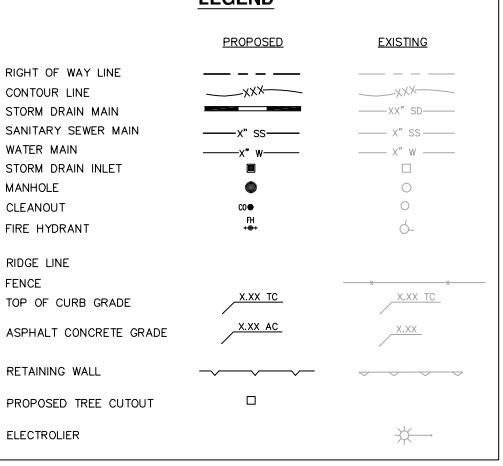


ABBREVIATIONS

Table with columns: SYMBOL and DESCRIPTION. Lists abbreviations for various construction elements like Aggregate Base, Asphalt Concrete, Area Drain, etc.

FLOOD ZONE

THE BUILDING FOOTPRINT IS LOCATED IN FLOOD ZONE X AS SHOWN ON THE FEDERAL EMERGENCY MANAGEMENT AGENCY FLOOD INSURANCE RATE MAP...

THE BASE FLOOD ELEVATION FOR THE FLOOD ZONE "AE" WAS DETERMINED TO BE 35 FEET BASED ON THE NORTH AMERICAN VERTICAL DATUM OF 1988 (NAVD88)...

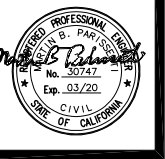

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FAX: (408) 467-9199

HOME2 SUITES BY HILTON logo and vertical address: 1205 REDWOOD WAY, PETALUMA, CA 94954

Table with columns: REVISION, DATE, COMMENTS. Contains one revision entry.

PRINT DATE: 02-15-2019

Table with columns: PROJECT NO., DATE, DRAWN BY, CHECKED BY. Contains project information.

NOTES & LEGEND

SHEET TITLE: NOTES & LEGEND

SHEET NUMBER: C-1

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EXISTING KOHL'S PARKING LOT

KOHL'S BUILDING

REDWOOD GATEWAY, LLC
DN 2006-119461



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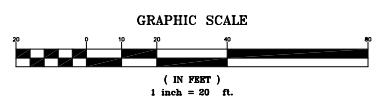
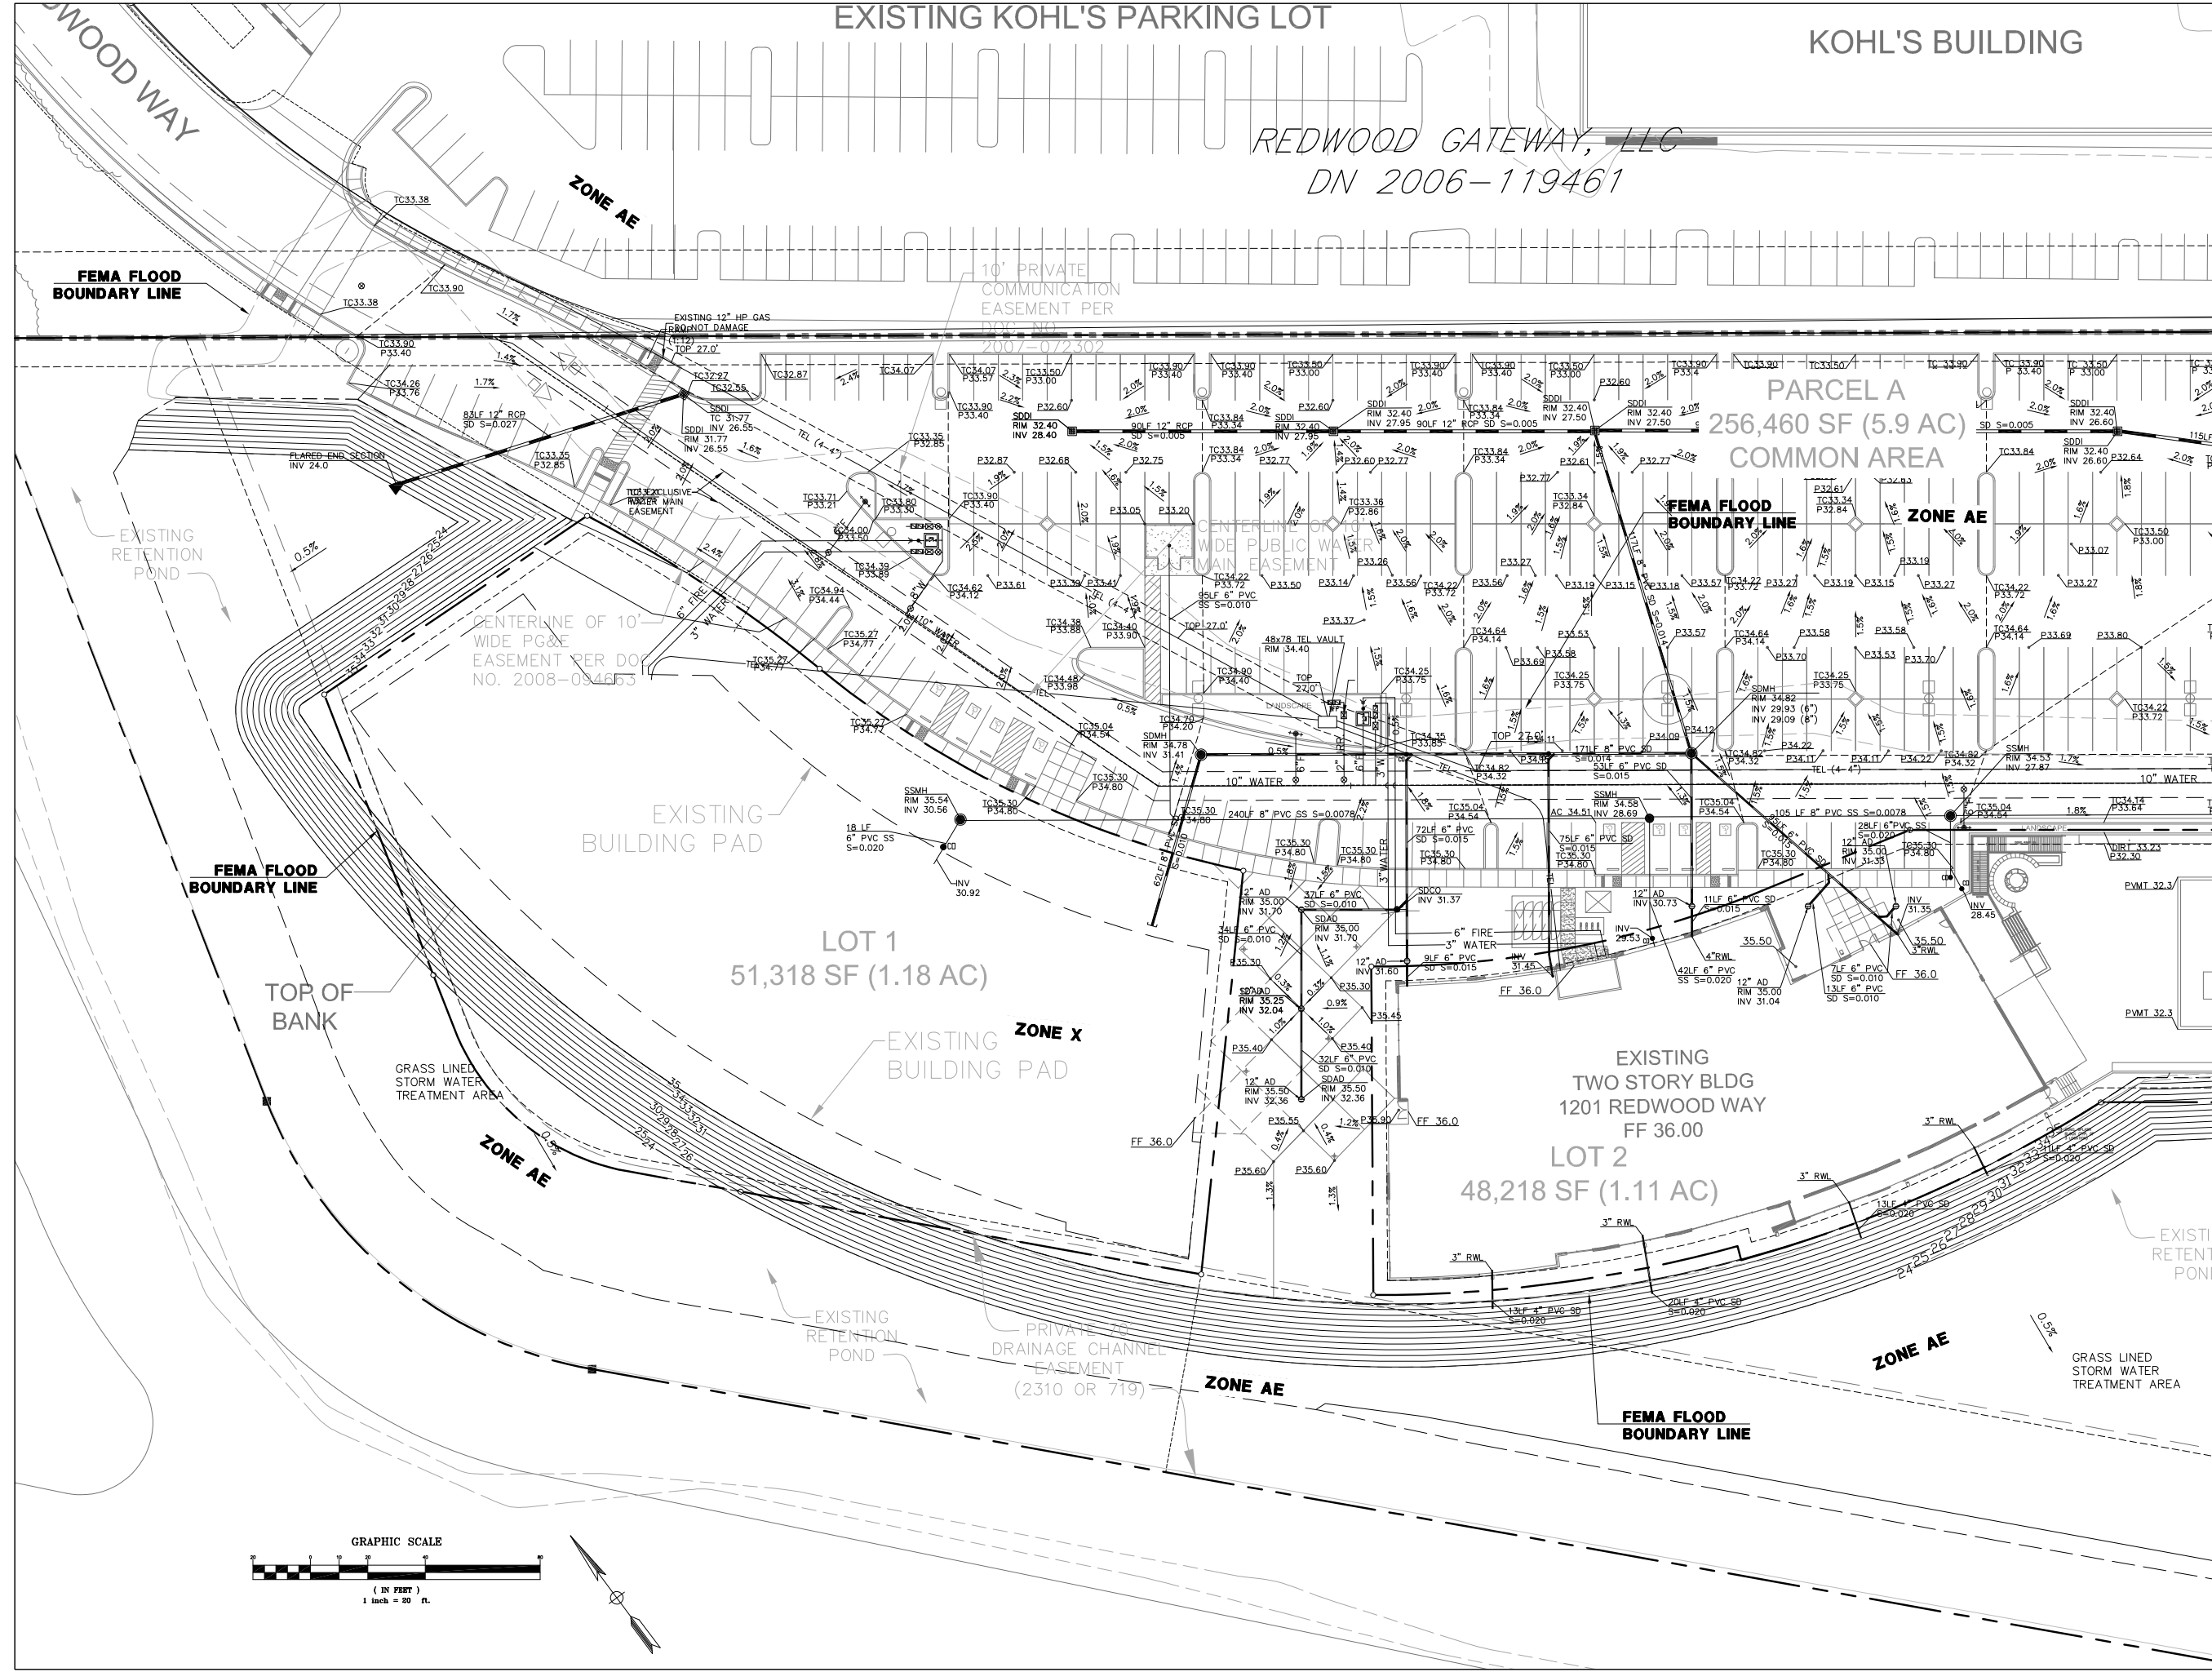
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02-15-2019


PROJECT NO: 18305
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CHECKED BY: MBP

SHEET TITLE:
EXISTING
CONDITIONS

SHEET NUMBER:
C-2



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REVISION	DATE	COMMENTS

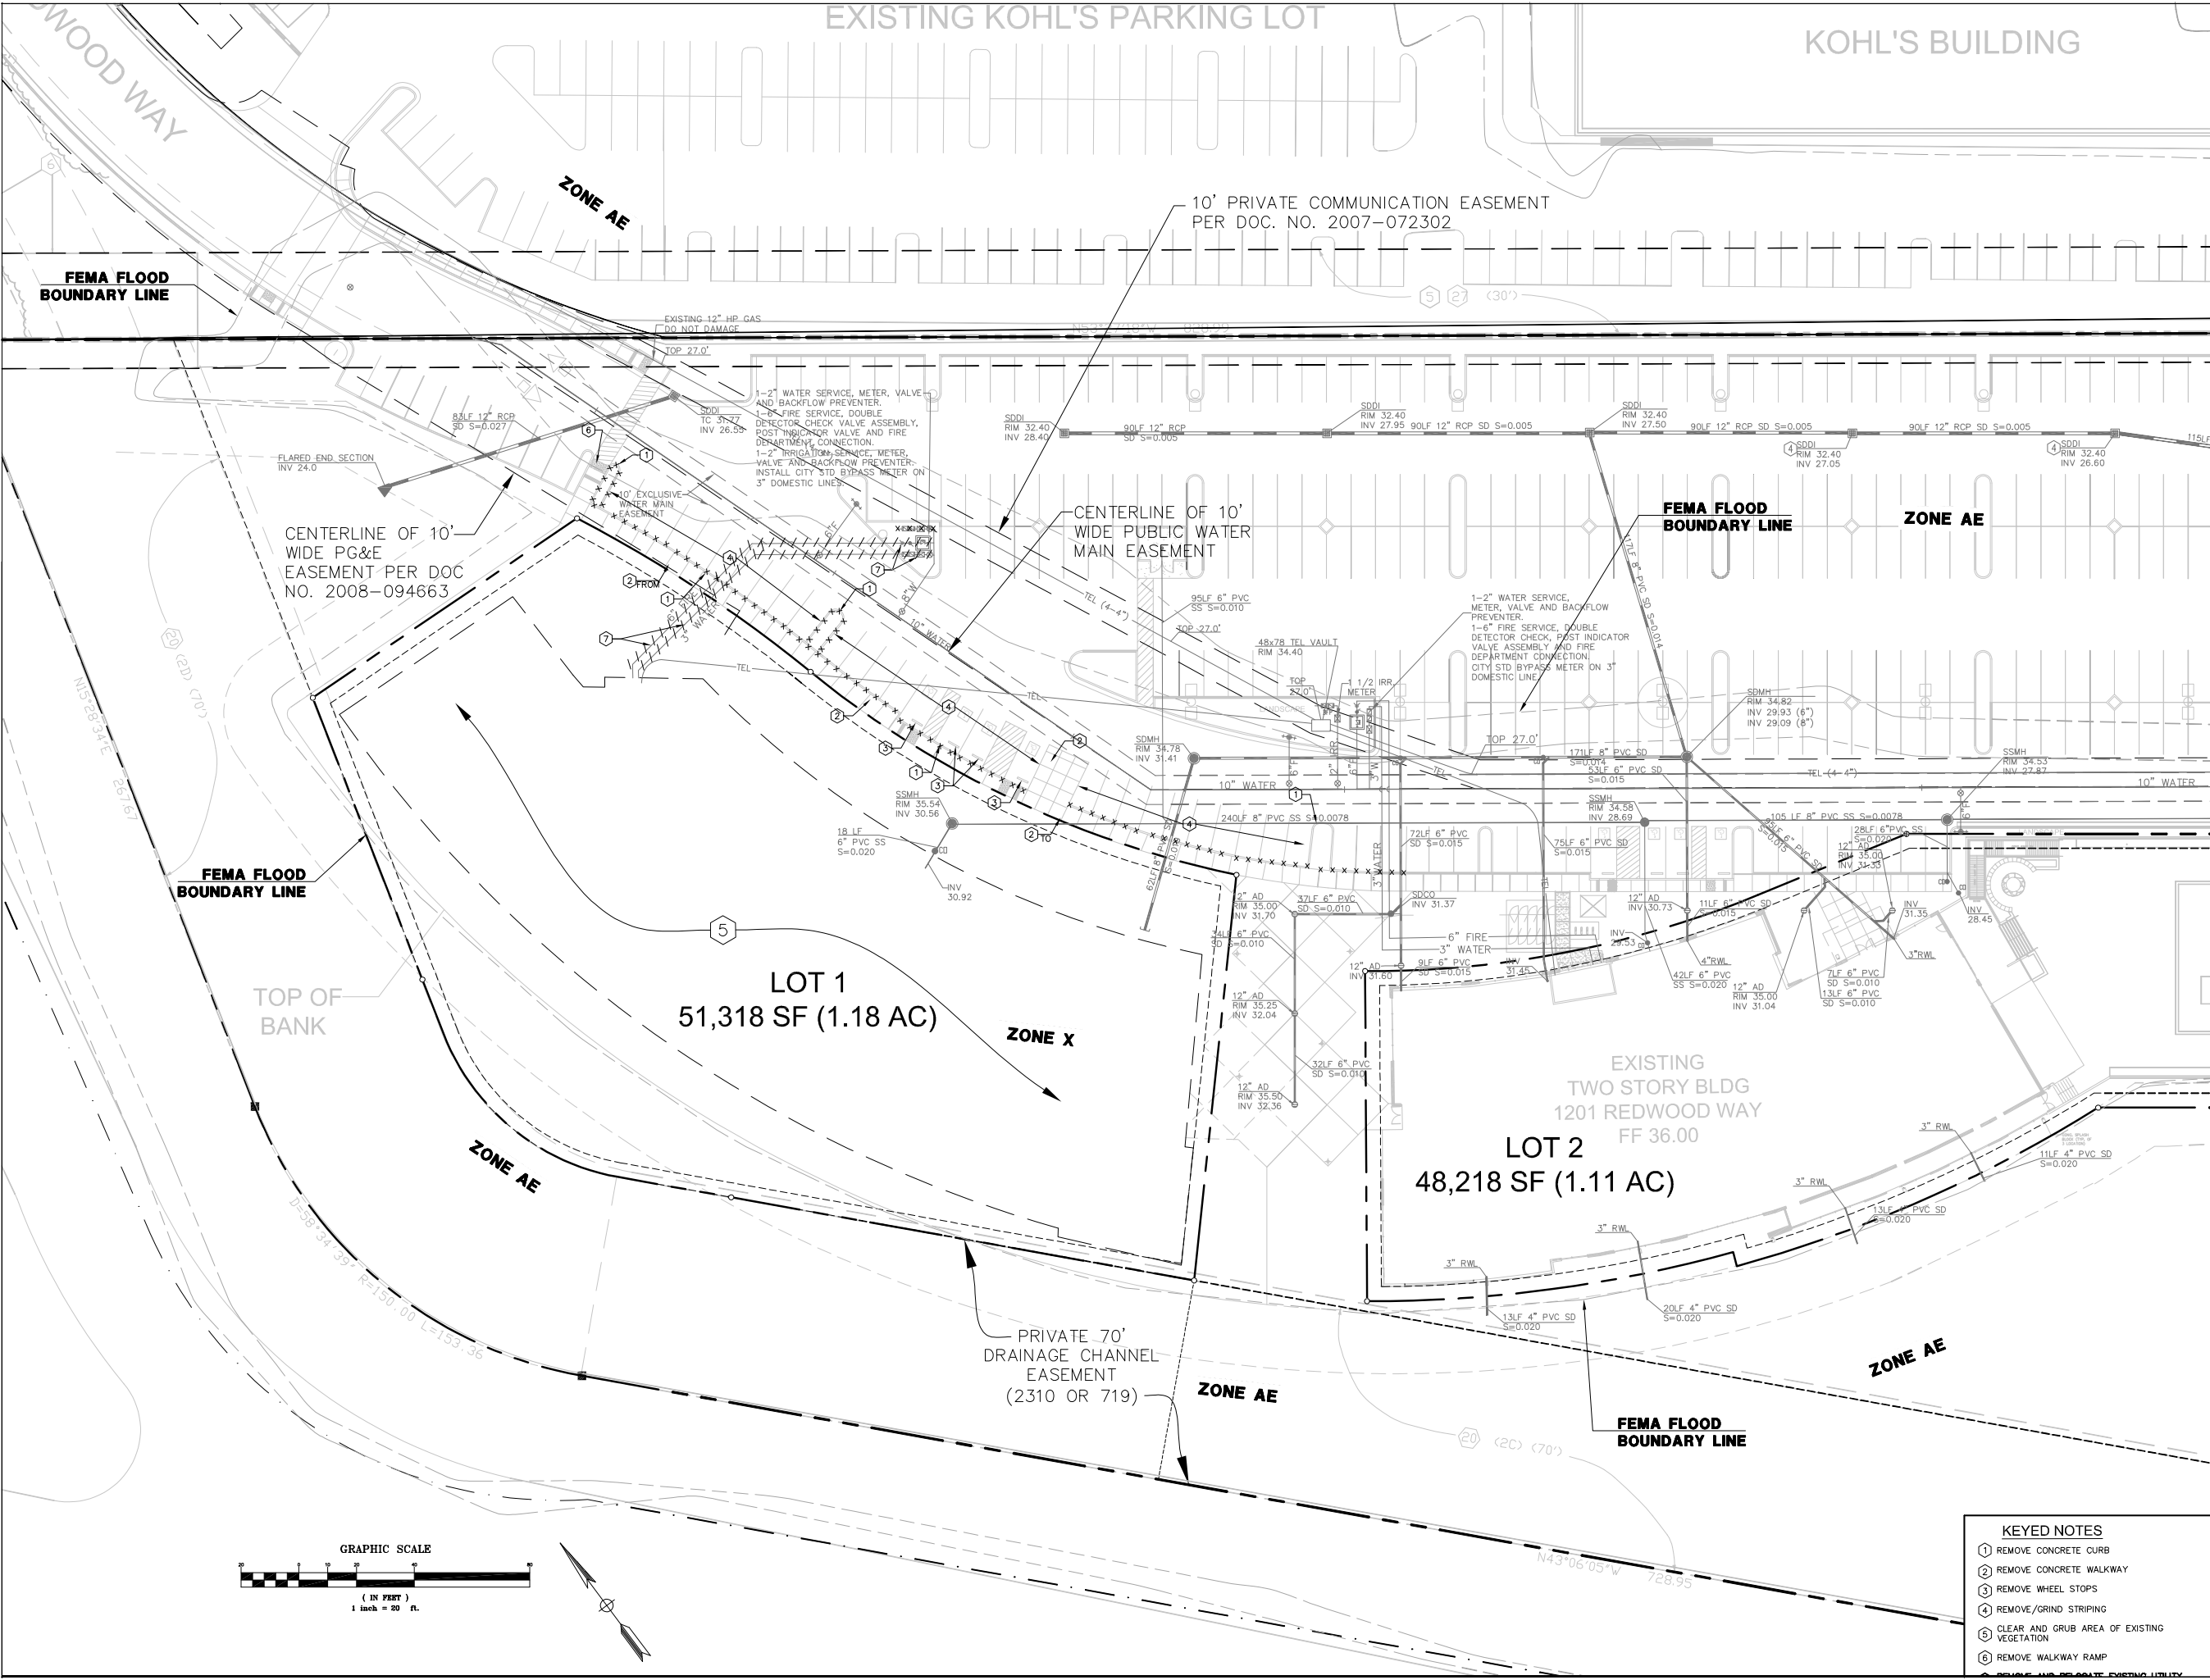
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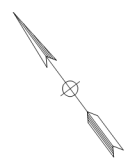
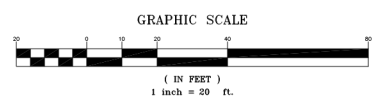
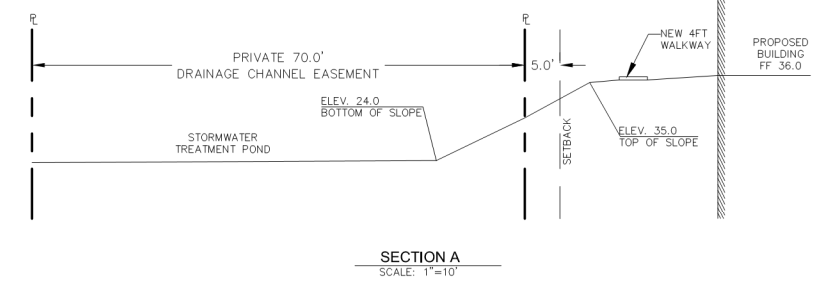
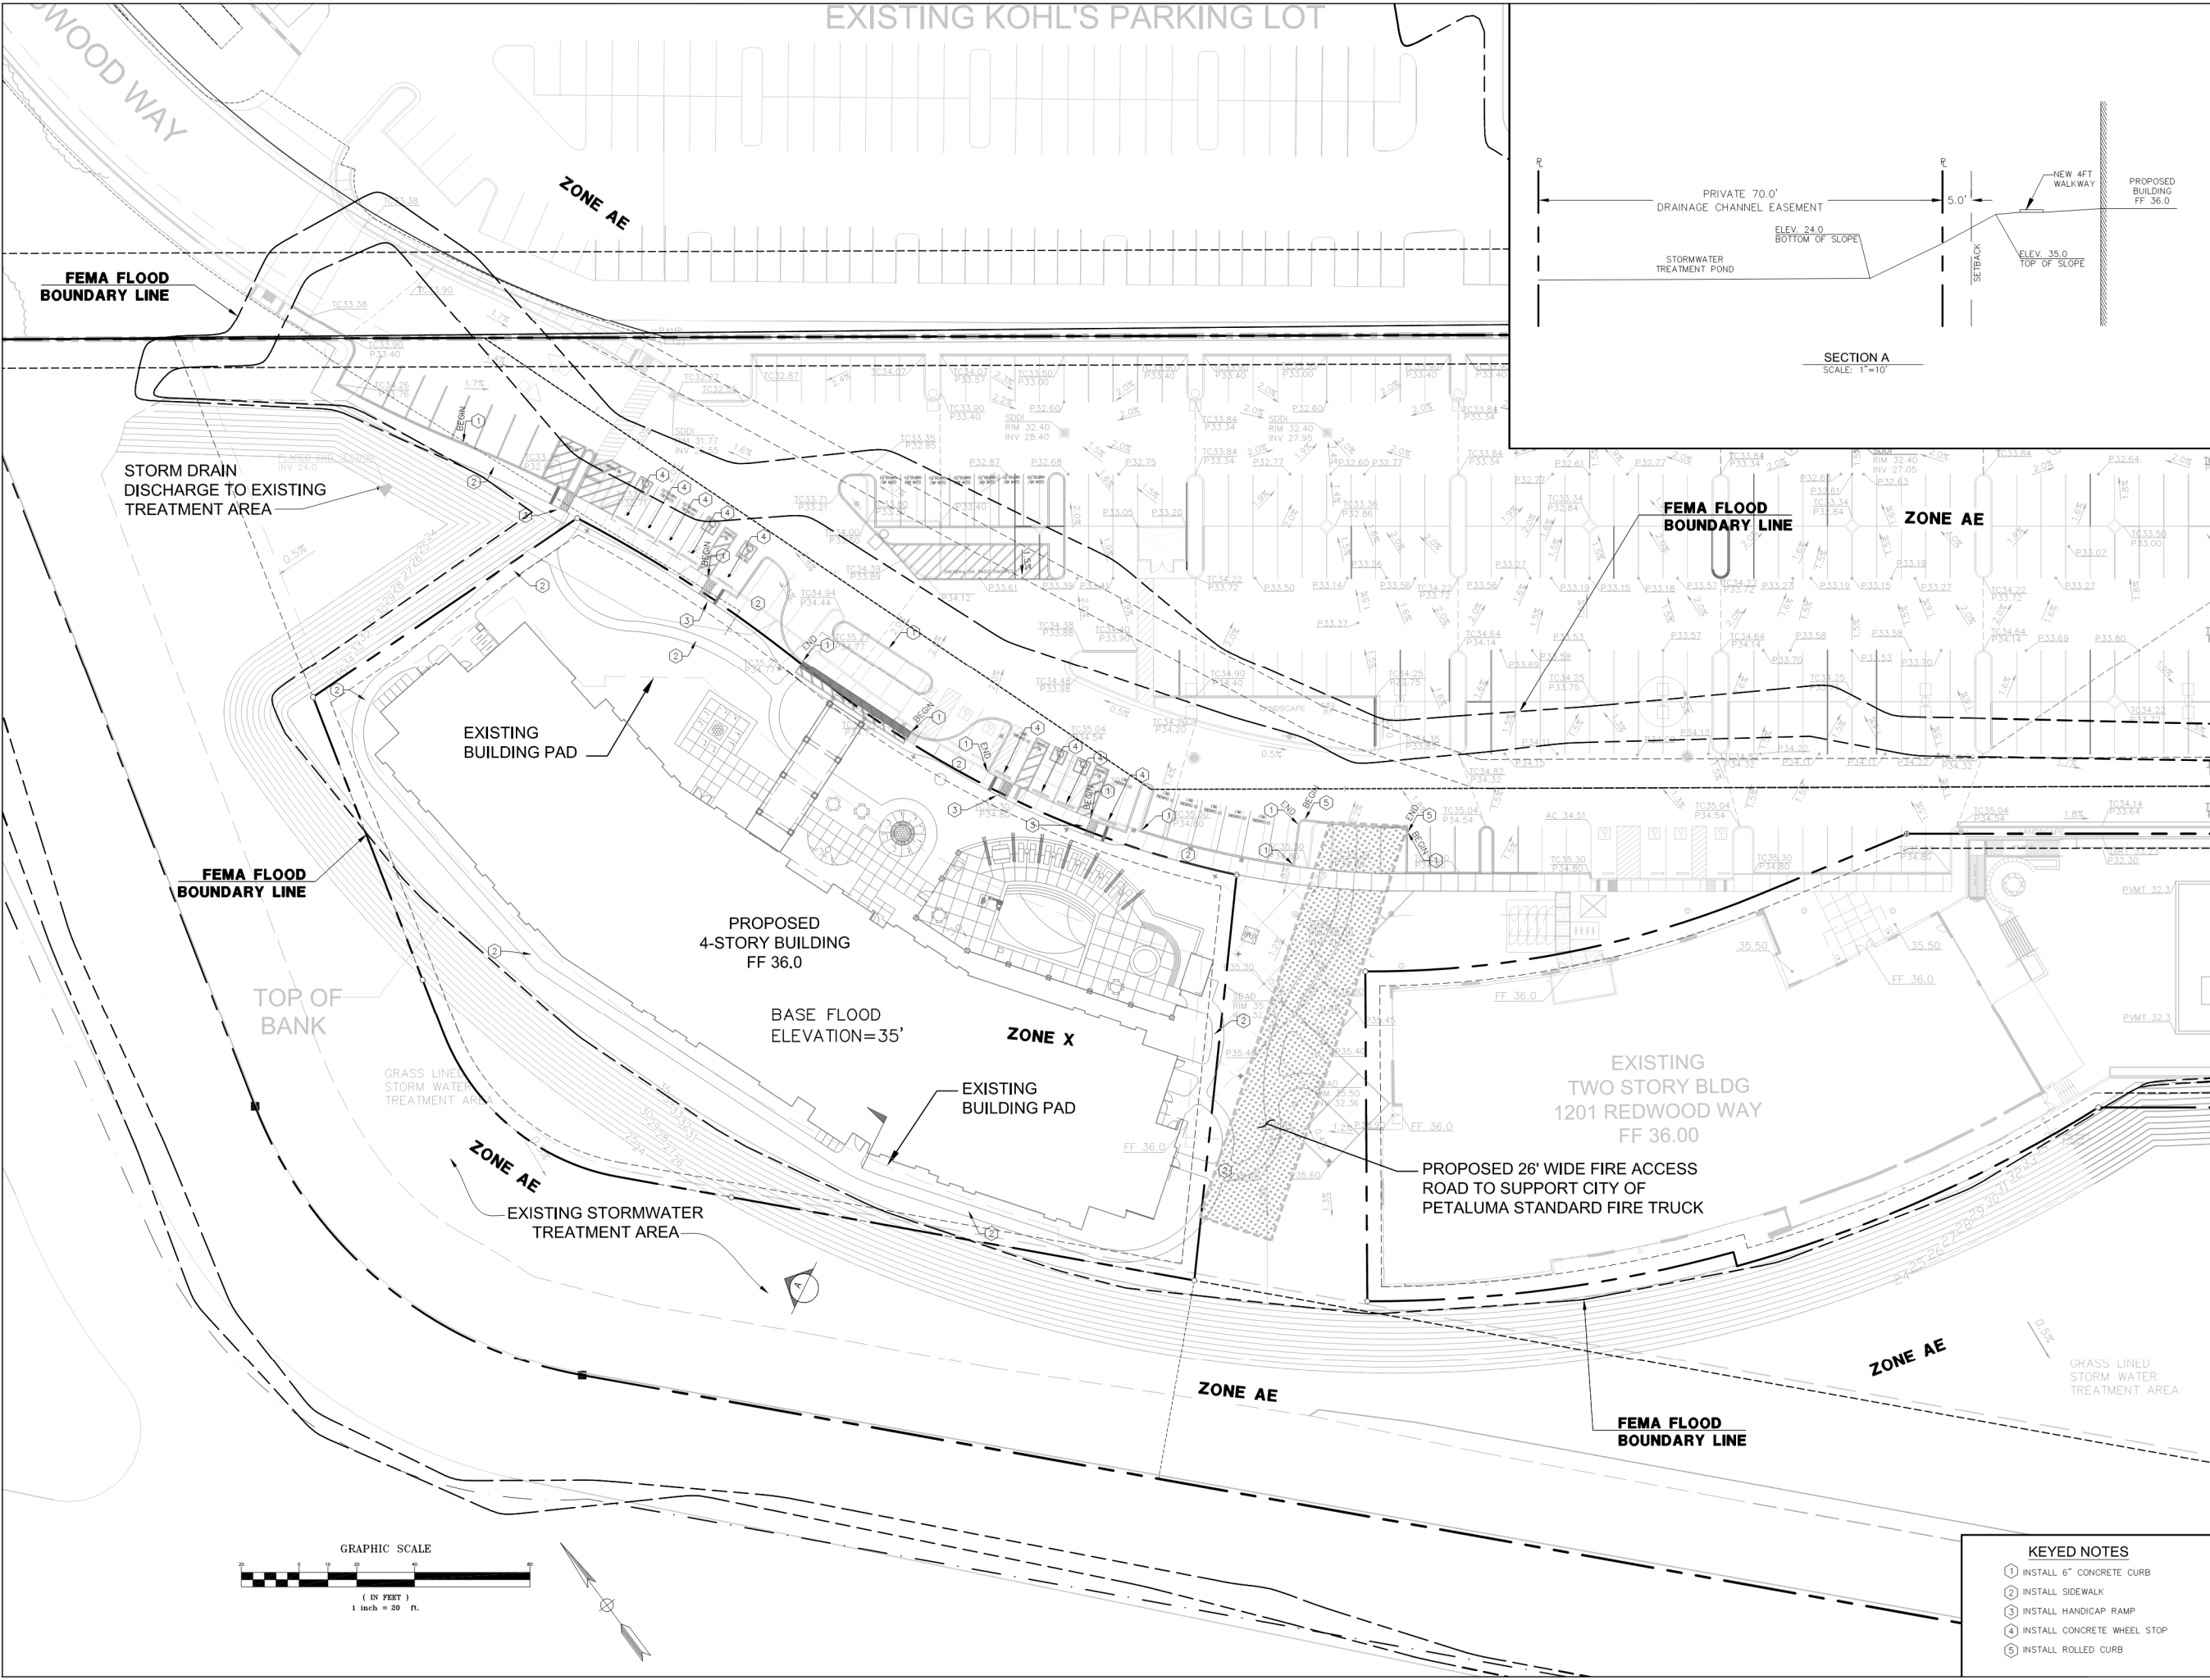
SHEET TITLE:
DEMOLITION PLAN

SHEET NUMBER:
C-3

- KEYED NOTES**
- ① REMOVE CONCRETE CURB
 - ② REMOVE CONCRETE WALKWAY
 - ③ REMOVE WHEEL STOPS
 - ④ REMOVE/GRIND STRIPING
 - ⑤ CLEAR AND GRUB AREA OF EXISTING VEGETATION
 - ⑥ REMOVE WALKWAY RAMP
 - ⑦ REMOVE AND RELOCATE EXISTING UTILITY



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- KEYED NOTES**
- ① INSTALL 6" CONCRETE CURB
 - ② INSTALL SIDEWALK
 - ③ INSTALL HANDICAP RAMP
 - ④ INSTALL CONCRETE WHEEL STOP
 - ⑤ INSTALL ROLLED CURB

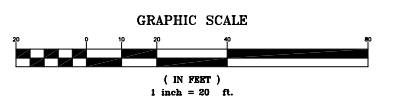

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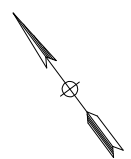
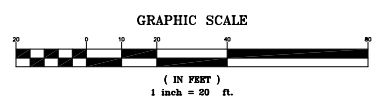
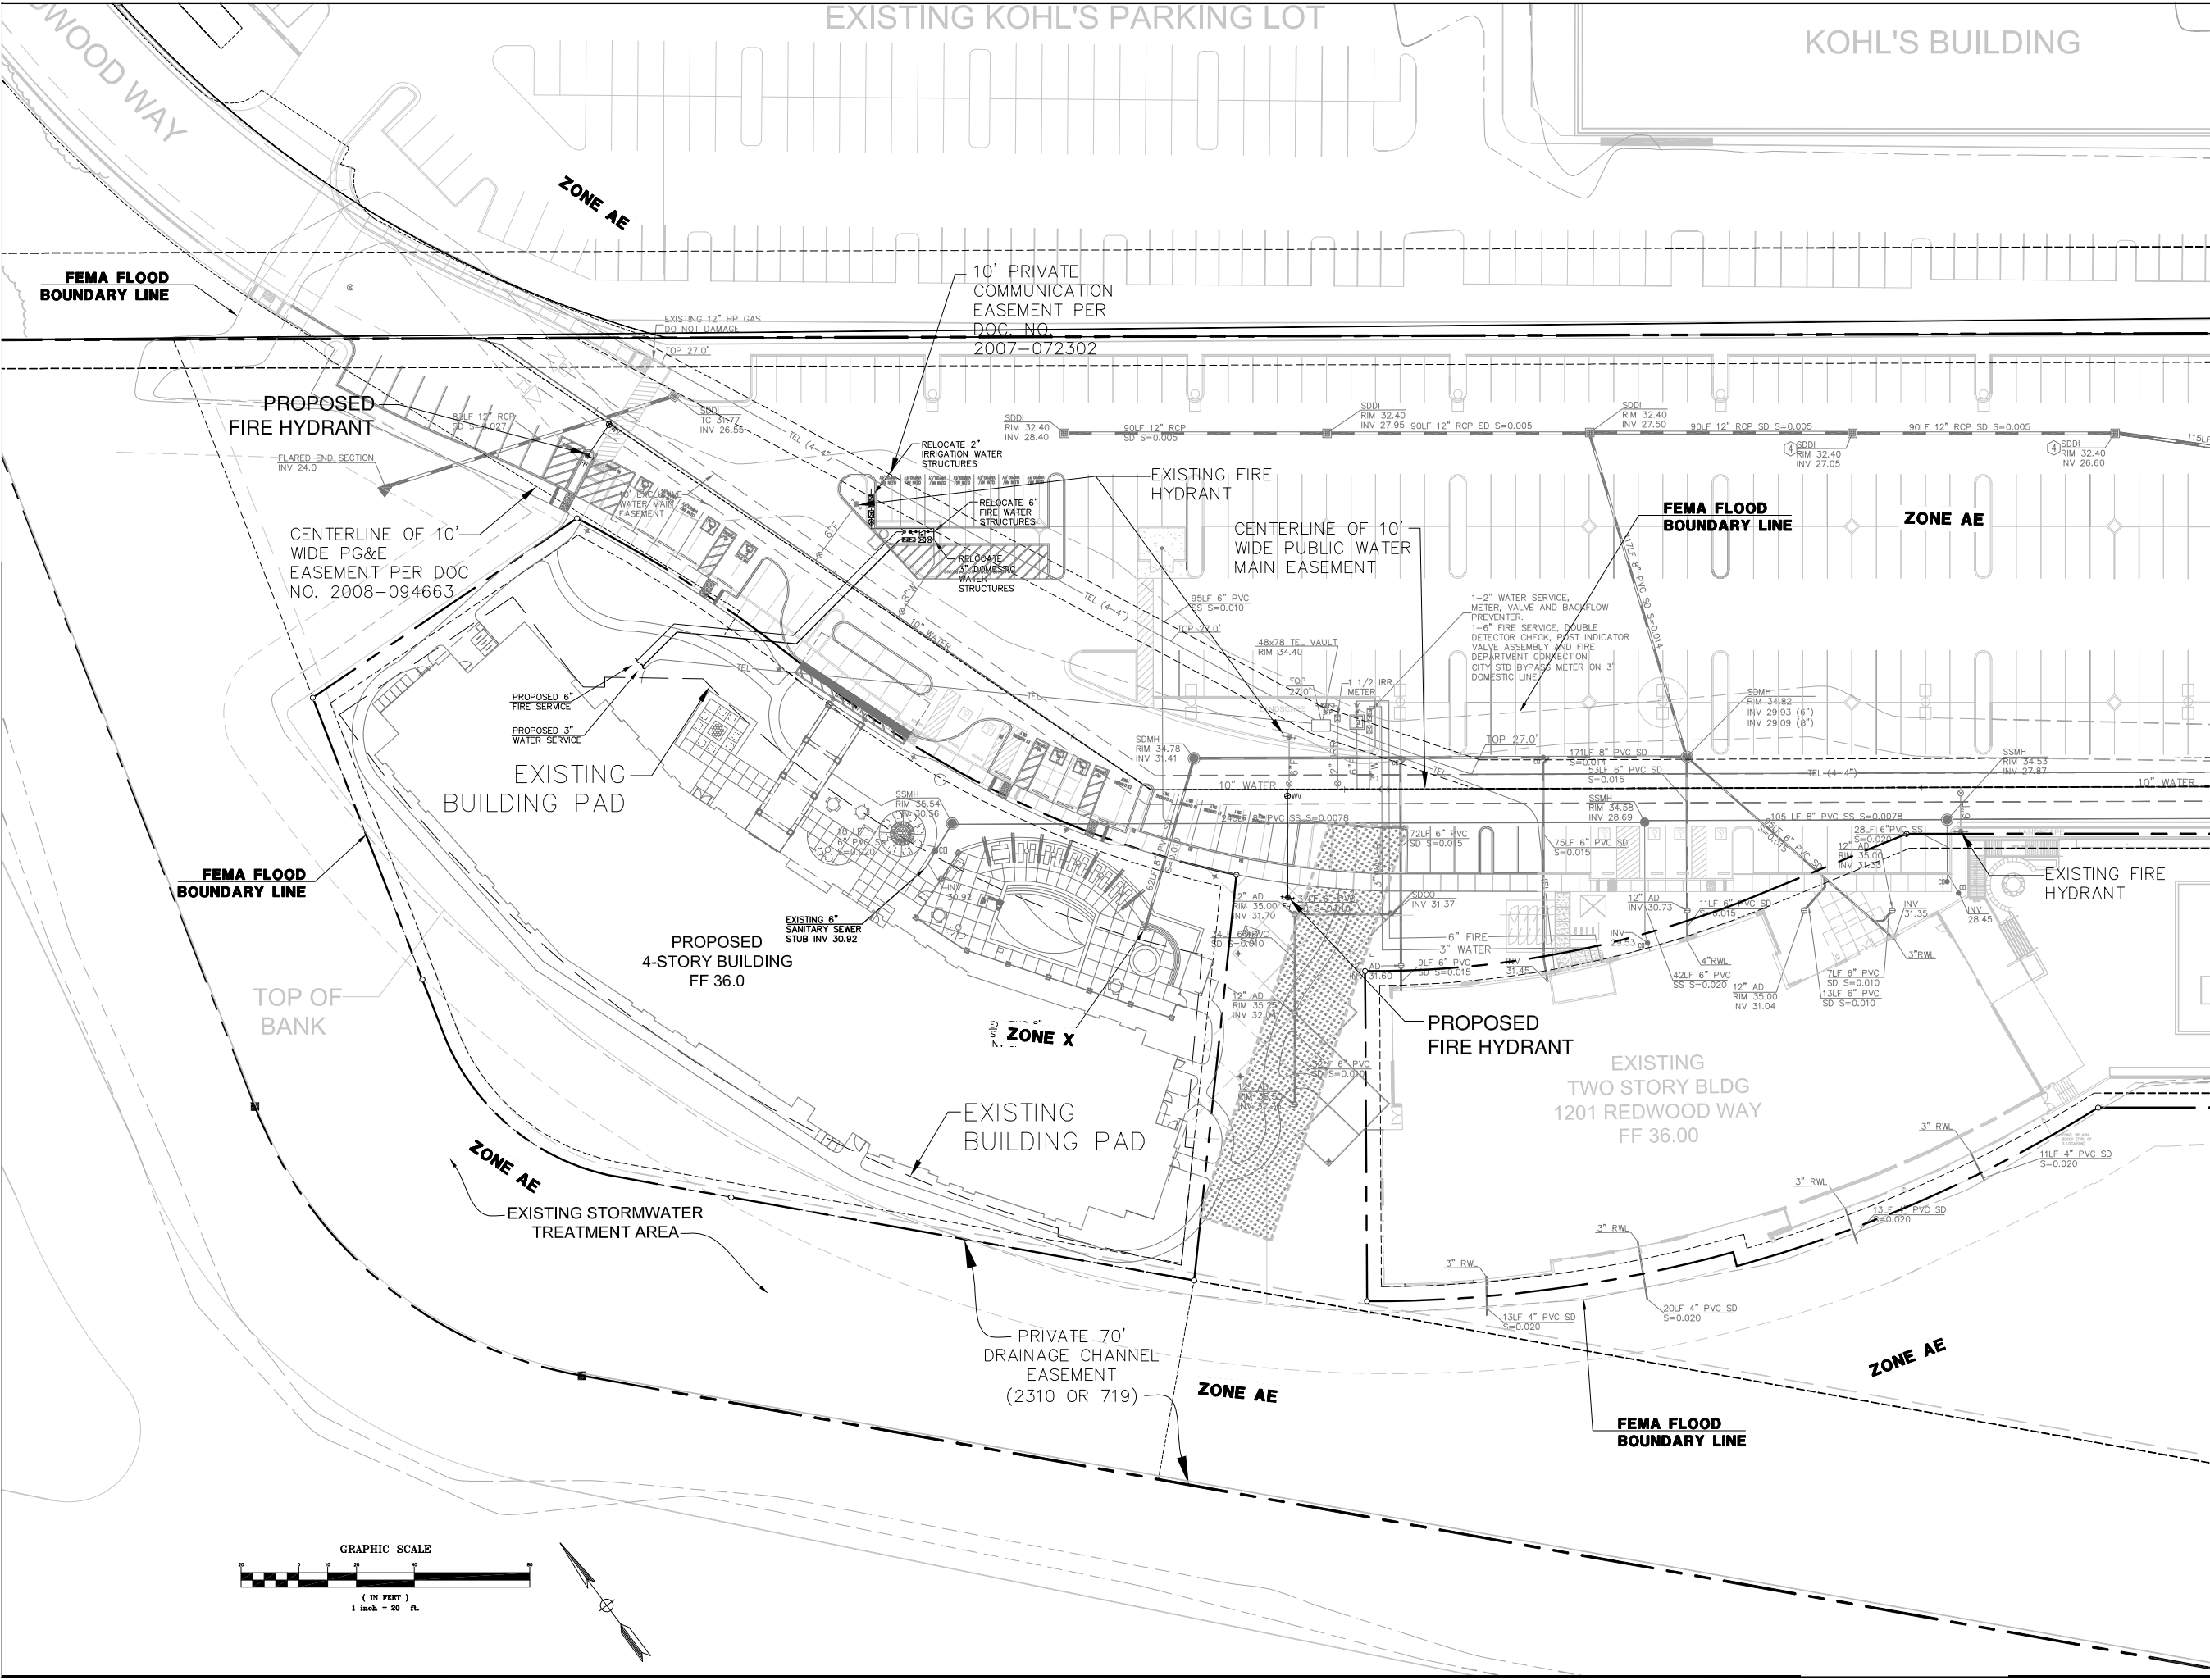
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
SHEET TITLE:
GRADING PLAN


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
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
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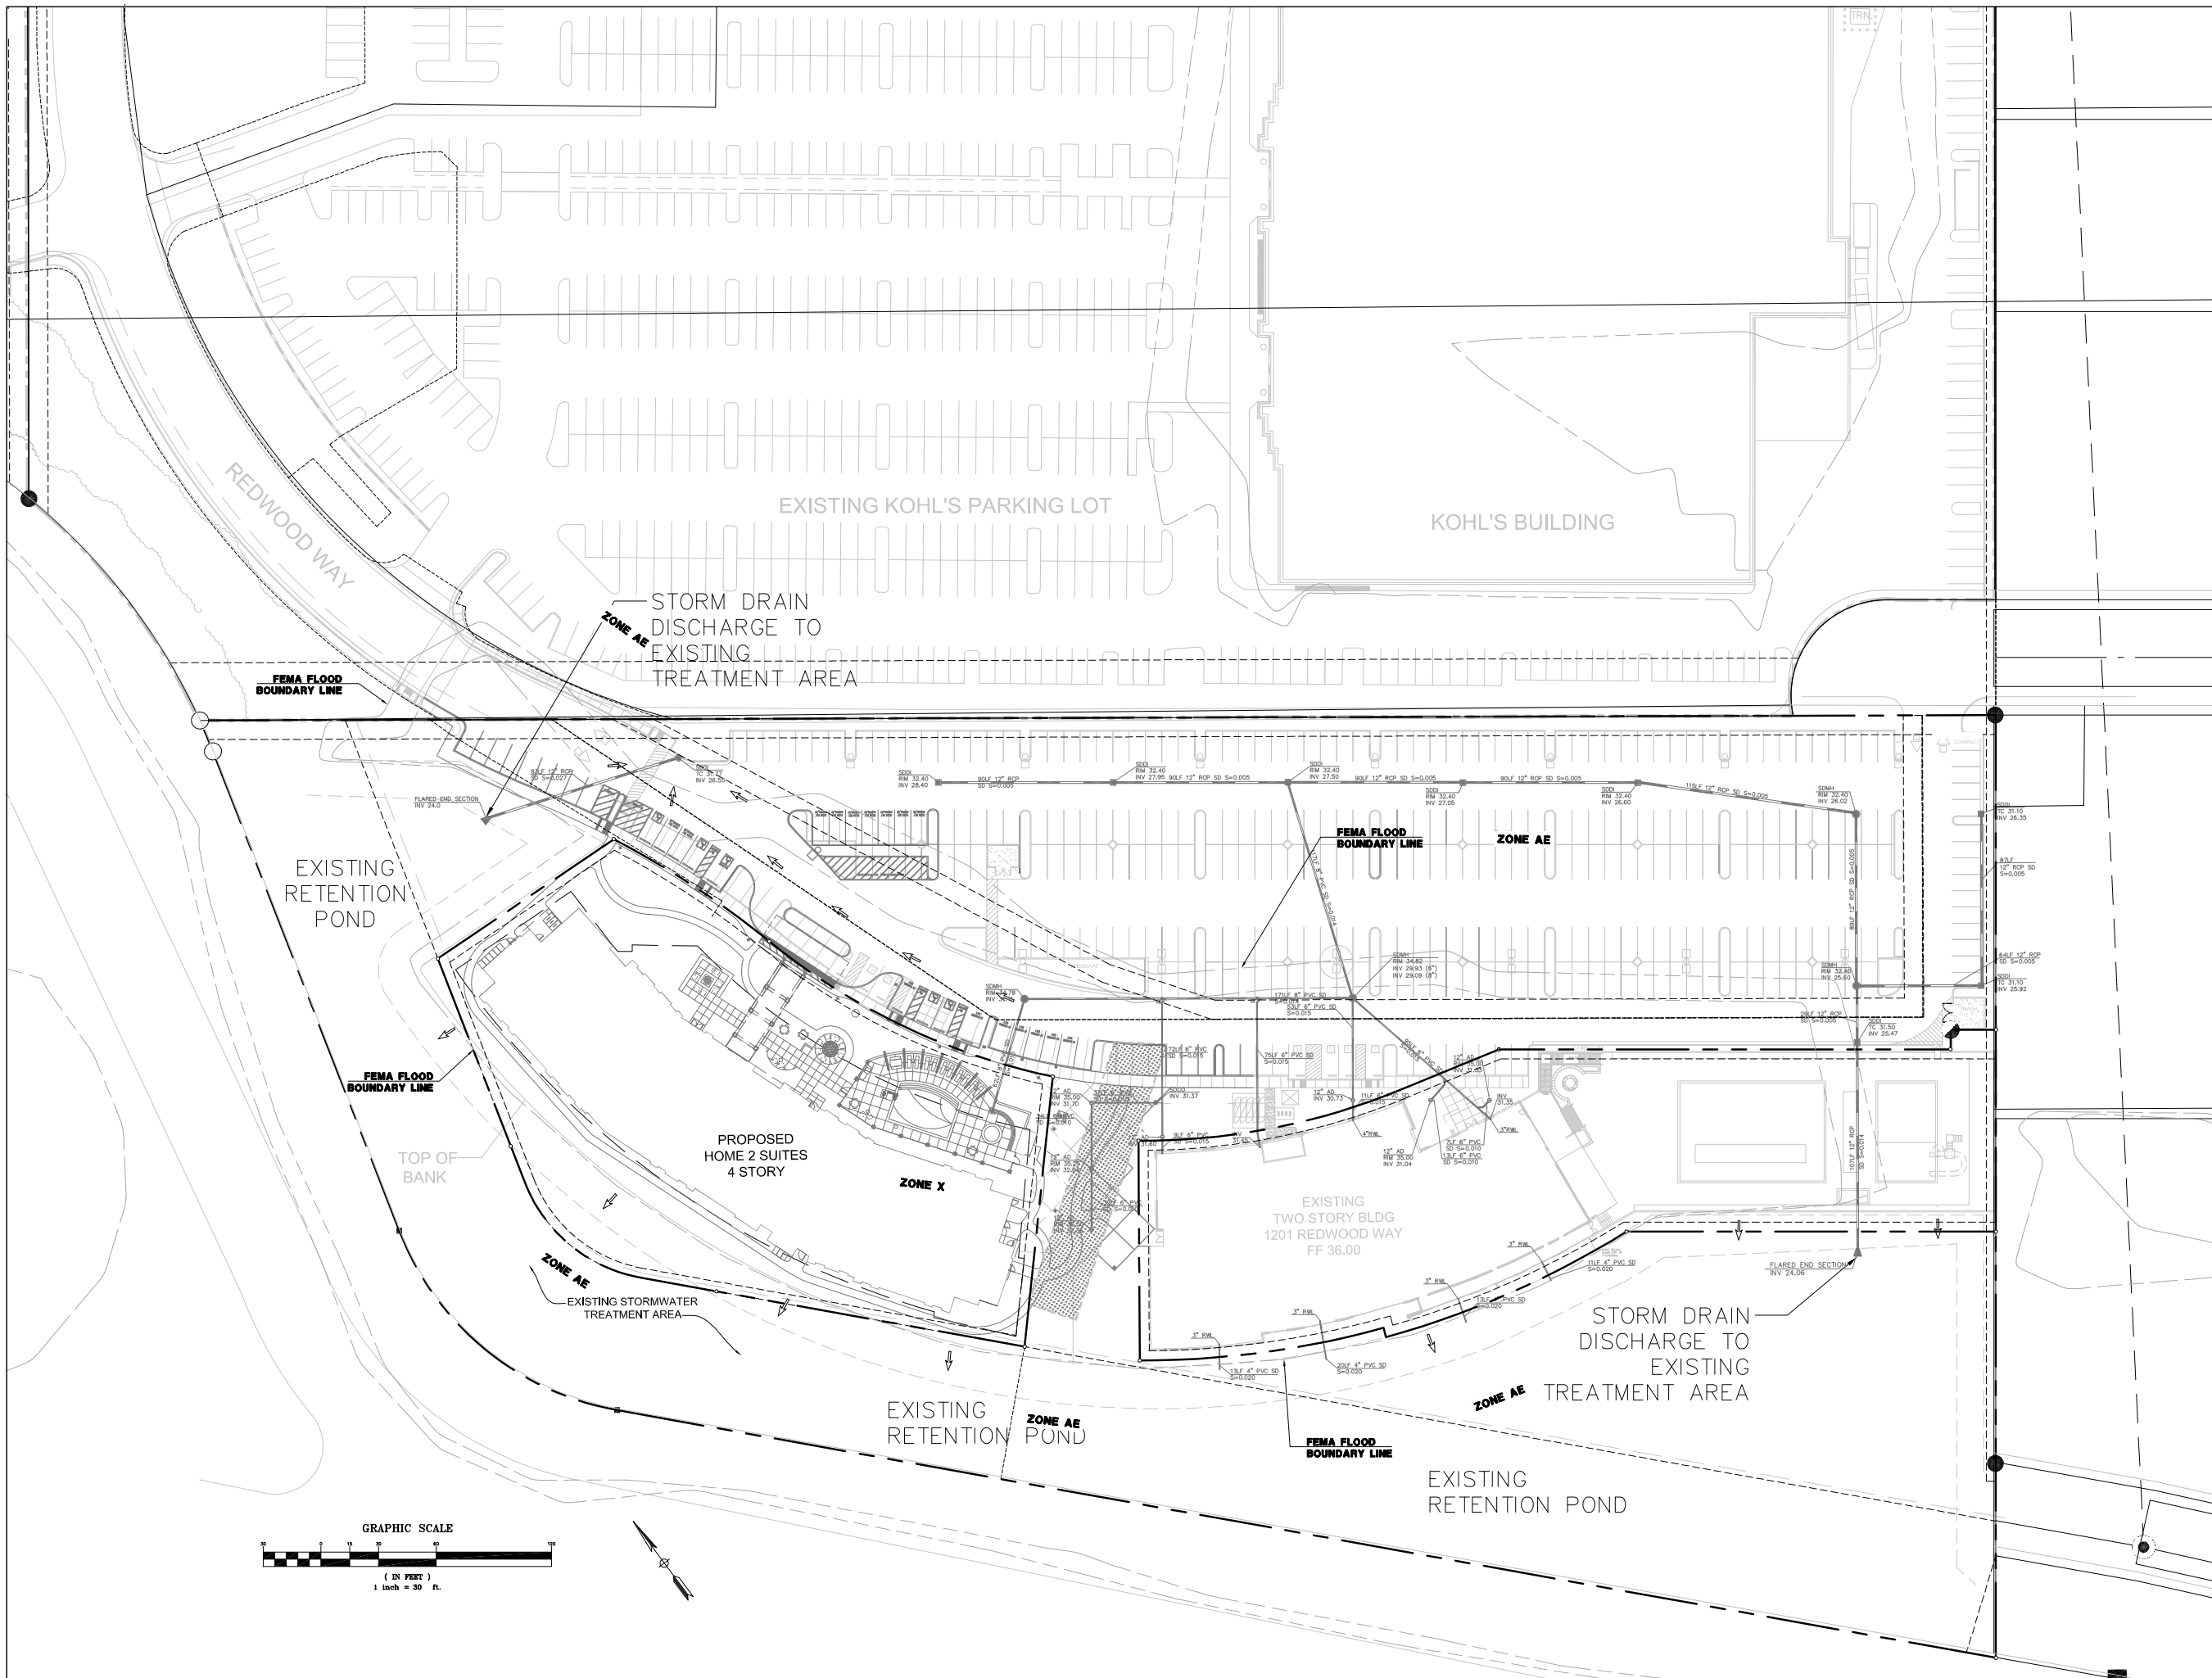
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
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
SHEET TITLE:
UTILITY PLAN

SHEET NUMBER:
C-5




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




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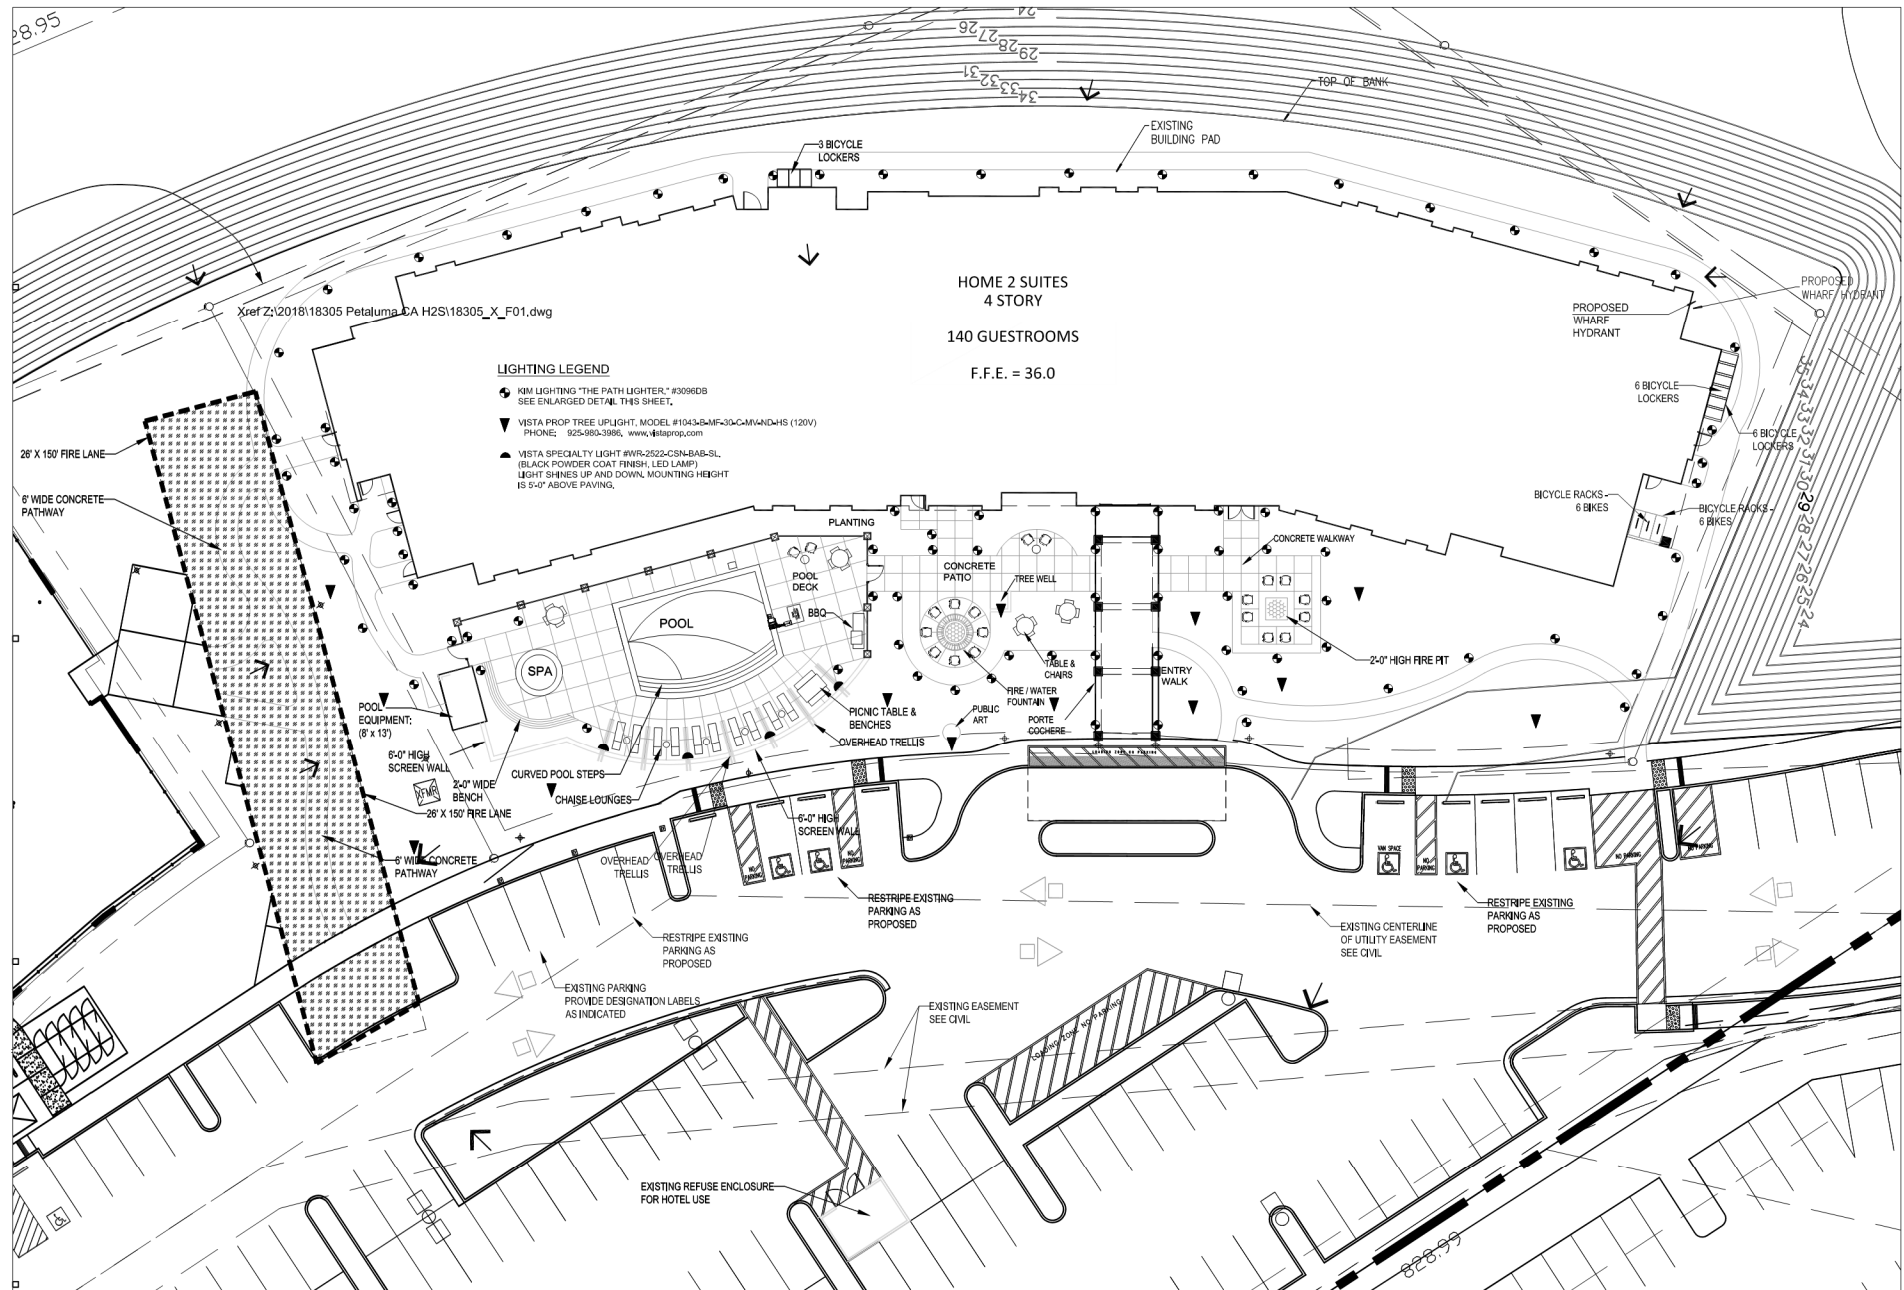
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PROJECT NO.: 18305
DATE: 02-15-2019
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CHECKED BY: MBP

SHEET TITLE:
STORM WATER CONTROL PLAN

SHEET NUMBER:
C-6



LIGHTING LEGEND

- KIM LIGHTING "THE PATH LIGHTER" #3098DB (SEE ENLARGED DETAIL THIS SHEET)
- VISTA PROP TREE UPLIGHT, MODEL #1043-DMF-30-C-MAN-4HS (120V) PHONE: 602-863-3686, WWW.VISTALIGHTING.COM
- VISTA SPECIALTY LIGHT #1043-2522-CSN-BAS-SL (BLACK POWDER COAT FINISH, LED LAMP) LIGHT SHINES UP AND DOWN, MOUNTING HEIGHT IS 5'-0" ABOVE PAVING.

KIM LIGHTING The Path-Lighter 3091 / 3095
120 Volt Cast Aluminum, A-21 Incand., Compact Fluorescent

Type:
Job:
Fixture Catalog number:

Apprvals:
Date:
Page: 1 of 1

Specifications

Housing: One piece cast aluminum, two 1/2" NPT in bottom.
Top: Cast aluminum with flush stainless steel flat slotted screws.
Lens: Milled boroalicate prismatic glass with removable 1/8" reflector shield.
Gasketing: Silicone gaskets used throughout.
Socket: (3091) Phoenix medium base, (3095) G21D 2-pin base.
Electrical Components: (3095) Normal power factor towards 20% starting.
Finish: Super TFC® thermoplastic polyester powder coat paint, 2.5 mil nominal film thickness, applied over a chrome conversion coating. (3091) has salt spray test endurance rating. Standard colors are Black (BL), Dark Bronze (DB) and Venic Green (GR).
Certification: U.S. Listed to U.S. and Canadian safety standards for wet locations. Fixture manufacturer shall employ a quality program that is certified to meet the IEC 9001:2000 standard.

ORDERING INFORMATION

Fixture	Finish
3091BL	Black
3091DB	Dark Bronze
3091GR	Venic Green

Wattage / Lamp
100W
A-21
Incandescent

Fixture

Fixture	Finish
3095BL	Black
3095DB	Dark Bronze
3095GR	Venic Green

Wattage / Lamp
20W
Double Twin Tube
Fluorescent

MOUNTING INFORMATION:

- Clean appearance - no visible junction box.
- Very rigid when installed in concrete.
- Can be installed flush with paving surface.

CAUTION: Fixture must not be in contact with soil or standing water. Provide drainage away from fixture. Install a barrier to isolate fixture and provide a trim edge for landscaping.

*"X" = required depth of conduit per local code.

Fixture installed in concrete. Fixture installed in rock.

VISTA PROFESSIONAL OUTDOOR LIGHTING

Model:
Project:

SPECIFICATION SHEET

MODEL 1043 Architectural Series • Up & Accent

FIXTURE SPECIFICATIONS:

DOOR: Die-cast, zinc copper coated, A300 aluminum offers maximum corrosion protection. Stainless steel hardware fitted to a monolithic rigid polycarbonate door. Door is designed to shed water from the lens surface. Also available as an accessory in a die-cast medium shield CE.

HOUSING: Die-cast A300 aluminum. Optic and driver compartment separately sealed and being electrically connected. Housing gasketing achieved via a Viste patented Infinity Knuckle (see MOUNTING).

FINISH: Double powder coat finish available in Black, Architectural Bronze, Dark Bronze, Green, Silver, Architectural Black, Light Bronze, Special Bronze, Shiny Gray, Rust, Horizon Green, Weathered Bronze, Weathered Iron, Graphite Metallic, Venic Green, Venic Bronze, Venic and Old Finish. Custom Powder coat finishes available on request.

LED: Clear MT-G2 High Density Array (HDA) driven at 500mA, 700mA, 1000mA, 1200mA, 1600mA, or 1750mA.

COLOR TEMPERATURE: LED's are offered in 2700K, 3000K, 3500K, 4000K, or 5000K CCT (AHS unless 4-wire, Cree® Easy View™ lens).

LIGHT DISTRIBUTION: Very Narrow Spot VNS (1.5° FWHM), Narrow Spot NS (1.5° FWHM), Medium Flood MF (30° FWHM), and Wide Flood WF (45° FWHM).

REFLECTOR: High quality vacuum metallized, specular or semi-specular optics designed for maximum performance and uniformity. Very Narrow Spot VNS optic incorporates an internal louver shield to eliminate unwanted glare outside the beam pattern.

LENS/SEAL: 2.7 mm thick tempered and washed clear glass sealed with a closed cell modulated silicone gasket.

WIRING: Insulated with 180° Crated wire.

DRIVER: Inverter CUL based LED driver. Non-dimmable (ND), dimming driver available in 0-10V (0/10), TRIAC dimming (0/0V input only) (0/1) or ELV dimming (1/1).

ACCESSORIES: Barn Doors BD, Full Shield FS, and Half Shield HS available. Accessories are attached to the pre-wiring wire, located on the underside of the fixture door providing for a better free appearance.

MOUNTING: Infinity Knuckle - Die-cast, copper free aluminum, stainless steel stem with 1/2" NPT thread. Fully sealed spherical grommet allows infinite adjustment capabilities.

CERTIFICATION: U.S. & CUL wet location certified. IP65.

All Viste luminaires are MADE IN THE U.S.A.

DIMENSIONS:

CONSTRUCTION NOTES

1. DECEMPOSED GRANITE SHALL BE "PACIFIC GOLD," SIZE SHALL BE 1/4" TO DUST. ADD BINDER PER MANUFACTURER SPECIFICATION. INSTALL TO ACHIEVE A.D.A. COMPLIANT SURFACE.
2. CONCRETE PAVING SHALL BE MEDIUM BROOM FINISH WITH BROOM TEXTURE PERPENDICULAR TO FLOW OF TRAFFIC. CONCRETE SHALL INCLUDE INTEGRAL "SAN DIEGO BUFF" COLOR PER MANUFACTURER'S SPECIFICATION.

VISTA PROFESSIONAL OUTDOOR LIGHTING

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PRODUCTS | TECHNICAL DATA | COMPANY

PRODUCTS • SPECIALTY LIGHTS • 2522-CSN

Support Material

2522 Specification Sheet	<p>2522-CSN</p> <p>Boasting precision-engineered features and rugged construction, the 2522-CSN wall sconce features twin 20-watt MR16 lamps for simultaneous uplighting and downlighting. The copper housing is fitted with CNC-machined solid brass end covers with integrated dual o-rings, which protects it from the elements and hold the standard convex soda glass lenses. The lamp holding mechanism is suspended within each end cover. This design allows for easy access for relamping. The 2522-CSN is shipped with a standard 20V MR16 lamp, unless otherwise specified and is available in natural brass, stainless steel, and powder-coated aluminum.</p>
Photometric Guide	
2522 Installation Instructions	
Catalog Page	
Download Hi-Res Image	

Lamp Type: MR-16, LED
Max Wattage: 20W
Material: Copper

BRIAN POWELL & ASSOCIATES

10 H Street
San Rafael, CA 94901
415.491.4480 telephone, 415.602-0511 cell
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brian@brianpowelldesign.com

Consultant	
Architect:	
Structural Engineer	
Civil Engineer	
Electrical Engineer	
Other	
Drawn by	
Checked by	
Revisions	
Number Description	Date
Client	

BASIN STREET PROPERTIES

Project
HOME 2 SUITES

Sheet Title
LAYOUT AND LIGHTING PLAN

Job Number
21803
Date
FEBRUARY 22, 2019

Scale
1" = 20'-0"
Sheet Number
L1

Consultant

Architect:

Structural Engineer

Civil Engineer

Electrical Engineer

Other

Drawn by

Checked by

Revisions

Number	Description	Date

Client

**BASIN STREET
PROPERTIES**

Project
HOME 2 SUITES

Sheet Title

**LANDSCAPE
CONSTRUCTION
DETAILS**



Job Number
21803

Date
FEBRUARY 22, 2019




Scale
SEE DETAILS

Sheet Number

L2

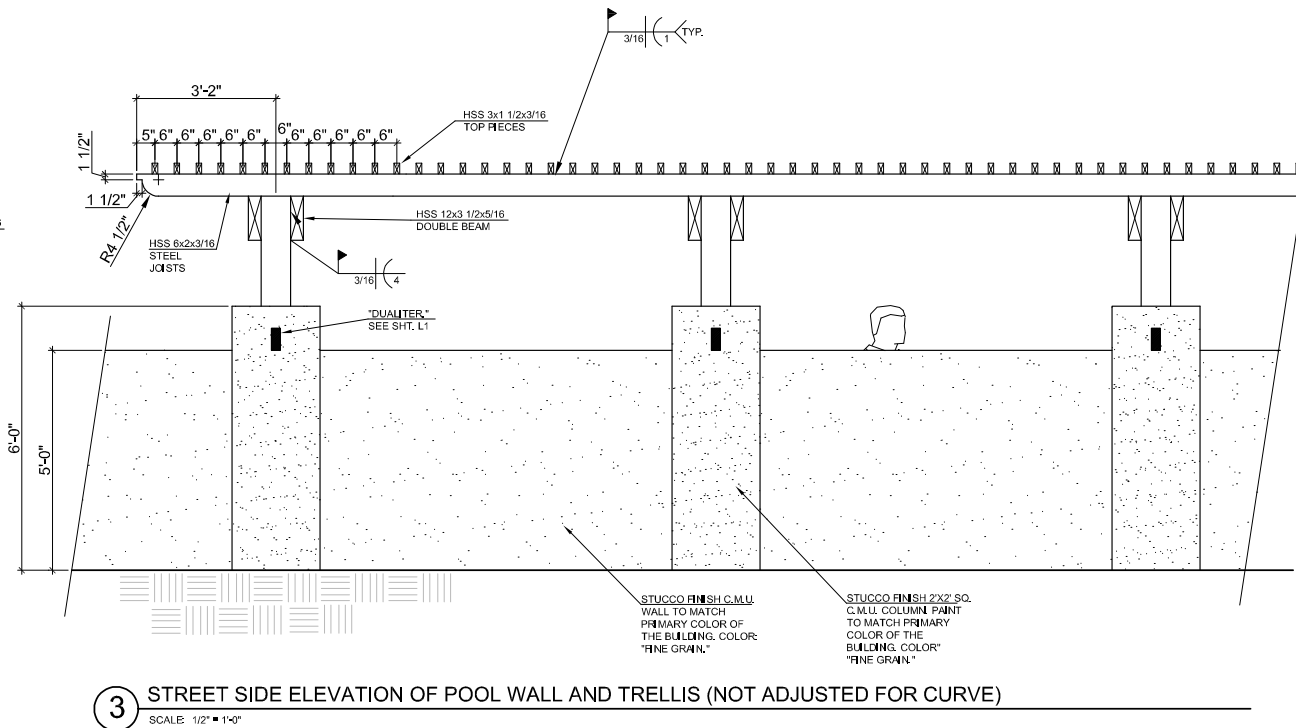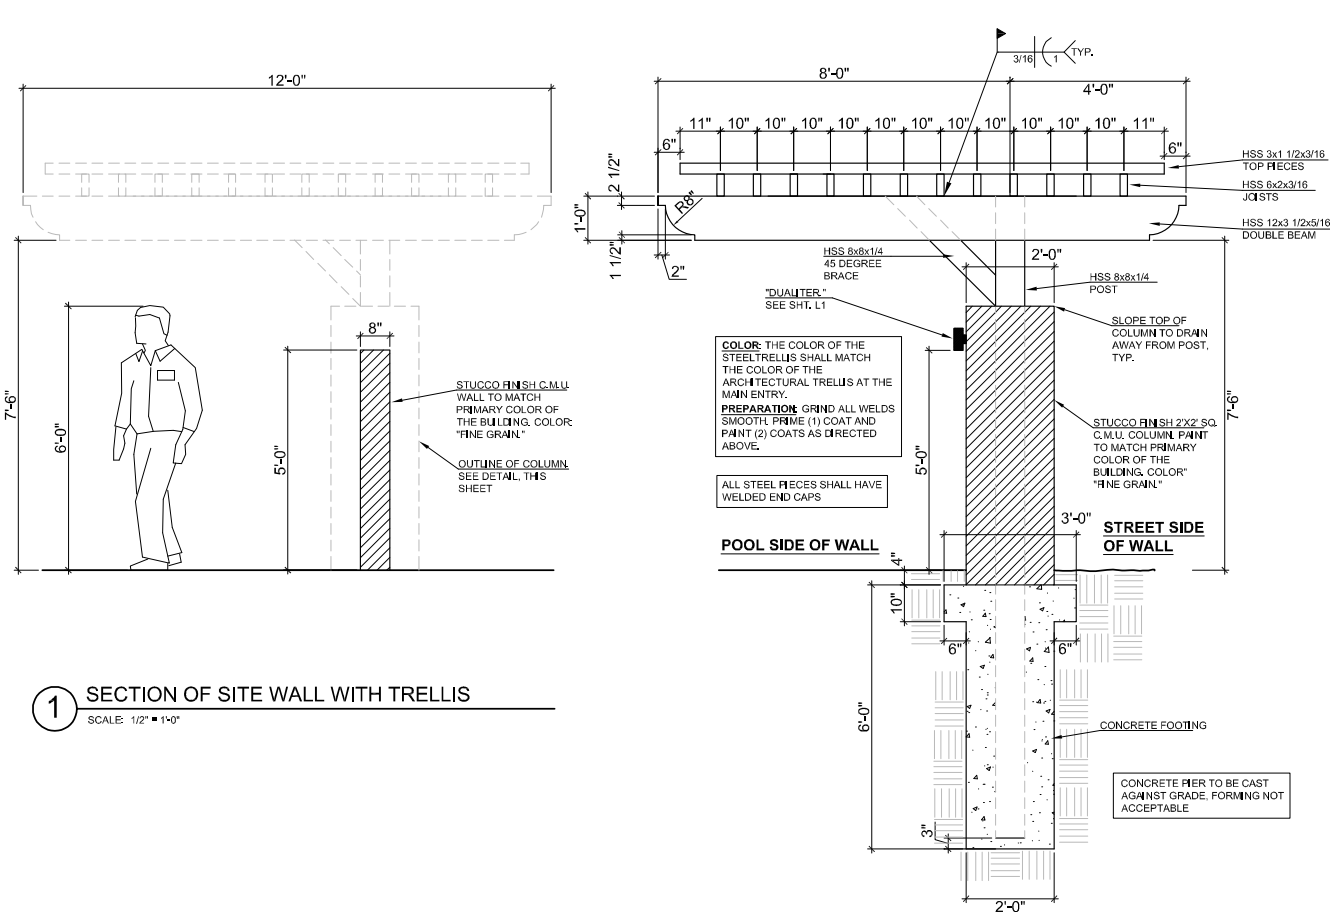

2 STEEL TRELLIS SECTION AT PERIMETER STUCCO WALL
SCALE: 1/2" = 1'-0"

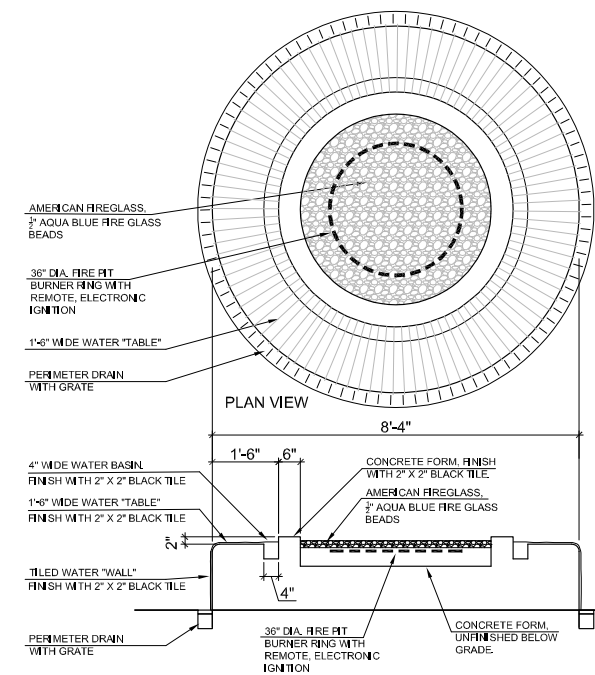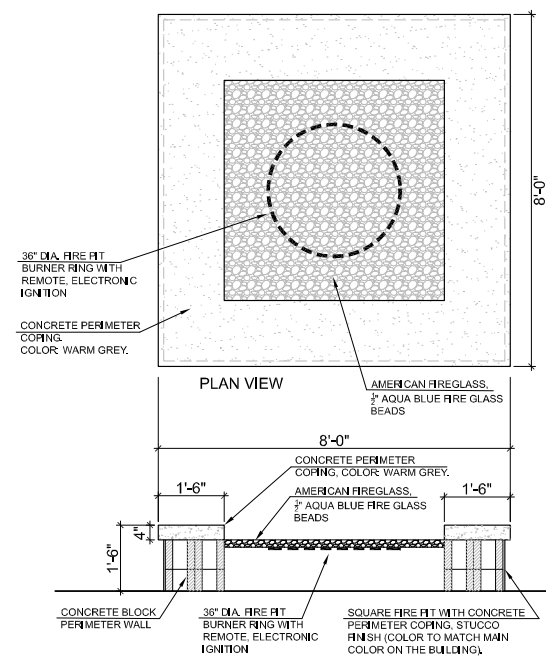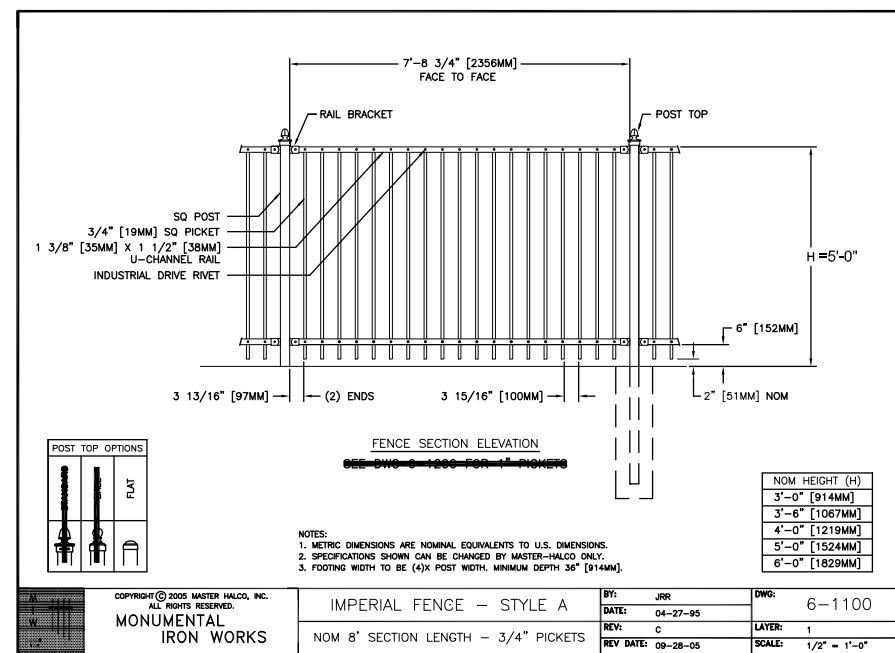


4 POOL FENCING AND GATE DESIGN
SCALE: NO SCALE

5 SECTION AND PLAN VIEW OF FIRE PIT
SCALE: 1/2" = 1'-0"


6 SECTION AND PLAN VIEW OF FOUNTAIN / FIRE PIT
SCALE: 1/2" = 1'-0"



CODE	BOTANICAL NAME	COMMON NAME	SIZE	REMARKS	WUCOLS	HEIGHT & WIDTH	QUANTITIES
TREES							
COT COG	COTINUS COGOCYGRIA	Smoke Tree	24" box	1" cal., symm., 8h x 3w	Low	25' high x 15'-25' wide	11
LAG TUS	LAGERSTROEMIA INDICA 'TUSCARORA'	Tuscarora Crepe Myrtle	24" box	1.25" cal., symm., 10h x 3w	Low	25' high x 15'-25' wide	11
OLE SWA	OLEA EUROPAEA SWAN HILL'	Swan Hill Olive	24" box	1" cal., symm., 3w x 4h	Low	12' high x 15' wide	1
PRU CAR	PRUNUS CAROLINIANA	Carolina Cherry	24" box	1.25" cal., symm., 10h x 3w	Low	25' high x 20' wide	4
RHU LAN	RHUS LANCEA	Albizia Sumac	24" box	1.25" cal., symm., 10h x 3w	Low	25' high x 15'-25' wide	10
SHRUBS							
ARC HOW	ARCTOSTAPHYLOS HOWARD McMINN'	Howard McMinn Manzanita	5 gallon		Low	4' x 5'	35
ART POW	ARTEMISIA POWIS CASTLE'	No Common Name	5 gallon		Low	3' x 5'	5
CAL LIT	CALLISTEMON VINALIS LITTLE JOHN'	Little John Bottlebrush	5 gallon		Low	3' x 4'	76
CEA DAR	CEANOETHUS DARK STAR'	Dark Star Ceanothus	5 gallon		Low	3' x 8'	20
CIS SUN	CISTUS SUNSET	Sunset Rockrose	5 gallon		Low	3' x 3'	21
LOR CHI	LOROPETALUM CHINENSERAZZLEBERG'	Razzerpetal Loropetalum	5 gallon		Low	4' x 8'	16
MAH REP	MAHONIA REPENS	Chinese Mahonia	5 gallon		Low	3' x 3'	26
NAN DOM	NANDINA DOMESTICA	Heavenly Bamboo	5 gallon		Low	3' x 3'	61
OLE LIL	OLEA EUROPAEA LITTLE OLLIE'	Little Olive Olive	5 gallon	Prune to ht. as needed	Low	4' x 4'	67
PIT WHE	PITOSPORUM TOBIRA 'WHEELERS DWARF'	Wheeler's Dwarf Tobira	5 gallon		Low	3' x 5'	65
RHA BAL	RHAPHOLEPIS INDICA BALLERINA'	Ballarina Indian Hawthorne	5 gallon		Low	2' x 4'	15
SAL LEU	SALVIA LEUCANTHA	Mexican Sage	5 gallon		Low	3' 6" x 3' 6"	22
SAR RUS	SARCOCOCOA RUBROFOLIA	Sweet Sarcococca	5 gallon		Low	3' 6" x 3' 6"	16
TEU CHA	TEUCLIDUM CHAMAEDRY'S	Dwarf Bush Germander	5 gallon		Low	4' 6" x 4' 6"	76
XYL COM	XLOSMA CONGESTUM 'COMPACTA'		5 gallon		Low	4' 6" x 4' 6"	56
GROUNDCOVERS							
CAR PRA	CAREX PRAECORCLLUS	California Meadow Sedge	Plugs	Plug size: 1.5" x 1.5" x 2.5"	Low	1.5" x 2.5"	2,705
CAR TUM	CAREX TUMIDA/OLIA	Berkley Sedge	Plugs	Plug size: 1.5" x 1.5" x 2.5"	Low	1" x 2"	1,760
COP KR	COPROSMA KIKI'	Tailing Coprosma	5 gallon		Low	7' x 2'	1
COR CAR	CORREA 'CARMINE BELLS'	No Common Name	5 gallon		Low	1' 6" x 4' 0"	60
IRI HYB	IRIS DOUGLASSIANA	Douglas Iris	1 gallon	1' 6" o.c.	Low	1' 6" x 1' 6"	70
JUN WIL	JUNIPERUS HORIZONTALIS 'WILTON'	Blue Carpet Juniper	5 gallon	3' 6" o.c.	Low	1' 6" x 1' 6"	201
LAN PUR	LANTANA MONTEJOSISS	Purple Lantana	5 gallon		Low	1.5' x 4'	8
LAN NEW	LANTANA NEW GOLD'	New Gold Lantana	5 gallon		Low	1.5' x 4'	27
NAN HAR	NANDINA DOMESTICA 'HARBOR DWARF'	Harbor Dwarf Heavenly Bamboo	2 gallon		Low	2' x 2'	140
NEP FAA	NEPETA FAASSENI	Catmint	1 gallon		Low	2' x 2'	11
ROS OFF	ROSMARIANUS OFFICINALIS 'HUNTINGTON BLUE'	Huntington Blue Rosemary	5 gallon	3'-0" o.c.	Low	2.5' x 4'	1
SAR HOO	SARCOCOCOA 'HOOKERIANA HUMILIS	Sweet Box ground cover	5 gallon	3'-0" o.c.	Low	1' 0" x 4' 0"	12
VINES							
GEL SEM	GELSEMIUM SEMPERVIRENS	Carolina Jasmine	5 gallon		Low		4
PAR TR	PARTHENOCISSUS TROUSPIDATA	Boston Ivy	5 gallon		Low		1

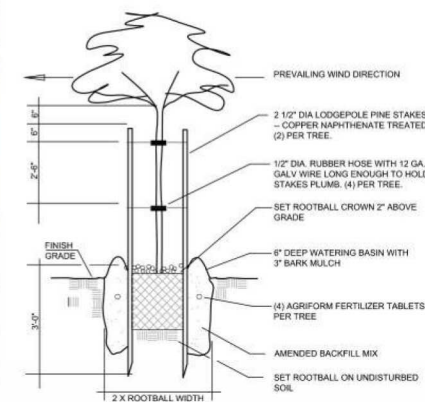

TREE PLANTING DETAIL

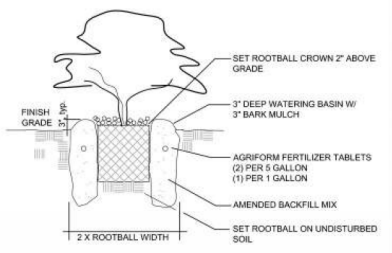

SHRUB PLANTING DETAIL

PLANTING NOTES

- LANDSCAPE ARCHITECT SHALL APPROVE THE QUALITY AND LOCATIONS OF ALL PLANT MATERIALS PRIOR TO INSTALLATION.
- ALL PLANT MATERIALS SHALL BE HEALTHY, WELL-SHAPED, VIGOROUS AND UNDAMAGED.
- BEFORE PLANTING BEGINS, THE CONTRACTOR SHALL TAKE A SOIL SAMPLE FROM TWO (2) REPRESENTATIVE, FINISH-GRADED SAMPLING AREAS AND SEND THEM TO WAYPOINT ANALYTICAL, INC. FOR A HORTICULTURAL SUITABILITY TEST ON THE SOIL. EACH SOIL SAMPLE SHALL CONSIST OF SIX TO TEN SHOVEL/SPADE DIGGINGS TAKEN TO A 6"-8" DEPTH. DIGGINGS FROM EACH SAMPLING AREA SHALL BE MIXED SEPARATELY AND THOROUGHLY IN A CLEAN BUCKET. TAKE TWO CUPS FROM EACH BUCKET, PLACE IN A ZIP LOCK PLASTIC BAG AND LABEL CAREFULLY. SEND PLASTIC BAGS TO:

WAYPOINT ANALYTICAL, INC.
1101 SOUTH WINCHESTER BLVD., SUITE G 173
SAN JOSE, CA 95128
PHONE: 408-727-0330
- FOLLOW LABELING DIRECTIONS AS DESCRIBED ON THE WAYPOINT ANALYTICAL, INC. WEBSITE.
- REVIEW SAMPLING AREAS WITH LANDSCAPE ARCHITECT PRIOR TO TAKING THE SAMPLE DIGGINGS.
- IF SOIL TESTS PRODUCE HIGH READINGS FOR SOIL SALINITY, ALKALINITY, WET SOILS OR HEAVY CLAY SOILS, PLANT SUBSTITUTIONS MAY BE REQUIRED.
- FORWARD RESULTS OF SOILS TEST(S) TO LANDSCAPE ARCHITECT IMMEDIATELY.
- CLEARING AND GRUBBING: THE CONTRACTOR SHALL CLEAR ALL UNWANTED, MATURE SHRUBS AND TREES BY CUTTING THE PLANTS TO GRADE AND REMOVING THE STUMPS WITH A GRINDER. FOR THE REMAINING UNWANTED GRASSES, LAWN, AND MISCELLANEOUS VEGETATION, SEE "PLANT INSTALLATION AND SOIL PREPARATION" SPECIFICATIONS ON THIS SHEET.
- SOIL AMENDMENT: "ALL GREEN COMPOST" BY GRAB 'N GROW. PHONE: 707-575-7275.
- PLANT PIT BACKFILL AMENDMENT: PRIOR TO PLANT INSTALLATION, THE CONTRACTOR SHALL CREATE A BACKFILL MIX BY ADDING THE SOIL AMENDMENT DESCRIBED ABOVE TO NATIVE SOIL AT THE RATE OF 15% BY VOLUME. INSTALL FERTILIZER "AGRIFORM" TABLETS AT EACH PLANT PIT BASED ON MANUFACTURER'S SPECIFICATIONS: (1) FOR ONE GALLON, (3) FOR FIVE GALLON, (9) FOR 15 GALLON, ETC.
- DRAINAGE TEST: IN ORDER TO INSURE PROPER DRAINAGE FOR ORNAMENTAL GRASSES, SEDGES AND GROUND COVER PLANT HOLES, THE CONTRACTOR SHALL PERFORM THE FOLLOWING PROCEDURE:
 - EXCAVATE ONE (1) PLANT PIT FOR EACH PLANT SIZE IN REPRESENTATIVE AREA OF THE SITE. TEST PITS SHALL THEN BE FILLED WITH WATER AND ALLOWED TO DRAIN IN A 24 HOUR PERIOD. IF STANDING WATER OCCURS AT ANY PLANT PIT, THE CONTRACTOR SHALL OVEREXCAVATE THE HOLES AND REPEAT THE WATER TEST UNTIL THE PIT DRAINS IN A 24 HOUR PERIOD. THE SIZE OF THE FINAL TEST PITS SHALL BE THE STANDARD FOR ALL PLANT PITS MENTIONED ABOVE.
 - FOR SHRUB AND TREE PITS, CONDUCT THE DRAINAGE TEST DESCRIBED ABOVE. IF THE SHRUB AND TREE PITS FAIL THE DRAINAGE TEST, THE CONTRACTOR SHALL AT A MINIMUM REPEAT THE DRAINAGE TEST DESCRIBED ABOVE AND SHALL CONTACT THE LANDSCAPE ARCHITECT IMMEDIATELY. DRAINAGE LINES FROM EACH PLANT PIT MAY BE REQUIRED.
- MULCH: APPLY THREE (3) INCHES OF "ARBOR MULCH" FROM GRAB 'N GROW, SANTA ROSA, (707-575-7275) TO ALL SHRUB AND GROUND COVER PLANTING BEDS AS STATED IN THE SPECIFICATION "PLANT INSTALLATION AND SOIL AMENDMENT" ON THIS SHEET. SUBMIT SAMPLE OF MULCH TO LANDSCAPE ARCHITECT AND FIRE MARSHAL FOR APPROVAL PRIOR TO INSTALLATION. KEEP MULCH 6"-12" AWAY FROM CROWN OF PLANTS. "MONKEY HAIR" BARK MULCH IS NOT ALLOWED. MULCH SHALL BE DARK IN COLOR.
- MAINTENANCE PERIOD: A NINETY (90) DAY MAINTENANCE PERIOD SHALL BE REQUIRED FOR ALL PLANT AND LANDSCAPE MATERIALS SHOWN IN THIS PLAN. CONTRACTOR SHALL MAINTAIN THE SITE ON A WEEKLY BASIS (MINIMUM), BY PULLING WEEDS, MOWING LAWNS AND CLEARING HARDSAPE OF DEBRIS. REPLACE ALL DEAD OR DYING PLANTS DURING THE MAINTENANCE PERIOD. ALL TREES SHALL BE WARRANTEED FOR 12 MONTHS.
- DEER TEST: THE CONTRACTOR SHALL SUPPLY SAMPLES OF EACH PLANT SPECIFIED HEREIN AND HAVE THEM DELIVERED TO THE SITE ONE MONTH PRIOR TO ORDERING THE BALANCE OF THE PLANT MATERIAL. THE CONTRACTOR SHALL MONITOR DEER INTRUSION ON A DAILY BASIS AND MAKE A REPORT TO THE LANDSCAPE ARCHITECT. IF ANY PLANT SHOWS DAMAGE FROM DEER OR OTHER LOCAL ANIMALS, THAT PLANT SHALL BE REMOVED FROM THE PLANT PALETTE AND A SUBSTITUTE WILL BE SELECTED BY THE LANDSCAPE ARCHITECT. TREES CAN BE TEMPORARILY NETTED OR FENCED IF MINOR DAMAGE OCCURS.
- PRE-CONSTRUCTION MEETING: TWO WEEKS PRIOR TO START OF CONSTRUCTION LANDSCAPE CONTRACTOR SHOULD CONTACT THE OWNER AND LANDSCAPE ARCHITECT TO REQUEST LANDSCAPE PRE-CONSTRUCTION MEETING.
- SLOPE STABILIZATION: THE CONTRACTOR SHALL INSTALL JUTE MESH ON ALL SLOPES THAT ARE 3:1 AND GREATER. INSTALL JUTE MESH WITH LANDSCAPE STAPLES AND PER MANUFACTURER'S SPECIFICATION. ON SLOPES STEEPER THAN 3:1, THE CONTRACTOR SHALL USE STRAW (NOT HAY) IN ADDITION TO THE JUTE MESH. COIR CAN BE USED AS AN ALTERNATIVE TO STRAW AND JUTE MESH.
- PYROPHYTIC PLANTS: NO PYROPHYTIC PLANTS WILL BE ALLOWED WITHIN 50' OF THE BUILDING OR GARAGE.
- EXCAVATION SAFETY: CALL BEFORE YOU DIG-PG&E 811. CONSULT WITH LOCAL SEWER DISTRICT TO CONFIRM THE LOCATION OF ALL LEACH FILED LINES AND LEACH FIELD TANKS PRIOR TO CONSTRUCTION.
- CLIMBING ROSES AT FENCE: TO SUPPORT THE CLIMBING ROSES AT THE PRIVACY FENCES, THE CONTRACTOR SHALL ATTACH THREE (3) ELECTRICAL STAPLES TO THE FENCE ON EACH SIDE OF THE PLANT. THE STAPLES SHALL BE ALIGNED IN A VERTICAL "COLUMN" 1'-6" FROM EACH OTHER. EACH COLUMN SHALL BE 1'-6" FROM THE CENTER OF THE PLANT. ONCE THE STAPLES ARE SECURED, THE CONTRACTOR SHALL RUN "GREEN TAPE" THROUGH THE EYE OF EACH STAPLE AND TIE THE CLOSEST ROSE CANE LOOSELY TO THE FENCE ALLOWING MOVEMENT IN THE CANES. USE ONE GREEN TAPE TIE PER STAPLE. THERE SHALL BE SIX (6) TIES TOTAL PER PLANT.
- TREE PROTECTION: BEFORE ANY EQUIPMENT IS MOVED ON SITE (INCLUDING PICK UP TRUCKS) THE CONTRACTOR SHALL INSTALL TEMPORARY CHAIN FENCING WITH CONCRETE, TEMPORARY, ABOVE GRADE FOOTINGS AROUND ALL TREES TO REMAIN. DURING CONSTRUCTION, THE CONTRACTOR SHALL EMPLOY THE HIGHEST INDUSTRY STANDARDS TO PROTECT ALL EXISTING TREE TRUNKS AND LIMBS FROM DAMAGE AND ALL ROOT ZONES FROM COMPACTION AND EXCESSIVE WATER.
- PLANT QUANTITIES: THE PLANT QUANTITIES SHOWN IN THE PLANT LEGENDS ARE DISPLAYED FOR THE CONVENIENCE OF THE CONTRACTOR ONLY. IF THERE IS A DISCREPANCY BETWEEN THE QUANTITIES SHOWN IN THE LEGEND AND THE QUANTITIES SHOWN ON THE PLAN, THE QUANTITIES ON THE PLAN SHALL PREVAIL.

WATER CONSERVATION STATEMENTS
AS THE LANDSCAPE ARCHITECT ON THIS PROJECT, I AGREE TO COMPLY WITH THE REQUIREMENTS OF THE LANDSCAPE WATER USE EFFICIENCY STANDARDS AND SUBMIT A COMPLETE LANDSCAPE DOCUMENTATION PACKAGE.

I HAVE COMPLIED WITH THE CRITERIA OF THE ORDINANCE AND APPLIED THEM FOR THE EFFICIENT USE OF WATER IN THE LANDSCAPE DESIGN PLAN.
BRIAN W. POWELL, CALIFORNIA RLA #2525

HYDROZONE TABLE

Hydrozone	Valve	Irrigation Method & Coefficient	Area (sq. ft.)	% of Landscape Area
Low		Drip	18,900	100
TOTAL:			18,900	100%

MAWA = 26.65" rain/year X .62 X (.57 X 18,900sf) = 178,000 GALLONS
ETWU (LOW) = 26.65" x .62 X [(3 X 18,900sf) / .85] = 110,220 GALLONS