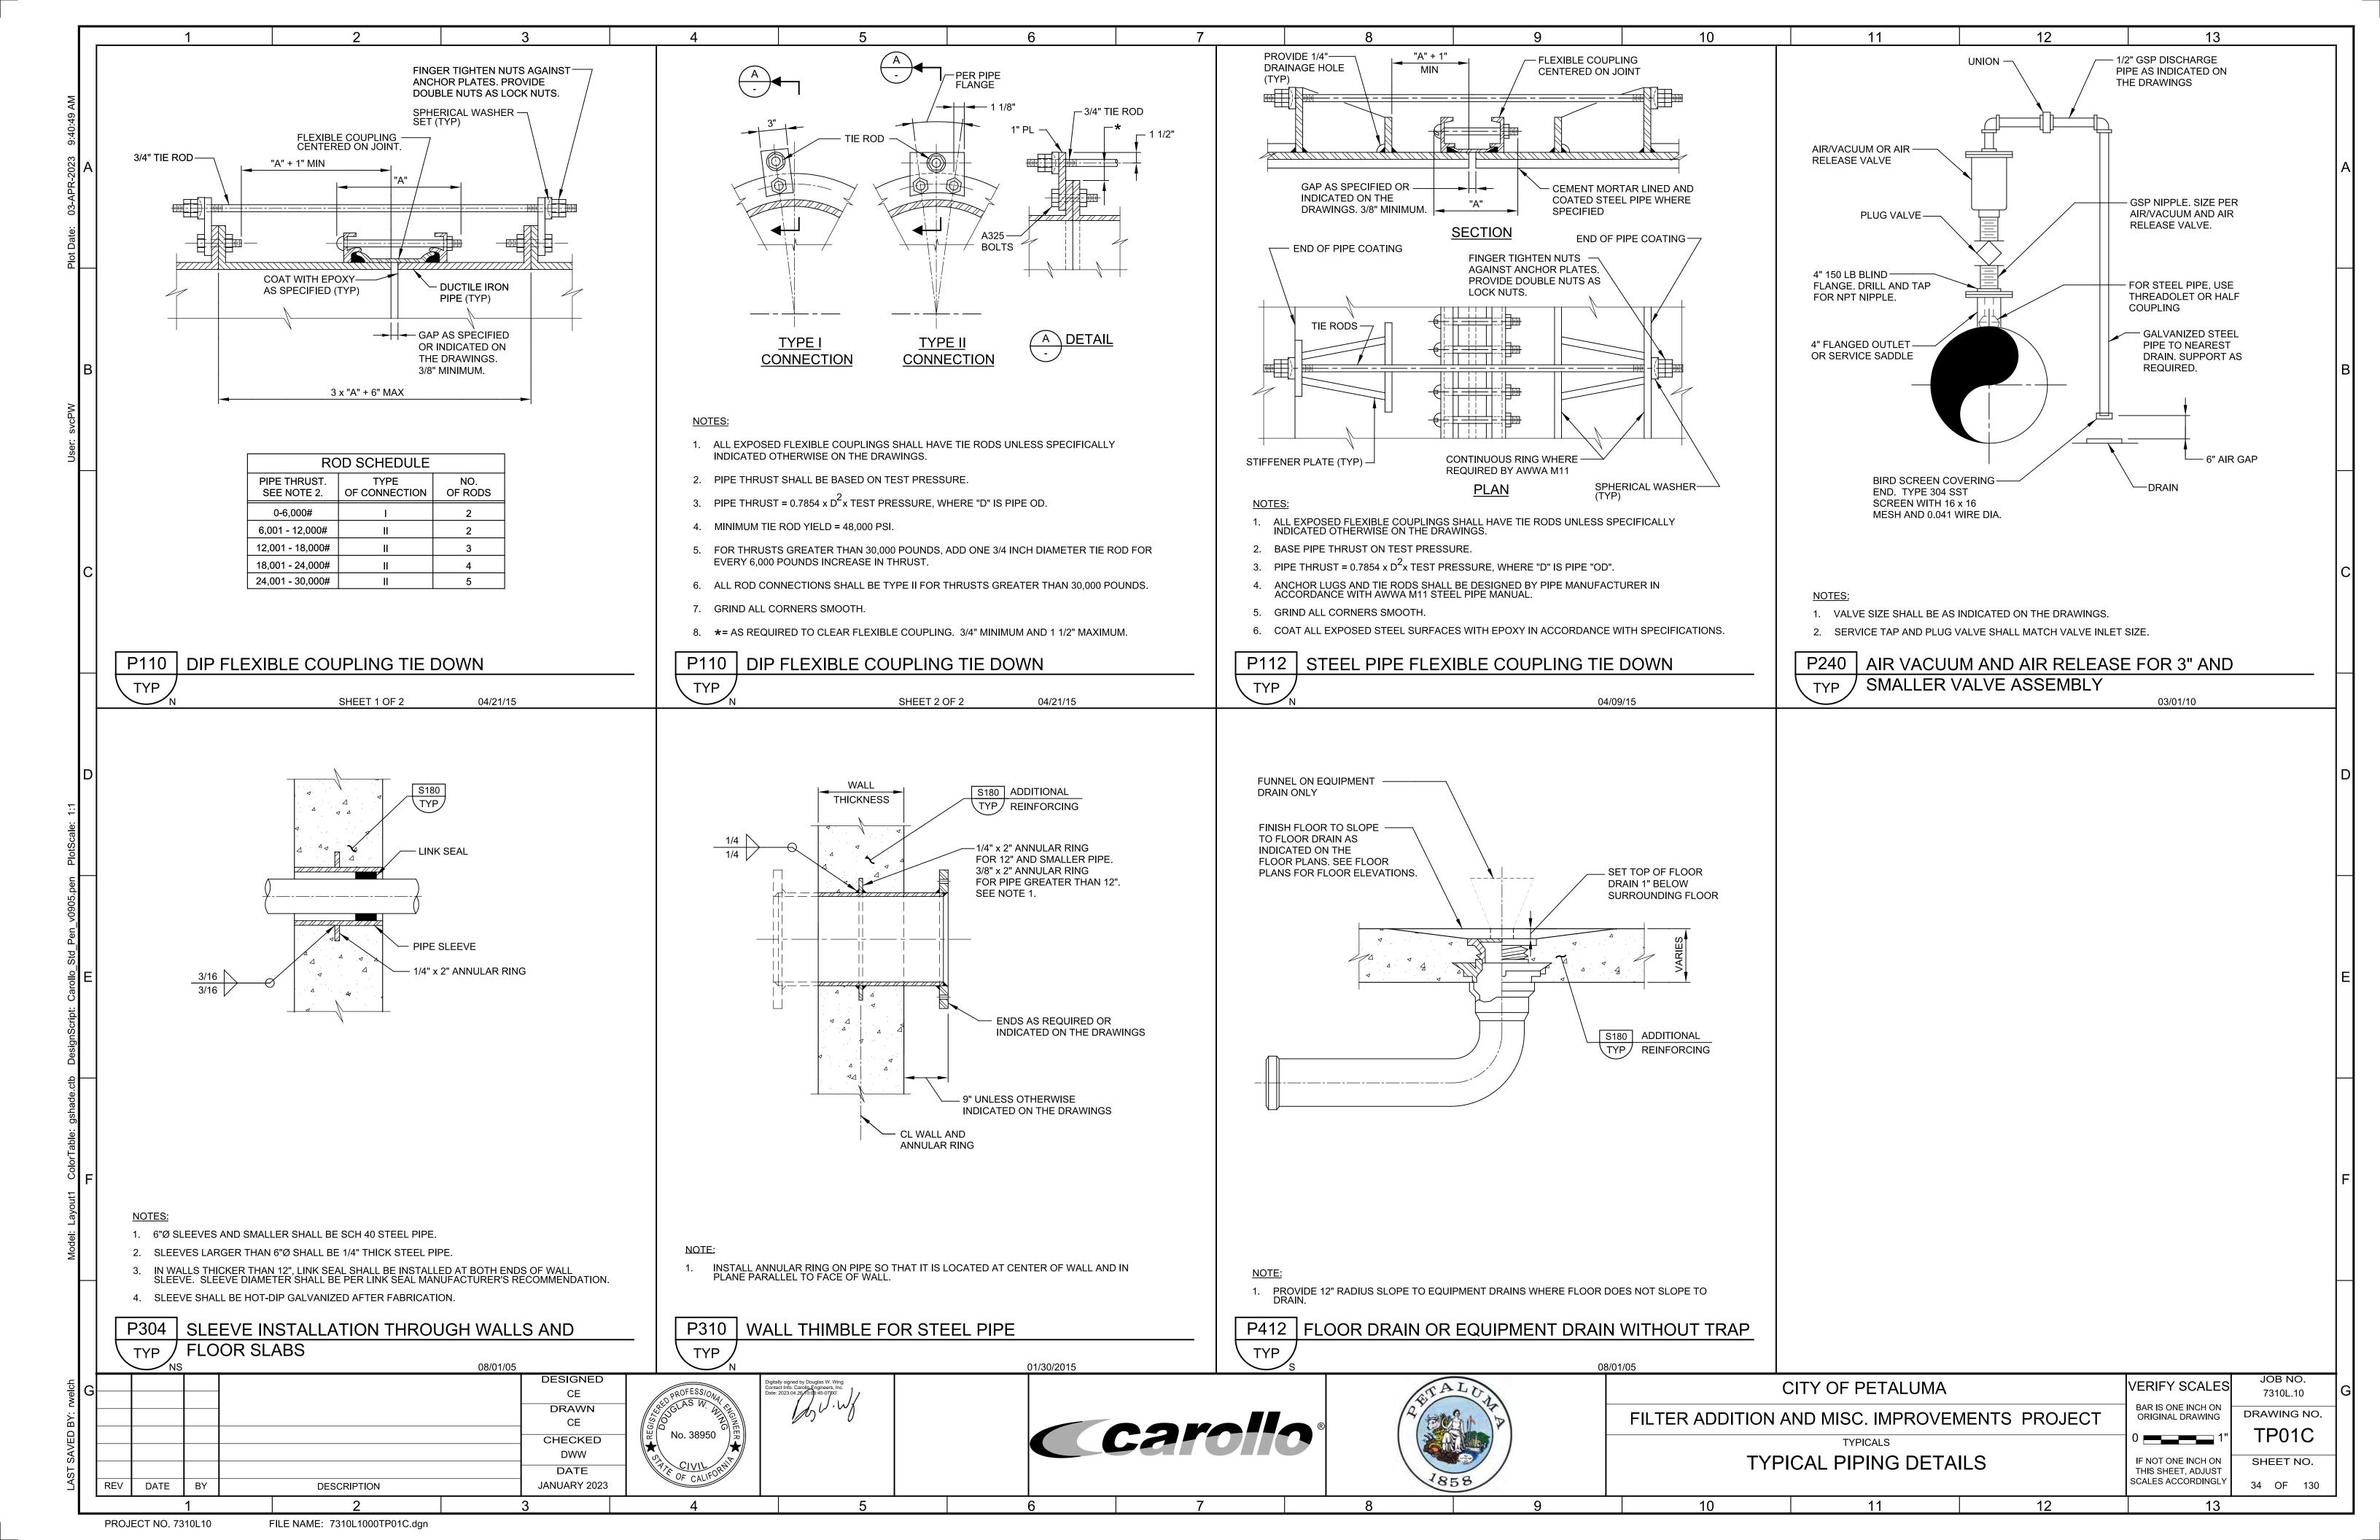
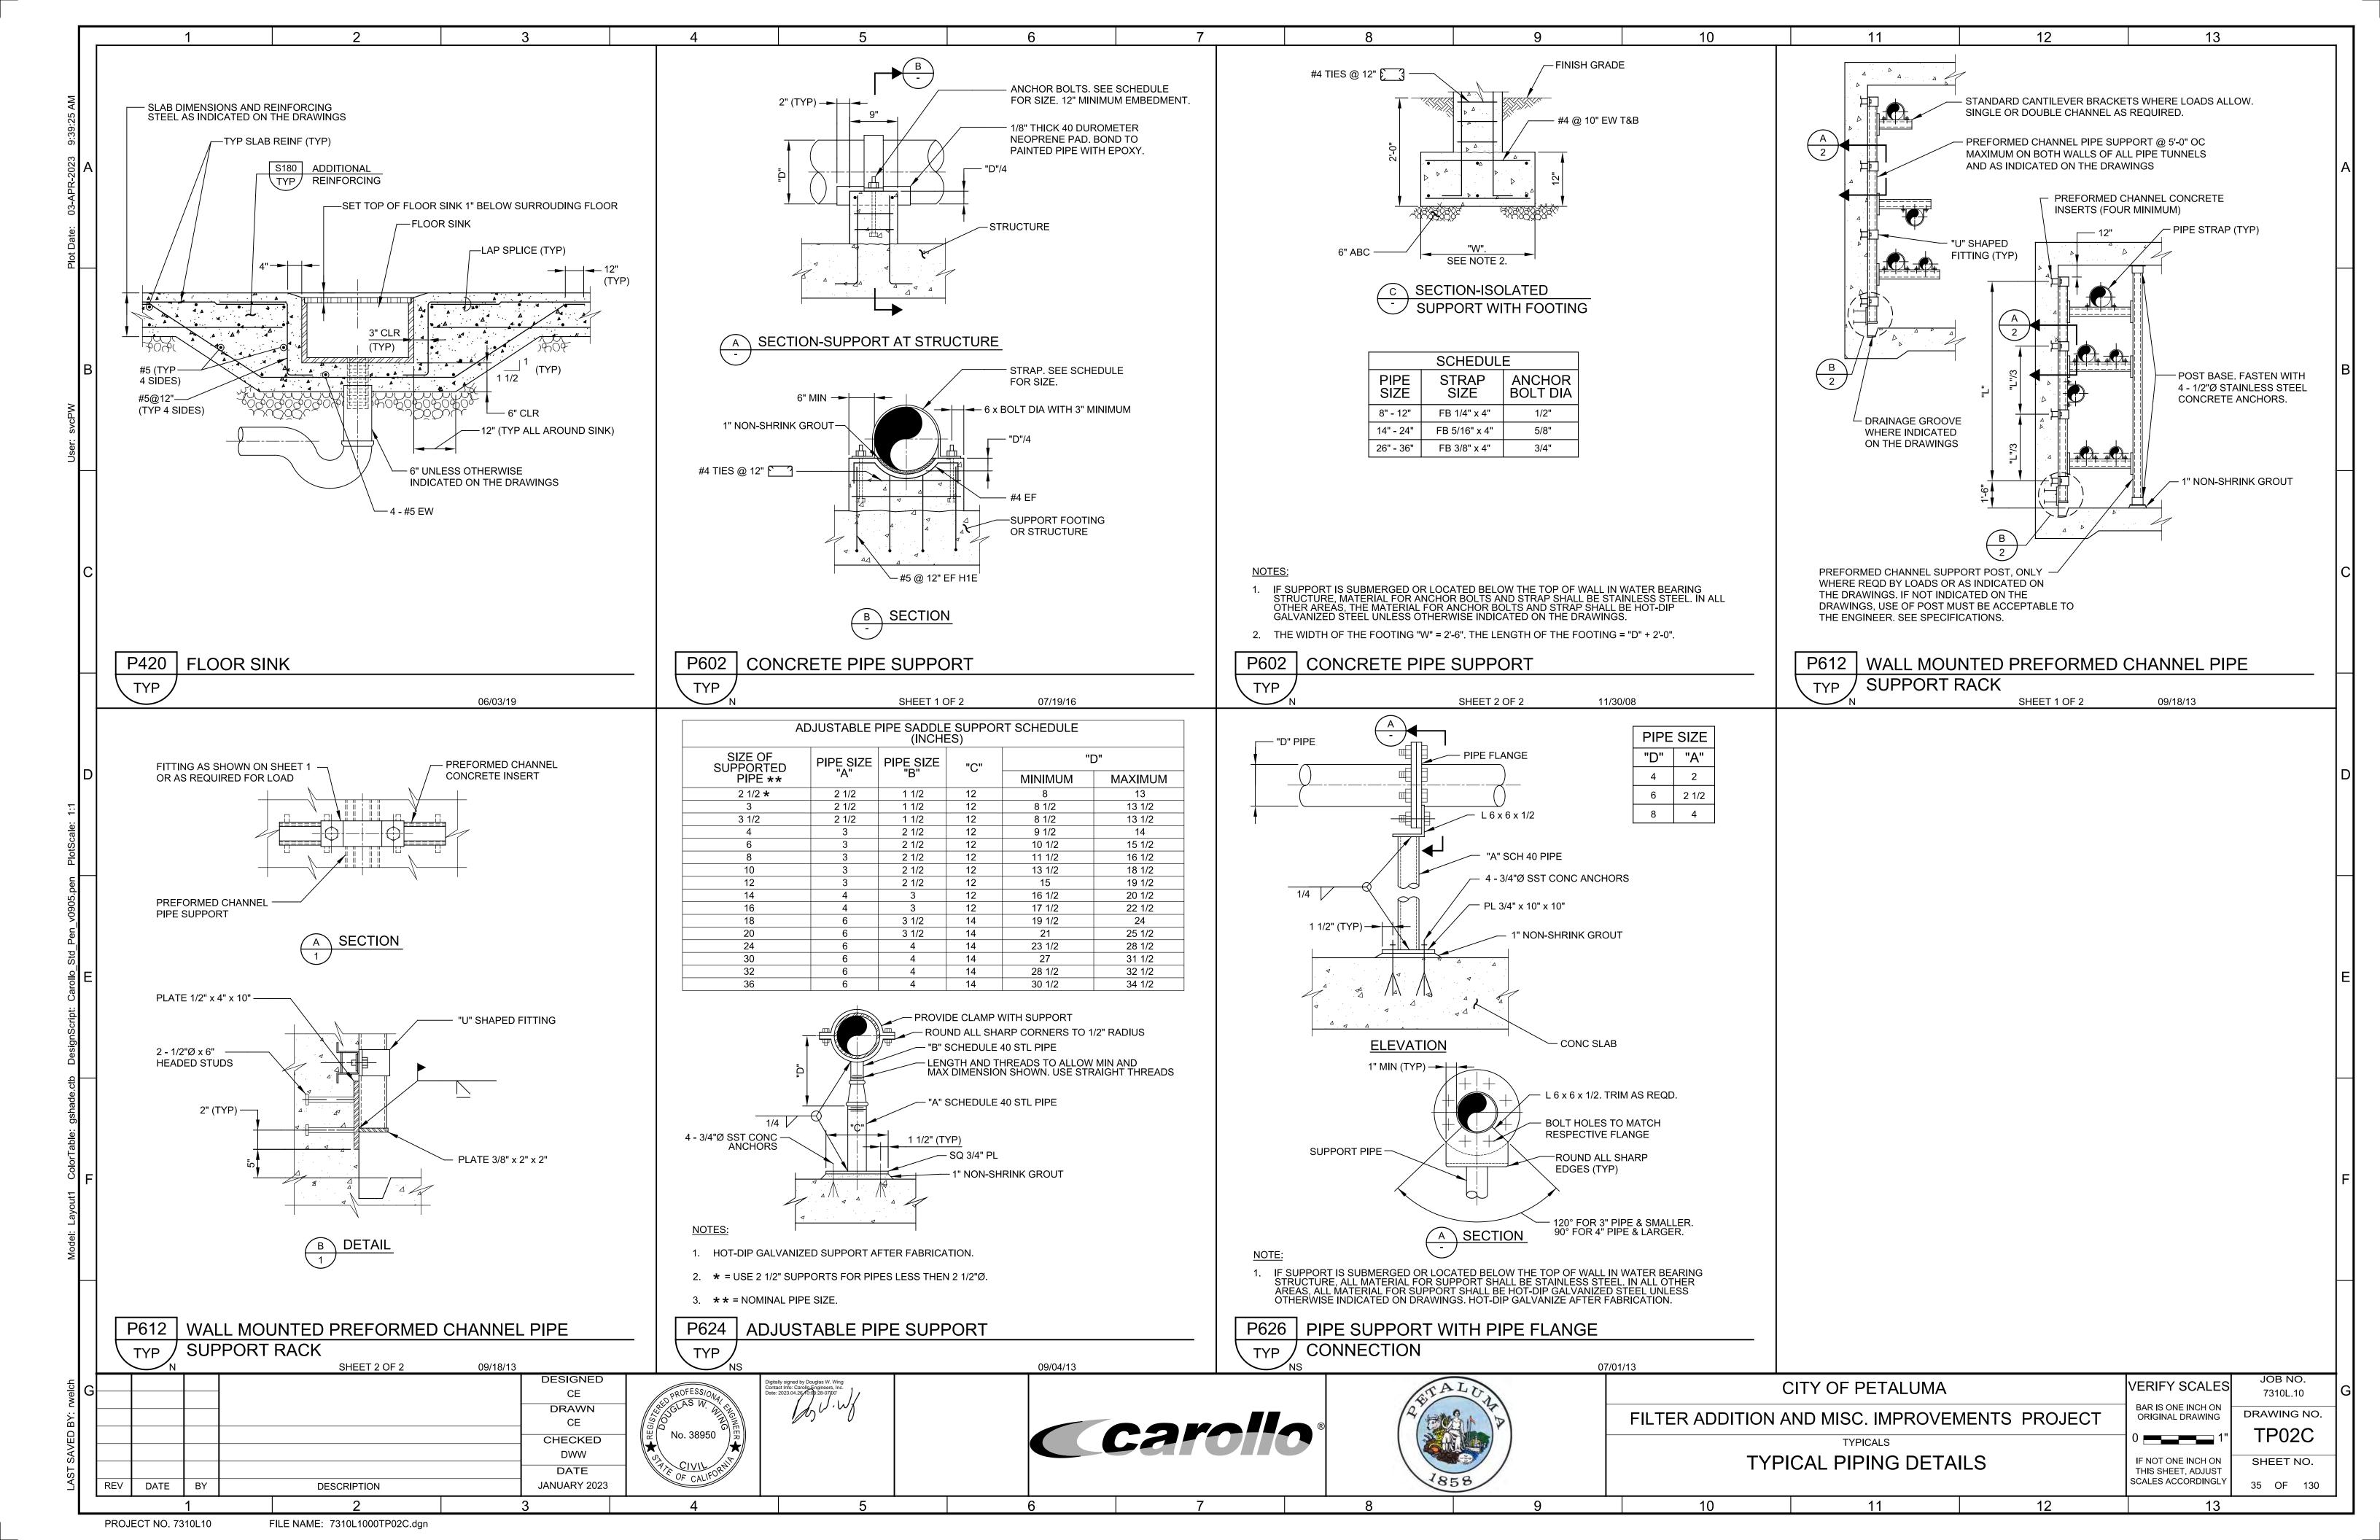
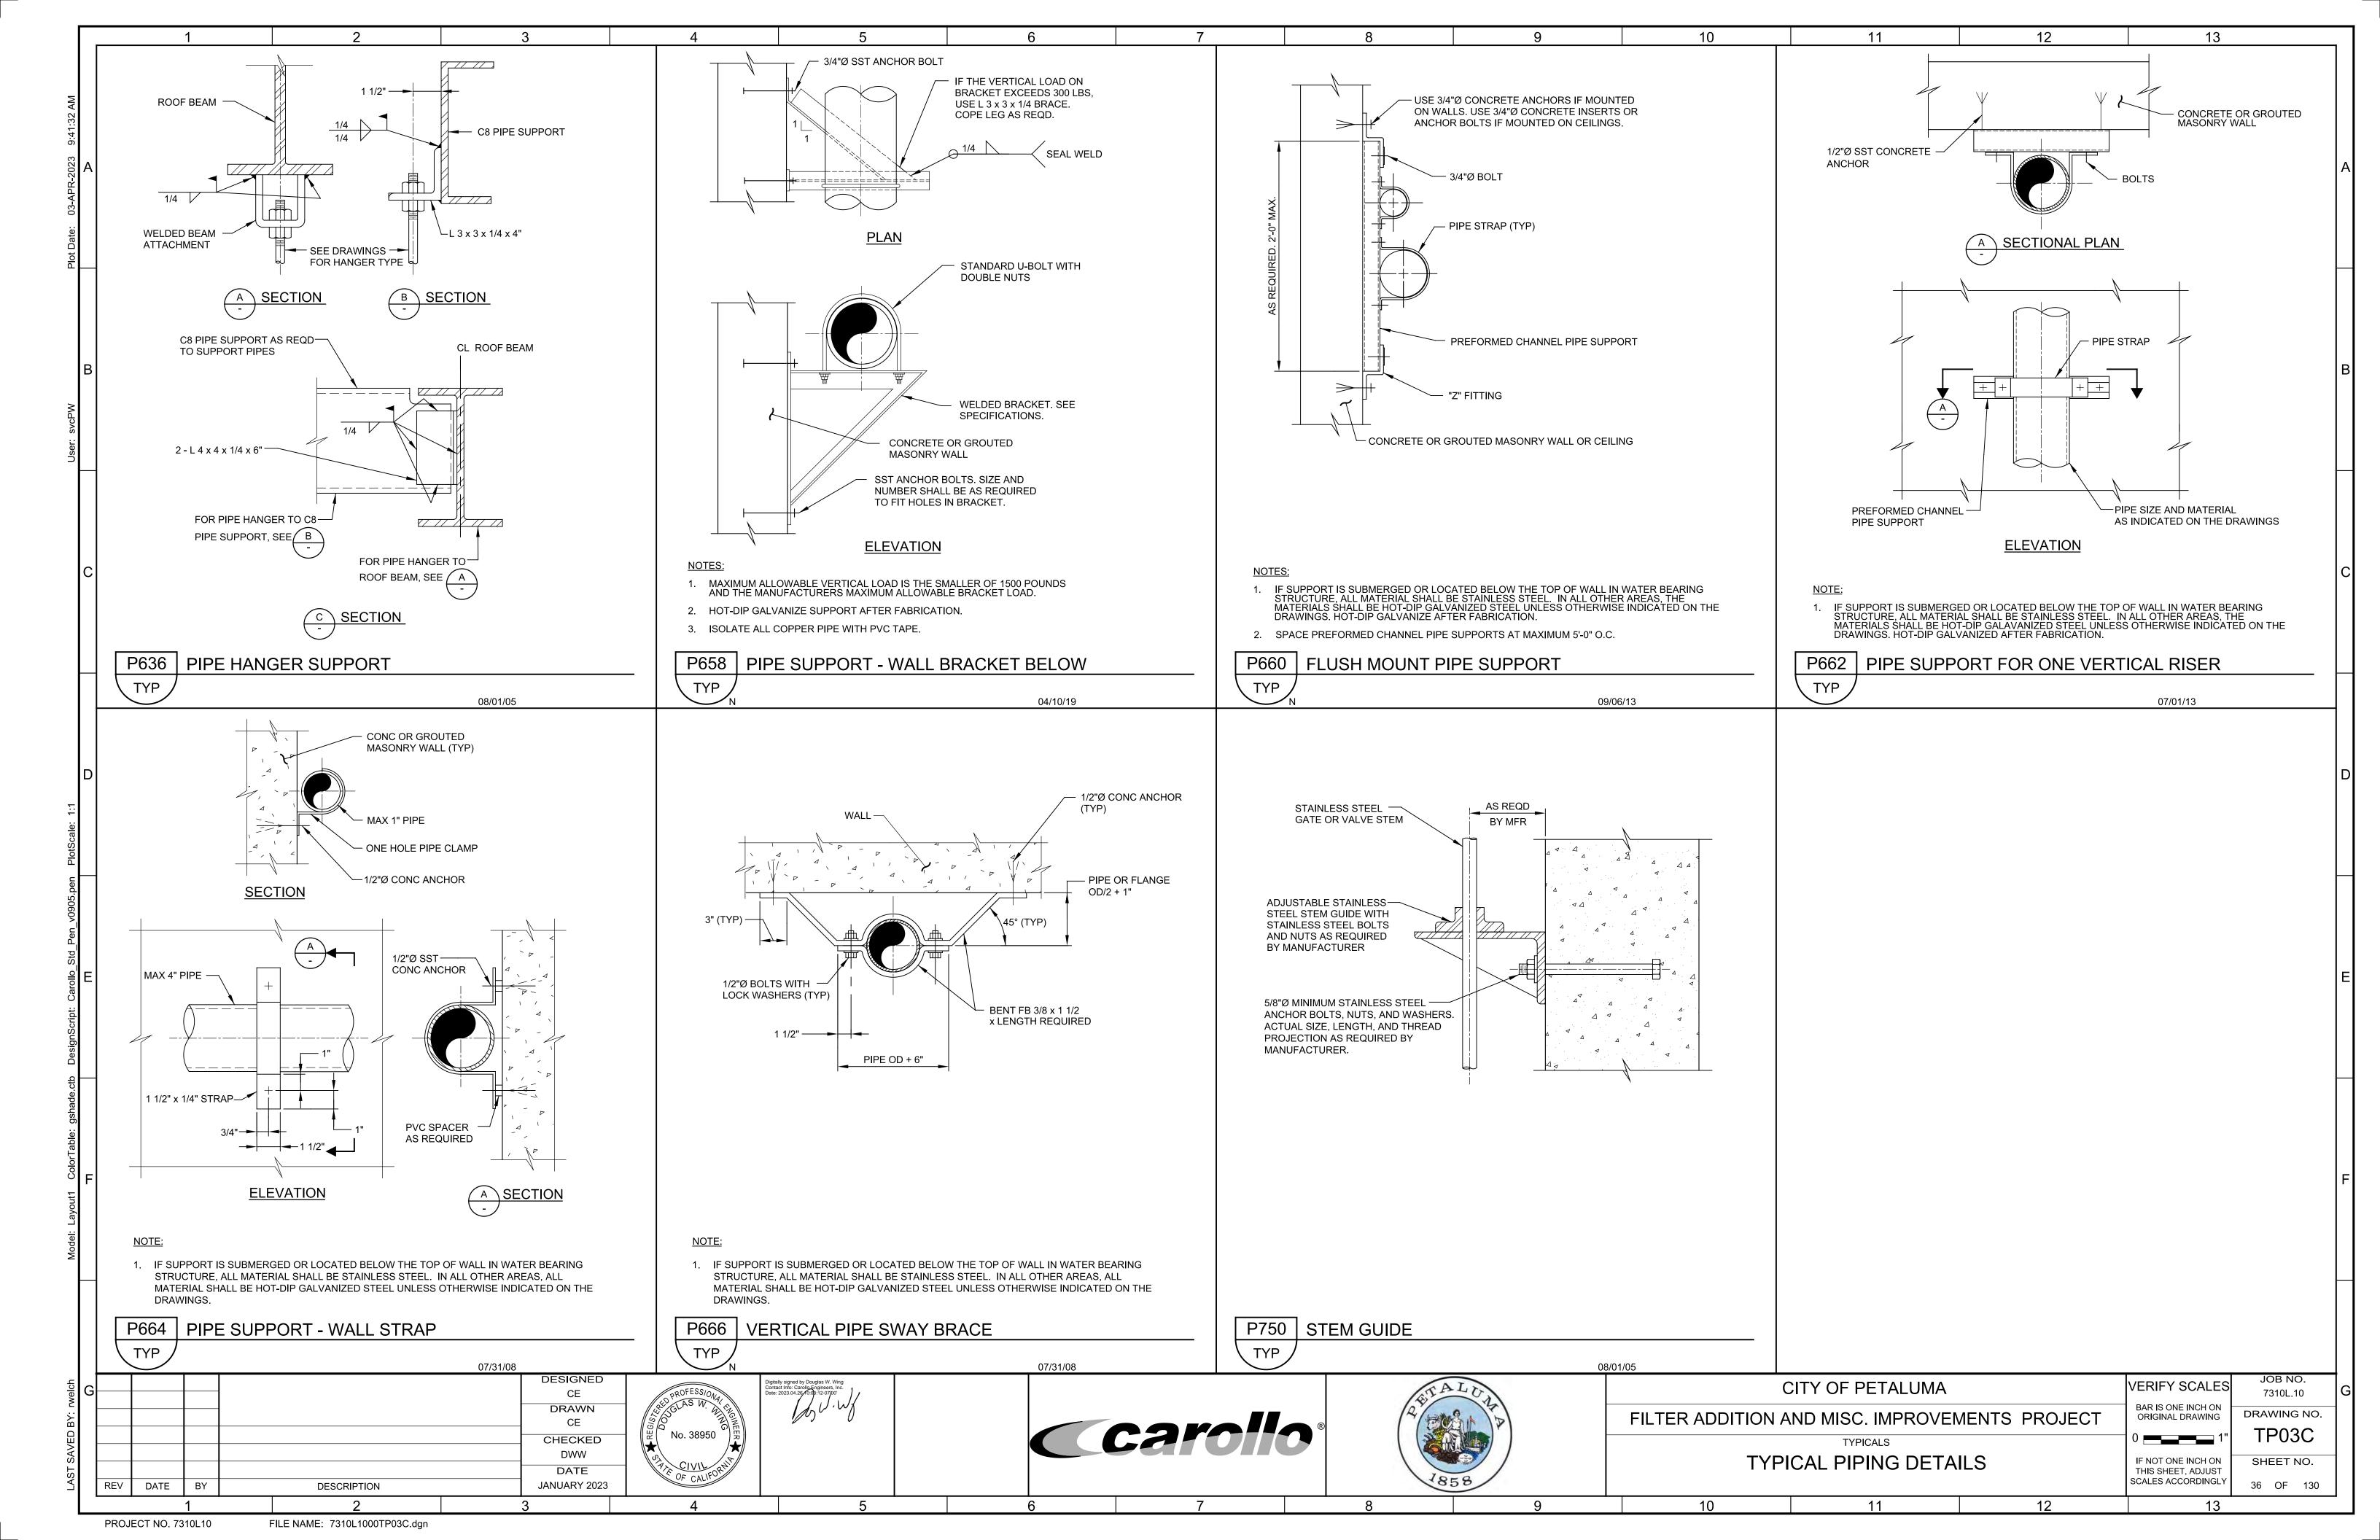
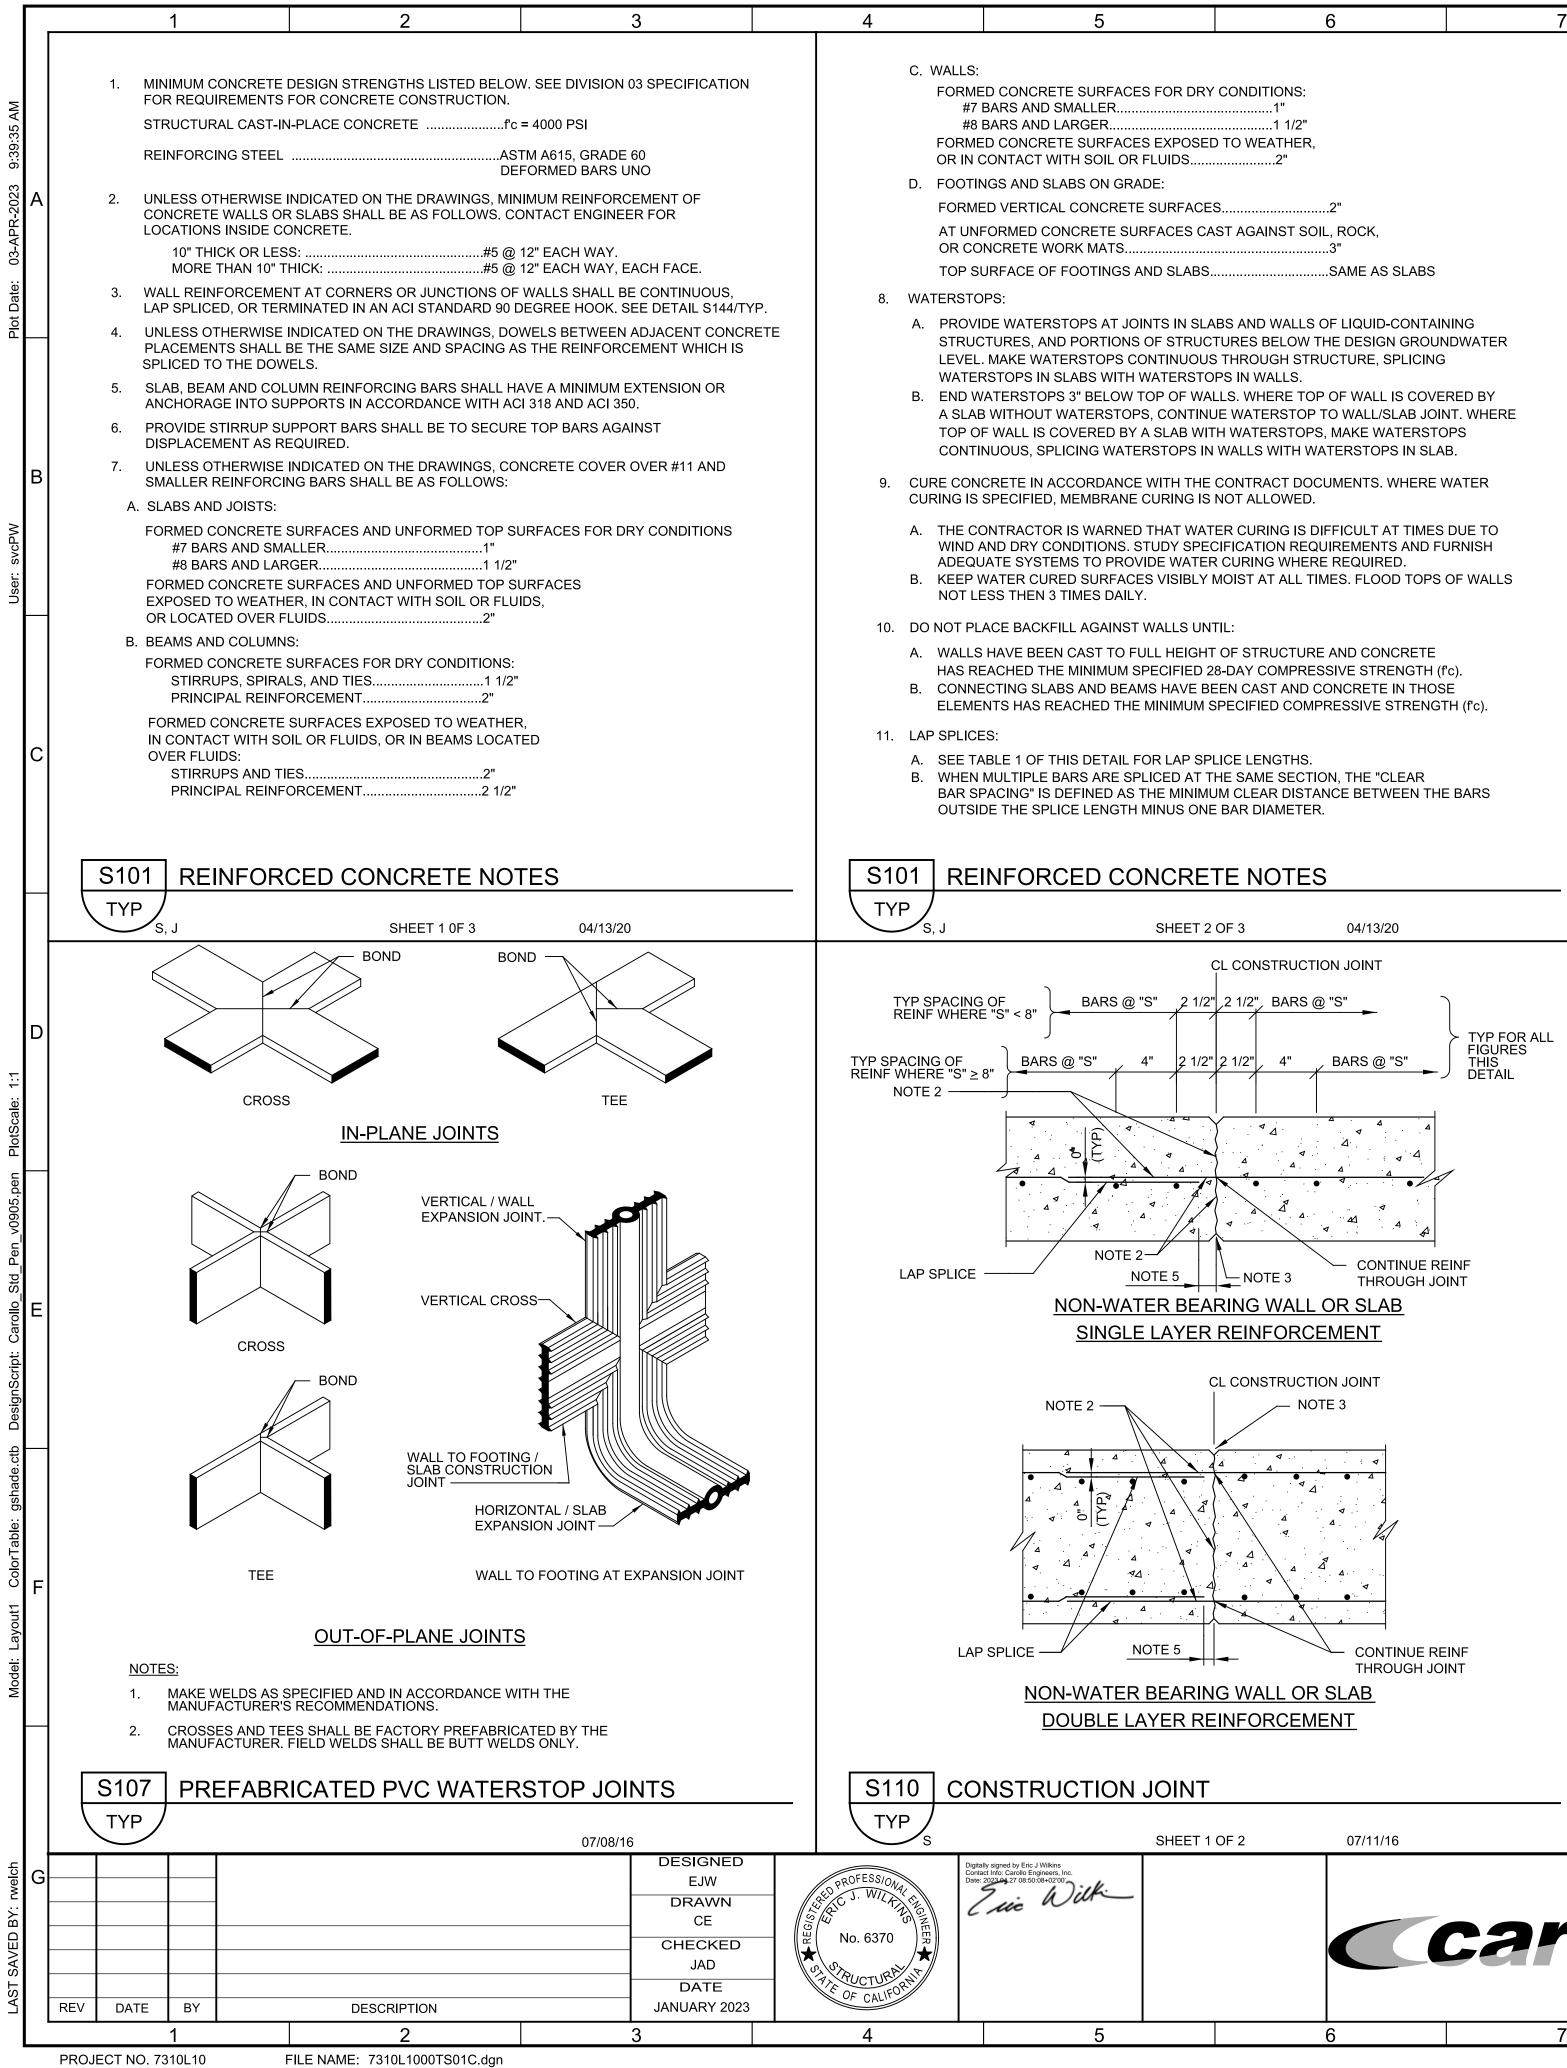


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					П
ION AN	TY OF PETALUMA ID MISC. IMPROVEN INSTRUMENTATION STRUMENTATION	IENTS PROJECT	VERIFY SCALES BAR IS ONE INCH ON ORIGINAL DRAWING 0 1" IF NOT ONE INCH ON THIS SHEET, ADJUST SCALES ACCORDINGLY	JOB NO. 7310L.10 DRAWING NO. TNO2C SHEET NO. 33 OF 130	G
	11	12	13		









5	6	7		8		9	10
RFACES FOR DRY (ER RFACES EXPOSED OIL OR FLUIDS N GRADE:	1" 1 1/2" TO WEATHER,		D. 12. FOR OTH	SPLICE SHALL BE IN "TOP BARS" ARE HO THAN 12 INCHES OF M EXPOSED CONCR ERWISE INDICATED	E INDICATED ON THE DRAV CONTACT WITH EACH OTH RIZONTAL REINFORCEMEN FRESH CONCRETE IS CAS ETE CORNERS AND EDGES ON THE DRAWINGS.	HER. NT AT LOCATIONS WHE IT IN THE MEMBER BEL S WITH 3/4" CHAMFER I	ERE MORE LOW THE BAR. UNLESS
ICRETE SURFACES.	2"		TABL	E 1: REINFORC	ING BAR LAP SPLIC	ES: f'c = 4000 PS	I, Fy = 60,000 PSI
ETE SURFACES CAST AGAINST SOIL, ROCK, IATS			BAR	MINIMUM COVER	MINIMUM CLEAR BAR SPACING	LAP SPLICE LE	ENGTH (INCHES)
INGS AND SLABS	SAME AS SLABS		SIZE	(BAR DIA)	(BAR DIA)	TOP BARS	OTHER BARS
			#4	MORE THAN 1	MORE THAN 2	32 *	25 *
	S AND WALLS OF LIQUID-CONTAIN			MORE THAN 2	MORE THAN 4	20	16
	URES BELOW THE DESIGN GROUN THROUGH STRUCTURE, SPLICING	DWATER	#5	MORE THAN 1	MORE THAN 2	40 *	31 *
WITH WATERSTOP				MORE THAN 2	MORE THAN 4	26	20
	S. WHERE TOP OF WALL IS COVER		#6	MORE THAN 1	MORE THAN 2	48 *	37 *
•	E WATERSTOP TO WALL/SLAB JOIN I WATERSTOPS, MAKE WATERSTO			MORE THAN 2	MORE THAN 4	30	24
	VALLS WITH WATERSTOPS IN SLAP		#7	MORE THAN 1	MORE THAN 2	70 *	54 *
				MORE THAN 2	MORE THAN 4	43	33
BRANE CURING IS N	ONTRACT DOCUMENTS. WHERE W		#8	MORE THAN 1	MORE THAN 2	81 *	62 *
				MORE THAN 2	MORE THAN 4	50	38
	R CURING IS DIFFICULT AT TIMES I FICATION REQUIREMENTS AND FU		#9	MORE THAN 1	MORE THAN 2	90 *	70 *

MORE THAN 2

MORE THAN 1

MORE THAN 2

MORE THAN 1

MORE THAN 2

REINFORCING BAR LAP SPLICE TABLE NOTES:

#10

#11

MORE THAN 4

MORE THAN 2

MORE THAN 4

MORE THAN 2

MORE THAN 4

1. TABULATED SPLICE LENGTHS ARE APPLICABLE ONLY WHEN BOTH REQUIREMENTS FOR MINIMUM COVER AND FOR MINIMUM CLEAR BAR SPACING ARE SATISFIED.

*= IF THE CLEAR BAR SPACING IS LESS THAN OR EQUAL TO TWO BAR DIAMETERS, OR THE COVER IS LESS THAN OR EQUAL TO ONE BAR DIAMETER, THE LAP SPLICE LENGTH SHALL BE INCREASED BY 50 PERCENT.

56

62

69

104 *****

114 *****

42

48

88 *

54

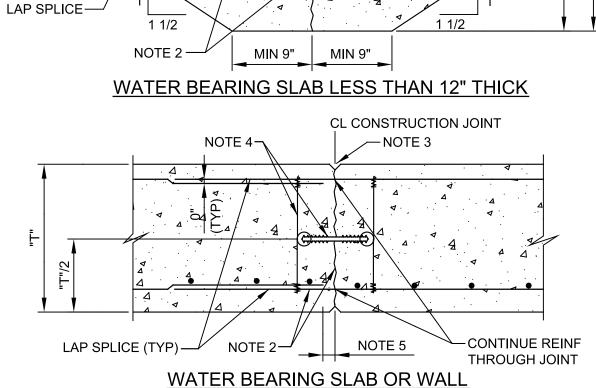
04/13/20

- CONTINUE REINF THROUGH JOINT

-NOTE 4

81 *****

S101 **REINFORCED CONCRETE NOTES** TYP SHEET 3 OF 3 NOTE 3 — CL CONSTRUCTION JOINT NOTE 5



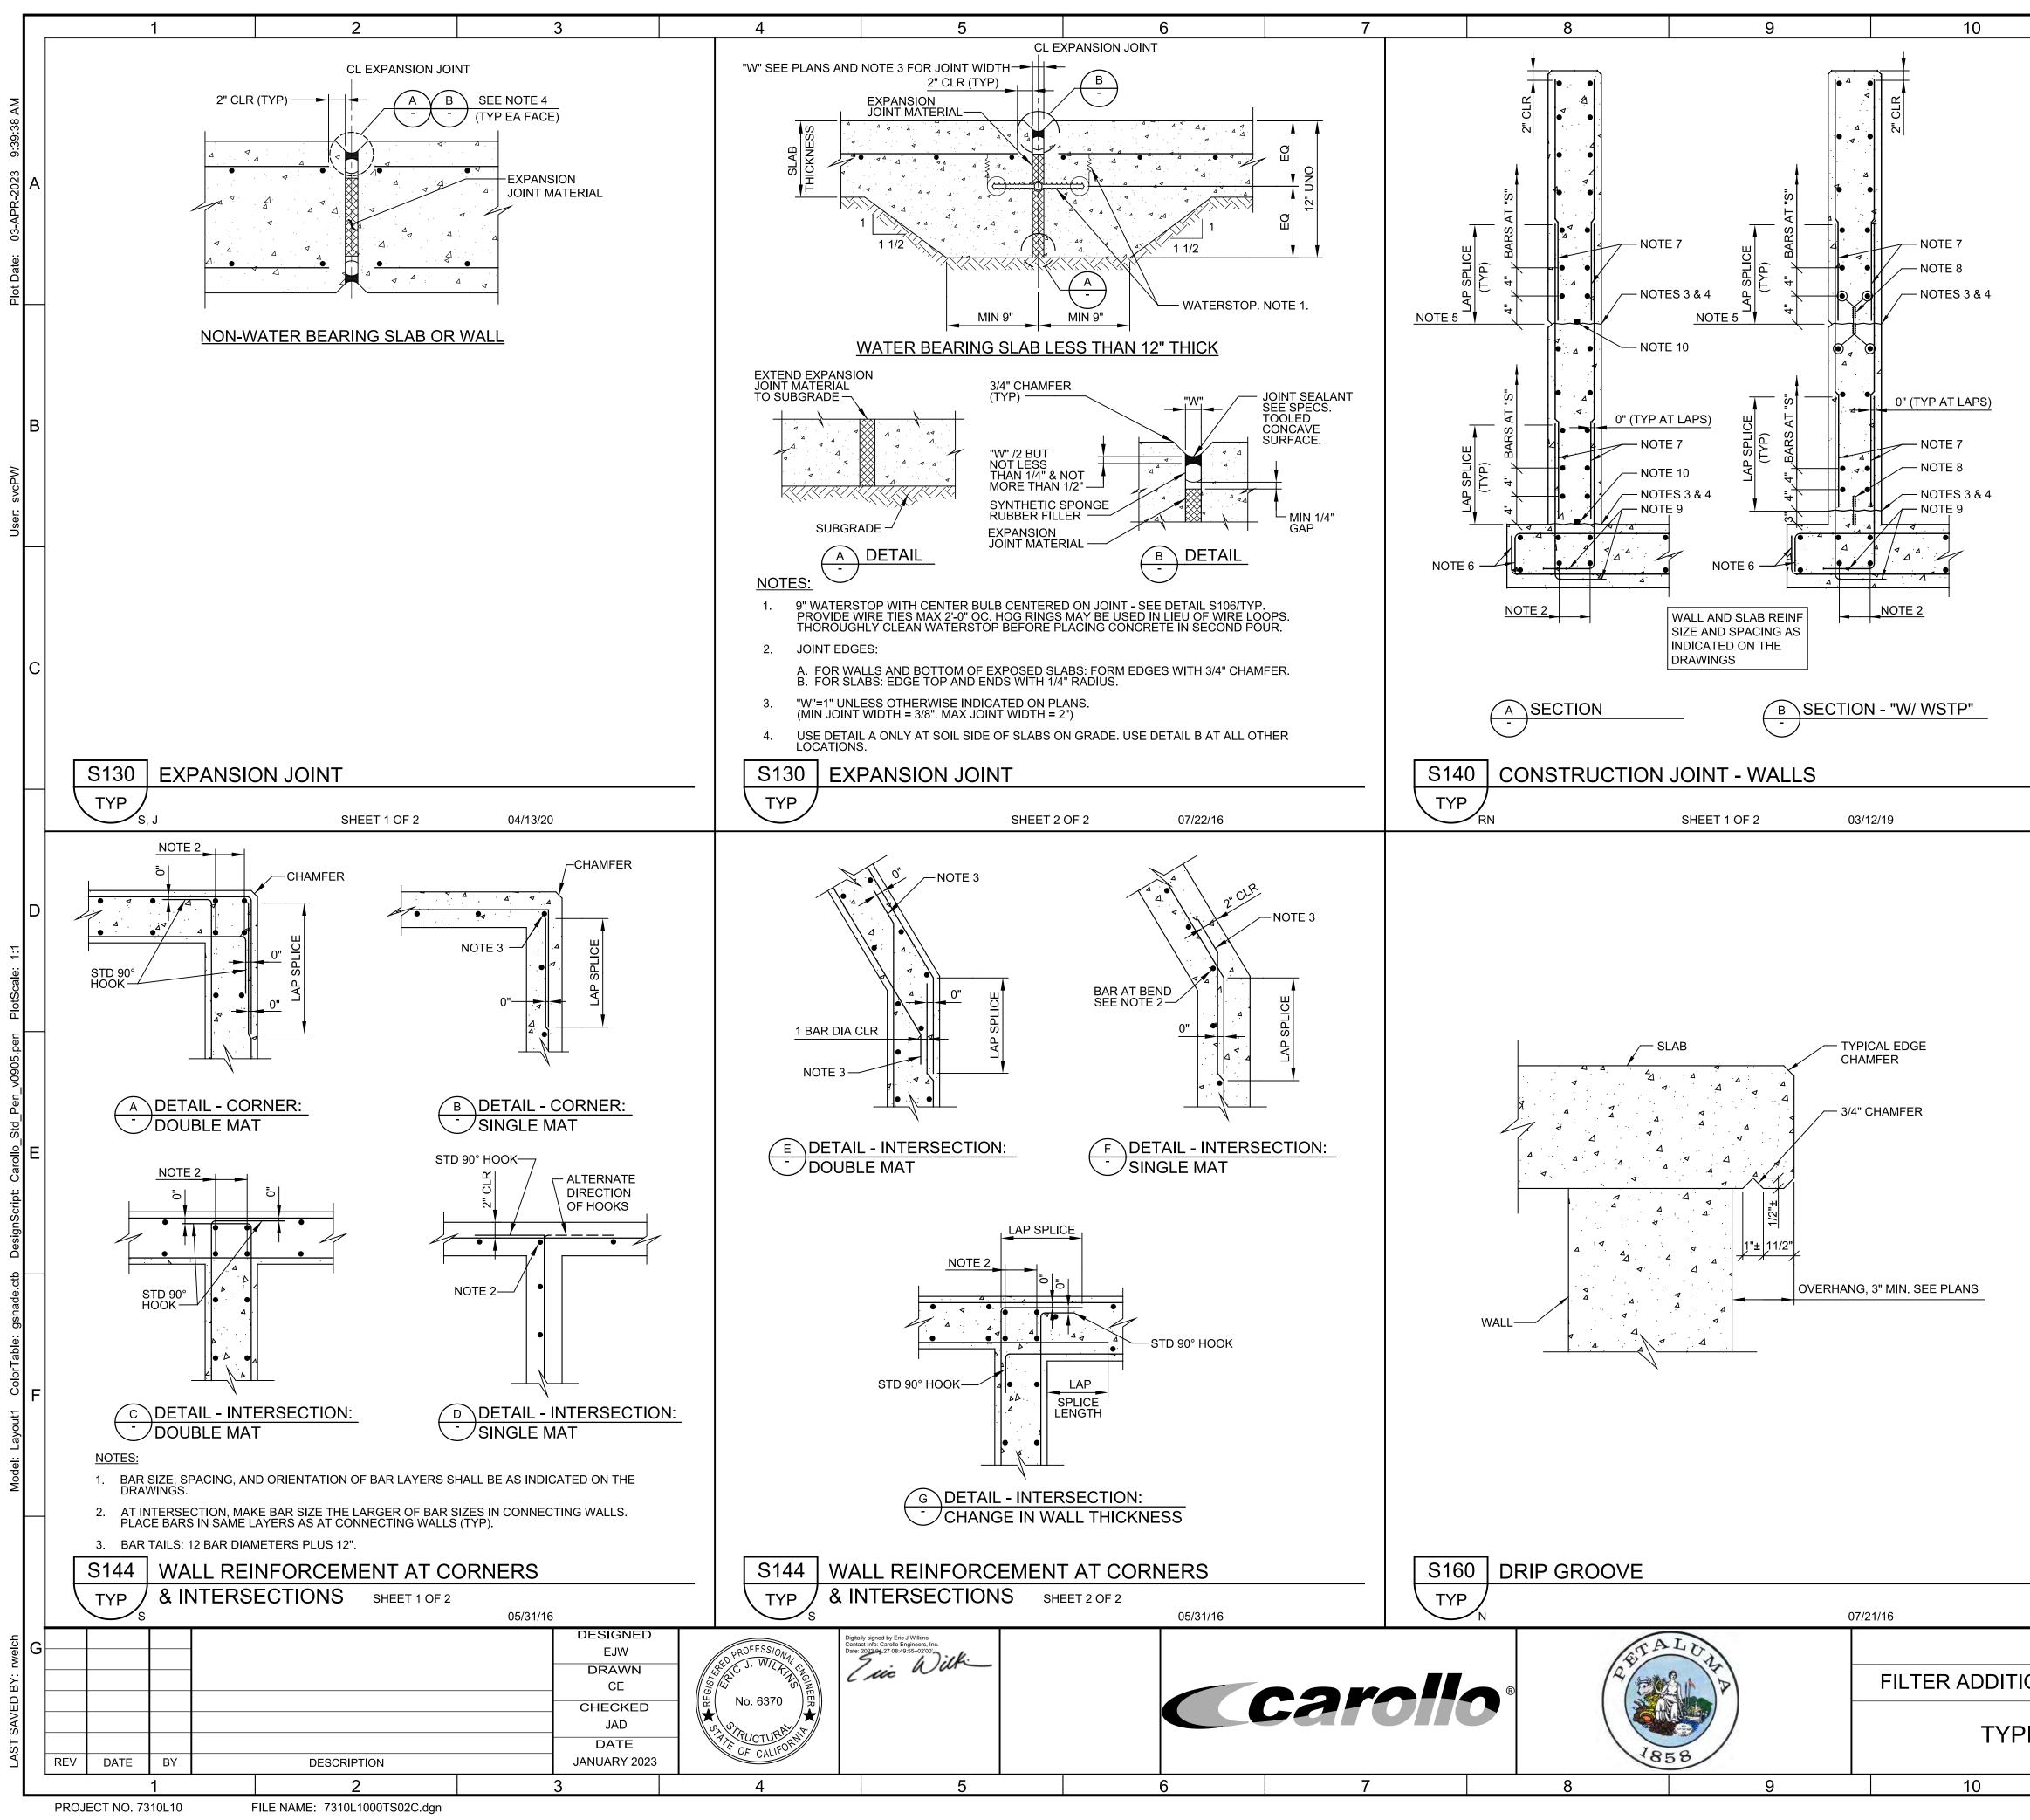
NOTES:

- "S" EQUALS TYPICAL BAR SPACING INDICATED ON THE DRAWINGS. "T" EQUALS SLAB OR WALL THICKNESS.
- WATER-BLAST EXPOSED JOINT FACE AND PROJECTING REINFORCEMENT BEFORE 2. PLACING CONCRETE.
- JOINT EDGES:
 - A. FOR WALLS AND BOTTOM OF EXPOSED SLABS: FORM EDGES WITH 1/2" CHAMFER. B. FOR SLABS: EDGE TOP AND ENDS WITH 1/4" RADIUS.
- 6" WATERSTOP CENTERED ON JOINT SEE DETAIL S106/TYP. PROVIDE WIRE TIES MAX 2'-0" OC. HOG RINGS MAY BE USED IN LIEU OF WIRE LOOPS. THOROUGHLY CLEAN WATERSTOP BEFORE 4. PLACING CONCRETE IN SECOND POUR.

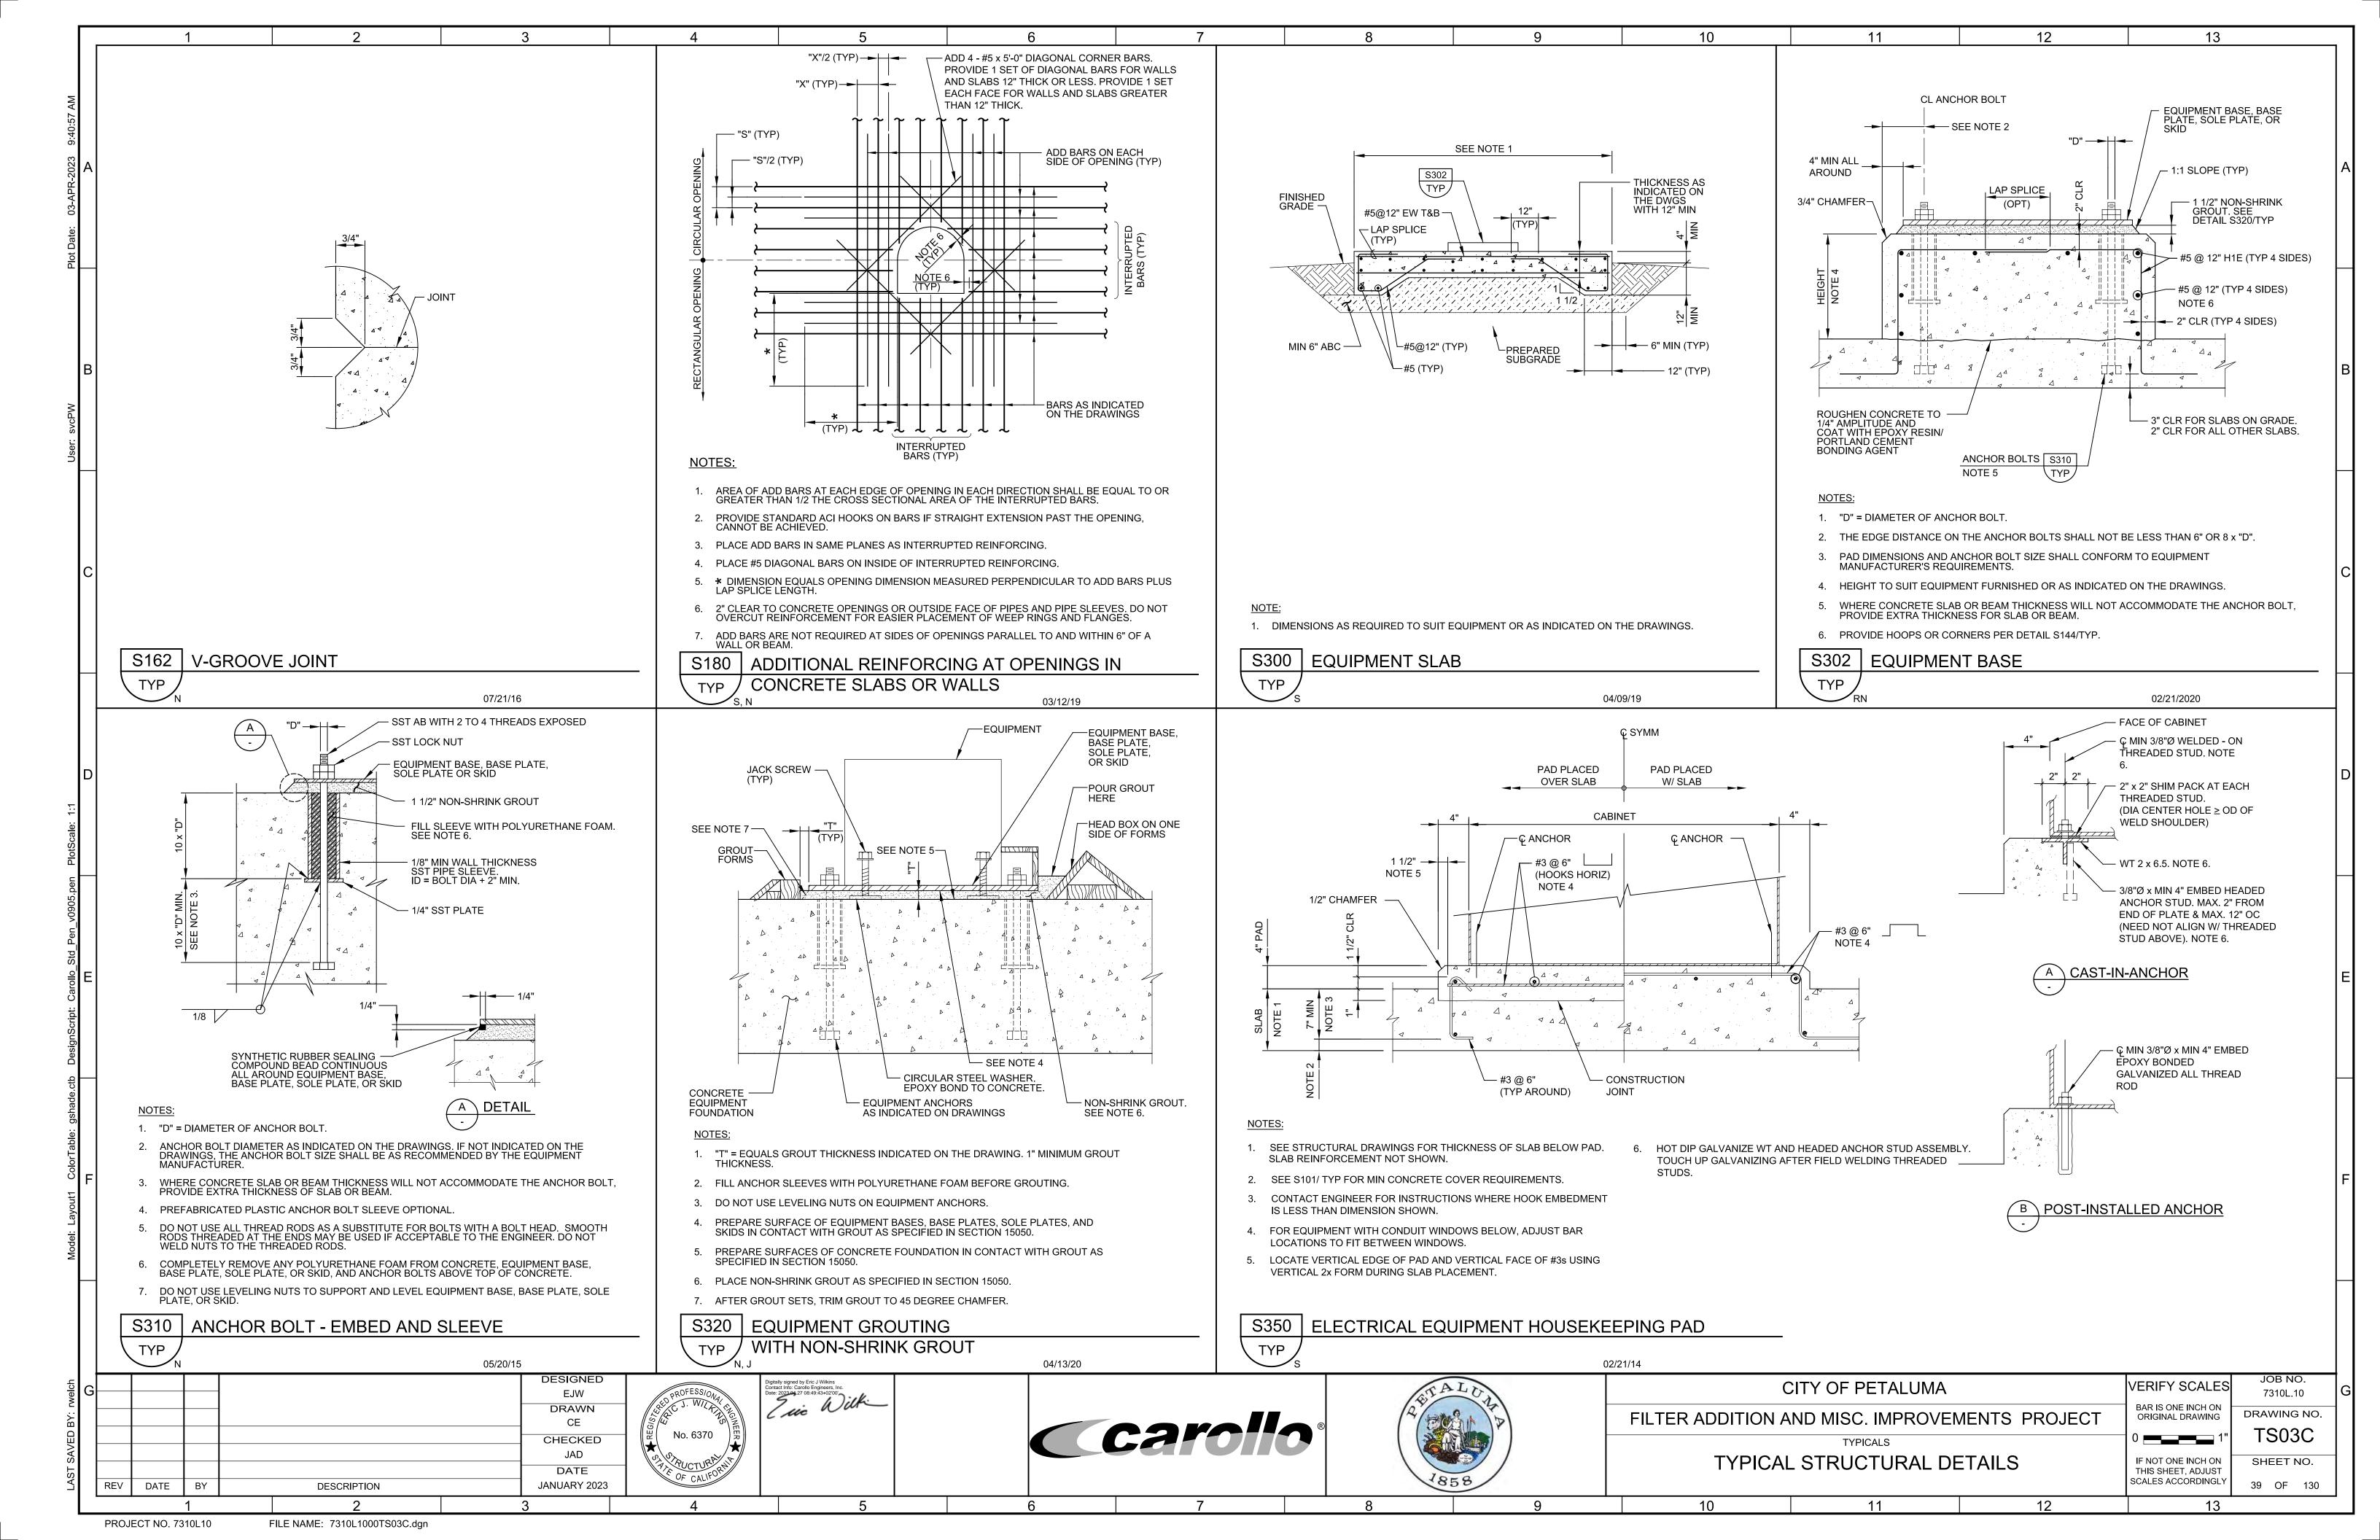
5. STOP REINFORCING 2" CLEAR OF JOINT.

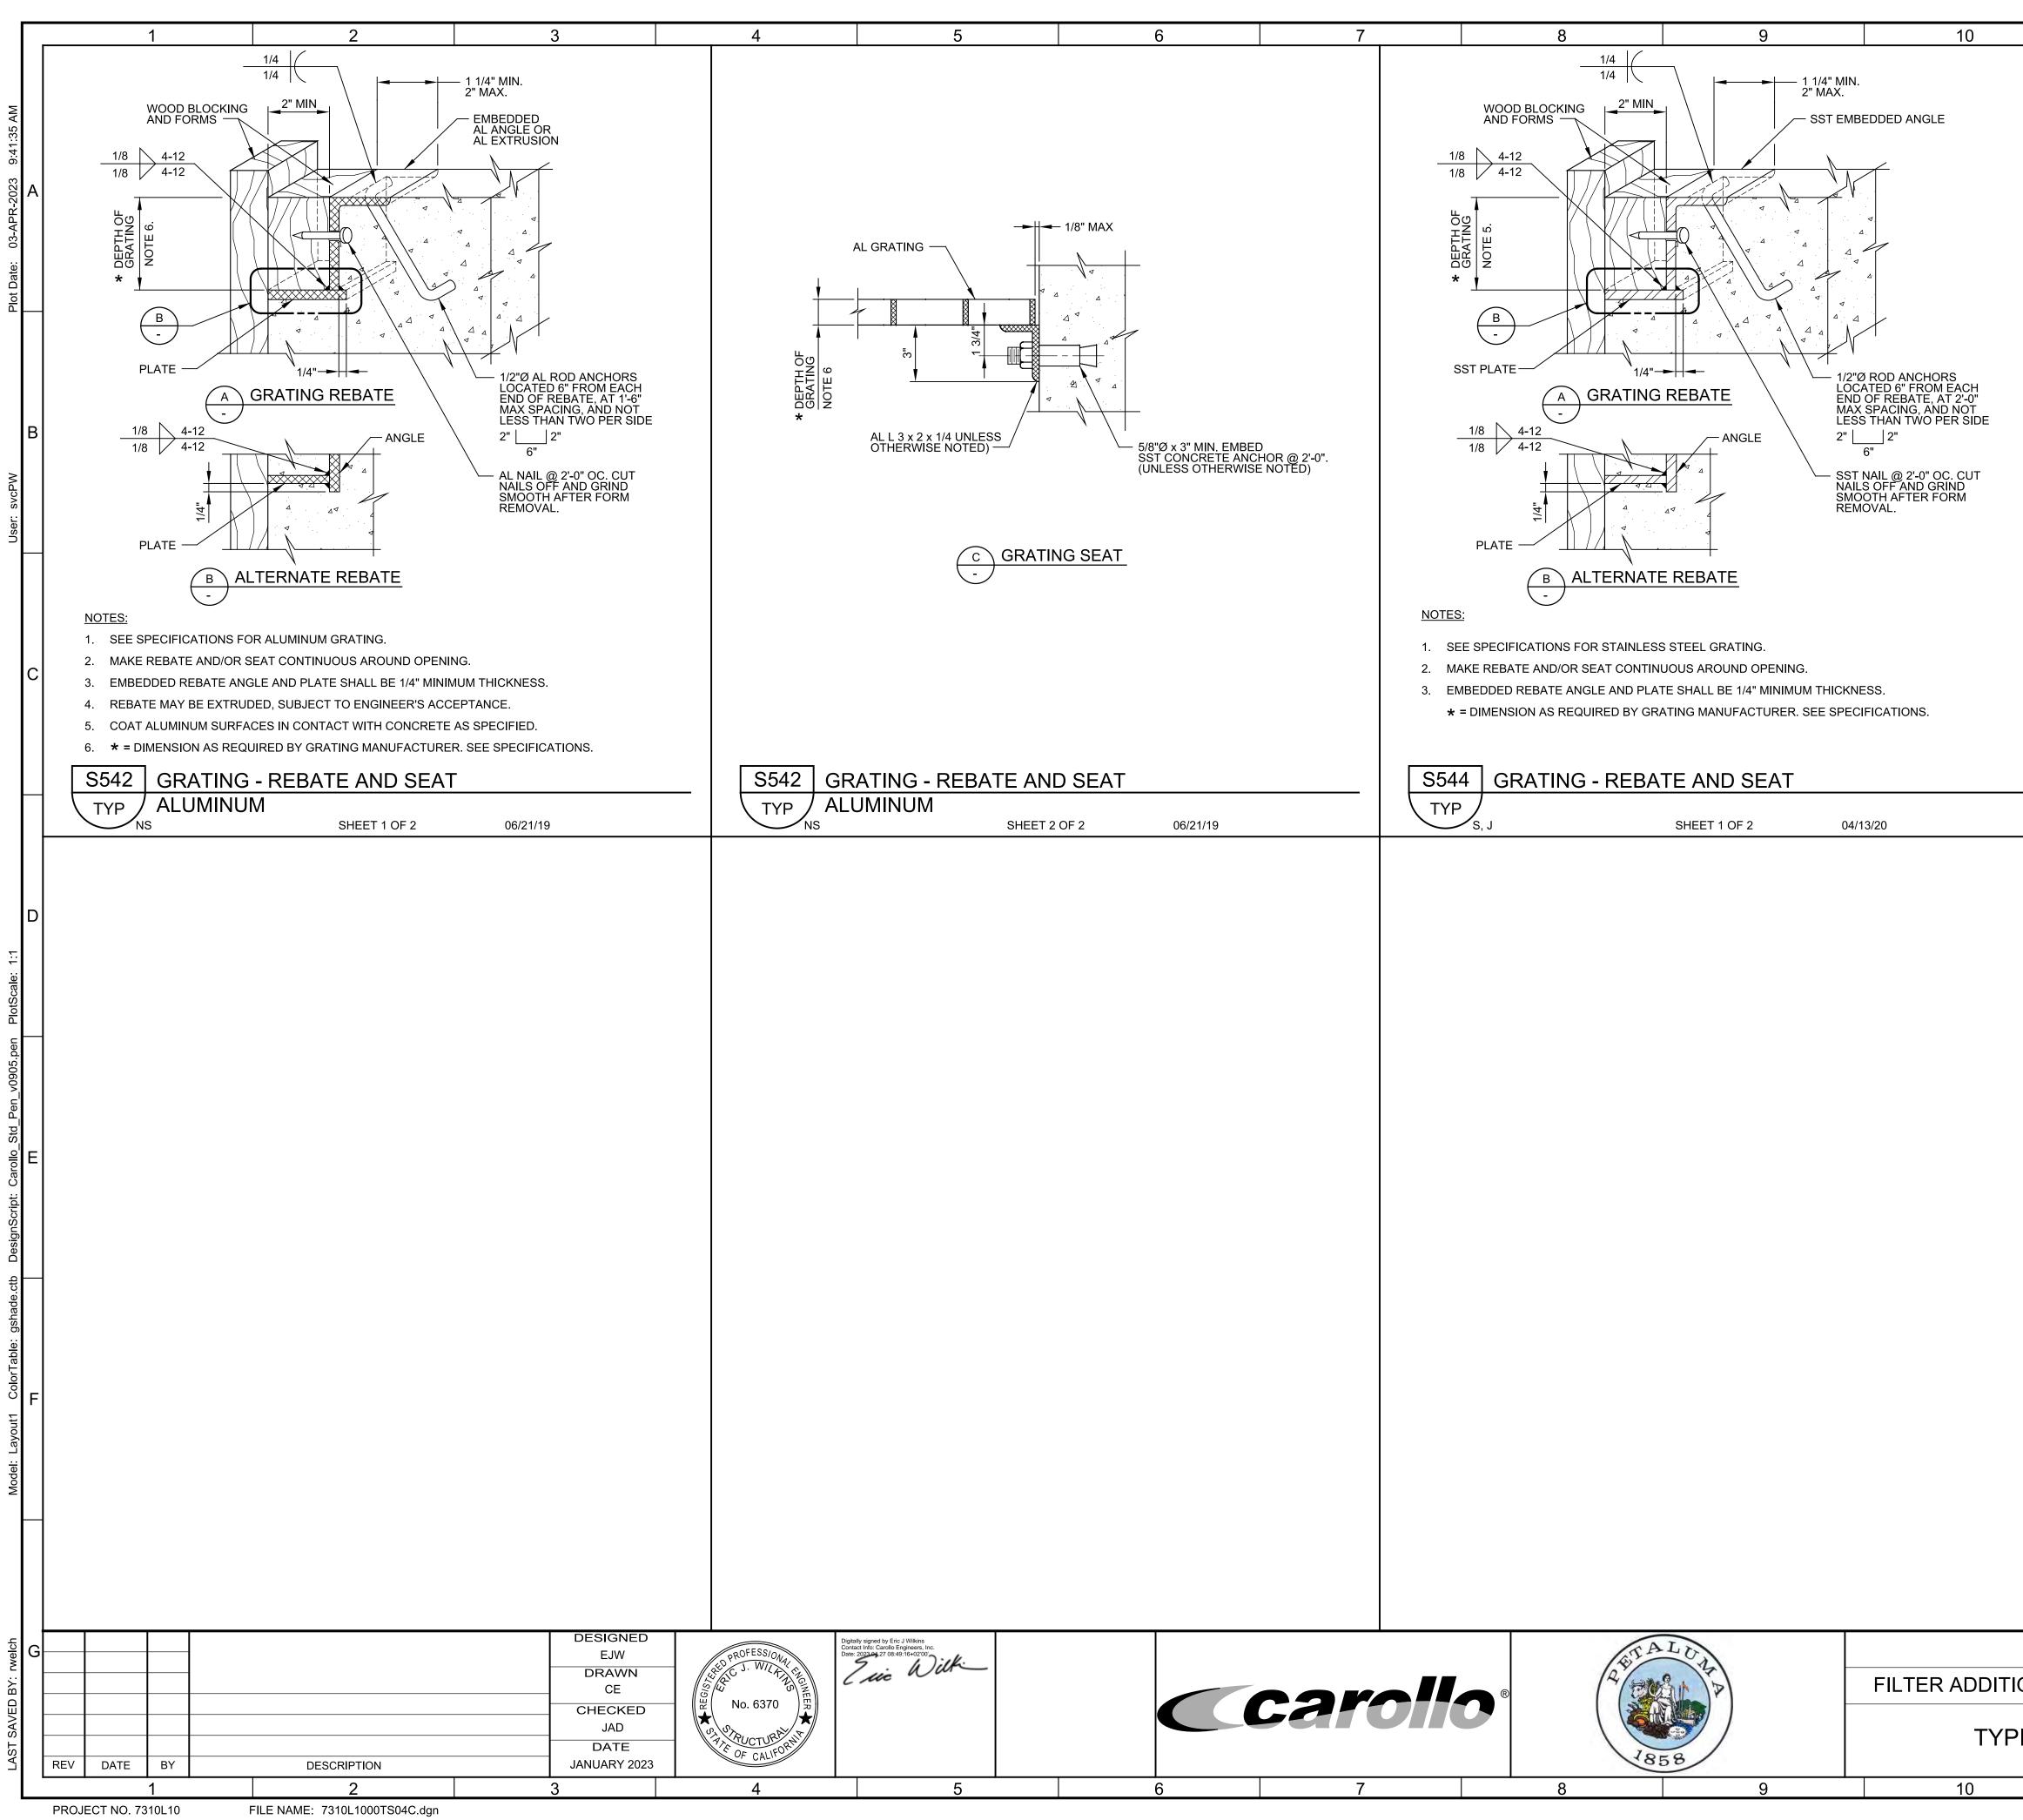
SHEET 1 OF 2	07/11/16		T A	SHEET 2 OF 2	07/11/16
		arollo	®	SUL IN	FILTER ADDITIC
			18	58	TYPI
		7	0	0	

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	11				12			13			
					"A"						
			"B" –			г "С"					
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	\sim		<u> </u>		Ý		V				
		–"E" = NU RIBS PE		F	Ĩ	'F"		"D" ——			
		(MINIMU									
	TYPE	"A"	"B"	"C"	"D"	"E"	"F"	APPLIC		1	_
		A	D				Г 	APPLIC	ATION	-	
	W/O CENTERBULB	6"	-	3/8"	3/8"	7	-	CONSTRUC CONTROI			
	L I			1	1						3
	NOTES:									-	_
	1. SEE SPE										
	2. DIMENSI	ONS ARE	MINIMUN	M, UNLES	S OTHER	WISE NOT	ſED.				
										C	;
_	S106 PVC	WAT	ERS	FOP S	CHEE	DULE					
	TYP						0	2/21/20			
								2/21/20			
)
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										F	:
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-											
									JOB NO		
	CITY OF PETAL							Y SCALES	7310L.10		;
ON A	ND MISC. IMPI	ROVE	MEN	TS P	ROJE	СТ	ORIGIN	AL DRAWING	drawing		
	TYPICALS			110			0	1" ONE INCH ON	SHEET N		
ιυAl				ILO			THIS SH	HEET, ADJUST ACCORDINGLY		130	
	11				12		1	13			



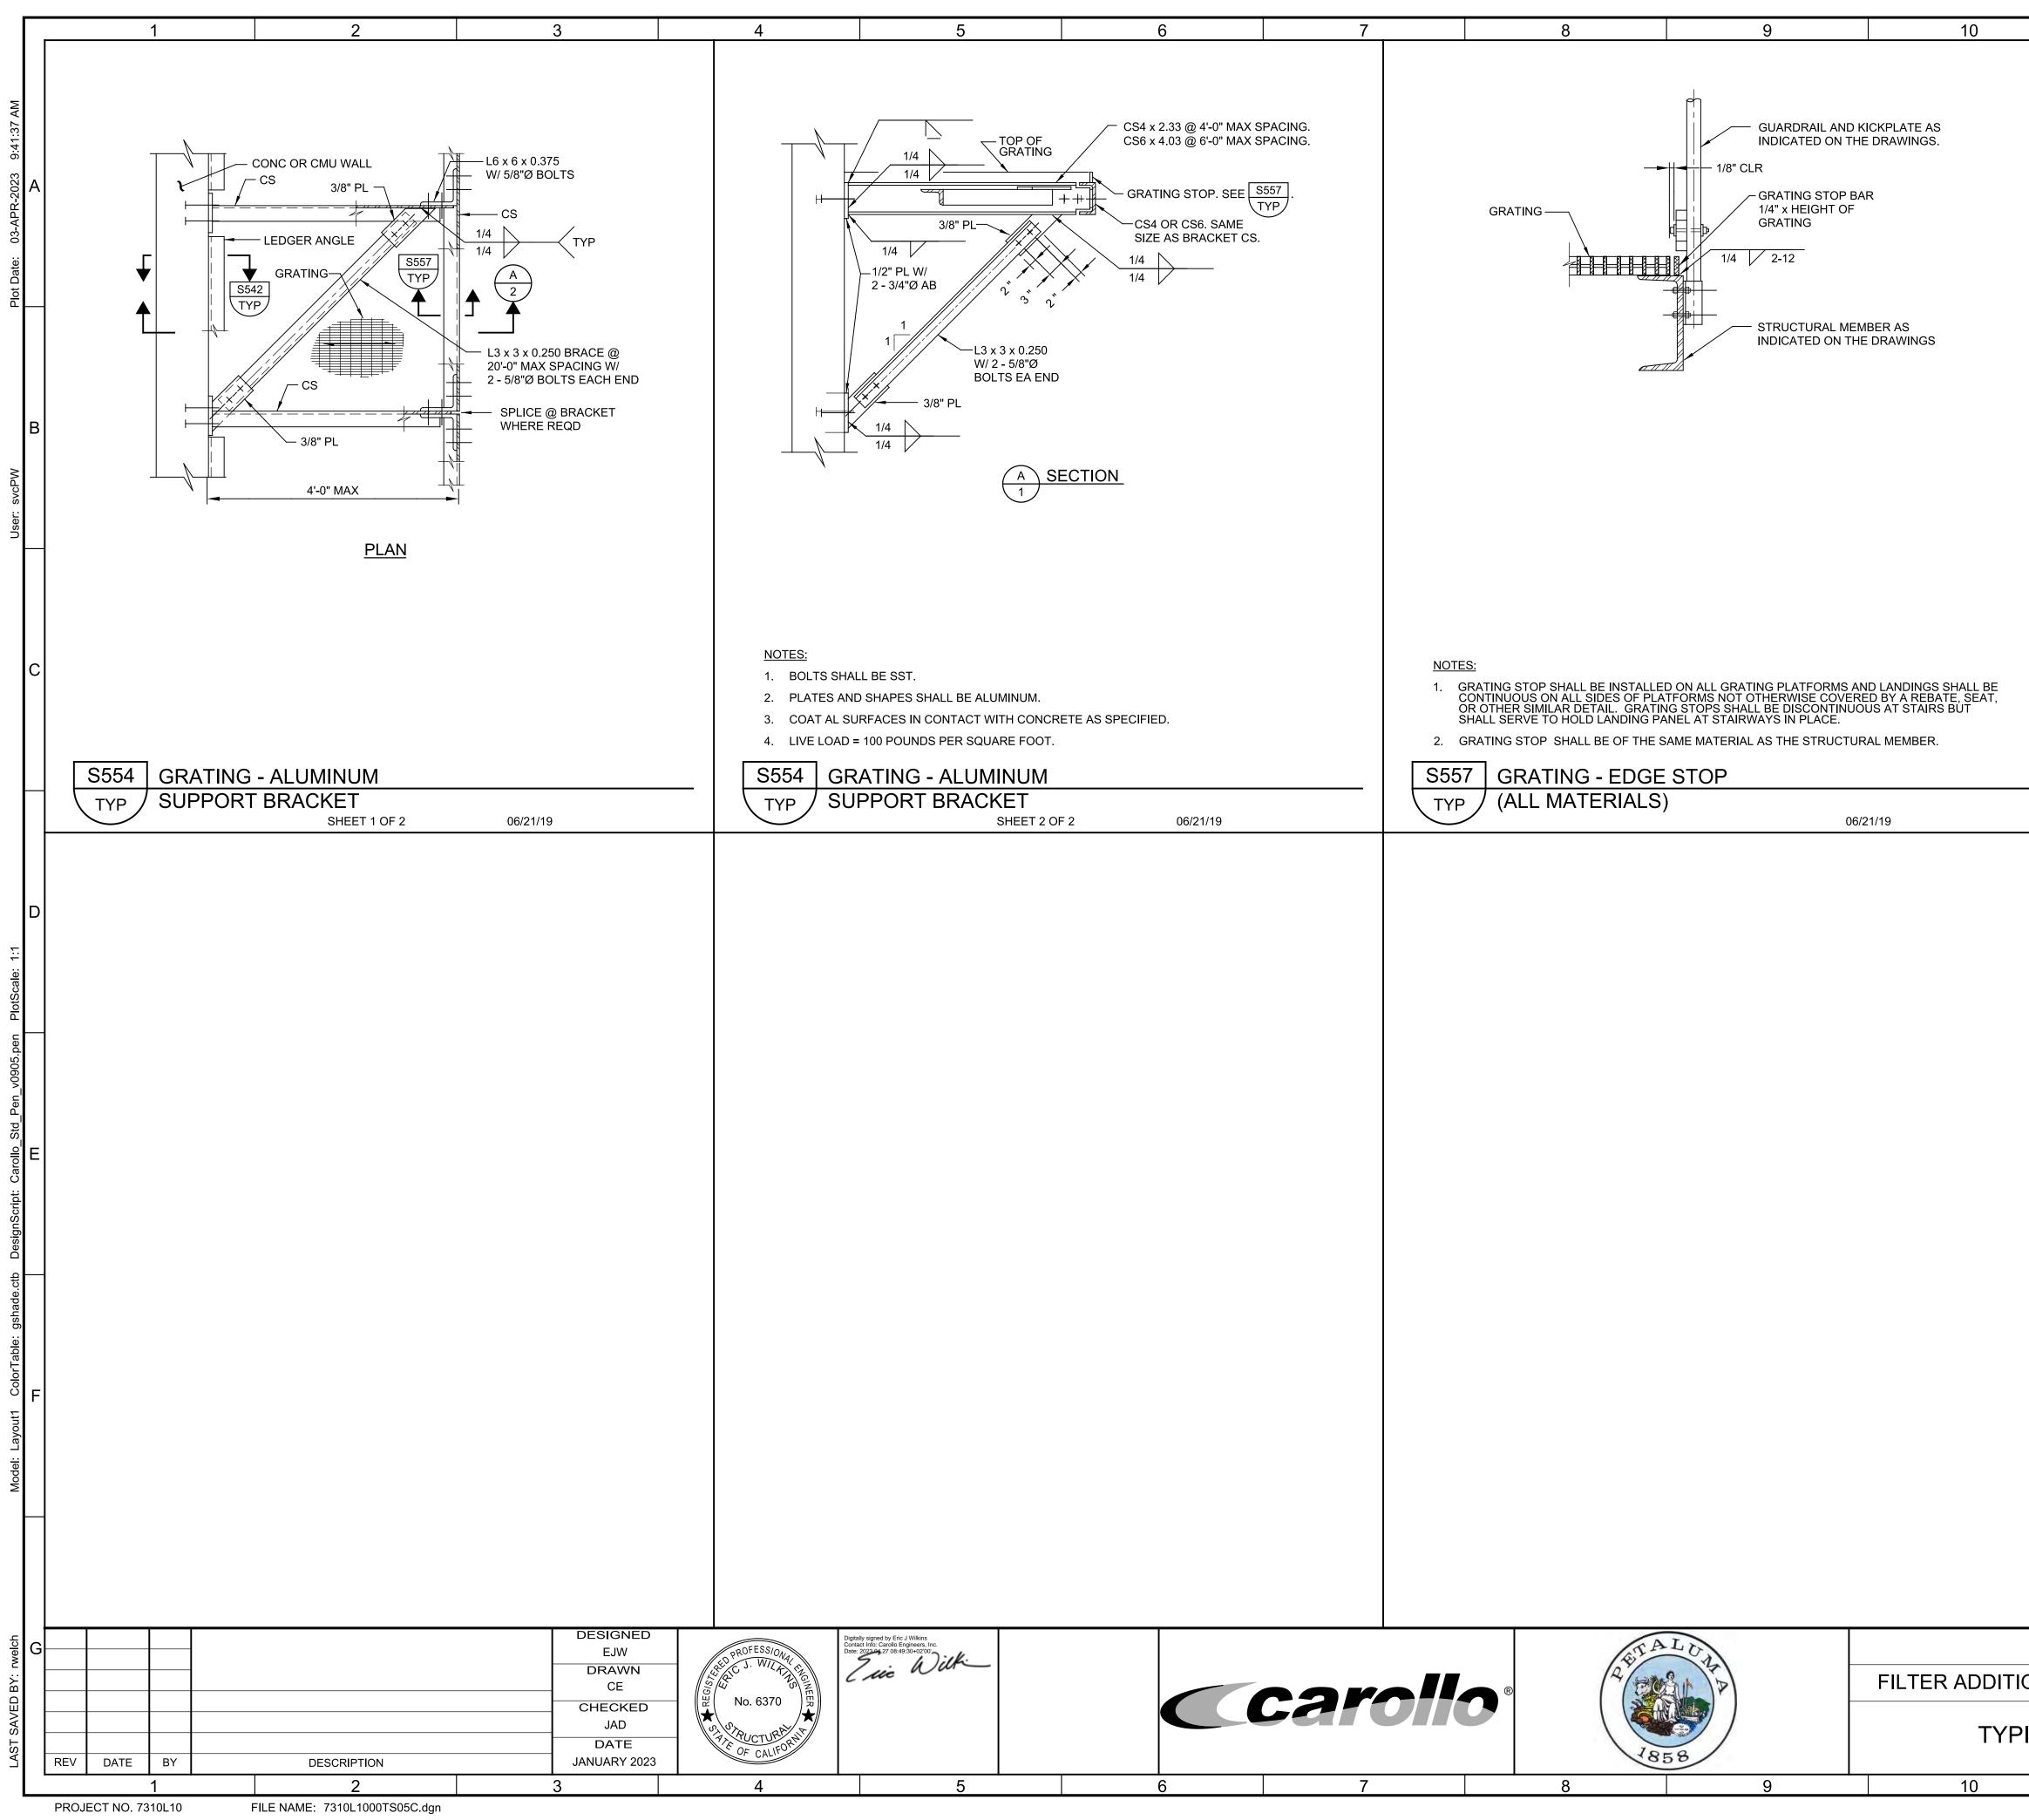
	11	12	13	
	 PLACE AND ALIGN BARS WATER-BLAST JOINT FA PLACE CEMENT GROUT (SEE SPECIFICATIONS.) CONSTRUCTION JOINT V EXPOSED TO VIEW IN TH STANDARD 90° HOOK W 180° HOOK WHERE REQ DOWELS: SAME SIZE AN 6" PVC WATERSTOP CEN HOG RINGS MAY BE USE BEFORE PLACING CONC STANDARD 90° HOOK UN WHERE DRAWINGS INDI 	OVER JOINT FACE IMMEDIATELY B WHERE INDICATED ON THE DRAWIN HE FINISHED WORK, PROVIDE V-GR HERE INDICATED ON THE DRAWING UIRED BY SLAB THICKNESS.) ID SPACING AS VERTICAL WALL BAI NTERED VERTICALLY ON JOINT. PR ED IN LIEU OF WIRE LOOPS. THORO CRETE. NLESS OTHERWISE INDICATED ON CATE "W/ STRIP WSTP" PROVIDE LO	SIZE TO MATCH SLAB BARS. MENT BEFORE PLACING CONCRETE. EFORE PLACING CONCRETE. NGS. WHERE WALL SURFACE IS COOVE PER DETAIL S162/TYP. GS. (ALTERNATE: PROVIDE RS, UNLESS OTHERWISE NOTED. OVIDE WIRE TIES MAX 2'-0" OC. UGHLY CLEAN WATERSTOP THE DRAWINGS. OW EXPANSION HYDROPHILIC	A
	WATERSTOP AT TOP SU	IRFACE OF JOINT AND CENTERED E	BETWEEN VERTICAL BARS.	В
	S140 CONSTRU	<u>CTION JOINT - WALL</u>	S	С
	TYP S, N	SHEET 2 OF 2	03/12/19	
				D
				E
				F
_				
ION A	CITY OF PETALUMA AND MISC. IMPROVEN TYPICALS L STRUCTURAL DE		VERIFY SCALES BAR IS ONE INCH ON ORIGINAL DRAWING 0 1" TS020 IF NOT ONE INCH ON THIS SHEET, ADJUST SCALES ACCORDINCLY) G NO. C O.
	11	12	SCALES ACCORDINGLY 38 OF 13	130



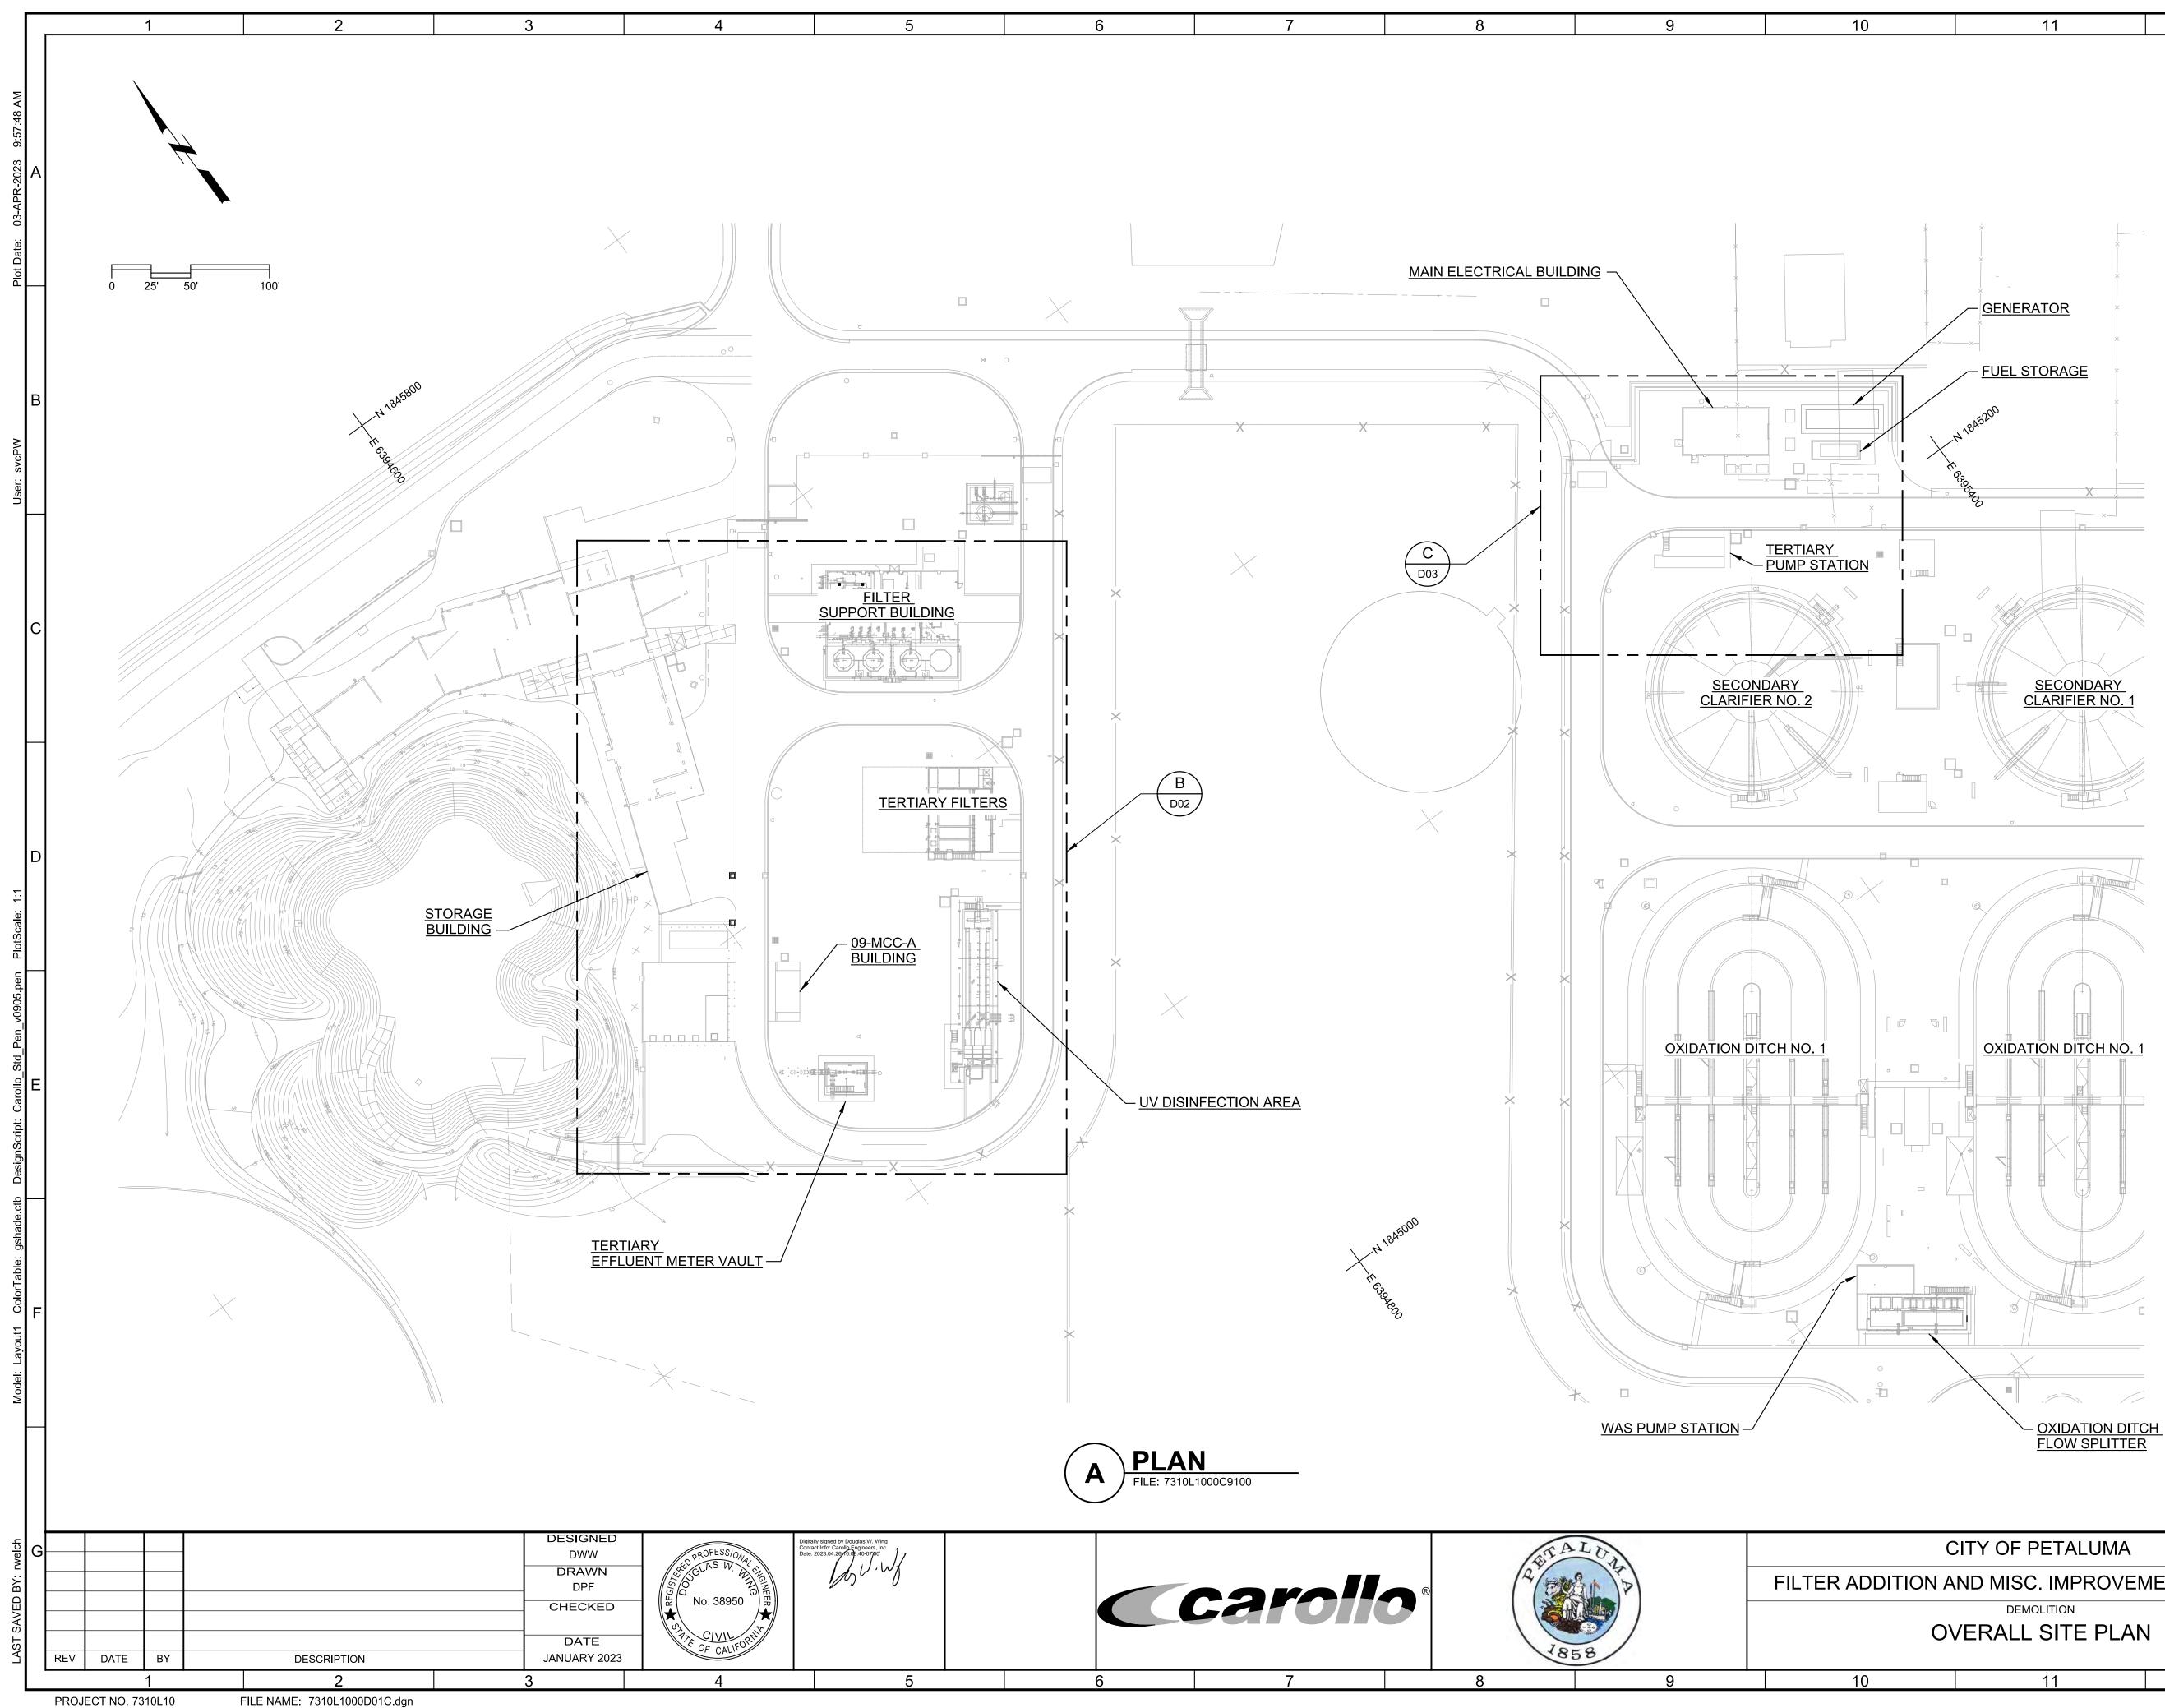


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	11	12	13		
	SST GRATING- BOHLABO HOLE 2: HOLE 2: *				A
	HUJZ * SSTL3×2×1 OTHERWISE N	1/4 (UNLESS NOTED) C GRATING SEAT	5/8"Ø x 3" MIN. EMBED SST CONCRETE ANCHO UNLESS OTHERWISE N -	DRS @ 2'-0". NOTED)	В
	S544 GRATING -	- REBATE AND SEAT			С
_	TYPS,J	SHEET 2 OF 2	04/13/20		D
					E
					F
	CITY OF PETALUMA AND MISC. IMPROVEN TYPICALS AL STRUCTURAL DE	MENTS PROJECT	VERIFY SCALES BAR IS ONE INCH ON ORIGINAL DRAWING 0 1" IF NOT ONE INCH ON THIS SHEET, ADJUST SCALES ACCORDINGLY	JOB NO. 7310L.10 DRAWING NO. TSO4C SHEET NO. 40 OF 130	G
	11	12	13		



			1	
	11	12	13	
		SECTION OF GRATING		A
	TOP FLANGE OF SUPPORT		MIN 2 BOLTS PER @ ALL SUPPORTS.	В
_	2. GRATING FASTENERS SH SPACING NOT TO EXCEE	IALL BE INSTALLED WHERE INDICA HALL BE INSTALLED AT EACH CORN D 8'-0". FASTENERS RIALS)		C
-+		,	06/21/19	
				D
				E
				F
I	CITY OF PETALUMA		VERIFY SCALES JOB NO 7310L.10	G
	AND MISC. IMPROVEN TYPICALS		BAR IS ONE INCH ON ORIGINAL DRAWING 0	C
			THIS SHEET, ADJUST SCALES ACCORDINGLY 41 OF	130
	11	12	13	



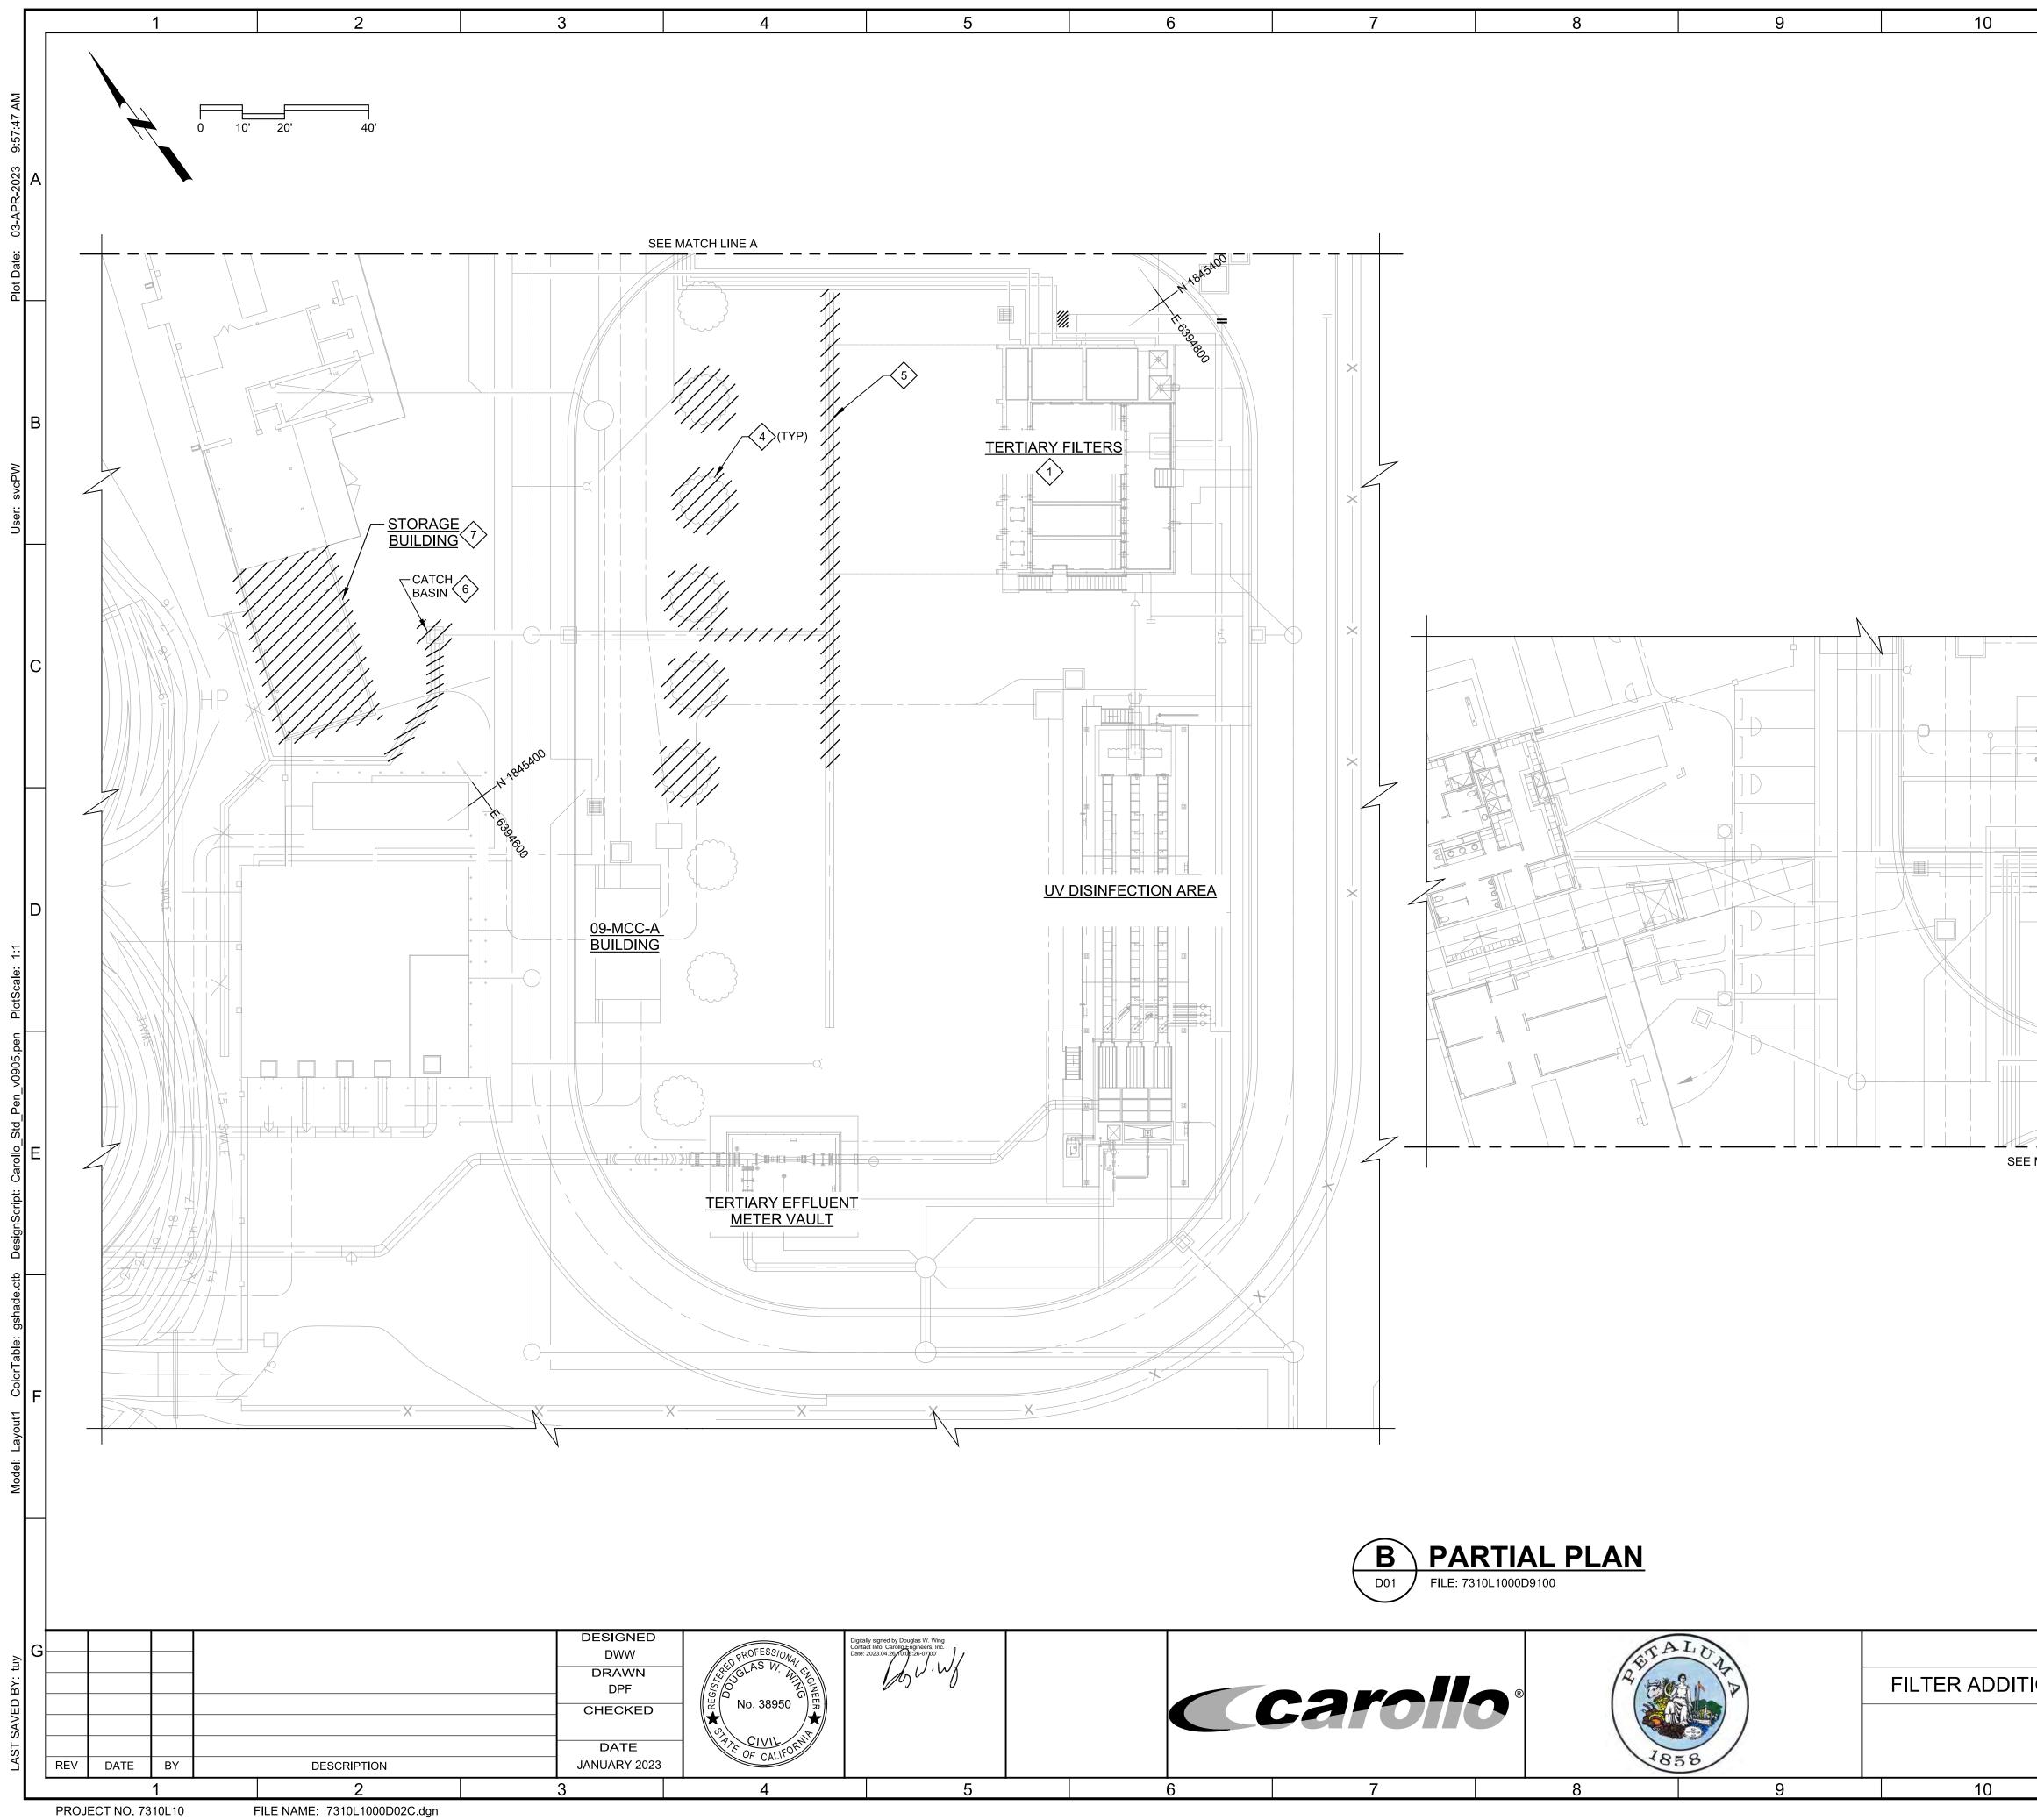




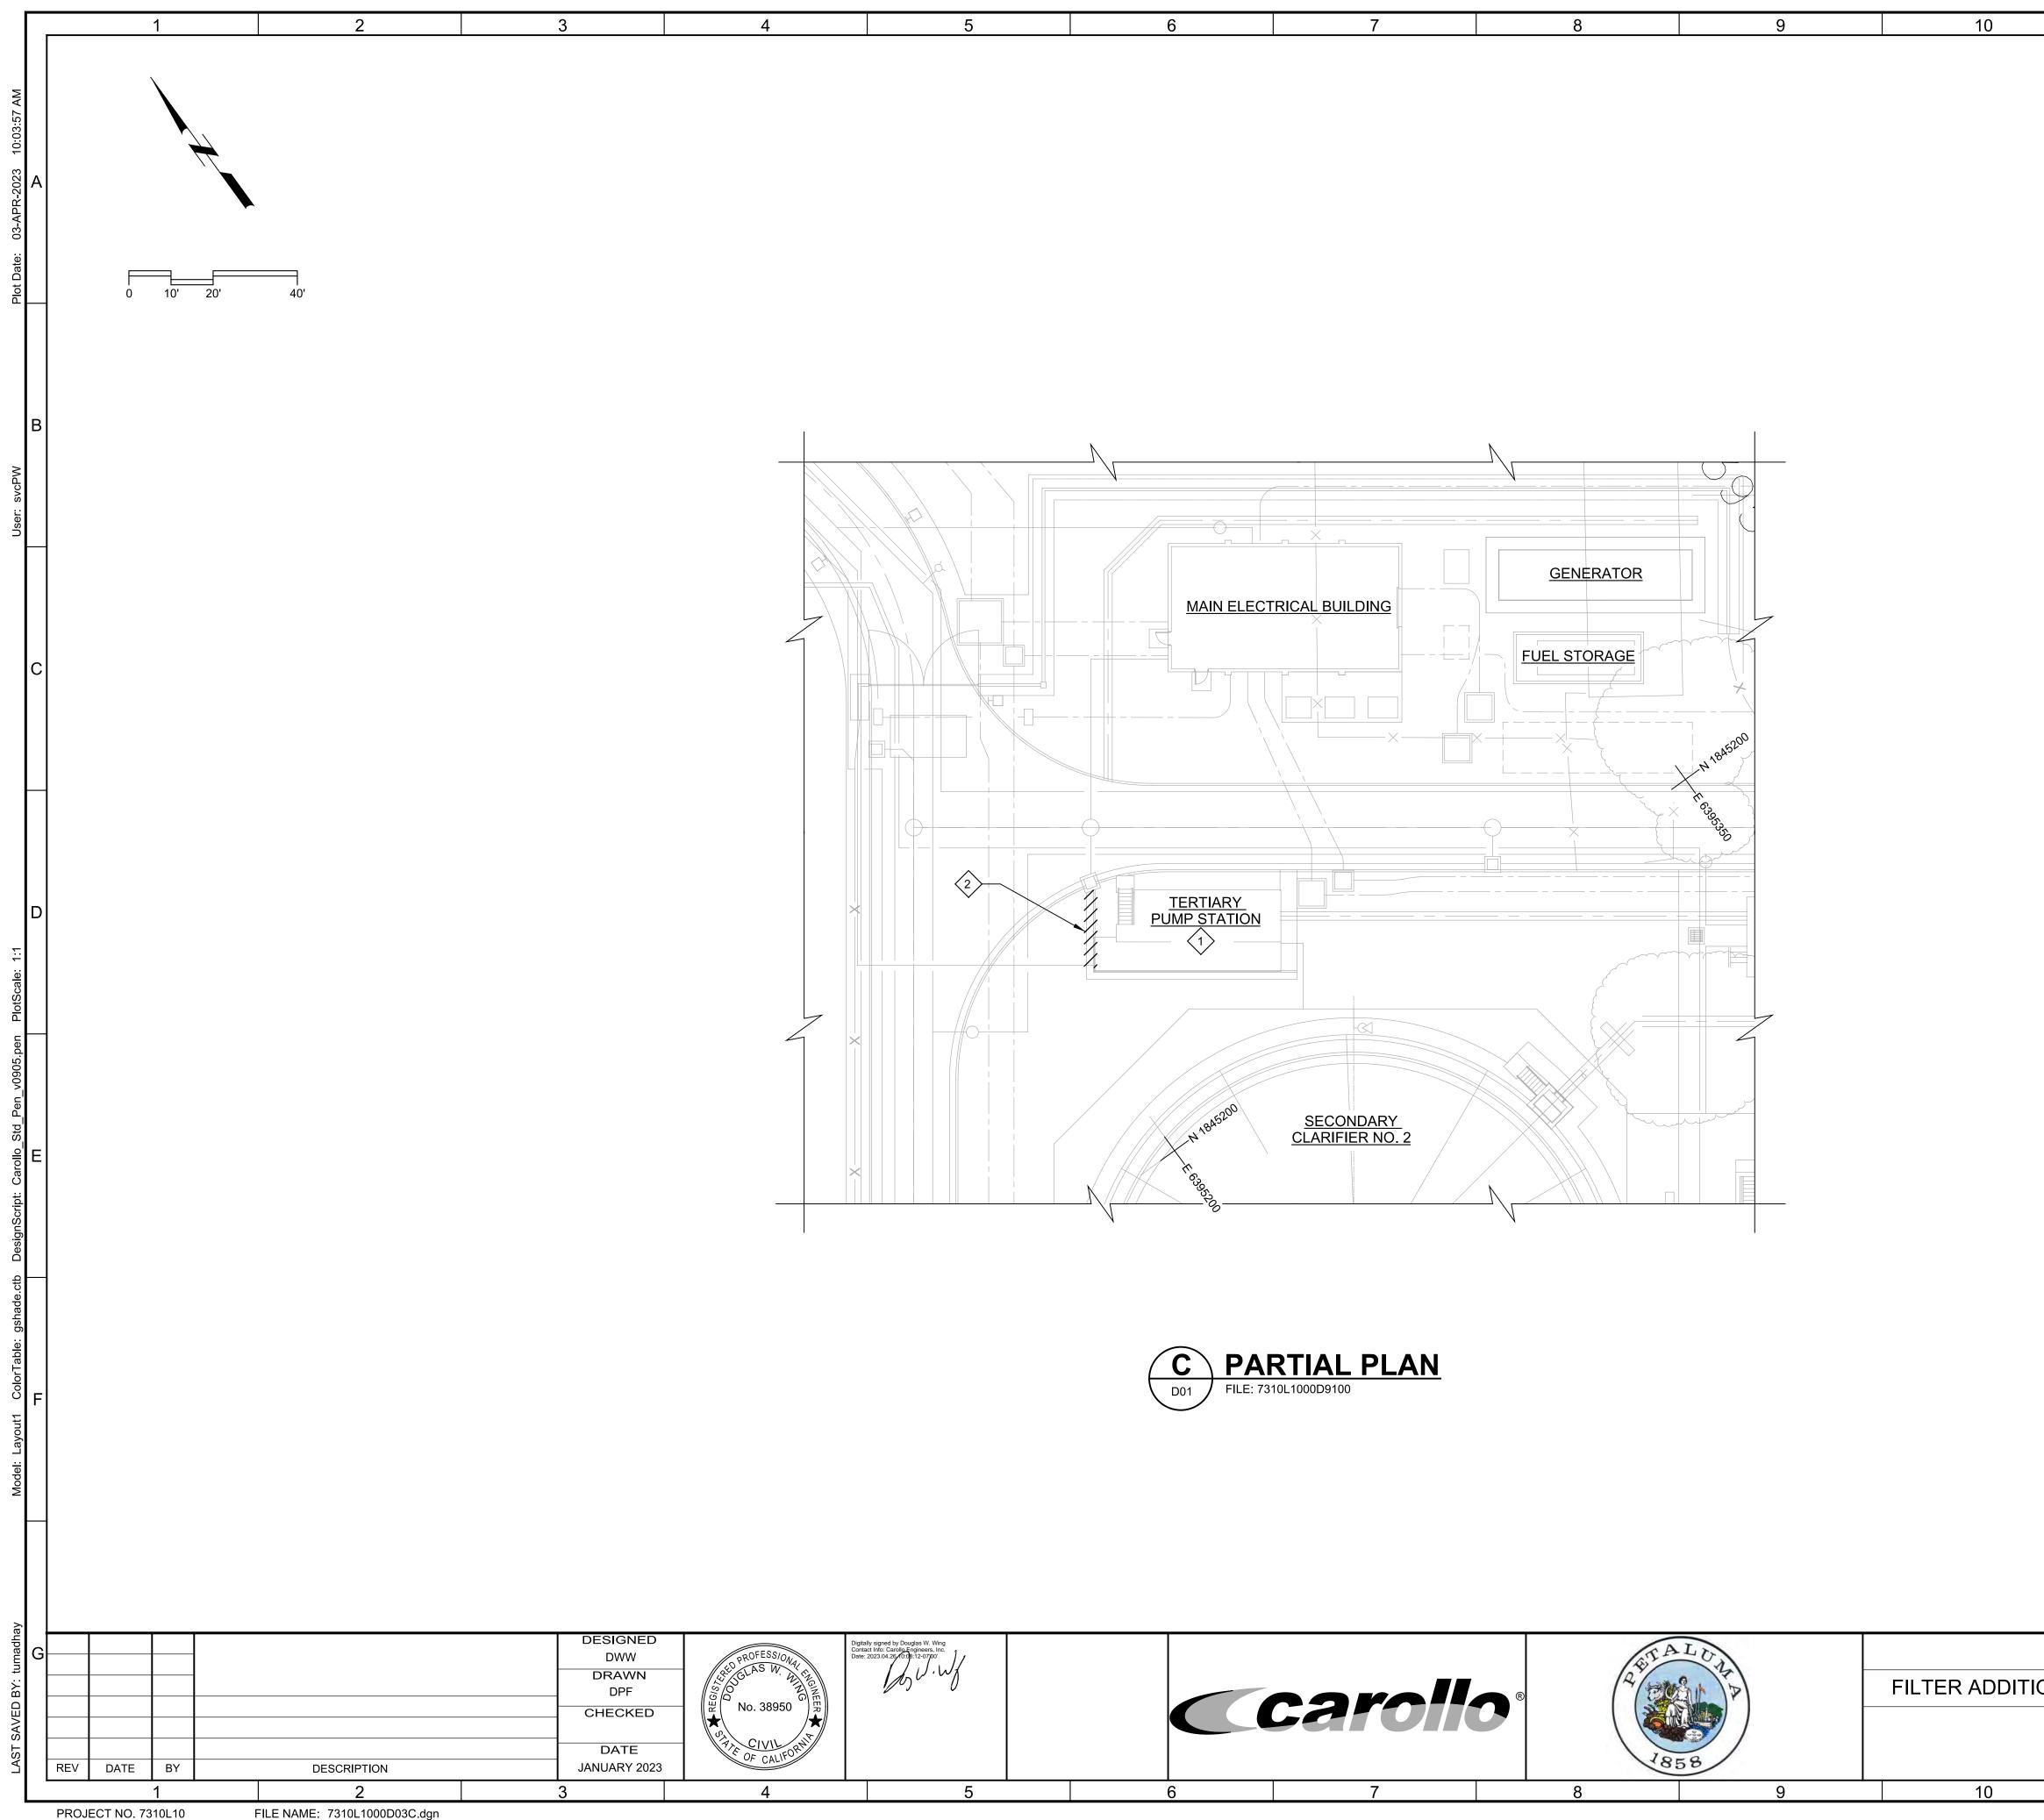
1. NOT ALL DEMOLITION WORK REQUIRED ON THIS PROJECT IS SHOWN ON THE DEMOLITION DRAWINGS. SEE OTHER CONTRACT DWGS FOR ADDITIONAL DEMOLITION WORK REQUIRED. SEE YARD PIPING DRAWINGS FOR BELOW GRADE PIPING DEMOLITION.

- 2. COORDINATE DEMOLITION WORK WITH SPECIFICATION SECTIONS 01140.
- 3. THE DEMOLITION DRAWINGS HEREIN ARE PROVIDED TO THE CONTRACTOR FOR REFERENCE IN DETERMINING THE SCOPE OF DEMOLITION REQUIRED. THE CONTRACTOR SHALL MAKE SUCH INVESTIGATIONS AS NECESSARY TO SATISFY HIMSELF AS TO FIELD CONDITIONS. THE USE OF THESE DRAWINGS SHALL BE AT CONTRACTOR'S DISCRETION. THE CONTRACTOR IS CAUTIONED TO REVIEW THE GENERAL CONDITIONS OUTLINED IN VOLUME.
- 4. ALL AREAS WHERE CONCRETE FILL IS CALLED FOR SHALL BE SANDBLASTED AND COATED WITH EPOXY BONDING AGENT PRIOR TO PLACING CONCRETE.
- 5. WHERE EQUIPMENT, BRACKETS, CLAMPS, ETC. ARE REMOVED. FASTENER SHALL BE CUT OFF 1/2-INCH BELOW SURFACE. PATCH HOLE WITH NON-SHRINK GROUT.
- 6. SALVAGE EQUIPMENT PER OWNER'S INSTRUCTION.
- 7. PROVIDE 30 DAYS WRITTEN NOTICE TO OWNER PRIOR TO DEMOLISHING ANY STRUCTURE OR BUILDING.
- 8. DISCONNECT AND REMOVE POWER AND CONTROL WIRING BETWEEN THE DEMOLISHED EQUIPMENT AND IT'S ASSOCIATED MCC OR CONTROL PANEL. PALLETIZE CONDUITS AND WIRES AND RETURN TO OWNER.
- REFER TO SPEC SECTION 02200 FOR CLEARING, GRUBBING, AND 9. STRIPPING REQUIREMENTS.
- 10. SITE DEMOLITION WILL IMPACT EXISTING DRAINAGE PATTERNS. MAINTAIN SITE DRAINAGE PATTERNS DURING CONSTRUCTION. REROUTE EARTHEN SWALES AND PROVIDE TEMPORARY FACILITIES AS NECESSARY.

CITY OF PETALUMA		VERIFY SCALES	JOB NO. 7310L.10	G
ION AND MISC. IMPROVEN	IENTS PROJECT	BAR IS ONE INCH ON ORIGINAL DRAWING	DRAWING NO.	
DEMOLITION	0 1"	D01C		
OVERALL SITE PLAN	J	IF NOT ONE INCH ON THIS SHEET, ADJUST	SHEET NO.	
		SCALES ACCORDINGLY	42 OF 130	
11	12	13		



11	12	13	
	$\frac{\text{KEY NOTES:}}{1}$ $\frac{1}{2}$ SEE DRAWING 06D02 FOF $\frac{2}{2}$ NOT USED. $\frac{3}{3}$ NOT USED.	ON NOTES, REFER TO DRAWING D01C. R DEMOLITION IN THIS AREA. CESSARY FOR NEW SWALE.	A
	* •	ATCH BASIN RELOCATION.	В
N 184559			С
FILTER SUPPORT BUILDING	N 1845440		D
E MATCH LINE A	- K GBARA		. E
			F
CITY OF PETALUMA FION AND MISC. IMPROVEN DEMOLITION PARTIAL SITE PLAN		VERIFY SCALES BAR IS ONE INCH ON ORIGINAL DRAWING 0 IF NOT ONE INCH ON THIS SHEET, ADJUST JOB NO. 7310L.10 DRAWING NO DRAWING NO SHEET NO.	G
11	12	SCALES ACCORDINGLY 43 OF 130 13	



FILE NAME: 7310L1000D03C.dgn

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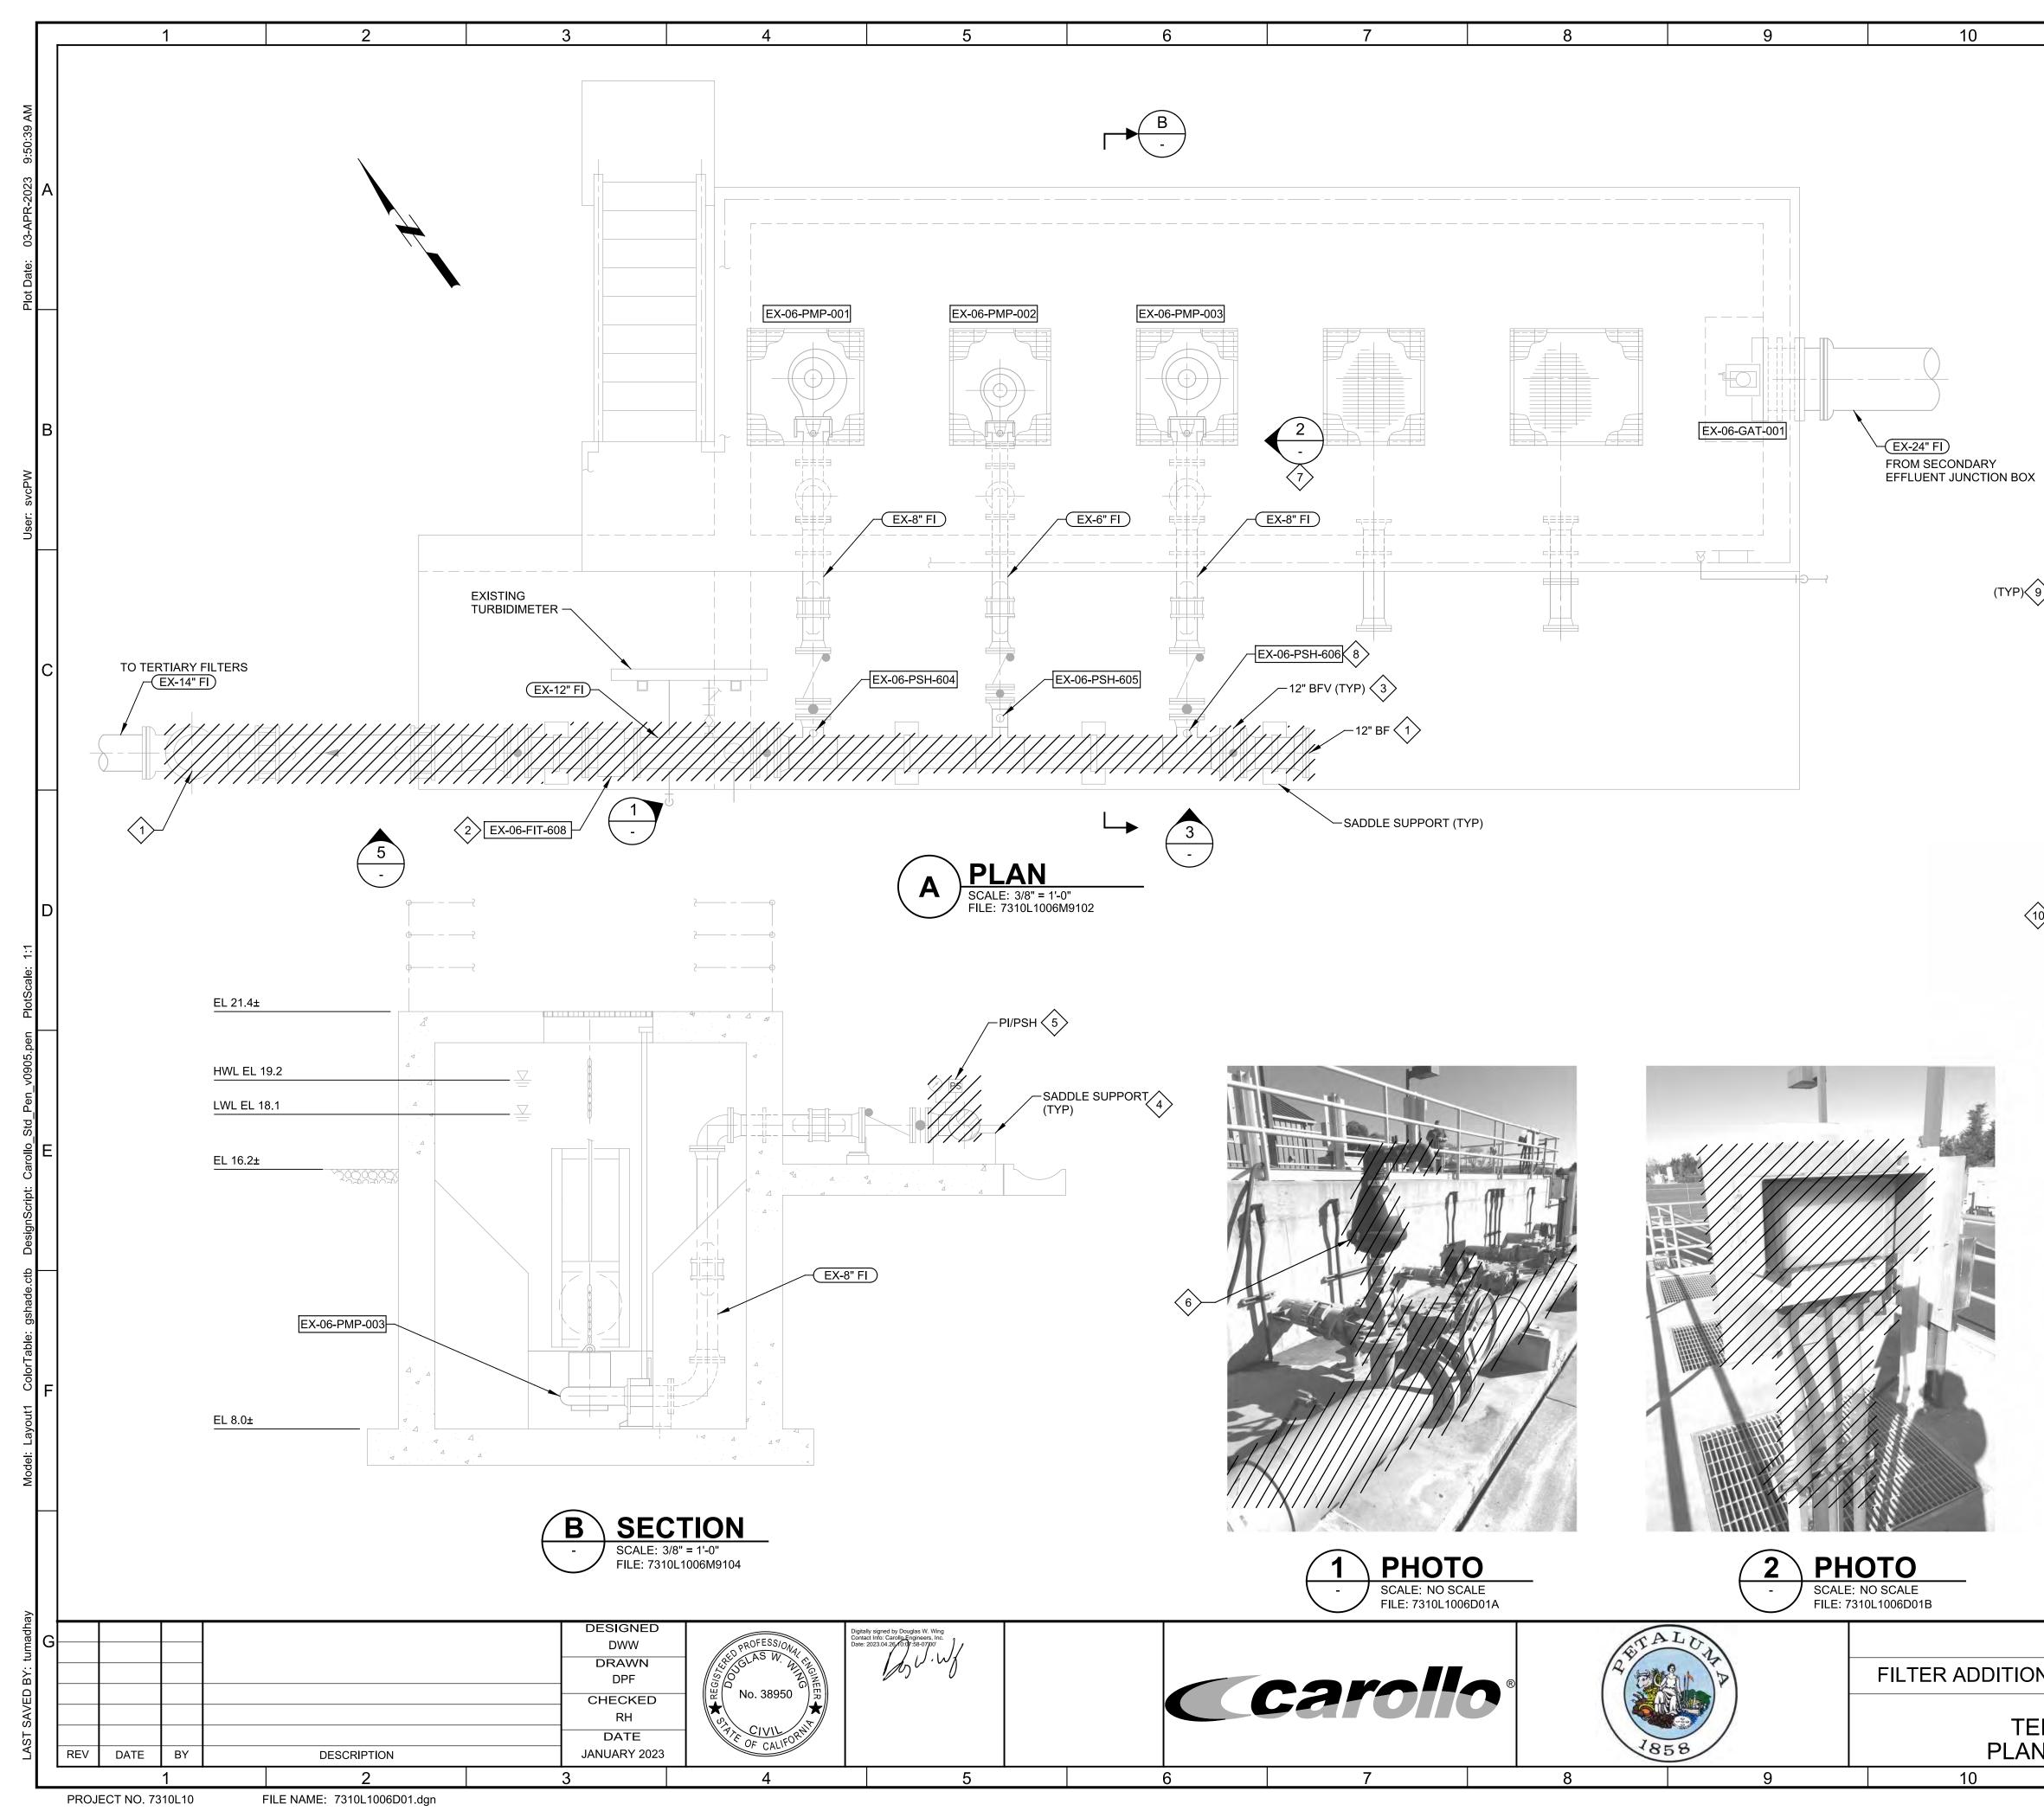
11	12	13
	GENERAL NOTES:	
	1. FOR GENERAL DEMOLITIO	N NOTES, REFER TO DRAWING D01C.

KEY NOTES:

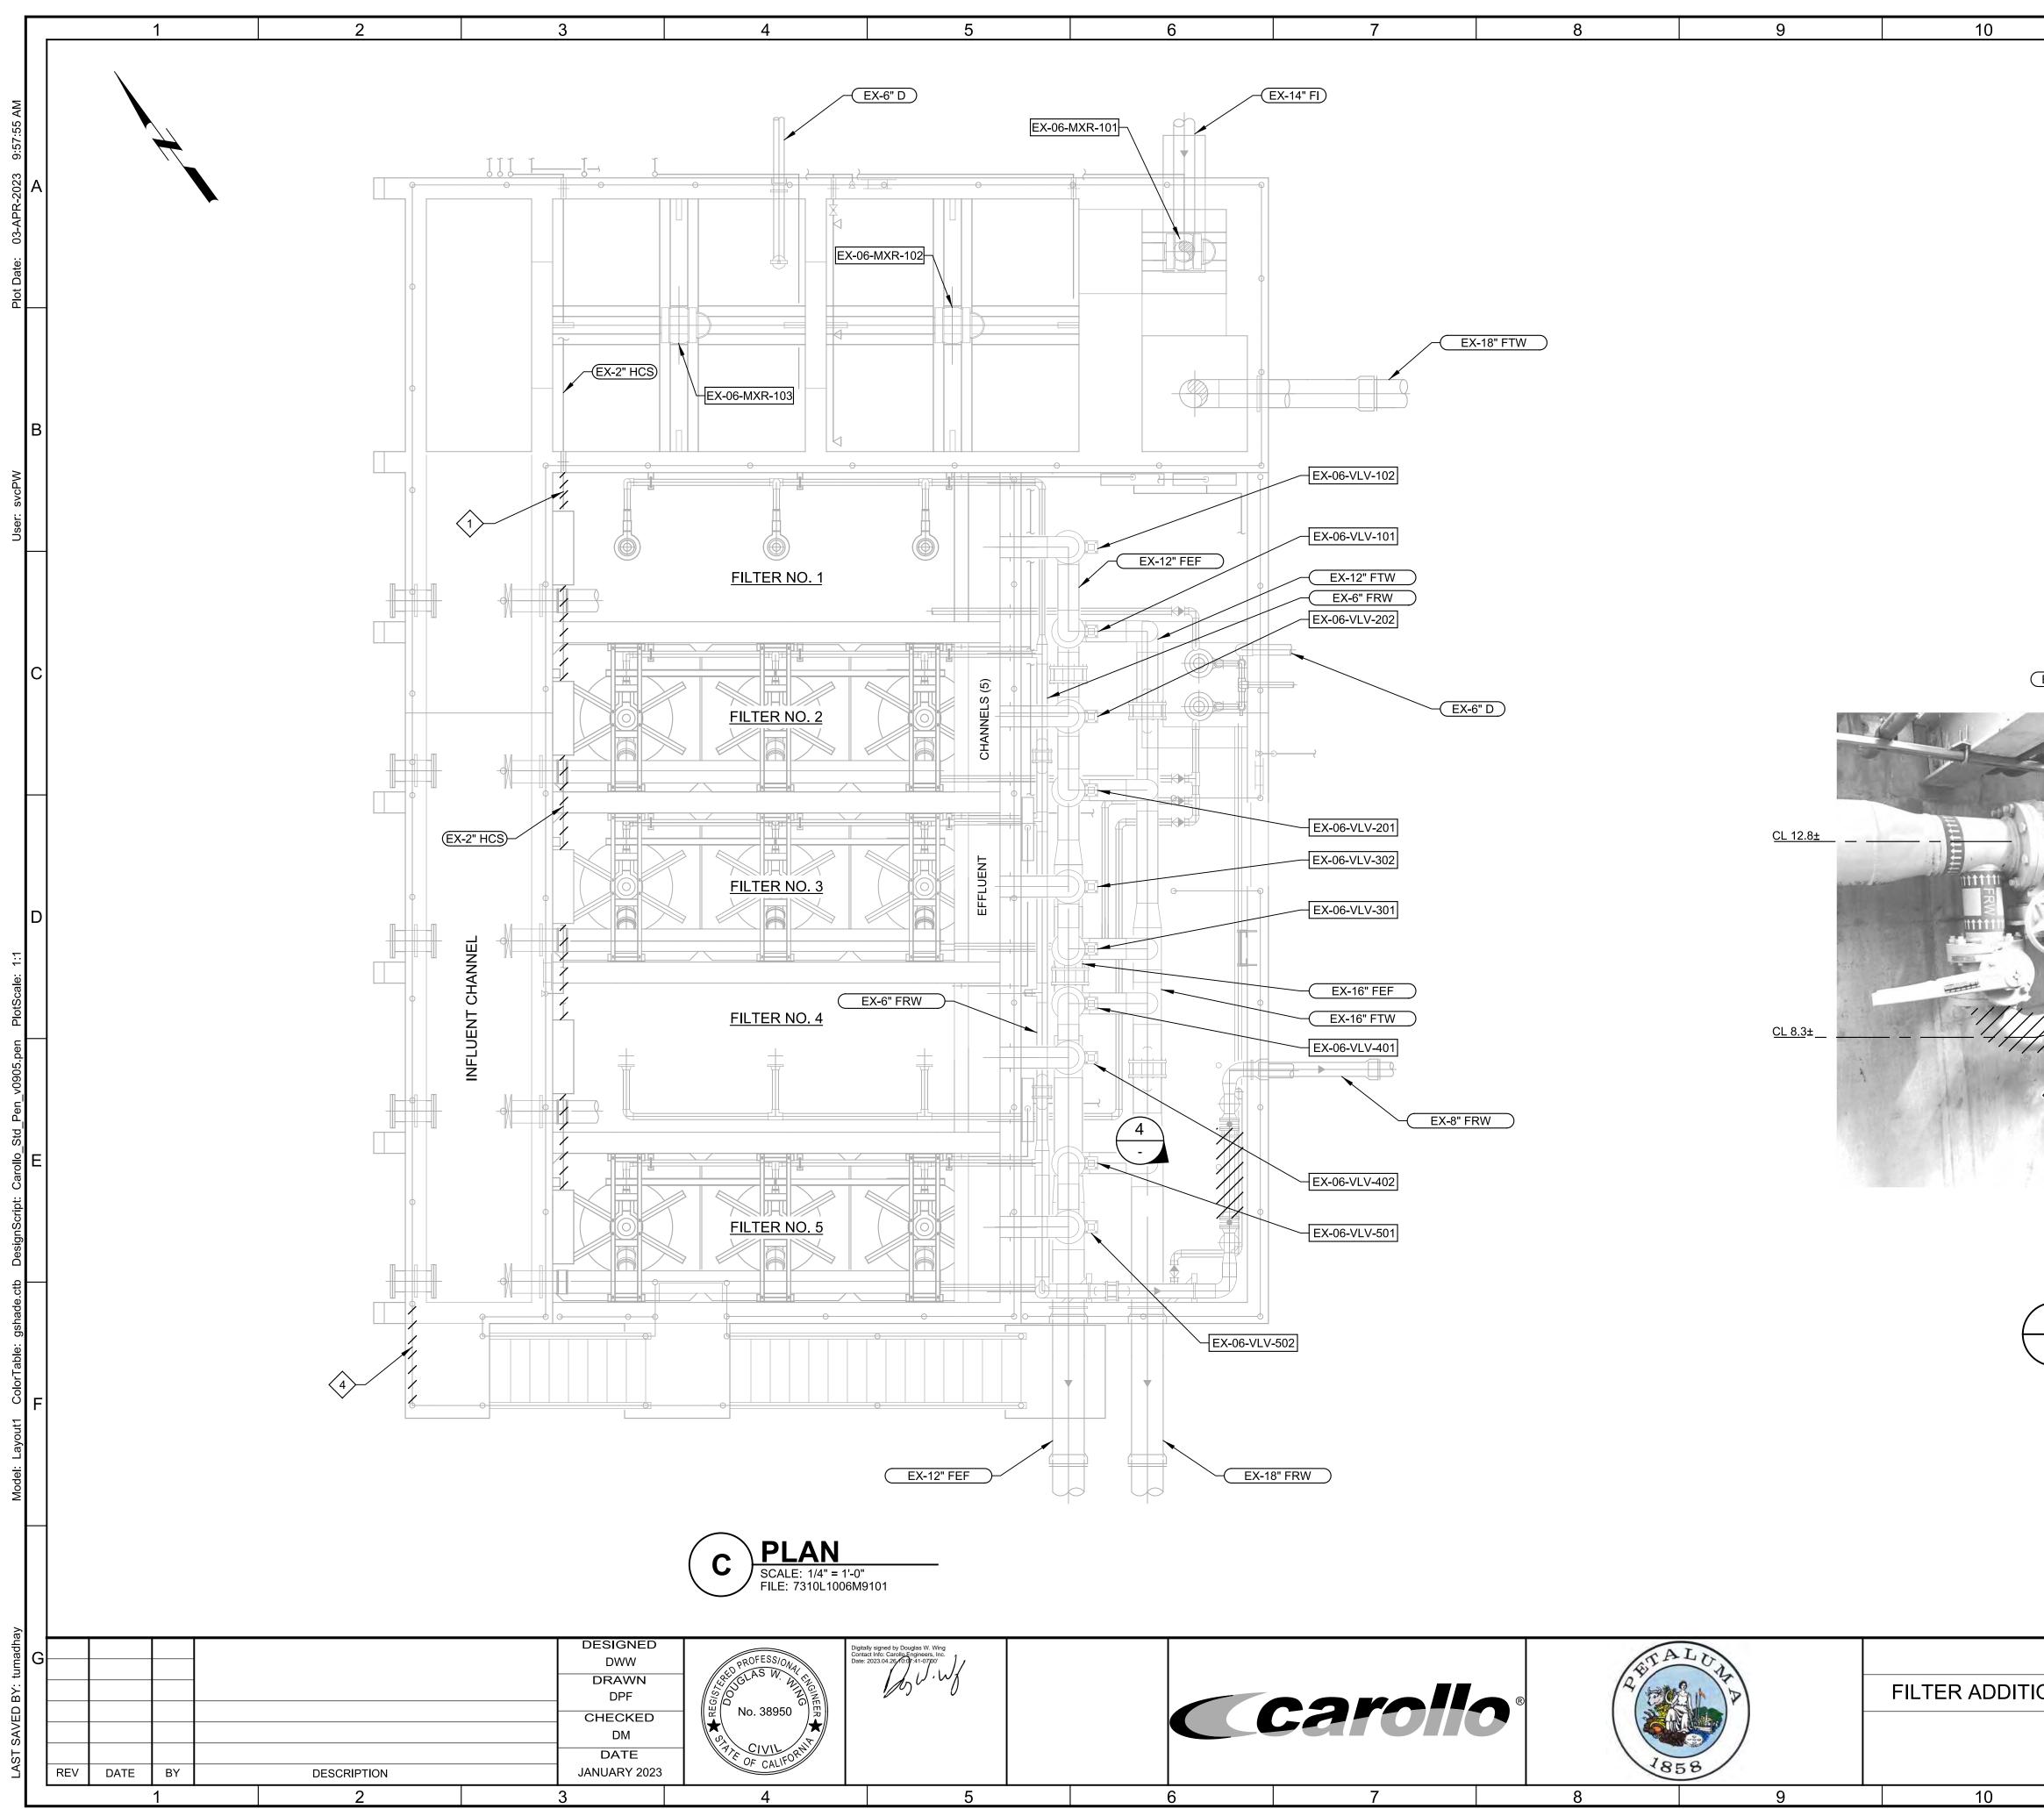
1 SEE DRAWING 06D01 FOR DEMOLITION IN THIS AREA.

DEMOLISH CONCRETE SWALE. LIMIT TO MATCH NEW EQUPMENT PAD. REFERENCE DRAWING 06M01.

CITY OF PETALL	VERIFY SCALES	JOB NO. 7310L.10	G	
ION AND MISC. IMPR	BAR IS ONE INCH ON ORIGINAL DRAWING			
DEMOLITION	0 1"	D03C		
PARTIAL SITE PL	IF NOT ONE INCH ON THIS SHEET, ADJUST	SHEET NO.		
	SCALES ACCORDINGLY	44 OF 130		
11	12	13		_



11	12		13		$\overline{1}$
GENERAL NOTES: 1. FOR GENERAL DEMOLIT		RAWING D01C			
KEY NOTES:					
DEMOLISH EXISTING FI			W GRADE TO BLIN	ND FLANGE.	
2 DEMOLISH EXISTING 12"	MAGNETIC FLOWMETER		RIGID CONDUIT	AND WIRING	A
FOR CONNECTION TO T		WNER'S DISCRE	TION.		
4 REMOVE TOP STRAP, RE				ALLATION.	
5 DEMOLISH EXISTING PI/I	PSH AS SHOWN.				
6 REMOVE AIR RELEASE \					$\left - \right $
\[\] \[ENSOR AND LEVEL TRAN	ISMITTER. PROTE	ECT THE CONDUIT	ΓAND	
8DEMOLISH THE PRESSUASSEMBLY. DEMOLISH TBOX ON TOP OF THE WE	HE PRESSURE SWITCH				
9 REMOVE AND REPLACE					В
X	WALE. LIMIT TO MATCH	NEW EQUIPMENT	PAD. SEE DRAW	ING 06M01.	
				1	с
	A A A A A A A A A A A A A A A A A A A	THU.			
10 5	<u> PHOTO</u>				D
	SCALE: NO SCALE FILE: 7310L1006D01	D			
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				4	Н
	PHOTO SCALE: NO SCALE				
	FILE: 7310L1006D01			JOB NO.	¦ ∣
		BAR IS ON		7310L.10 AWING NO.	G
DN AND MISC. IMPROVEME	NIS PROJEC			06D01	
ERTIARY PUMP STATIO		THIS SHEE	ET, ADJUST	HEET NO.	
N, SECTION, AND PHO	<u>12</u>	SCALES AC	CORDINGLY 45	5 OF 130	
	12		10		

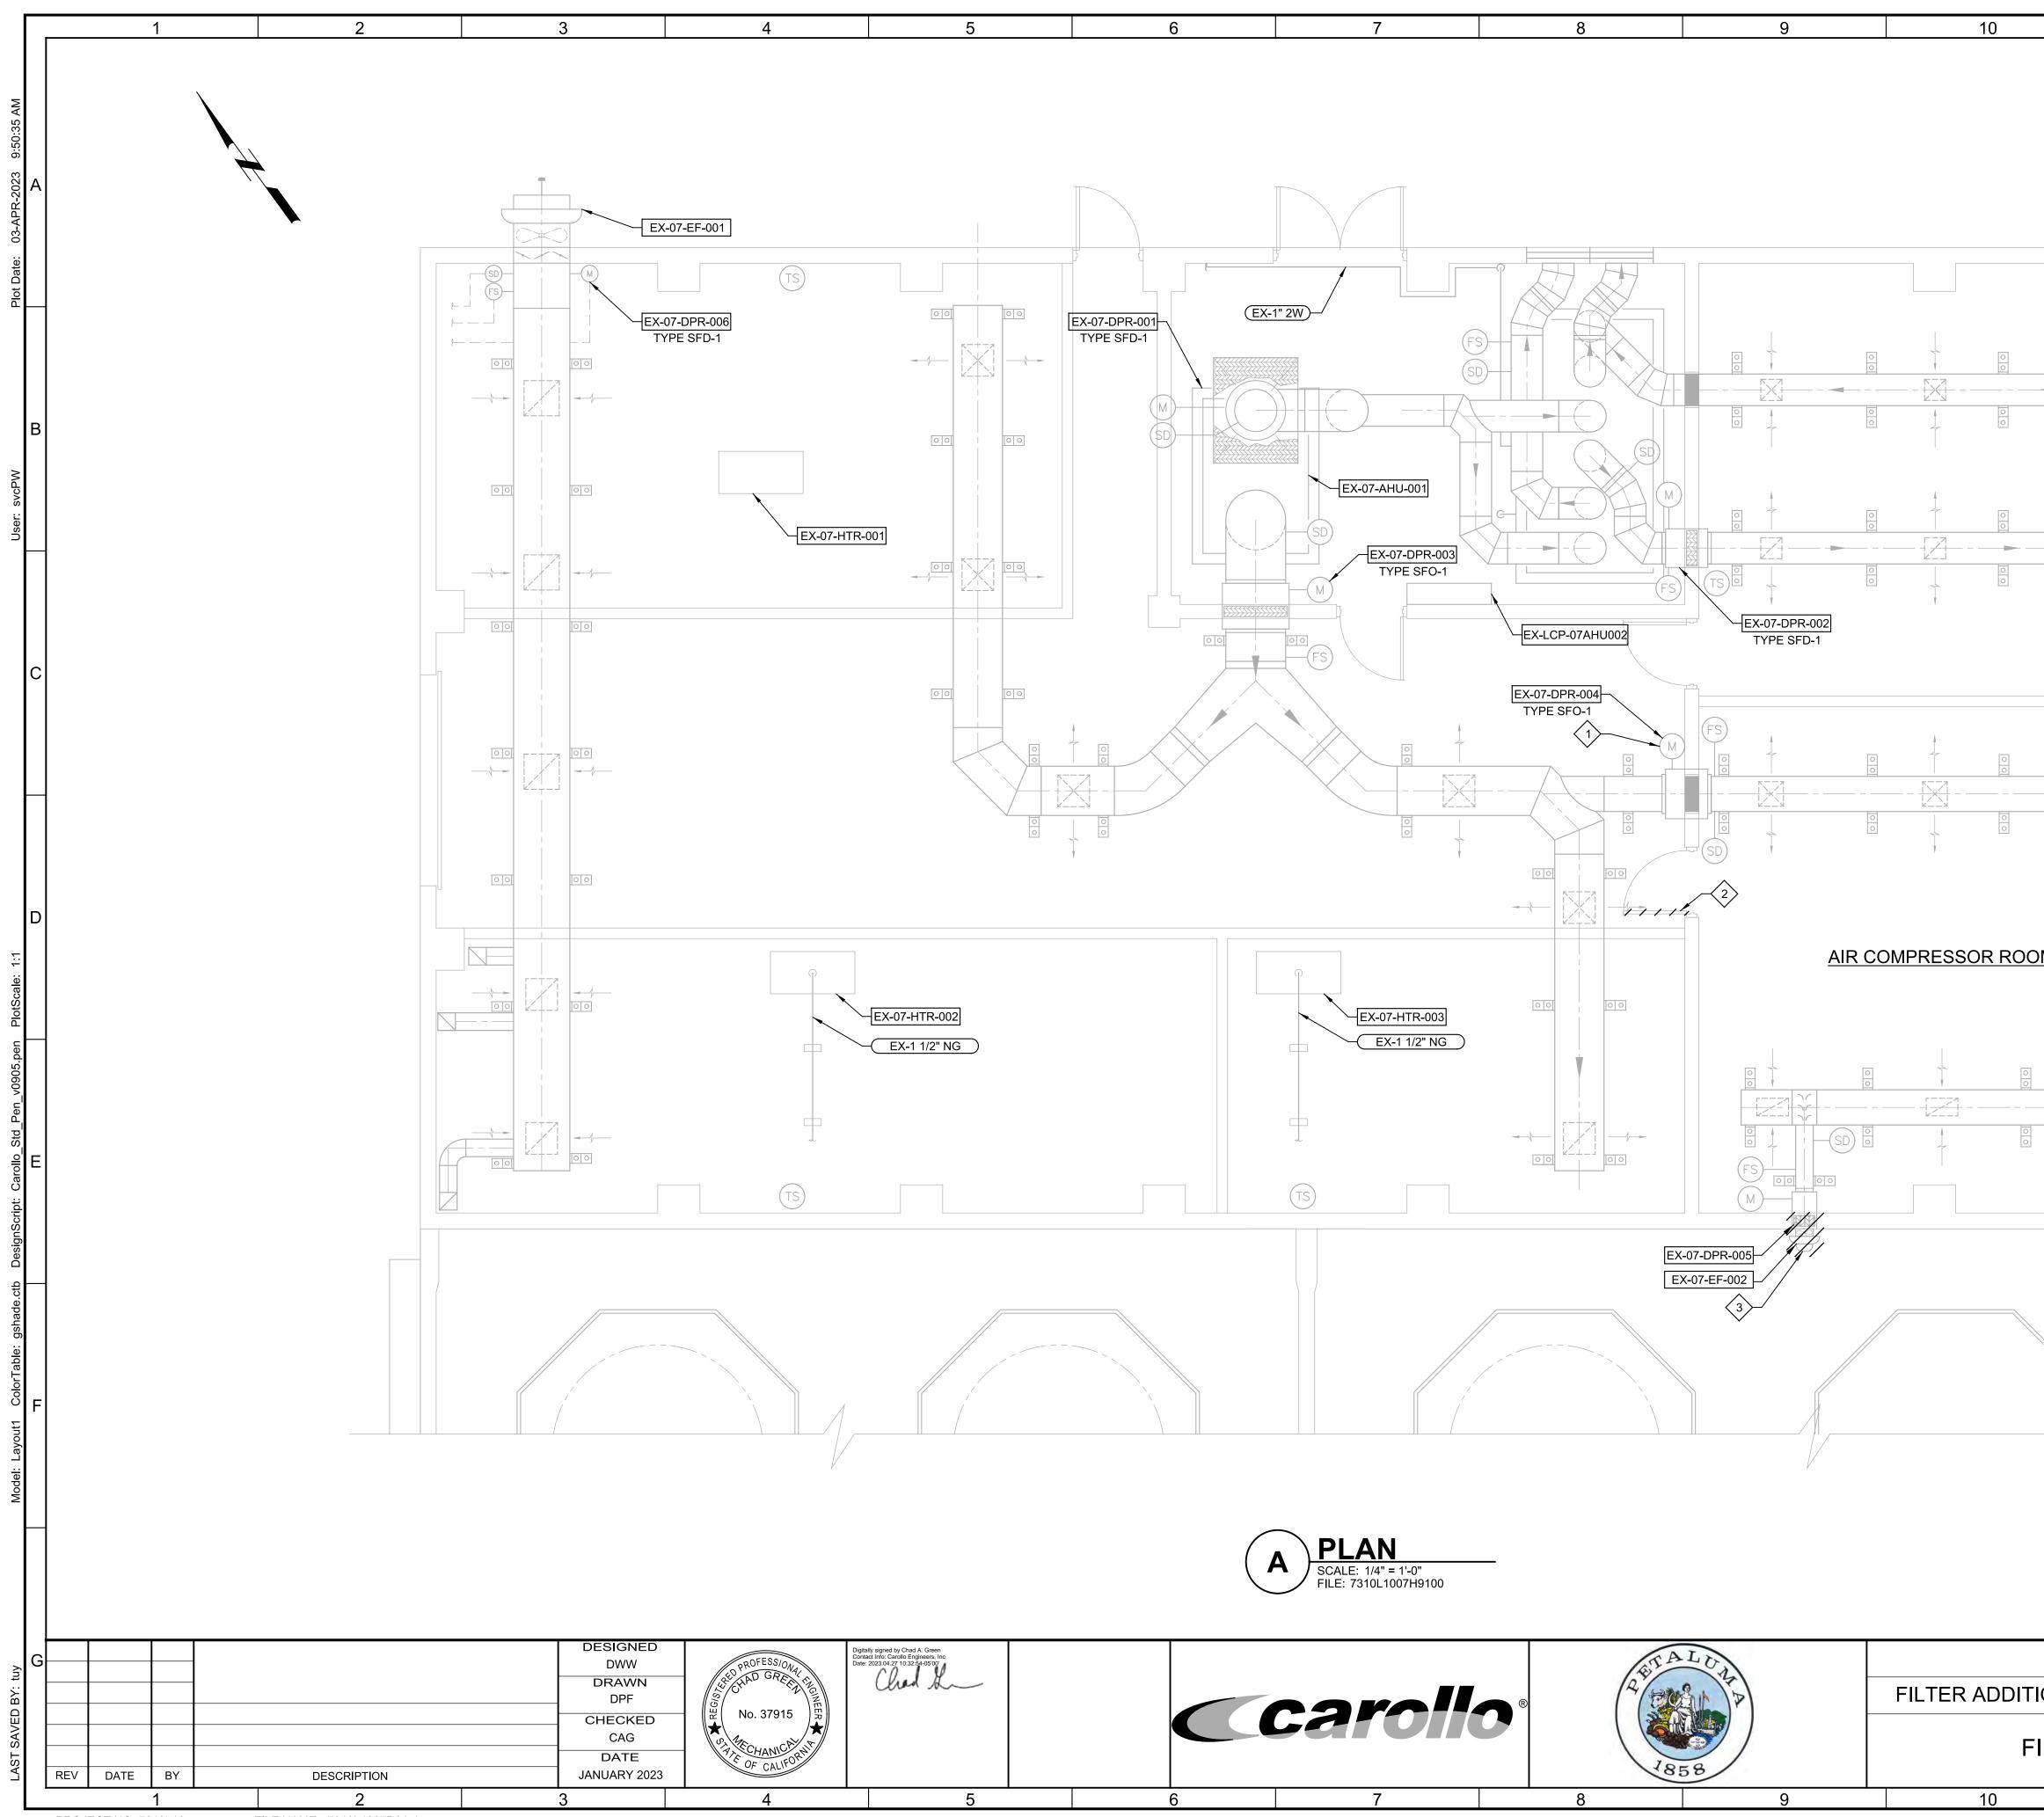


FILE NAME: 7310L1006D02.dgn

	11	12	13	1	
		GENERAL NOTES: 1. FOR GENERAL DEMOLITIC	ON NOTES, REFER TO DRAWING D01C.		
		$\frac{\text{KEY NOTES:}}{1}$ DEMOLISH EXISTING 2" HO	CS PIPING FOR FILTERS NOS. 1-5.	A	
		2 SALVAGE EXISTING 4" MA FLOW METER AT OWNER			
		3 REMOVE AND RETAIN EXIS FASTENERS AND RETAIN	STING PIPE SUPPORT STRAP AND FOR REINSTALLATION.		
		4 DEMOLISH EXISTING GUA ACCOMMODATE NEW STA			
				B	
EX-6" FI	\supset	EX-8" FRW	\supset	c	
/	- server				
11	Internet				
R		Company in the		D	
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114	AAAA				
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	a a land		~2>	E	
	(EX-3" D)	TOC 7.5±			
4	PHOTO SCALE: NO SCALE FILE: 7310L1006D02A				
\bigcirc				 F	
			VERIFY SCALES JOB NO. 7310L.10 BAR IS ONE INCH ON ORIGINAL DRAWING DRAWING NO.	G	
	ND MISC. IMPROVEN		0 miginal drawing 0 drawing no.		
	RTIARY FILTERS 1- PLAN AND PHOTO	-5	IF NOT ONE INCH ON THIS SHEET, ADJUST SCALES ACCORDINGLY 46 OF 130	1	
•	11	12	13	1	ĺ

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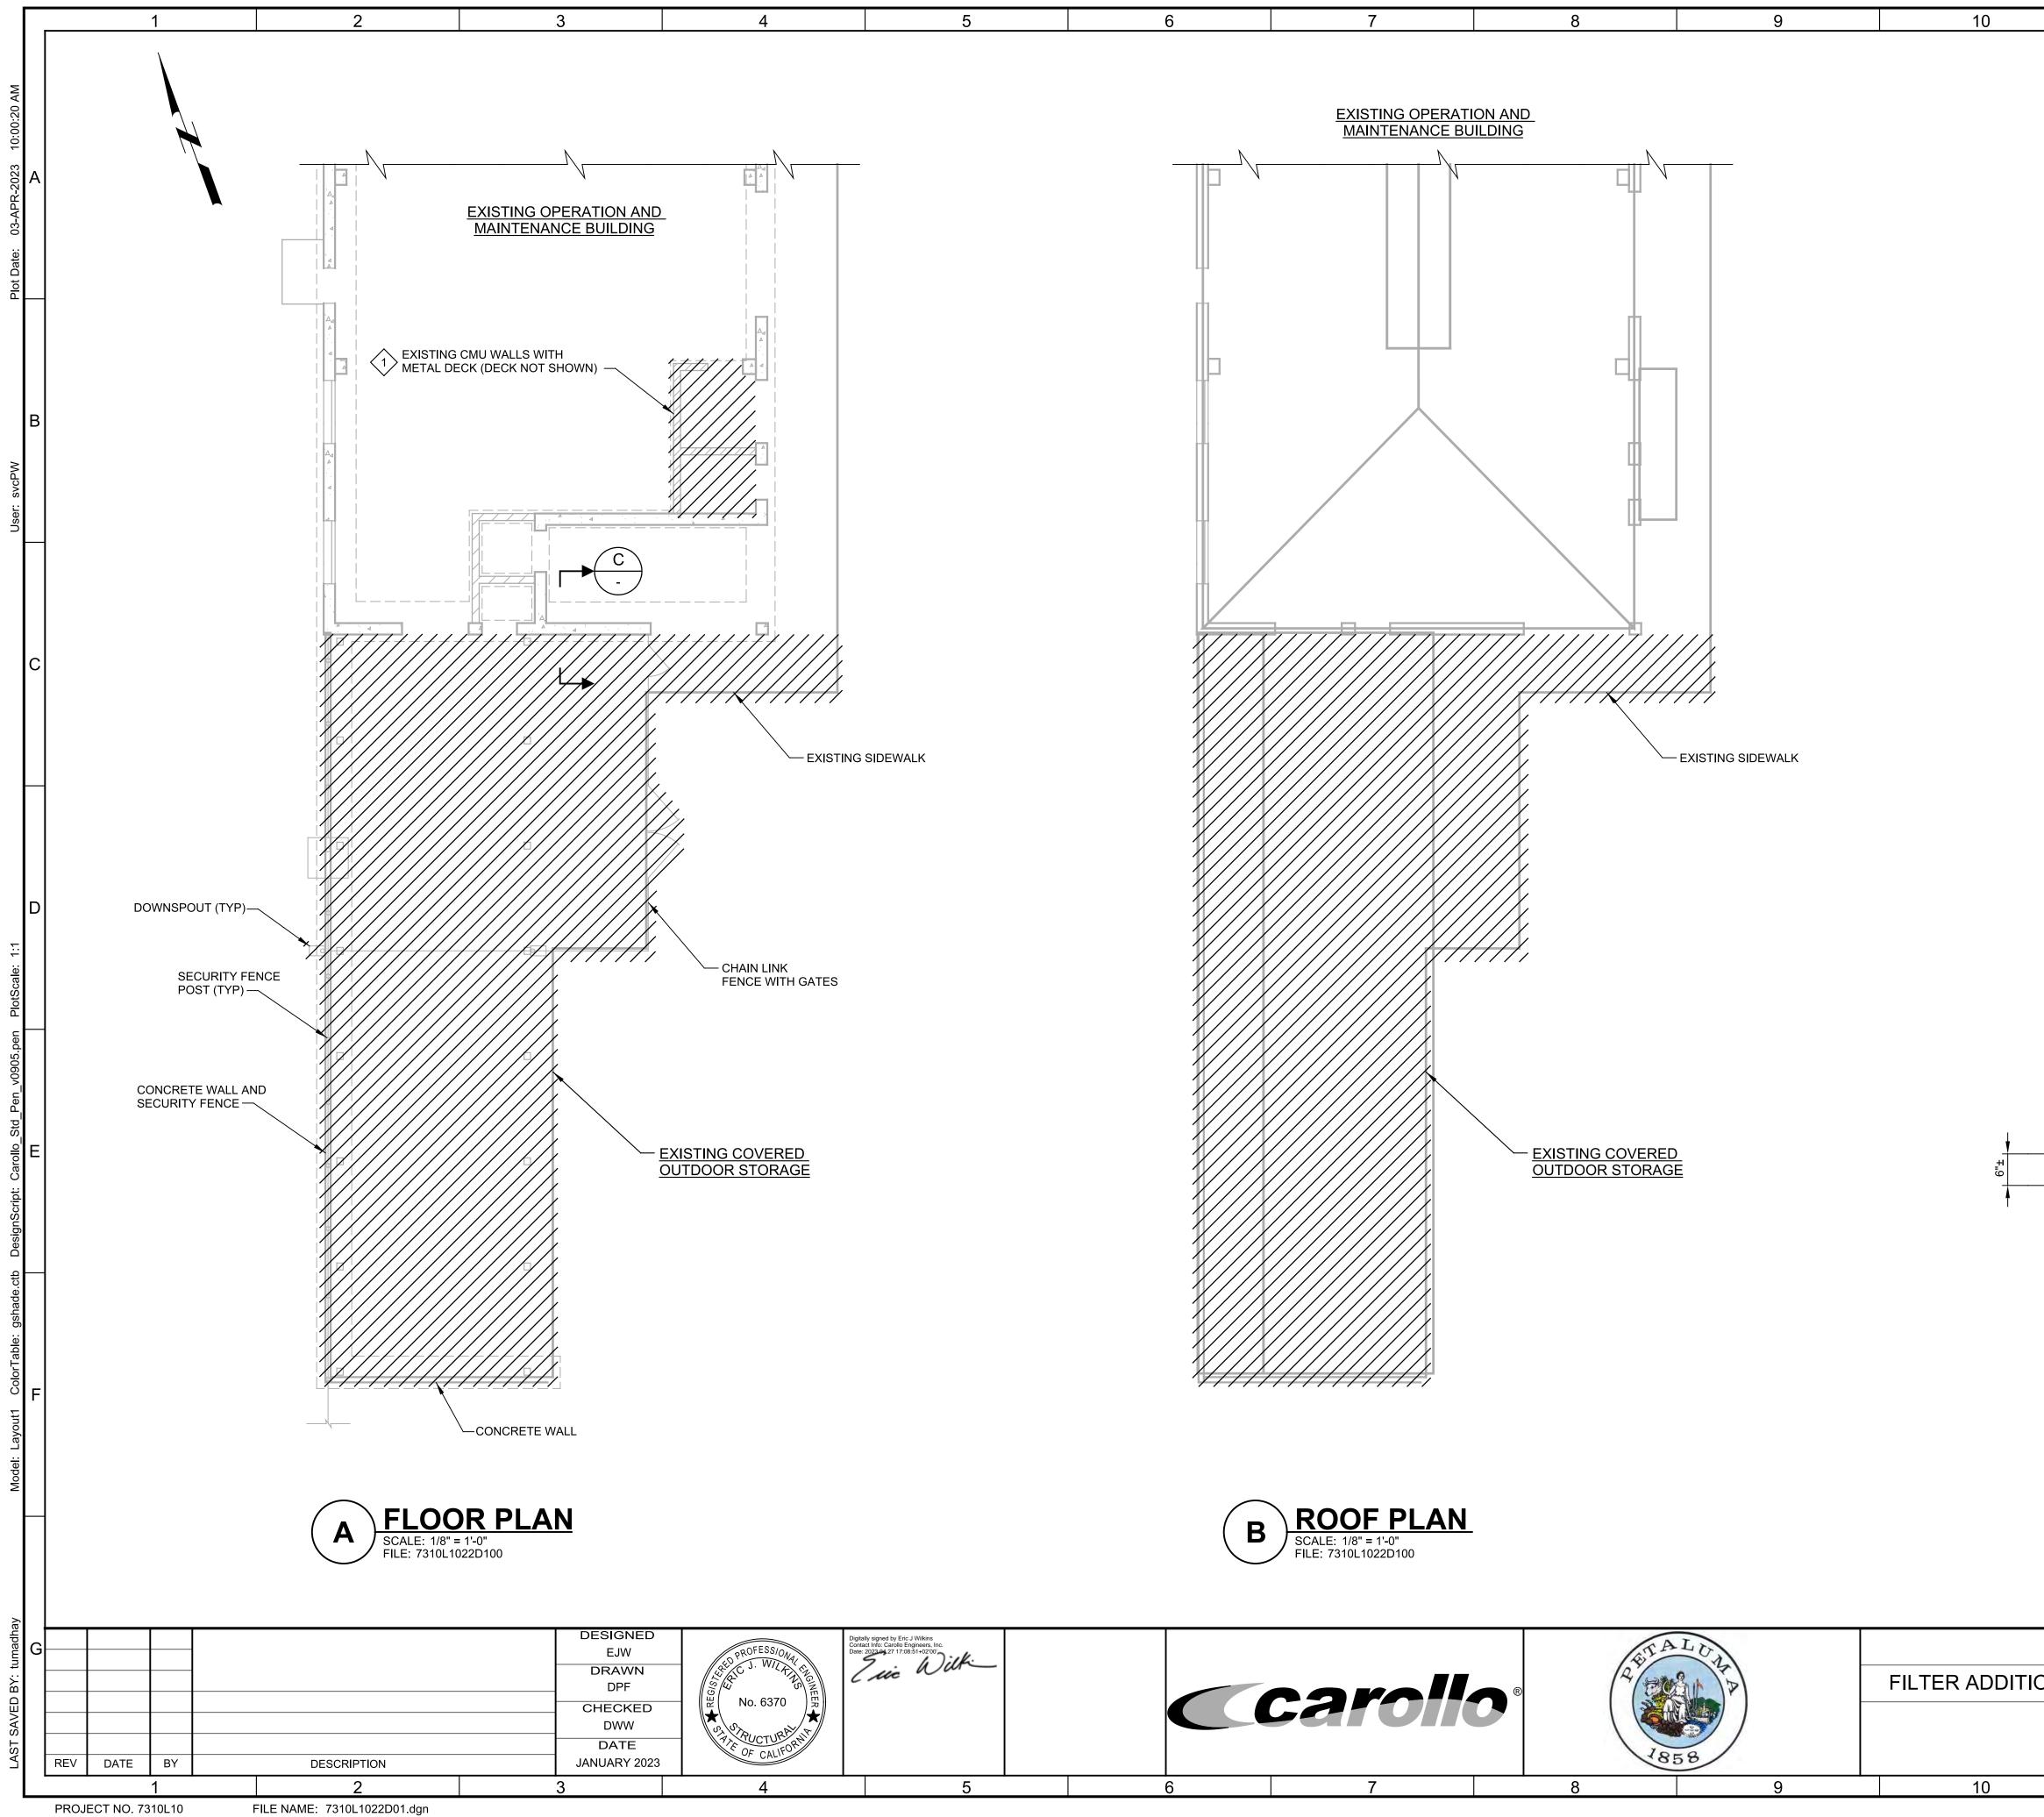
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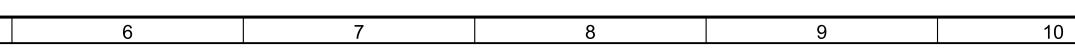
11	12	13	
		ENERAL NOTES:	
	1.		
	2.	KIND OR REPAIR EXISTING ITEMS DAMAGED BY THE CONTRACTOR'S ACTIVITIES. NOT ALL THE EXISTING ITEMS ARE SHOWN ON THE DRAWINGS.	A
	3.	 a. FIELD-VERIFY ALL EXISTING DIMENSIONS, ELEVATIONS, AND CONDITIONS PRIOR TO DEMOLITION, SHOP DRAWING PREPARATION, AND FABRICATION. b. NOTIFY ENGINEER IMMEDIATELY IF CONDITIONS NOT COVERED BY THESE DRAWINGS ARE EXPOSED DURING CONSTRUCTION INCLUDING BUT NOT LIMITED TO: 	В
		KEY NOTES:	с
	\checkmark	DAMPER IN THE FULLY OPEN POSITION. DISABLE ELECTRICAL CONTROL TO THE DAMPER. > DEMOLISH AND REPLACE EXISTING	
	$\langle 3 \rangle$	DOOR WITH NEW LOUVERED DOOR. REFER TO ARCHITECTURAL SHEETS FOR REPLACEMENT DOOR DETAILS.	
<u>MC</u>	~	EXHAUST FAN AND CONTROLS. REFER TO HVAC SHEETS FOR NEW WALL MOUNT EXHAUST FAN INSTALLATION AND DETAILS.	D
			E
			F
		VERIFY SCALES JOB NO.	
CITY OF PETALUMA		BAR IS ONE INCH ON	G
FILTER SUPPORT BUILD HVAC PLAN		0 1" 07D01 IF NOT ONE INCH ON THIS SHEET, ADJUST SCALES ACCORDINGLY 47 OF 130	
4.4	40	40	ľ

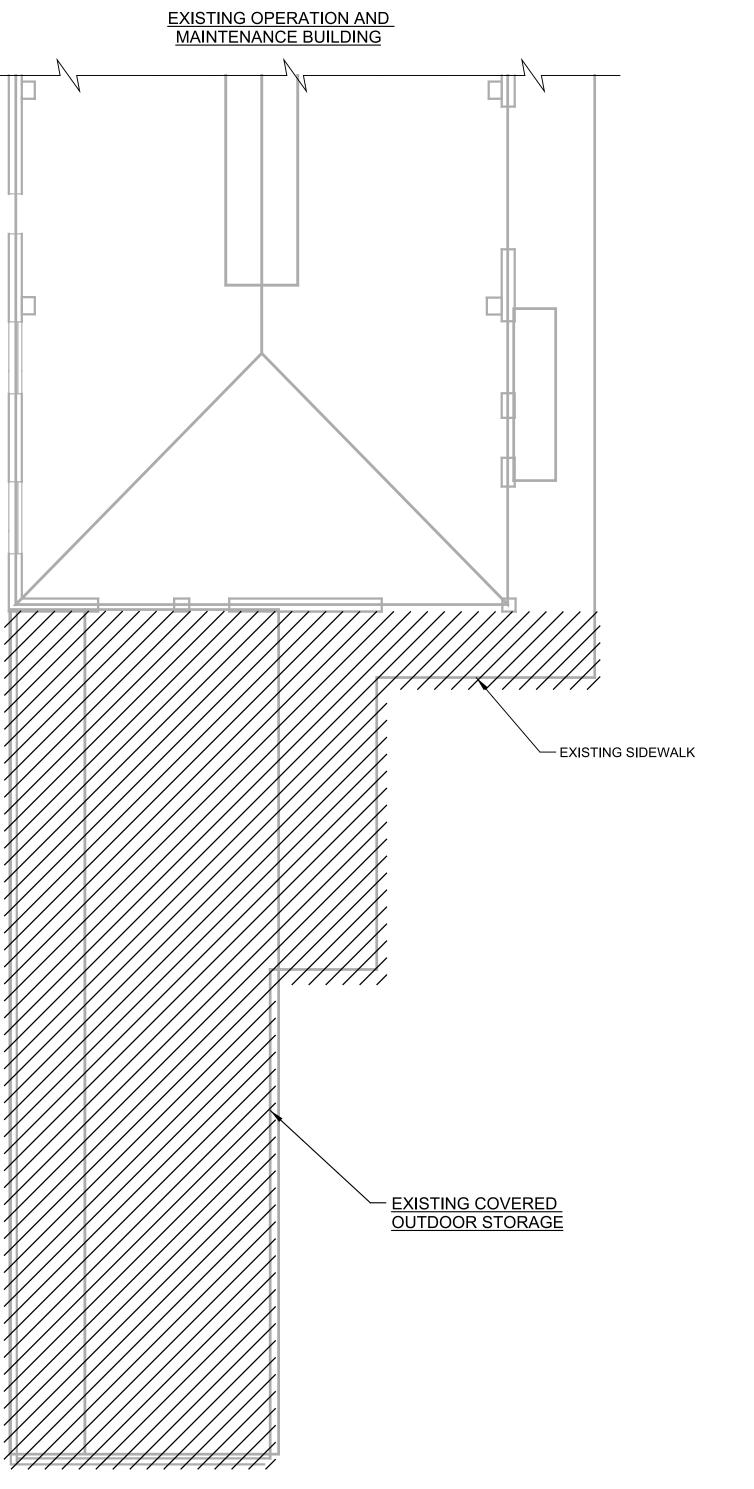
FILTER SUPPORT BUILDING HVAC PLAN

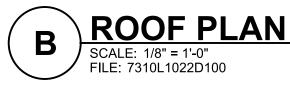
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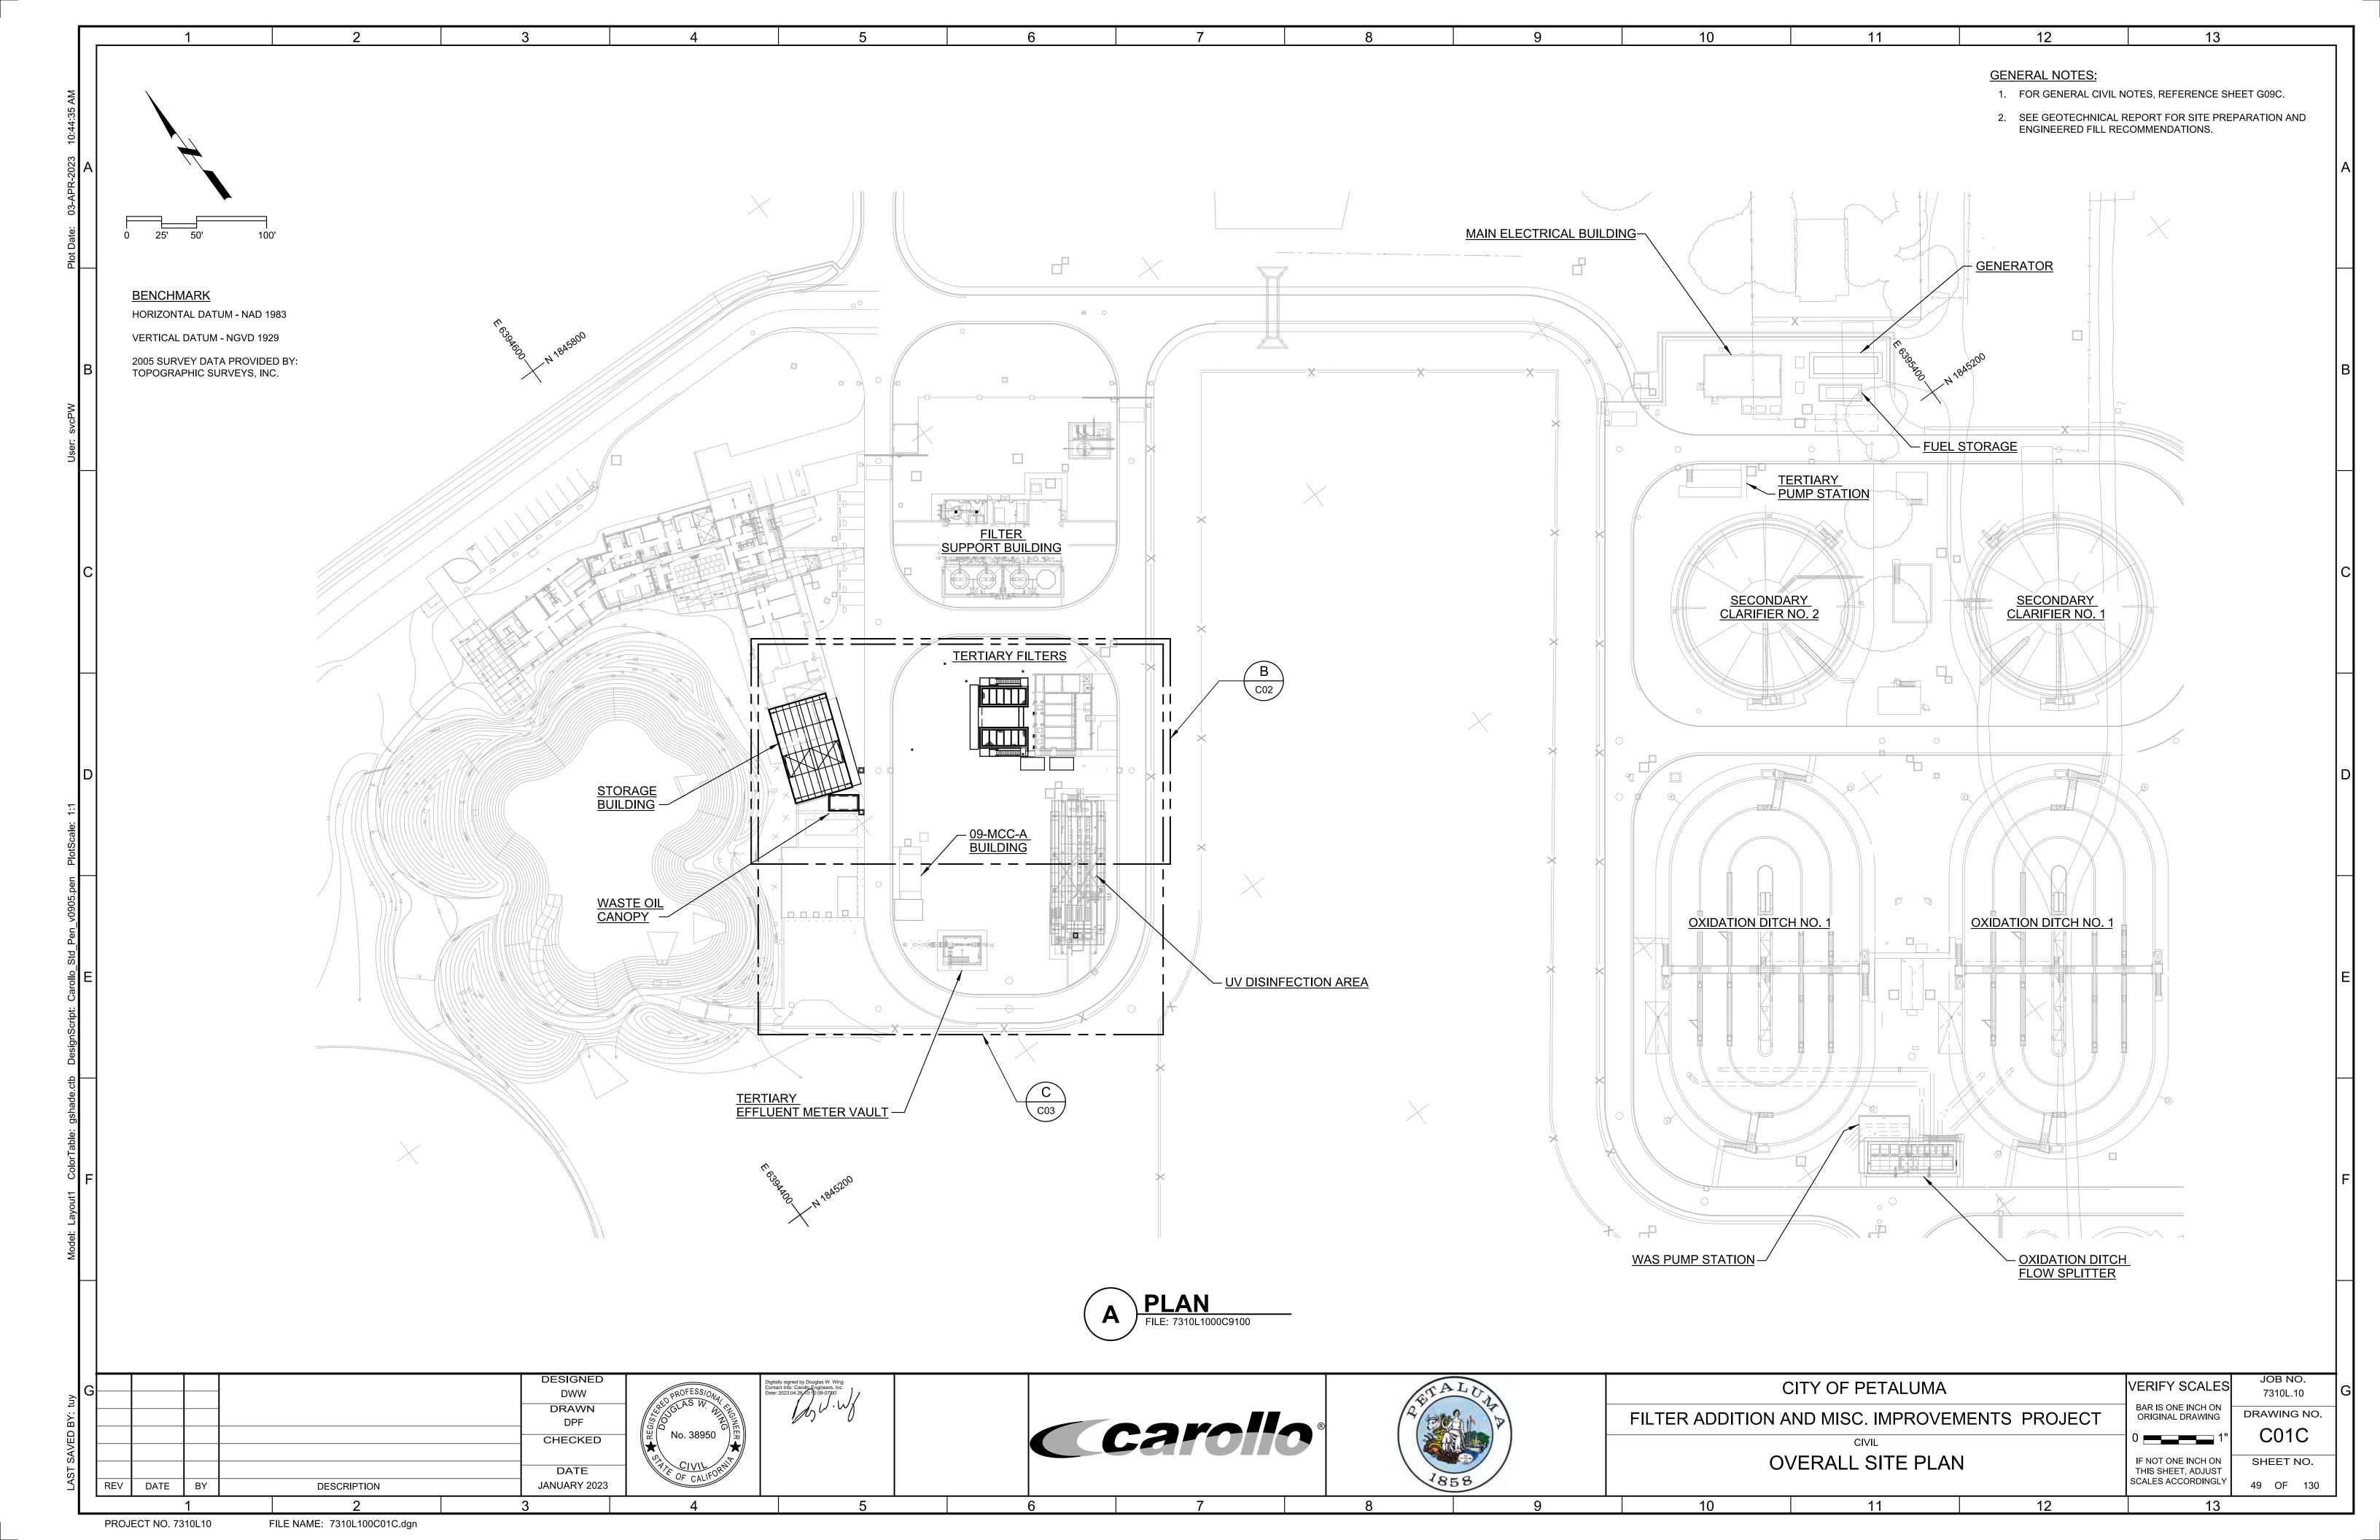


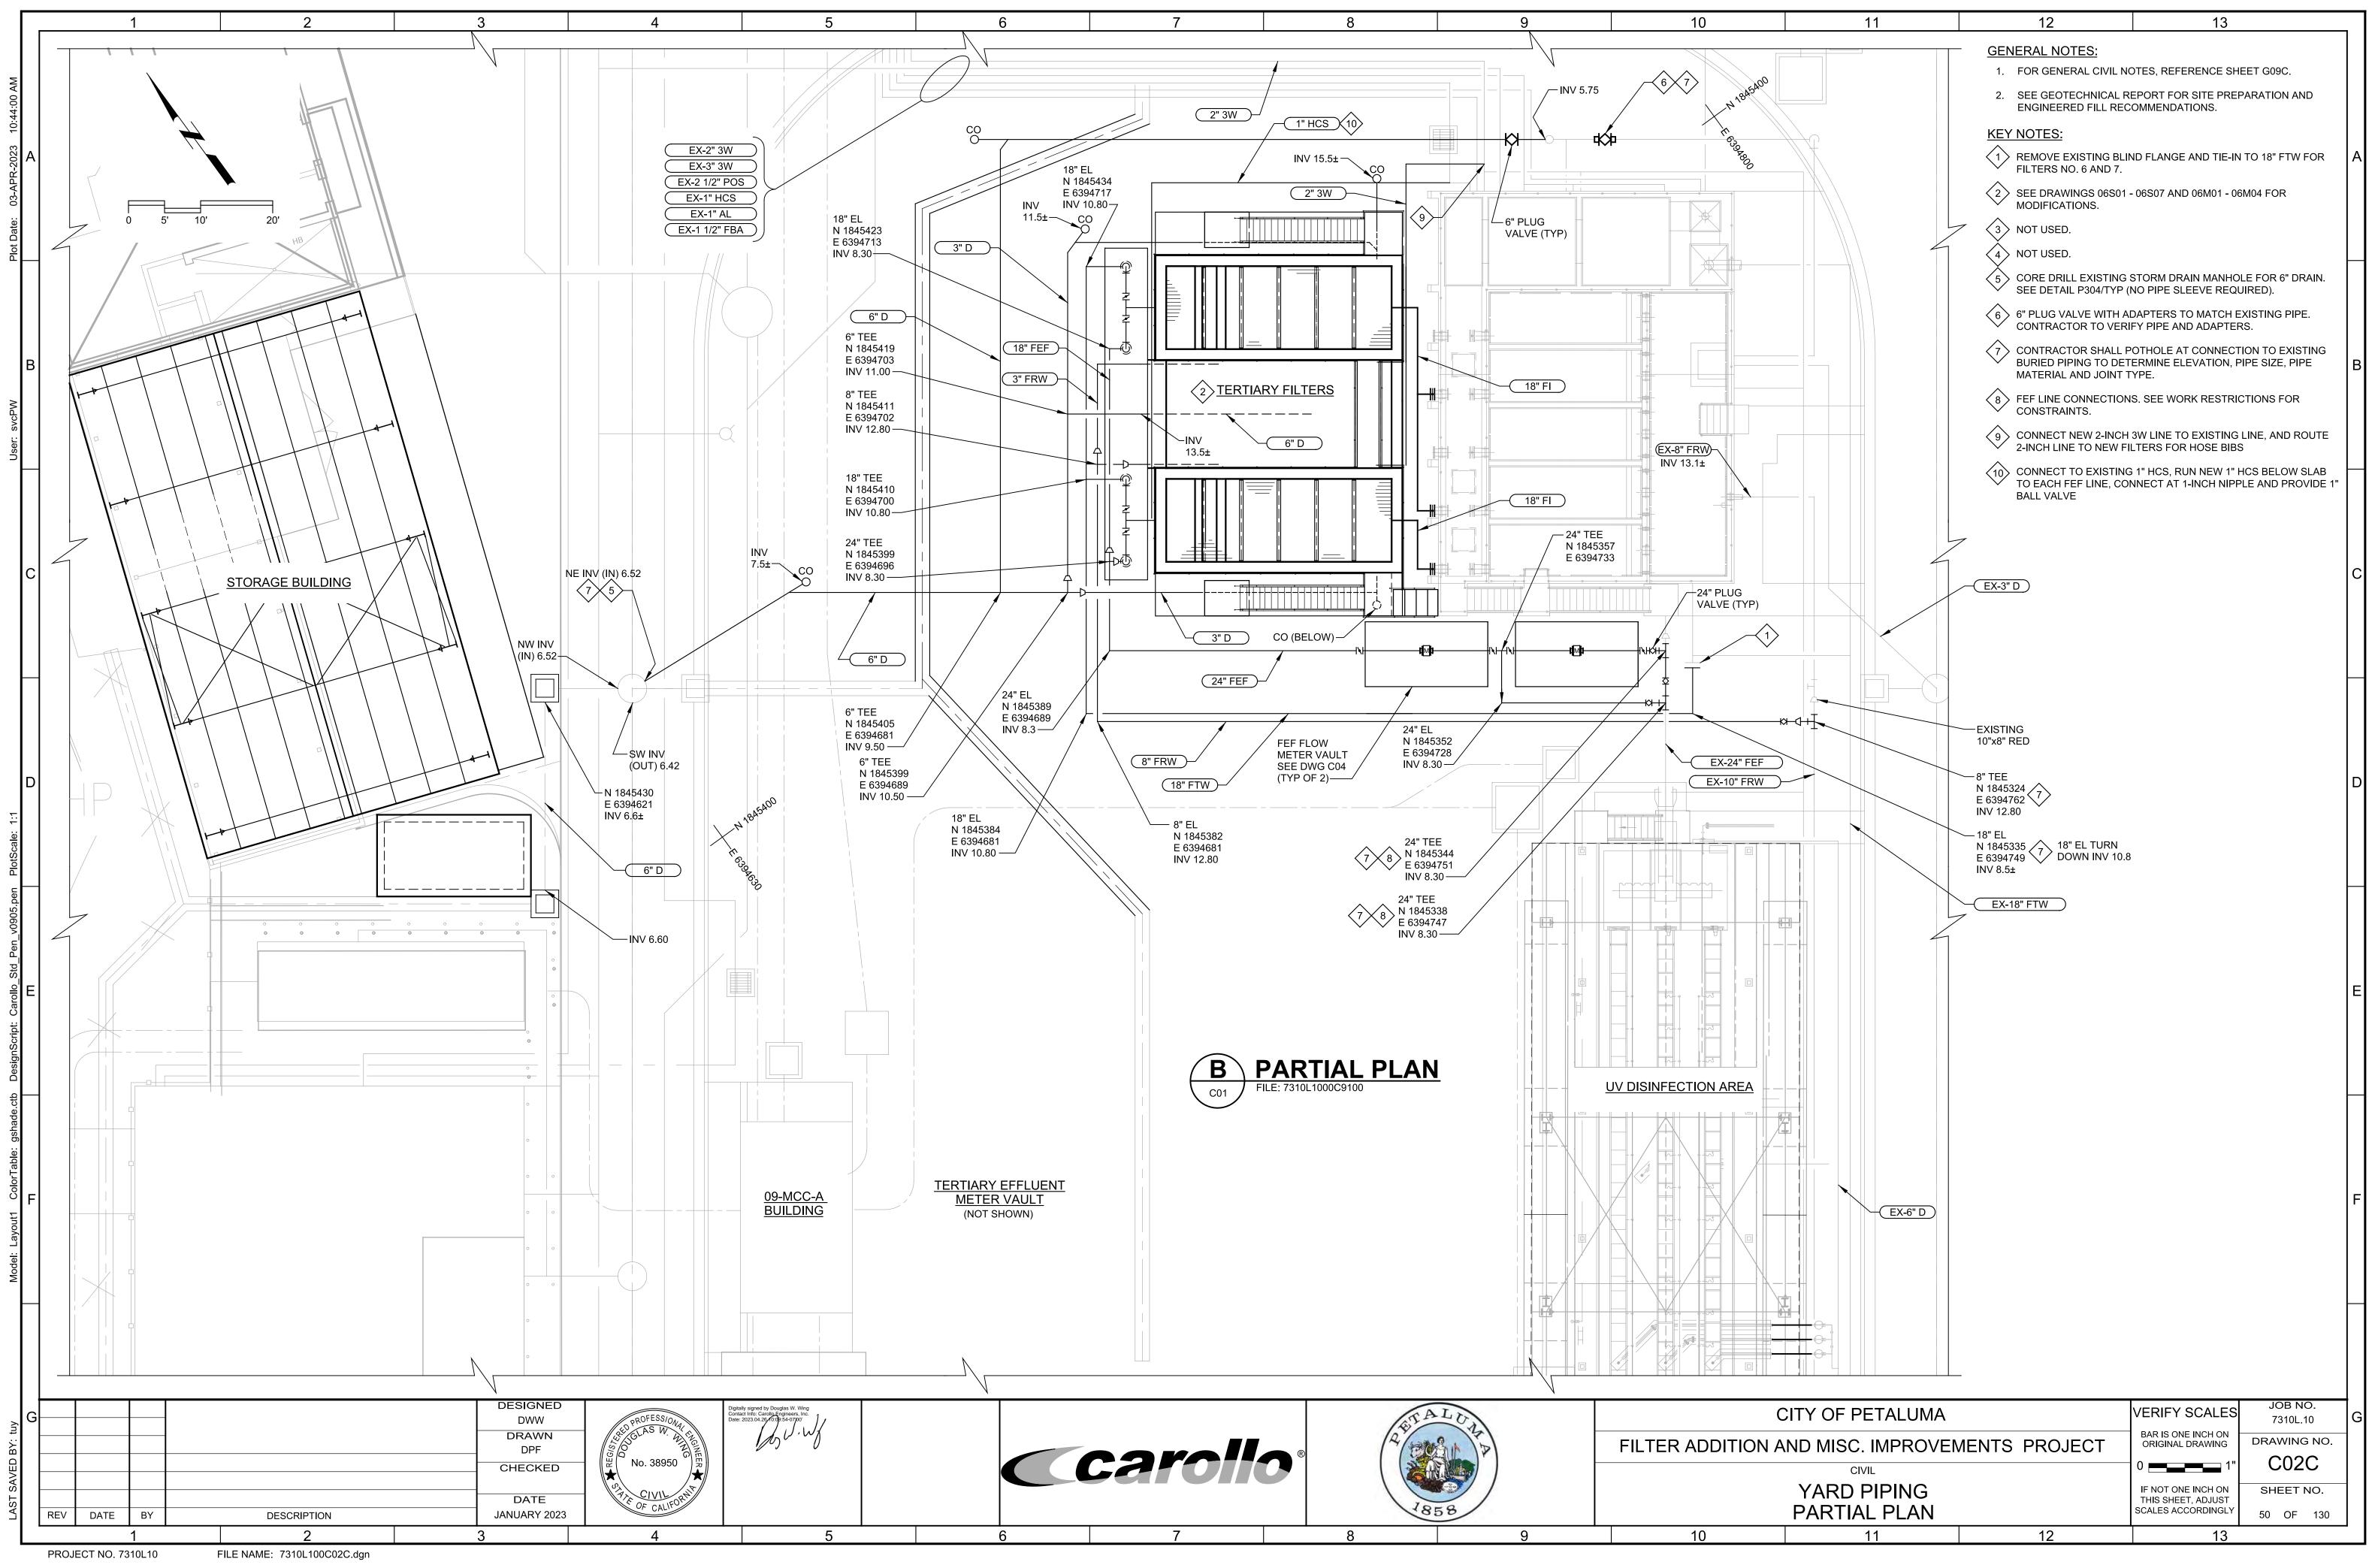


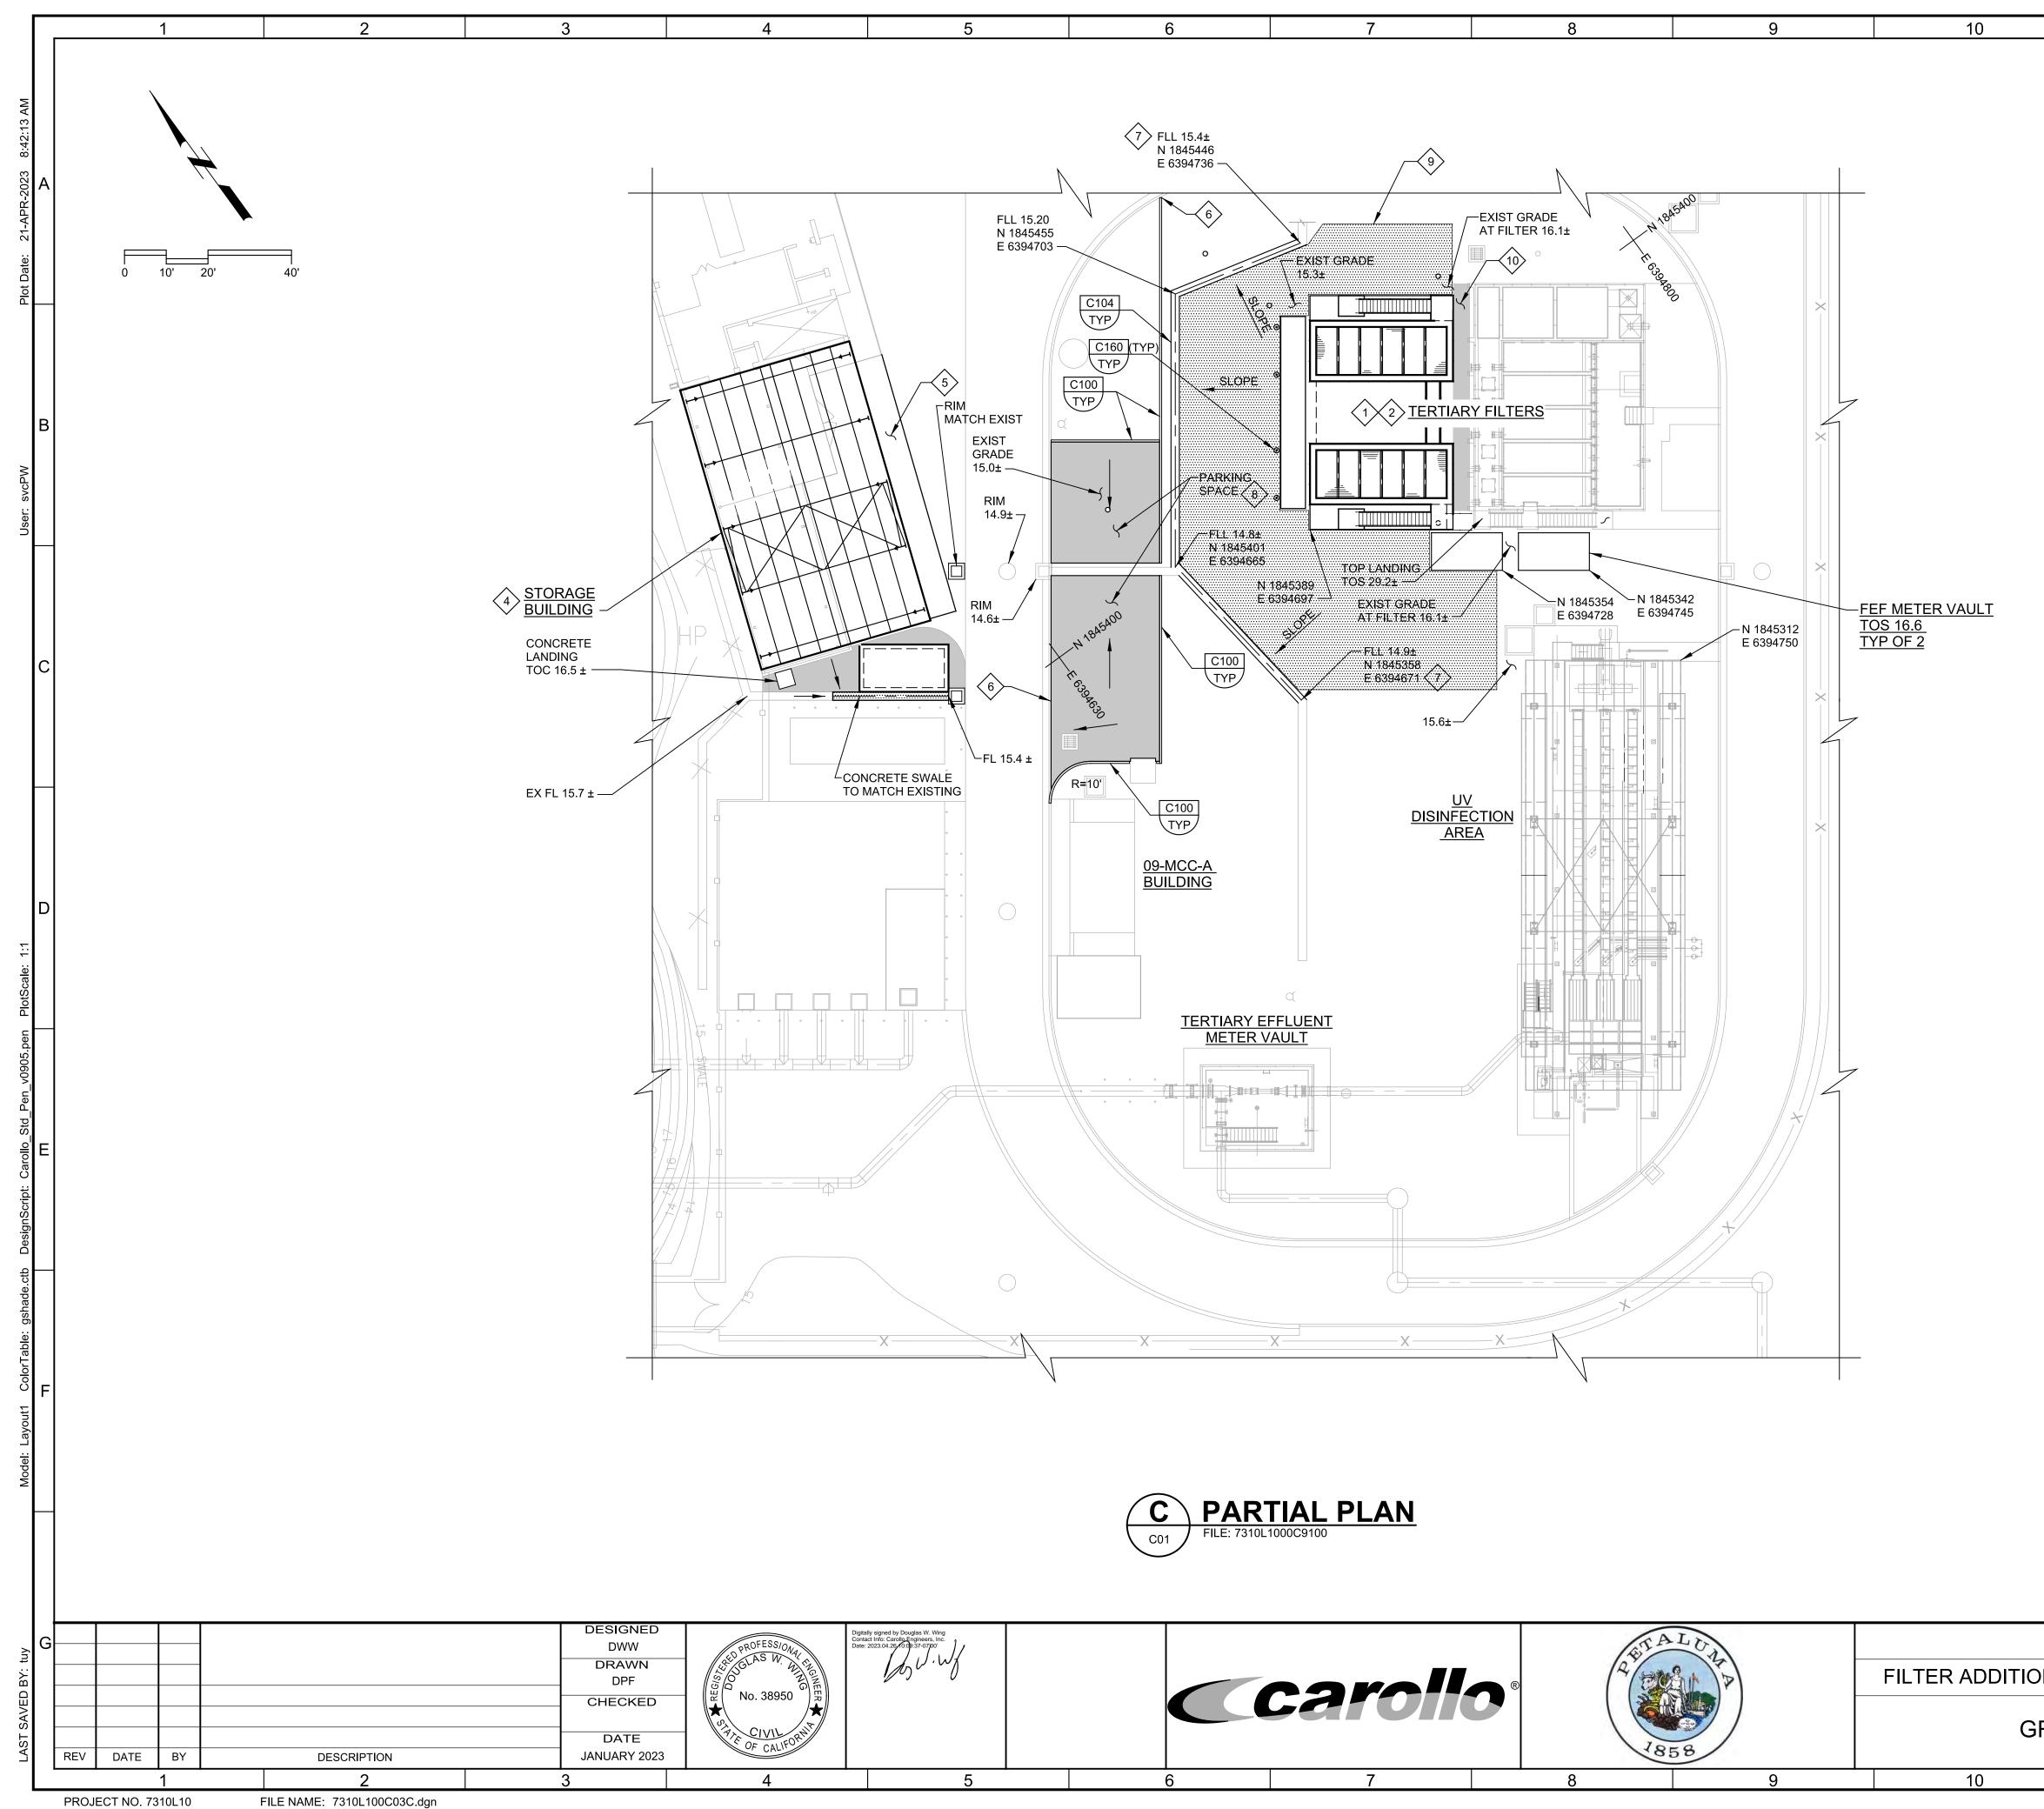




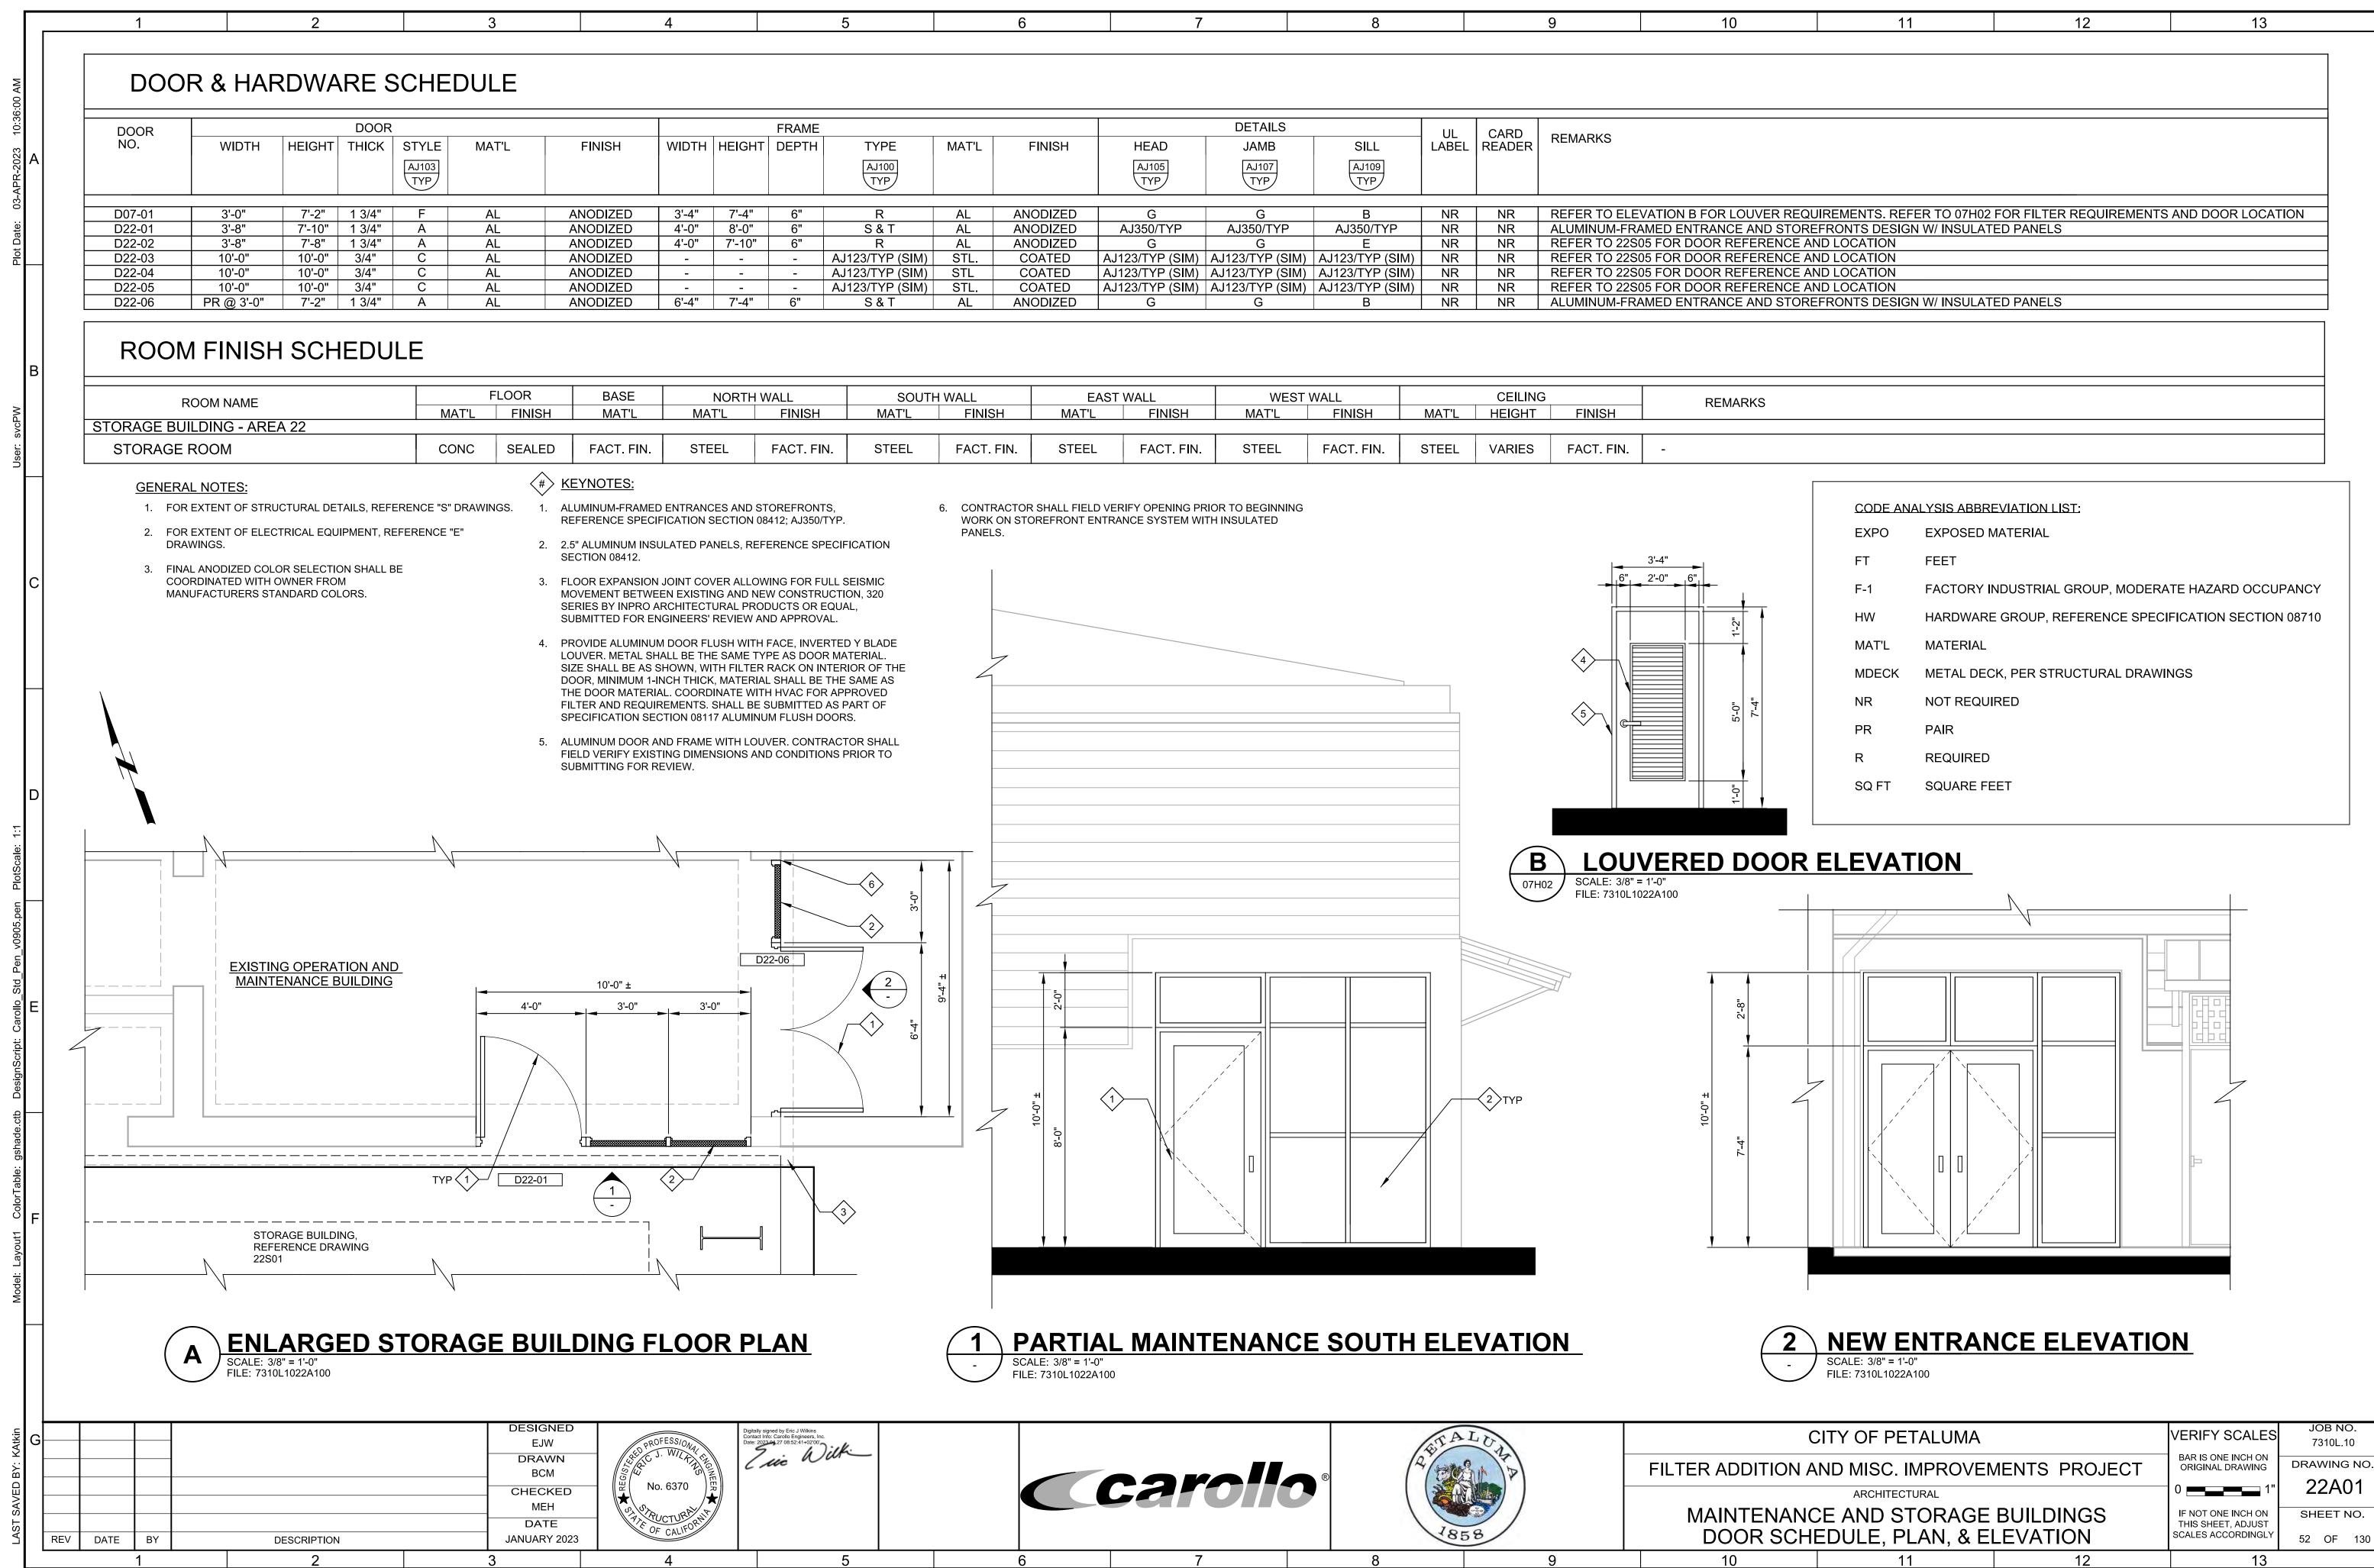
11	14		
	KEY NOTES:	DN NOTES, REFER TO DRAWING D01C.	Α
			В
			С
			D
		EXISTING OPERATION AND MAINTENANCE BUILDING	E
C - SCALE: 3/4 FILE: 7310L	TION " = 1'-0" .1022D300		F
CITY OF PETALUMA ON AND MISC. IMPROVEM DEMOLITION STORAGE BUILDING PLANS AND SECTION 11		VERIFY SCALES BAR IS ONE INCH ON ORIGINAL DRAWING 0 1" DRAWING NO. 22D01 IF NOT ONE INCH ON THIS SHEET, ADJUST SCALES ACCORDINGLY 13	G







	11	12	13	1
	GEN	IERAL NOTES:		
	1.	FOR GENERAL CIVIL NOTES, REFE	ERENCE SHEET G09C.	
	2.		R COORDINATE LOCATION DETAILS.	
	3.	SEE GEOTECHNICAL REPORT FOI ENGINEERED FILL RECOMMENDA		
	KEY	NOTES:		A
	$\langle 1 \rangle$	FINISH GRADE AROUND FILTERS	SHALL BE 16.10±.	
	$\langle 2 \rangle$	TERTIARY FILTERS, SEE DRAWING	2.06501	
	\sim	TENTIANT TIETENS, SEE DIAWING	5 00301.	
	$\langle 3 \rangle$	NOT USED.		
	4	STORAGE BUILDING, SEE DRAWIN	IG 22S01.	
	5	STORAGE BUILDING SIDEWALK PE	ER DETAIL C124/TYP. MATCH	
		EXISTING WIDTH.		
	$\langle 6 \rangle$	END DEPRESSED CURB AT EXISTI	NG CONCRETE SWALE.	В
	$\langle 7 \rangle$	NEW SWALES SHALL TIE TO THE E AREA DRAINAGE.	EXISTING SWALE AND PROVIDE	
	8	STRIPE PARKING AREA FOR 5 SPA	ACES.	
	\sim			
	9	ADD 6" AGGREGATE BASE		$\left - \right $
		PAVE BETWEEN EXISTING FILER A 16.3 ± IN MIDDLE, 16.1 ± AT N AND	AND NEW FILTERS, HIGH POINT S ENDS TO MATCH EXIST	
		GRADE. 4-INCH ÁC AND 6-INCH AB		
				C
				D
				E
				F
				↓ ┃
С	ITY OF PETALUMA		VERIFY SCALES JOB NO. 7310L.10	G
ON A	ND MISC. IMPROVEN	IENTS PROJECT	BAR IS ONE INCH ON ORIGINAL DRAWING DRAWING NO.	
	CIVIL		⁰ 1" C03C	
GRA	DING AND DRAINA	GE	IF NOT ONE INCH ON SHEET NO. THIS SHEET, ADJUST	
	PARTIAL PLAN	12	SCALES ACCORDINGLY 51 OF 130]
	11	17	13	



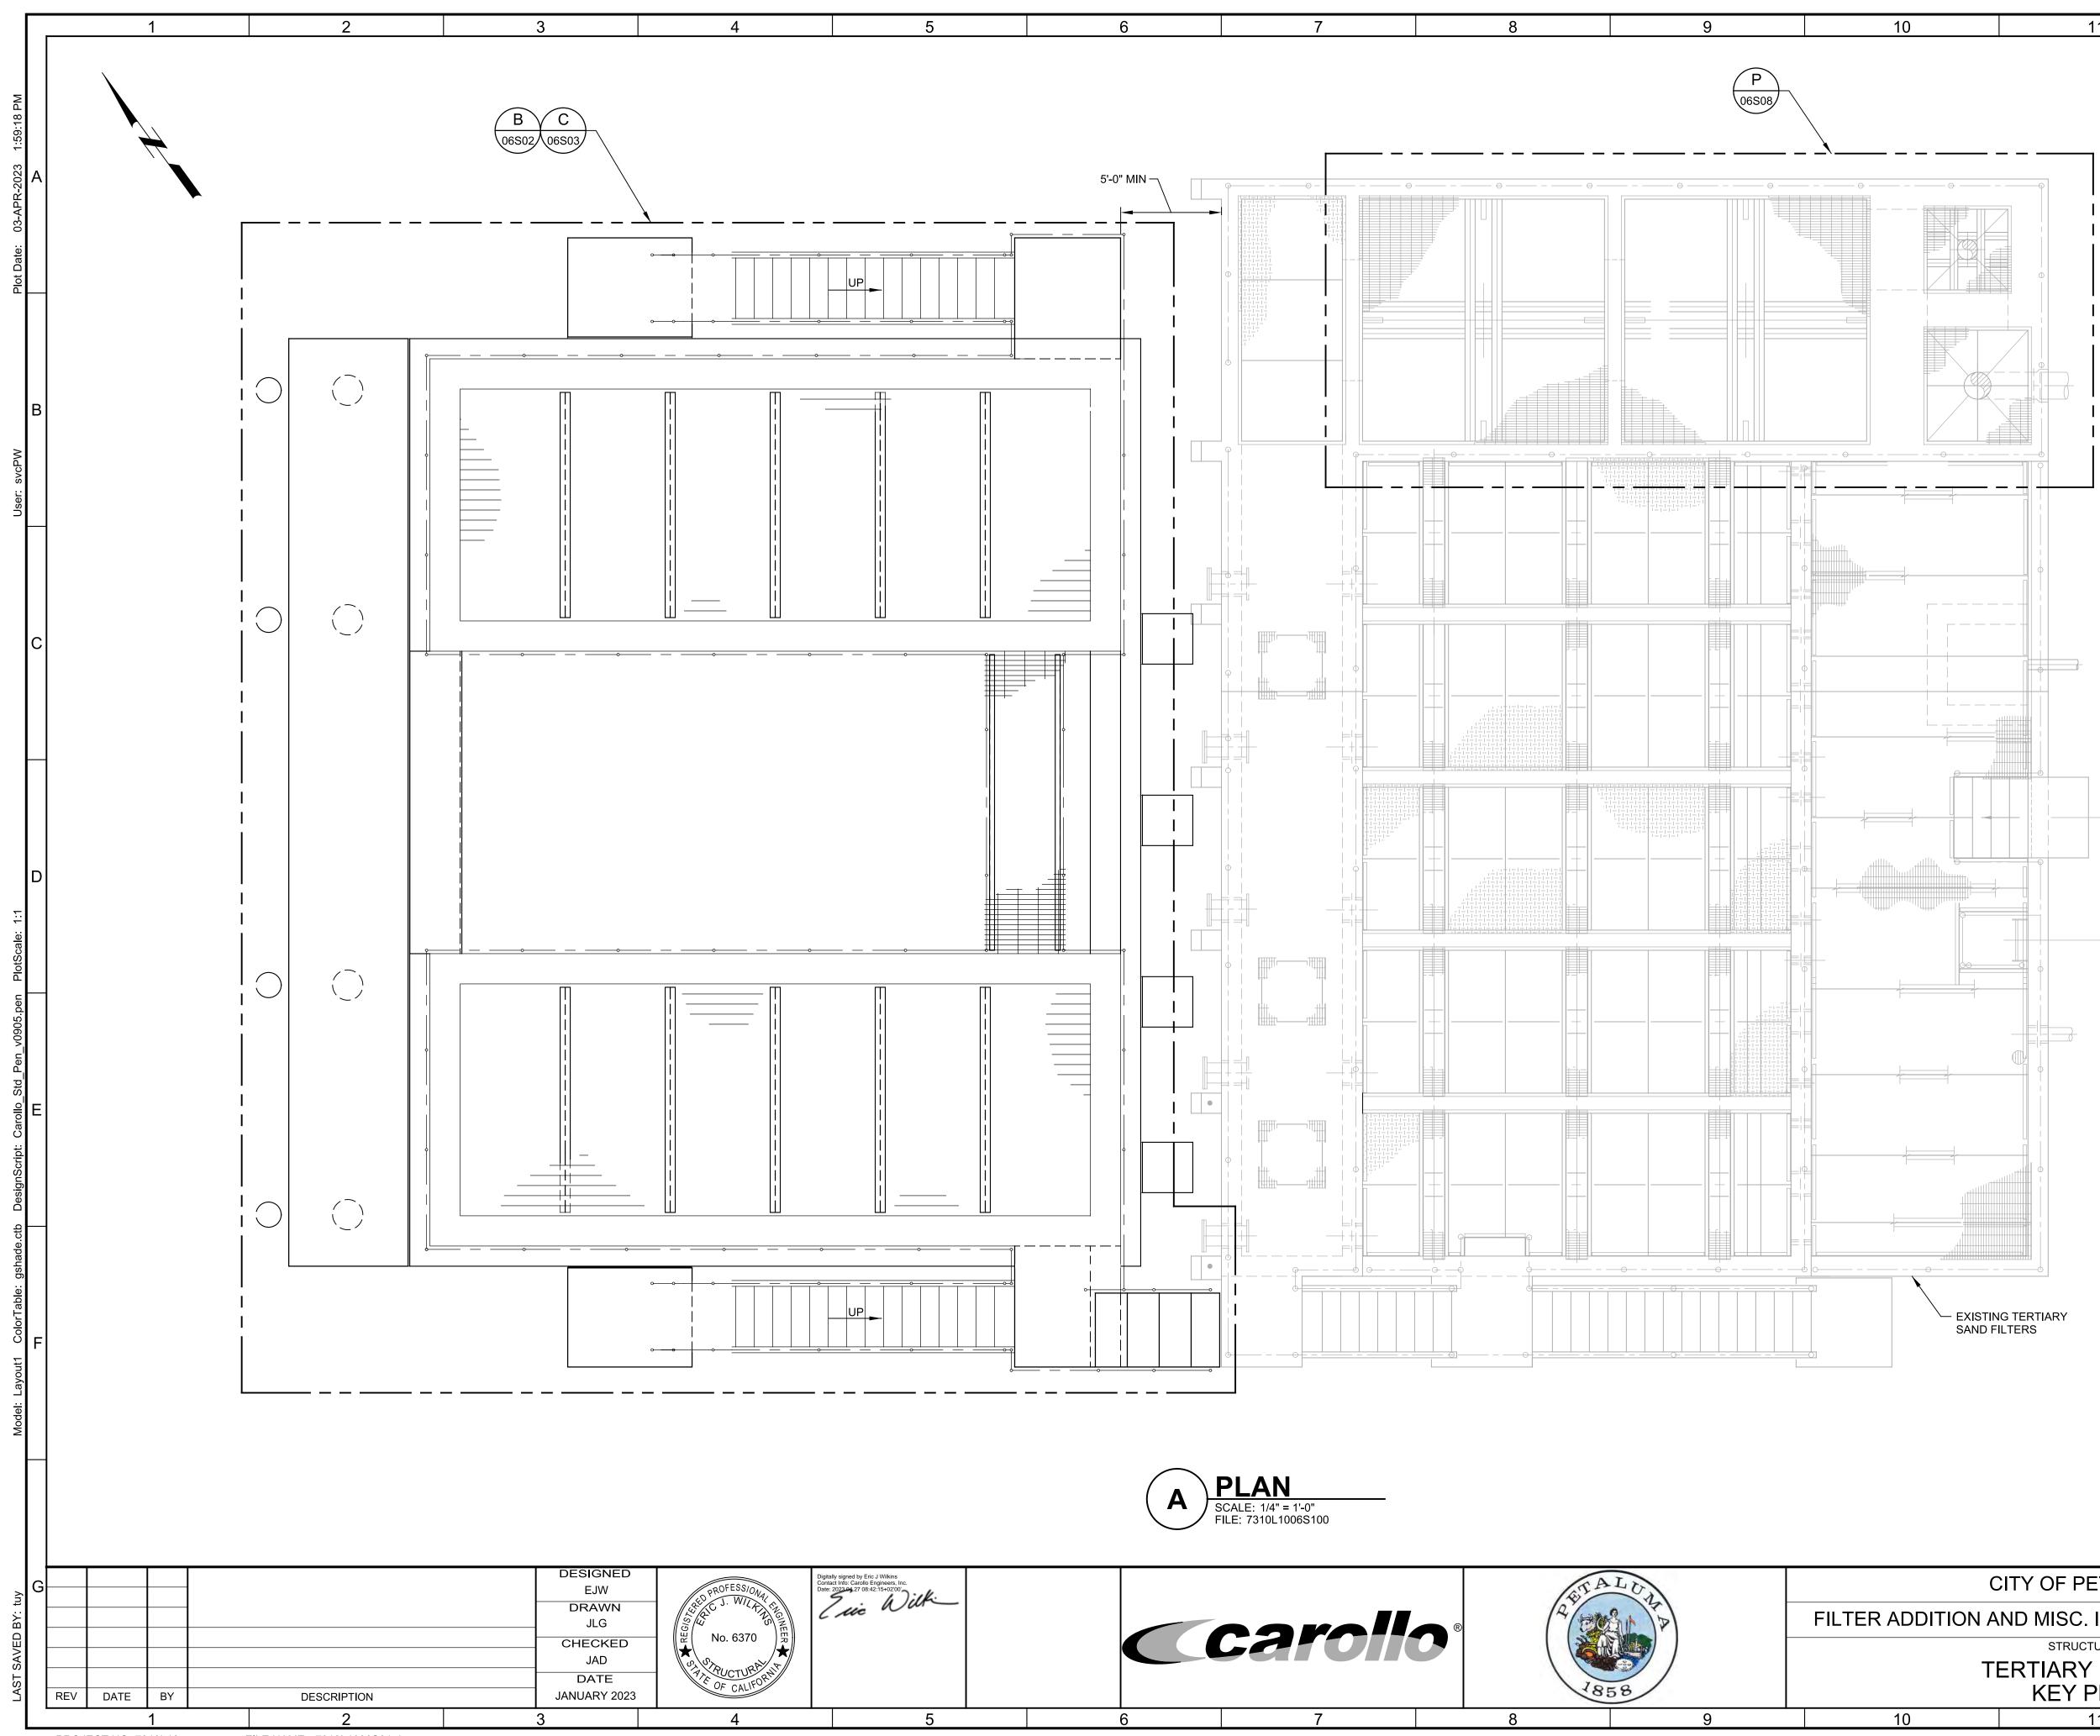
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				L		I			
				DETAILS		UL	CARD		
TYPE	MAT'L	FINISH	HEAD	JAMB	SILL	LABEL	READER	REMARKS	
AJ100			AJ105	AJ107	AJ109				
AJ100 TYP			TYP	TYP	AJ109 TYP				
							· · · · · ·		
R	AL	ANODIZED	G	G	В	NR	NR	REFER TO ELEVATION B FOR LOUVER REQUIREMENTS. REFER TO 07H02 FOR FILTER REQUIREMENTS AND DOOR LOCATION	
S & T	AL	ANODIZED	AJ350/TYP	AJ350/TYP	AJ350/TYP	NR	NR	ALUMINUM-FRAMED ENTRANCE AND STOREFRONTS DESIGN W/ INSULATED PANELS	
R	AL	ANODIZED	G	G	E	NR	NR	REFER TO 22S05 FOR DOOR REFERENCE AND LOCATION	
J123/TYP (SIM)	STL.	COATED	AJ123/TYP (SIM)	AJ123/TYP (SIM)	AJ123/TYP (SIM)	NR	NR	REFER TO 22S05 FOR DOOR REFERENCE AND LOCATION	
J123/TYP (SIM)	STL	COATED	AJ123/TYP (SIM)	AJ123/TYP (SIM)	AJ123/TYP (SIM)	NR	NR	REFER TO 22S05 FOR DOOR REFERENCE AND LOCATION	
J123/TYP (SIM)	STL.	COATED	AJ123/TYP (SIM)	AJ123/TYP (SIM)	AJ123/TYP (SIM)	NR	NR	REFER TO 22S05 FOR DOOR REFERENCE AND LOCATION	
S & T	Δι		G	G	B	NR	NR	ALUMINUM-FRAMED ENTRANCE AND STOREERONTS DESIGN W/ INSULATED PANELS	

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				DETAILS		UL	CARD	REMARKS					
TYPE	MAT'L	FINISH	HEAD	JAMB	SILL	LABEL	READER						
AJ100			AJ105	AJ107	AJ109								
TYP			TYP	ТҮР	TYP								
				1									
R	AL	ANODIZED	G	G	B	NR	NR	REFER TO ELE	VATION B FOR LOUVER REQ	UIREMENTS. REFER TO 07H02	FOR FILTER REQUIREMENTS	AND DOOR LOCATION	
S & T	AL	ANODIZED	AJ350/TYP	AJ350/TYP	AJ350/TYP	NR	NR			EFRONTS DESIGN W/ INSULAT	FED PANELS		
R	AL	ANODIZED	G	G	E	NR	NR	REFER TO 22S	05 FOR DOOR REFERENCE A	ND LOCATION			
123/TYP (SIM)	STL.	COATED	AJ123/TYP (SIM)	AJ123/TYP (SIM)	AJ123/TYP (SIM)	NR	NR	REFER TO 22S	05 FOR DOOR REFERENCE A	ND LOCATION			7
J123/TYP (SIM)	STL	COATED	AJ123/TYP (SIM)	AJ123/TYP (SIM)	AJ123/TYP (SIM)	NR	NR	REFER TO 22S	05 FOR DOOR REFERENCE A	ND LOCATION			7 [
J123/TYP (SIM)	STL.	COATED		· · · · · · · · · · · · · · · · · · ·	AJ123/TYP (SIM)	NR	NR	REFER TO 22S	05 FOR DOOR REFERENCE A	ND LOCATION			7
S&T	AL	ANODIZED	G	G	B	NR	NR	ALUMINUM-FR	AMED ENTRANCE AND STOR	EFRONTS DESIGN W/ INSULAT	ED PANELS		7
													_

SOUTH	SOUTH WALL		WALL	WEST WALL		CEILING		REMARKS		
MAT'L	FINISH	MAT'L	FINISH	MAT'L	FINISH	MAT'L	HEIGHT	FINISH	REIVIARNO	
STEEL	FACT. FIN.	STEEL	FACT. FIN.	STEEL	FACT. FIN.	STEEL	VARIES	FACT. FIN.	-	

CODE AN/	ALYSIS ABBREVIATION LIST:
EXPO	EXPOSED MATERIAL
FT	FEET
F-1	FACTORY INDUSTRIAL GROUP, MODERATE HAZARD OCCUPANCY
HW	HARDWARE GROUP, REFERENCE SPECIFICATION SECTION 08710
MAT'L	MATERIAL
MDECK	METAL DECK, PER STRUCTURAL DRAWINGS
NR	NOT REQUIRED
PR	PAIR
R	REQUIRED
SQ FT	SQUARE FEET



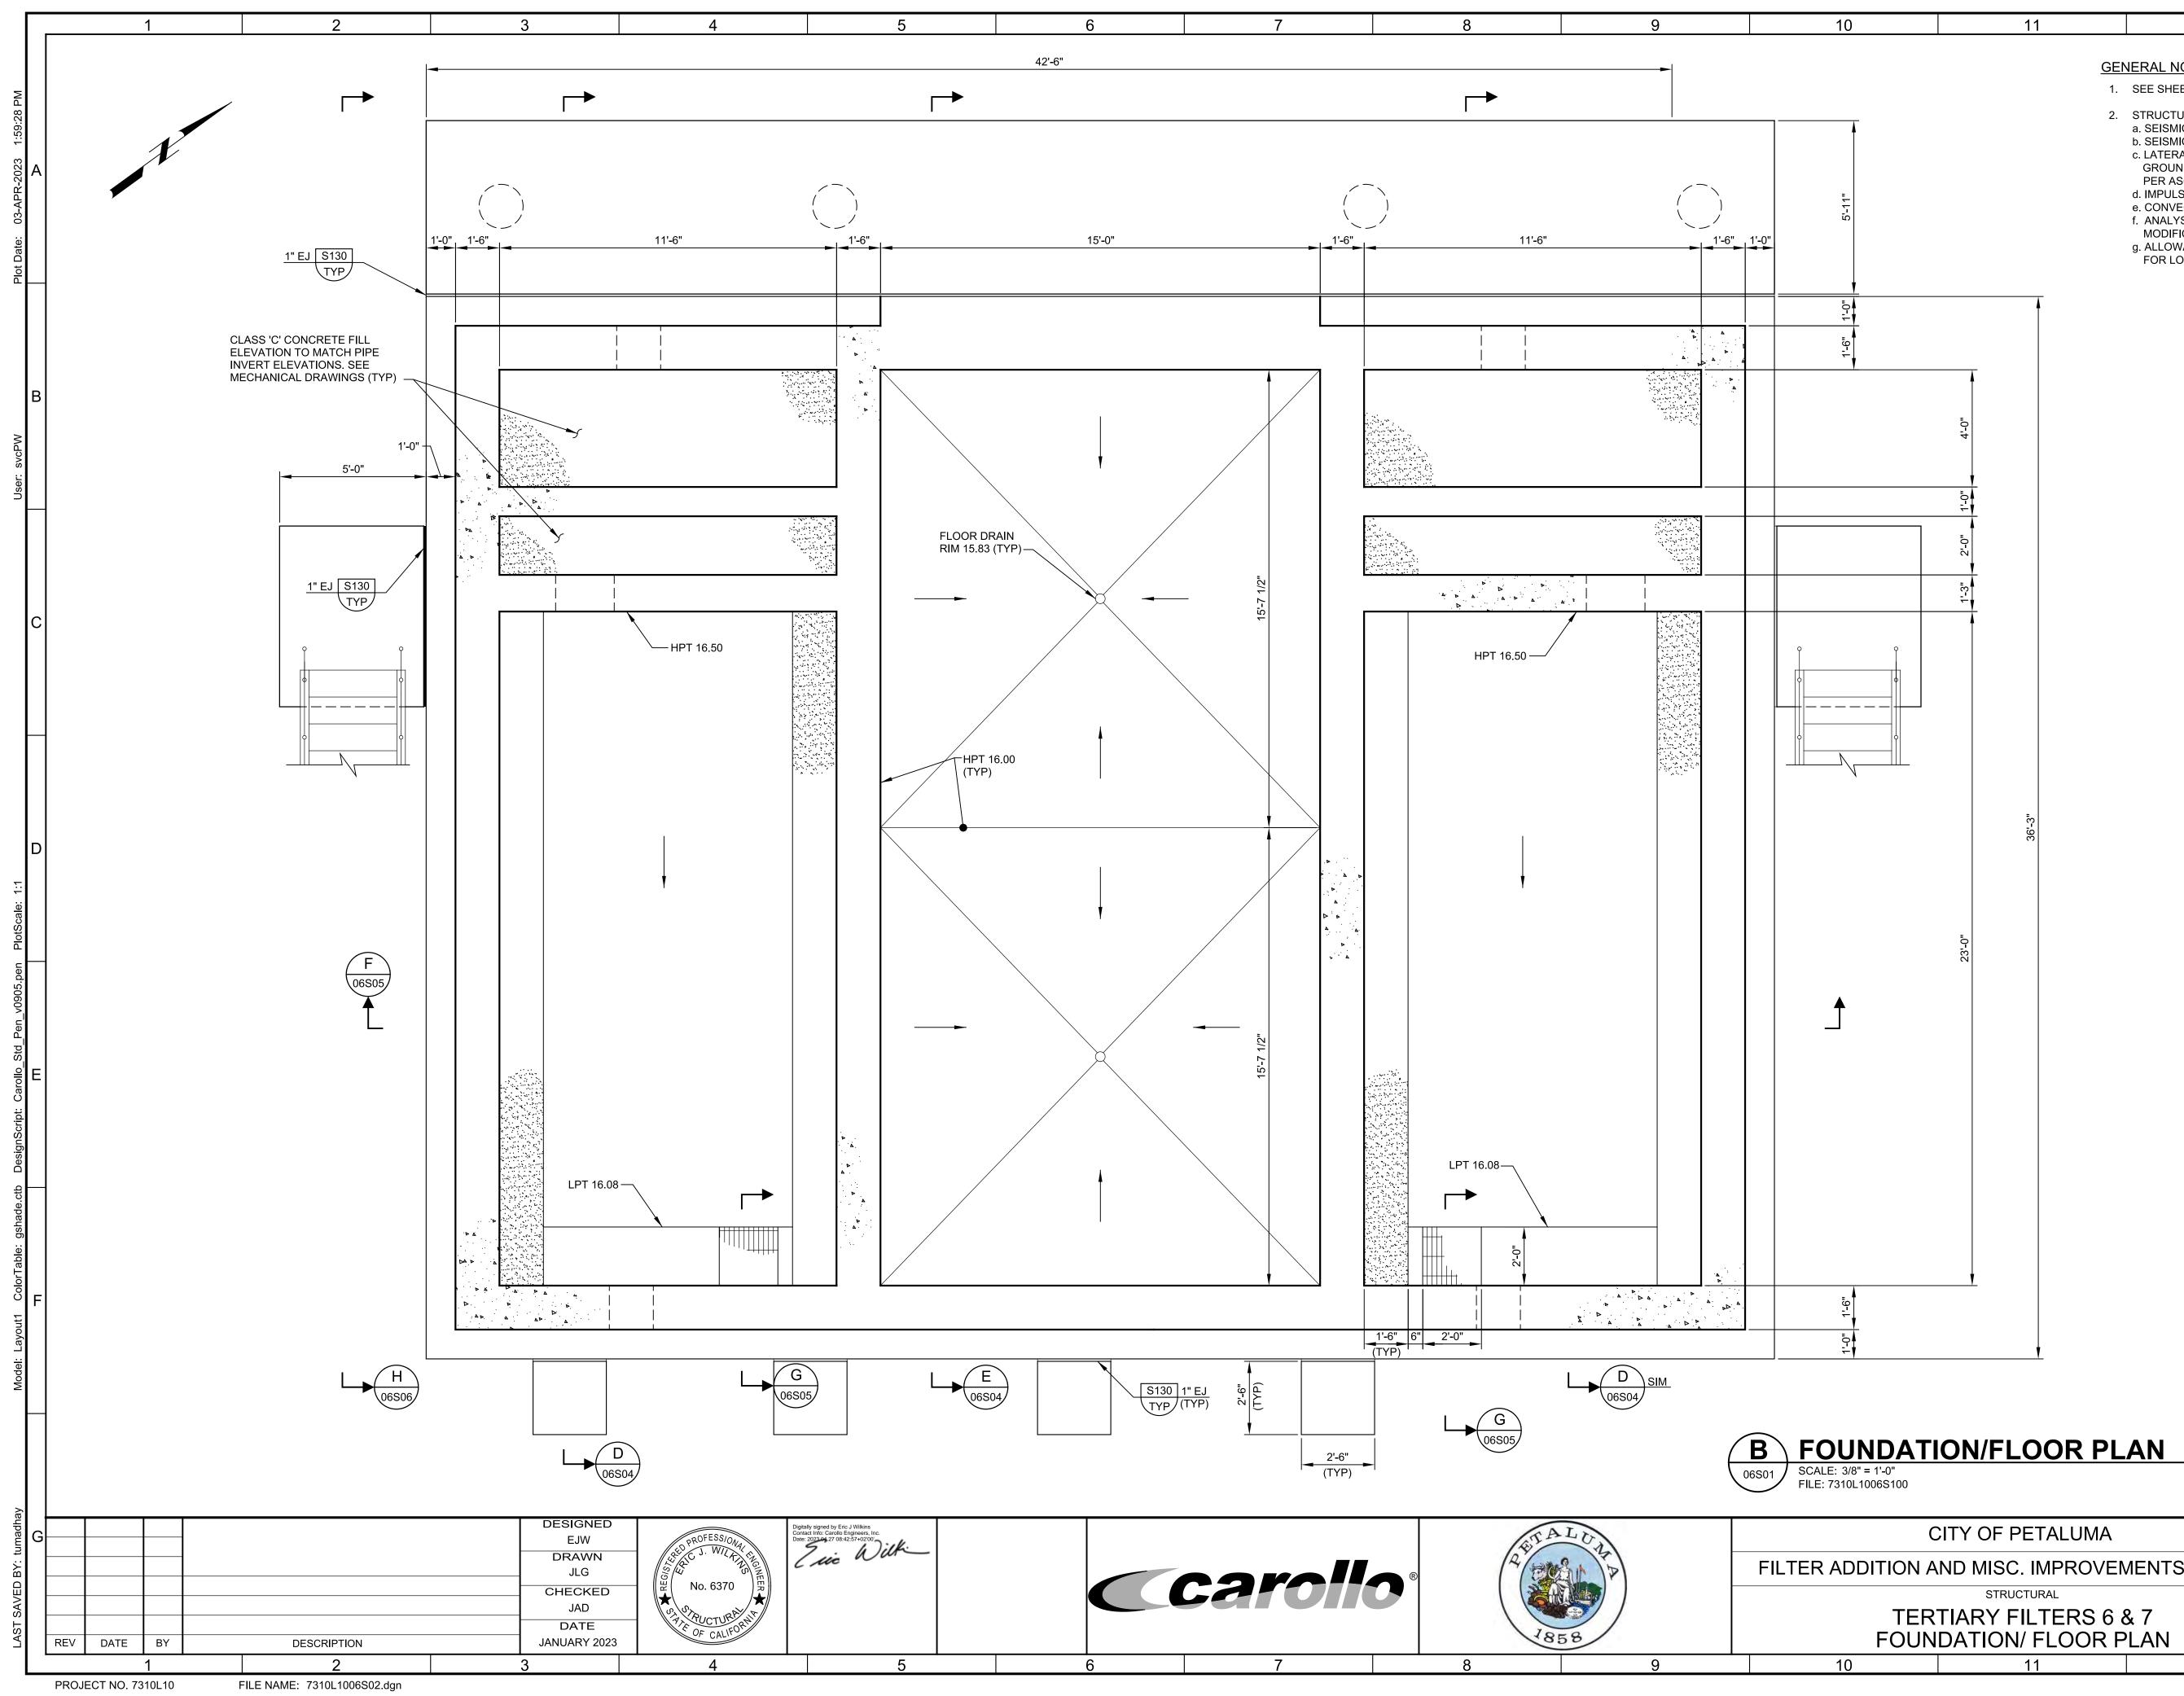
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GENERAL NOTES:

- 1. SEE SHEETS G10C & G11C FOR GENERAL STRUCTURAL NOTES.
- 2. SEE SPECIFICATION SECTION 01140 FOR WORK RESTRICTIONS.

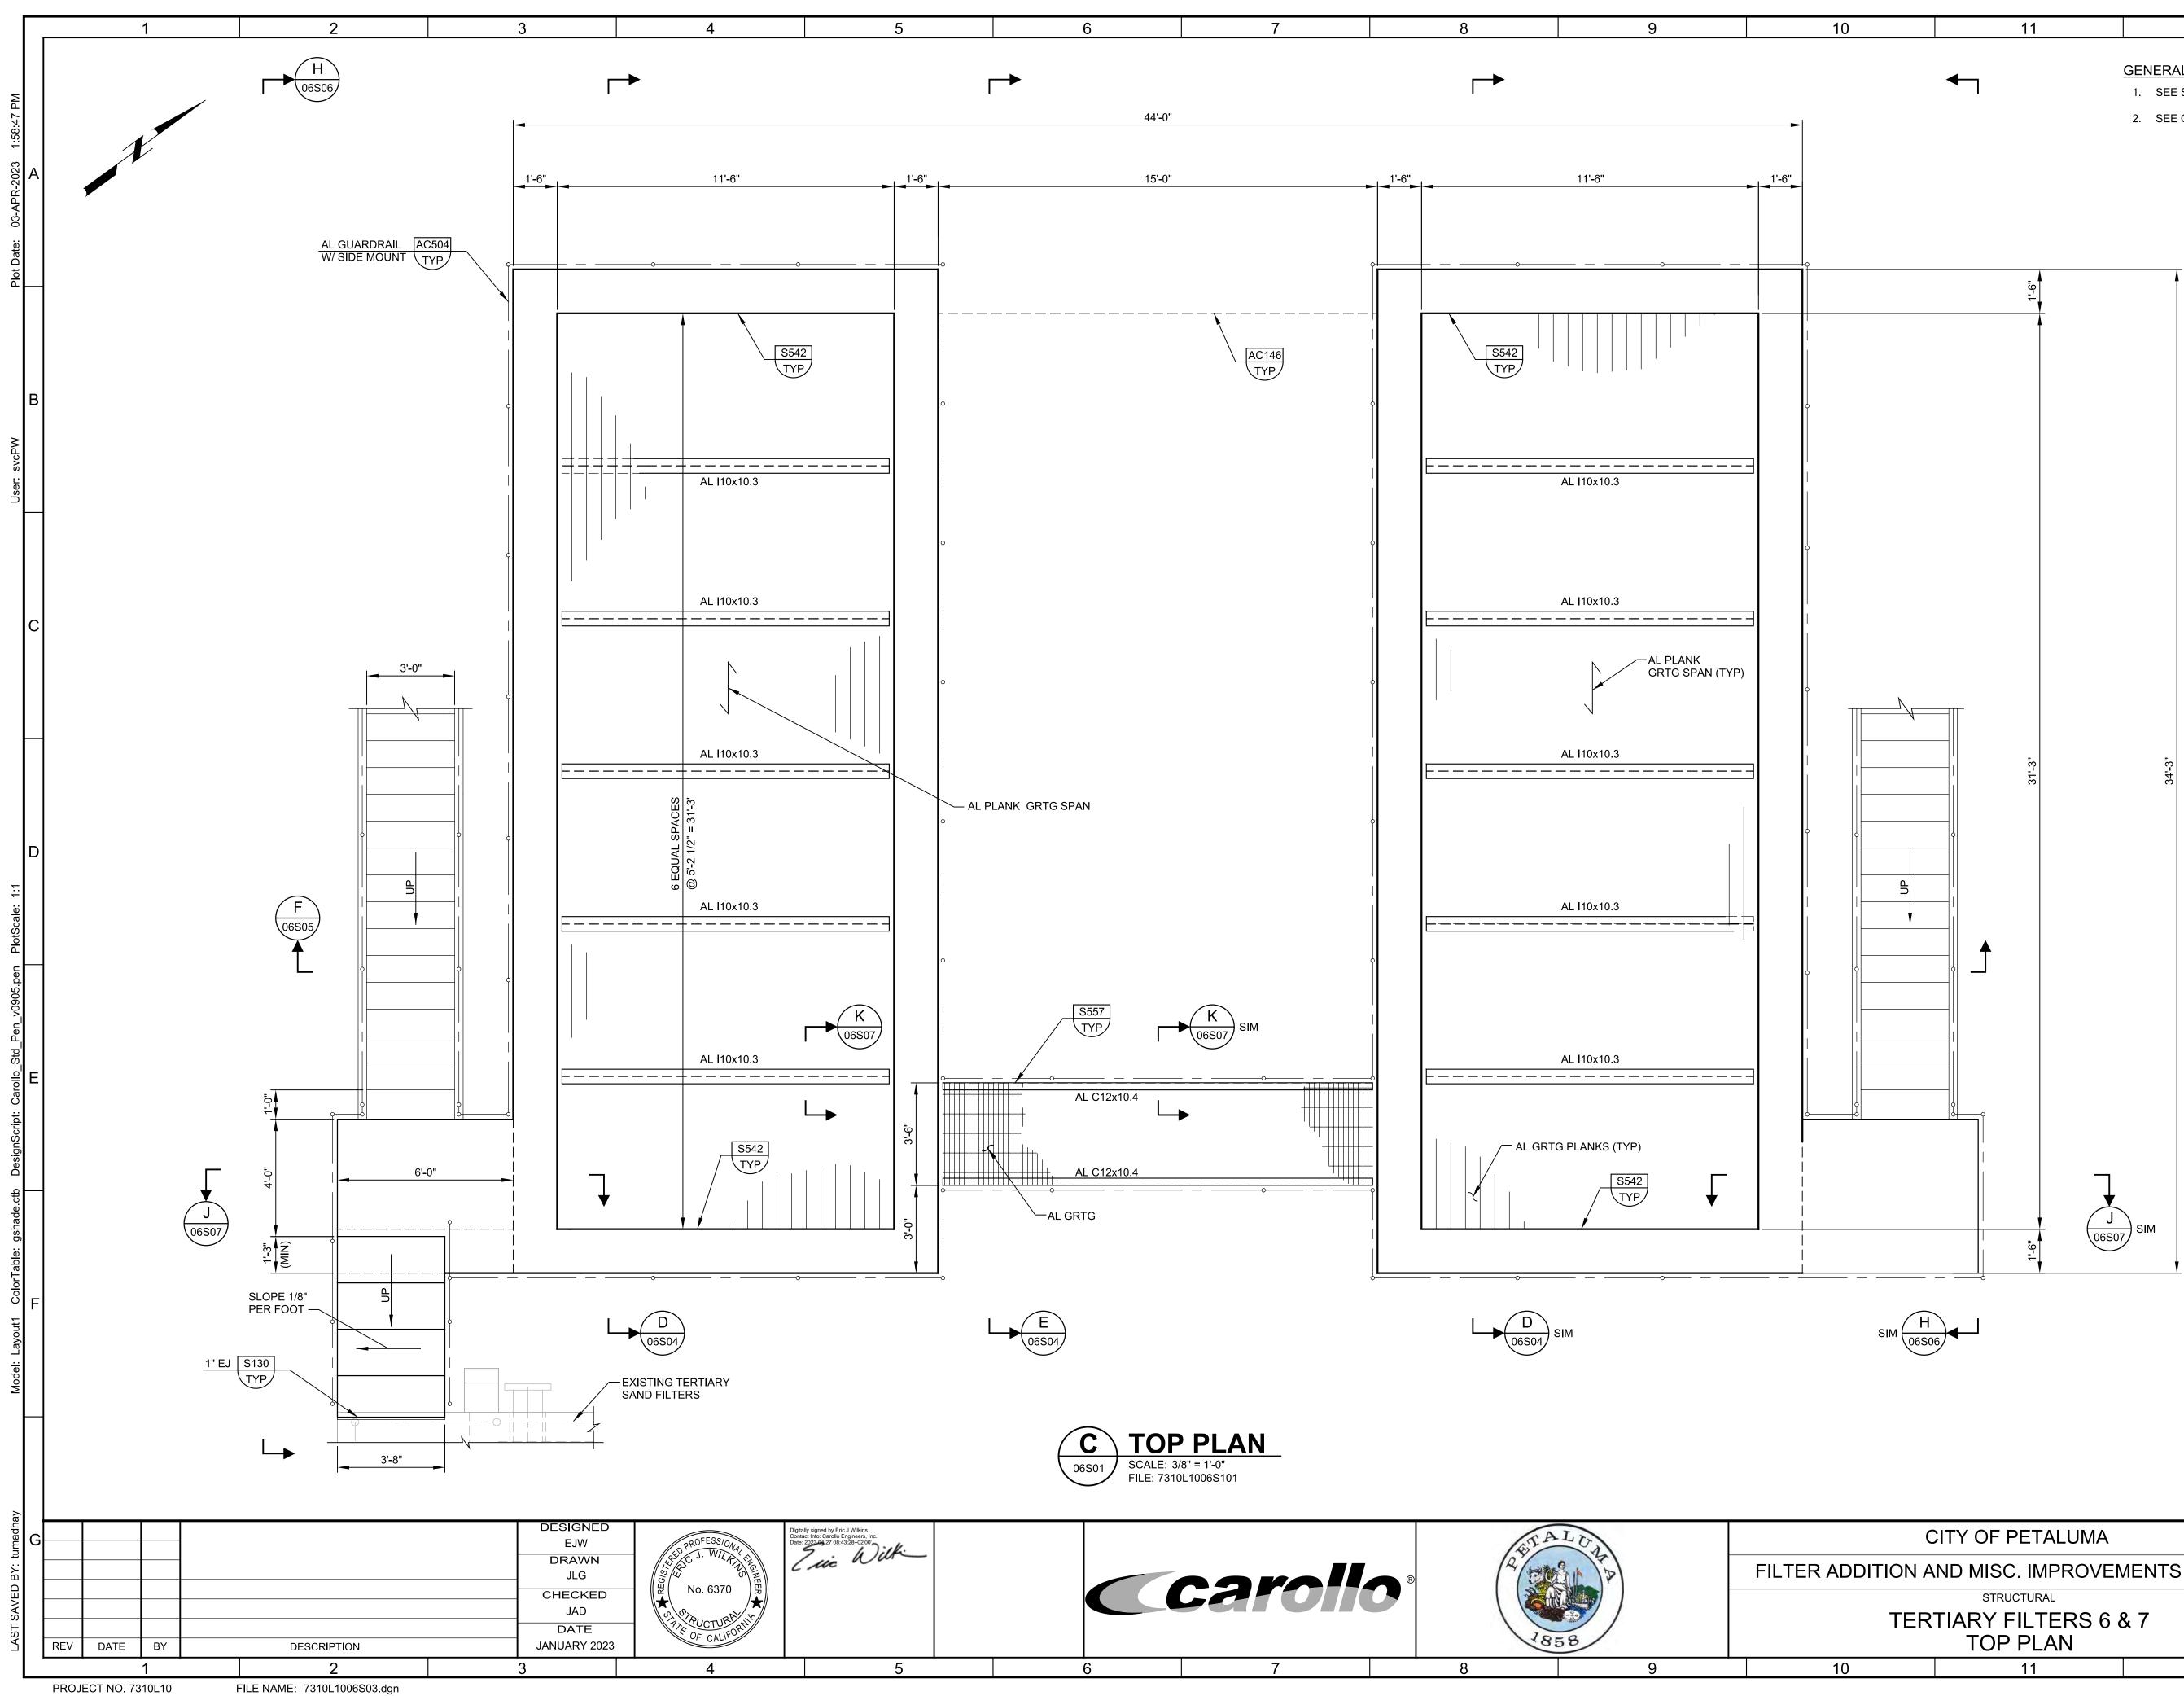
CITY OF PETALUMA	VERIFY SCALES BAR IS ONE INCH ON	JOB NO. 7310L.10	G				
TION AND MISC. IMPROVEN	N AND MISC. IMPROVEMENTS PROJECT						
STRUCTURAL	0 1"	06S01					
TERTIARY FILTERS KEY PLAN	IF NOT ONE INCH ON THIS SHEET, ADJUST SCALES ACCORDINGLY	SHEET NO. 53 OF 130					
11	12	13					



GENERAL NOTES:

- 1. SEE SHEETS G10C & G11C FOR GENERAL STRUCTURAL NOTES.
- 2. STRUCTURAL DESIGN CRITERIA:
- a. SEISMIC IMPORTANCE FACTOR: le=1.25 b. SEISMIC DESIGN CATEGORY: D
- c. LATERAL FORCE RESISTING SYSTEM: FLAT-BOTTOM GROUND-SUPPORTED REINFORCED NON-SLIDING CONCRETE TANK PER ASCE 7-16 AND FIXED BASE (TYPE 1.1) PER ACI 350.3-06
- d. IMPULSIVE RESPONSE MODIFICATION FACTOR, R=2.0 e. CONVECTIVE RESPONSE MODIFICATION FACTOR, Rc=1.0
- f. ANALYSIS PROCEDURE PER ACI 350.3-06 WITH ASCE 7-16 §15.7.7.3
- MODIFICATIONS. g. ALLOWABLE NET BEARING PRESSURE: 1500 PSF WITH 1/3 INCREASE FOR LOAD COMBINATIONS INCLUDING SEISMIC OR WIND.

CITY OF PETALUMA			JOB NO. 7310L.10	G
ON AND MISC. IMPROVEMENTS PROJECT		BAR IS ONE INCH ON ORIGINAL DRAWING		
		0 1"	06S02	
TERTIARY FILTERS 6 &		IF NOT ONE INCH ON THIS SHEET, ADJUST SCALES ACCORDINGLY	SHEET NO. 54 OF 130	
11	12	13		
		•		



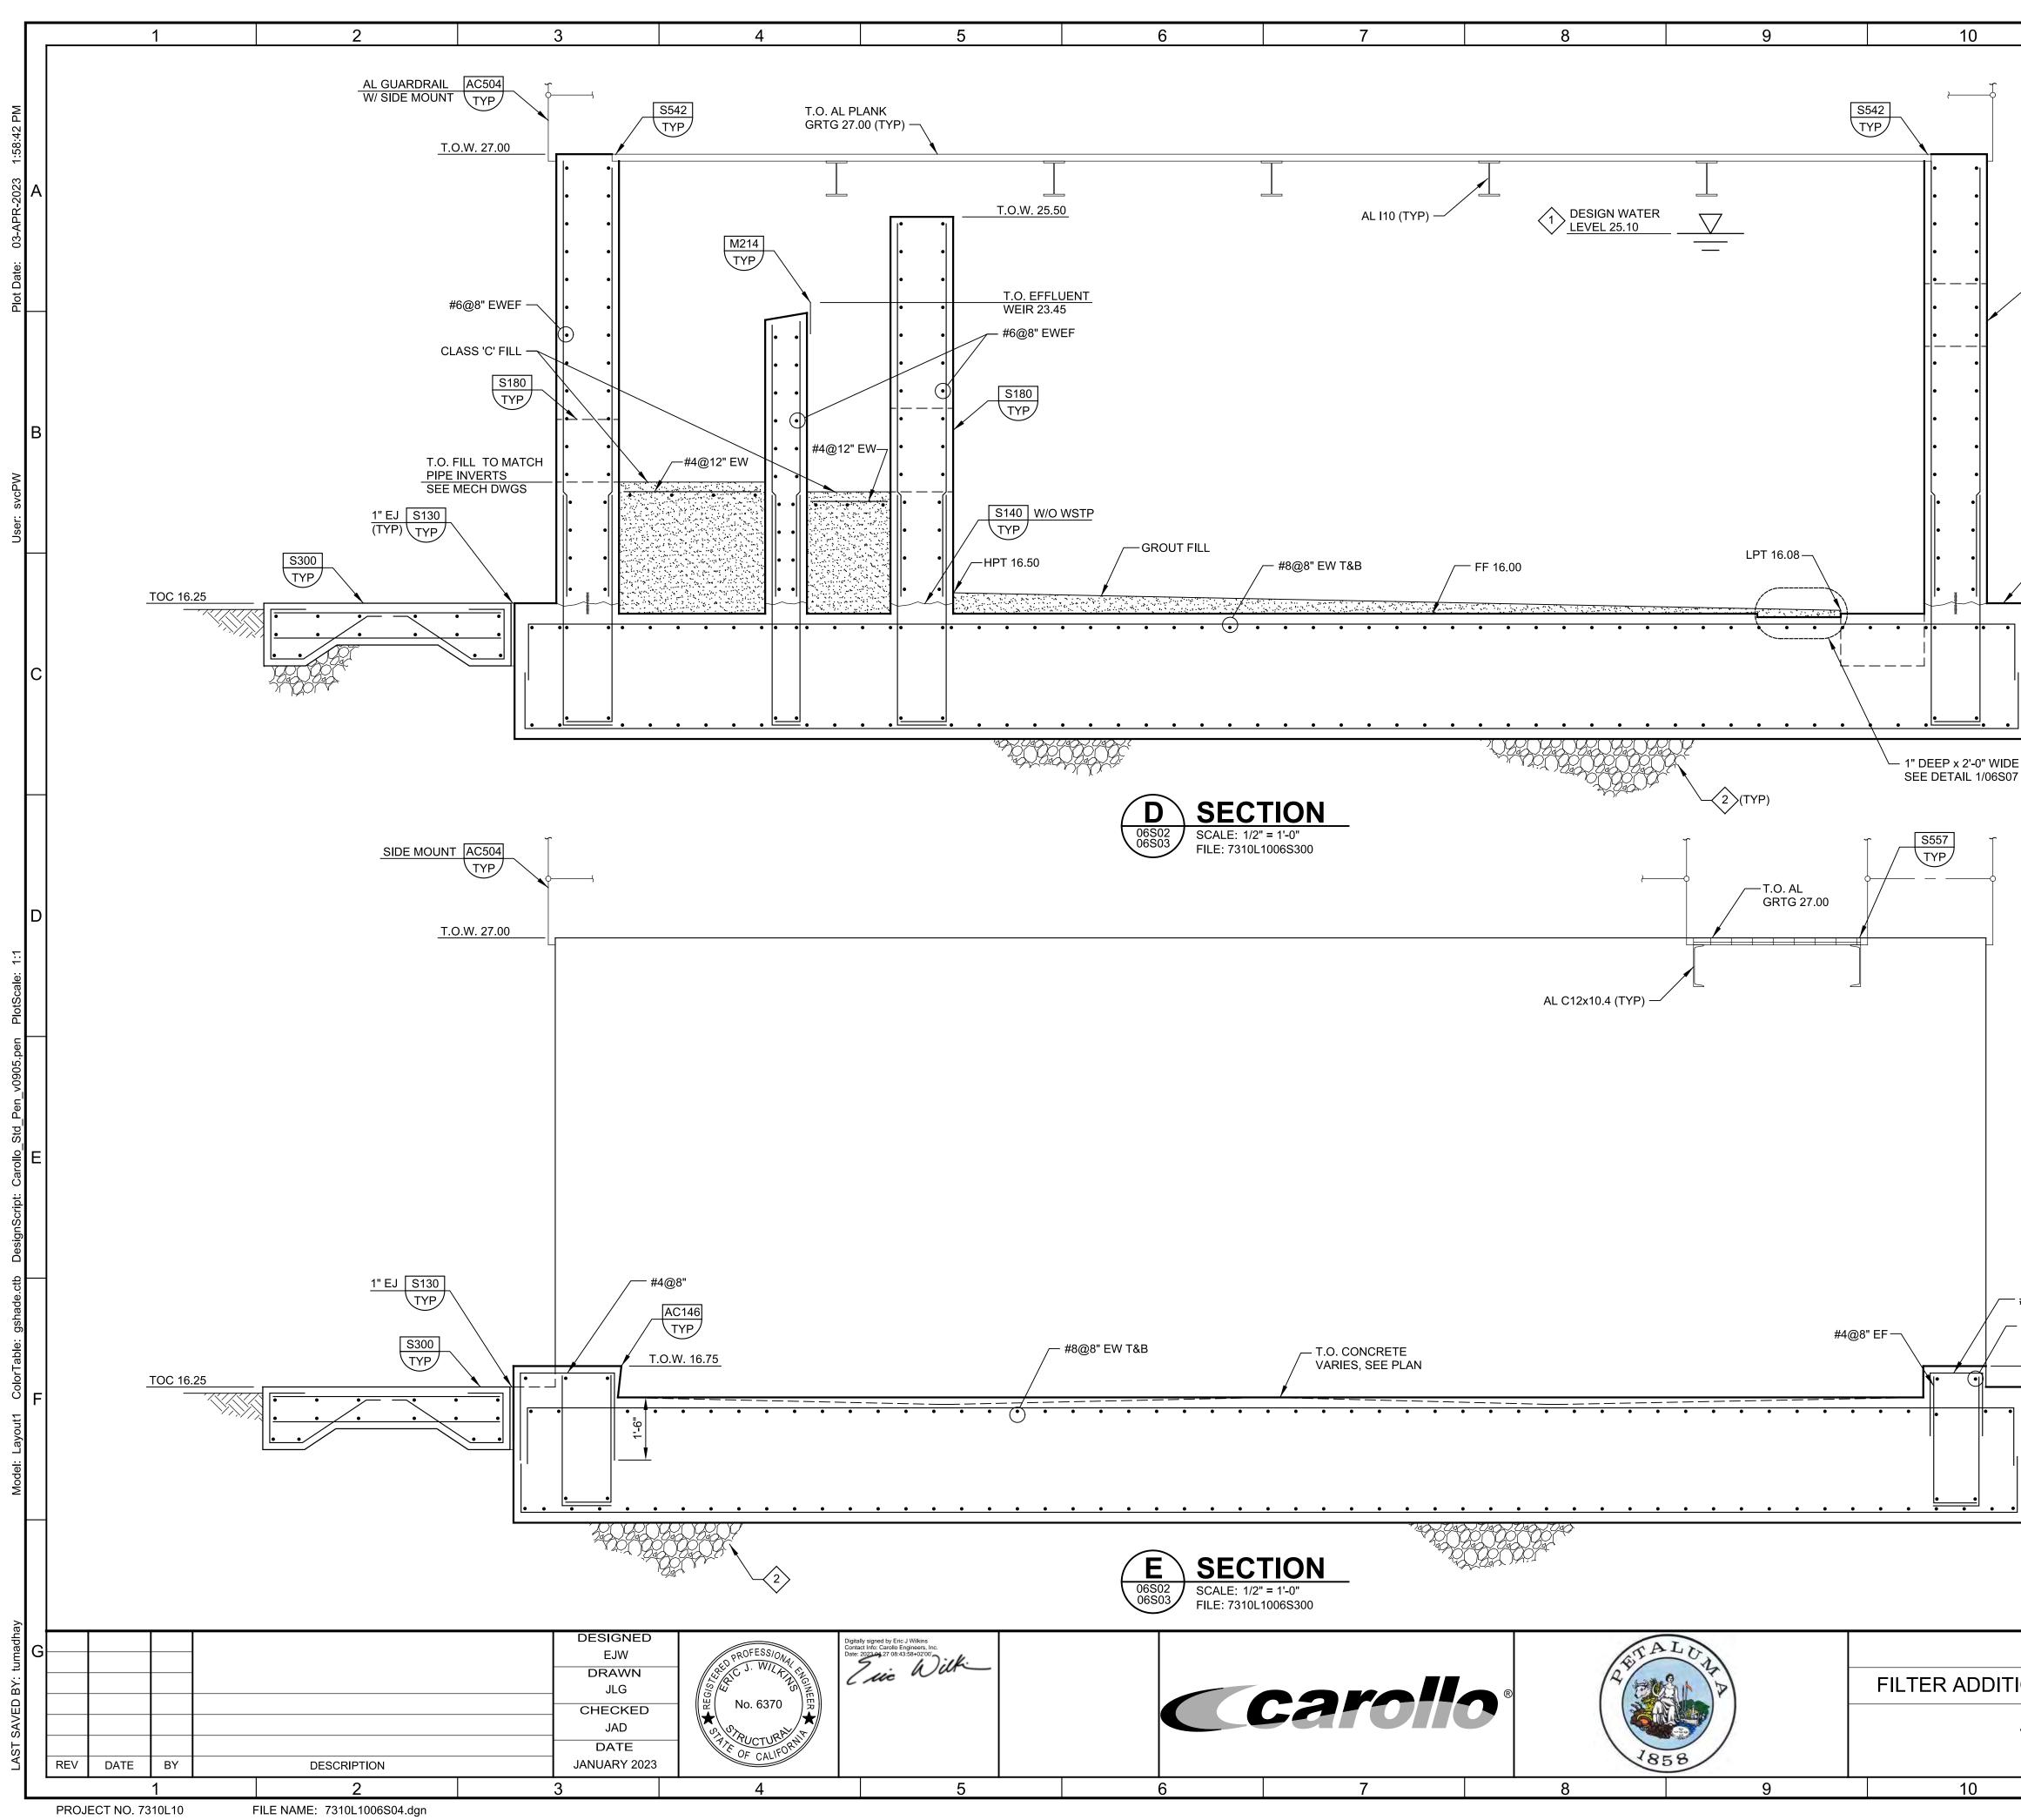
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GENERAL NOTES:

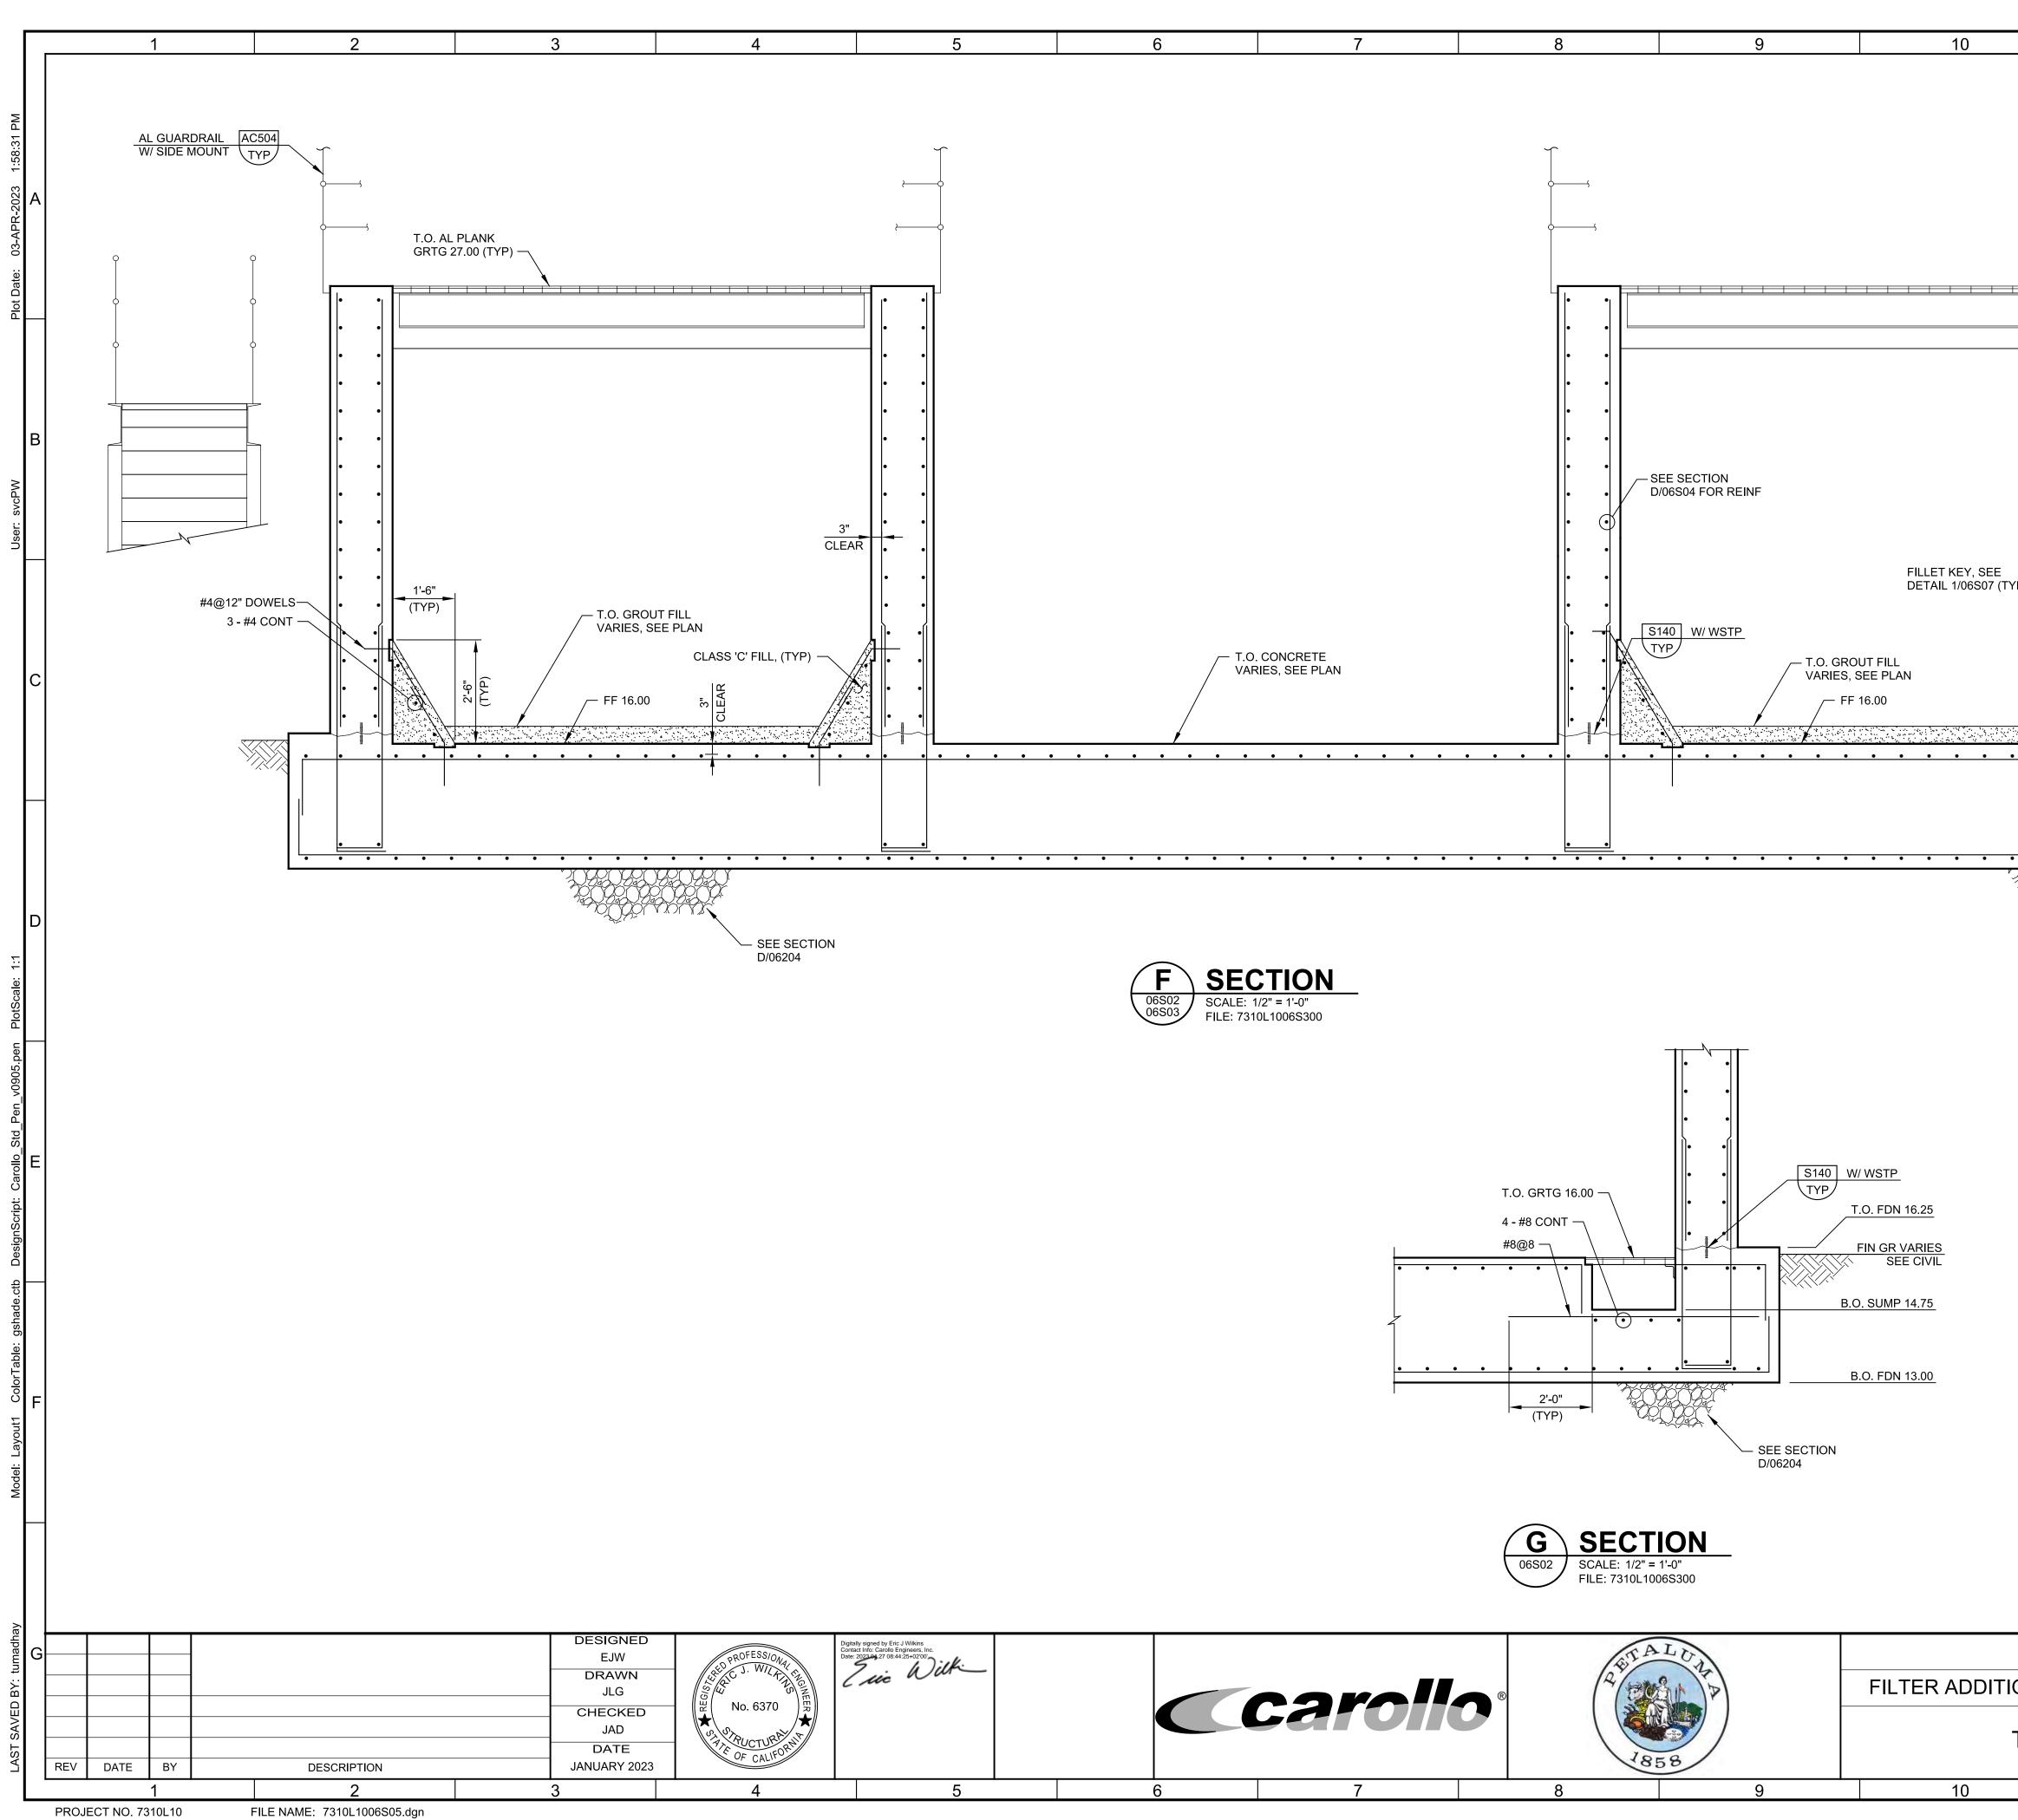
1. SEE SHEETS G10C & G11C FOR GENERAL STRUCTURAL NOTES.

2. SEE GENERAL NOTE 2/06S02 FOR STRUCTURAL DESIGN CRITERIA.

CITY C	F PETALUMA		VERIFY SCALES	JOB NO. 7310L.10	G
TON AND M	ISC. IMPROVEN	IENTS PROJECT	BAR IS ONE INCH ON ORIGINAL DRAWING	DRAWING NO.	
	STRUCTURAL		0 1"	06S03	
	Y FILTERS 6 8 OP PLAN	& 7	IF NOT ONE INCH ON THIS SHEET, ADJUST SCALES ACCORDINGLY	SHEET NO. 55 OF 130	
	11	12	13		1

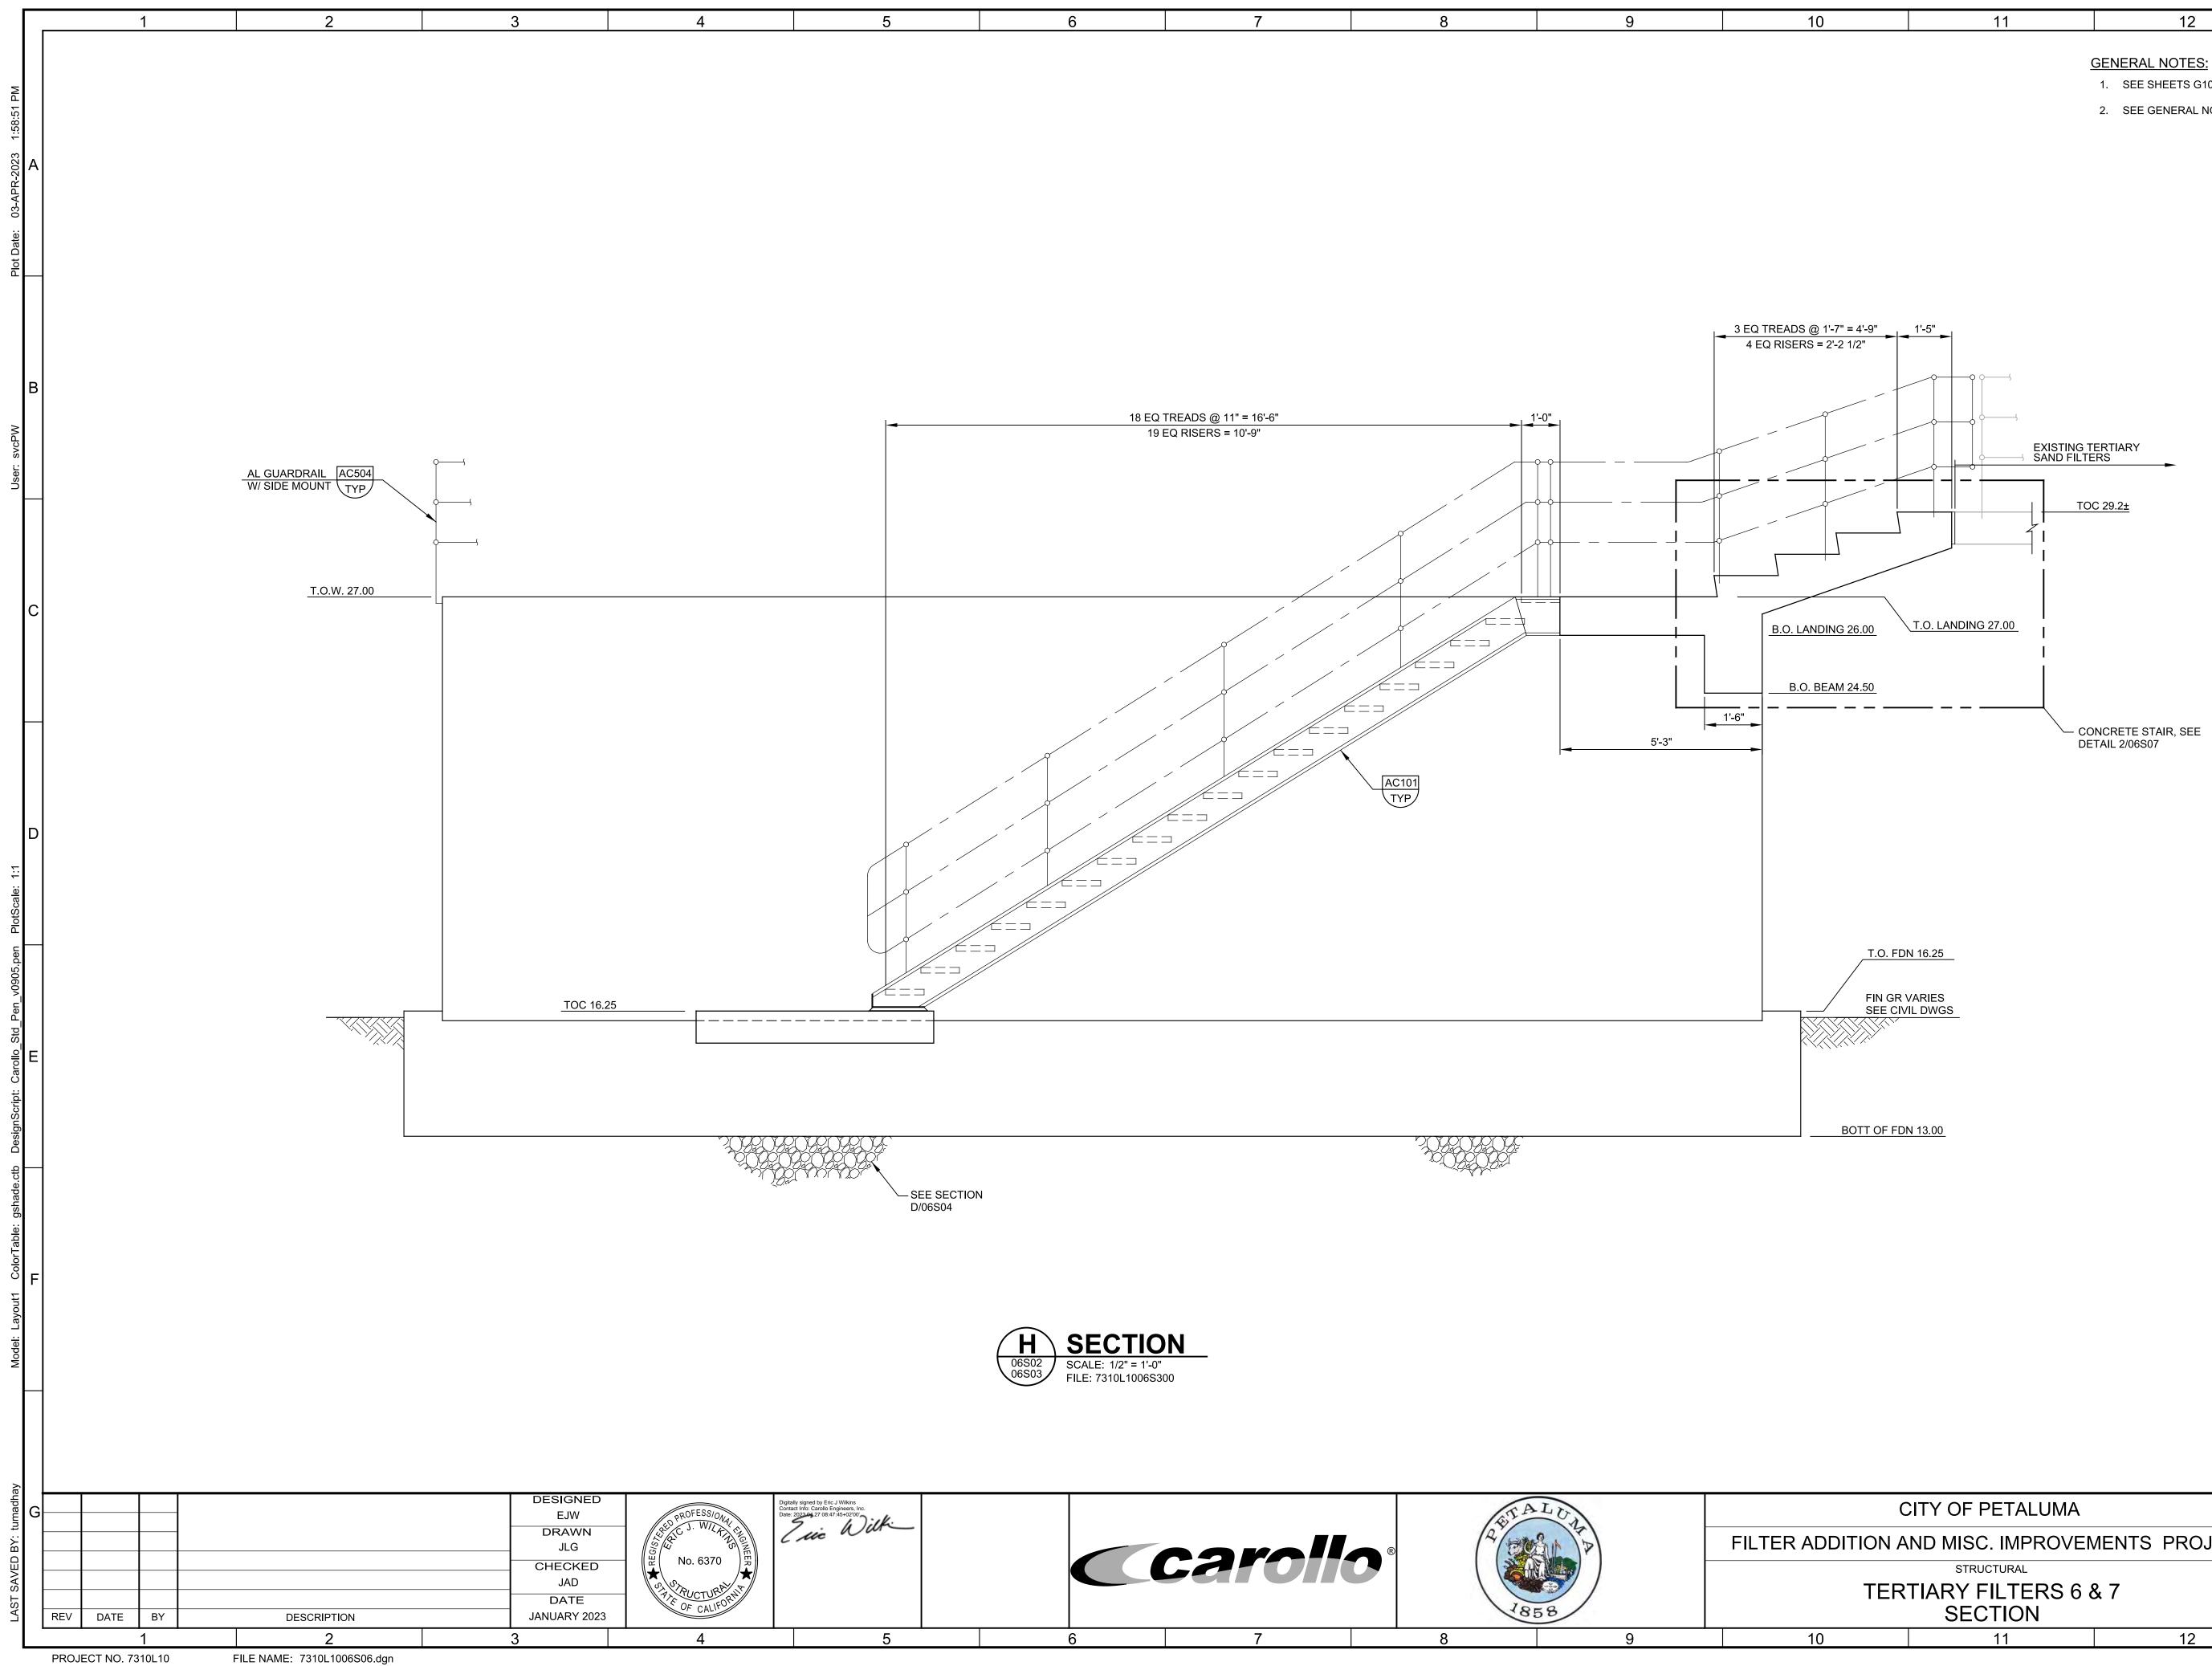


11	12	13	
<u>S180</u> TYP	GENERAL NOTES: 1. SEE SHEETS G10C & 2. SEE GENERAL NOTE KEY NOTES: 1 AT PEAK FLOW OF 7. 2 12" AGGREGATE BAS	G11C FOR GENERAL STRU 2/06S02 FOR STRUCTURAL 6 MGD. SE COURSE WRAPPED IN W	DESIGN CRITERIA.
<u>T.O. FDN 16.25</u>			В
5 #5 EQUALLY SPACE EWT&B	ED		С
			D
			E
- #4@8" - 2 - #4 CONT T.O.W. 16.75 T.O. FDN 16.25 FIN GR VARIES SEE CIVIL DWGS B.O. FDN 13.00			F
CITY OF PETALUMA TION AND MISC. IMPROVEI STRUCTURAL TERTIARY FILTERS 6 SECTIONS	& 7	0 1" IF NOT ONE INCH ON THIS SHEET, ADJUST SCALES ACCORDINGLY	JOB NO. 7310L.10 G DRAWING NO. 06S04 SHEET NO. 56 OF 130
11	12	13	



11 12 13	
<u>GENERAL NOTES:</u> 1. SEE SHEETS G10C & G11C FOR GENERAL STRUCTURAL NOTES 2. SEE GENERAL NOTE 2/06S02 FOR STRUCTURAL DESIGN CRITER	
	A
T.O.W. 27.00	
T.O.W. 25.50 BEYOND	В
 . .<	
TYP)	
T.O. FDN 16.25 FIN GR VARIES SEE CIVIL	C
BOTT OF FDN 13.00	
	D
	E

С	ITY OF PETALUMA		VERIFY SCALES	JOB NO. 7310L.10	G
ION A	ON AND MISC. IMPROVEMENTS PROJECT		BAR IS ONE INCH ON ORIGINAL DRAWING		
			0 1"	06S05	
TER1	FIARY FILTERS 6 8 SECTIONS	§ 7	IF NOT ONE INCH ON THIS SHEET, ADJUST SCALES ACCORDINGLY	SHEET NO. 57 OF 130	
	11	12	13		



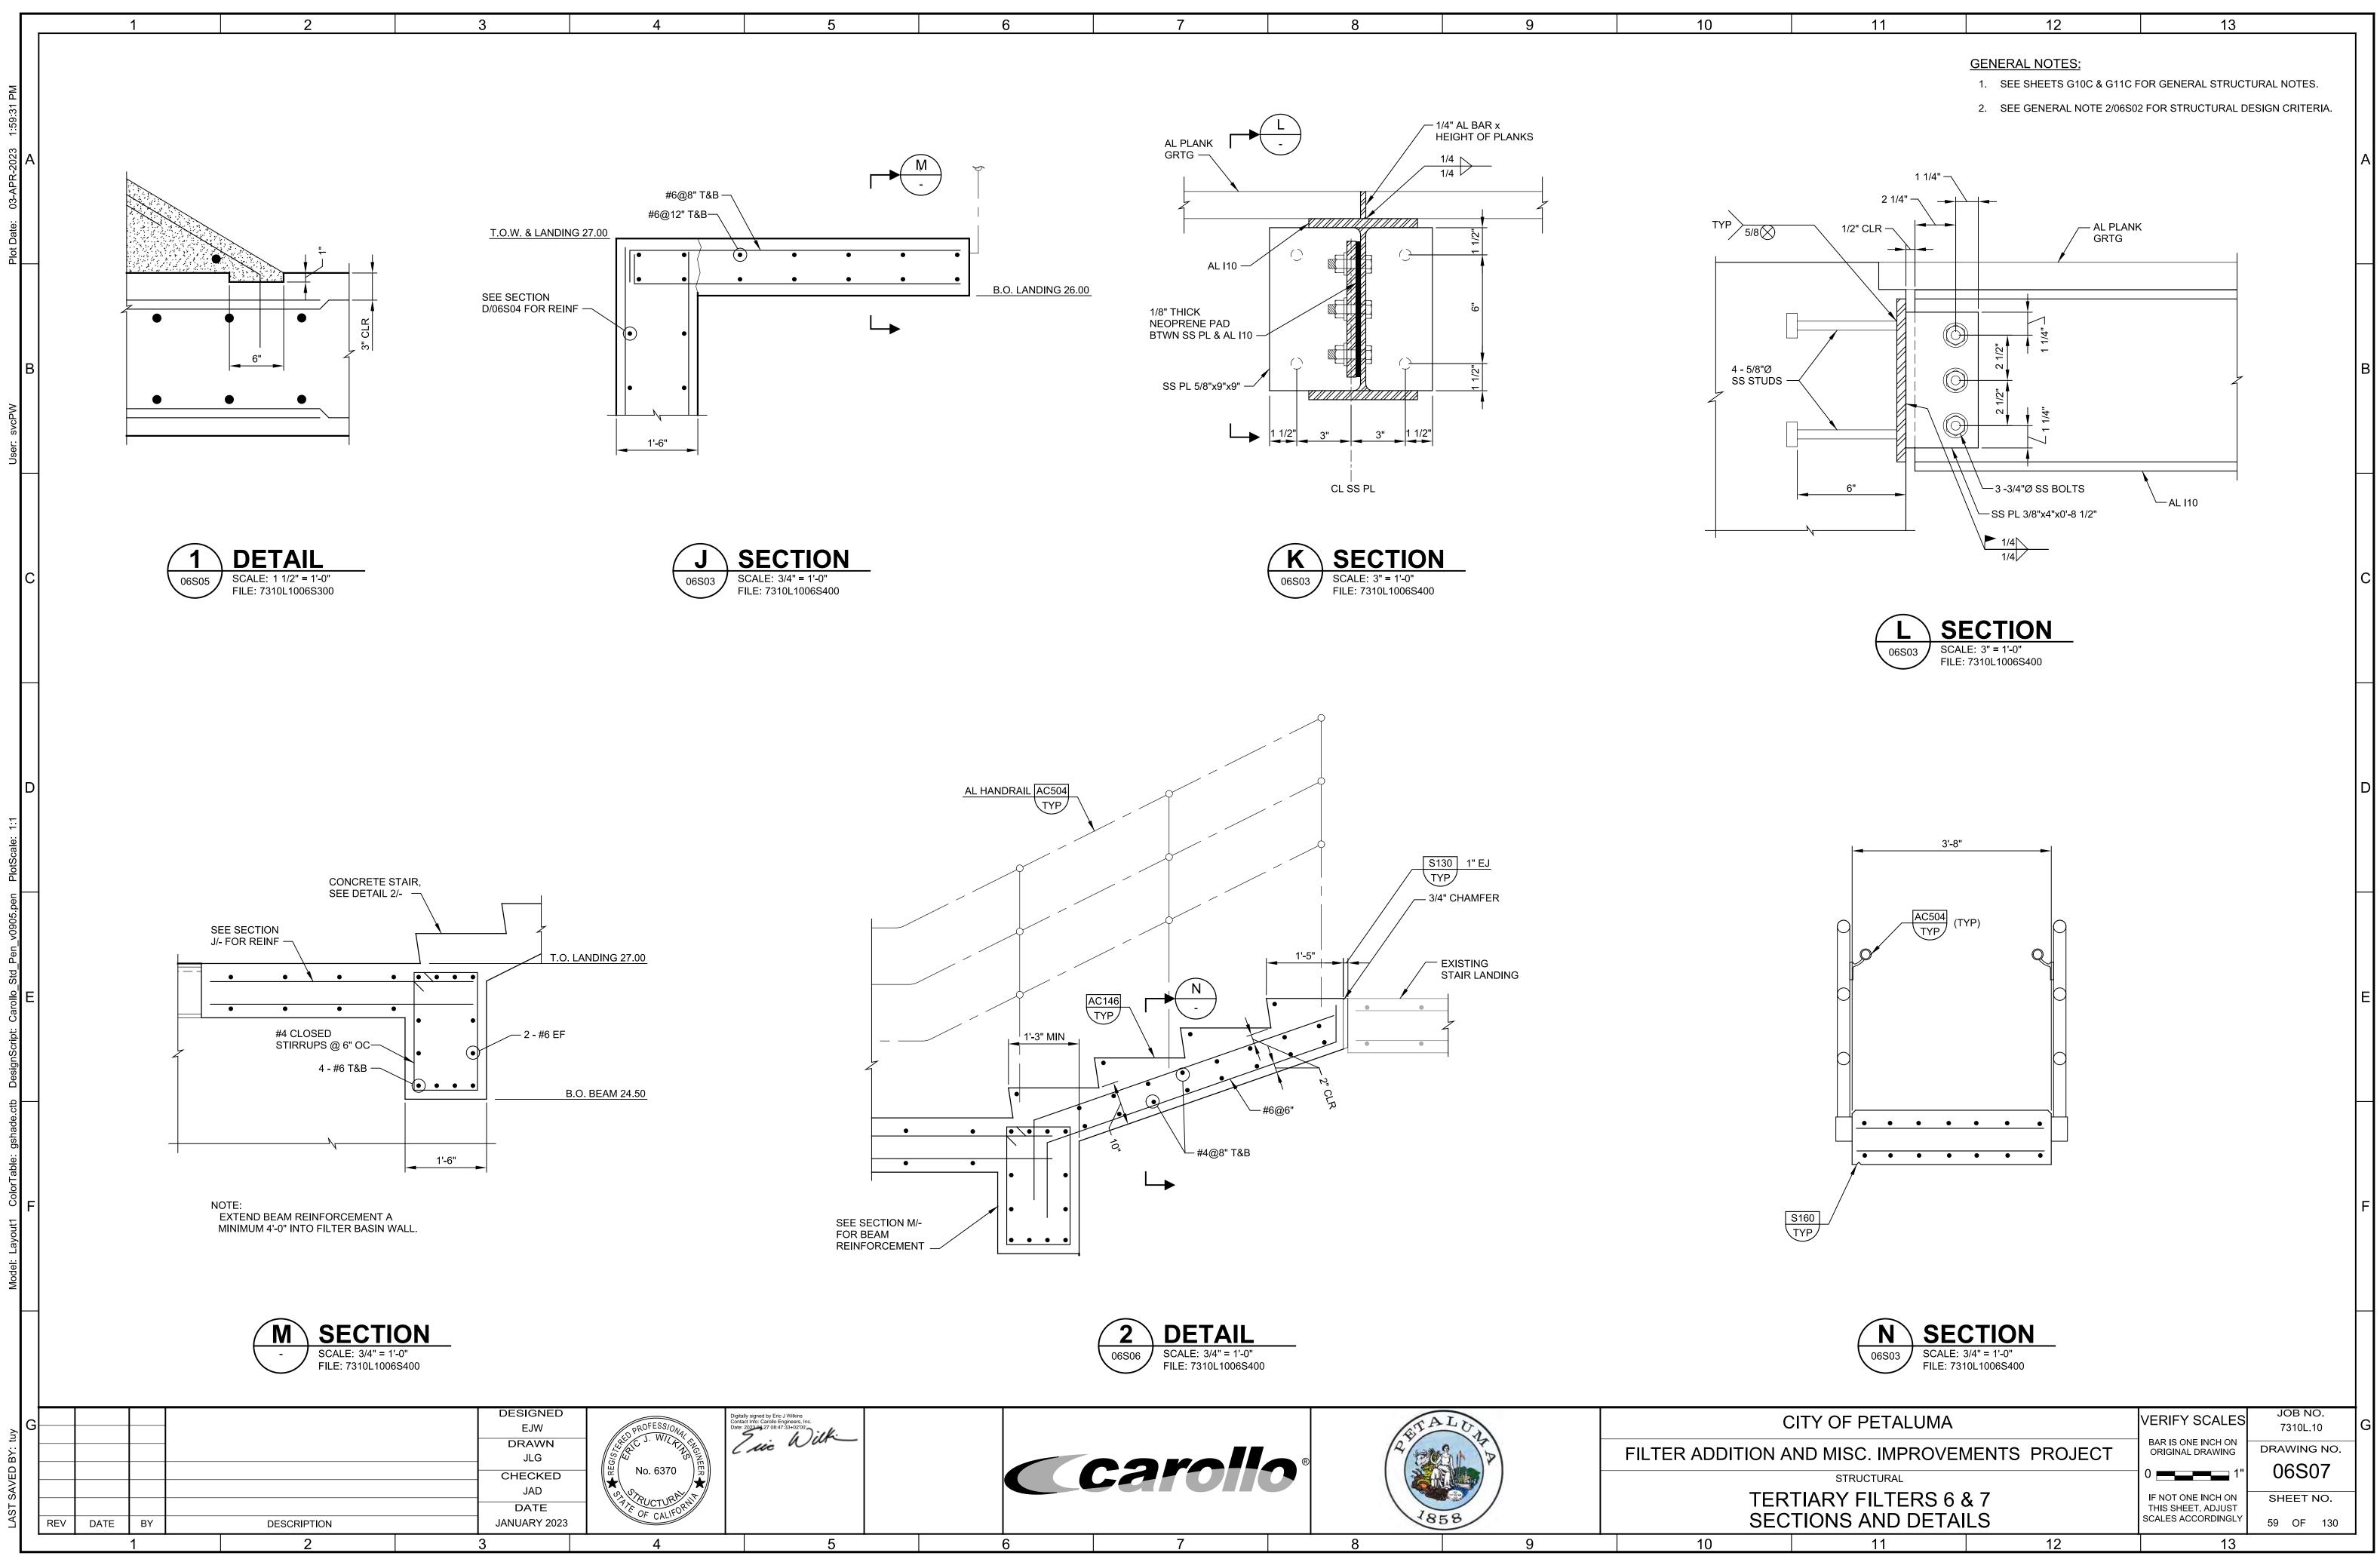
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GENERAL NOTES:

1. SEE SHEETS G10C & G11C FOR GENERAL STRUCTURAL NOTES.

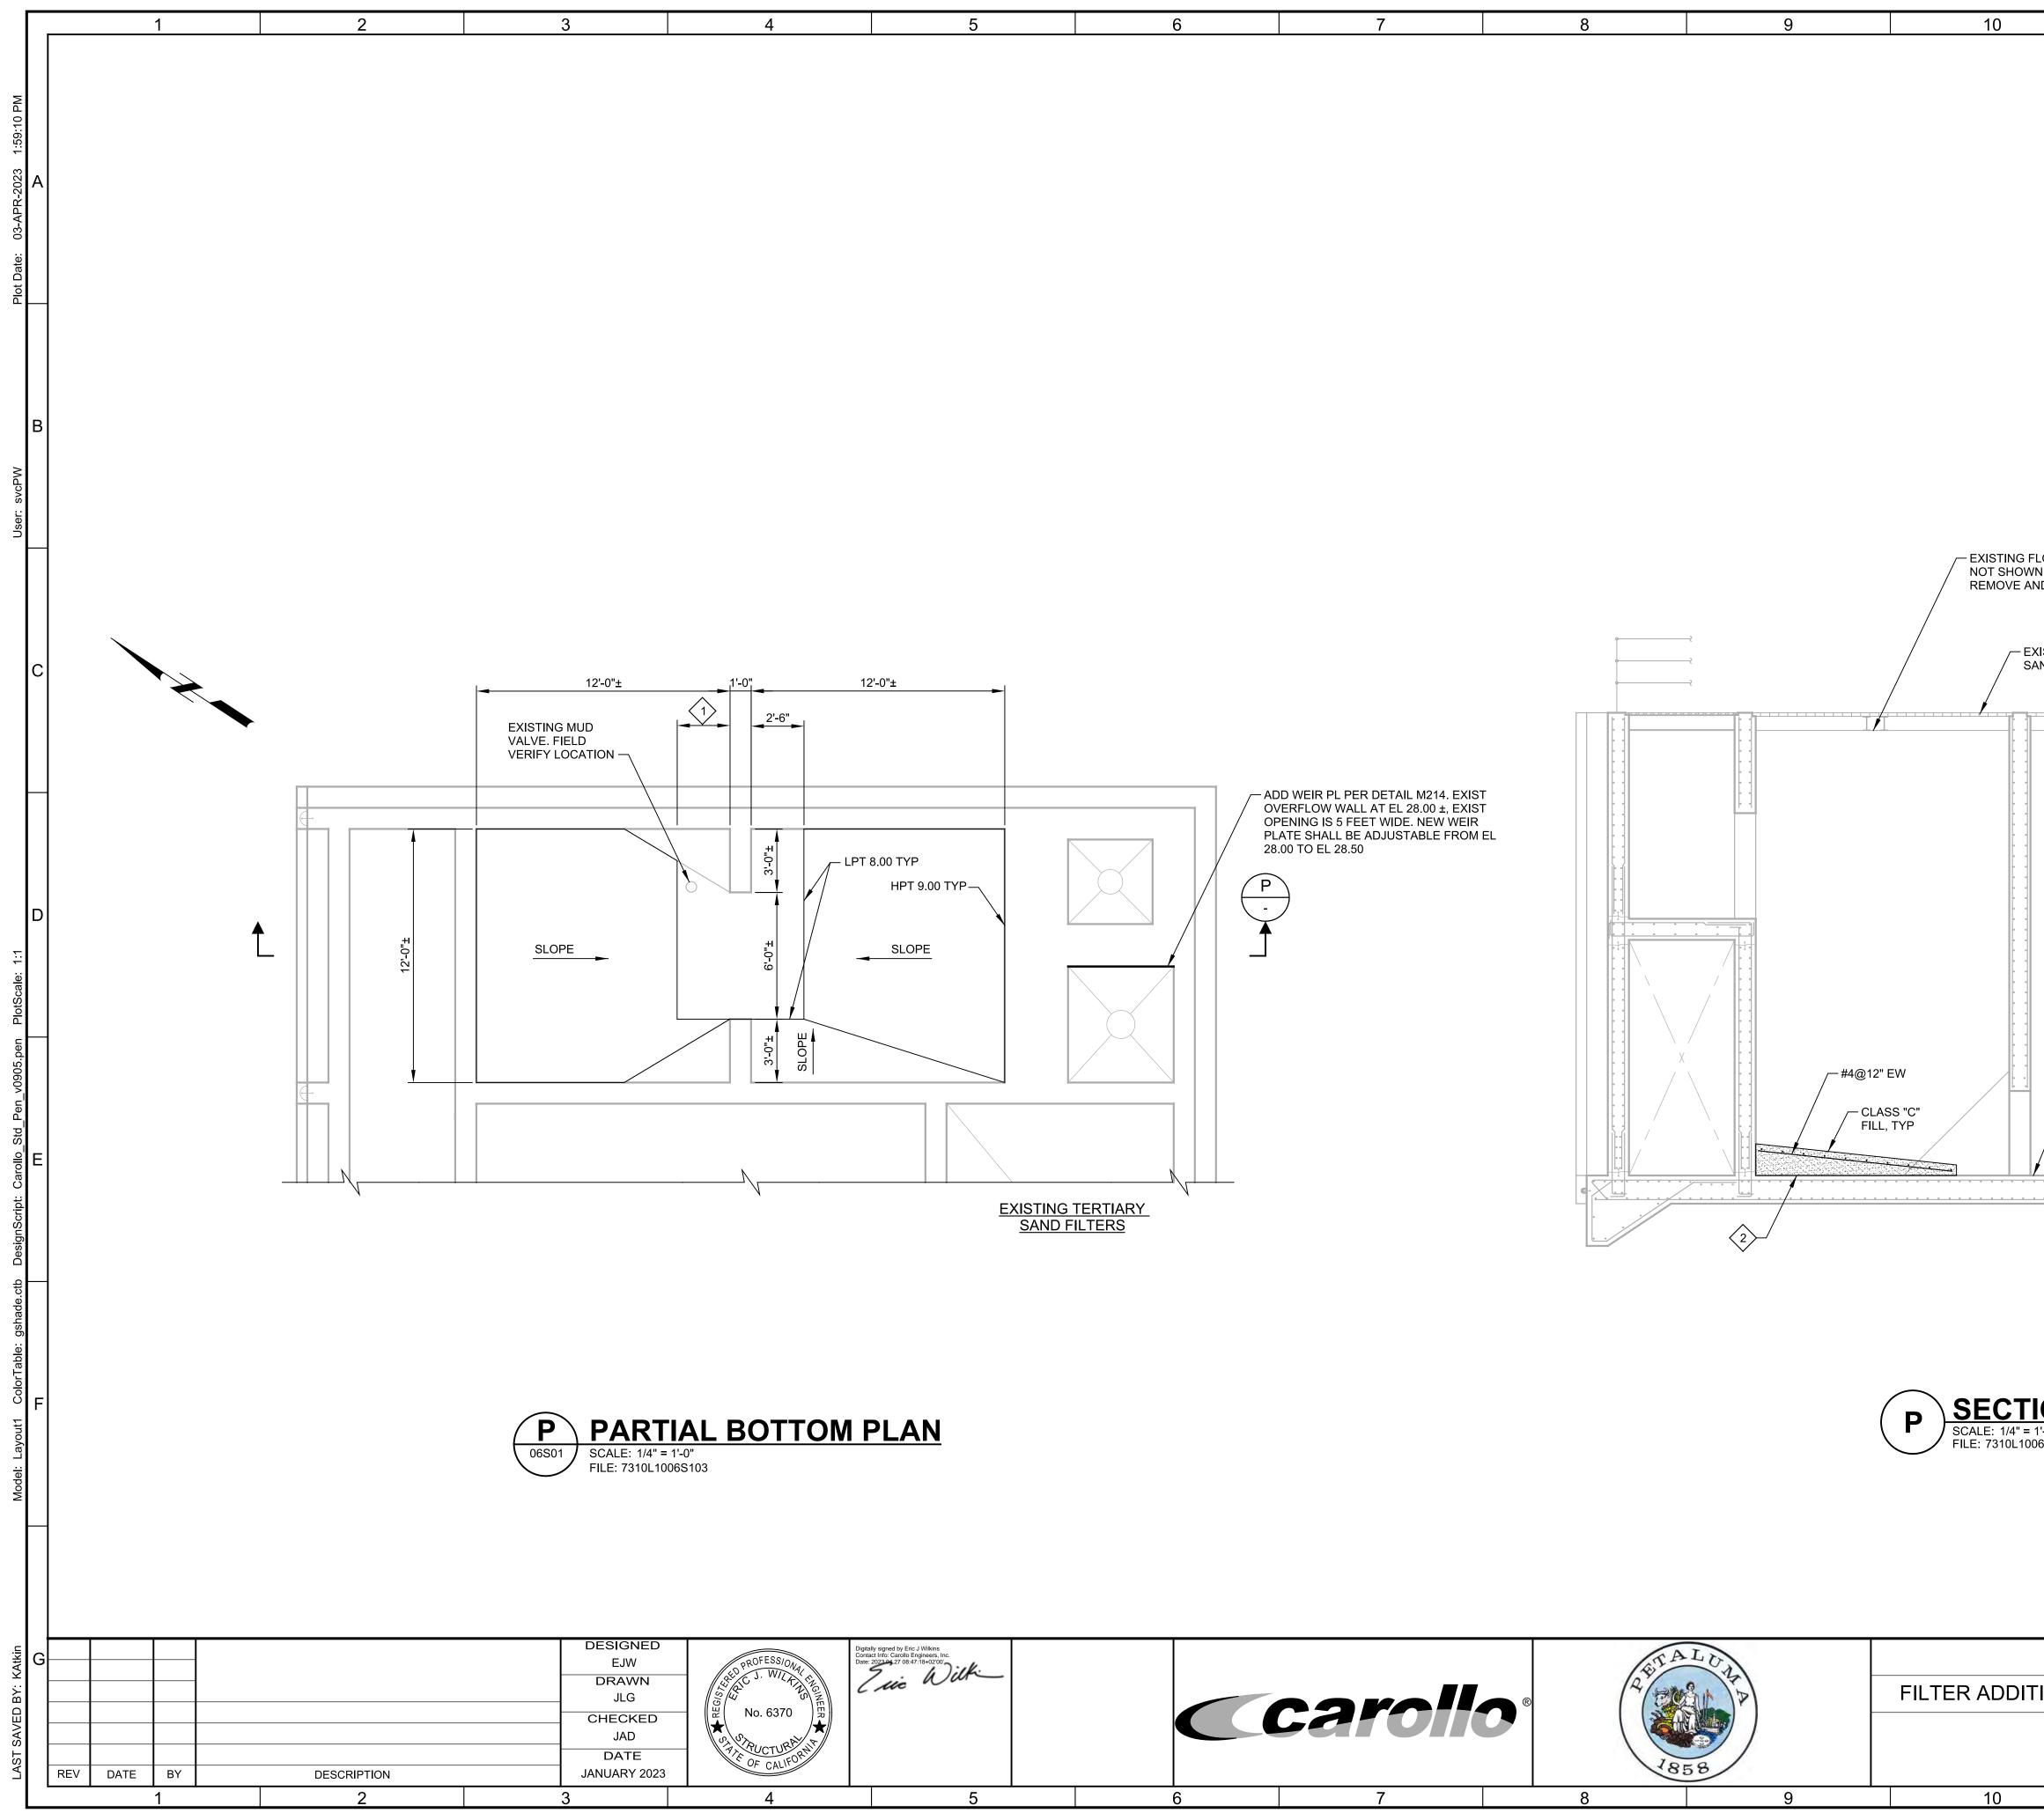
2. SEE GENERAL NOTE 2/06S02 FOR STRUCTURAL DESIGN CRITERIA.

CIT	CITY OF PETALUMA ION AND MISC. IMPROVEMENTS PROJECT STRUCTURAL		VERIFY SCALES	JOB NO. 7310L.10	G
ION AND MISC. IMPROVEMENTS PROJECT		BAR IS ONE INCH ON ORIGINAL DRAWING	DRAWING NO.		
STRUCTURAL		0 1"	06S06		
TERTI	ARY FILTERS 6 8 SECTION	& 7	IF NOT ONE INCH ON THIS SHEET, ADJUST SCALES ACCORDINGLY	SHEET NO. 58 OF 130	
	11	12	13		-



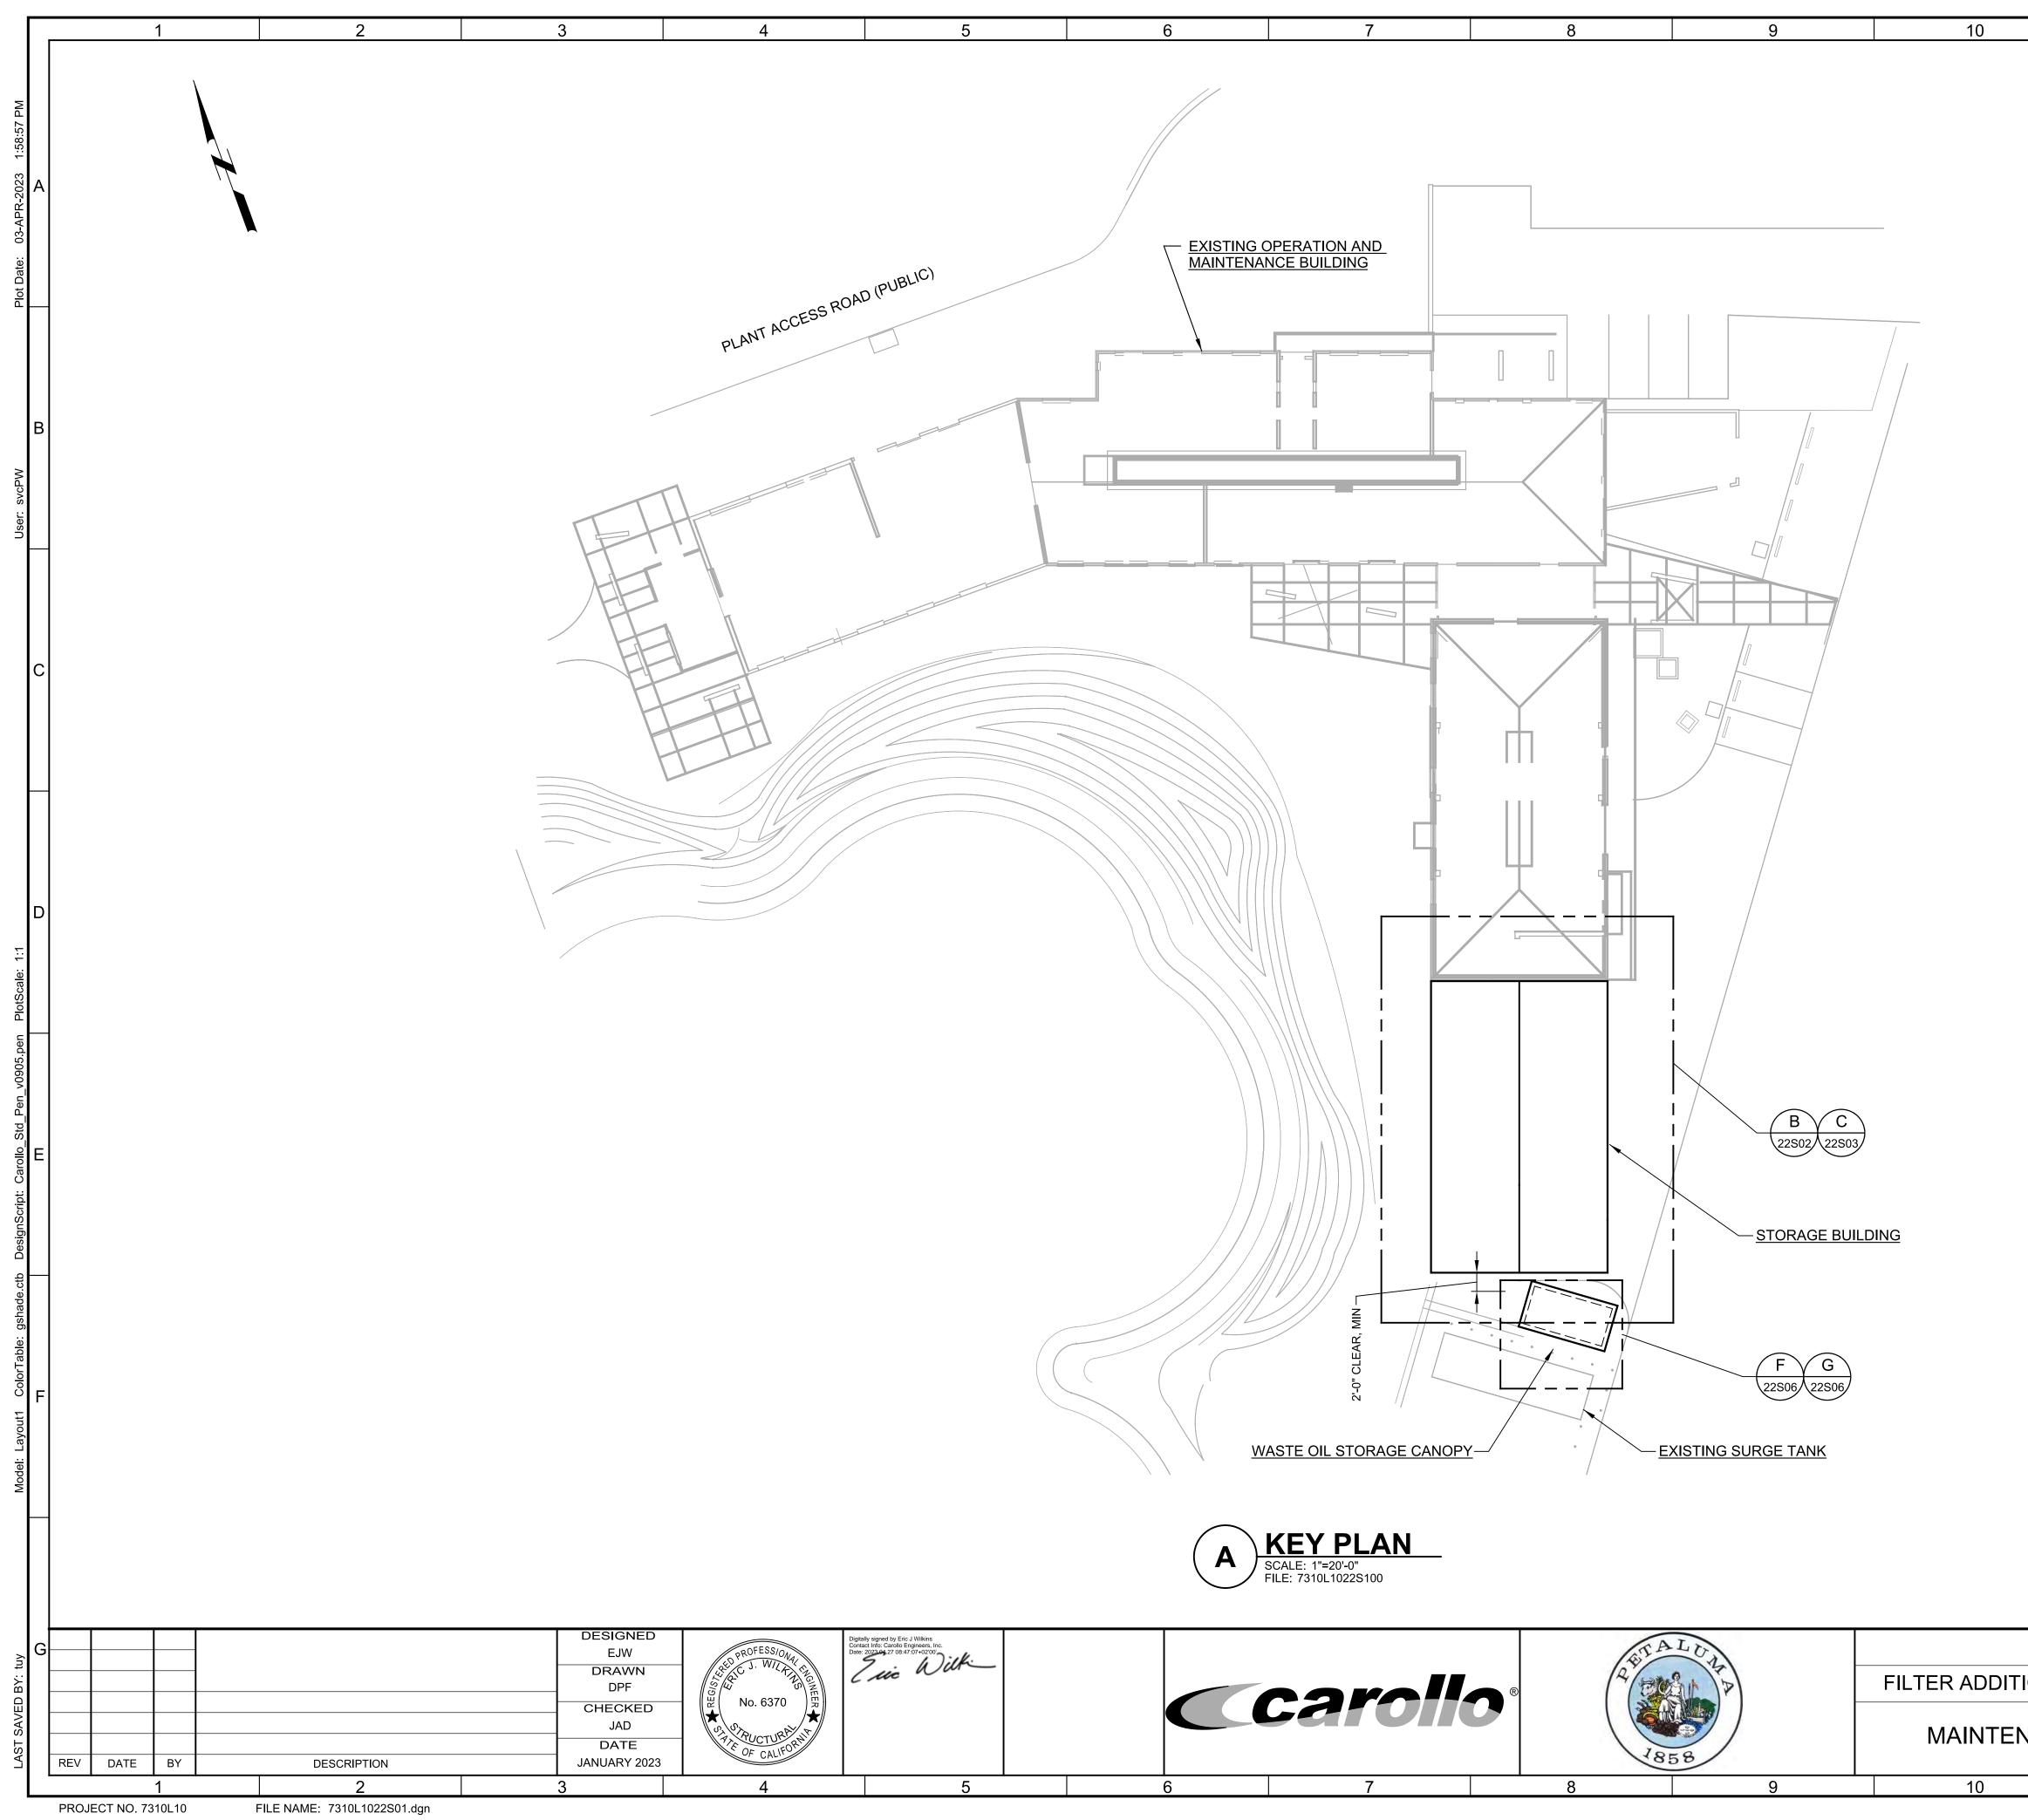
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	6	7	8	9	10



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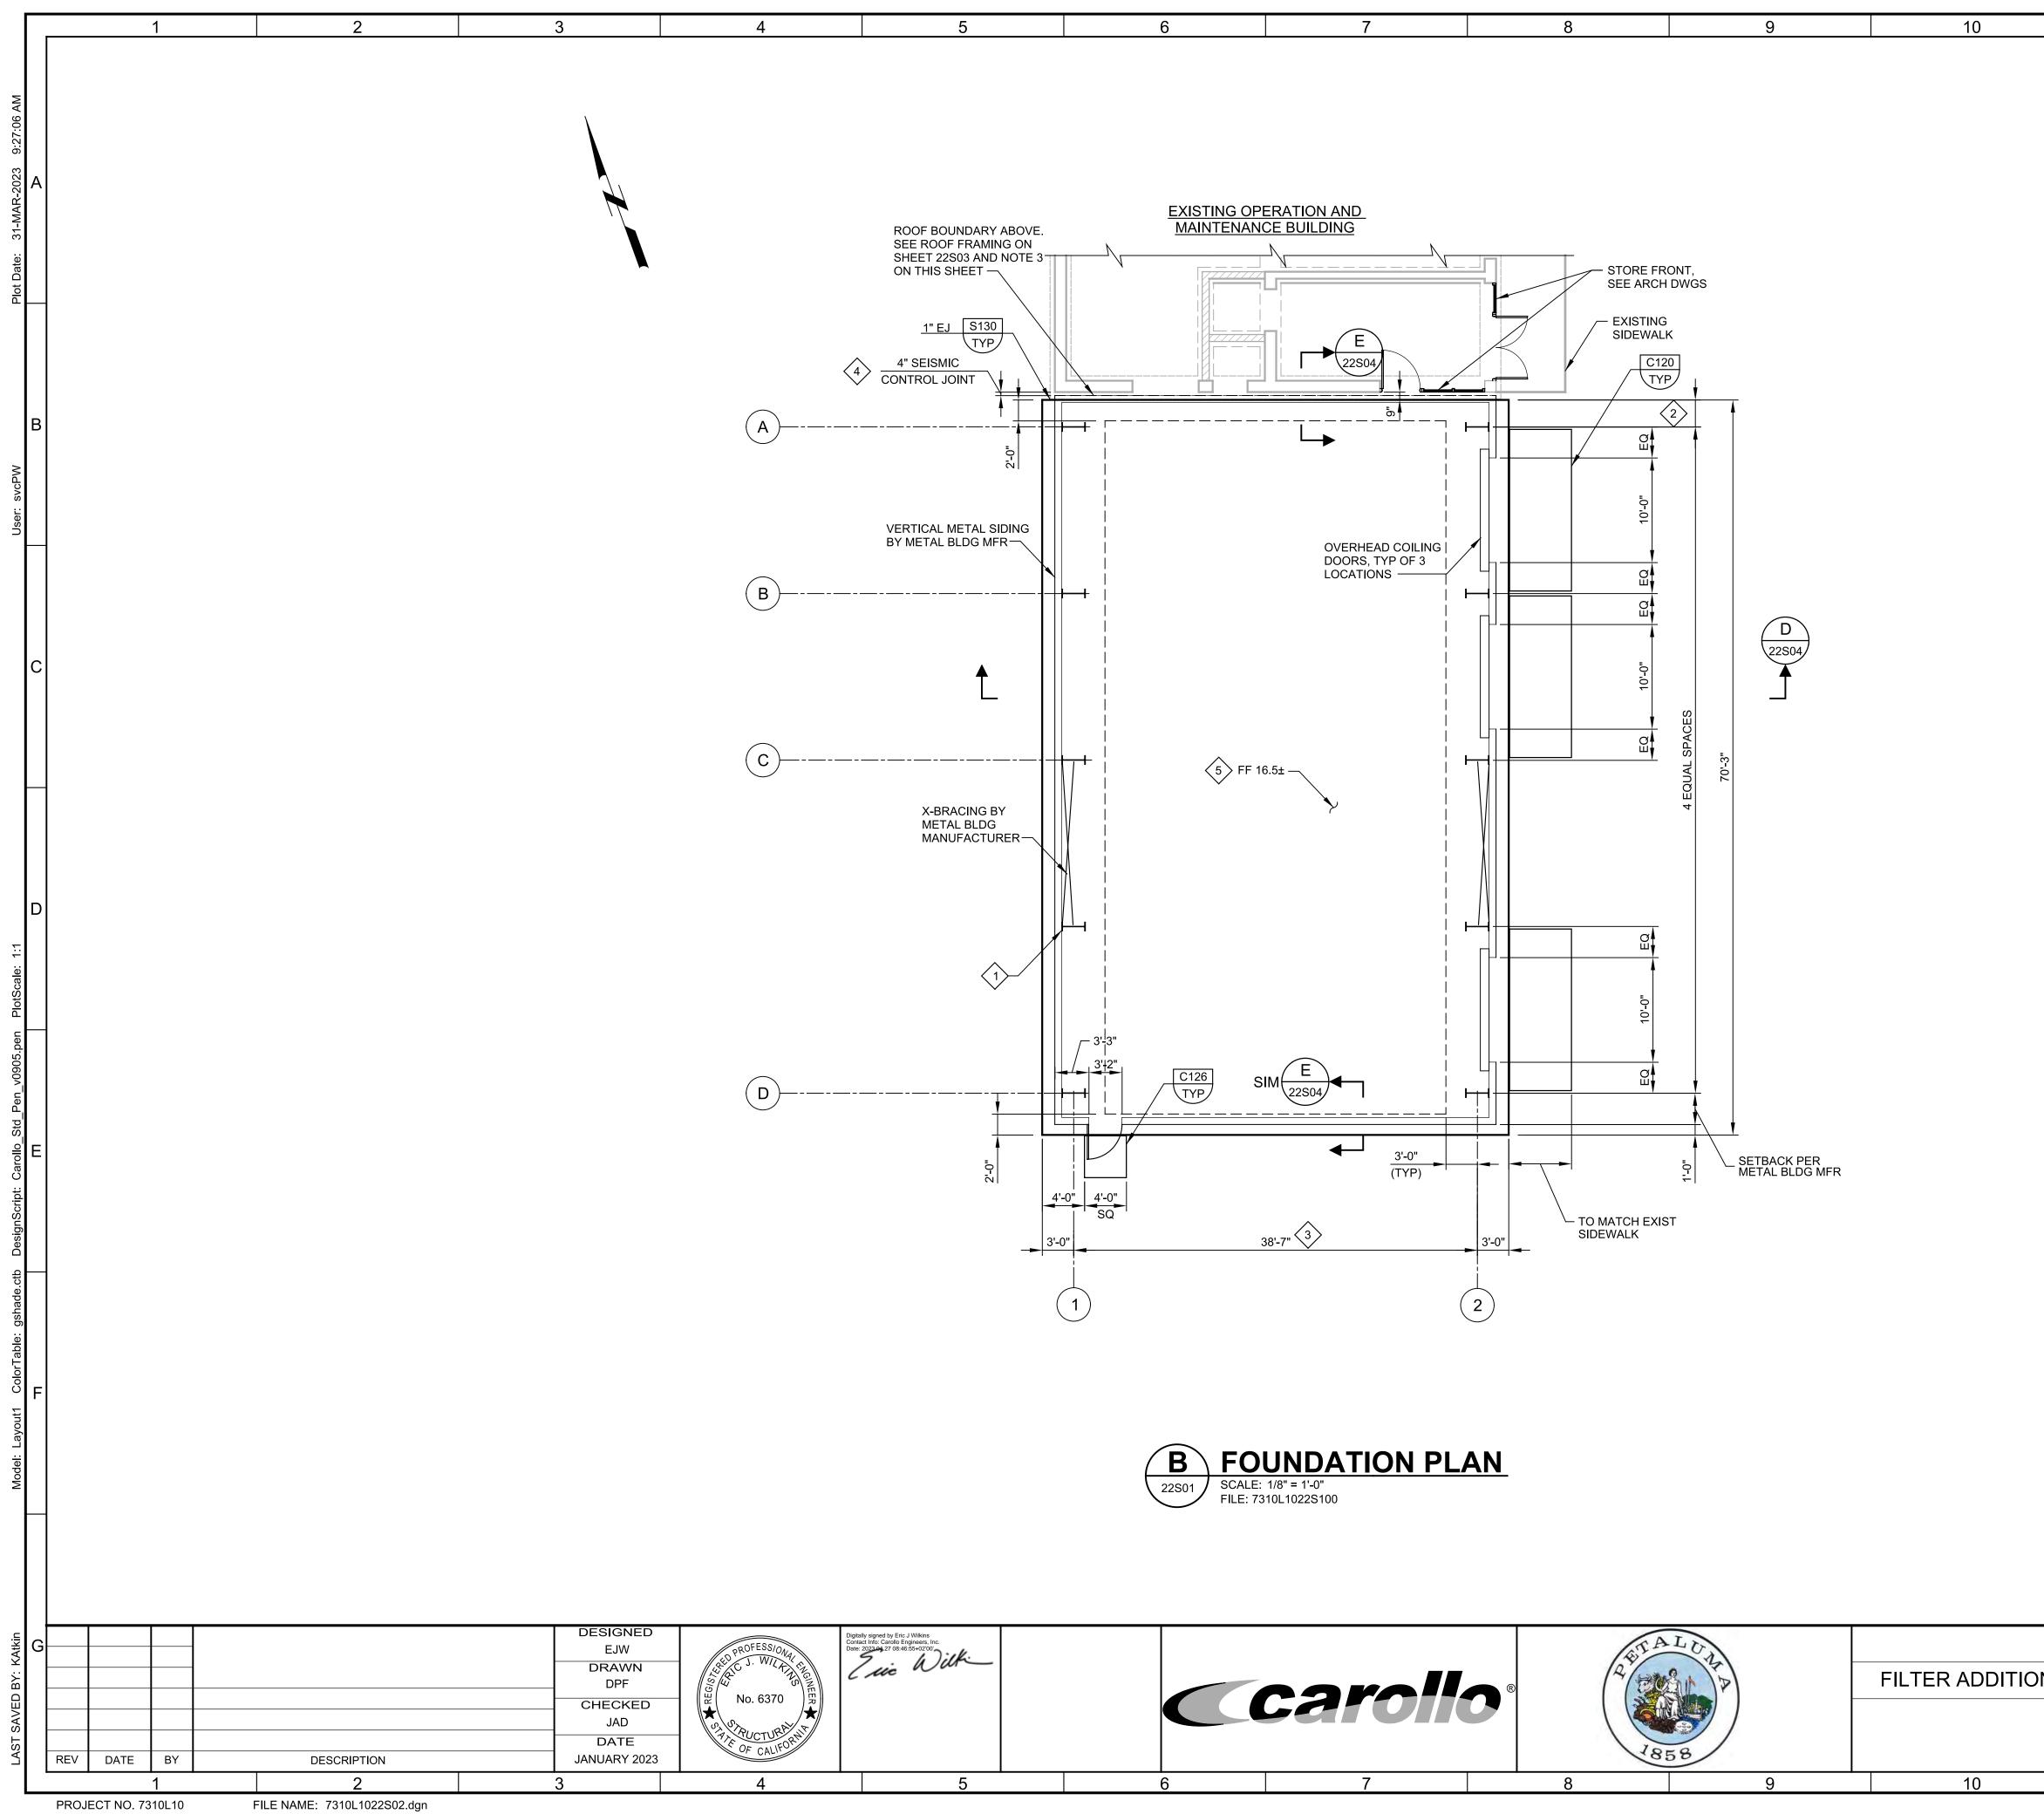
6 7	8 9	10 11	12 13	
			 GENERAL NOTES: SEE SHEETS G10C & G11C FOR GENERAL STRUCTURAL NOTES. DIMENSIONS SHOWN ARE BASED OFF THE RECORD DRAWINGS TITLED "ELLIS CREEK WATER RECYCLING FACILITY PROJECT" BY CAROLLO ENGINEERS DATED JULY 2005. CONTRACTOR SHALL FIELD VERIFY ALL DIMENSIONS PRIOR TO INITIATION OF CONSTRUCTION. <u>KEY NOTES:</u> 2'-6" MINIMUM. INCREASE AS REQUIRED TO MAINTAIN MINIMUM 1'-3" DIMENSION BETWEEN CENTERLINE OF EXISTING 6" MUD VALVE AND EDGE OF CONCRETE FILL. ROUGHEN SURFACE TO 1/4" AMPLITUDE. REMOVE ALL SIGNS OF OIL, DIRT AND LAITANCE AND APPLY EPOXY BONDING COMPOUND PRIOR TO PLACING CLASS 'C' CONCRETE FILL. EPOXY BONDING COMPOUND SHALL BE APPLIED IN STRICT ACCORDANCE WITH MANUFACTURER'S WRITTEN RECOMMENDATIONS. 	A
		- EXISTING FLOCULATORS IN EACH BASIN NOT SHOWN. CONTRACTOR SHALL REMOVE AND REINSTALL AS NEEDED.		
ADD WEIR PL PER DETAIL M214. EXIST OVERFLOW WALL AT EL 28.00 ±, EXIST OPENING IS 5 FEET WIDE. NEW WEIR PLATE SHALL BE ADJUSTABLE FROM EL 28.00 TO EL 28.50		EXISTING TERTIARY SAND FILTERS	T.O.W. 29.5±	c
EXISTING TERTIARY SAND FILTERS	FIL FIL	2" EW ASS "C" L, TYP ELEVATION VARIES, SEE PLAN		E
		BECTION SCALE: 1/4" = 1'-0" FILE: 7310L1006S302		F
6 7	8 9	CITY OF PETALUI FILTER ADDITION AND MISC. IMPRO STRUCTURAL FLOCCULATION T PLAN & SECTION 10 11	DVEMENTS PROJECT BAR IS ONE INCH ON ORIGINAL DRAWING DRAWING NO. 0 <td< td=""><td>G</td></td<>	G



11	12	13	
	GENERAL NOTES:		

1. SEE SHEETS G10C & G11C FOR GENERAL STRUCTURAL NOTES..

CITY OF PETALUMA			VERIFY SCALES	JOB NO. 7310L.10	G
TION AND MISC. IMPROVEMENTS PROJECT			BAR IS ONE INCH ON ORIGINAL DRAWING		
STRUCTURAL			0 1"	22S01	
NANCE AND STORAGE BUILDINGS			IF NOT ONE INCH ON THIS SHEET, ADJUST	SHEET NO.	
KEY PLAN			SCALES ACCORDINGLY	61 OF 130	
	11 12		13		



6	7	8	9 1	0

	10			
11	12	13		
	GENERAL NOTES: 1. SEE SHEETS G10C & G NOTES.	11C FOR GENERAL STRUC	TURAL	
	DRAWINGS TITLED "ELI FACILITY PROJECT" BY	RE BASED OFF THE RECO LIS CREEK WATER RECYCI CAROLLO ENGINEERS DA IALL FIELD VERIFY ALL DIM ION.	LING TED JULY	А
		IALL HAVE NO WALL SIDIN L BE OPEN TO THE EXISTIN		
	REINFORCEMENTS ARI DIMENSIONS AND REIN COORDINATED WITH T	G FOUNDATION DIMENSION E SHOWN ON THIS SHEET. IFORCEMENT SHALL BE HE ACTUAL BUILDING LOAI IE APPROVED PRE-ENGINE IITTAL.	FINAL DS AS	
	5. THE PRE-ENGINEERED FOLLOWING MINIMUM S CBC 2019 AND ASCE 7- A. E-W SEISMIC FORCE STEEL ORDINARY M RESPONSE MODIFIC B. N-S SEISMIC FORCE	METAL BUILDING SHALL H STRUCTURAL DESIGN CRIT 16: RESISTING SYSTEM: OMENT FRAME WITH ATION FACTOR, R= 3 1/2 RESISTING SYSTEM: DNCENTRICALLY BRACED		В
	PERPENDICULAR TO (N-S DIRECTION): H/2	PORTAL FRAMES 250 WHERE H IS		
		PSF ELASSIFICATION: ED. DIL BEARING PRESSURE:		
		LUDING SEISMIC OR WIND.		
	6. REFER TO DRAWING 22 ROOM FINISH SCHEDU KEY NOTES:	2A01 FOR DOOR, HARDWAI LES.	RE, AND	С
	1 PRE-ENGINEERED MI	ETAL BUILDING. SEE NOTE CATION SECTION 13122 FO		
		ASE AS REQUIRED BY MET D ANCHORAGE REQUIREM		
	BUILDING MANUFACT	VITH PRE-ENGINEERED ME TURER AND EXISTING OPE DING. SEE KEY NOTE 2/22S ATION	RATIONS AND	
	4 SEISMIC CONTROL	. JOINT TO BE PROVIDED E TURER FOR A WATER AND		D
	5 MATCH EXISTING OP BUILDING FINISH FLC	ERATIONS AND MAINTENA OOR ELEVATION.	NCE	
				E
				F
CITY OF PETALUMA		VERIFY SCALES	JOB NO.	
N AND MISC. IMPROVEN	MENTS PROJECT		7310L.10 DRAWING NO.	G
			22S02	
	•	IE NOT ONE INCH ON		

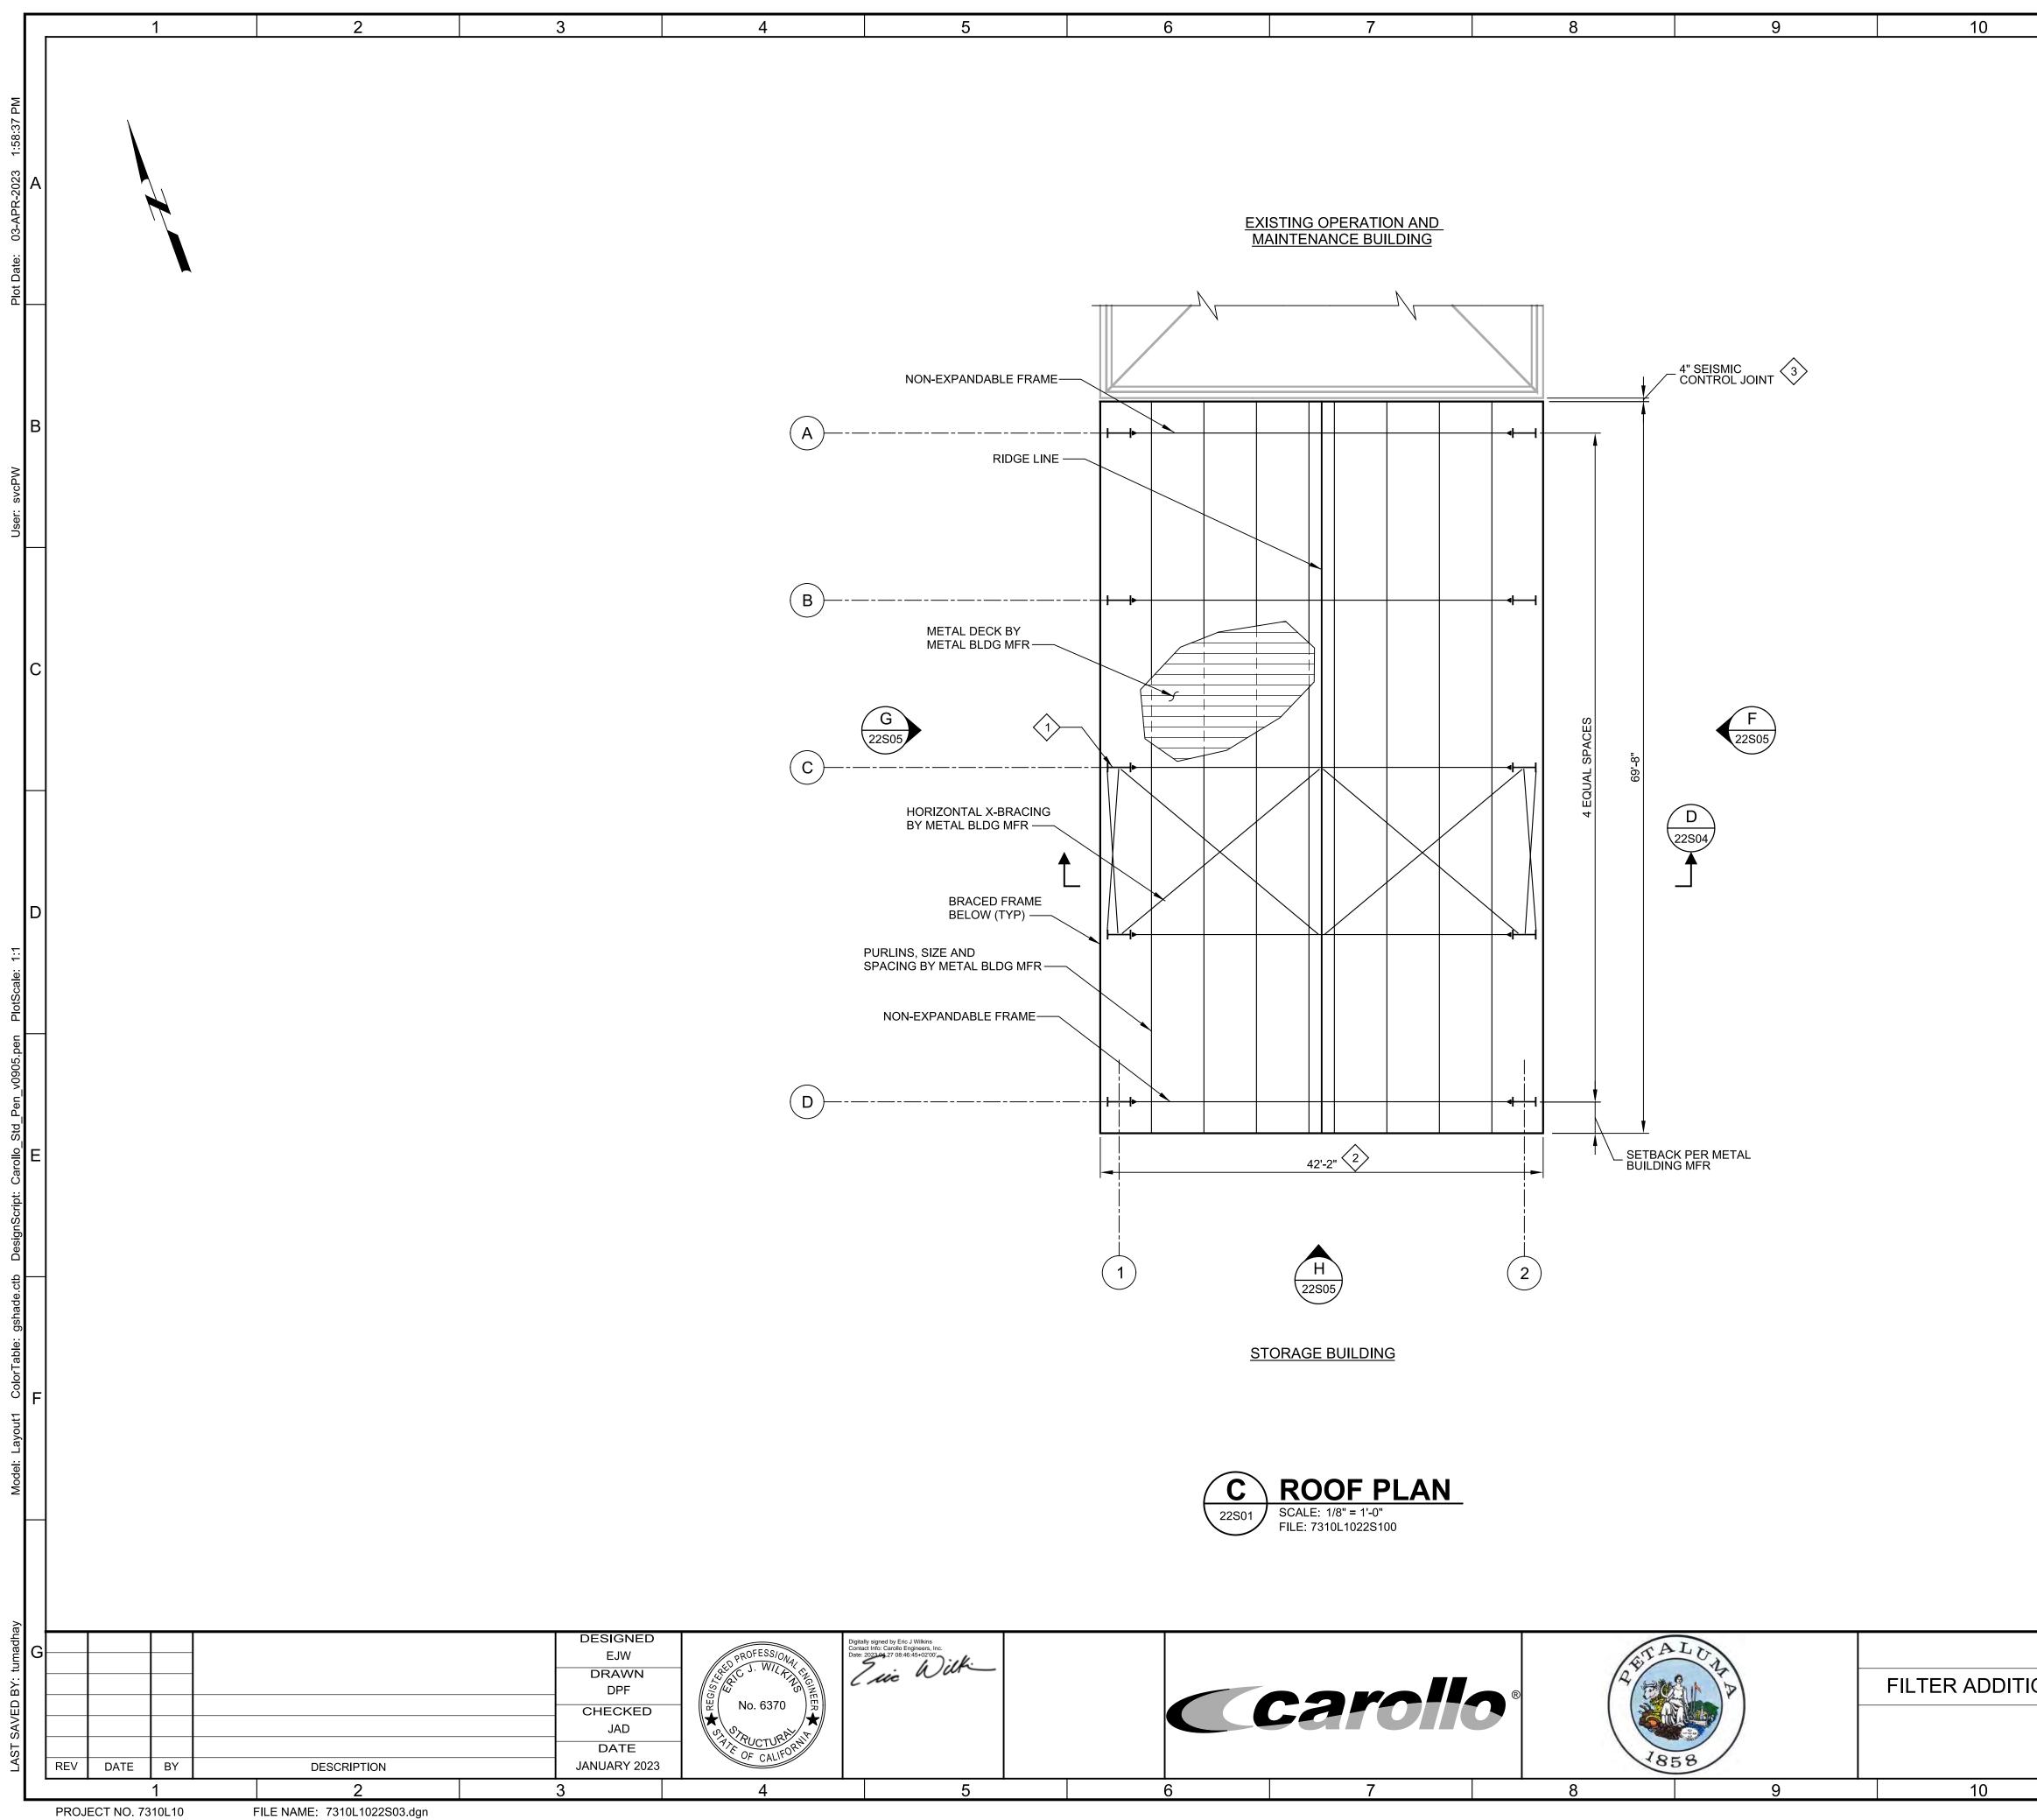
STORAGE BUILDING
FOUNDATION PLAN

IF NOT ONE INCH ON THIS SHEET, ADJUST SCALES ACCORDINGLY

13

SHEET NO.

61 OF 129



GENERAL NOTES:

- 1. SEE SHEETS G10C & G11C FOR GENERAL STRUCTURAL NOTES.
- 2. DIMENSIONS SHOWN ARE BASED OFF THE RECORD DRAWINGS TITLED "ELLIS CREEK WATER RECYCLING FACILITY PROJECT" BY CAROLLO ENGINEERS DATED JULY 2005. CONTRACTOR SHALL FIELD VERIFY ALL DIMENSIONS PRIOR TO CONSTRUCTION.

13

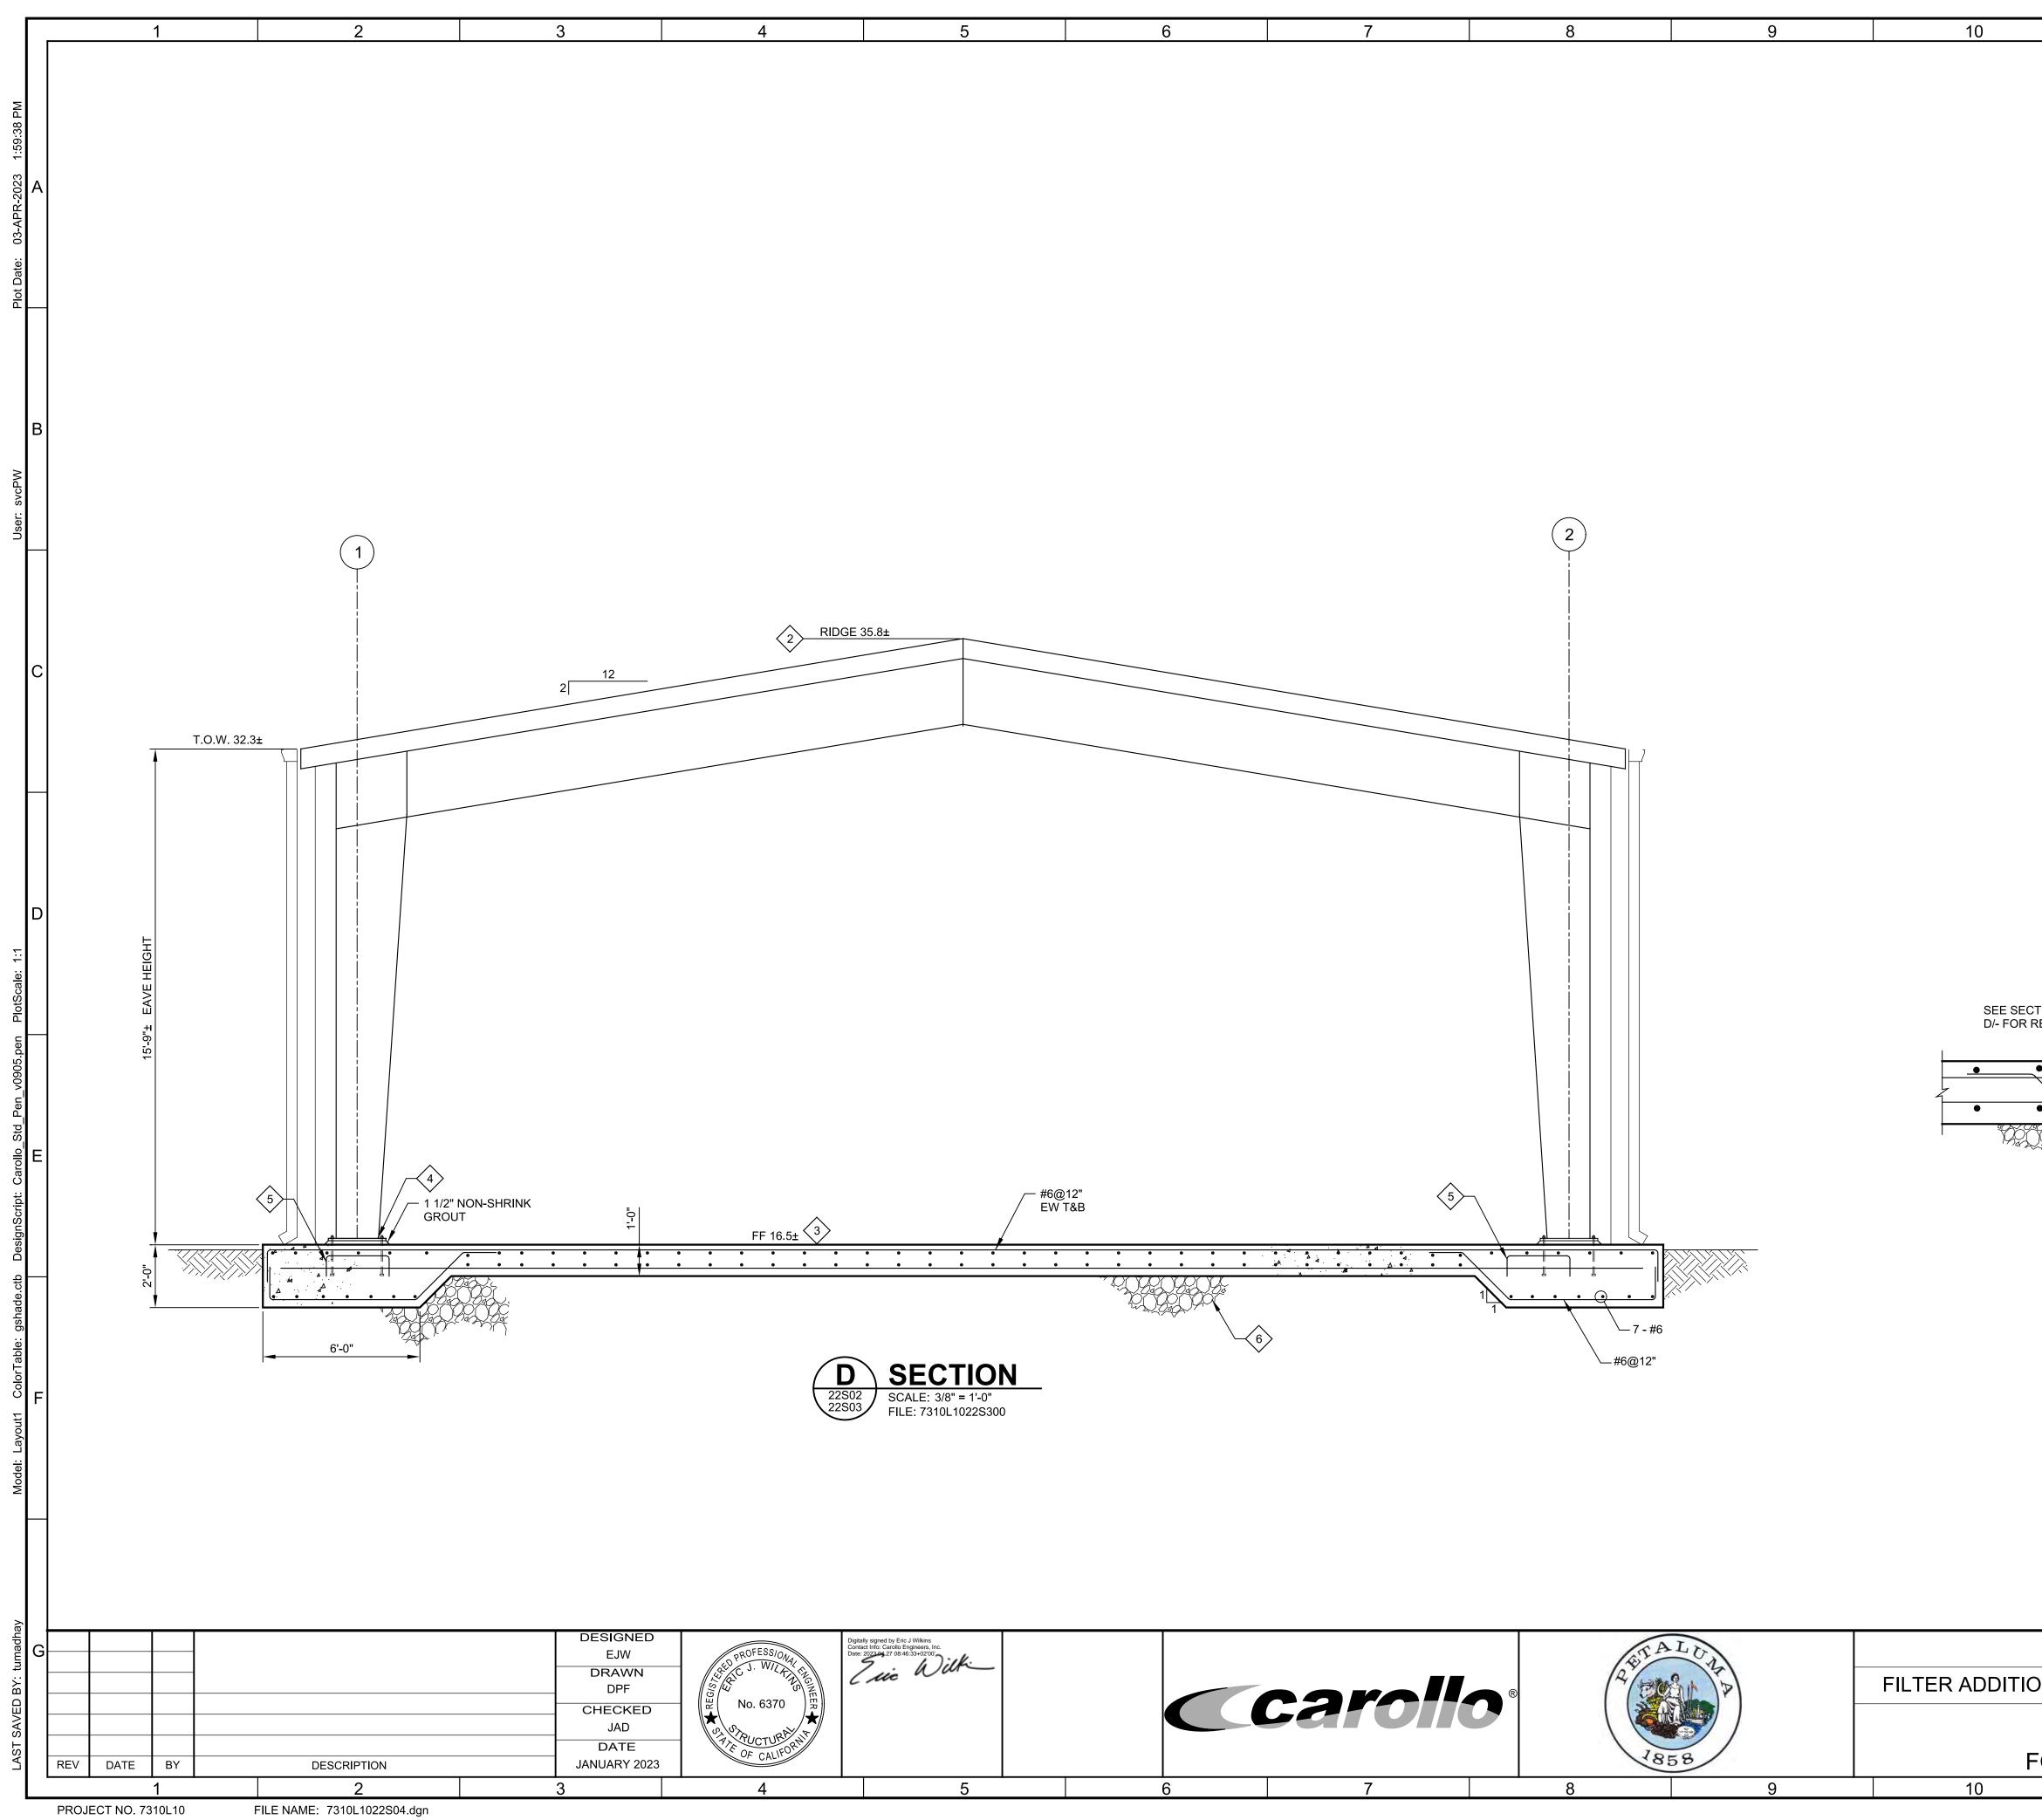
3. REFER TO DRAWING 22A01 FOR DOOR, HARDWARE, AND ROOM FINISH SCHEDULES.

KEY NOTES:



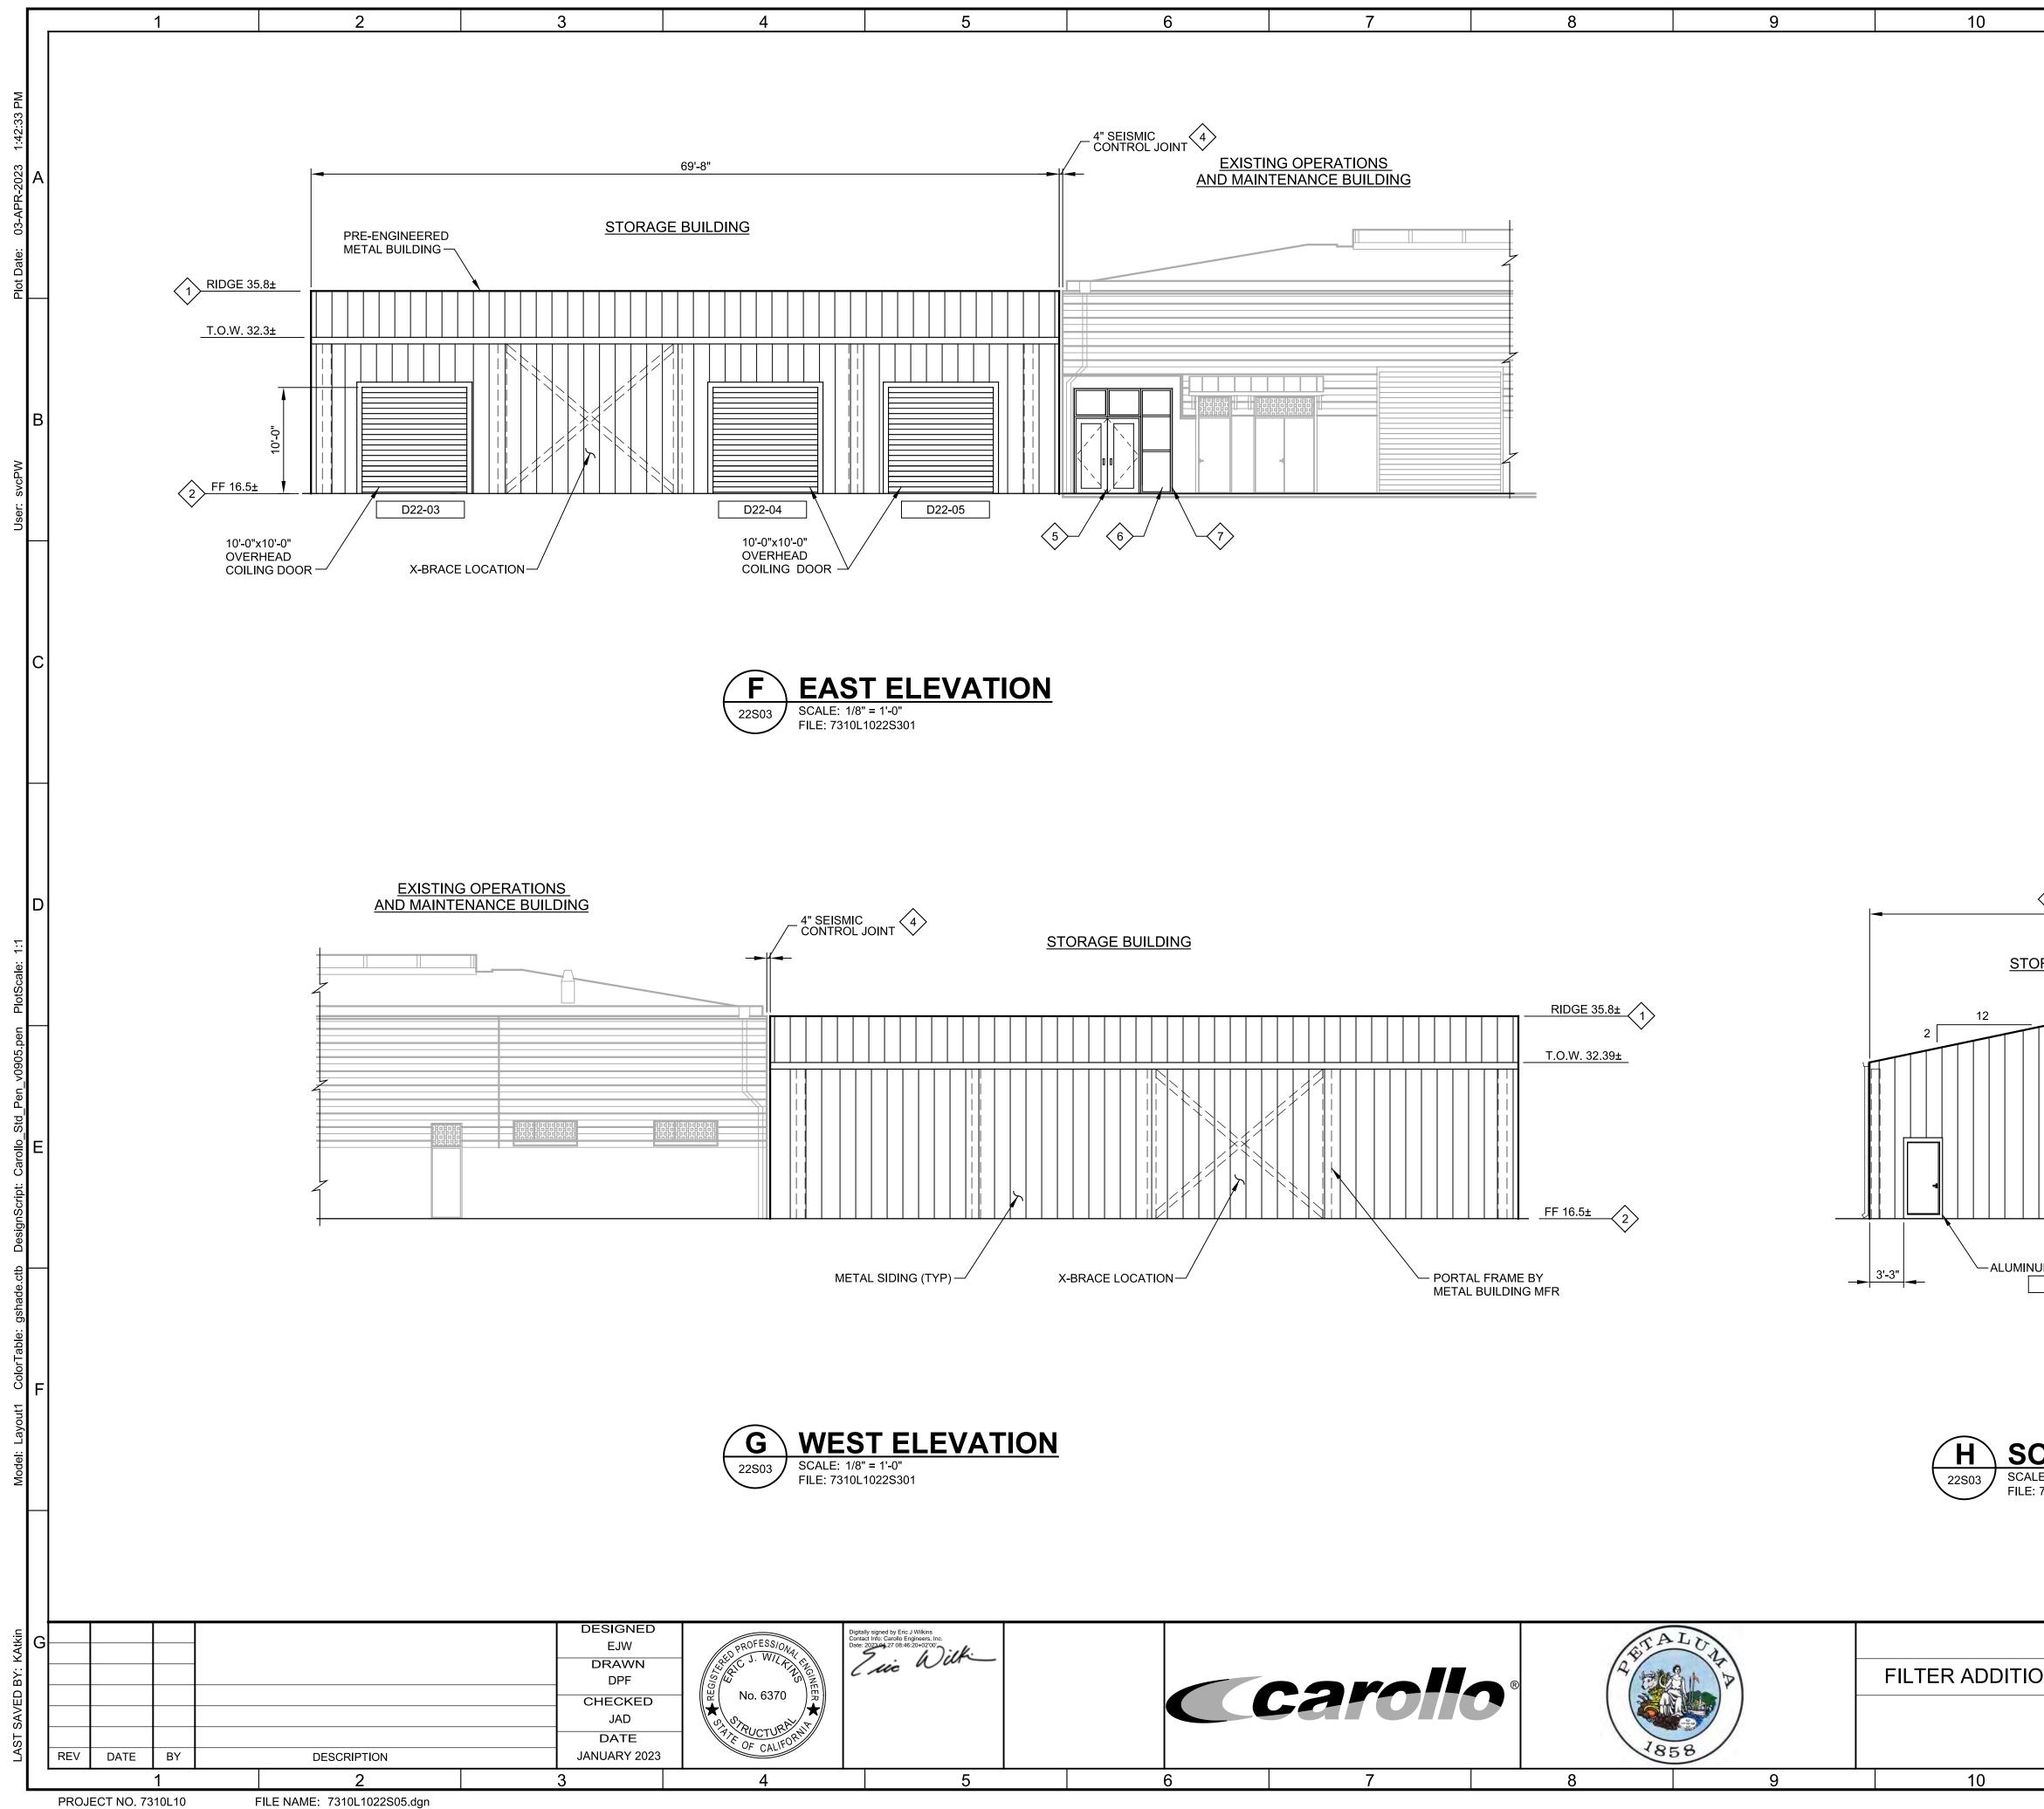
- PRE-ENGINEERED METAL BUILDING. SEE NOTE 5/22S02 AND SPECIFICATION SECTION 13122 FOR DESIGN CRITERIA.
- $\langle 2 \rangle$ MATCH EXISTING OPERATIONS AND MAINTENANCE BUILDING WIDTH.
- 4" SEISMIC CONTROL JOINT TO BE PROVIDED BY METAL BUILDING MANUFACTURER FOR A WATER AND WEATHERTIGHT SEAL.

CITY OF PETALUMAVERIFY SCALESJOB NO. 7310L.10GION AND MISC. IMPROVEMENTS PROJECTBAR IS ONE INCH ON ORIGINAL DRAWINGDRAWING NO.DRAWING NO.STRUCTURAL01"22S03STORAGE BUILDING ROOF FRAMING PLANIF NOT ONE INCH ON THIS SHEET, ADJUST SCALES ACCORDINGLYSHEET NO.111213						
ION AND MISC. IMPROVEMENTS PROJECT ORIGINAL DRAWING DRAWING NO. STRUCTURAL 0 22S03 STORAGE BUILDING IF NOT ONE INCH ON SHEET NO. ROOF FRAMING PLAN 63 OF	CITY OF PETALUMA	VERIFY SCALES		G		
STRUCTURAL IF NOT ONE INCH ON THIS SHEET, ADJUST SCALES ACCORDINGLY SHEET NO. 63 OF 130	ION AND MISC. IMPROVER					
ROOF FRAMING PLAN 63 OF 130	STRUCTURAL	0 1"	22803			
		THIS SHEET, ADJUST				
					I I	
	11	12	13			



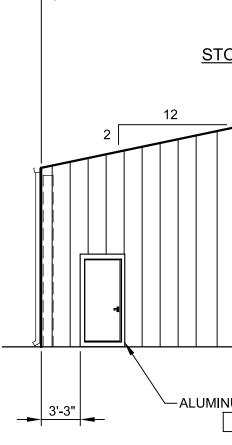
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11	12	13	7
	GENERAL NOTES: 1. SEE SHEETS G10C & G110	C FOR GENERAL STRUCTURAL NOTES.	
	2. DIMENSIONS SHOWN ARE TITLED "ELLIS CREEK WA CAROLLO ENGINEERS DA	E BASED OFF THE RECORD DRAWINGS TER RECYCLING FACILITY PROJECT" BY TED JULY 2005. CONTRACTOR SHALL SIONS PRIOR TO CONSTRUCTION.	
	DIMENSIONS AND REINFO WITH THE ACTUAL BUILDI	DATION DIMENSIONS AND IOWN ON THIS SHEET. FINAL PRCEMENT SHALL BE COORDINATED NG LOADS AS DETERMINED FROM THE RED METAL BUILDING SUBMITTAL.	A
	KEY NOTES:		
	SPECIFICATION SECTION	BUILDING. SEE NOTE 5/22S02 AND 13122 FOR DESIGN CRITERIA.	
	ALIGN WITH EXISTING OPI BUILDING TOP OF WALL E	ERATIONS AND MAINTENANCE LEVATION.	
	3 ALIGN WITH EXISTING OPI BUILDING FINISH FLOOR E	ERATIONS AND MAINTENANCE ELEVATION.	
	AND INSTALLED BY CONT SECTION 13122 FOR ADDI	RAGE TO BE DESIGNED, FURNISHED RACTOR. SEE SPECIFICATION TIONAL INFORMATION. CONTRACTOR S NUTS AS REQUIRED BY METAL R.	В
		T AS REQUIRED BY ANCHORAGE CEMENT SHALL BE DESIGNED AND DR.	
	6 12" AGGREGATE BASE CO	URSE WRAPPED IN WOVEN PECIFICATION SECTIONS 02050 AND	
			с
			D
ECTION TYP		NG TIONS & ENANCE BLDG	
• •			
			E
	¥		
4 - #6/ #6@12"			
2'-0"			
(E) SCALE: 3/4 22S02 SCALE: 3/4 FILE: 7310L			F
CITY OF PETALUMA		VERIFY SCALES JOB NO. 7310L.10	G
TON AND MISC. IMPROVEM	IENTS PROJECT	BAR IS ONE INCH ON ORIGINAL DRAWING DRAWING NO. 0 22S04	
STORAGE BUILDING		IF NOT ONE INCH ON SHEET NO. THIS SHEET, ADJUST	
FOUNDATION SECTION	NS 12	SCALES ACCORDINGLY 64 OF 130	┘┃



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		RAL NOTES:		FOR GENERAL	. STRUCTU	IRAL NOTES.	
	2. DII TIT BY SH	MENSIONS SH FLED "ELLIS CI Y CAROLLO EN IALL FIELD VE	IOWN ARE REEK WAT IGINEERS I RIFY ALL D	BASED OFF TH ER RECYCLING DATED JULY 20 DIMENSIONS PF	E RECORE FACILITY 05. CONTR	DRAWINGS PROJECT"	
	3. RE	ONSTRUCTION FER TO DRAV	VING 22A0 ²	1 FOR DOOR, H	ARDWARE	, AND ROOM	A
	<u>KEY NO</u>	DTES:					
		IGN WITH EXIS		RATIONS AND EVATION.	MAINTENA	NCE	
		IGN WITH EXIS		RATIONS AND	MAINTENA	NCE	
		IGN WITH EXIS		RATIONS AND	MAINTENA	NCE	
	V BL		FACTUREF	T TO BE PROVI R FOR A WATEF		ETAL	в
				ANCES AND ST			
		" ALUMINUM I) PANELS, REFE)8412.	ERENCE		
	→ _{BE}		RK ON STO	D VERIFY OPEN REFRONT ENT			
							С
342'-2"±							D
ORAGE BUILDING							
		RIDGE 35.8±	\wedge				
		T.O.W. 32.39±					
			^				E
		FF 16.5±	2				
NUM DOOR AND FRAME							\mid
							F
OUTH ELEVATION	l						
E: 7310L1022S301							
CITY OF PETALUMA			1	VERIFY SCA		JOB NO. 7310L.10	G
ON AND MISC. IMPROVEN	IENTS	PROJE	СТ	BAR IS ONE INC ORIGINAL DRAV		00000000000000000000000000000000000000	
STORAGE BUILDING	6			IF NOT ONE INC THIS SHEET, AD	H ON	SHEET NO.	-
ELEVATIONS		12		SCALES ACCORD		65 OF 130	
1	1	14			I J		I