

SPAR APPLICATION

09/08/2023

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SPAR-6.1	PHOTOMETRIC PLAN - ROOF	08 SEPTEMBER 2023	24 JUNE 2022
Grand total:	39		

PROJECT INFORMATION			
PROJECT ADDRESS:	2 PETALUMA BLVD NORTH PETALUMA, CALIFORNIA		
OCCUPANCY TYPE:	A-2 RESTAURANTS R-1 HOTEL GUESTROOMS S-2 PARKING		
APN:			
CONSTRUCTION TYPE:	IA		
NUMBER OF STORIES:	FIVE STORIES ABOVE GRADE, ONE ROOFTOP, ONE STORY BELOW GRADE		
BUILDING HEIGHT ABOVE GRADE:	55' 9" (TOP OF ROOF PAVER)		
SITE AREA:	14,256.54 SF		
FAR:	4.78		
PROJECT AREA:		Gross	Net
	Basement	13,100	
	Parking		9174
	Storage		1256
	MEP		1082
	Ground Floor	12,727	
	Restaurant		2308
	outdoor seating		901
	Kitchen		1832
	MEP		1142
	trash		176
	Hotel		1460
	boh		3213
	Level 2	12,117	
	Guest		6860
	Fitness		1283
	Balc		508
	Terrace		898
	Admin		1050
	Level 3	12,117	
	Guest		9323
	Balc		508
	Level 4	12,117	
	Guest		9323
	Balc		508
	Level 5	11,502	
	Guest		8700
	Balc		988
	Level 6	4,220	
	Event		1372
	Pantry		967
	Terrace		5514
Total Above Grade Gross (shafts not removed)		64,800	
Land area		14,256	
FAR		4.55	
Site coverage		100%	
Keys		93	
Building Height (max to top of event roof from ave grade)		67'-10"	



EKN Appellation Hotel

2 Petaluma Blvd South
Petaluma, California



Page Southernland Page, Inc.
414 Jackson Street, 4th Floor
San Francisco, CA 94111
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FAX 415.249.0132

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STRUCTURAL
BUEHLER
444 Flower St 3800
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90071
323 536 2362

LANDSCAPE
BRIGHTVIEW
8 Hughes
Ste. 150
Irvine, CA, 4900
949 238 4900

FF&E
DH-COMPANIES
7591 Coppermine Drive
Manassas, VA
20109
703 520 1885

MEP
INTERACE ENGINEERING
601 South Figueroa St
Suite 2750
Los Angeles, CA 90017
213 694 3408

CIVIL
N CONSULTENG
4 Park Plz
Irvine, CA
92614
949 396 1161

INTERIOR
SIXTEEN-FIFTY
7509 Girard Ave.
La Jolla, CA
92037
858 454 6909

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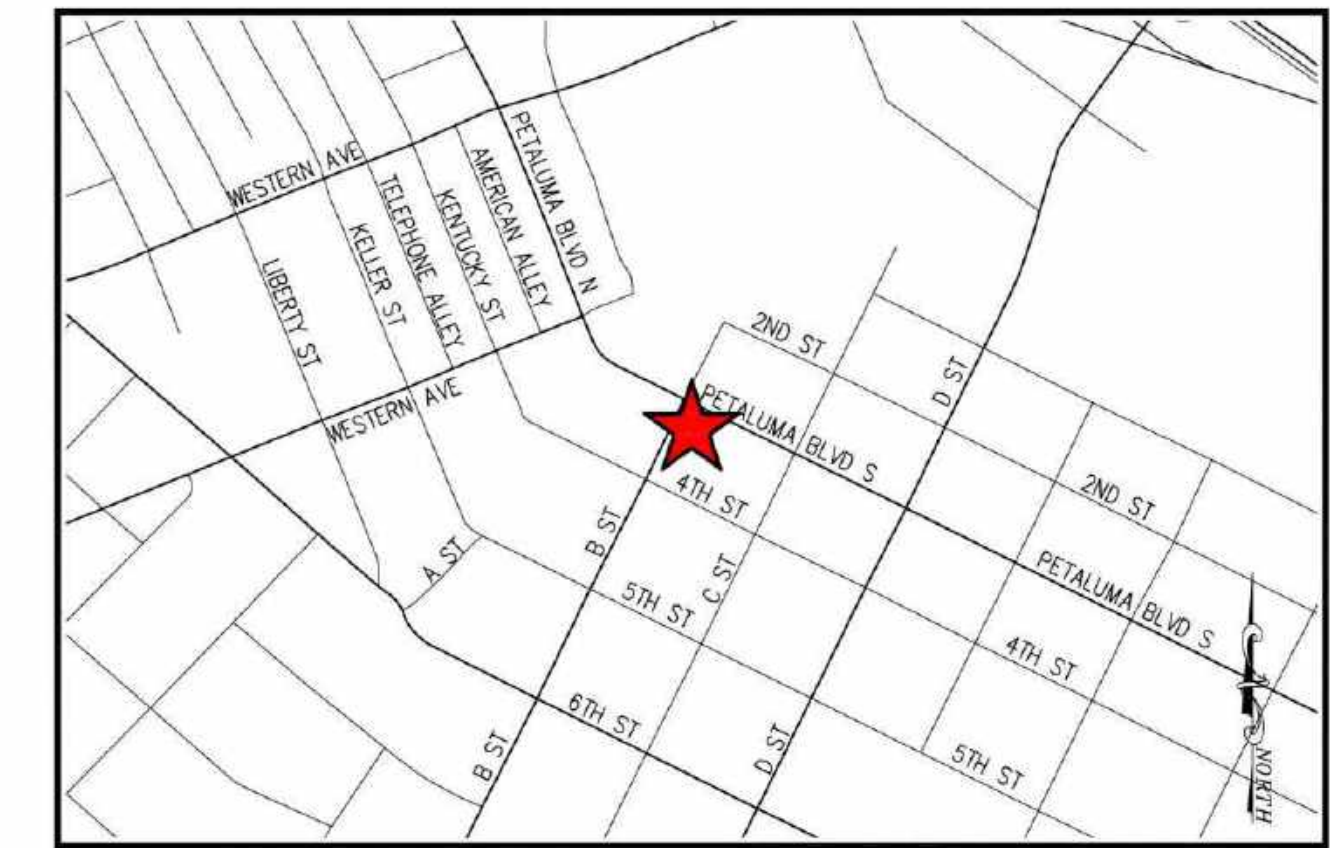
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MEP LANDSCAPE
INTERFACE ENGINEERING BRIGHTVIEW DESIGN GROUP
601 South Figueroa Street 1645 Grant Street
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323 536 2362 949 238 4900

STRUCTURE FF&E
BUEHLER ENGINEERING DH-COMPANIES
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Suite 1125 San Francisco, CA 94103
213 694 3408 Manassas, VA, 20109

INTERIORS CIVIL
SIXTEEN FIFTY N CONSULTING ENGINEERS
7509 Girard Ave 4 Park Plz
La Jolla, CA Irvine, CA
92037 92034
858 454 6909 949 369 1161



VICINITY MAP
SCALE: 1" = 500'

PROJECT TEAM
OWNER / DEVELOPER
EKN DEVELOPMENT GROUP
222 NEWPORT CENTER DRIVE, SUITE 11-262
NEWPORT BEACH, CA 92660
CONTACT: MIKE JOLLY
PHONE: 310.776.0821

ARCHITECT
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CONTACT: SAM GELFAND
PHONE: 415.249.0130

CIVIL ENGINEER
N CONSULTING ENGINEERS, INC.
4 PARK PLAZA, SUITE 1750
IRVINE, CA 92614
CONTACT: DEREK KARIMOTO P.E., QSD
PHONE: 714.514.8858

LANDSCAPE ARCHITECT
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BUEHLER
444 FLOWER ST 3000
LOS ANGELES, CA 90017
CONTACT:
PHONE: 323.536.2362

MEP
INTERFACE ENGINEERING, INC.
601 SOUTH FIGUEROA STREET, SUITE 2750
LOS ANGELES, CA 90017
CONTACT: EUGENE DE SOUZA
PHONE: 213.694.3408

PROJECT DATA	
APN(S)	008-063-008, 008-063-009, 008-063-011
ADDRESS	2 PETALUMA BLVD S, PETALUMA, CA 94962
ZONING DESIGNATION	MIXED USE 2 (MU2)
OVERLAY DISTRICT(S)	PARKING ASSESSMENT DISTRICT, THEATER DISTRICT, HISTORIC COCKBURN DISTRICT
EXISTING LAND USE	ROUGH GRADED SITE - VACANT LOT
AREA	14,296 SF 0.327 ACRES


DEMOLITION NOTES	
[A] ADJUST TO GRADE.	EA
[M] MOVE OR RELOCATE.	EA
[P] PROTECT IN PLACE.	EA
[R] REMOVE AND DISPOSE OF OFF-SITE.	EA

CONSTRUCTION NOTES	
1. CONSTRUCT CURB, GUTTER AND SIDEWALK PER CITY OF PETALUMA STANDARD DETAILS 202 AND 203. SEE LANDSCAPE PLAN FOR PATTERN AND COLOR.	LF
2. CONSTRUCT DRIVEWAY PER CITY OF PETALUMA STANDARD DETAIL 203.	EA
3. CONSTRUCT CURB RAMP "CASE A" PER CALTRANS STANDARD PLAN A88A.	EA
4. CONSTRUCT ACCESSIBLE DROP-OFF PER CALTRANS STANDARD PLAN A90B.	EA
5. STRIPE IN-KIND.	LF
6. PAINT 4" WIDE WHITE PAINTED STRIPE (TWO COATS) 45° @ 3" O.C., TYP. STENCIL "DROP-OFF ZONE" IN 12" HIGH LETTERING.	LF
7. INSTALL RELOCATED STREET LIGHT PER CITY OF PETALUMA STANDARD DETAIL 611.	EA
8. INSTALL STORM WATER DETENTION SYSTEM.	EA
9. CONSTRUCT TREE WELL PER LANDSCAPE PLANS.	EA
10. INSTALL HANDRAIL.	LF
11. INSTALL SIGN POST AND SIGNAGE.	EA

LEGEND	
---	PROPERTY LINE
---	EXCAVATION LIMITS
---	SAWCUT LINE
---	EXISTING GAS
---	EXISTING STORM DRAIN
---	EXISTING SANITARY SEWER
---	EXISTING WATER
---	PEDESTRIAN EASEMENT

EARTHWORK:	
CUT:	7138 C.Y.
FILL:	0 C.Y.
IMPORT:	0 C.Y.
EXPORT:	7138 C.Y.

EARTH WORK QUANTITIES ARE RAW ESTIMATES ONLY. NO MATERIAL SHRINKAGE OR EXPANSION FACTOR IS INCLUDED IN THIS ESTIMATE AND DOES NOT REFLECT SUBSIDENCE, OR ANY MATERIAL GENERATED BY UTILITY TRENCHING AND BUILDING FOOTINGS.

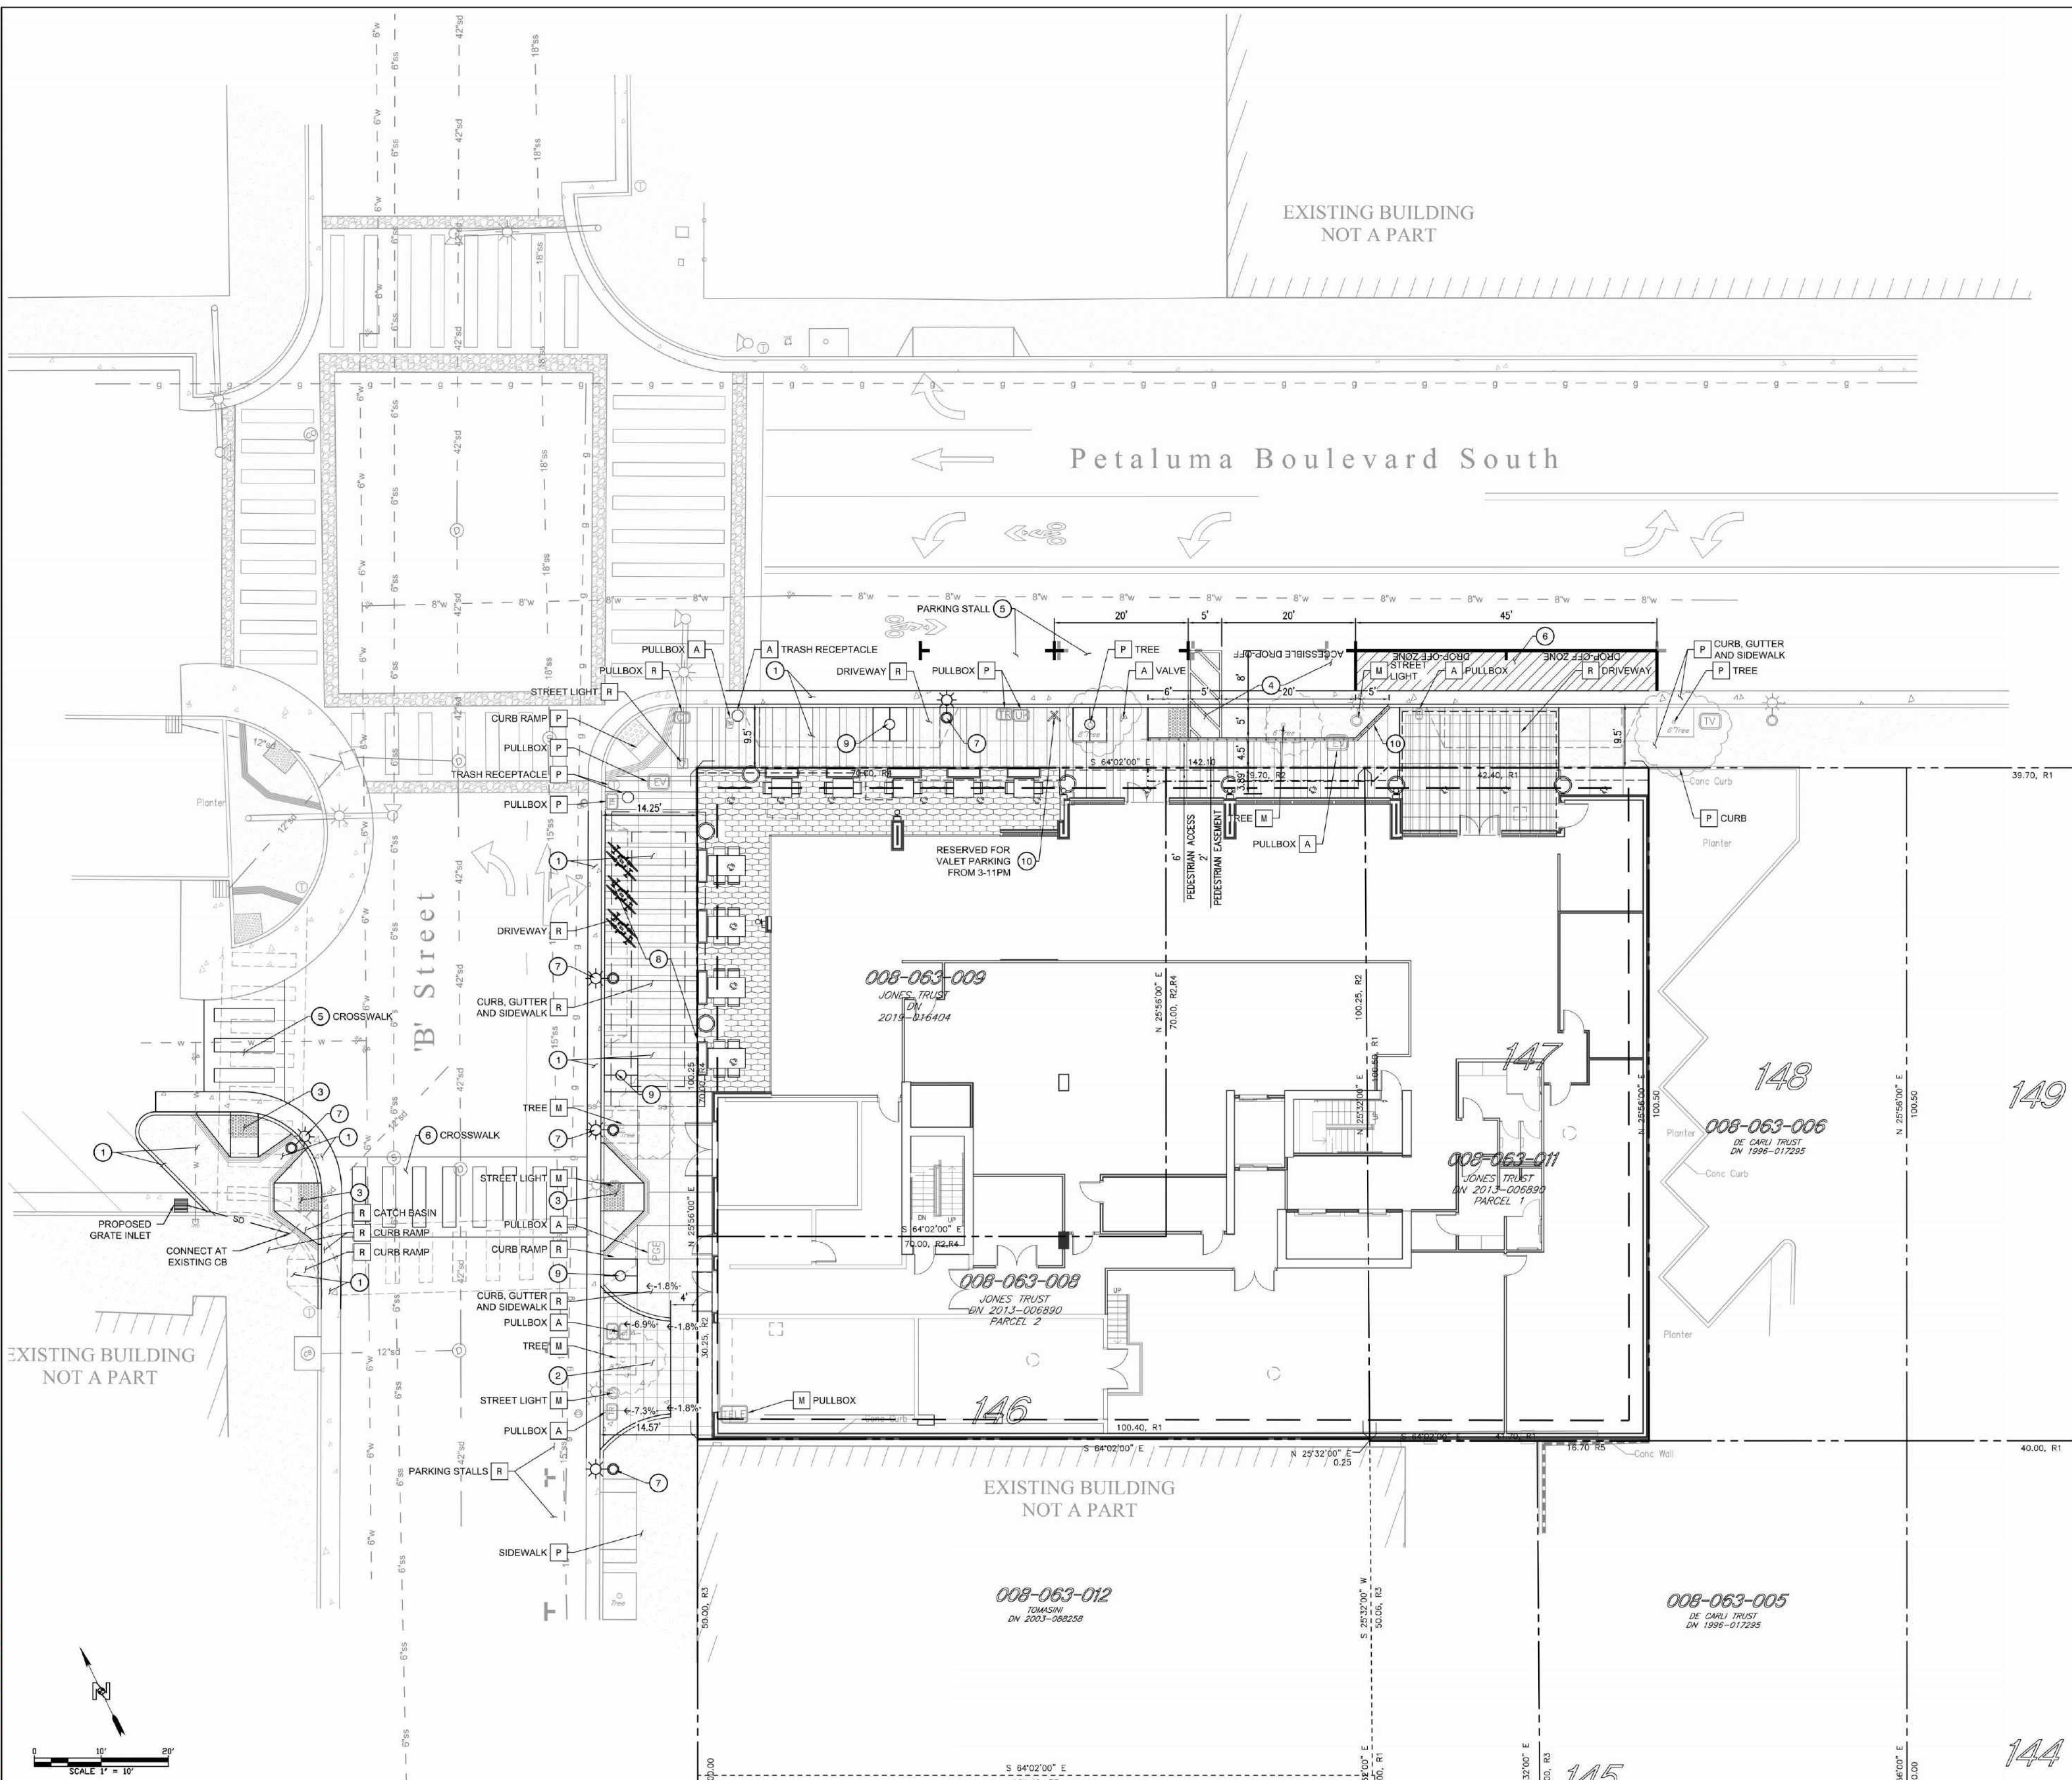

NOT FOR CONSTRUCTION

EKN Petaluma LLC
EKN APPELLATION HOTEL
2 Petaluma Blvd South
Petaluma, California

REVISION HISTORY

NO.	DATE	REVISION DESCRIPTION	DATE

INTERIM REVIEW
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CIVIL - CONCEPTUAL SITE PLAN

DRAWN BY	CHECKED BY
Author	Checker
PROJECT NUMBER 621010	PROJECT ABBREVIATION PH
ORIGINAL ISSUE SPAR APPLICATION	DATE 08 SEPTEMBER 2023

SPAR-1.1
SHEET NUMBER

Autodesk Docs://621010-Petaluma Hotel/621010-A-Petaluma-R23-CENTRAL.rvt
DATE PLOTTED: 9/8/2023 5:11:21 PM

DIGALERT
DIAL TOLL FREE
811
AT LEAST TWO DAYS BEFORE YOU DIG
UNDERGROUND SERVICE ALERT OF SOUTHERN CALIFORNIA

NOTICE TO CONTRACTOR:
1. THE LOCATIONS OF EXISTING UTILITY INSTALLATIONS AS SHOWN ON THIS PLAN ARE APPROXIMATE. THERE MAY BE OTHER UNDERGROUND UTILITY INSTALLATIONS WITHIN THE PROJECT AREA THAT ARE NOT SHOWN. N CONSULTING ASSUMES NO RESPONSIBILITY FOR DAMAGES, LIABILITY OR COSTS RESULTING FROM CHANGES OR ALTERATIONS MADE TO THIS PLAN WITHOUT THE EXPRESSED WRITTEN CONSENT OF N CONSULTING.

BENCH MARK
FOUND 3" BRASS DISK SET IN THE TOP OF A SANDSTONE WALL AT THE FOURTH STREET POST OFFICE, 0.3' ABOVE THE GROUND, STAMPED "12 246.51 103 1905". ELEVATION=15.20', NAVD83 DATUM (PER NGS DATASHEET). A CONVERSION FACTOR OF -2.795 SHOULD BE USED TO CONVERT NAVD83 ELEVATIONS TO NGVD29 ELEVATION.

BASIS OF BEARINGS
192 MAPS 26, SCR.

N CONSULTING ENGINEERS
4 Park Plaza, Suite 1750
Irvine, CA 92614
PHONE: 949.396.1161
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DEREK H. KARIMOTO

Derek H. Karimoto
Professional Engineer
No. 4226
Feb 2019
CIVIL
STATE OF CALIFORNIA

PROJECT ADDRESS: 2 PETALUMA BLVD
PETALUMA, CA 94952

PROJECT NO.: 21-402

DATE: 8/28/2022

DATE: 2022-08-26

DATE: 2022-08-26

PROJECT NAME: EKN PETALUMA HOTEL

TITLE: CONCEPTUAL SITE PLAN

SCALE AT D: 1" = 10'

CHECKED: D.H.K.


DATE: 2022-08-26

DATE: 2022-08-26


PROJECT NO.: 21-402

SHEET: SPAR.C1

DATE: 08 SEPTEMBER 2023

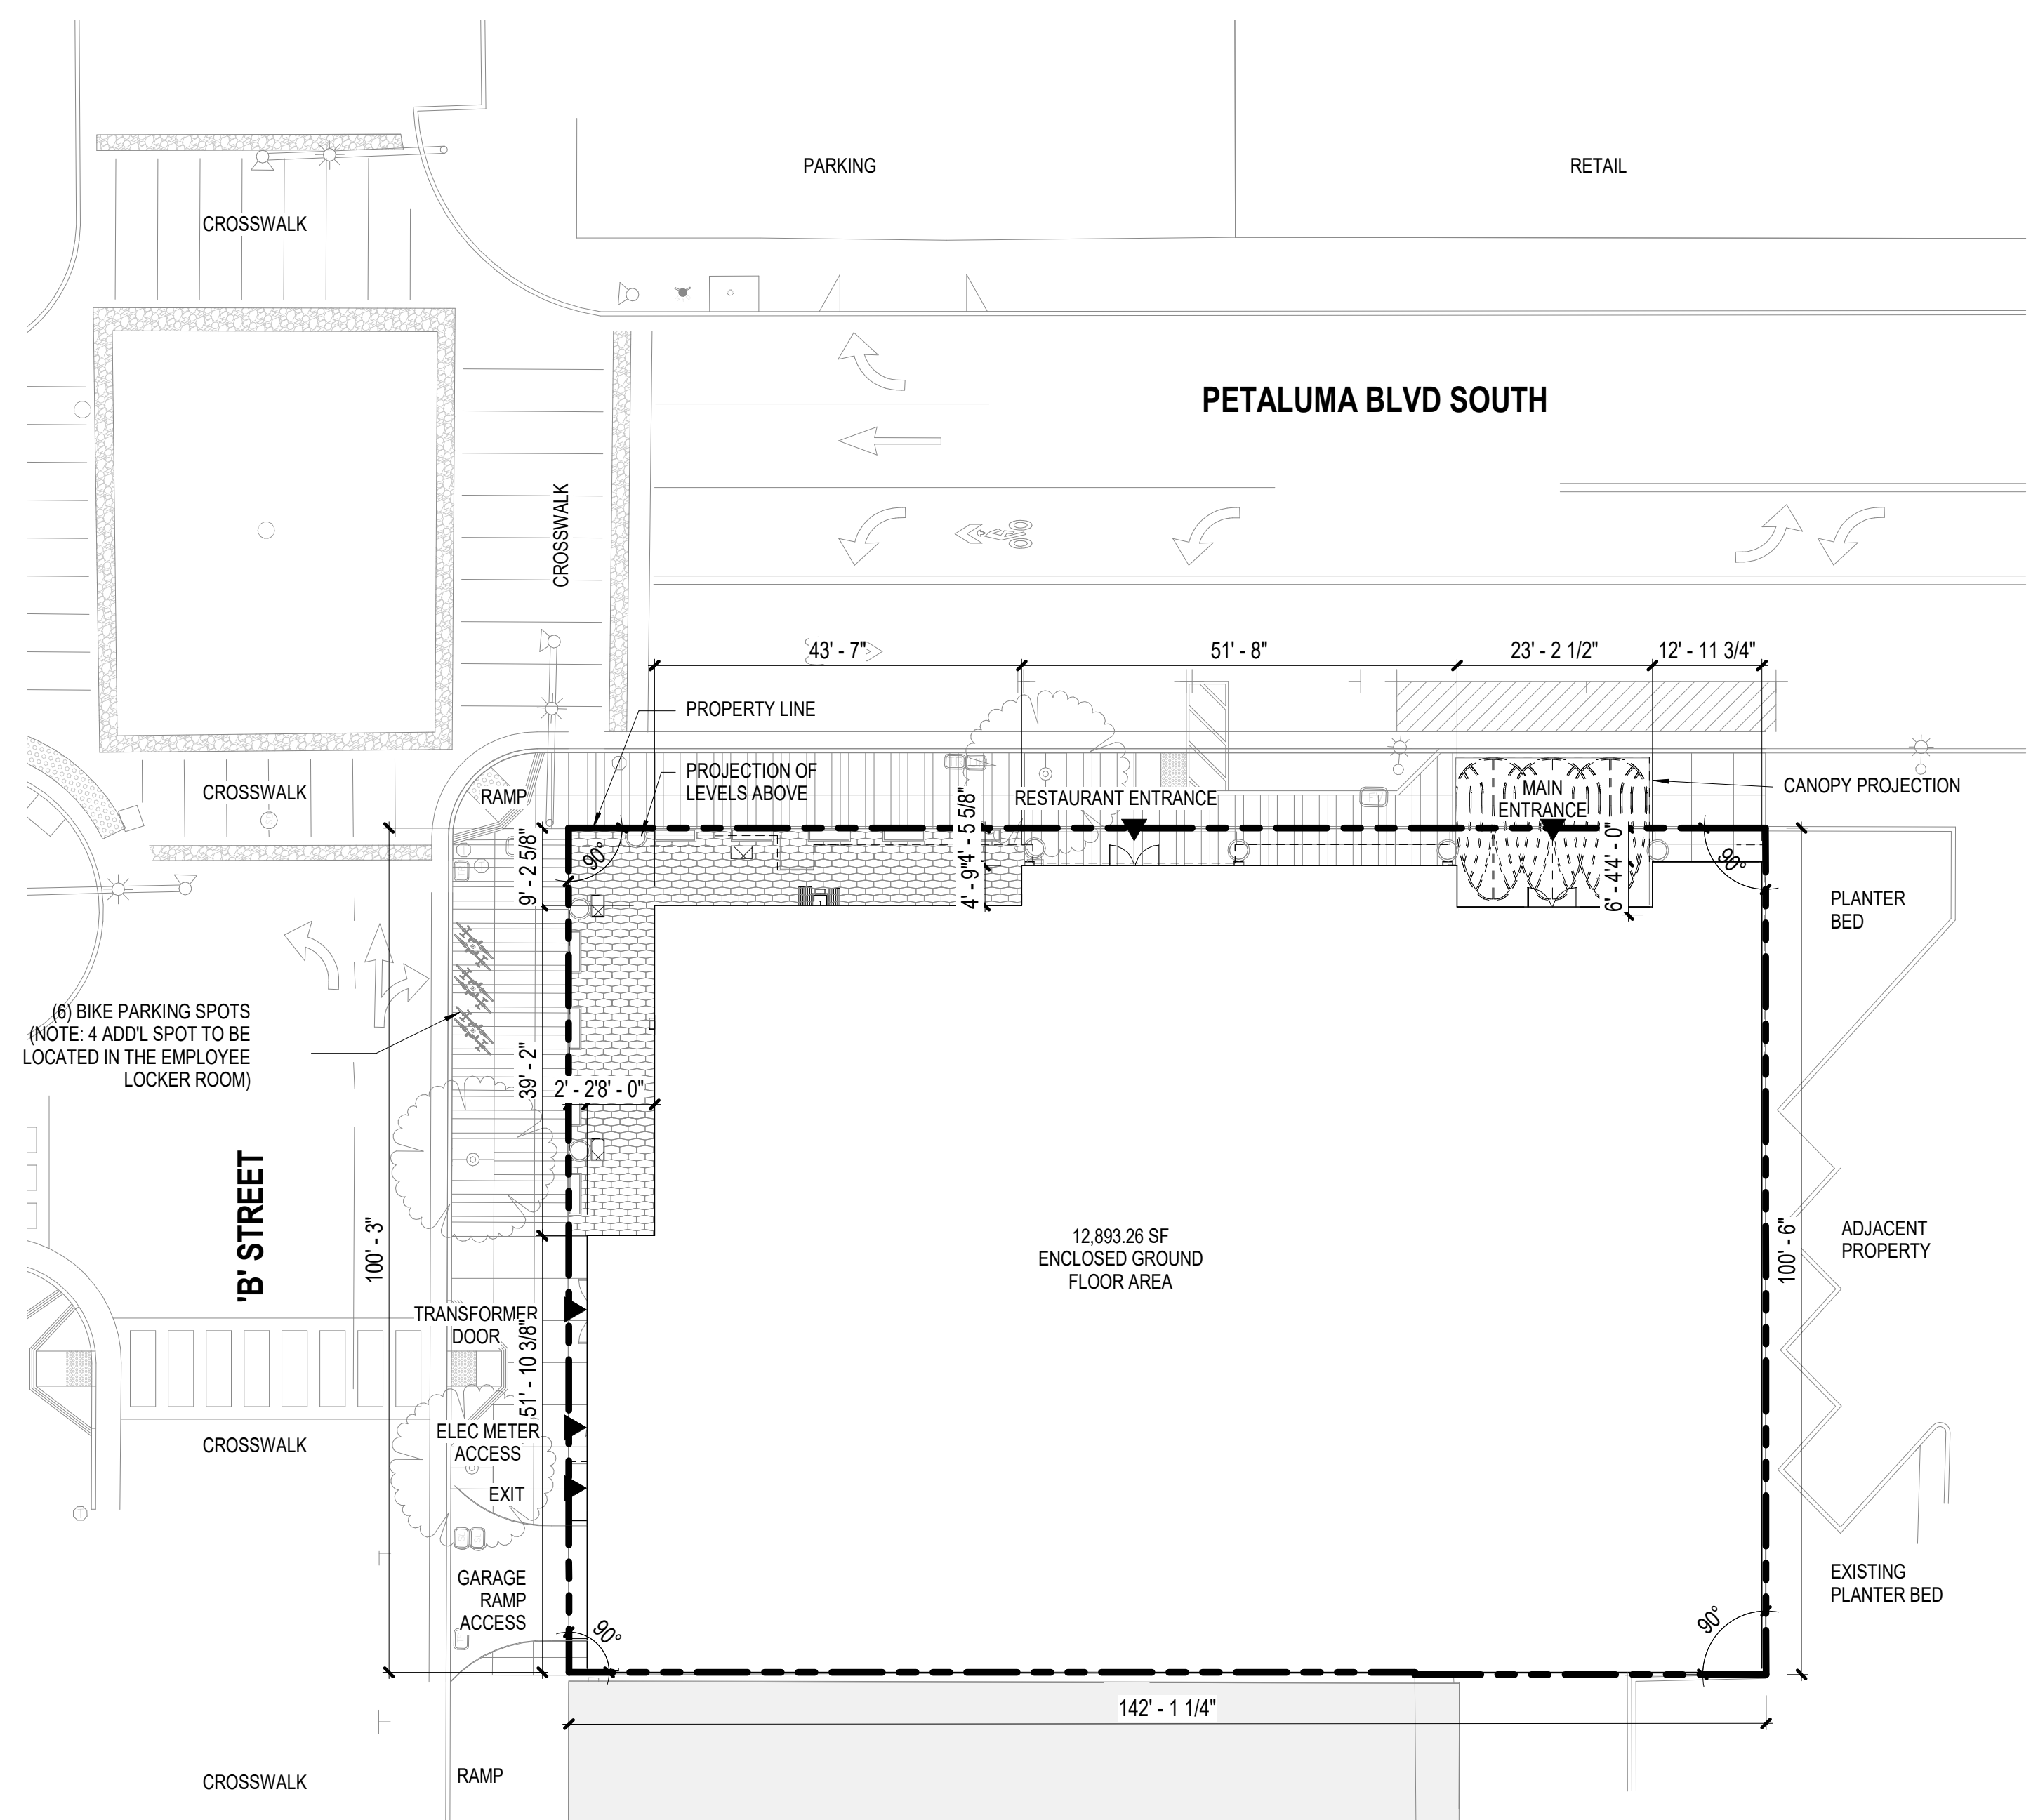

2 ARCHITECTURAL - SITE
SCALE: 1/16" = 1'-0"

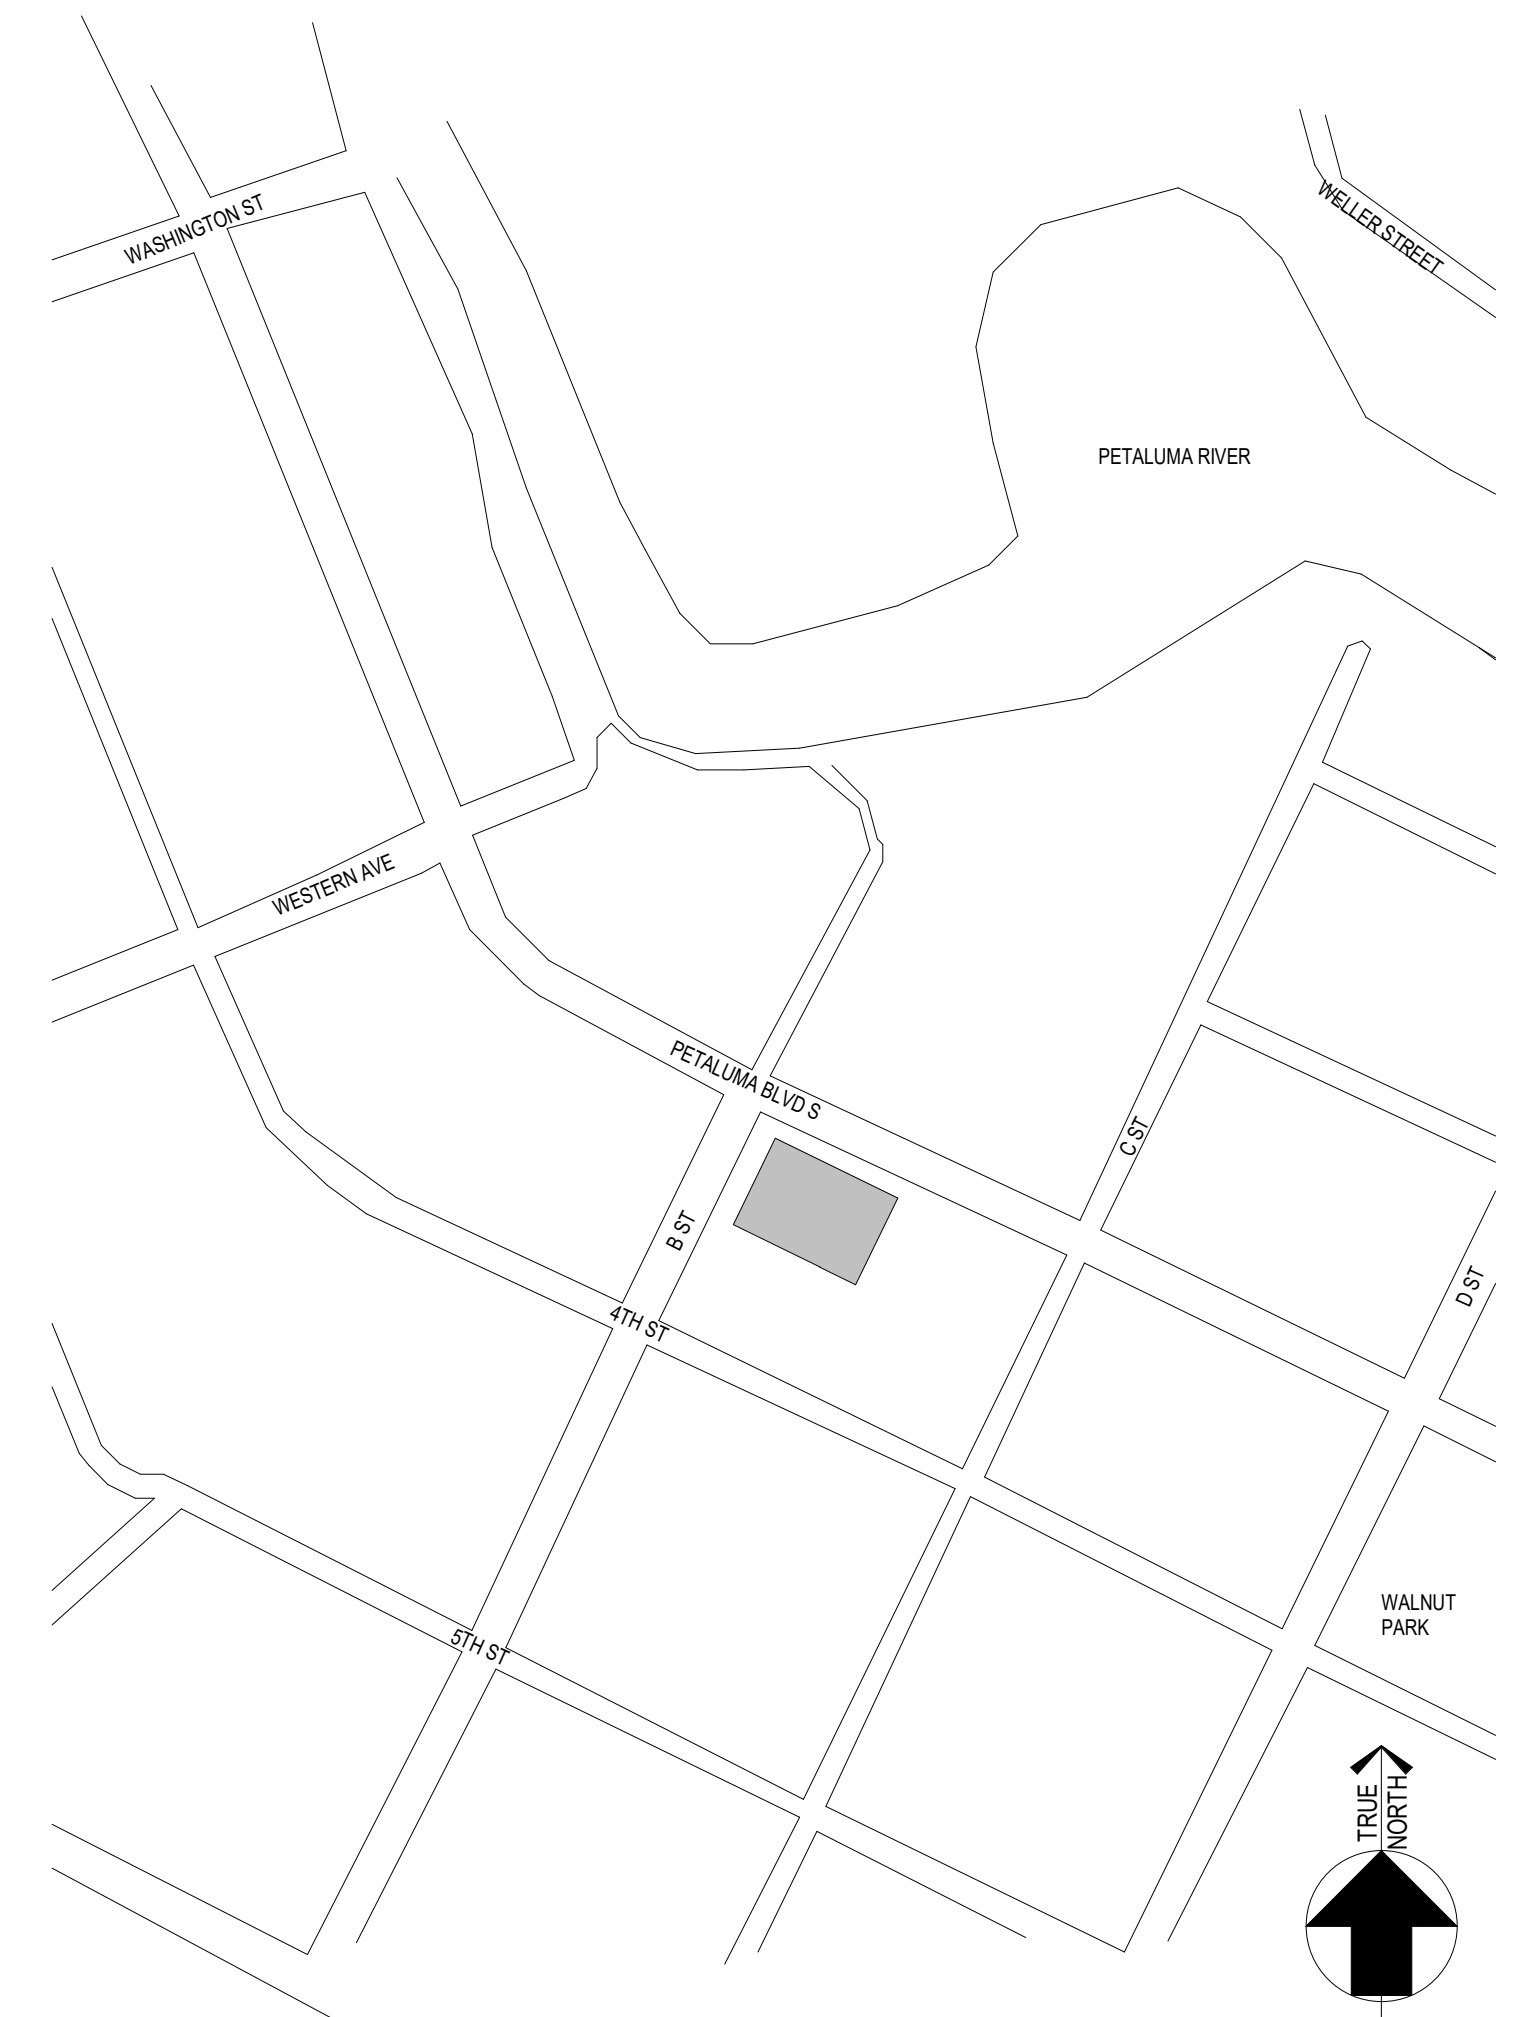

5 VICINITY MAP
SCALE: 1" = 200'-0"



3 SITE - PHOTOS
SCALE: 1" = 160'-0"

PROGRAM OUTSIDE OF PARKING DISTRICT:




PARKING TABULATIONS:
Parking requirements per Table 11.1 for program outside of Parking District
(10 spaces required for program inside of district)

Table with 2 columns: Level, Spaces. Levels 1-5 with their respective parking requirements.

PARKING ASSESSMENT BOUNDARY CALCULATION



Technical specifications for PARKPLUS DP003 DOUBLE STACKER, including components, dimensions, and installation details.

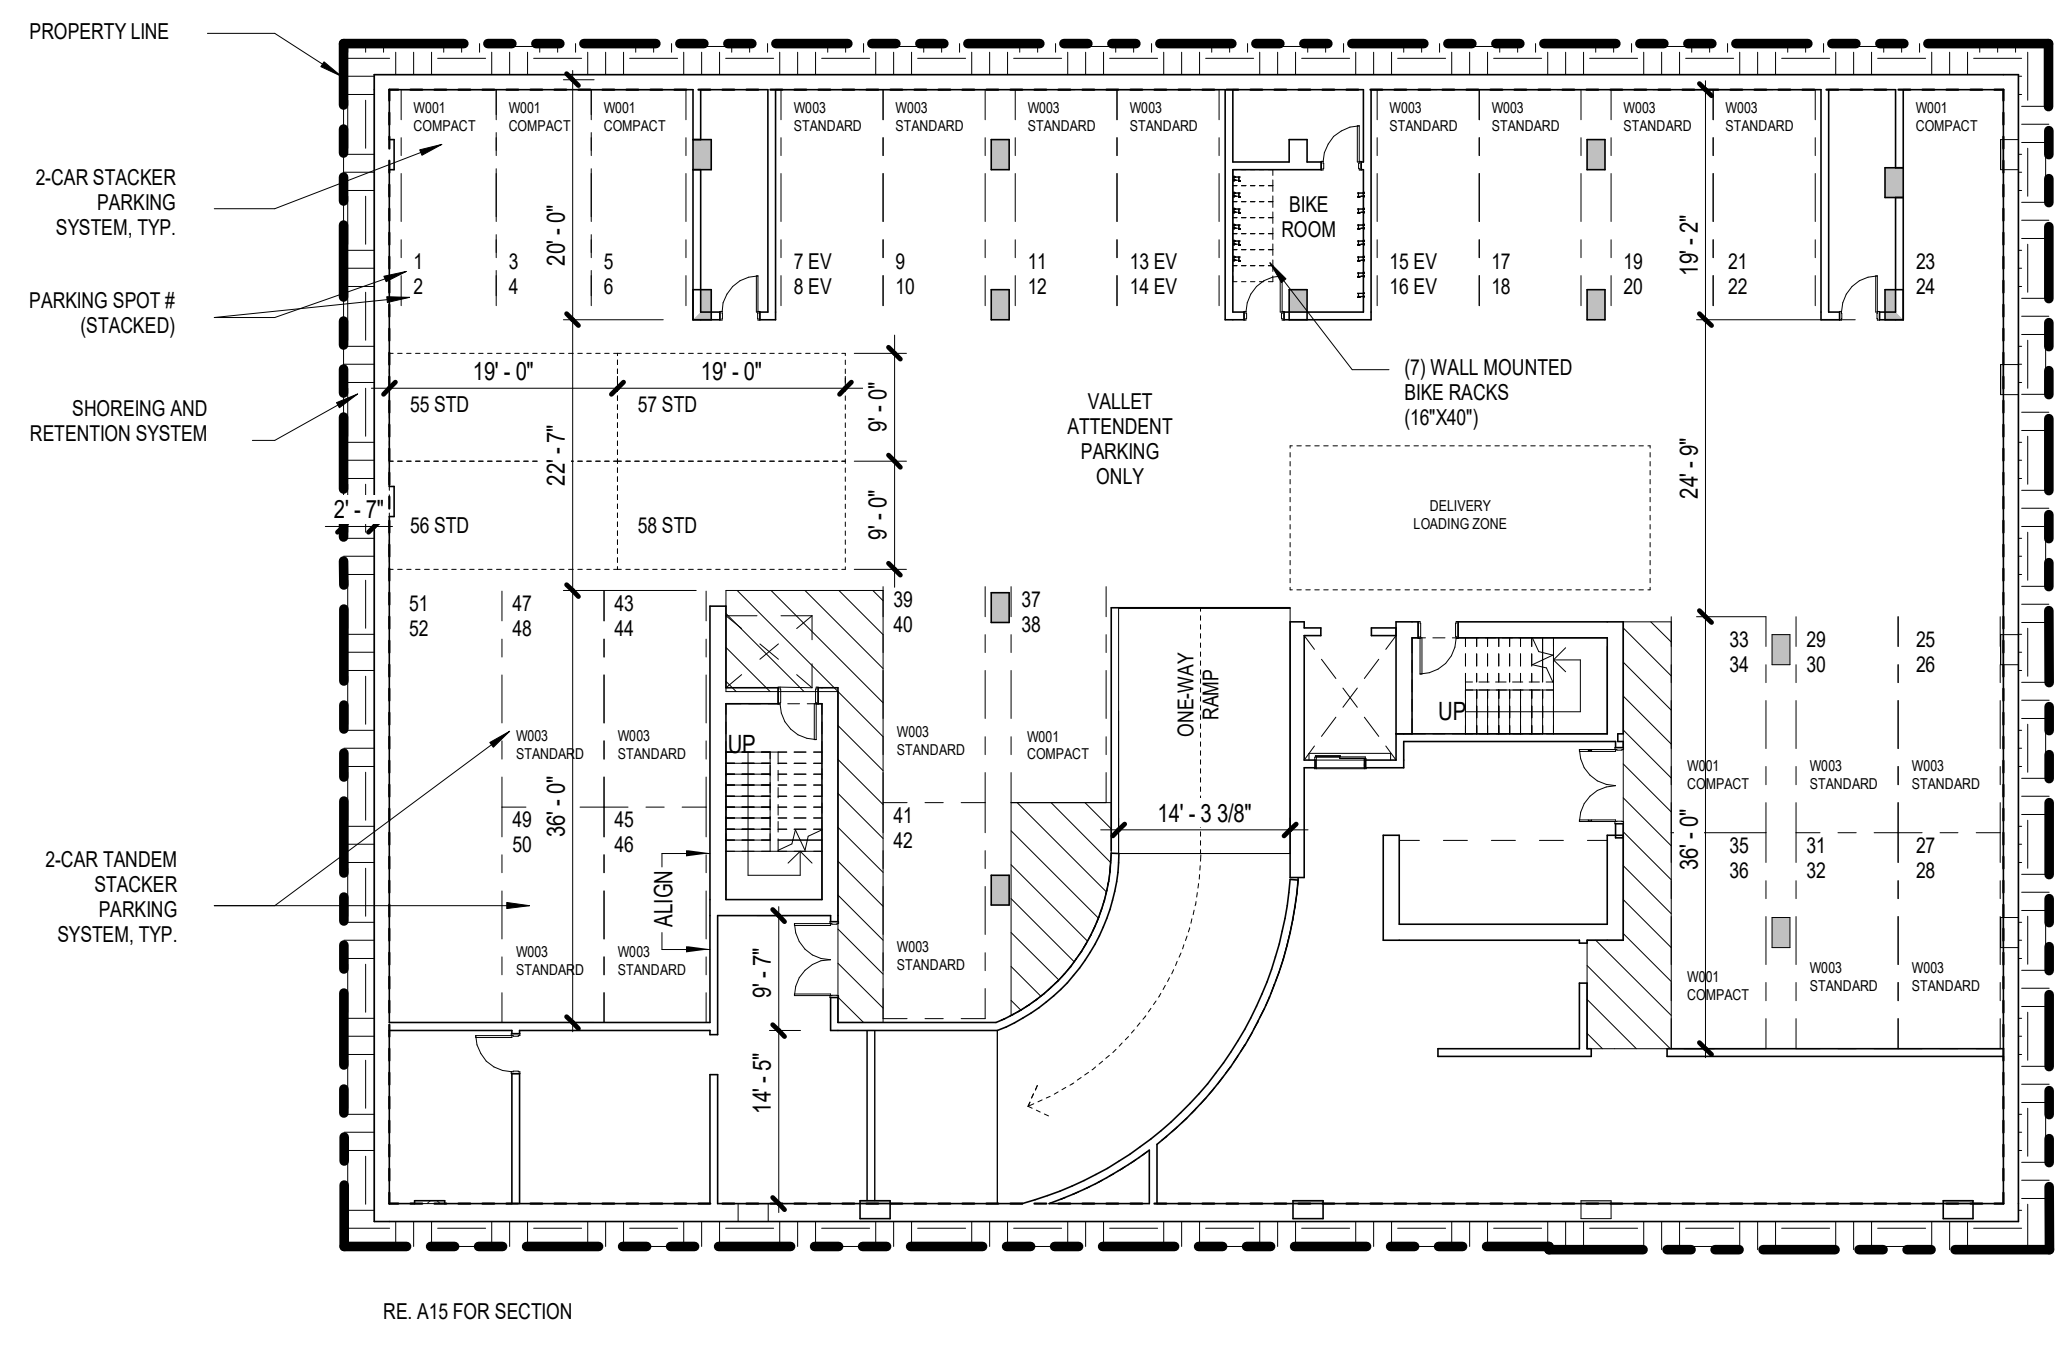

1 PARKING SUMMARY
SCALE: 1/16" = 1'-0"

EKN Petaluma LLC
EKN APPELLATION HOTEL
2 Petaluma Blvd South
Petaluma, California

REVISION HISTORY table with columns for REVISION, DESCRIPTION, and DATE.

ARCHITECTURAL - SITE PLAN table with columns for DRAWN BY, CHECKED BY, PROJECT NUMBER, and DATE.

NOTES

1. ALL PLANT MATERIALS TO BE IN ACCORDANCE WITH THE AMERICAN STANDARD FOR NURSERY STOCK ANSI Z60.1.
2. ALL PLANT SIZES NOTED ON THE PLANT SCHEDULE ARE MINIMUM SPECIFICATIONS, AND ARE TO BE INCREASED IF NECESSARY TO CONFORM TO PLANT SIZE AND SPECIFICATIONS.
3. ALL LANDSCAPED AREAS TO RECEIVE ORGANIC SOIL PREPARATION WITH COMPOST AT THE RATE OF 4 CU. YD. / 1,000 SF AND INCORPORATED TO A DEPTH OF SIX INCHES. SOIL AMENDMENTS TO BE INCORPORATED ACCORDING TO RECOMMENDATIONS OF THE REQUIRED SOILS REPORT AND AS APPROPRIATE FOR THE SPECIFIC PLANTS SPECIFIED.
4. A MINIMUM THREE-INCH LAYER OF MULCH TO BE APPLIED ON ALL EXPOSED SOIL SURFACES OF PLANTING AREAS EXCEPT IN TURF AREAS, CREEPING OR ROOTING GROUNDCOVERS, OR AS NOTED ON PLANS.
5. ALL LANDSCAPED AREAS AND PLANT MATERIALS TO BE WATERED BY AN AUTOMATIC UNDERGROUND IRRIGATION SYSTEM. IRRIGATION SYSTEM DESIGN, INSTALLATION, OPERATION AND MAINTENANCE TO CONFORM TO REQUIREMENTS FOUND IN THE MUNICIPAL CODE CHAPTER 15.17 - WATER CONSERVATION REGULATIONS.
6. ALL LANDSCAPING SHALL BE MAINTAINED IN HEALTHY GROWING CONDITION BY THE PERMIT HOLDER FOR A PERIOD OF 90 DAYS AFTER RECEIVING AN OCCUPANCY PERMIT. SUCH MAINTENANCE SHALL INCLUDE, WHERE APPROPRIATE: PRUNING, MOWING, WEEDING, CLEANING OF DEBRIS AND TRASH, FERTILIZING AND REGULAR WATERING. WHENEVER NECESSARY, PLANTING SHALL BE REPLACED WITH OTHER PLANT MATERIALS TO ENSURE CONTINUED COMPLIANCE WITH APPLICABLE LANDSCAPING REQUIREMENTS. REQUIRED IRRIGATION SYSTEMS SHALL BE FULLY MAINTAINED IN SOUND OPERATING CONDITION WITH HEADS PERIODICALLY CLEANED AND REPLACED WHEN MISSING TO ENSURE CONTINUED REGULAR WATERING OF LANDSCAPE AREAS, AND HEALTH AND VITALITY OF LANDSCAPE MATERIALS.
7. HERBICIDES/PESTICIDES SHALL NOT BE APPLIED IN AREAS USED BY PEDESTRIANS/BICYCLISTS WITHIN THE PROJECT WITHOUT FIRST PROVIDING APPROPRIATE SIGNS WARNING OF THE USE OF CHEMICALS. THE PROJECT SHALL UTILIZE BEST MANAGEMENT PRACTICES (BMP'S) REGARDING PESTICIDE/HERBICIDE USE AND AS WELL AS INTEGRATED PEST MANAGEMENT TECHNIQUES FOR THE PROTECTION OF BICYCLISTS AND PEDESTRIANS.
8. ALL TREE STAKES AND TIES SHALL BE REMOVED WITHIN ONE YEAR FOLLOWING INSTALLATION OR AS SOON AS TREES ARE ABLE TO STAND ERECT WITHOUT SUPPORT.
1) PROVIDE STRUCTURAL SOILS WITHIN ALL TREE WELLS, AND UNDER THE SIDEWALKS FOR A SIX-FOOT MINIMUM DISTANCE BEYOND ANY TREE WELL, FOR A 24-INCH MINIMUM DEPTH, AND FOR A LENGTH OF AT LEAST 8 FEET CENTERED ON EACH STREET TREE, AND
2) NOTE IRRIGATION, WALK-ON MULCH, AND ROOT BARRIERS WHERE APPROPRIATE.

IRRIGATION SYSTEM INTENT

THE PRIMARY GOAL OF THE DESIGN OF THE IRRIGATION SYSTEM IS FOR A SYSTEM THAT WILL IRRIGATE THE PLANT MATERIALS WITH FOCUS ON WATER CONSERVATION TECHNOLOGIES AND SYSTEM EFFICIENCY TO GIVE THE OWNER A SYSTEM THAT MINIMIZES WATER CONSUMPTION AND MINIMAL MAINTENANCE COST. WHILE STILL PRELIMINARY IN NATURE AND AS YET NOT DESIGNED, THE SYSTEM WILL BE DESIGNED PER CITY OF PETALUMA STANDARDS AND REGULATIONS AND WILL FEATURE THE FOLLOWING:

1. POINT OF CONNECTION IS EXPECTED TO BE FROM A CITY WATER MAINLINE LOCATED IN EITHER PETALUMA BOULEVARD OR B STREET, WITH A PIPING INFRASTRUCTURE THAT WILL BE DESIGNED TO SUPPLY WATER TO ALL PLANTING AREAS THAT WILL REQUIRE IRRIGATION.
2. THE AUTOMATIC IRRIGATION CONTROLLER WILL BE AN ET BASED CENTRAL CONTROL SYSTEM THAT WILL UTILIZE EVAPOTRANSPIRATION OR SOIL MOISTURE SENSOR DATA AND UTILIZE A RAIN SENSOR.
3. PRESSURE REGULATORS WILL BE INSTALLED TO ENSURE DYNAMIC PRESSURE OF THE SYSTEM IS WITHIN MANUFACTURER'S RECOMMENDED PRESSURE RANGE.
4. MANUAL SHUT-OFF VALVES WILL BE INSTALLED AS CLOSE AS POSSIBLE TO THE POINT OF CONNECTION, TO MINIMIZE WATER LOSS IN CASE OF AN EMERGENCY, SUCH AS A MAINLINE BREAK, OR ROUTINE REPAIR.
5. A BACKFLOW PREVENTION DEVICE WILL BE INSTALLED TO PROTECT THE WATER SUPPLY FROM CONTAMINATION BY THE IRRIGATION SYSTEM.
6. FLOW SENSORS WILL BE INSTALLED TO ALLOW DETECTION OF HIGH FLOW CONDITIONS CREATED BY SYSTEM DAMAGE OR MALFUNCTIONS.
7. ALL IRRIGATION EMISSION DEVICES WILL MEET THE REQUIREMENTS PER ANSI STANDARD ASABE/ICC 802-2014 "LANDSCAPE IRRIGATION SPRINKLER AND EMITTER STANDARD".
8. THE DESIGN OF THE IRRIGATION SYSTEM WILL UTILIZE HYDROZONES PER THE LANDSCAPE PLAN.
9. ALL PLANTING AREAS LOCATED WITHIN ABOVE GRADE PLANTERS AT BOTH THE STREET LEVEL AND THE AMENITY DECKS WILL BE IRRIGATED WITH A SUB-SURFACE DRIP SYSTEM. TREES LOCATED WITHIN THESE PLANTERS MAY ALSO FEATURE A BUBBLE OR DRIP TREE-RING SYSTEM, IF NECESSARY TO SUPPLEMENT WATER TO THE TREES.
10. TREES LOCATED AT THE STREET EDGE WITHIN TREE GRATES WILL BE IRRIGATED WITH EITHER A BUBBLE OR DRIP TREE-RING SYSTEM.

SITE LEGEND (THIS SHEET)

CODE	DESCRIPTION
PAVING	
P1	C.I.P. CONCRETE PAVEMENT
P2	PRECAST CONCRETE PAVER - TYPE 1 (ACCENT, DIAMOND, MORTAR SET)
P3	PRECAST CONCRETE PAVER - TYPE 2 (FIELD, RECTANGULAR, MORTAR SET)
P4	PRECAST CONCRETE PAVER - TYPE 3 (ACCENT, SQUARE, MORTAR SET)
PLANTERS	
PL1	FREESTANDING PLANTER - TYPE 1 (METAL, RECTANGULAR)
PL2	FREESTANDING PLANTER - TYPE 2 (FIBERGLASS, ROUND)
SITE FURNISHINGS	
SF1	BIKE RACK (FORMAL/COMBINATION "Bike Rack Study" (METAL, 2 BICYCLES))
SF2	TREE GRATE (METAL, 5' X 5')
SITE LIGHTING	
L3	STREET/PEDESTRIAN LIGHT
L4	DOWNLIGHT
L5	WALL SCONCE

PRELIMINARY WATER CALCULATIONS

Reference	Evapotranspiration (Eto)	39.60	Private - POC 1	Non-Residential
Hydrozone # / Planting descriptions	Plant Factor (PF)	Irrigation Efficiency (IE)	ETAF (PFIE)	ETAF x Area
LOW	0.3	Drip: 0.81	0.37	505
MEDIUM	0.5	Drip: 0.81	0.62	160
HIGH	0.7	Drip: 0.81	0.86	99
			1.00	-
Regular Landscape Area Totals:				1,523
Special Landscape Area				604
Special Landscape Area Totals:				0
ETWU Total:				14,819
Maximum Allowed Water Allowance (MAWA)				16,827
Over All Landscape Area Totals:				1,523
MAWA Total:				16,827

**Hydrozone # Planting Description*
Eg 1) front lawn
2) low water use plantings
3) medium water use planting

**Irrigation Method*
overhead spray or drip

**Irrigation Efficiency*
0.75 for spray
0.81 for drip

**ETWU (Annual Gallons Required) = Eto x 0.62 x ETAF x Area*
where 0.62 is a conversion factor that acre-inches per acre per year to gallons per square foot per year.

**MAWA (Annual Gallons Allowed) = (Eto) x 0.62 [(ETAF x LA) + ((1-ETAF) x SLA)]*
where 0.62 is a conversion factor that acre-inches per acre per year to gallons per square foot per year. LA is the total landscape area in square feet. SLA is the total special landscape area in square feet, and ETAF is .25 or residential areas and 0.45


ETAF Calculations

Regular Landscape Area	All Landscape Area (including special landscape area)
Total ETAF x Area: 604	Total ETAF x Area: 604
Total Area: 1,523	Total Area: 1,523
Average ETAF: 0.40	Site-wide ETAF: 0.40


Average ETAF for Regular Landscape Areas must be 0.55 or below for residential areas, and 0.45 or below for non-residential areas.

PLANT SCHEDULE (THIS SHEET)

TREES	CODE	QTY	BOTANICAL / COMMON NAME	SIZE	WATER USE
	AA	3	ACER RUBRUM 'ARMSTRONG' ARMSTRONG RED MAPLE	36" BOX	MED
SHRUB AREAS					
	ADE	45 SF	SUCCULENT MIX - LOW		
	ADE	8	AEONIUM DECORUM PINK WHEEL	1 GAL	LOW
	CPE	10	CRASSULA PERFORATA STRING-OF-BUTTONS	1 GAL	LOW
	DPU	10	DUDLEYA PULVERULENTA CHALK LETTUCE	1 GAL	LOW
	STE	38	SEMPERIVIVUM TECTORUM HEN-AND-CHICKS	1 GAL	LOW
	SRO	5	SENECIO ROWLEYANUS STRING OF BEADS	1 GAL	LOW
	SSE	8	SENECIO SERPENS BLUE CHALKSTICKS	1 GAL	LOW
	ABG	28 SF	SUCCULENT MIX - TALL		
	ABG	6	AGAVE X 'BLUE GLOW' BLUE GLOW AGAVE	1 GAL	LOW
	SMA	21	SENECIO MANDRALISCAE BLUE FINGERS	1 GAL	LOW
	SRA	21	SENECIO RADICANS STRING OF BANANAS	1 GAL	LOW

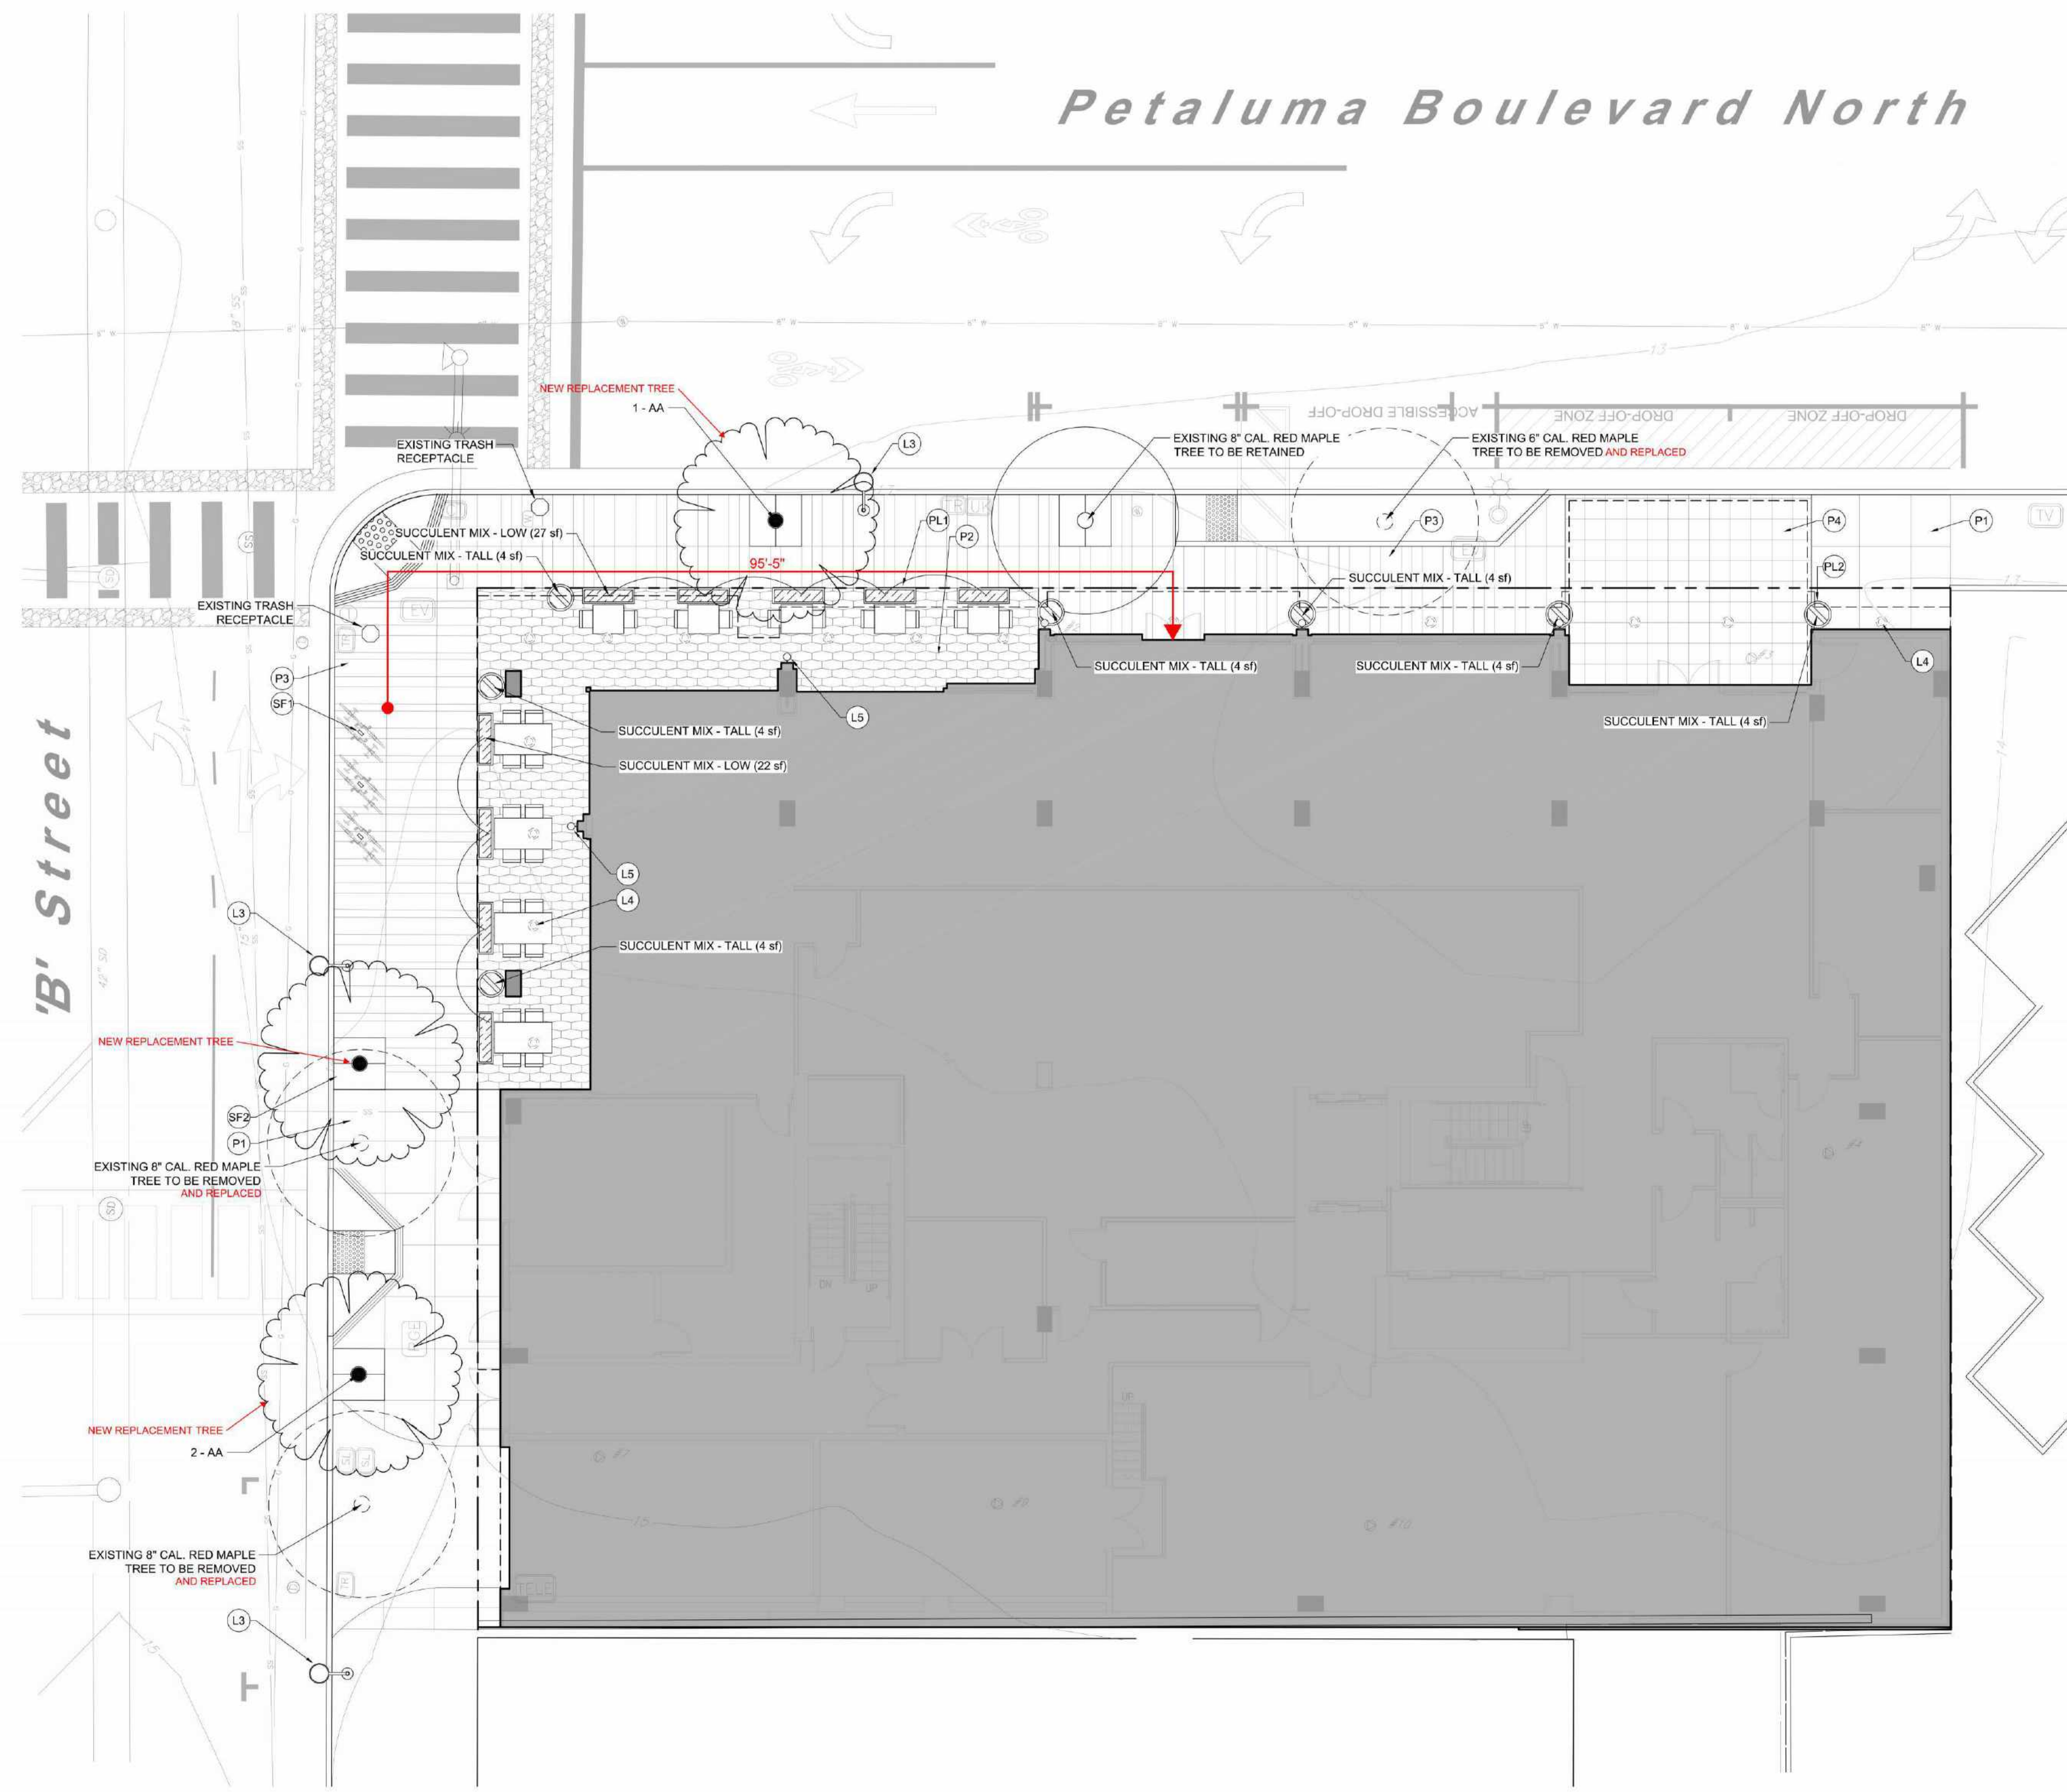

SITE LANDSCAPE PLAN - LEVEL 01

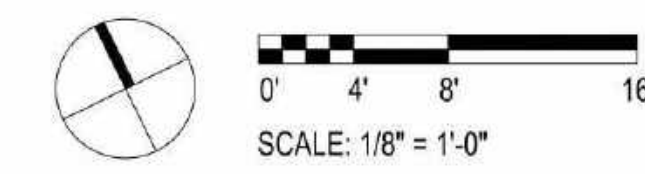

REVISION HISTORY

NO.	DESCRIPTION	DATE

PROFESSIONAL SEAL
INTERIM REVIEW
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SITE LANDSCAPE PLAN - LEVEL 01

DRAWN BY	CHECKED BY
Author	Checker
PROJECT NUMBER: 621010	PROJECT ABBREVIATION: PH
ORIGINAL ISSUE: SPAR APPLICATION	DATE: 08 SEPTEMBER 2023

EKN Petaluma LLC
EKN APPELLATION HOTEL
2 Petaluma Blvd South
Petaluma, California

NOTES

- ALL PLANT MATERIALS TO BE IN ACCORDANCE WITH THE AMERICAN STANDARD FOR NURSERY STOCK ANSI Z60.1.
- ALL PLANT SIZES NOTED ON THE PLANT SCHEDULE ARE MINIMUM SPECIFICATIONS, AND ARE TO BE INCREASED IF NECESSARY TO CONFORM TO PLANT SIZE AND SPECIFICATIONS.
- ALL LANDSCAPED AREAS TO RECEIVE ORGANIC SOIL PREPARATION WITH COMPOST AT THE RATE OF 4 CU. YD. / 1,000 SF AND INCORPORATED TO A DEPTH OF SIX INCHES. SOIL AMENDMENTS TO BE INCORPORATED ACCORDING TO THE RECOMMENDATIONS OF THE REQUIRED SOILS REPORT AND AS APPROPRIATE FOR THE SPECIFIC PLANTS SPECIFIED.
- A MINIMUM THREE-INCH LAYER OF MULCH TO BE APPLIED ON ALL EXPOSED SOIL SURFACES OF PLANTING AREAS EXCEPT IN TURF AREAS, CREEPING OR ROOTING GROUNDCOVERS, OR AS NOTED ON PLANS.
- ALL LANDSCAPED AREAS AND PLANT MATERIALS TO BE WATERED BY AN AUTOMATIC UNDERGROUND IRRIGATION SYSTEM. IRRIGATION SYSTEM DESIGN, INSTALLATION, OPERATION AND MAINTENANCE TO CONFORM TO REQUIREMENTS FOUND IN THE MUNICIPAL CODE CHAPTER 15.17 - WATER CONSERVATION REGULATIONS.
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- HERBICIDES/PESTICIDES SHALL NOT BE APPLIED IN AREAS USED BY PEDESTRIANS/BICYCLISTS WITHIN THE PROJECT WITHOUT FIRST PROVIDING APPROPRIATE SIGNAGE WARNING OF THE USE OF CHEMICALS. THE PROJECT SHALL UTILIZE BEST MANAGEMENT PRACTICES (BMPs) REGARDING PESTICIDE/HERBICIDE USE AND AS WELL AS INTEGRATED PEST MANAGEMENT TECHNIQUES FOR THE PROTECTION OF BICYCLISTS AND PEDESTRIANS.
- ALL TREE STAKES AND TIES SHALL BE REMOVED WITHIN ONE YEAR FOLLOWING INSTALLATION OR AS SOON AS TREES ARE ABLE TO STAND ERECT WITHOUT SUPPORT.
- PRIOR TO PUBLIC IMPROVEMENT PLAN APPROVAL, REGARDING STREET TREES, THE PLAN SET SHALL:
 - PROVIDE STRUCTURAL SOILS WITHIN ALL TREE WELLS, AND UNDER THE SIDEWALKS FOR A SIX-FOOT MINIMUM DISTANCE BEYOND ANY TREE WELL, FOR A 24-INCH MINIMUM DEPTH, AND FOR A LENGTH OF AT LEAST 8 FEET CENTERED ON EACH STREET TREE; AND
 - NOTE IRRIGATION, WALK-ON MULCH, AND ROOT BARRIERS WHERE APPROPRIATE.

IRRIGATION SYSTEM INTENT

THE PRIMARY GOAL OF THE DESIGN OF THE IRRIGATION SYSTEM IS FOR A SYSTEM THAT WILL IRRIGATE THE PLANT MATERIALS WITH FOCUS ON WATER CONSERVATION TECHNOLOGIES AND SYSTEM EFFICIENCY TO GIVE THE OWNER A SYSTEM THAT MINIMIZES WATER CONSUMPTION AND MINIMAL MAINTENANCE COST, WHILE STILL PRELIMINARY IN NATURE AND AS YET NOT DESIGNED, THE SYSTEM WILL BE DESIGNED PER CITY OF PETALUMA STANDARDS AND REGULATIONS AND WILL FEATURE THE FOLLOWING:


- POINT OF CONNECTION IS EXPECTED TO BE FROM A CITY WATER MAINLINE LOCATED IN EITHER PETALUMA BOULEVARD OR B STREET, WITH A PIPING INFRASTRUCTURE THAT WILL BE DESIGNED TO SUPPLY WATER TO ALL PLANTING AREAS THAT WILL REQUIRE IRRIGATION.
- THE AUTOMATIC IRRIGATION CONTROLLER WILL BE AN ET BASED CENTRAL CONTROL SYSTEM THAT WILL UTILIZE EVAPOTRANSPIRATION OR SOIL MOISTURE SENSOR DATA AND UTILIZE A RAIN SENSOR.
- PRESSURE REGULATORS WILL BE INSTALLED TO ENSURE DYNAMIC PRESSURE OF THE SYSTEM IS WITHIN MANUFACTURER'S RECOMMENDED PRESSURE RANGE.
- MANUAL SHUT-OFF VALVES WILL BE INSTALLED AS CLOSE AS POSSIBLE TO THE POINT OF CONNECTION, TO MINIMIZE WATER LOSS IN CASE OF AN EMERGENCY, SUCH AS A MAINLINE BREAK, OR ROUTINE REPAIR.
- A BACKFLOW PREVENTION DEVICE WILL BE INSTALLED TO PROTECT THE WATER SUPPLY FROM CONTAMINATION BY THE IRRIGATION SYSTEM.
- FLOW SENSORS WILL BE INSTALLED, TO ALLOW DETECTION OF HIGH FLOW CONDITIONS CREATED BY SYSTEM DAMAGE OR MALFUNCTIONS.
- ALL IRRIGATION EMISSION DEVICES WILL MEET THE REQUIREMENTS PER ANSI STANDARD ASABE/ICC 802-2014 'LANDSCAPE' IRRIGATION SPRINKLER AND EMITTER STANDARD.
- THE DESIGN OF THE IRRIGATION SYSTEM WILL UTILIZE HYDROZONES PER THE LANDSCAPE PLAN.
- ALL PLANTING AREAS LOCATED WITHIN ABOVE GRADE PLANTERS AT BOTH THE STREET LEVEL AND THE AMENITY DECKS WILL BE IRRIGATED WITH A SUB-SURFACE DRIP SYSTEM. TREES LOCATED WITHIN THESE PLANTERS MAY ALSO FEATURE A BUBBLE OR DRIP TREE-RING SYSTEM, IF NECESSARY TO SUPPLEMENT WATER TO THE TREES.
- TREES LOCATED AT THE STREET EDGE WITHIN TREE GRATES WILL BE IRRIGATED WITH EITHER A BUBBLE OR DRIP TREE-RING SYSTEM.

SITE LEGEND (THIS SHEET)

CODE	DESCRIPTION
PAVING	
(P5)	PRECAST CONCRETE PAVEMENT - TYPE 4 (FIELD SQUARE, MORTAR SET)
(P6)	SYNTHETIC TURF OVER BASE TILE (MORTAR SET)
PLANTERS	
(PL1)	FREESTANDING PLANTER - TYPE 1 (METAL, RECTANGULAR)
(PL3)	BUILT-IN PLANTER (METAL, RECTANGULAR)
SITE LIGHTING	
(L1)	BOLLARD


PRELIMINARY WATER CALCULATIONS

Reference	Evapotranspiration (Eto)	39.60	Private - POC 1	Non-Residential		
Hydrozone # / Planting descriptions	Plant Factor (PF)	Irrigation Method	Irrigation Efficiency (IE) / ETAF (PF*IE)	Landscaping Area (SGLF)	ETAF x Area	Estimated Total Water Use (ETWU)
Regular Landscape Area						
LOW	0.3	Drip	0.81	0.37	1,363	505
MEDIUM	0.5	Drip	0.81	0.62	160	99
HIGH	0.7	Drip	0.81	0.66	-	-
				1	0.00	-
				1,523	604	-
Special Landscape Area						
				1	-	-
				1	-	-
				1	-	-
				0	0	-
						ETWU Total: 14,819
Maximum Allowed Water Allowance (MAWA)						
				1,523	MAWA Total: 16,627	

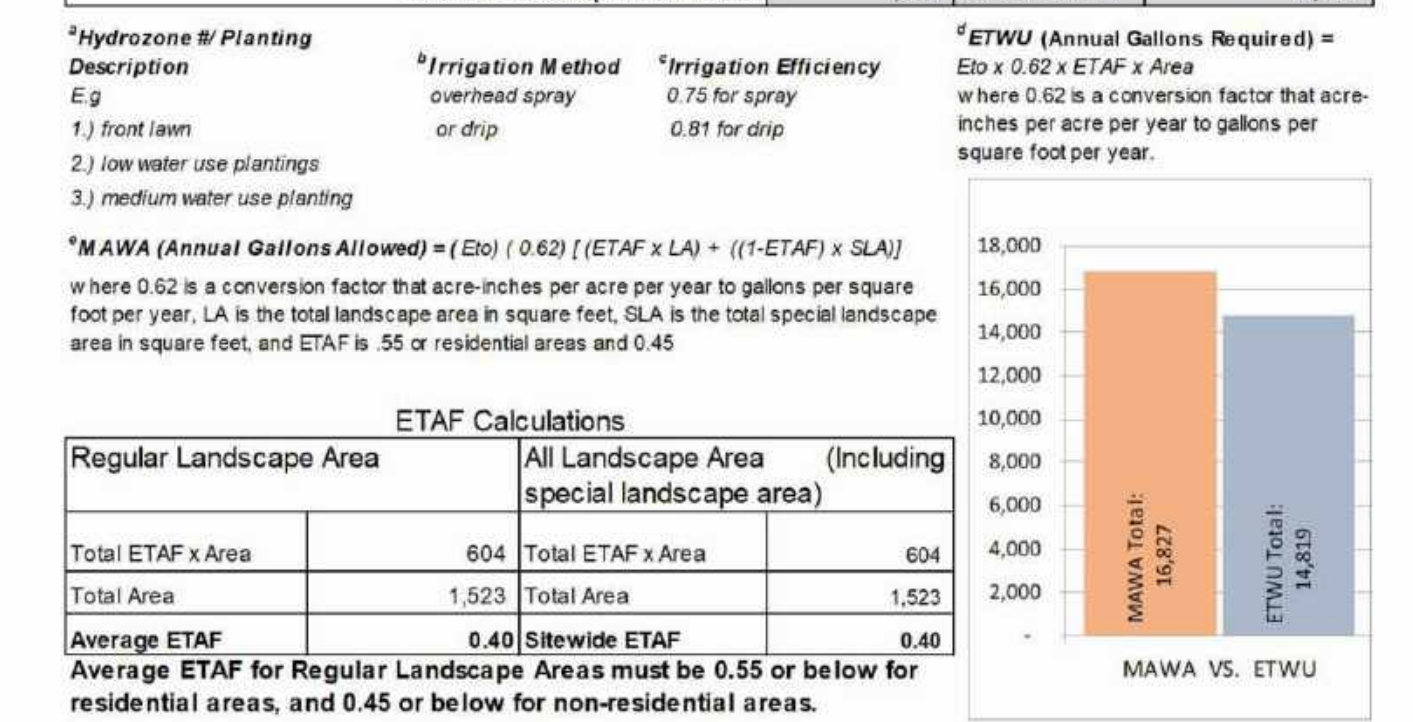

PLANT SCHEDULE (THIS SHEET)

TREES	CODE	QTY	BOTANICAL / COMMON NAME	SIZE	WATER USE
	CO	10	CERCIS OCCIDENTALIS WESTERN REDBUD	15 GAL.	V LOW
SHRUB AREAS					
		372 SF	PLANTER MIX		
	AYG	20	ANIGOZANTHOS X 'YELLOW GEM' YELLOW GEM KANGAROO PAW	1 GAL	LOW
	KUV	20	KNIPHOFIA UVARIA RED HOT POKER	1 GAL	LOW
	PDD	9	PHORMIUM X 'DARK DELIGHT' DARK DELIGHT PURPLE FLAX	5 GAL	LOW
	PTW	9	PITTOSPORUM 'TOBIRA' 'WHEELER'S DWARF' WHEELER'S DWARF PITTOSPORUM	5 GAL	LOW
	WFR	9	WESTRINGIA FRUTICOSA 'WES05' TM MUNDI COAST ROSEMARY	5 GAL	LOW
		351 SF	GREEN ROOF - SEDUM MIX		

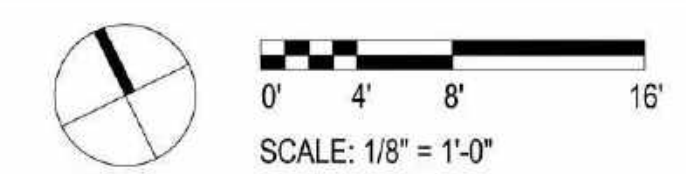

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SITE LANDSCAPE PLAN - LEVEL 02

DRAWN BY	CHECKED BY
Author	Checker
PROJECT NUMBER 621010	PROJECT ABBREVIATION PH
ORIGINAL ISSUE	DATE 08 SEPTEMBER 2023

NOTES

1. ALL PLANT MATERIALS TO BE IN ACCORDANCE WITH THE AMERICAN STANDARD FOR NURSERY STOCK ANSI Z60.1.
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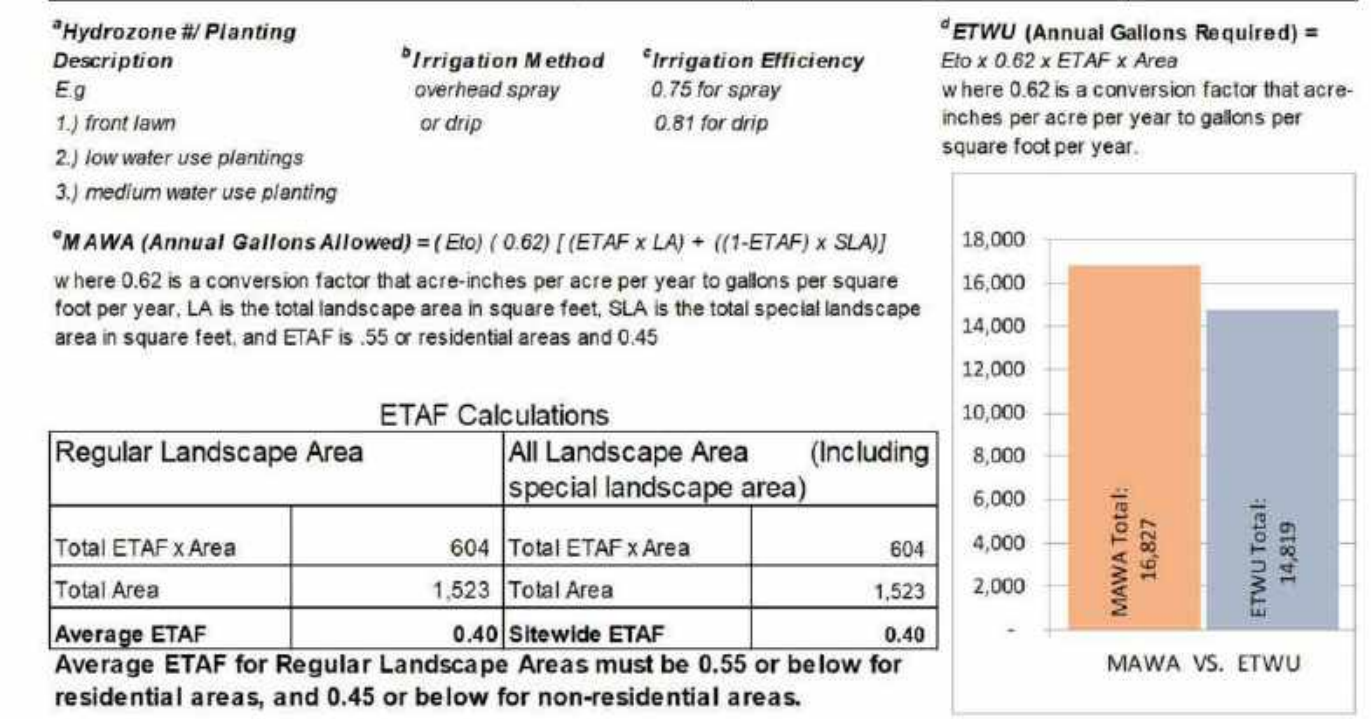
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SITE LEGEND (THIS SHEET)

CODE	DESCRIPTION
PAVING	
P4	PRECAST CONCRETE PAVER - TYPE 3 (ACCENT, SQUARE, ON PEDESTAL)
P7	PRECAST CONCRETE PAVER - TYPE 5 (FIELD, RECTANGULAR, ON PEDESTAL)
P8	WOOD TILE PAVER (ACCENT, RECTANGULAR, ON PEDESTAL)
PLANTERS	
PL1	FREESTANDING PLANTER - TYPE 1 (METAL, RECTANGULAR)
PL2	FREESTANDING PLANTER - TYPE 2 (FIBERGLASS, ROUND)
PL3	BUILT-IN PLANTER (METAL, RECTANGULAR)
SITE LIGHTING	
L1	BOLLARD
L2	URLIGHT



PRELIMINARY WATER CALCULATIONS

Reference Evapotranspiration (Eto)	39.60	Private - POC 1	Non-Residential				
Hydrozone # / Planting descriptions	Plant Factor (PF)	Irrigation Method	Irrigation Efficiency (IE)	ETAF (PPFE)	Landscape Area (Sq Ft.)	ETAF x Area	Estimated Total Water Use (ETWU)
Regular Landscape Area							
LOW	0.3	Drip	0.81	0.37	1,363	505	12,384
MEDIUM	0.5	Drip	0.81	0.62	160	99	2,425
HIGH	0.7	Drip	0.81	0.86	-	-	-
					1	0.00	-
Regular Landscape Area Totals:					1,523	604	-
Special Landscape Area							
					0	0	-
Special Landscape Area Totals:					0	0	-
							14,819
Maximum Allowed Water Allowance (MAWA)							16,827
Over All Landscape Area Totals:					1,523	MAWA Total:	16,827



PLANT SCHEDULE (THIS SHEET)

TREES	CODE	QTY	BOTANICAL / COMMON NAME	SIZE	WATER USE
	LA	4	LUMA APICULATA CHILEAN MYRTLE	15 GAL.	MED
SHRUB AREAS					
		144 SF	SUCCULENT MIX - LOW		
	ADE	23	AEONIU DECORUM PINWHEEL	1 GAL	LOW
	CPE	30	CRASSULA PERFORATA STRING-OF-BUTTONS	1 GAL	LOW
	DPU	30	DUDLEYA PULVERULENTA CHALK LETTUCE	1 GAL	LOW
	STE	120	SEMPERVIUM TECTORUM HEN-AND-CHICKS	1 GAL	LOW
	SRO	15	SENECIO ROWLEYANUS STRING OF BEADS	1 GAL	LOW
	SSE	23	SENECIO SERPENS BLUE CHALKSTICKS	1 GAL	LOW
		20 SF	SUCCULENT MIX - TALL		
	ABG	5	AGAVE X 'BLUE GLOW' BLUE GLOW AGAVE	1 GAL	LOW
	SMA	15	SENECIO MANDRALISCAE BLUE FINGERS	1 GAL	LOW
	SRA	15	SENECIO RADICANS STRING OF BANANAS	1 GAL	LOW
		403 SF	PLANTER MIX		
	AYG	21	ANIGOZANTHOS X 'YELLOW GEM' YELLOW GEM KANGAROO PAW	1 GAL	LOW
	KUV	21	KNIPHOFIA UVARIA RED HOT POKER	1 GAL	LOW
	PDD	10	PHORMIUM X 'DARK DELIGHT' DARK DELIGHT PURPLE FLAX	5 GAL	LOW
	PTW	10	PITTOSPORIUM TOBIIRA 'WHEELER'S DWARF' WHEELER'S DWARF PITTOSPORIUM	5 GAL	LOW
	WFR	10	WESTRINGIA FRUTICOSA 'WES05' TM MUNDI COAST ROSEMARY	5 GAL	LOW

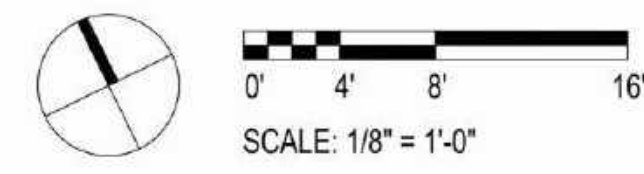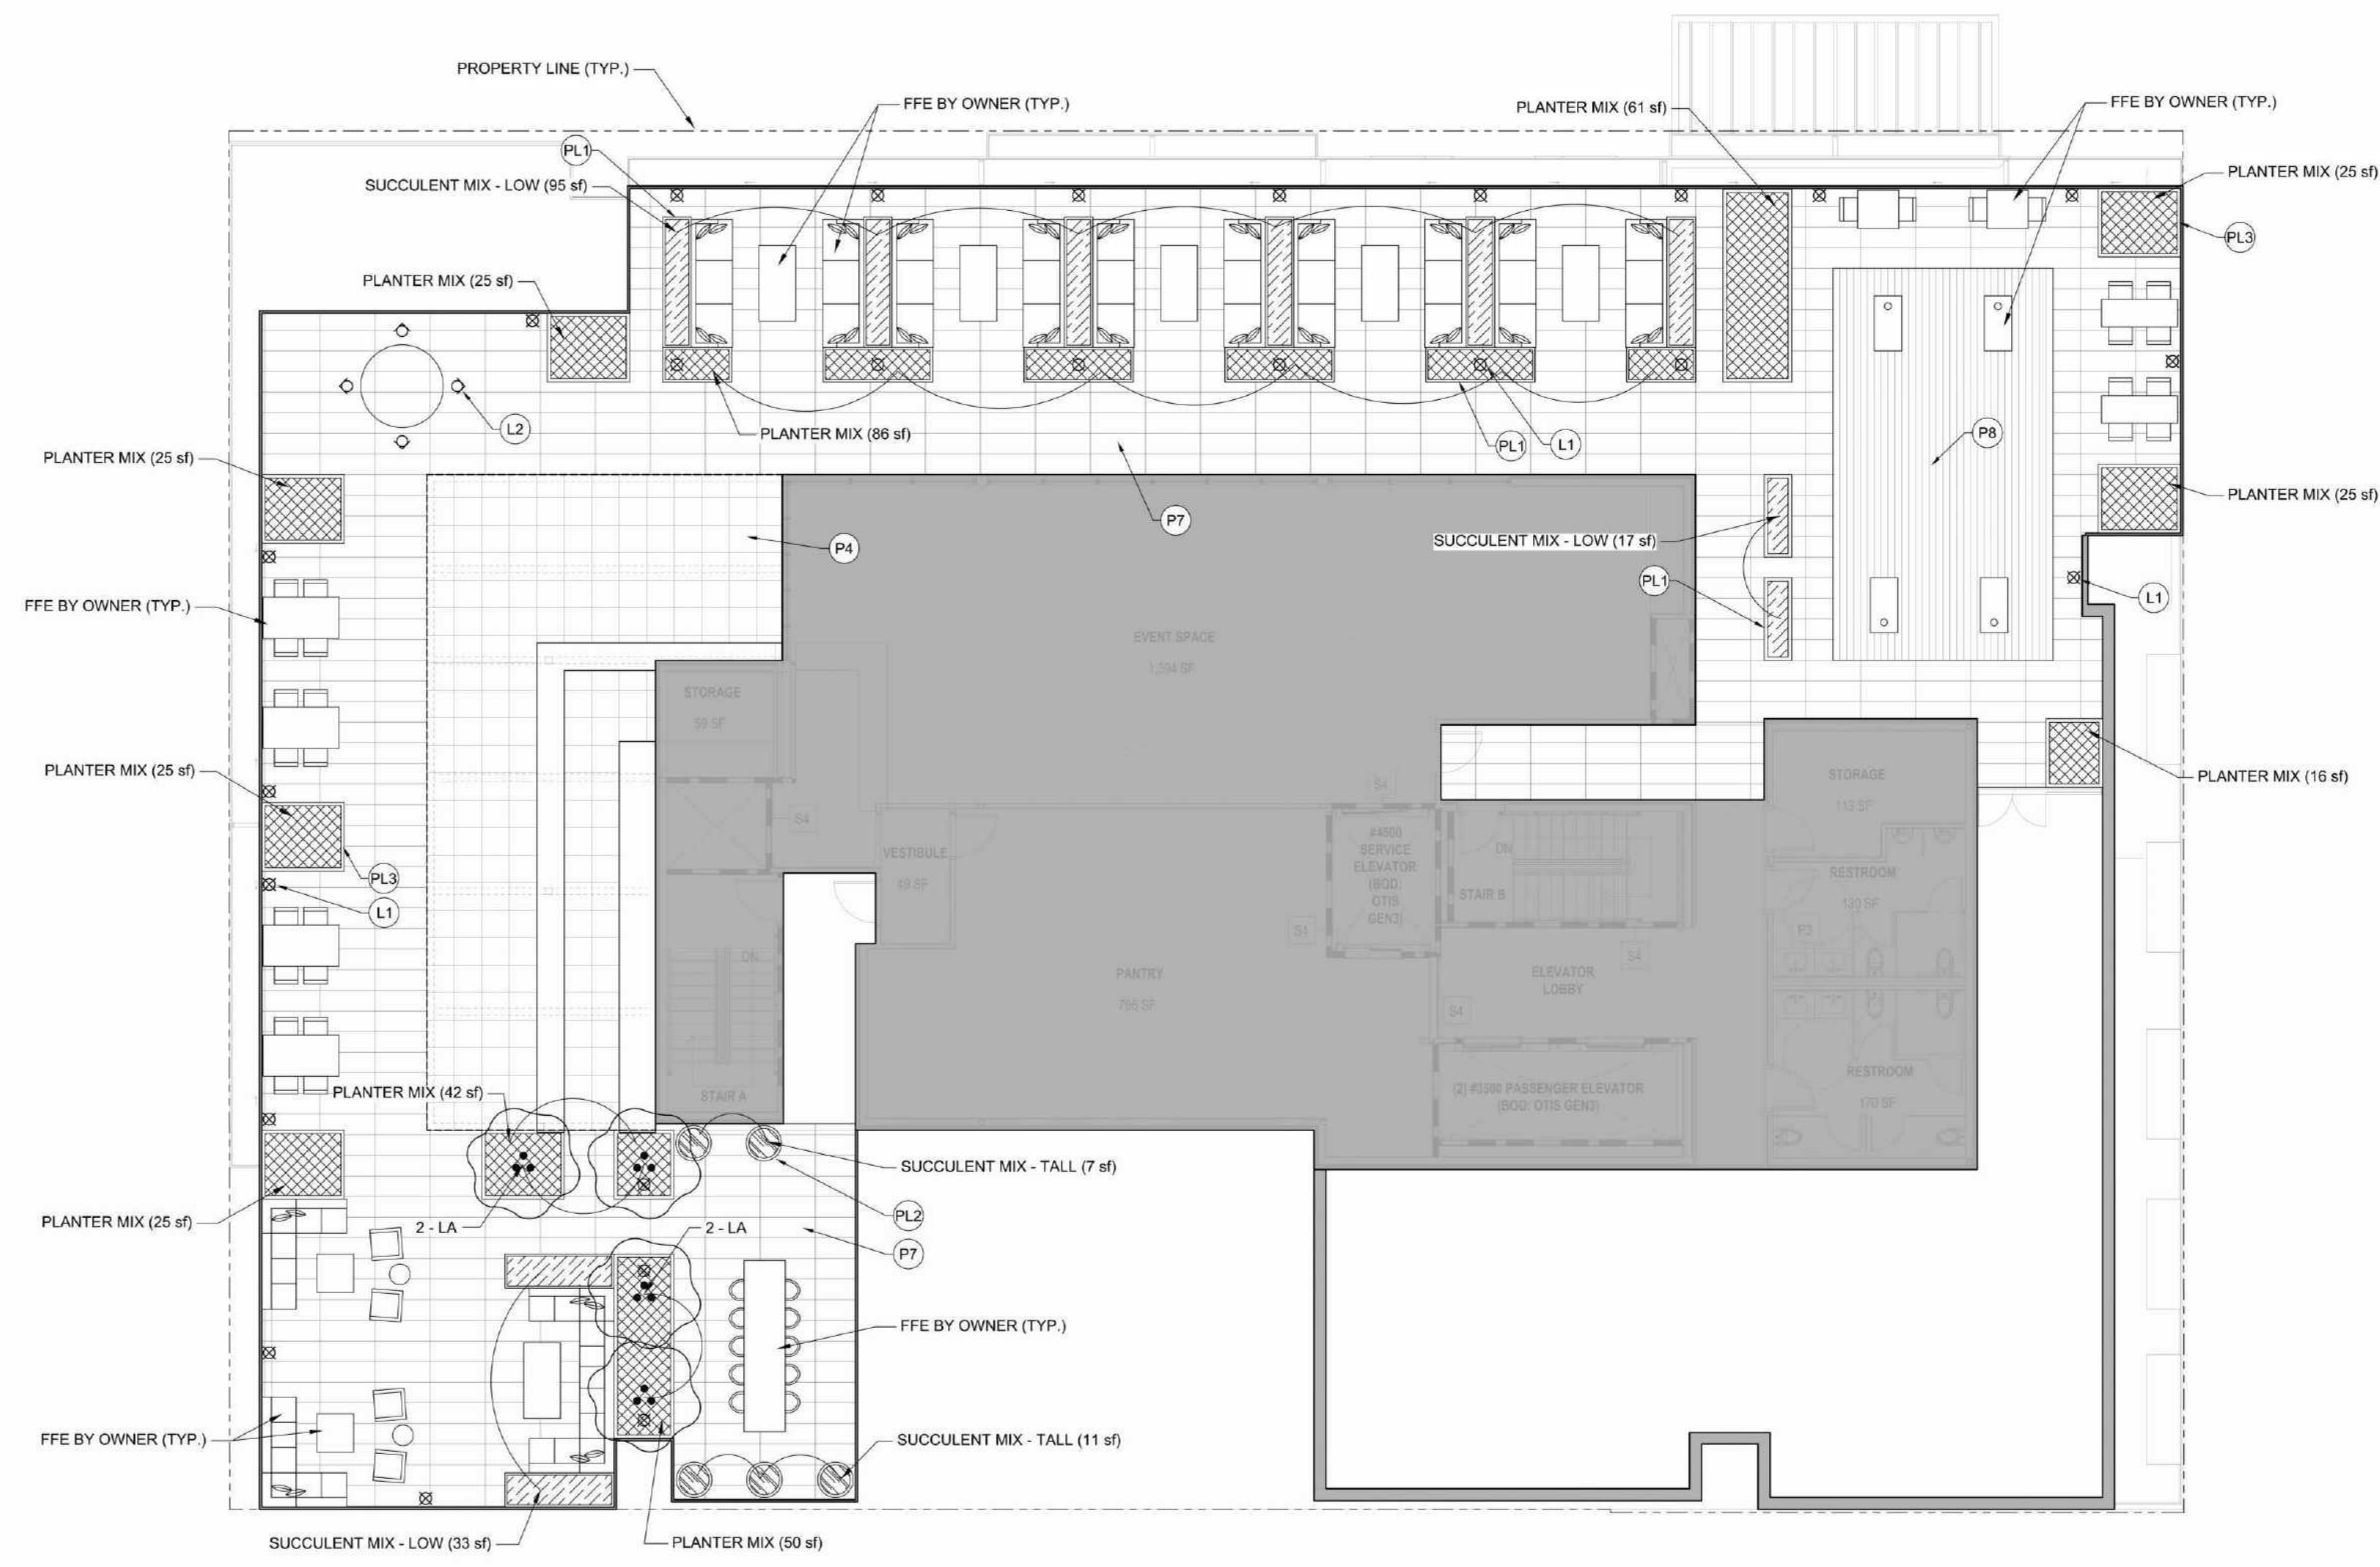

REVISION HISTORY

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SITE LANDSCAPE PLAN - LEVEL 06

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Author	Checker
PROJECT NUMBER 621010	PROJECT ABBREVIATION PH
ORIGINAL ISSUE	DATE 08 SEPTEMBER 2023

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INTERFACE ENGINEERING BRIGHTVIEW DESIGN GROUP
601 South Figueroa Street
Suite 2750
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323 536 2362


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N CONSULTING ENGINEERS
4 Park Plz
Irvine, CA
92614
949 369 1161



EKN Petaluma LLC
EKN APPELLATION HOTEL
2 Petaluma Blvd South
Petaluma, California

REVISION HISTORY

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PROFESSIONAL SEALS		
INTERIM REVIEW		
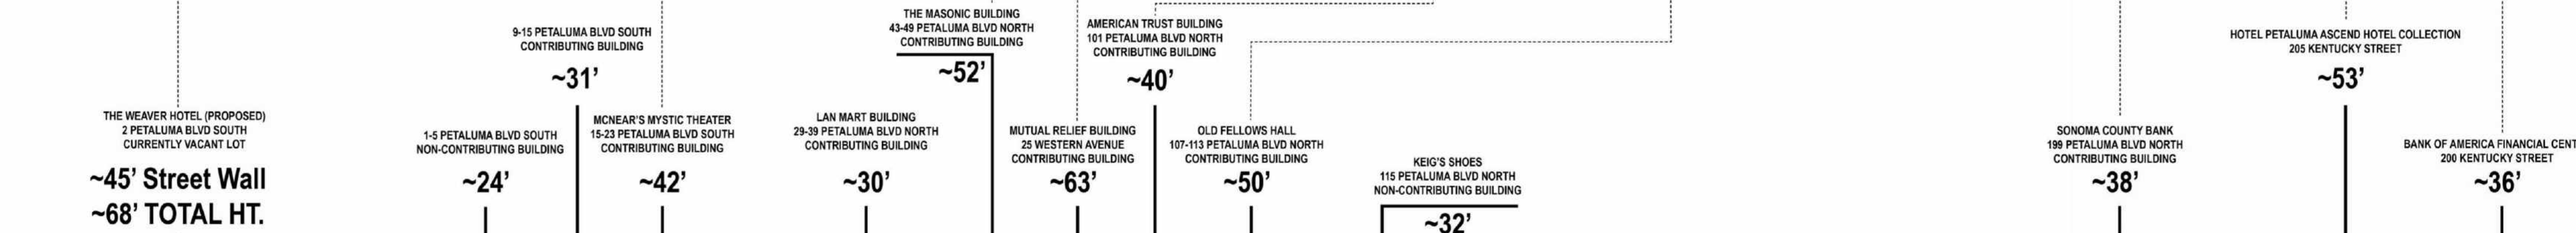
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ARCHITECTURAL - HISTORIC ANALYSIS DIAGRAMS

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Author	Checker
PROJECT NUMBER	PROJECT ABBREVIATION
621010	PH
ORIGINAL ISSUE	DATE
SPAR APPLICATION	08 SEPTEMBER 2023

SPAR-2.1
SHEET NUMBER

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page@psp.com

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ARCHITECTURE / INTERIORS / EXTERIORS / PLANNING / CONSULTING
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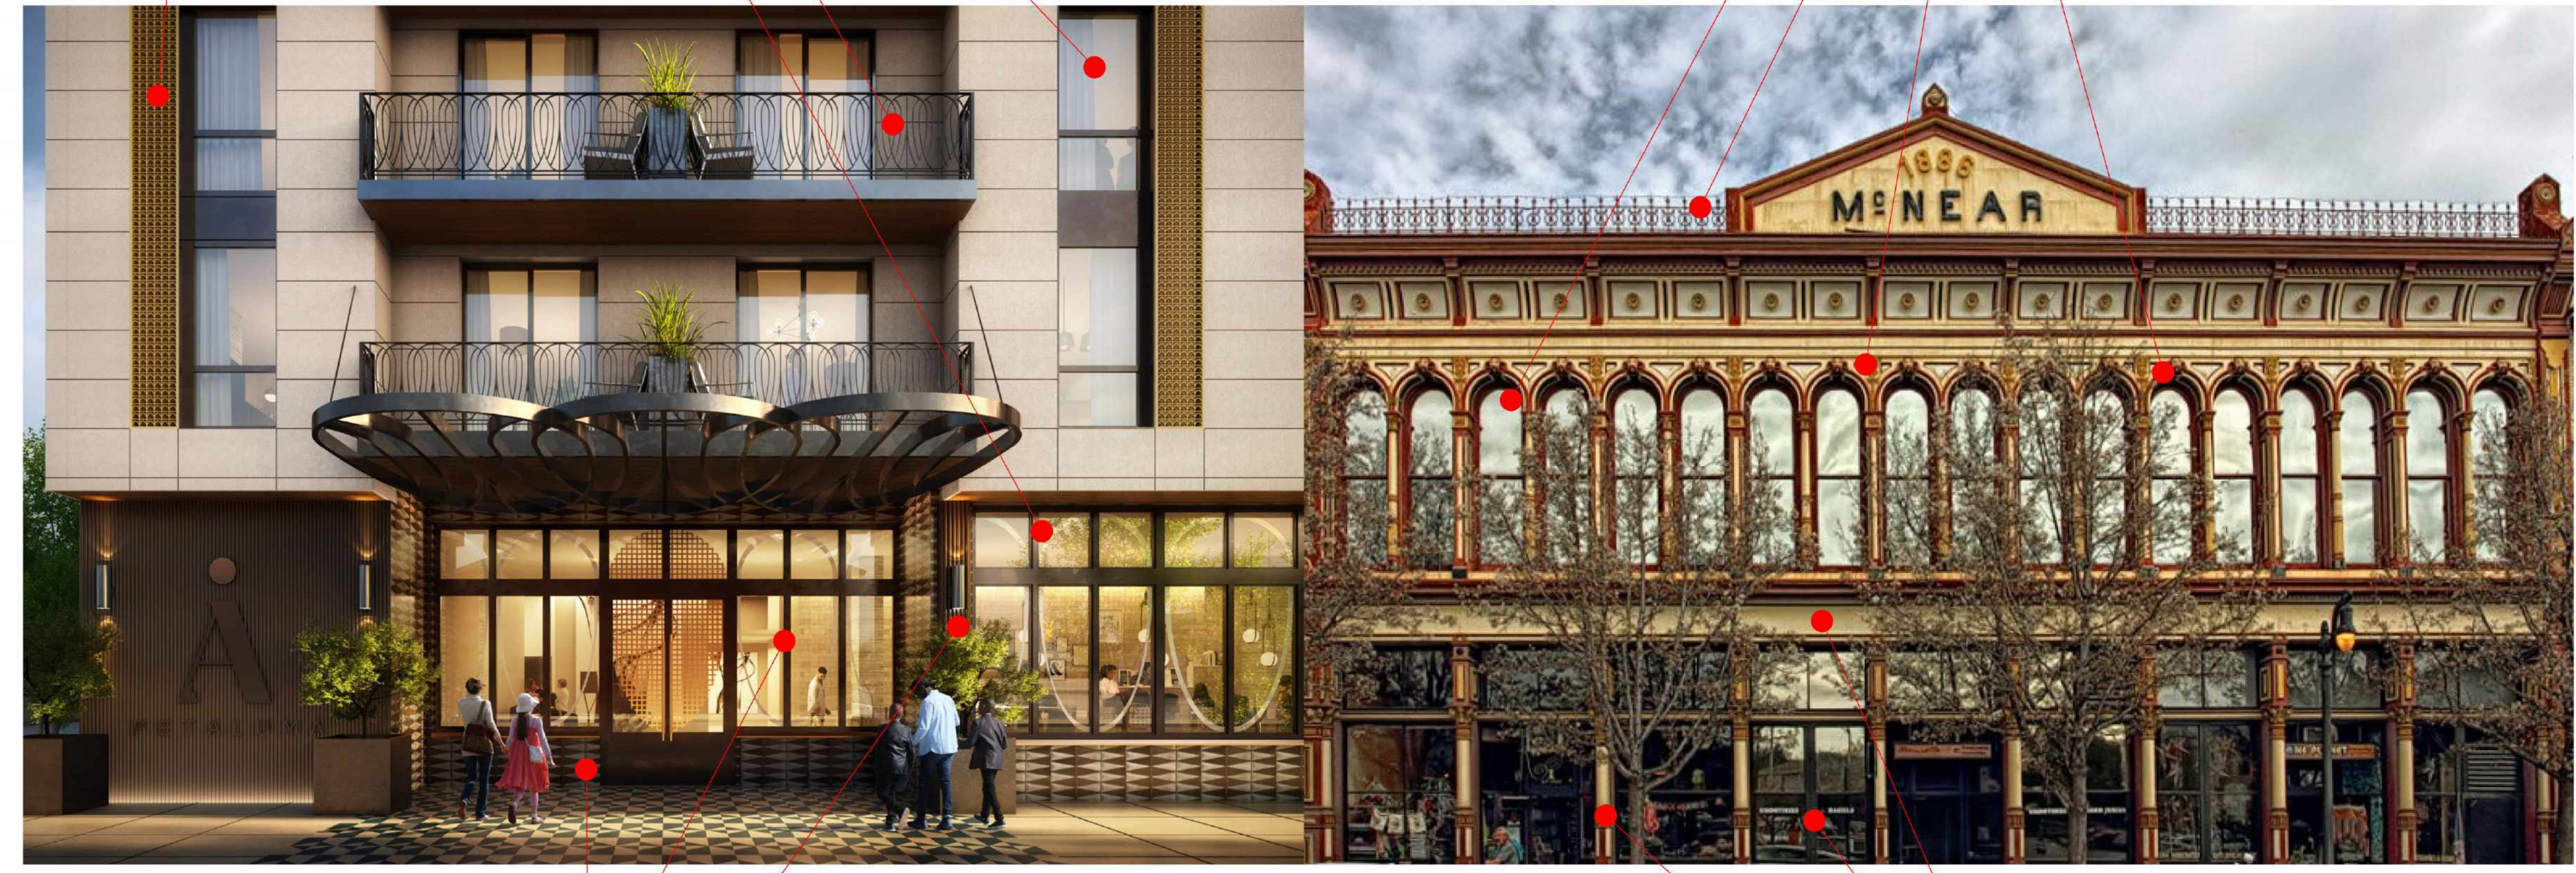
MEP: INTERFACE ENGINEERING BRIGHTVIEW DESIGN GROUP
601 South Figueroa Street Suite 2750 Los Angeles CA 90017 323 536 2362
LANDSCAPE: 1645 Grant Street Denver, Colorado 80203 Address Line 3 949 238 4900

STRUCTURE: BUEHLER ENGINEERING 5 Third Street Suite 1125 San Francisco, CA 94103 213 694 3408
FF&E: DH-COMPANIES 7591 Coppermine Drive Manassas, VA, 20109

INTERIORS: SIXTEEN FIFTY 7509 Girard Ave La Jolla, CA 92037 858 454 6909
CIVIL: N CONSULTING ENGINEERS 4 Park Plz Irvine, CA 92614 949 369 1161

RECESSED 4:1 RATIO WINDOWS
IRON WORK DETAILING
ORNATE DETAILING
ARCH MOTIF

RECESSED 4:1 RATIO WINDOWS
IRON WORK DETAILING
ORNATE DETAILING
ARCH MOTIF



EARTH-TONE COLORS
RHYTHMIC STOREFRONT
w/ TRANSOM
ENGAGED PILASTERS

EARTH-TONE COLORS
RHYTHMIC STOREFRONT
w/ TRANSOM
ENGAGED PILASTERS

EKN Petaluma LLC
EKN APPELLATION HOTEL
2 Petaluma Blvd South
Petaluma, California

REVISION HISTORY

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ARCHITECTURAL - HISTORIC ANALYSIS DIAGRAMS		
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Author	Checker	
PROJECT NUMBER	PROJECT ABBREVIATION	PH
621010		
ORIGINAL ISSUE	DATE	
SPAR APPLICATION	08 SEPTEMBER 2023	

SPAR-2.4

SHEET NUMBER

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 323.536.2362

STRUCTURE: BUEHLER ENGINEERING
 5 Third Street Suite 1125
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 213.694.3408

INTERIORS: SIXTEEN FIFTY
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 858.454.6909

LANDSCAPE: BRIGHTVIEW DESIGN GROUP
 1645 Grant Street Denver, Colorado 80203
 Address Line 3 949.238.4900

FF&E: DH-COMPANIES
 7591 Coppermine Drive
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 213.694.3408

CIVIL: N CONSULTING ENGINEERS
 4 Park Plz Irvine, CA
 92614
 949.369.1161

EKN Petaluma LLC
EKN APPELLATION HOTEL
 2 Petaluma Blvd South
 Petaluma, California

REVISION HISTORY

REVISION	DESCRIPTION	DATE
1	INTERIM REVIEW	


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SHADOW STUDY

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SPAR-2.5

SHEET NUMBER



SUN PATH - 21 DEC, 12:00 - 15:00 P.M.

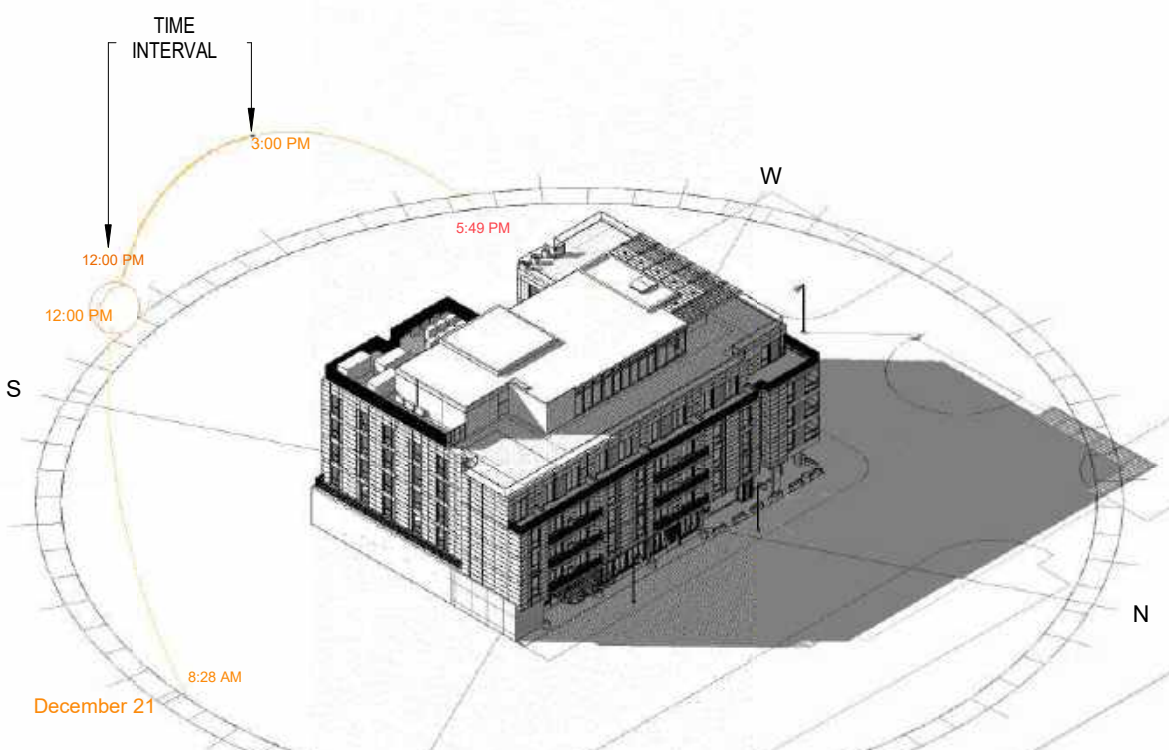

4 SHADOW STUDY @ 15 HRS
 SCALE: 3/64" = 1'-0"



2 SHADOW STUDY 13PM
 SCALE: 3/64" = 1'-0"




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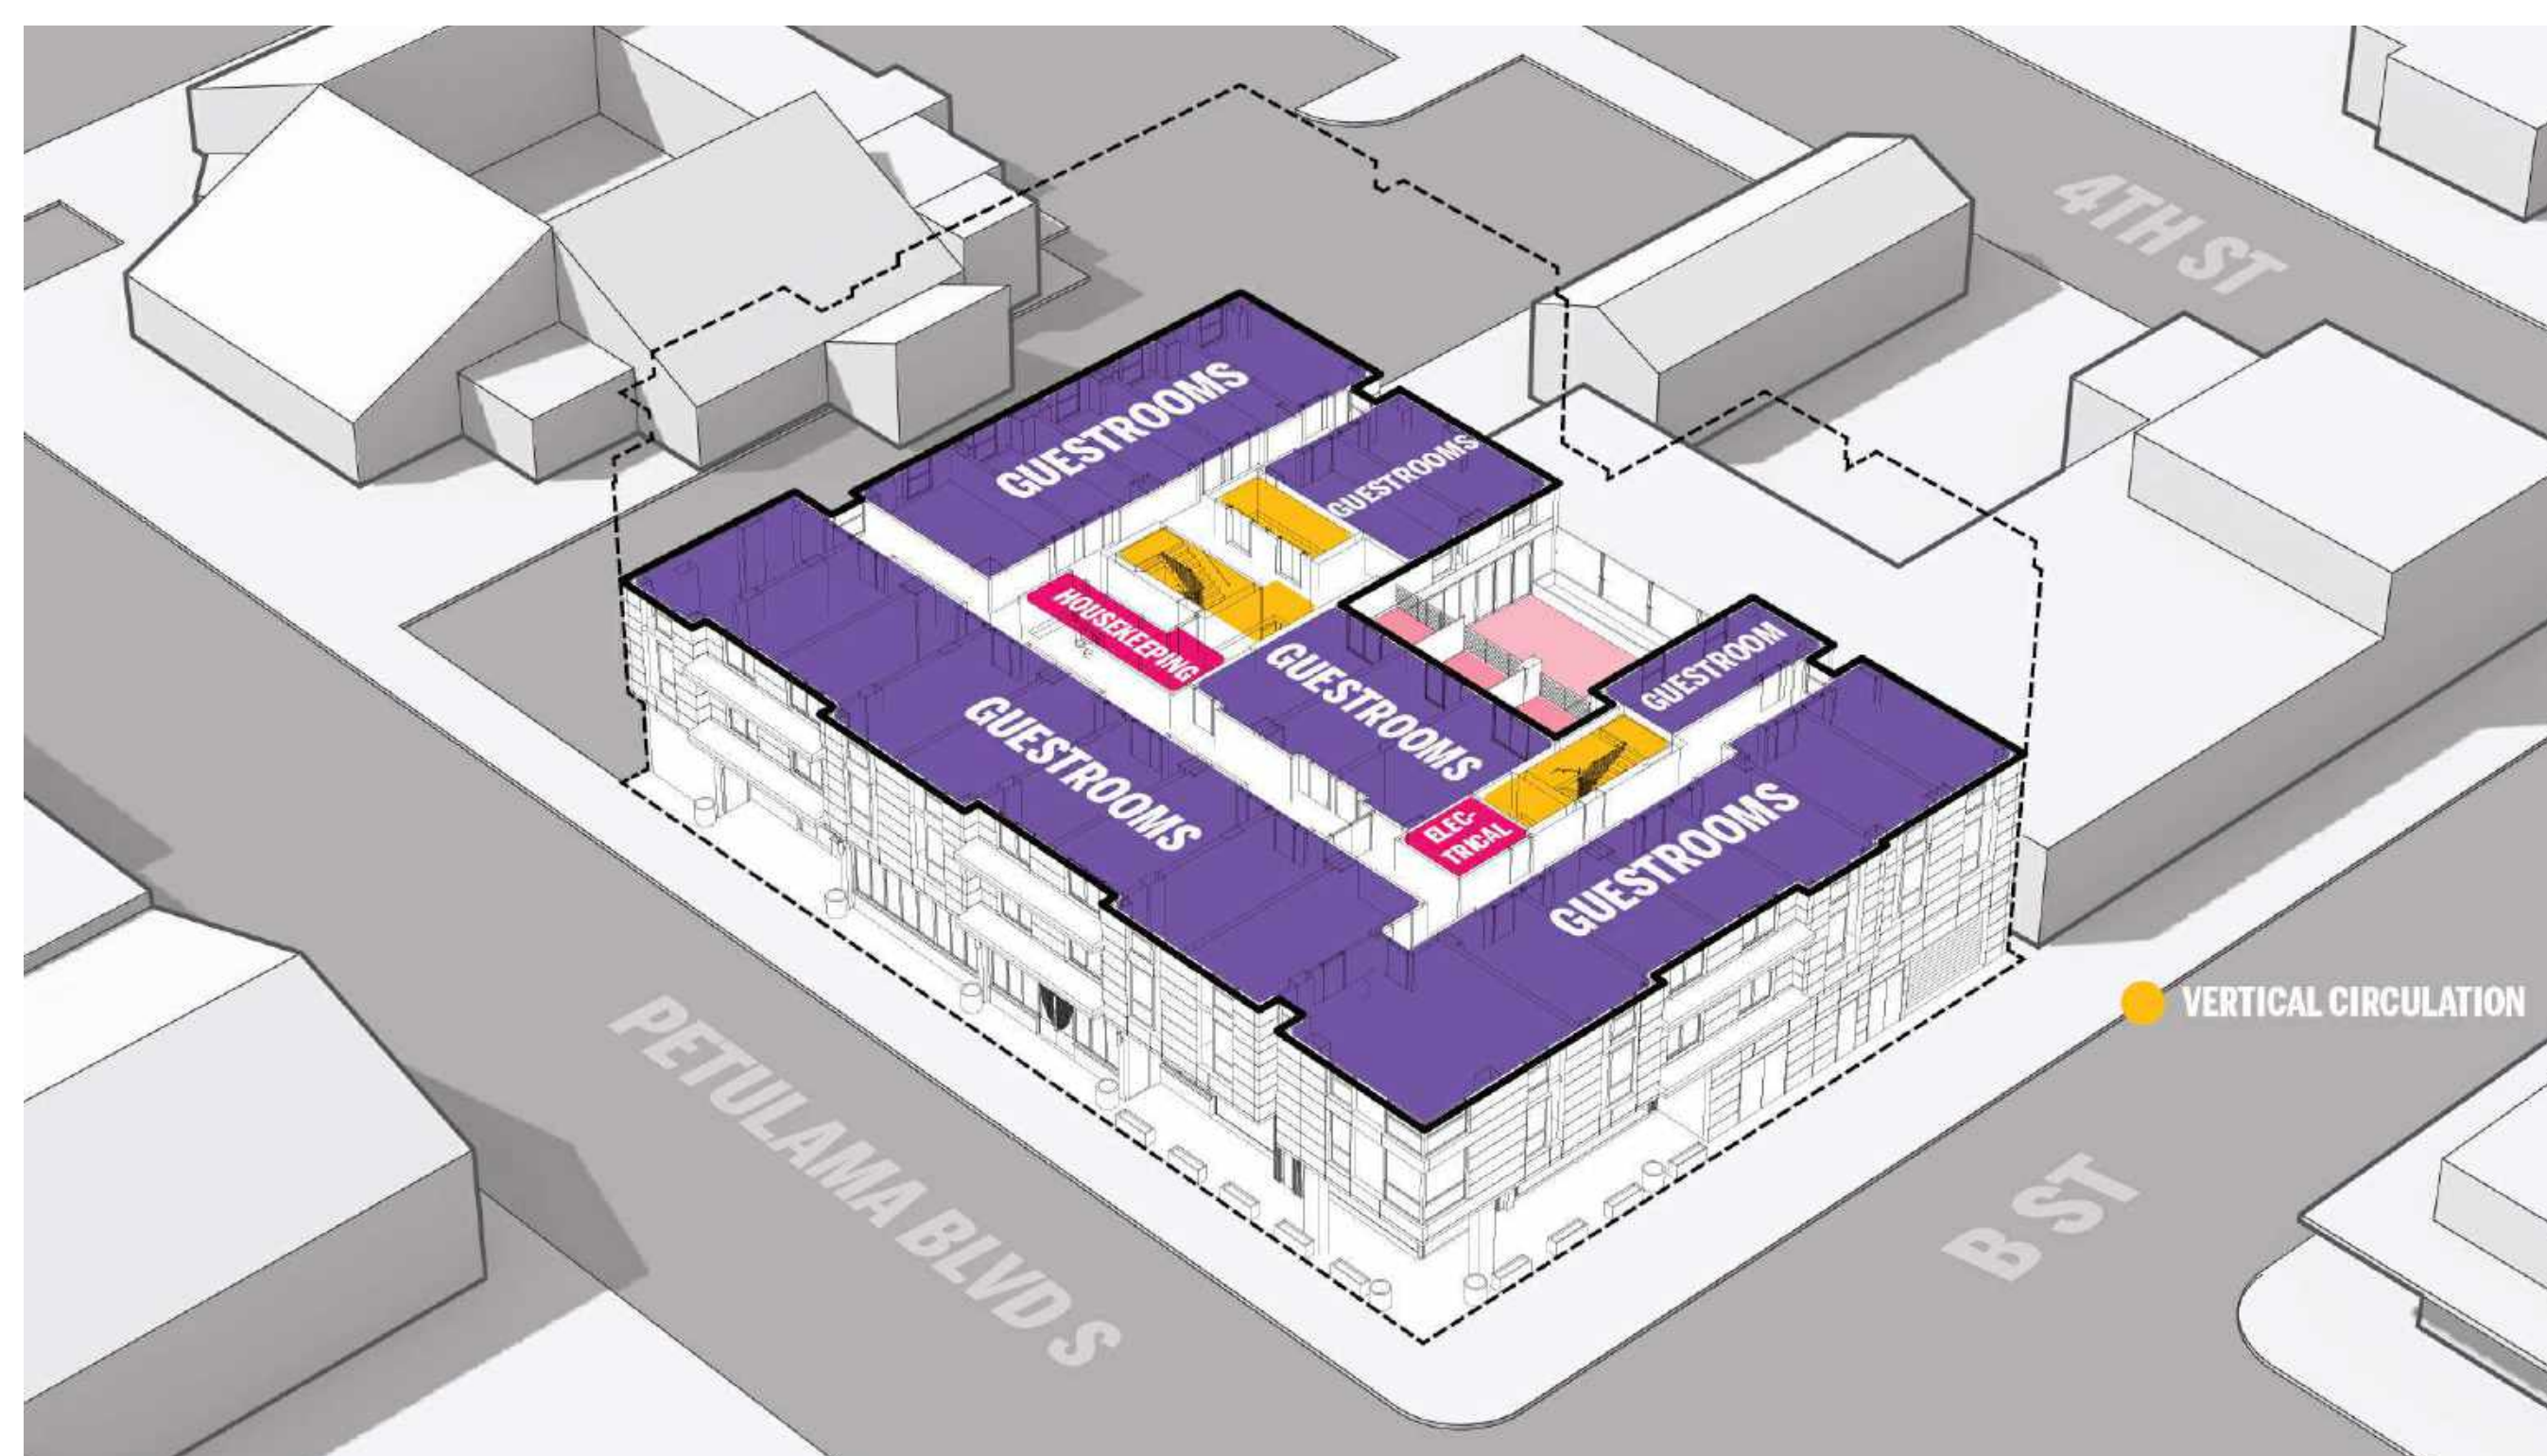
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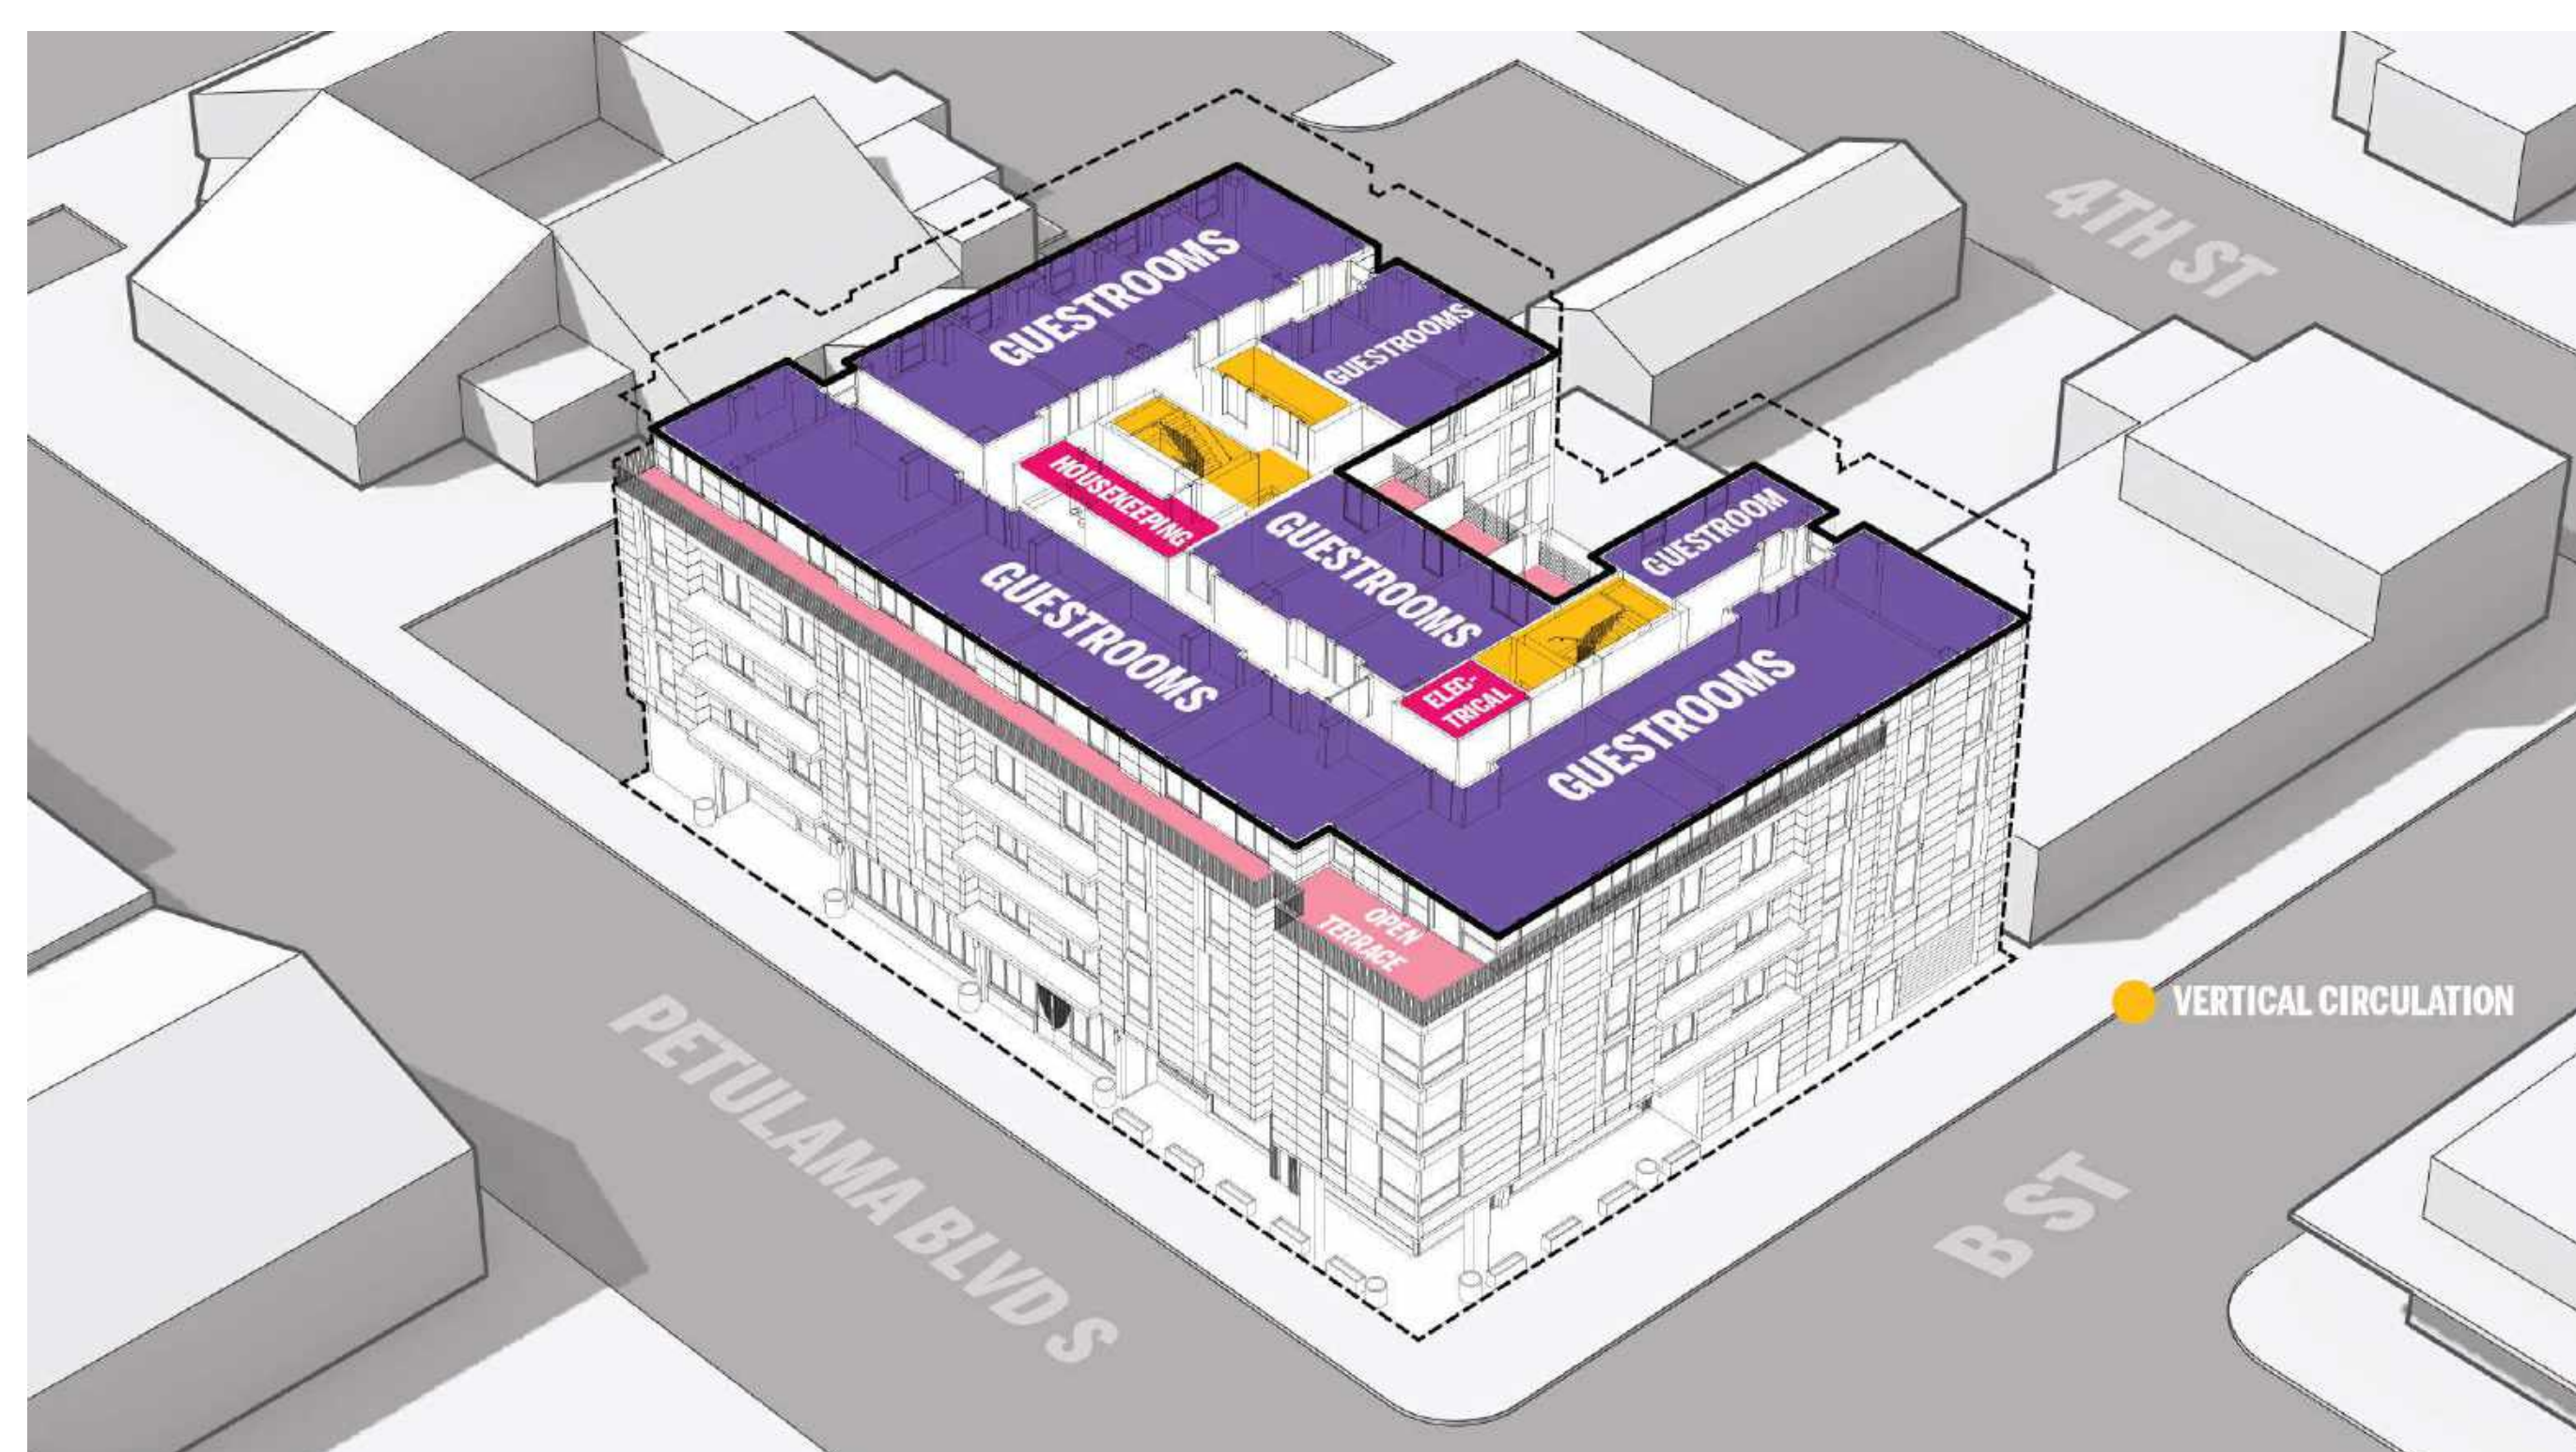
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2 Petaluma Blvd South
Petaluma, California




SIXTH FLOOR




THIRD FLOOR

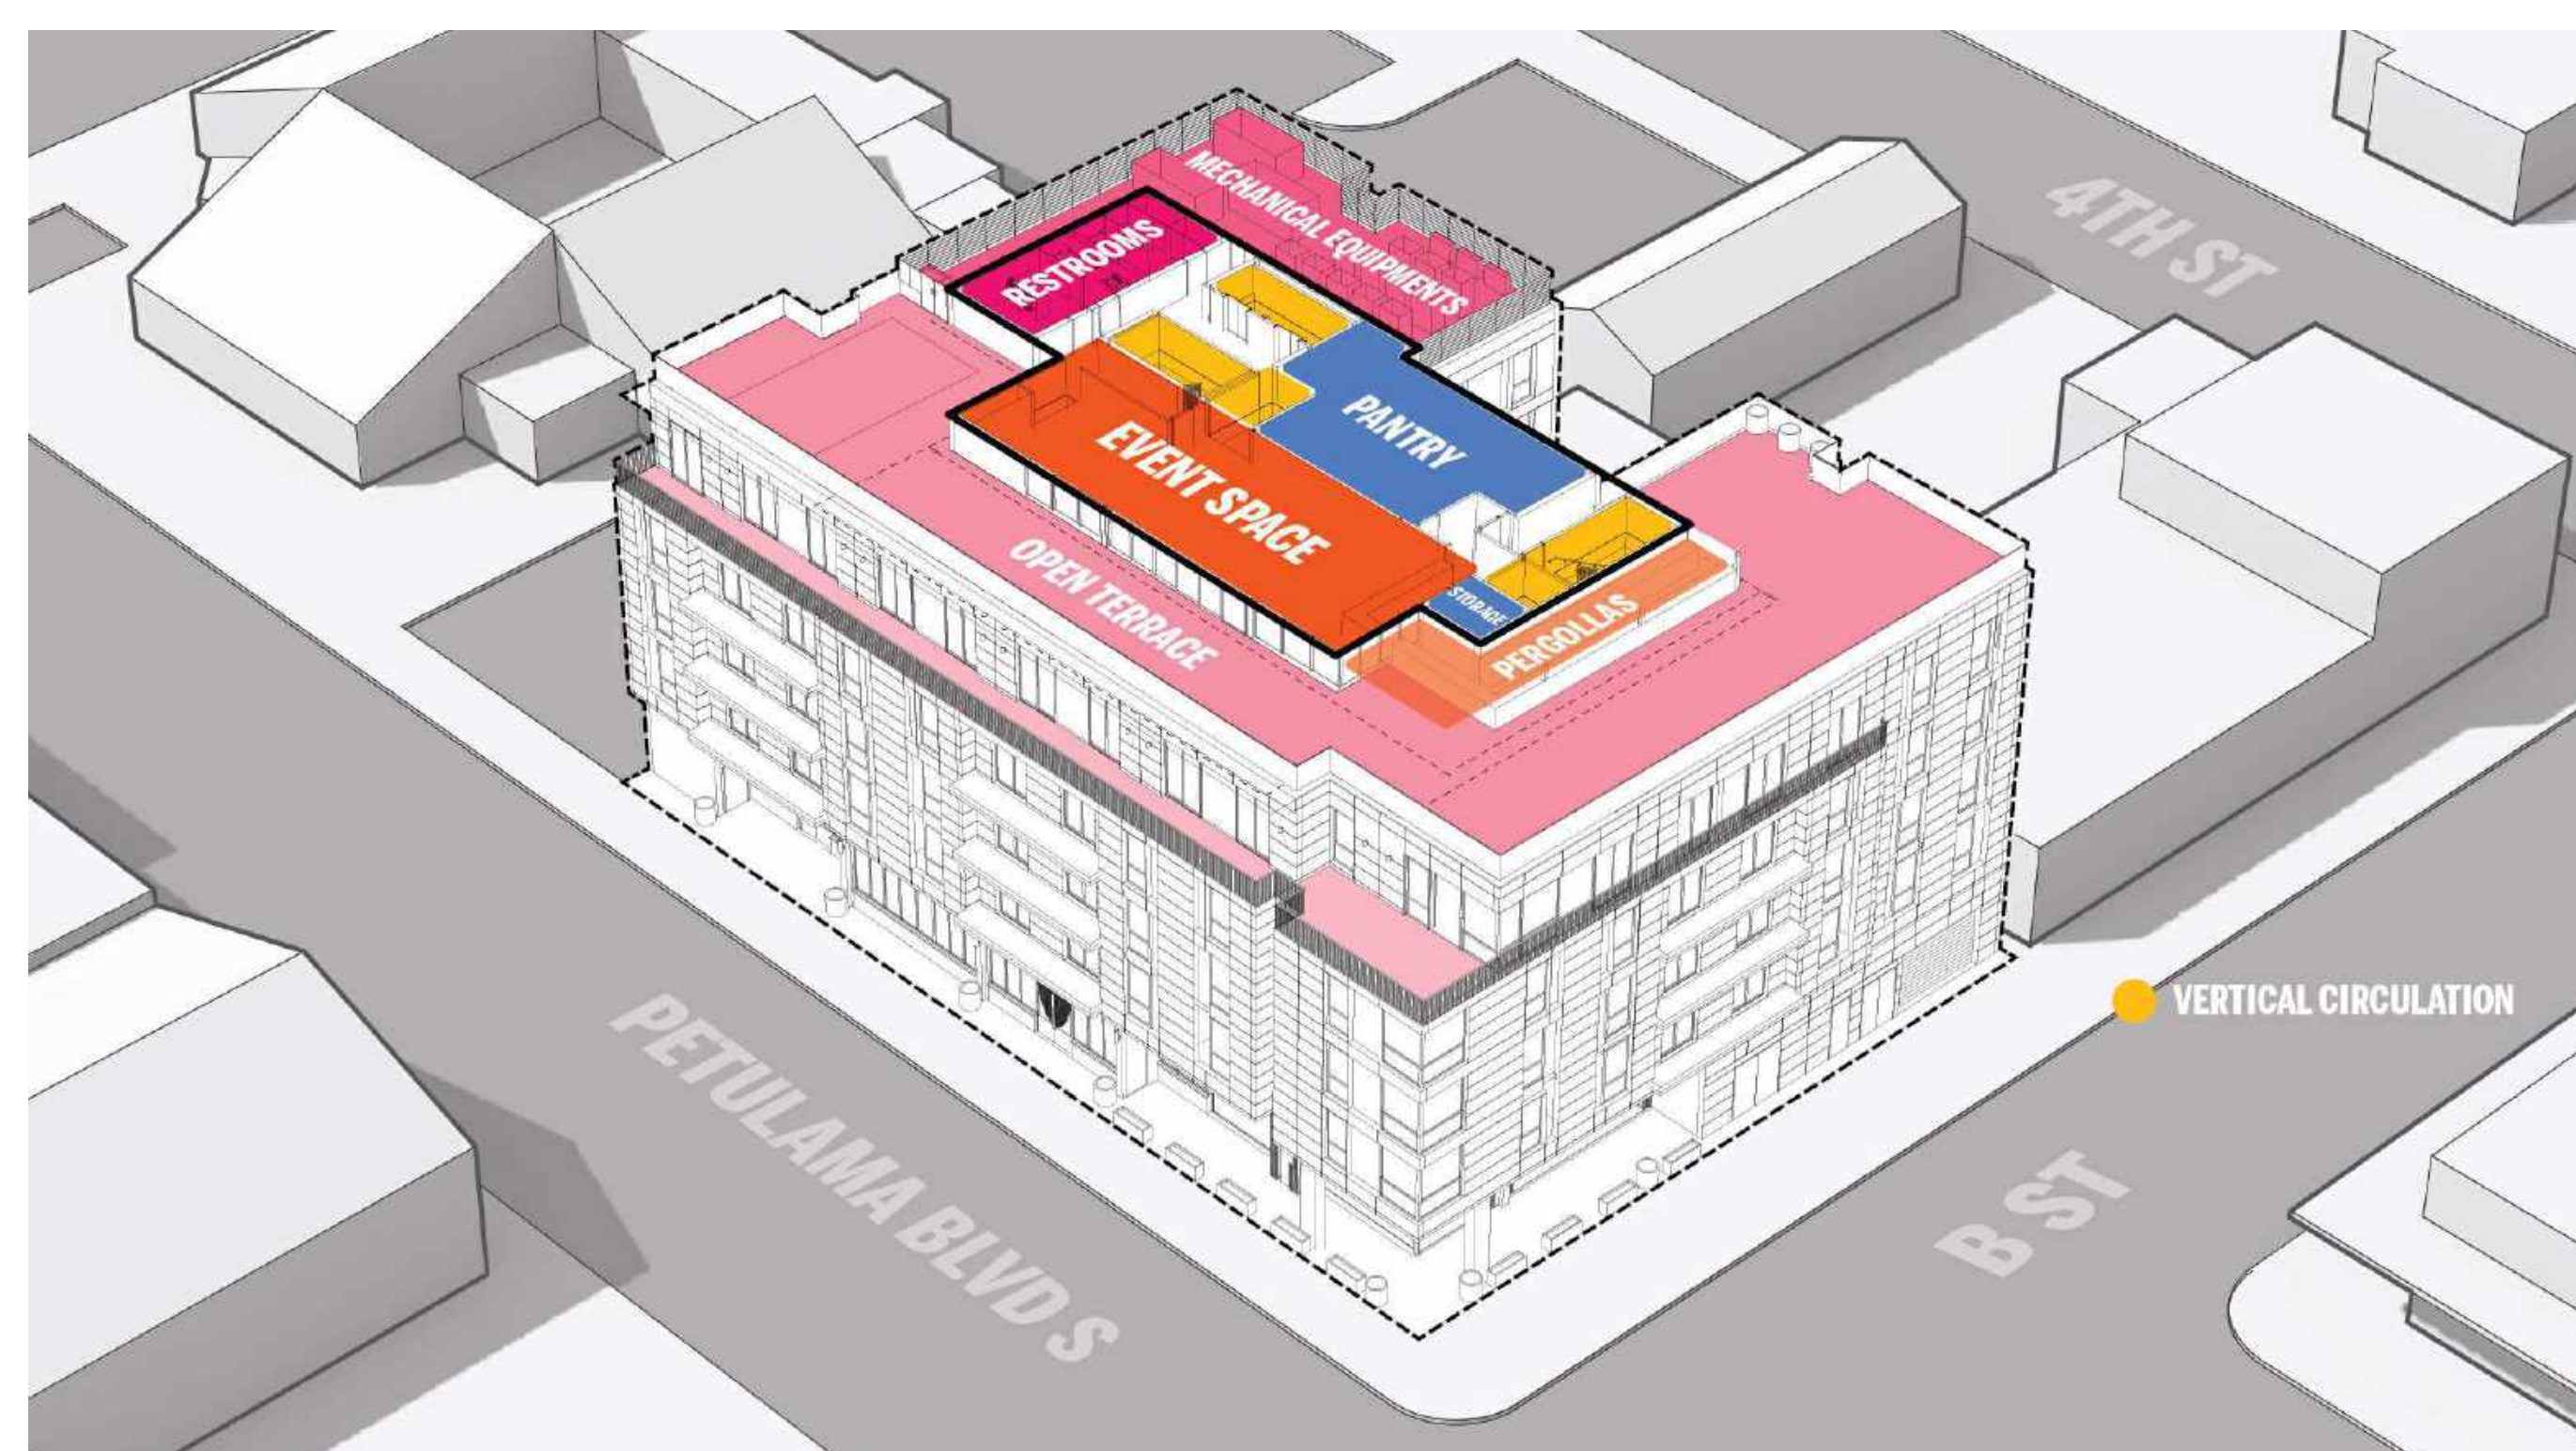


FIFTH FLOOR

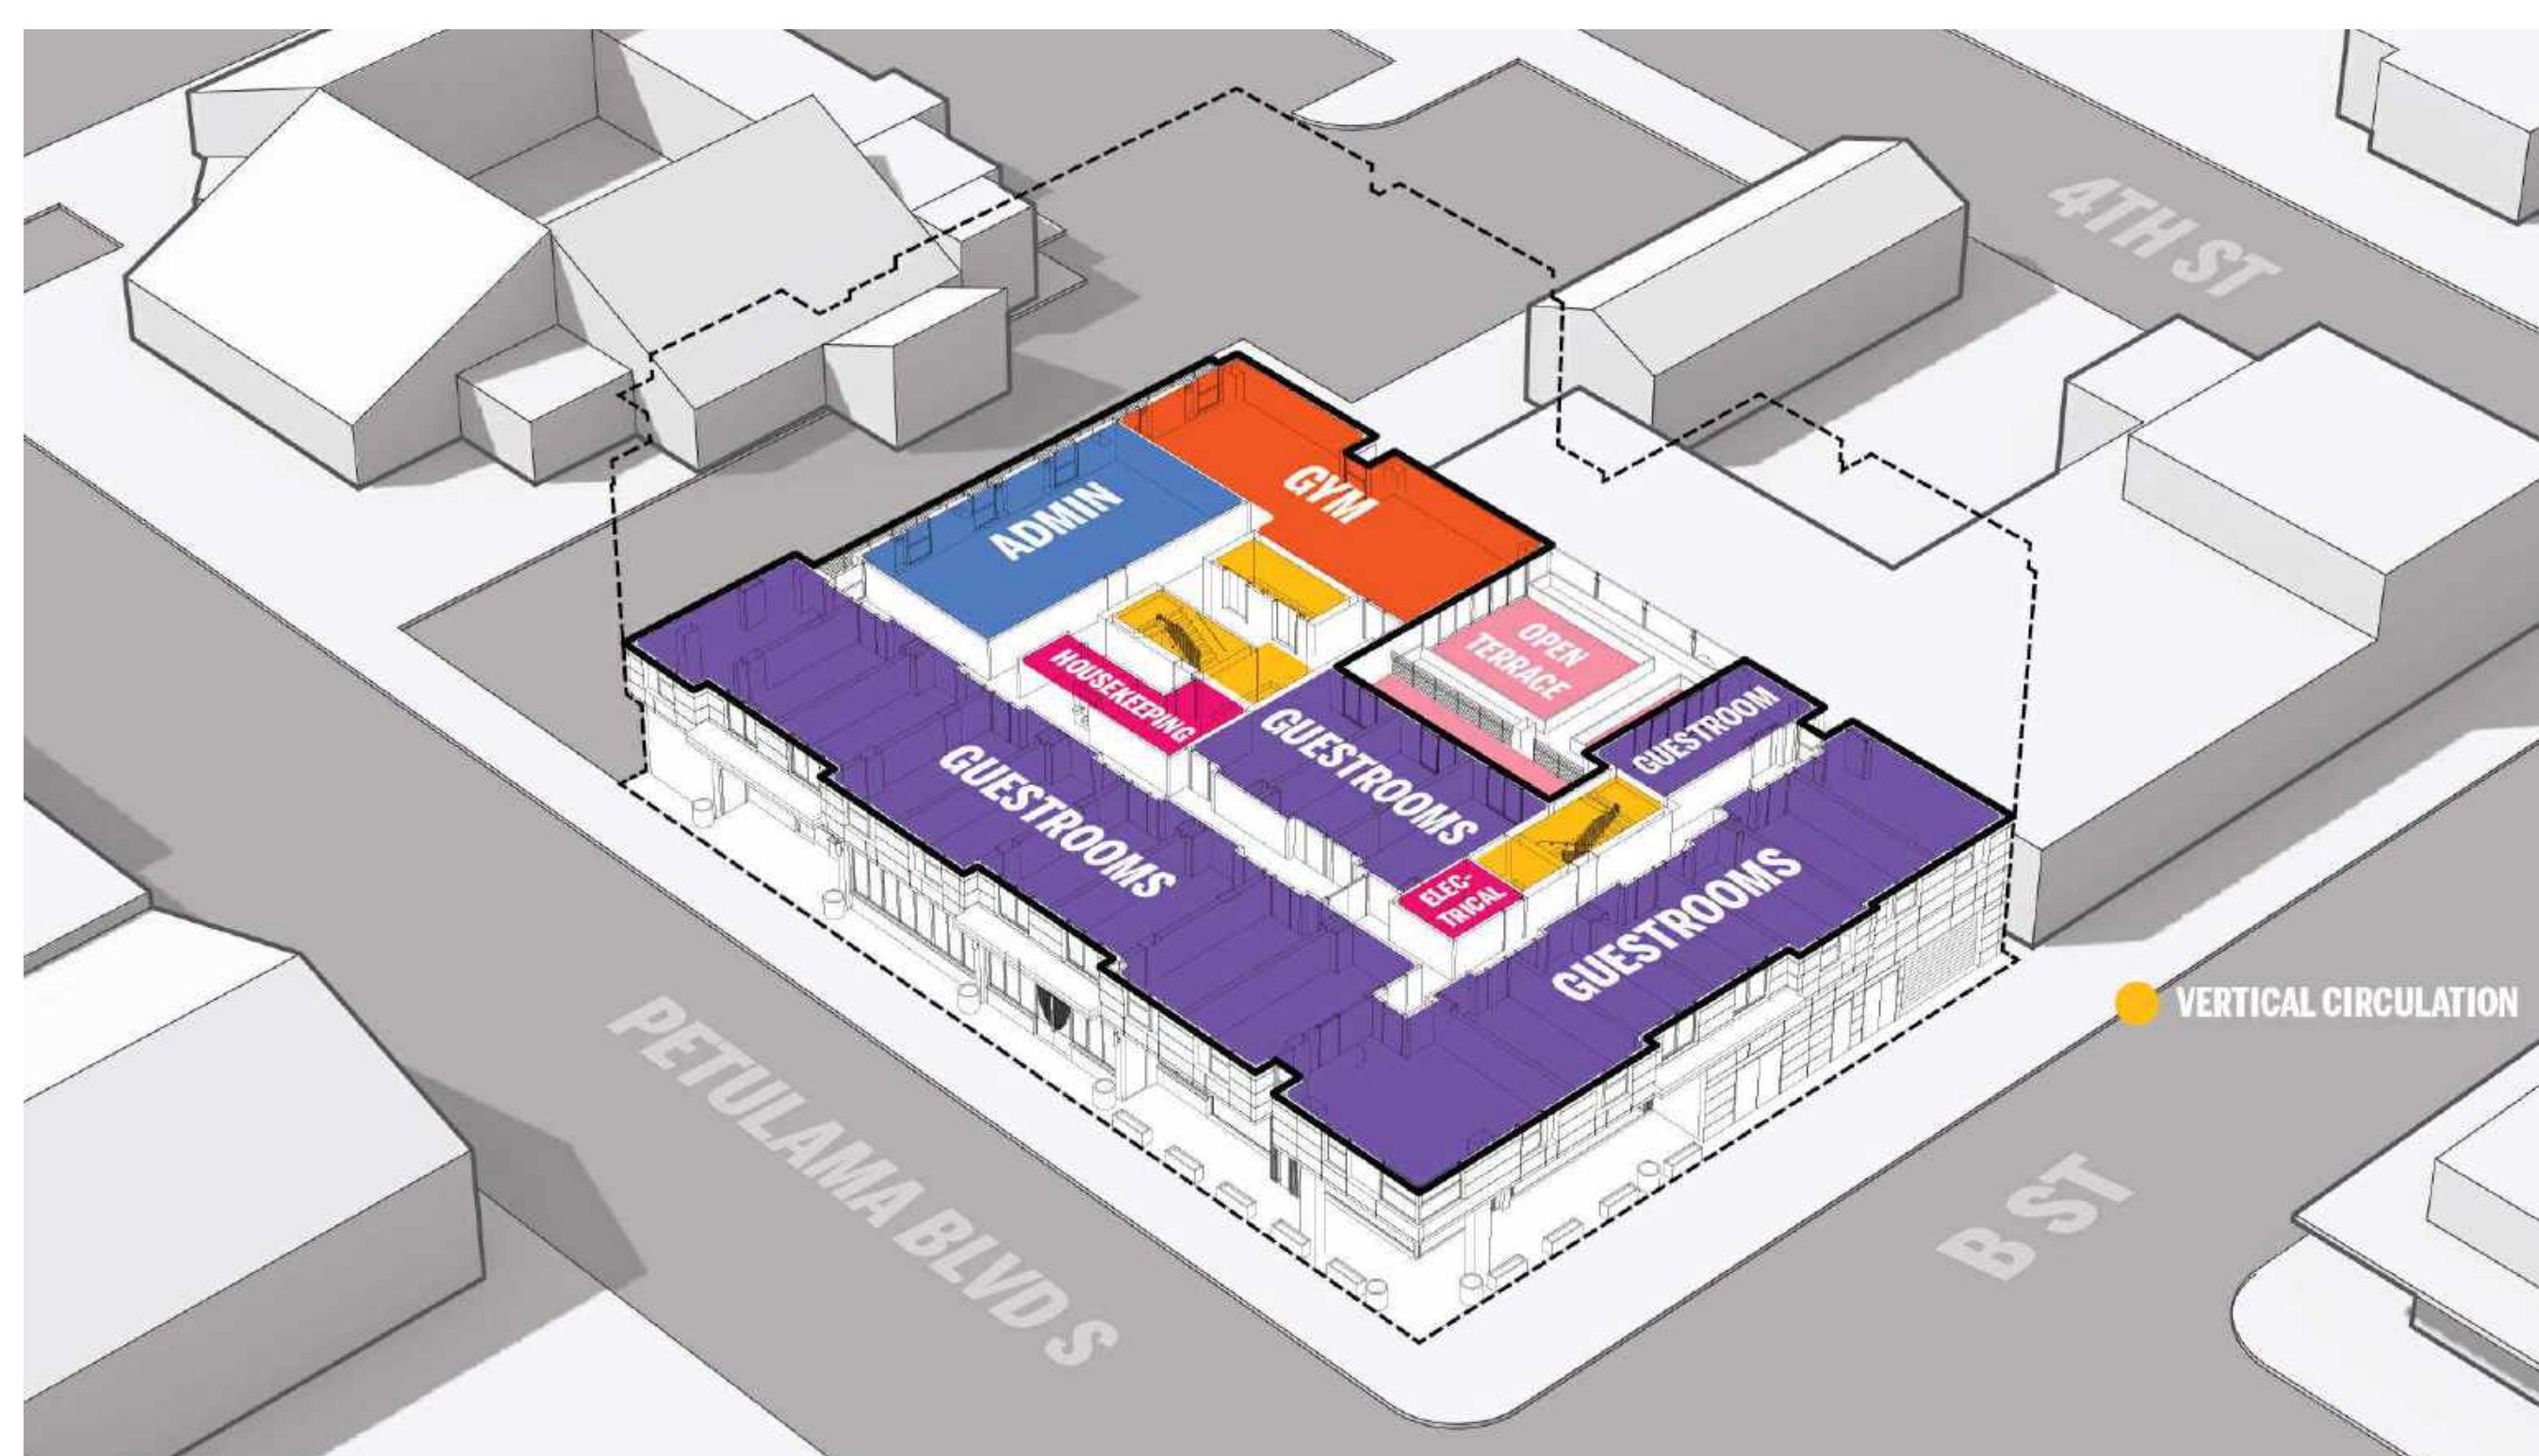

SECOND FLOOR

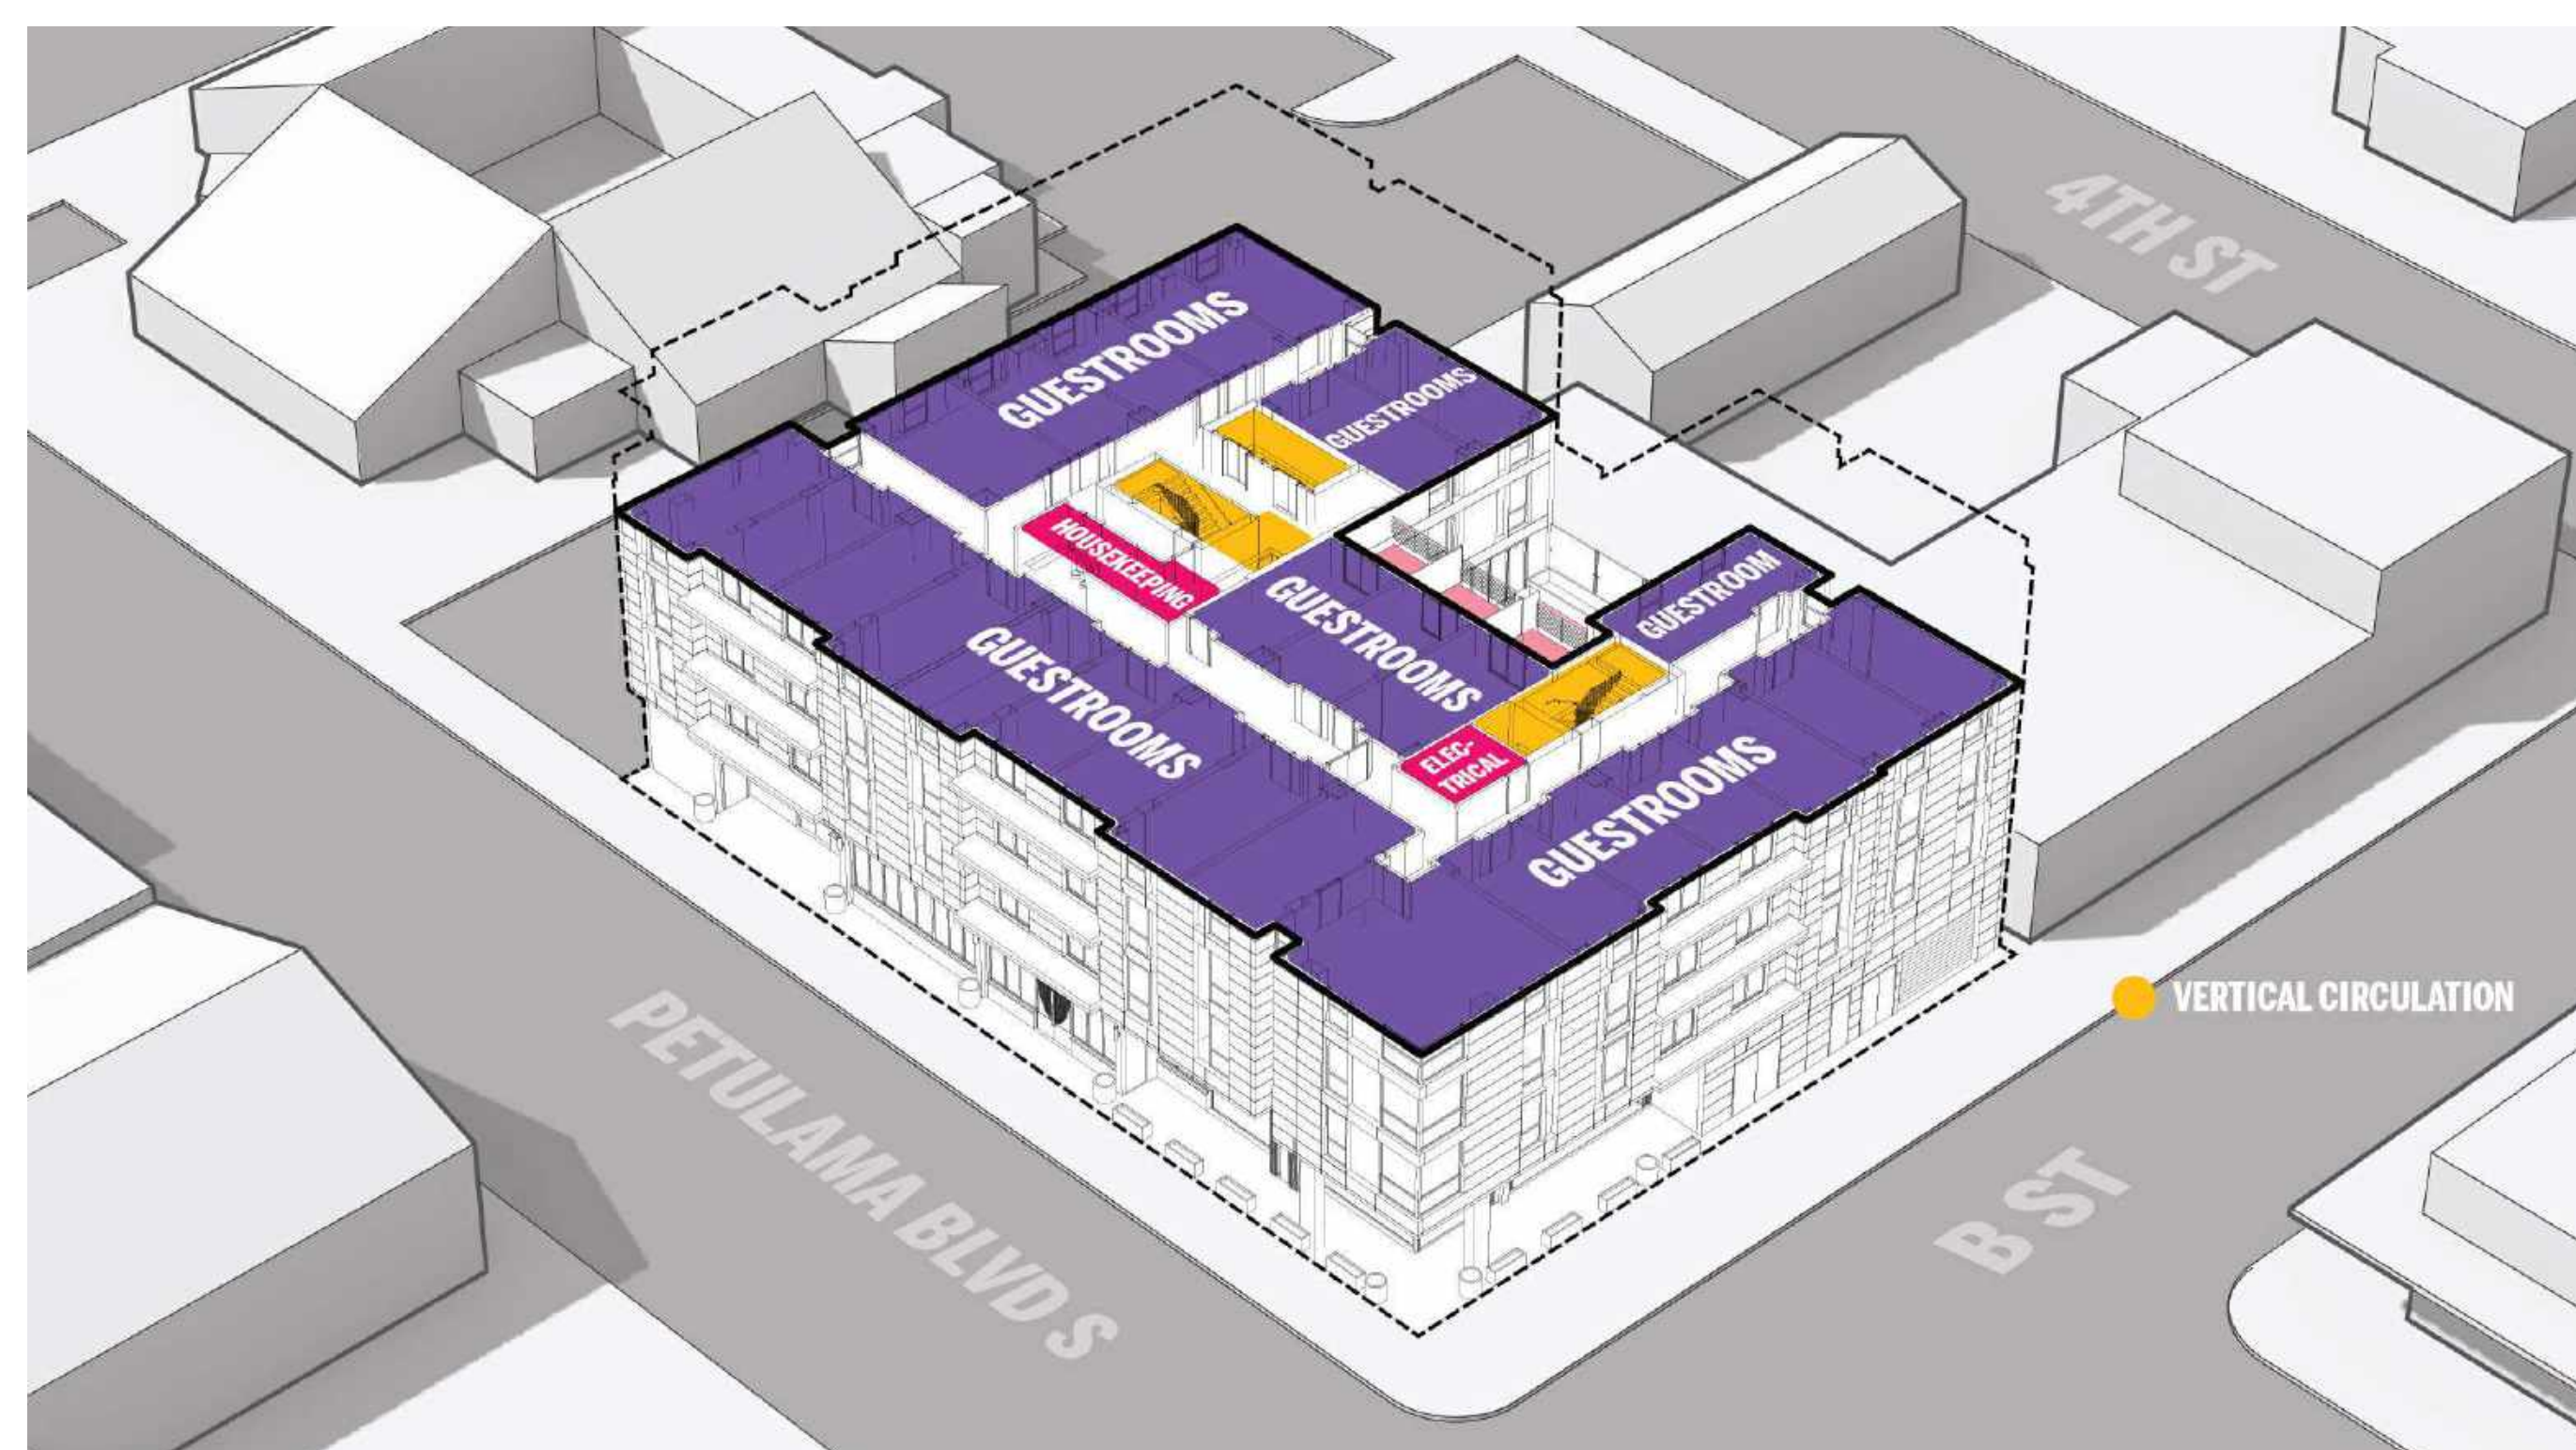

FOURTH FLOOR

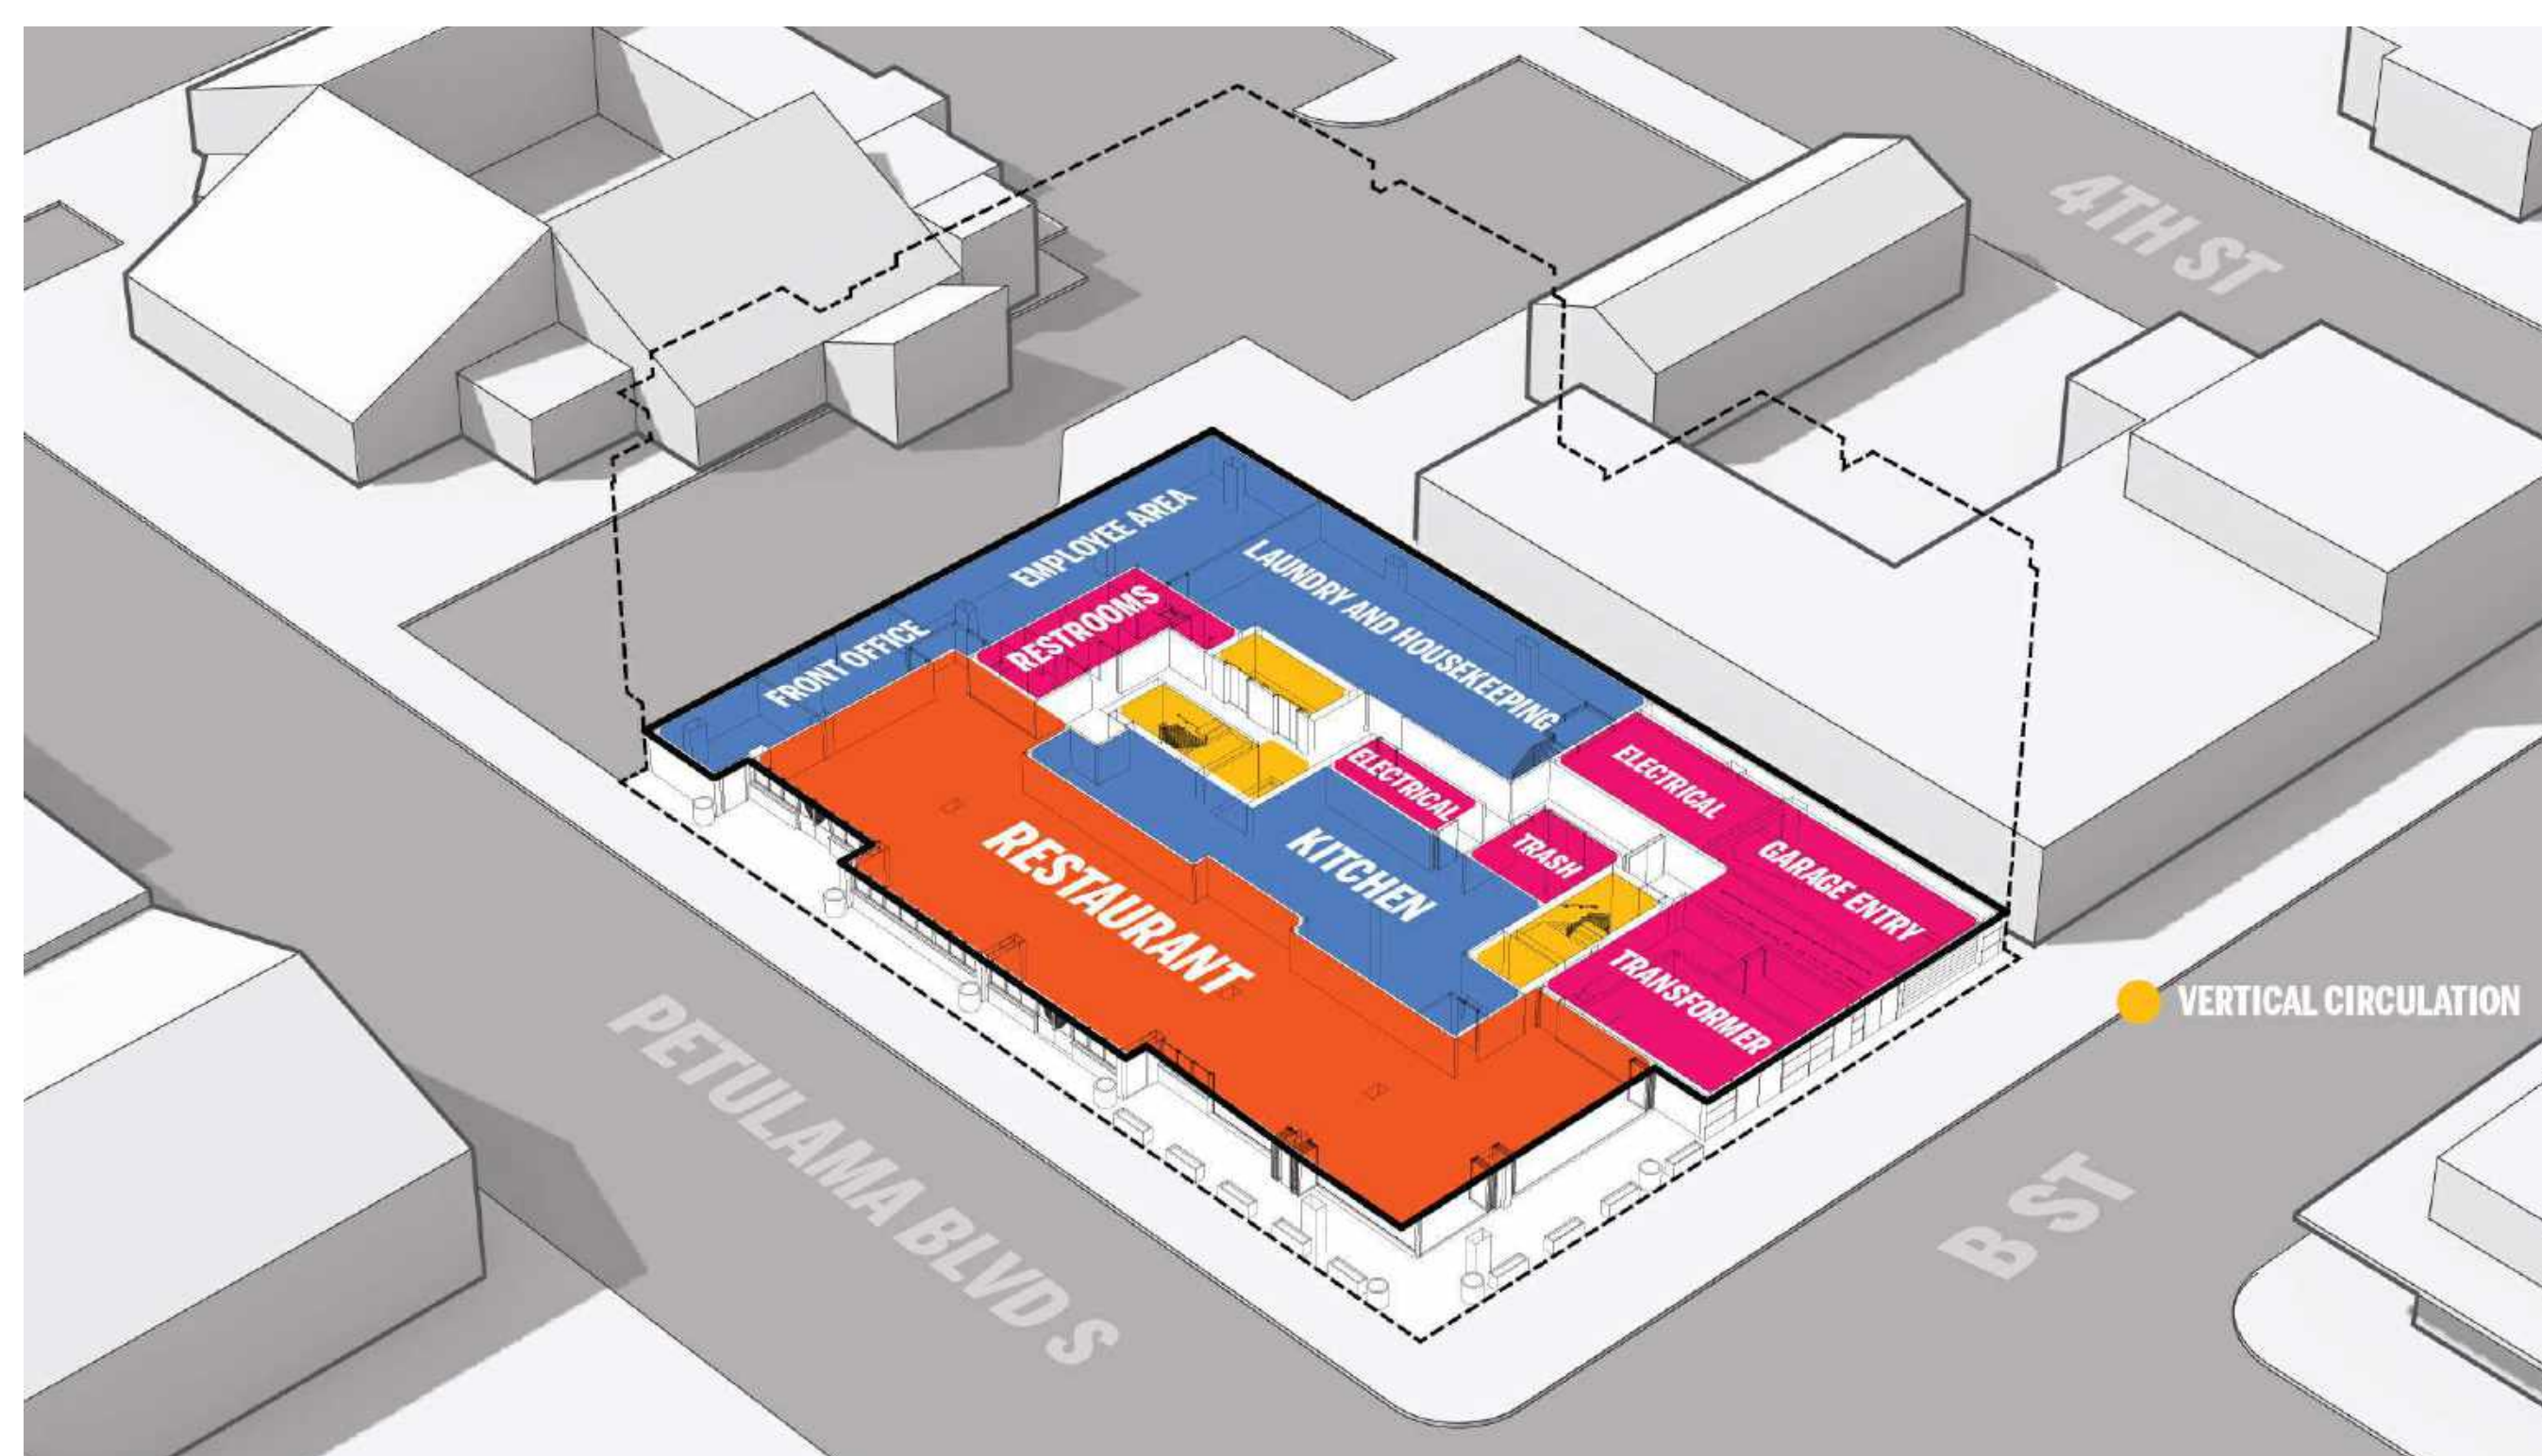

GROUND FLOOR

REVISION HISTORY

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PROGRAM DIAGRAMS

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PROJECT NUMBER 621010	PROJECT ABBREVIATION PH
ORIGINAL ISSUE	DATE 08 SEPTEMBER 2023

EKN Petaluma LLC
EKN APPELLATION HOTEL
2 Petaluma Blvd South
Petaluma, California

FLOOR PLAN GENERAL NOTES

- ALL UNMARKED PARTITIONS ARE TYPE A3. ALL COLUMN FURRING TO BE PARTITION TYPE UNLESS NOTED OTHERWISE.
- ALL WINDOW & DOOR PLAN OPENINGS ARE DIMENSIONED ON AREA PLANS.
- FOR FIRE AND LIFE SAFETY PLANS, REFER TO G1 DRAWINGS.
- ROOF PLAN SHOWN FOR REFERENCE ONLY. REFER TO ROOF PLAN FOR NOTES AND DIMENSIONS.
- REFER TO A2 SERIES DRAWINGS, EXTERIOR ELEVATIONS, A3 BUILDING AND WALL SECTIONS.
- REFER TO A6 SERIES FOR ALL PARTITIONS, DOORS, WINDOWS, AND ACCESSORIES.
- INSTALL APPROPRIATE MANUFACTURED EXPANSION JOINT COVERS AT ALL VISIBLE BUILDING EXPANSION JOINTS. TOP OF COVER OF FLOOR EXPANSION JOINT COVERS TO BE FLUSH WITH TOP OF FINISHED FLOOR.
- ALL PARTITION DIMENSIONS ARE TAKEN FROM THE CENTERLINE OF COLUMNS AND TO THE DRYWALL FACE.
- INSTALL BLOCKING AS REQUIRED TO SUPPORT WALL MOUNTED DEVICES.
- AT ALL SPANDREL GLASS LOCATIONS, FACE OF INTERIOR WALL TO BE CONTINUOUS WITH ADJACENT WALL.
- REFER TO A-S1 FOR INTERIOR EXPANSION JOINT DETAILS.
- GENERAL DIMENSIONS PROVIDED ON FLOOR PLANS AND AREA PLANS DO NOT REFLECT THE ROUGH OPENING DIMENSIONS REQUIRED FOR COORDINATION WITH MASONRY JOINT COURSING. CONTRACTOR IS TO PROVIDE ROUGH OPENING FRAMING DIMENSIONS CONSISTENT WITH ENLARGED ARCHITECTURAL PLAN/SECTION DETAILS (AS SERIES SHEETS), AND WINDOW SCHEDULE DETAILS (AS SERIES); CONTRACTOR TO SUBMIT RFI FOR ANY ROUGH OPENING DIMENSIONS NOT GIVEN IN DETAILING FOR CLARIFICATION REQUIRED.

KEYED NOTES

NUMBER	DESCRIPTION
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FLOOR PLAN LEGEND

SYMBOL	DESCRIPTION
	MATCH LINE
	SHEET REFERENCE
	KEYED NOTE KEYED NOTES ONLY APPLY TO THIS SHEET
	PARTITION TAG REFER TO PARTITION SCHEDULE
	BUILDING SECTION TAG WALL SECTION TAG
	EXTERIOR ELEVATION TAG
	INTERIOR ELEVATION TAG
	PLAN REFERENCE TAG
	ROOM NAME ROOM NUMBER
	SMOKE PARTITION
	1-HOUR FIRE WALL, FIRE BARRIER, OR FIRE PARTITION
	2-HOUR FIRE WALL, FIRE BARRIER, OR FIRE PARTITION
	3-HOUR FIRE WALL, FIRE BARRIER, OR FIRE PARTITION
	SHEAR WALL - RE. STRUCT.
	NEW DOOR WITH DOOR TAG REF DOOR SCHED
	NEW WINDOW WITH WINDOW MARK REF GLAZING ELEVATIONS
	COLUMN GRID DESIGNATIONS

REVISION HISTORY

NO.	DESCRIPTION	DATE


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ARCHITECTURAL - FLOOR PLAN - BASEMENT

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PROJECT NUMBER 621010	PROJECT ABBREVIATION PH
ORIGINAL ISSUE SPAR APPLICATION	DATE 08 SEPTEMBER 2023



SPAR-3.2

SHEET NUMBER

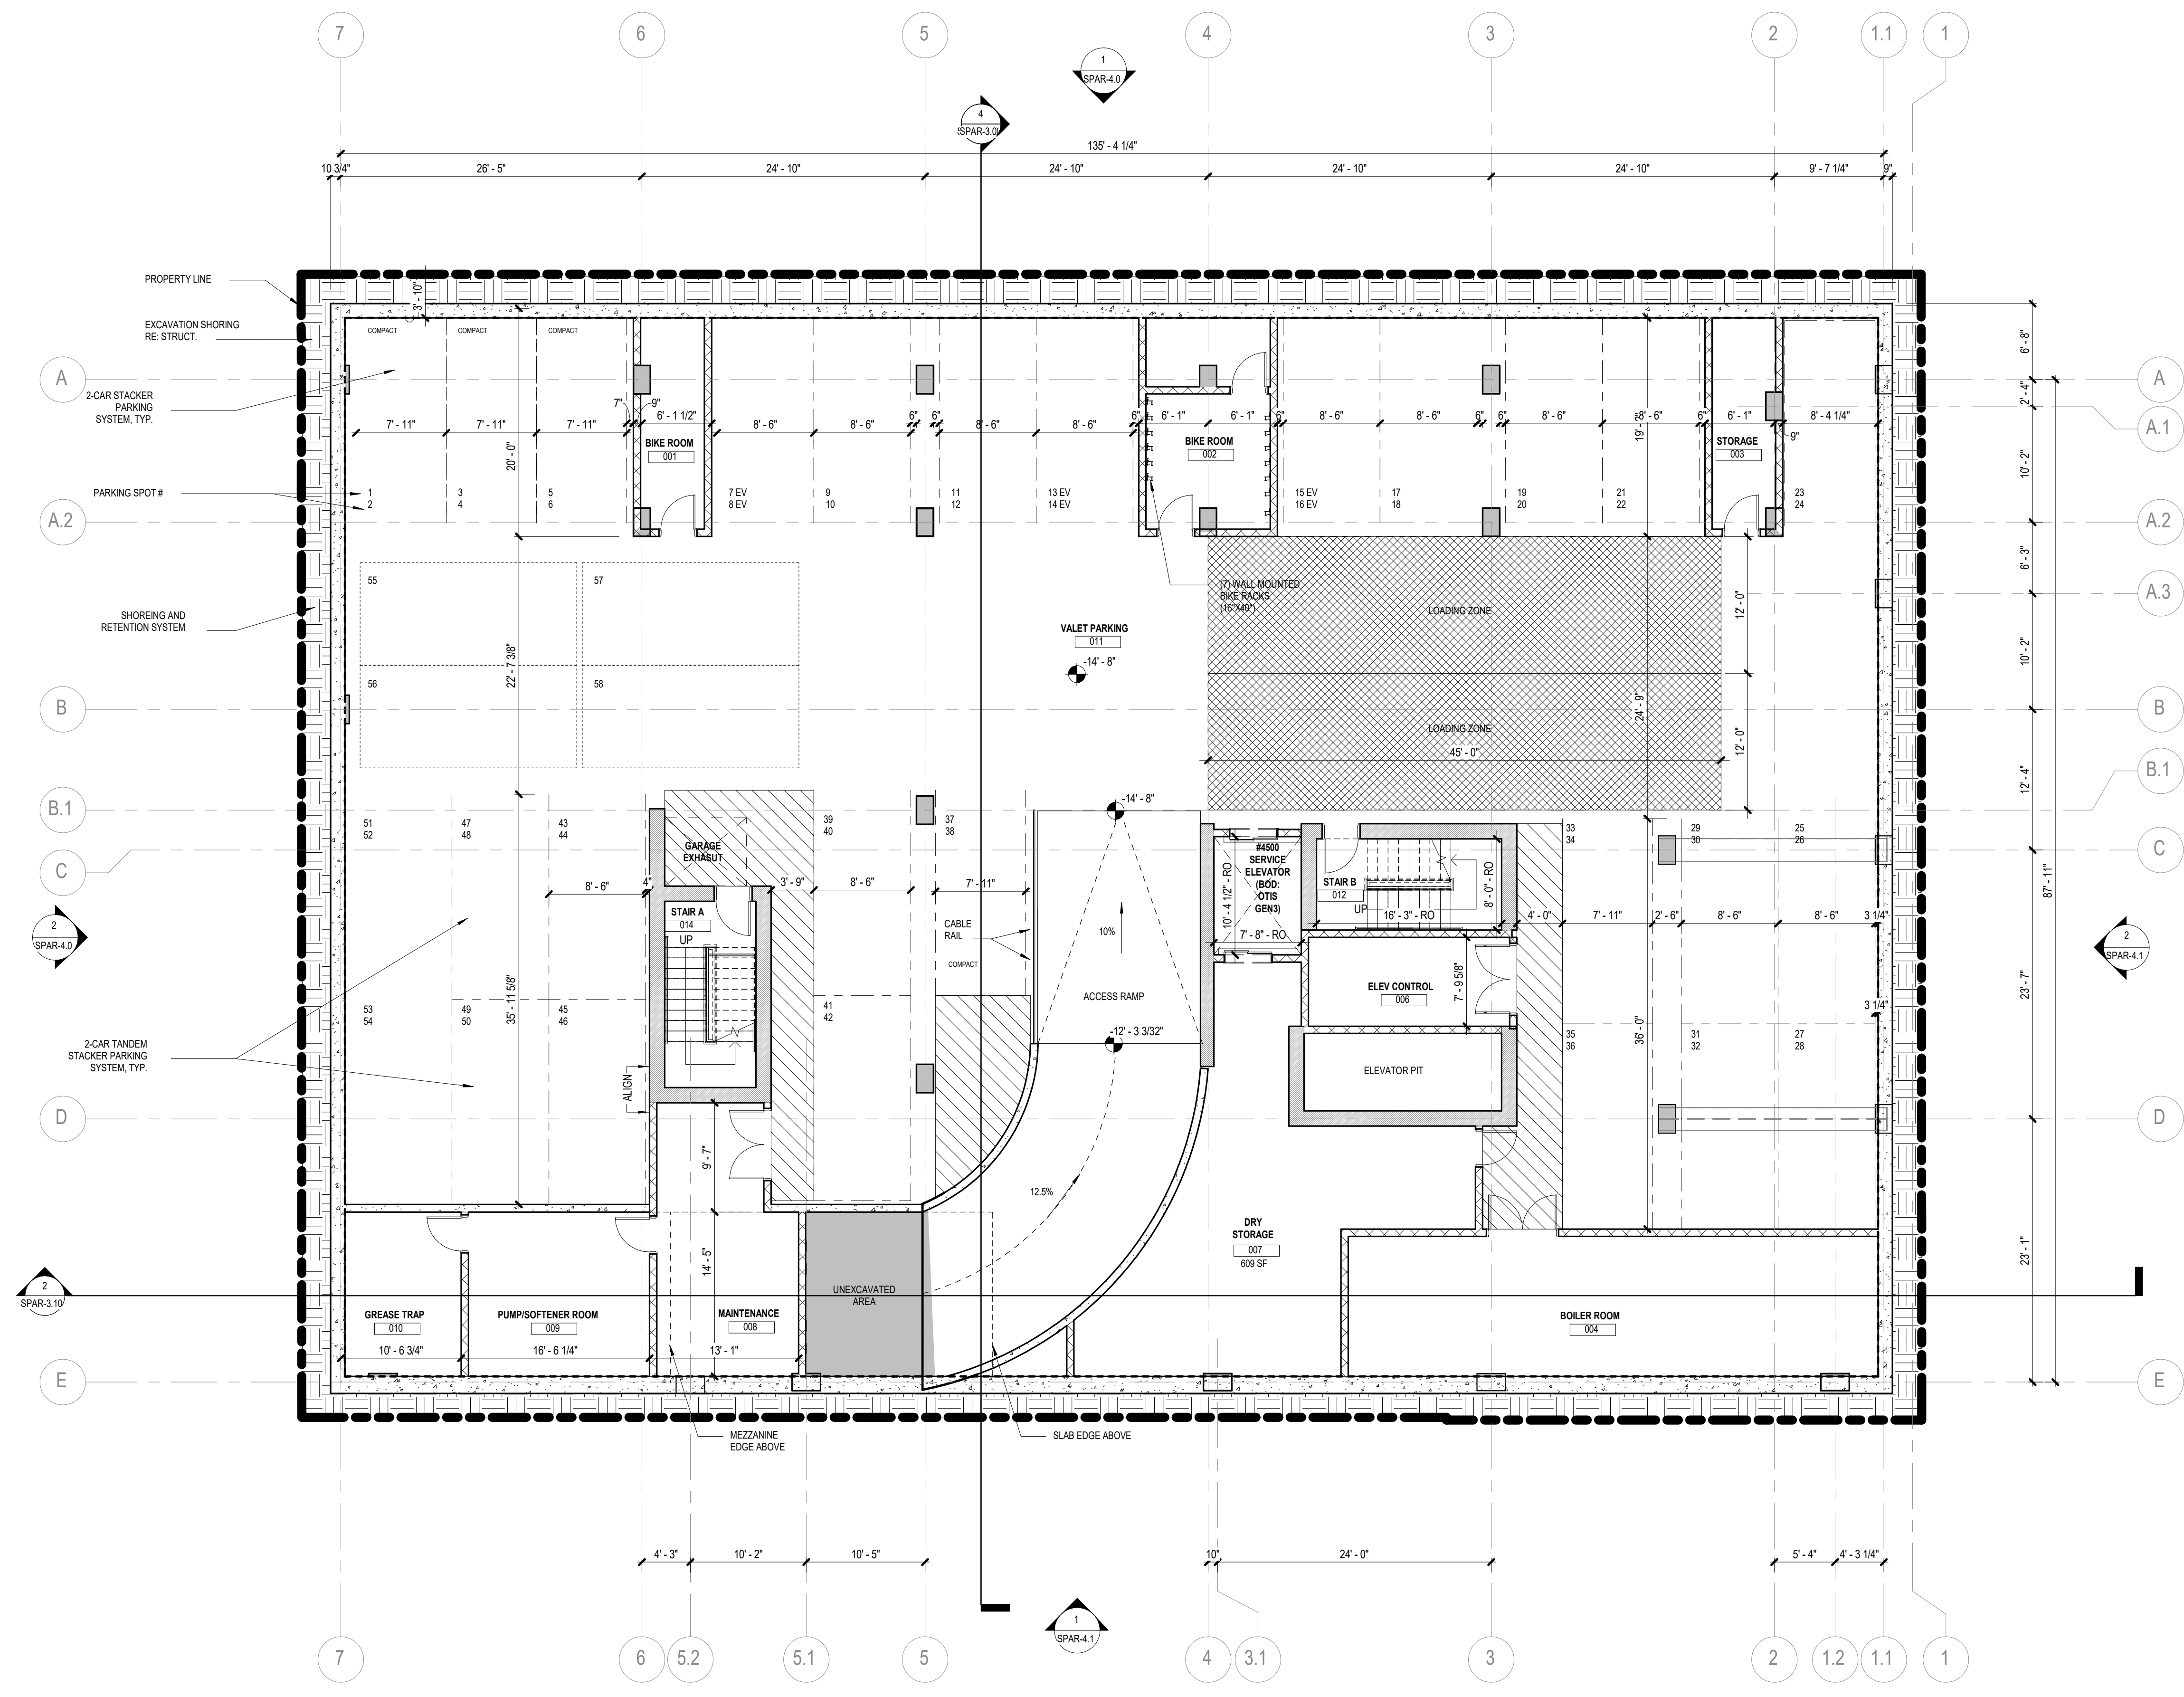

1 FLOOR PLAN - BASEMENT LEVEL
SCALE: 1/8" = 1'-0"

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USER NAME: 9/8/2023 5:13:08 PM
DATE STAMP:

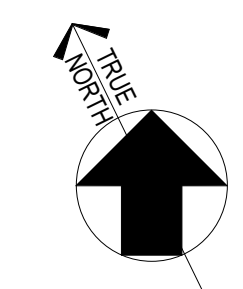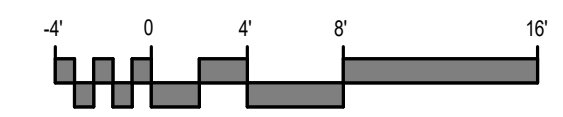

FLOOR PLAN GENERAL NOTES

1. ALL UNMARKED PARTITIONS ARE TYPE A3. ALL COLUMN FURRING TO BE PARTITION TYPE UNLESS NOTED OTHERWISE.
2. ALL WINDOW & DOOR PLAN OPENINGS ARE DIMENSIONED ON AREA PLANS.
3. FOR FIRE AND LIFE SAFETY PLANS, REFER TO G1 DRAWINGS.
4. ROOF PLAN SHOWN FOR REFERENCE ONLY. REFER TO ROOF PLAN FOR NOTES AND DIMENSIONS.
5. REFER TO A2 SERIES DRAWINGS, EXTERIOR ELEVATIONS, A3 BUILDING AND WALL SECTIONS.
6. REFER TO A6 SERIES FOR ALL PARTITIONS, DOORS, WINDOWS, AND ACCESSORIES.
7. INSTALL APPROPRIATE MANUFACTURED EXPANSION JOINT COVERS AT ALL VISIBLE BUILDING EXPANSION JOINTS. TOP OF COVER OF FLOOR EXPANSION JOINT COVERS TO BE FLUSH WITH TOP OF FINISHED FLOOR.
8. ALL PARTITION DIMENSIONS ARE TAKEN FROM THE CENTERLINE OF COLUMNS AND TO THE DRYWALL FACE.
9. INSTALL BLOCKING AS REQUIRED TO SUPPORT WALL MOUNTED DEVICES.
10. AT ALL SPANDREL GLASS LOCATIONS, FACE OF INTERIOR WALL TO BE CONTINUOUS WITH ADJACENT WALL.
11. REFER TO A-S61 FOR INTERIOR EXPANSION JOINT DETAILS.
12. GENERAL DIMENSIONS PROVIDED ON FLOOR PLANS AND AREA PLANS DO NOT REFLECT THE ROUGH OPENING DIMENSIONS REQUIRED FOR COORDINATION WITH MASONRY JOINT COURSING. CONTRACTOR IS TO PROVIDE ROUGH OPENING FRAMING DIMENSIONS CONSISTENT WITH ENLARGED ARCHITECTURAL PLAN/SECTION DETAILS (AS SERIES SHEETS), AND WINDOW SCHEDULE DETAILS (AS SERIES). CONTRACTOR TO SUBMIT RFIs FOR ANY ROUGH OPENING DIMENSIONS NOT GIVEN IN DETAILING FOR CLASSIFICATION REQUIRED.

KEYED NOTES

NUMBER	DESCRIPTION
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FLOOR PLAN LEGEND

SYMBOL	DESCRIPTION
	MATCH LINE
	SHEET REFERENCE
	KEYPAD NOTE KEYPAD NOTES ONLY APPLY TO THIS SHEET
	PARTITION TAG REFER TO PARTITION SCHEDULE
	BUILDING SECTION TAG
	WALL SECTION TAG
	EXTERIOR ELEVATION TAG
	INTERIOR ELEVATION TAG
	PLAN REFERENCE TAG
	ROOM NAME ROOM NUMBER
	SMOKE PARTITION
	1-HOUR FIRE WALL, FIRE BARRIER, OR FIRE PARTITION
	2-HOUR FIRE WALL, FIRE BARRIER, OR FIRE PARTITION
	3-HOUR FIRE WALL, FIRE BARRIER, OR FIRE PARTITION
	SHEAR WALL - RE: STRUCT
	NEW DOOR WITH DOOR TAG REF DOOR SCHED
	NEW WINDOW WITH WINDOW MARK REF GLAZING ELEVATIONS
	COLUMN GRID DESIGNATIONS

EKN Petaluma LLC
EKN APPELLATION HOTEL
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Petaluma, California

REVISION HISTORY


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ARCHITECTURAL - FLOOR PLAN - LEVEL 02



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Author	Checker
PROJECT NUMBER	PROJECT ABBREVIATION
621010	PH
ORIGINAL ISSUE	DATE
SPAR APPLICATION	08 SEPTEMBER 2023

SPAR-3.4
SHEET NUMBER



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USER NAME: 9/8/2023 5:13:18 PM
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1 FLOOR PLAN - LEVEL 02
SCALE: 1/8" = 1'-0"

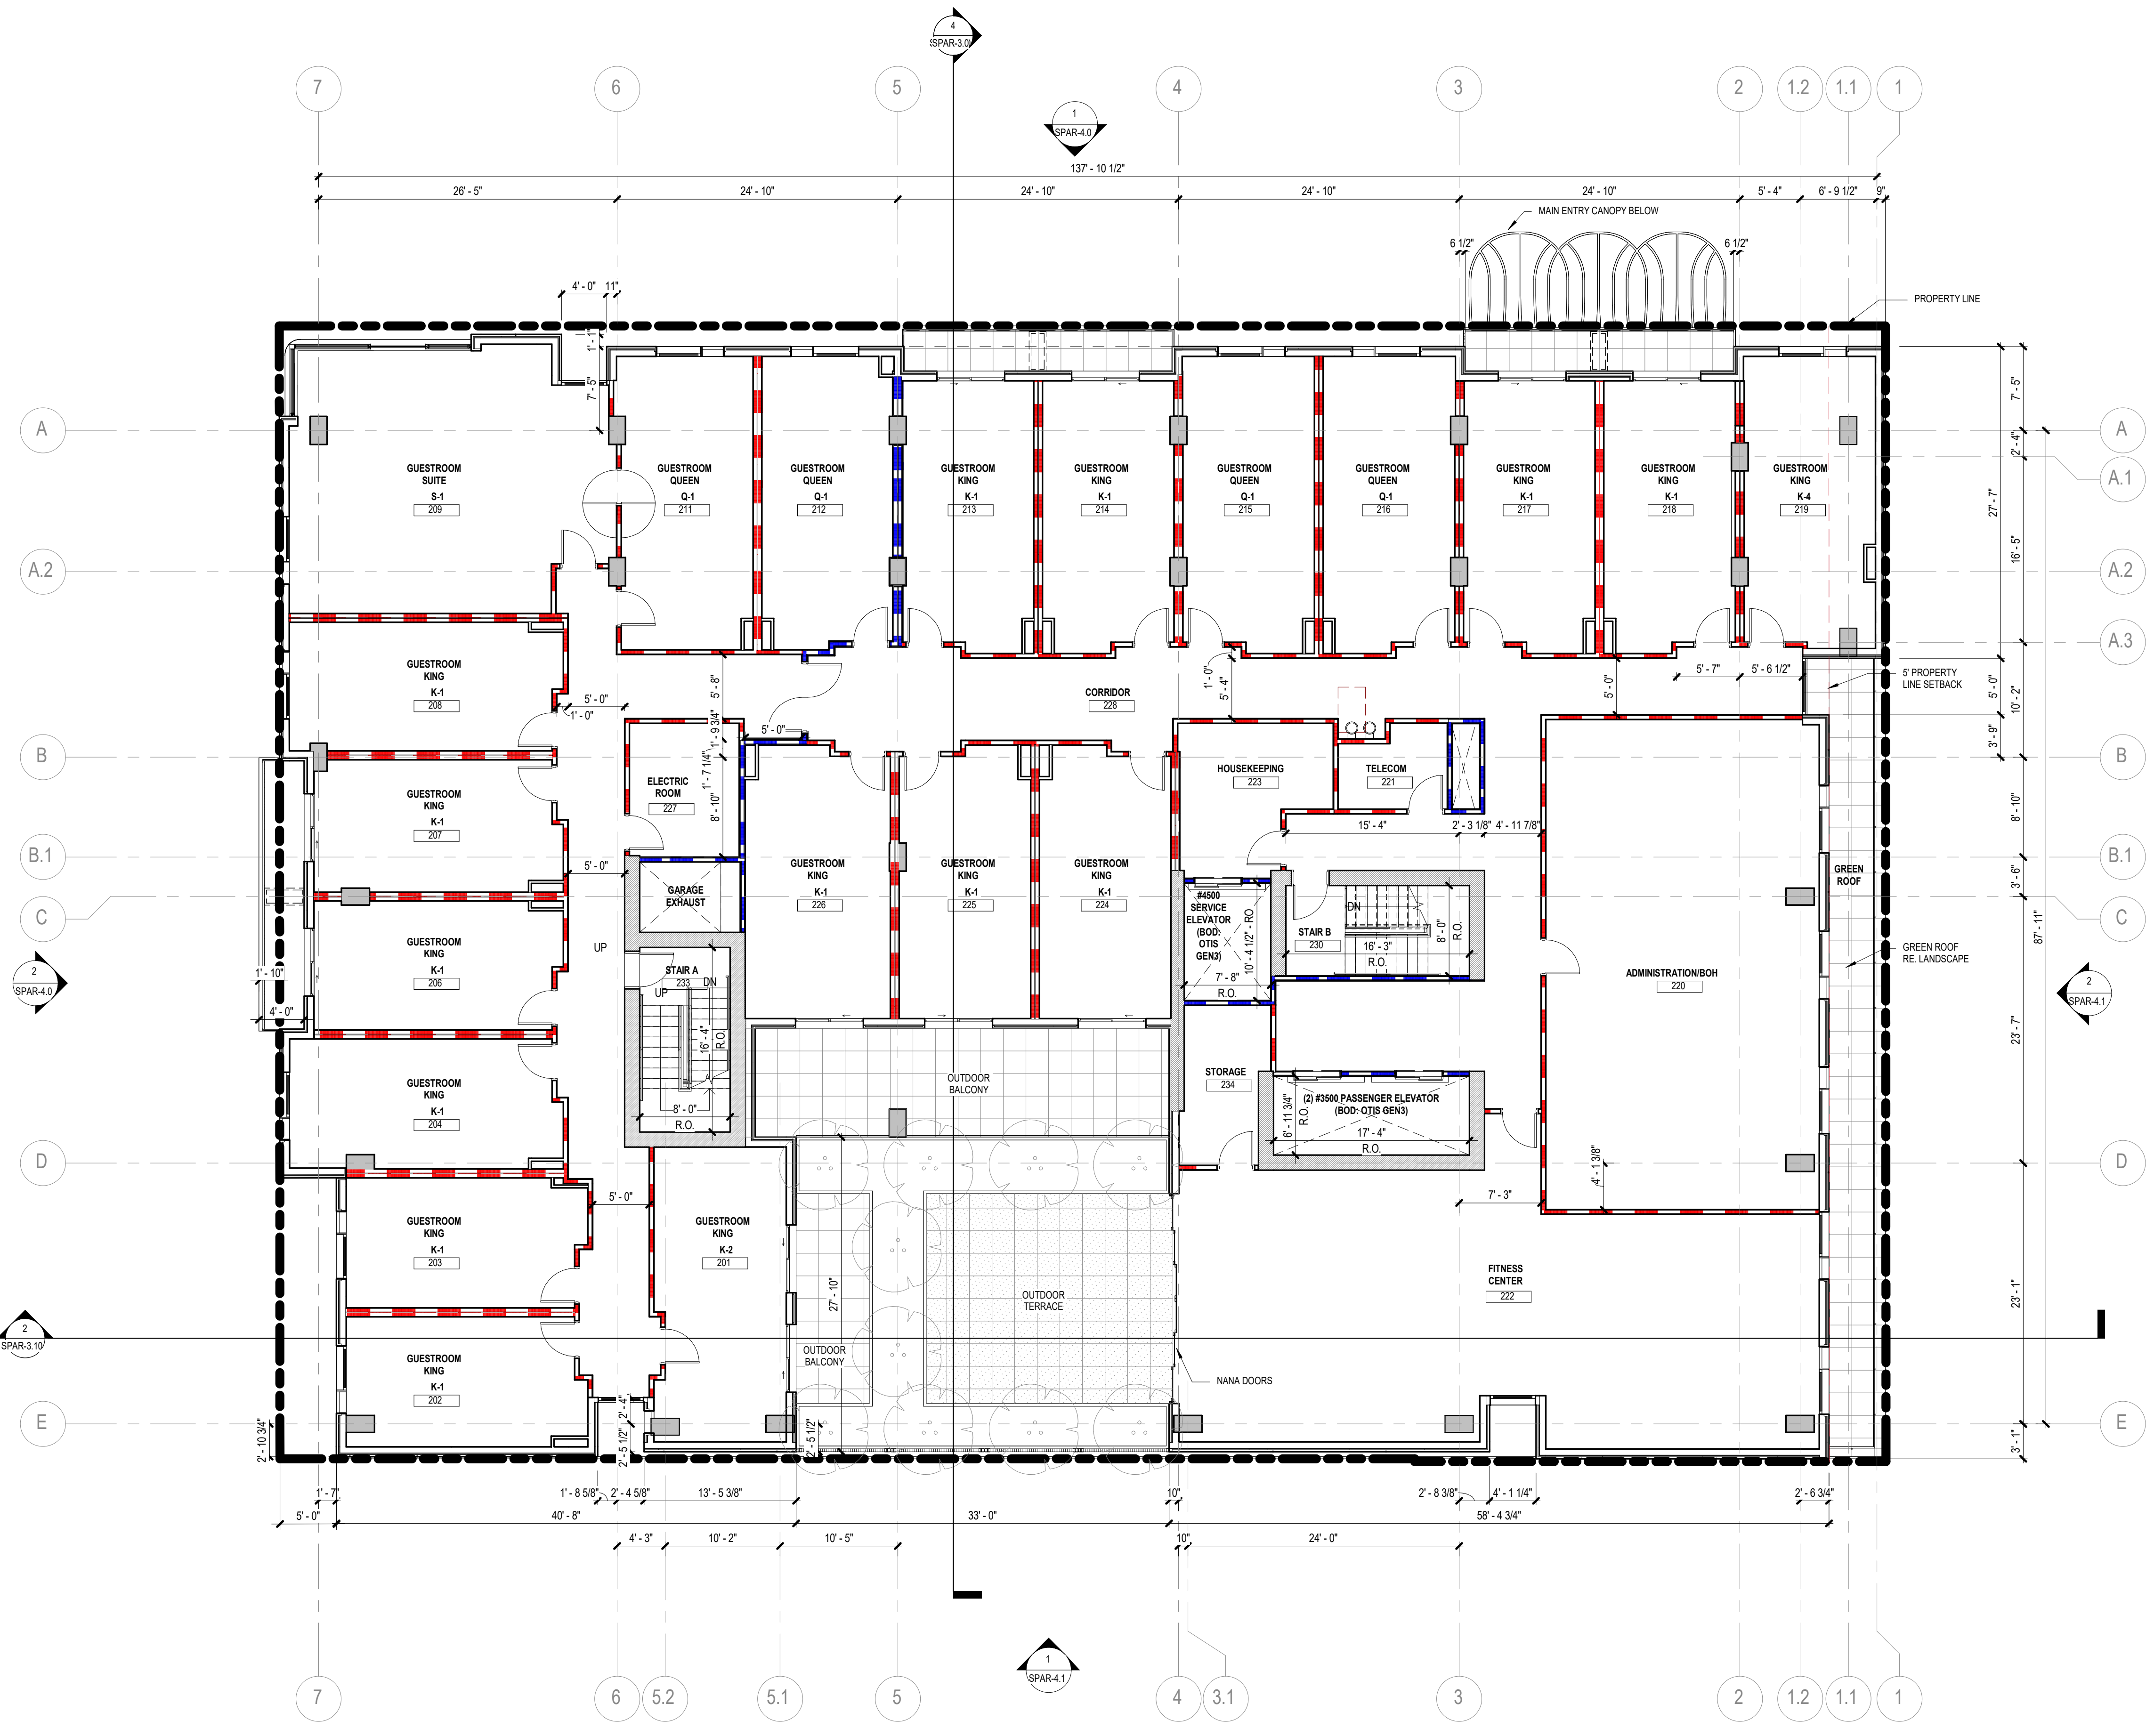

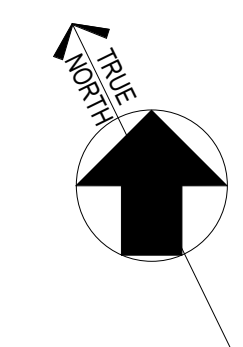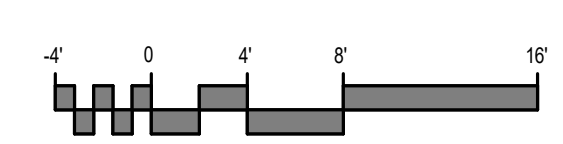EKN Petaluma LLC EKN APPELLATION HOTEL 2 Petaluma Blvd South Petaluma, California

FLOOR PLAN GENERAL NOTES

1. ALL UNMARKED PARTITIONS ARE TYPE A3. ALL COLUMN FURRING TO BE PARTITION TYPE __ UNLESS NOTED OTHERWISE.
2. ALL WINDOW & DOOR PLAN OPENINGS ARE DIMENSIONED ON AREA PLANS.
3. FOR FIRE AND LIFE SAFETY PLANS, REFER TO G1 DRAWINGS.
4. ROOF PLAN SHOWN FOR REFERENCE ONLY. REFER TO ROOF PLAN FOR NOTES AND DIMENSIONS.
5. REFER TO A2 SERIES DRAWINGS, EXTERIOR ELEVATIONS, A3 BUILDING AND WALL SECTIONS.
6. REFER TO A6 SERIES FOR ALL PARTITIONS, DOORS, WINDOWS, AND ACCESSORIES.
7. INSTALL APPROPRIATE MANUFACTURED EXPANSION JOINT COVERS AT ALL VISIBLE BUILDING EXPANSION JOINTS. TOP OF COVER OF FLOOR EXPANSION JOINT COVERS TO BE FLUSH WITH TOP OF FINISHED FLOOR.
8. ALL PARTITION DIMENSIONS ARE TAKEN FROM THE CENTERLINE OF COLUMNS AND TO THE DRYWALL FACE.
9. INSTALL BLOCKING AS REQUIRED TO SUPPORT WALL MOUNTED DEVICES.
10. AT ALL SPANDREL GLASS LOCATIONS, FACE OF INTERIOR WALL TO BE CONTINUOUS WITH ADJACENT WALL.
11. REFER TO A-S01 FOR INTERIOR EXPANSION JOINT DETAILS.
12. GENERAL DIMENSIONS PROVIDED ON FLOOR PLANS AND AREA PLANS DO NOT REFLECT THE ROUGH OPENING DIMENSIONS REQUIRED FOR COORDINATION WITH MASONRY JOINT COURSING. CONTRACTOR IS TO PROVIDE ROUGH OPENING FRAMING DIMENSIONS CONSISTENT WITH ENLARGED ARCHITECTURAL PLAN/SECTION DETAILS (AS SERIES SHEETS), AND WINDOW SCHEDULE DETAILS (AS SERIES). CONTRACTOR TO SUBMIT RFIs FOR ANY ROUGH OPENING DIMENSIONS NOT GIVEN IN DETAILING FOR CLARIFICATION REQUIRED.

KEYED NOTES

NUMBER	DESCRIPTION
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FLOOR PLAN LEGEND

SYMBOL	DESCRIPTION
MATCHLINE	MATCH LINE
REF: 01 / A101	SHEET REFERENCE
04.21.13.13.A01	KEYED NOTE
A1 X	PARTITION TAG
A-301	BUILDING SECTION TAG
A-201	EXTERIOR ELEVATION TAG
A-211	INTERIOR ELEVATION TAG
A-431	PLAN REFERENCE TAG
ROOM NAME	ROOM NAME
101	ROOM NUMBER
SMOKE PARTITION	SMOKE PARTITION
1-HOUR FIRE WALL, FIRE BARRIER, OR FIRE PARTITION	1-HOUR FIRE WALL, FIRE BARRIER, OR FIRE PARTITION
2-HOUR FIRE WALL, FIRE BARRIER, OR FIRE PARTITION	2-HOUR FIRE WALL, FIRE BARRIER, OR FIRE PARTITION
3-HOUR FIRE WALL, FIRE BARRIER, OR FIRE PARTITION	3-HOUR FIRE WALL, FIRE BARRIER, OR FIRE PARTITION
SHEAR WALL - RE-STRUCT	SHEAR WALL - RE-STRUCT
NEW DOOR WITH DOOR TAG REF DOOR SCHED	NEW DOOR WITH DOOR TAG REF DOOR SCHED
NEW WINDOW WITH WINDOW MARK REF GLAZING ELEVATIONS	NEW WINDOW WITH WINDOW MARK REF GLAZING ELEVATIONS
COLUMN GRID DESIGNATIONS	COLUMN GRID DESIGNATIONS

REVISION HISTORY

REVISION	DESCRIPTION	DATE
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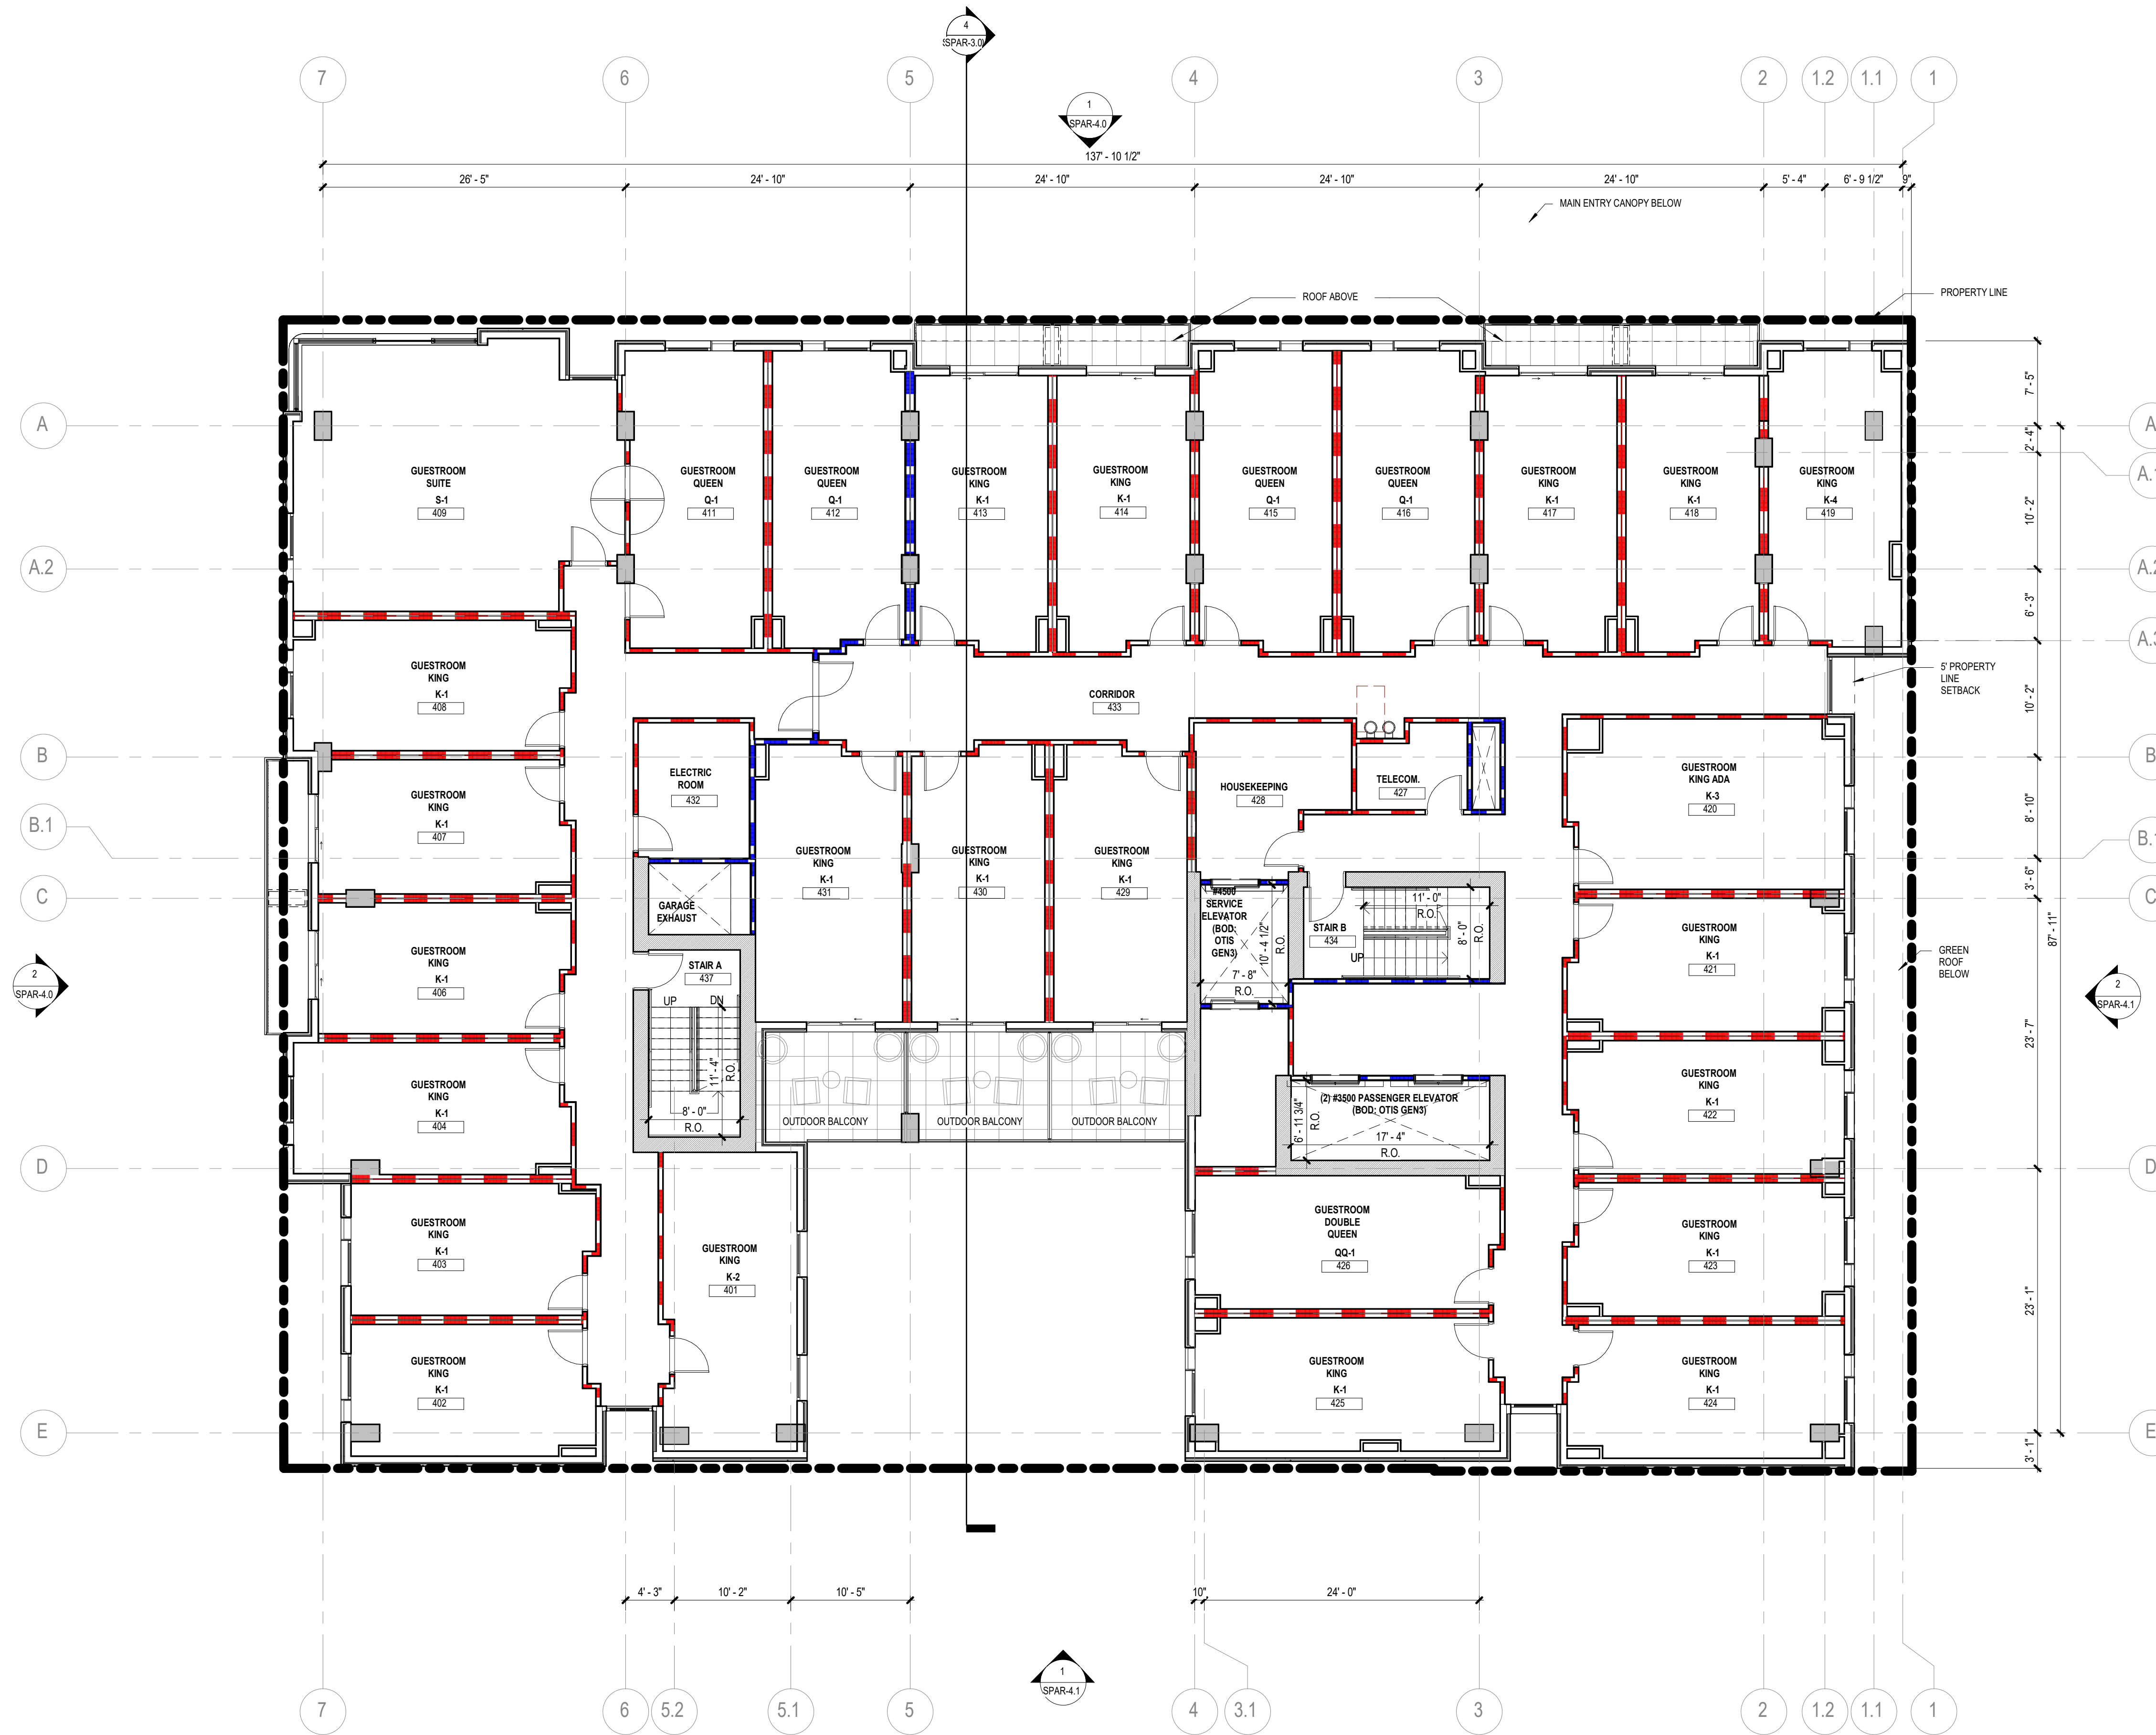
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ARCHITECTURAL - FLOOR PLAN - LEVEL 04

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ORIGINAL ISSUE SPAR APPLICATION	DATE 08 SEPTEMBER 2023



SPAR-3.6

SHEET NUMBER



1 FLOOR PLAN - LEVEL 04

SCALE: 1/8" = 1'-0"

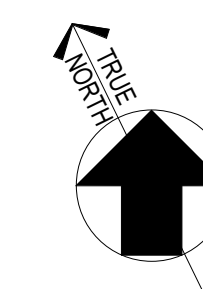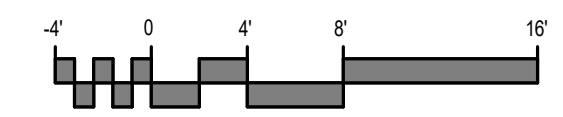

FLOOR PLAN GENERAL NOTES

- ALL UNMARKED PARTITIONS ARE TYPE A3. ALL COLUMN FURRING TO BE PARTITION TYPE UNLESS NOTED OTHERWISE.
- ALL WINDOW & DOOR PLAN OPENINGS ARE DIMENSIONED ON AREA PLANS.
- FOR FIRE AND LIFE SAFETY PLANS, REFER TO G1 DRAWINGS.
- ROOF PLAN SHOWN FOR REFERENCE ONLY. REFER TO ROOF PLAN FOR NOTES AND DIMENSIONS.
- REFER TO A2 SERIES DRAWINGS, EXTERIOR ELEVATIONS, A3 BUILDING AND WALL SECTIONS.
- REFER TO A6 SERIES FOR ALL PARTITIONS, DOORS, WINDOWS, AND ACCESSORIES.
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- ALL PARTITION DIMENSIONS ARE TAKEN FROM THE CENTERLINE OF COLUMNS AND TO THE DRYWALL FACE.
- INSTALL BLOCKING AS REQUIRED TO SUPPORT WALL MOUNTED DEVICES.
- AT ALL SPANDREL GLASS LOCATIONS, FACE OF INTERIOR WALL TO BE CONTINUOUS WITH ADJACENT WALL.
- REFER TO A-S61 FOR INTERIOR EXPANSION JOINT DETAILS.
- GENERAL DIMENSIONS PROVIDED ON FLOOR PLANS AND AREA PLANS DO NOT REFLECT THE ROUGH OPENING DIMENSIONS REQUIRED FOR COORDINATION WITH MASONRY JOINT COURSING. CONTRACTOR IS TO PROVIDE ROUGH OPENING FRAMING DIMENSIONS CONSISTENT WITH ENLARGED ARCHITECTURAL PLAN/SECTION DETAILS (AS SERIES SHEETS), AND WINDOW SCHEDULE DETAILS (AS SERIES). CONTRACTOR TO SUBMIT RFIs FOR ANY ROUGH OPENING DIMENSIONS NOT GIVEN IN DETAILING FOR CLARIFICATION REQUIRED.

KEYED NOTES

NUMBER	DESCRIPTION
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FLOOR PLAN LEGEND

SYMBOL	DESCRIPTION
	MATCHLINE
	SHEET REFERENCE
	KEYPAD NOTE
	PARTITION TAG
	BUILDING SECTION TAG
	WALL SECTION TAG
	EXTERIOR ELEVATION TAG
	INTERIOR ELEVATION TAG
	PLAN REFERENCE TAG
	ROOM NAME
	ROOM NUMBER
	SMOKE PARTITION
	1-HOUR FIRE-RATED WALL, FIRE BARRIER, OR FIRE PARTITION
	2-HOUR FIRE-RATED WALL, FIRE BARRIER, OR FIRE PARTITION
	3-HOUR FIRE-RATED WALL, FIRE BARRIER, OR FIRE PARTITION
	SHEAR WALL - RE: STRUCT
	NEW DOOR WITH DOOR TAG REF DOOR SCHED
	NEW WINDOW WITH WINDOW MARK REF GLAZING ELEVATIONS
	COLUMN GRID DESIGNATIONS

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EKN APPELLATION HOTEL
2 Petaluma Blvd South
Petaluma, California

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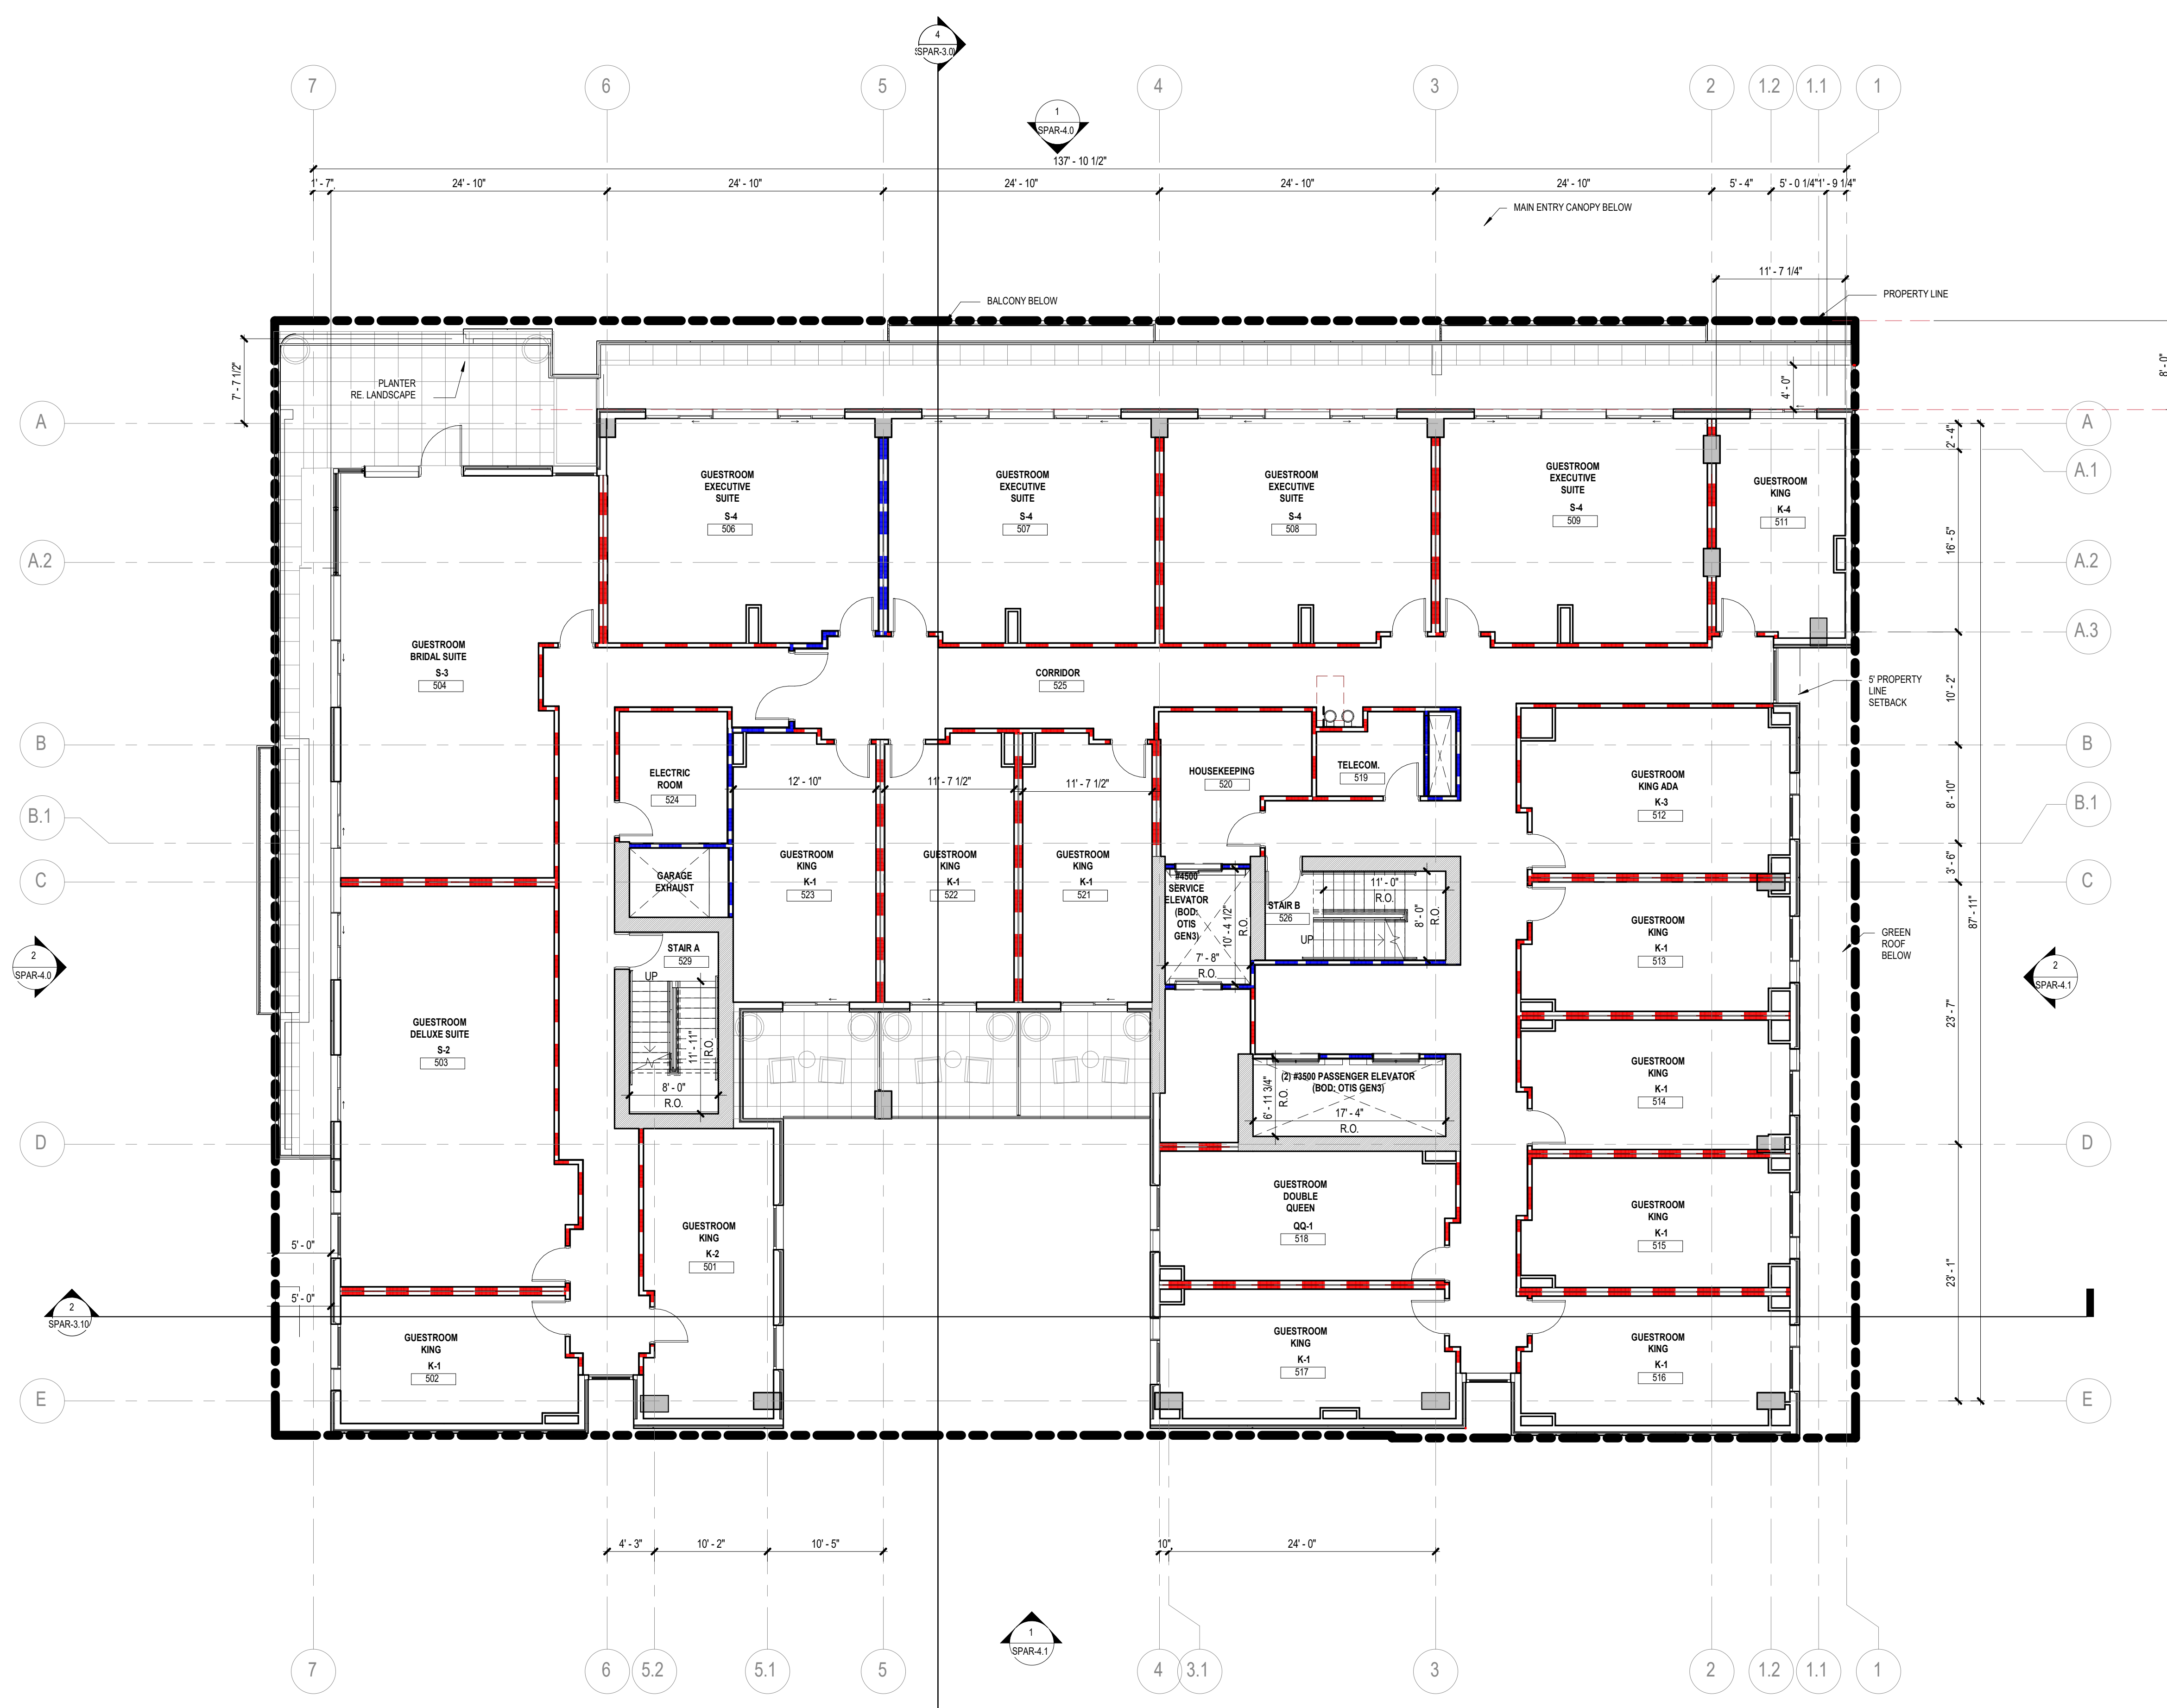
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ARCHITECTURAL - FLOOR PLAN - LEVEL 05



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PROJECT NUMBER 621010	PROJECT ABBREVIATION PH
ORIGINAL ISSUE SPAR APPLICATION	DATE 08 SEPTEMBER 2023

SPAR-3.7
SHEET NUMBER



1 FLOOR PLAN - LEVEL 05
SCALE: 1/8" = 1'-0"

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STRUCTURE BUEHLER ENGINEERING 5 Third Street Suite 1125 San Francisco, CA 94103 213 684 3408	FF&E DH-COMPANIES 7591 Coppermine Drive Manassas, VA, 20109
INTERIORS SIXTEEN FIFTY 7509 Grand Ave La Jolla, CA 92037 858 454 6909	CIVIL N CONSULTING ENGINEERS 4 Park Plz Irvine, CA 92614 949 369 1161

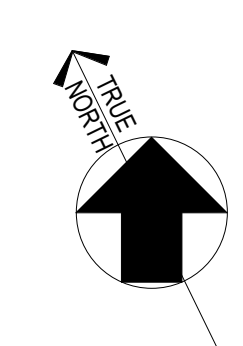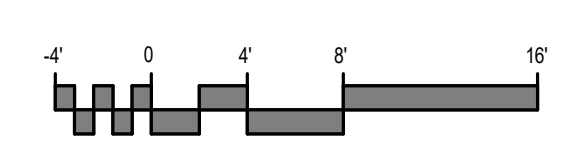CEILING PLAN GENERAL NOTES

- ALL CEILING HEIGHTS IN "CORRIDORS/HALLS" SHALL BE 9'-0" AFF UNLESS NOTED OTHERWISE.
- ALL ACoustICAL CEILING GRIDS TO BE CENTERED WITHIN ROOM UNLESS NOTED OTHERWISE.
- ALL CORRIDOR ACoustICAL CEILING GRIDS TO BE CENTERED WITHIN THE CORRIDOR UNLESS NOTED OTHERWISE.
- ALL 'CAN' LIGHT FIXTURES TO BE CENTERED WITHIN ACoustICAL CEILING TILES.
- ALL 'CAN' LIGHT FIXTURES IN TOILET ROOMS TO BE CENTERED.
- ALL GYP. BOARD FURRODOWN TO BE 7'-2" AFF. REFER TO A-2 SERIES FOR INTERIOR ELEVATIONS.
- PROVIDE CONTINUOUS R19 BATT INSULATION ABOVE PARKING AREA CEILING EXCEPT AT LOCATIONS DESIGNATED "INSULATED CEILING TILES".
- ALL CEILING HEIGHTS IN "TOILET ROOMS" SHALL BE 9'-0" AFF UNLESS NOTED OTHERWISE.
- ALL CEILING HEIGHTS NOT MARKED SHALL BE 9'-0" AFF.
- ALL DIFFUSERS AND AIR GRILLES SHALL BE PAINTED TO MATCH THE WALL OR CEILING THEY ARE INSTALLED IN U.N.O.

KEYED NOTES

NUMBER	DESCRIPTION
A.1	
A.2	
A.3	
B.1	
C	
D	
E	

EXTERIOR CEILING PLAN LEGEND

SYMBOL	DESCRIPTION
o	XA - EXTERIOR DOWNLIGHT
o	XB - EXTERIOR WALL WASHER
D	XC - EXTERIOR EGRESS SCENCE
o	DA - EXTERIOR SCENCE A
o	DB - EXTERIOR SCENCE B
---	DC - LINEAR LIGHTING

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2 Petaluma Blvd South
Petaluma, California

REVISION HISTORY


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INTERIM REVIEW
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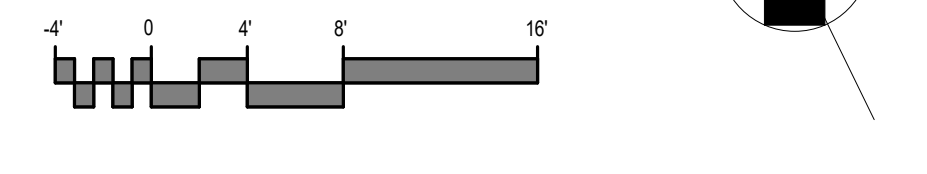
ARCHITECTURAL - REFLECTED
 CEILING PLAN - LEVEL 01

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Author	Checker
PROJECT NUMBER	PROJECT ABBREVIATION
621010	PH
ORIGINAL ISSUE	DATE
SPAR APPLICATION	08 SEPTEMBER 2023

SPAR-3.11
SHEET NUMBER



1 REFLECTED CEILING PLAN - LEVEL 01
SCALE: 1/8" = 1'-0"

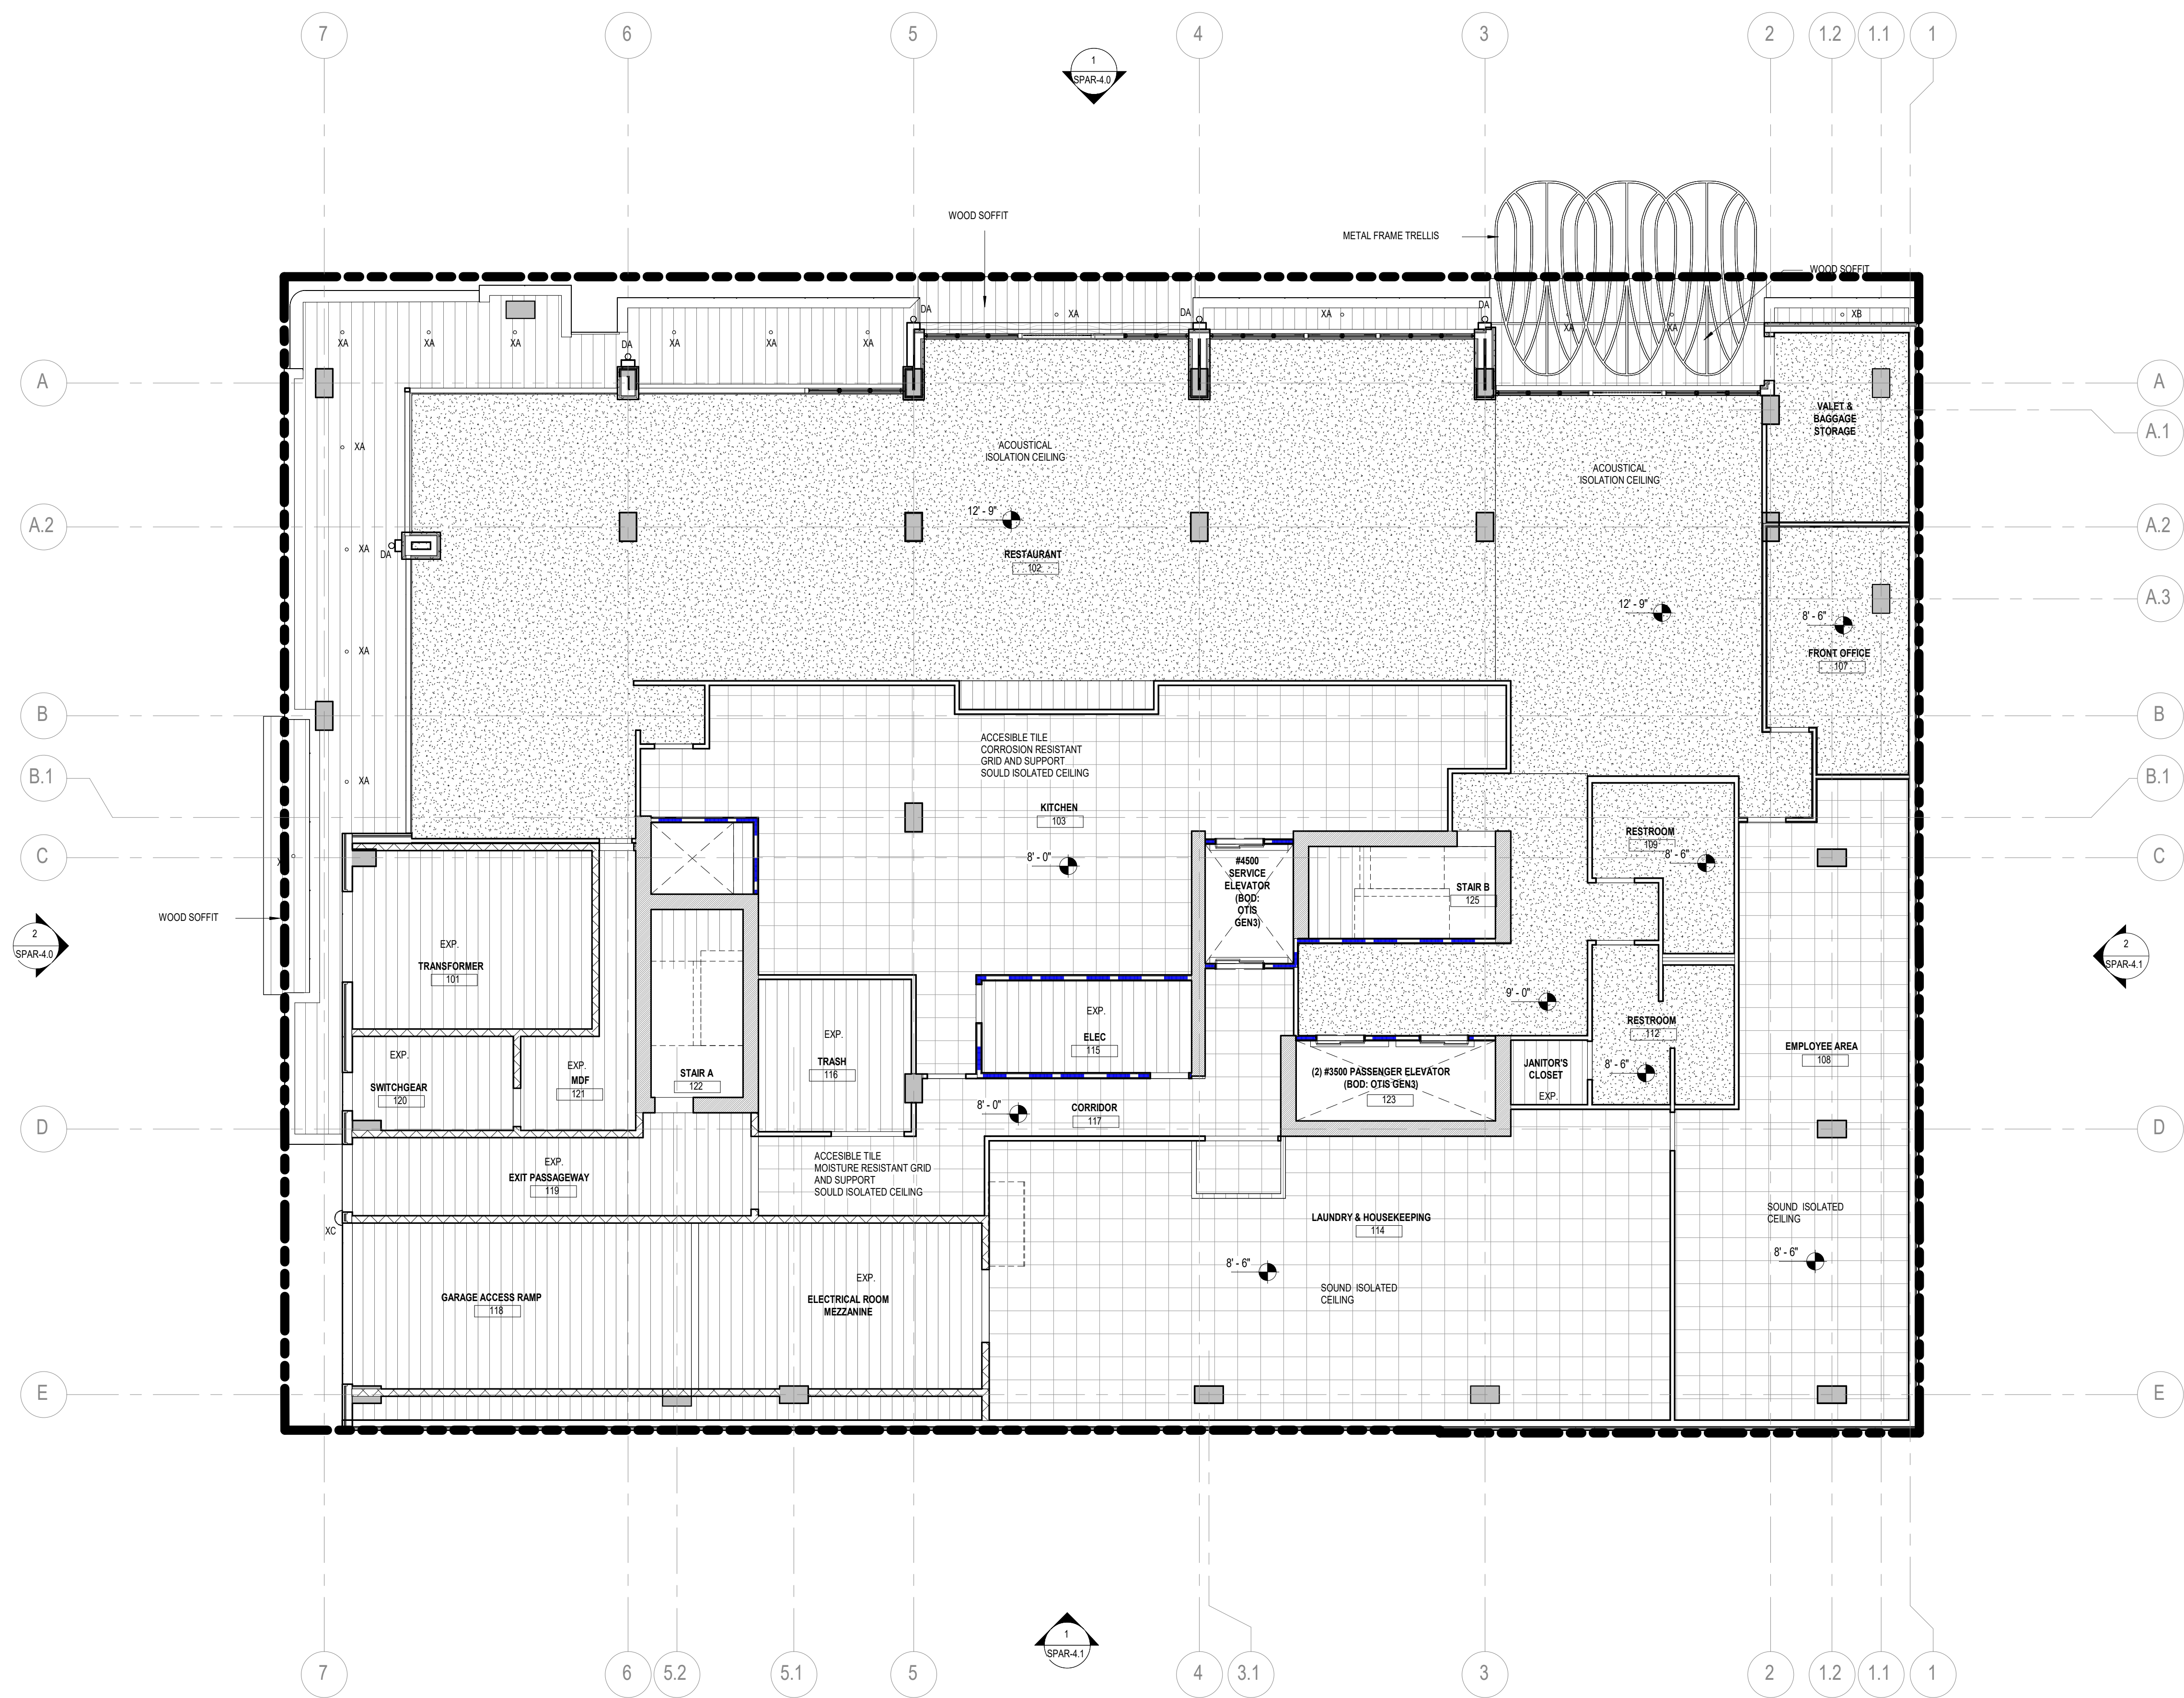

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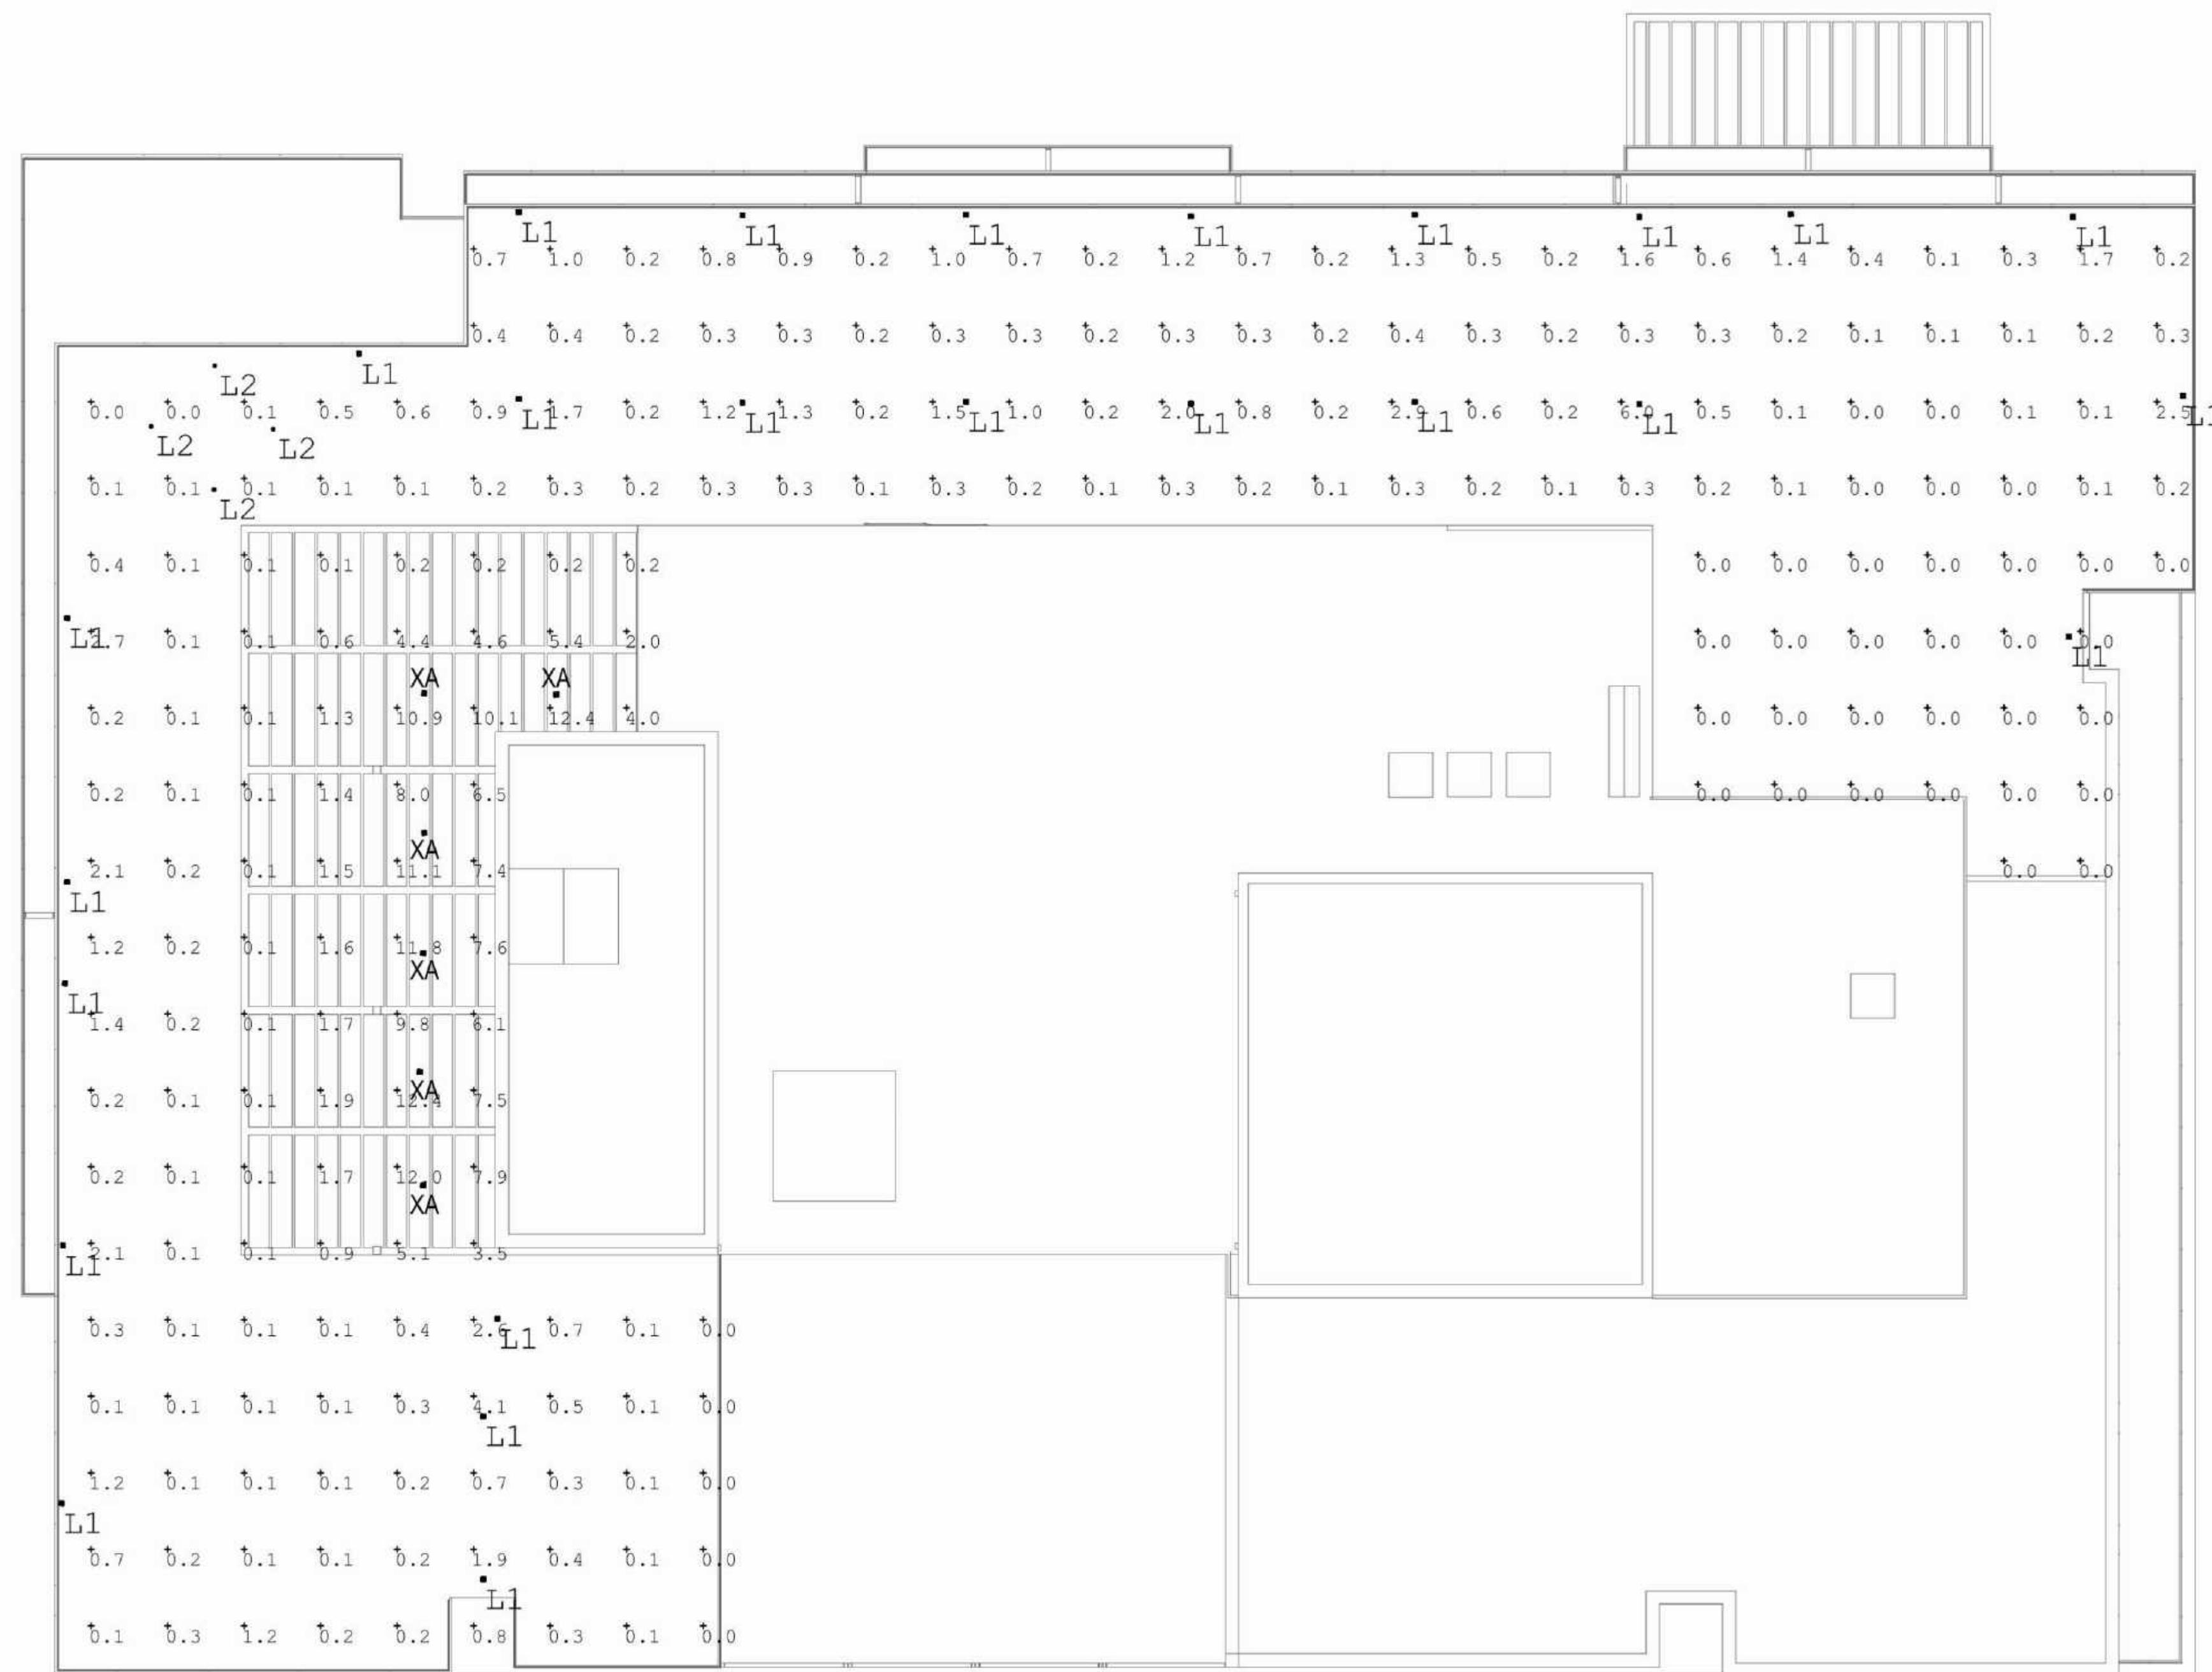
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Calculation Summary

Label	CalcType	Units	Avg	Max	Min	Avg/Min	Max/Min
rooftop area	Illuminance	Fc	1.12	12.4	0.0	N.A.	N.A.

Luminaire Schedule

Symbol	Qty	Label	Arrangement	Description	Tag	LLF	Luminaire Lumens	Luminaire Watts	Total Watts
☐	26	7380	Single	CRT2003060919-002, Model 7380	L1	0.850	630	13.3	345.8
☐	4	2134x212	Single	213 4x 212		0.850	144	5	20
☐	6	B3SD-09X3-30KS-40-S-MOD	Single	CRT1809251256-004-001-P7, Model B3SDF-20X3-30KS-40-NCIC-UNV-D6E MOD to 9W		0.850	947	9	54

REVISION HISTORY

REVISION DESCRIPTION DATE
PROFESSIONAL SEAL
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PHOTOMETRIC PLAN - ROOF

DRAWN BY CHECKED BY
Author Checker
PROJECT NUMBER PROJECT ABBREVIATION
621010 PH
ORIGINAL ISSUE DATE
SPAR APPLICATION 08 SEPTEMBER 2023

SPAR-6.1

SHEET NUMBER

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