BURIED UTILITIES ARE SHOWN AS INDICATED ON RECORD MAPS FURNISHED BY OTHERS AND ASSUMES NO LIABILITY FOR THE ACCURACY OF THOSE RECORDS, OR FOR THE FINAL LOCATION OF EXISTING UTILITIES IN AREAS CRITICAL TO DESIGN.

Need a plan sheet with clearing limits and significant trees to be retained with tree protection fencing specifications.


How is the required open space being provided? (POMC 20.127.350)


LEGEND: COUNTY LIDAR CONTOUR ---- WSE TOPO MINOR CONTOUR PROPOSED MAJOR CONTOUR PROPOSED MINOR CONTOUR APPLICANTS PARCEL LINES **NEIGHBORING PARCELS EXISTING GRAVEL EXISTING ASPHALT** PROPOSED ASPHALT

CONTOUR APARTMENTS REZONE

COVER SHEET

A PORTION OF SECTION 35, TOWNSHIP 24 NORTH, RANGE 1E, W.M. KITSAP COUNTY, WASHINGTON

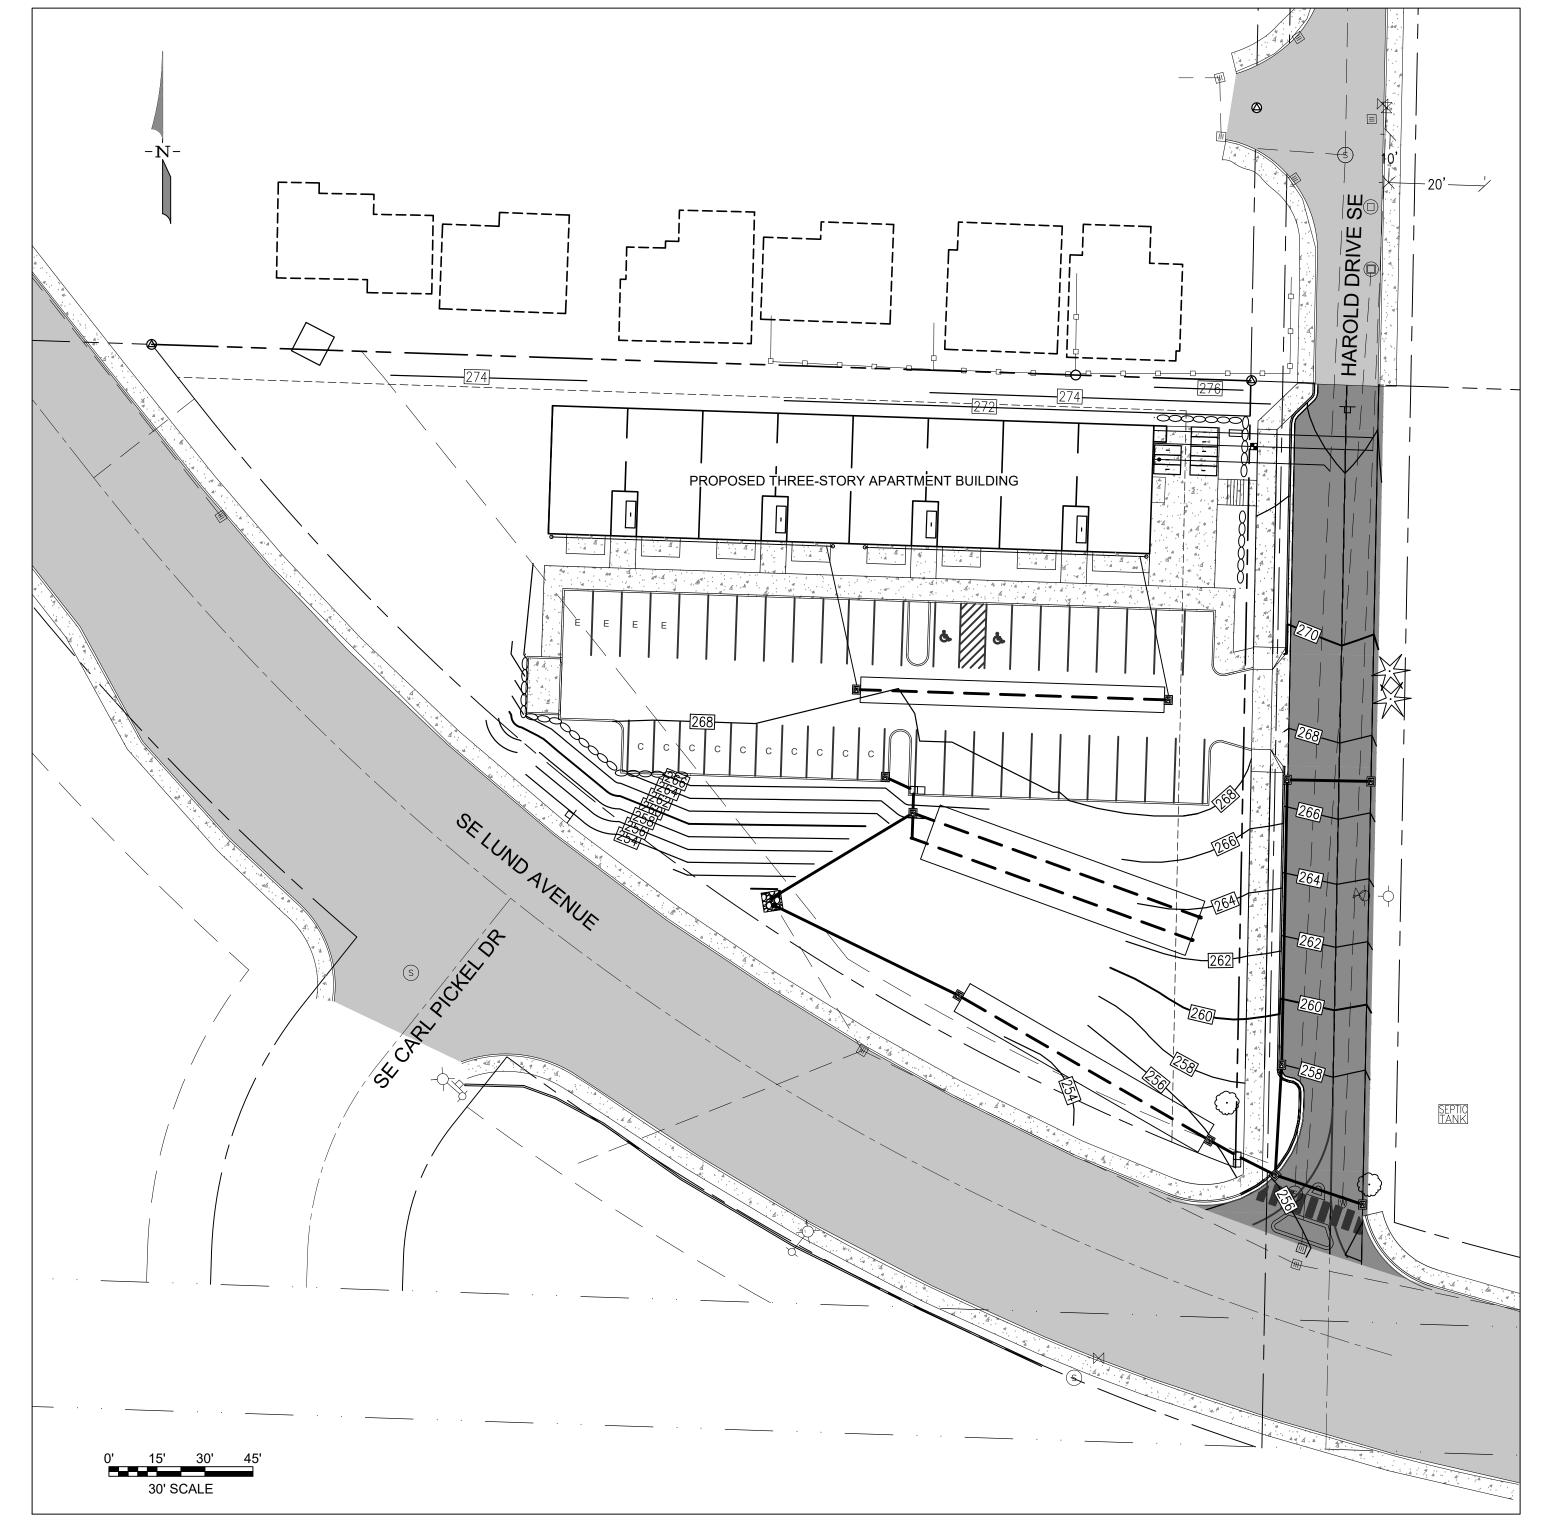

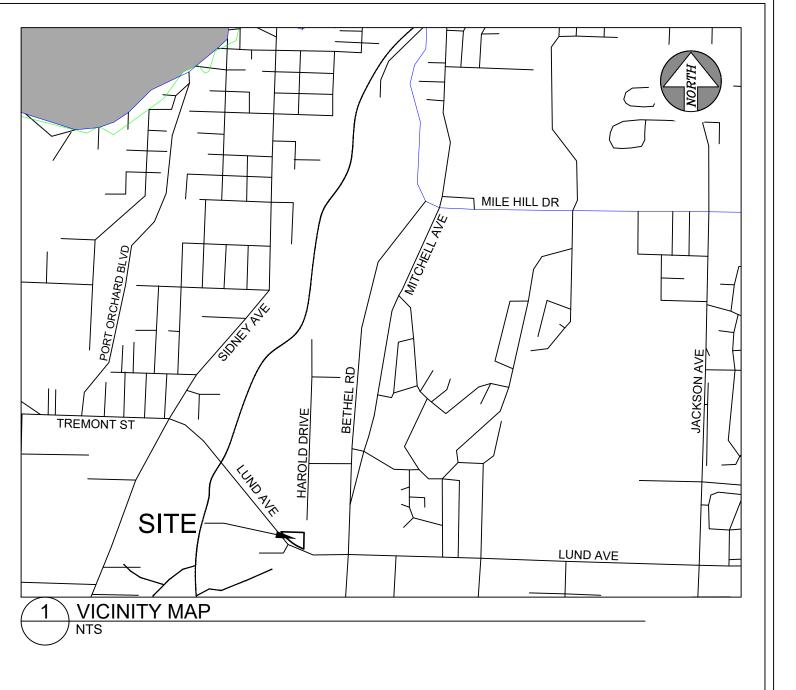

LEGAL DESCRIPTION (FROM TITLE REPORT):

CONVEYED TO CITY OF PORT ORCHARD BY DEED RECORDED UNDER AUDITOR NO 8401060113 AND RERECORDED UNDER AUDITOR NO 8805170107.

TAX PARCEL NUMBER:

4625-000-009-0206

SITE DATA:

PROPOSED USE: MULTI-FAMILY RESIDENTIAL

CURRENT ZONING: R2 PROPOSED ZONING: R3

SITE AREA = 1.22 ACRES

BUILDING FOOTPRINT AREA = 7,520 SQUARE FEET = 0.17 ACRES ASPHALT PARKING LOT AREA = 11,506 SQUARE FEET = 0.26 ACRES

CONCRETE SIDEWALK AND PATIO AREA = 2,458 SQUARE FEET = 0.06 ACRES TOTAL HARD SURFACE AREA = 21,484 SQUARE FEET = 0.49 ACRES (40%, LESS THAN 80%)

TOTAL FLOOR AREA (3 STORIES) = 22.560 SQUARE FEET

NUMBER OF UNITS = 23

PARKING SPACES REQUIRED = 40 (1.75 PER UNIT WITH ONSTREET PARKING)

PARKING SPACES PROVIDED = 41 (29 STANDARD, 10 COMPACT - LESS THAN 40%, 4 ELECTRIC, 2 ADA)

WATER: WEST SOUND UTILITIES SOUTH KITSAP SCHOOL DISTRICT SCHOOLS:

45' PUPLIC RIGHT-OF-WAY ROADS: PUGET SOUND ENERGY POWER: TELEPHONE: CENTURYTEL

FIRE DISTRICT: SOUTH KITSAP FIRE SEWER:

WEST SOUND UTILITIES POMC 20.32: Parking for Apartments not ON-SITE PARKING: 41 STALLS allowed in front or corner yards

Are all units 2-BR

23 bicycle parking

spaces required

TOPOGRAPHY NOTE:

THE TOPOGRAPHIC INFORMATION SHOWN IS ELEVATION DATA OBTAINED THOUGH FIELD SURVEYS PERFORMED BY WESTSOUND ENGINEERING. ALL DATA PRESENTED IS BASED ON THE NAVD88 DATUM.


JOB No. **2768.1**

SHEET INDEX


- C1 COVER SHEET
- C2 SITE PLAN
- C3 DEMOLITION AND SWPPP C4 - SWPPP NOTES AND DETAILS
- C5 GRADING AND DRAINAGE PLAN
- C6 DRAINAGE NOTES AND DETAILS C7 - DRAINAGE NOTES AND DETAILS
- C8 HAROLD STREET PLAN AND PROFILE
- C9 ROAD NOTES AND DETAILS
- C10 UTILITY PLAN C11 - WATER AND SANITARY SEWER NOTES AND DETAILS

MONUMENT REMOVAL PERMIT PROCESS

NO SURVEY MONUMENT SHALL BE REMOVED OR DESTROYED (THE PHYSICAL DISTURBANCE OR COVERING OF A MONUMENT SUCH THAT THE SURVEY POINT IS NO LONGER VISIBLE OR READILY ACCESSIBLE) BEFORE A PERMIT IS OBTAINED FROM THE DEPARTMENT OF NATURAL RESOURCES (DNR), WAC 332-120-030(2) STATES "IT IS THE RESPONSIBILITY OF THOSE PERFORMING CONSTRUCTION WORK OR OTHER ACTIVITY (INCLUDING ROAD AND STREET RESURFACING PROJECTS) TO ADEQUATELY SEARCH THE RECORDS AND THE PHYSICAL AREA OF THE PROPOSED CONSTRUCTION WORK OR OTHER ACTIVITY FOR THE PURPOSE OF LOCATING AND REFERENCING ANY KNOWN OR EXISTING SURVEY MONUMENTS." CONSTRUCTION SHALL NOT COMMENCE UNTIL WAC OUTLINED IN CHAPTER 332-120 IS COMPLIED WITH.

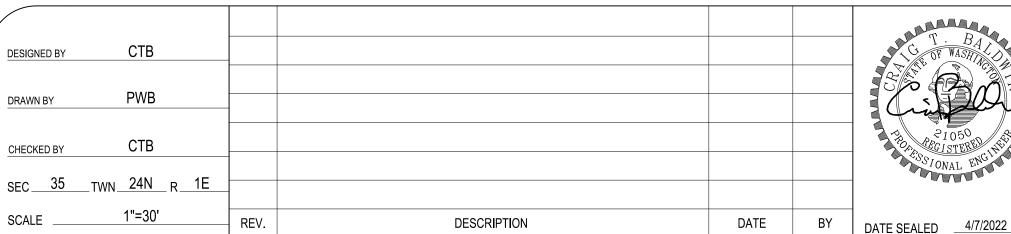

DRAWN BY

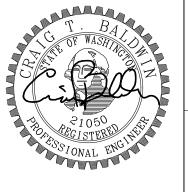

CONTOUR APARTMENTS REZONE


APARTMENTS AND REZONE COVER SHEET

CONTOUR CONSTRUCTION GROUP 3206 HORSEHEAD BAY DRIVE NW GIG HARBOR, WA 98335 (206) 650 - 7435

WestSound Engineering, Inc

217 S.W. Wilkins Drive Port Orchard, Wa. 98366 Phone (360) 876-3770 Fax (360) 876-0439 E-mail: wse@wsengineering.com http://www.wsengineering.com


SHT C1 OF 11 SHTS

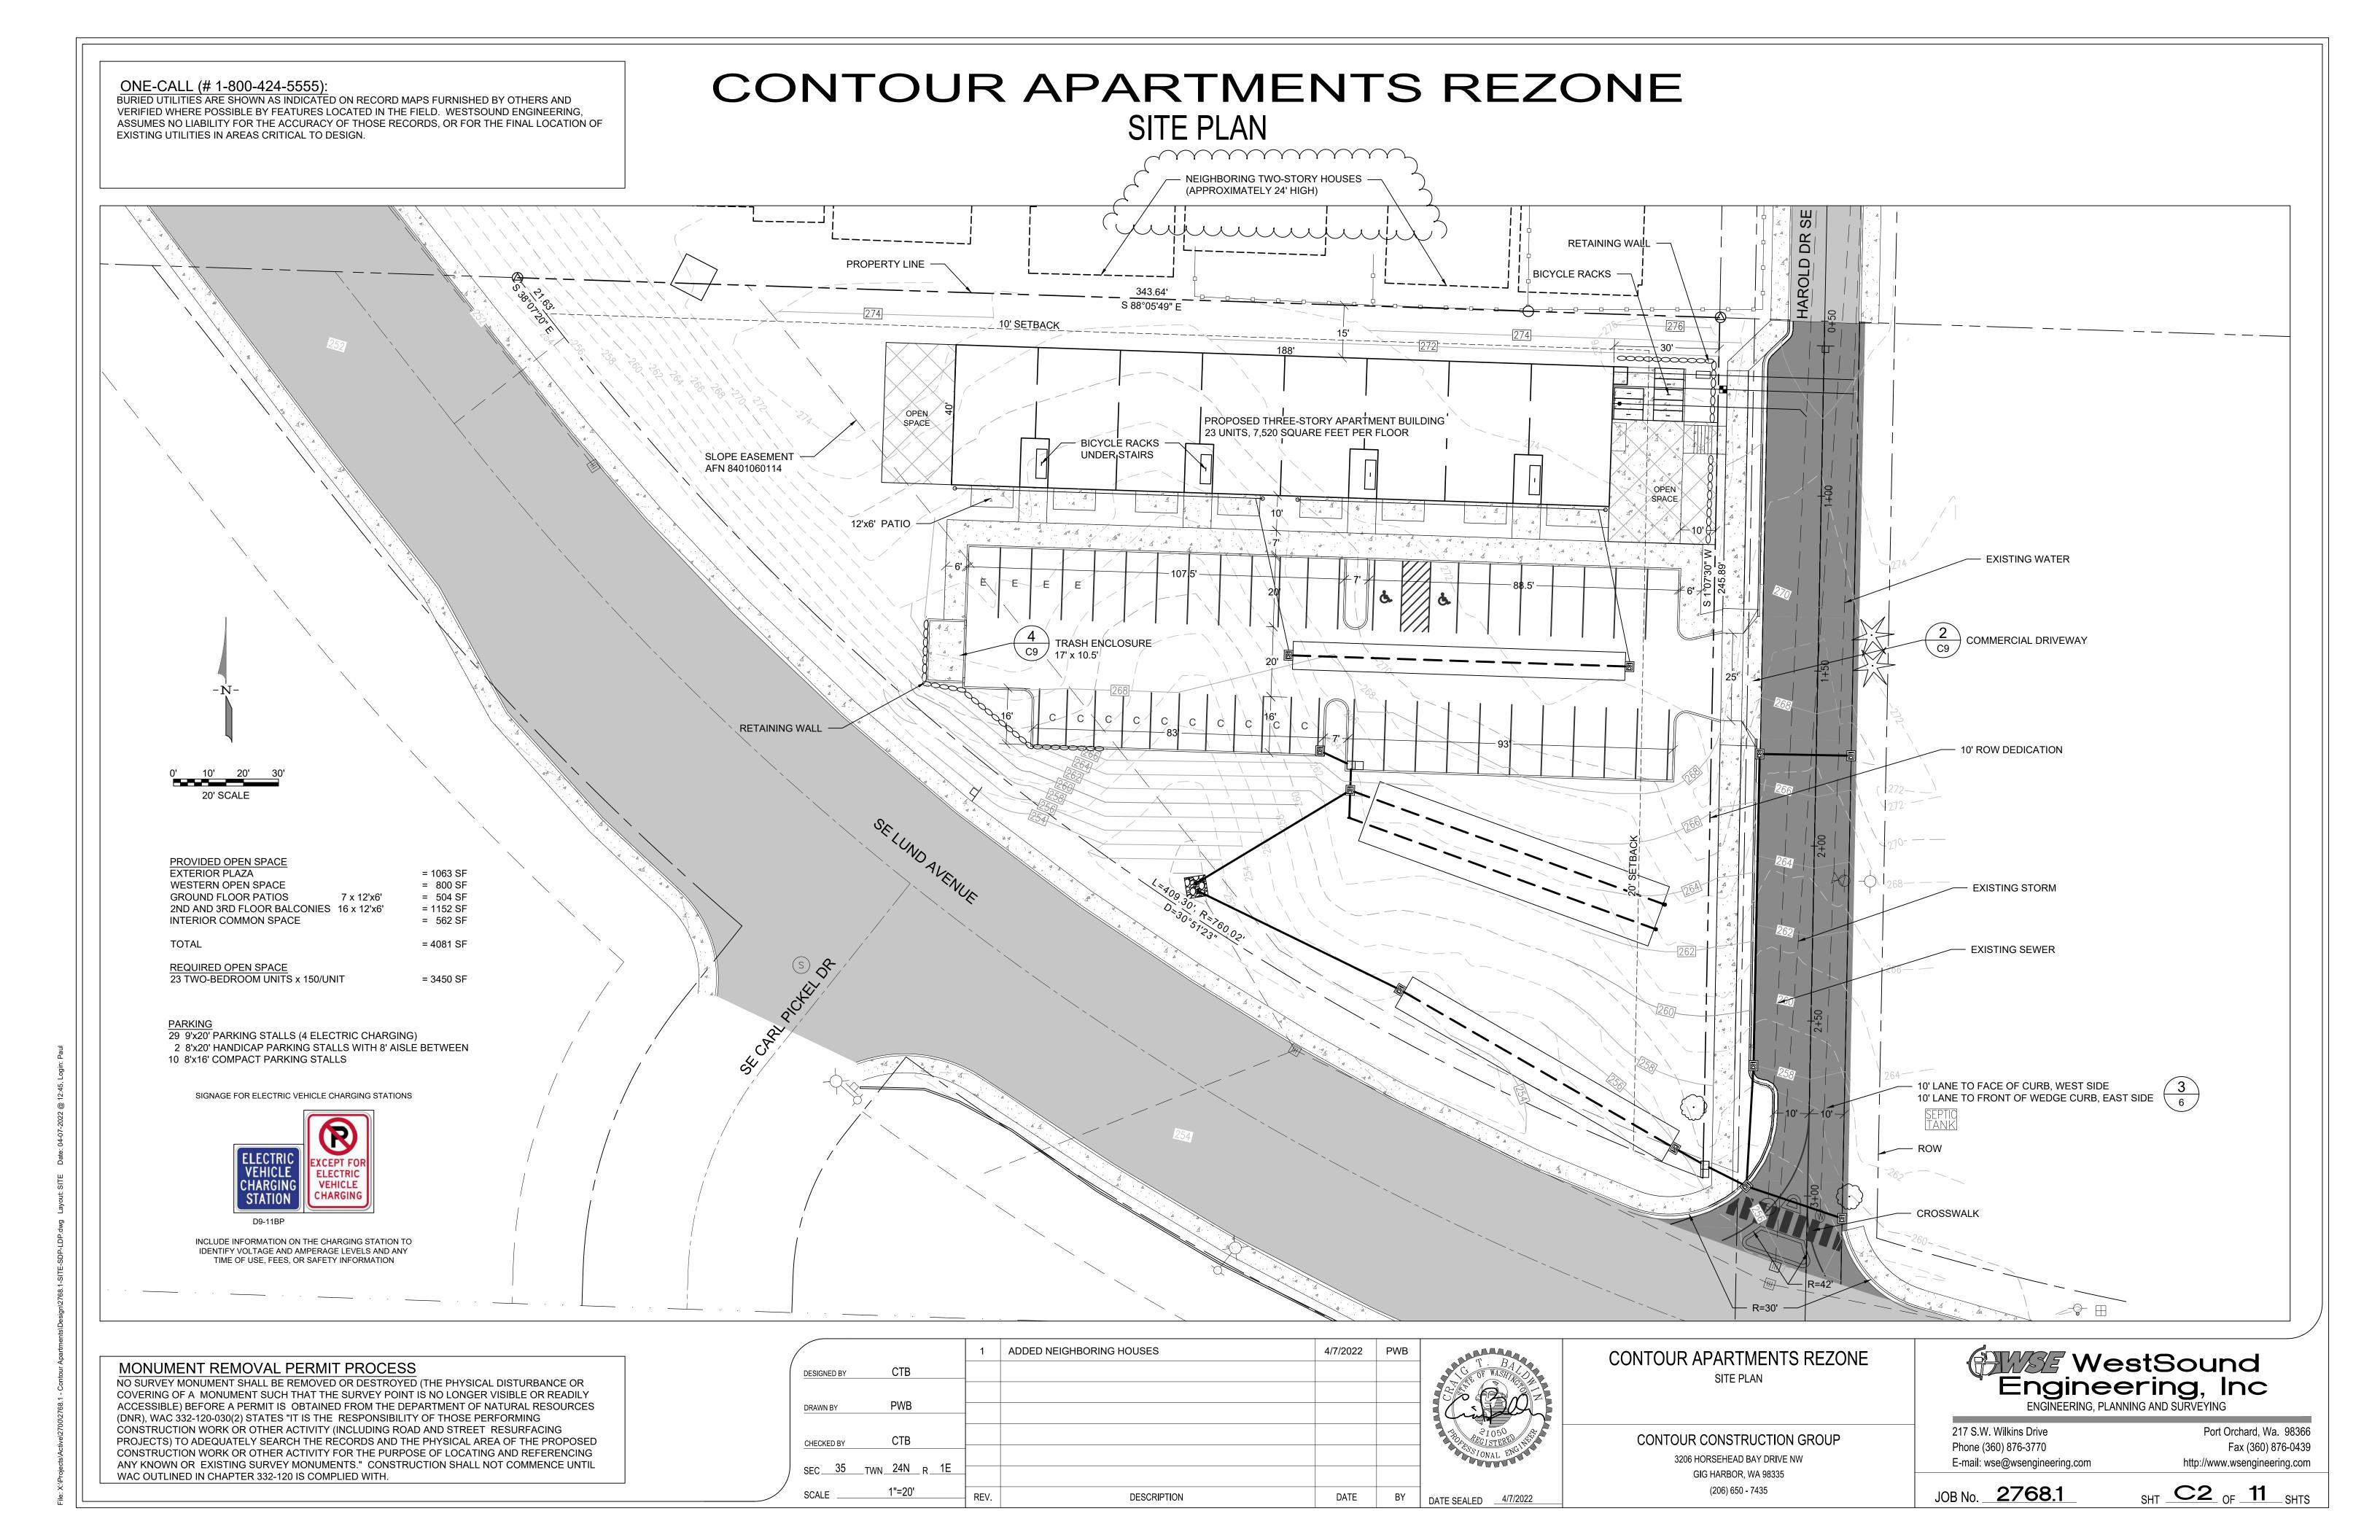


ONE-CALL (# 1-800-424-5555):
BURIED UTILITIES ARE SHOWN AS INDICATED ON RECORD MAPS FURNISHED BY OTHERS AND

CONTOUR APARTMENTS REZONE

DEMOLITION AND SWPPP

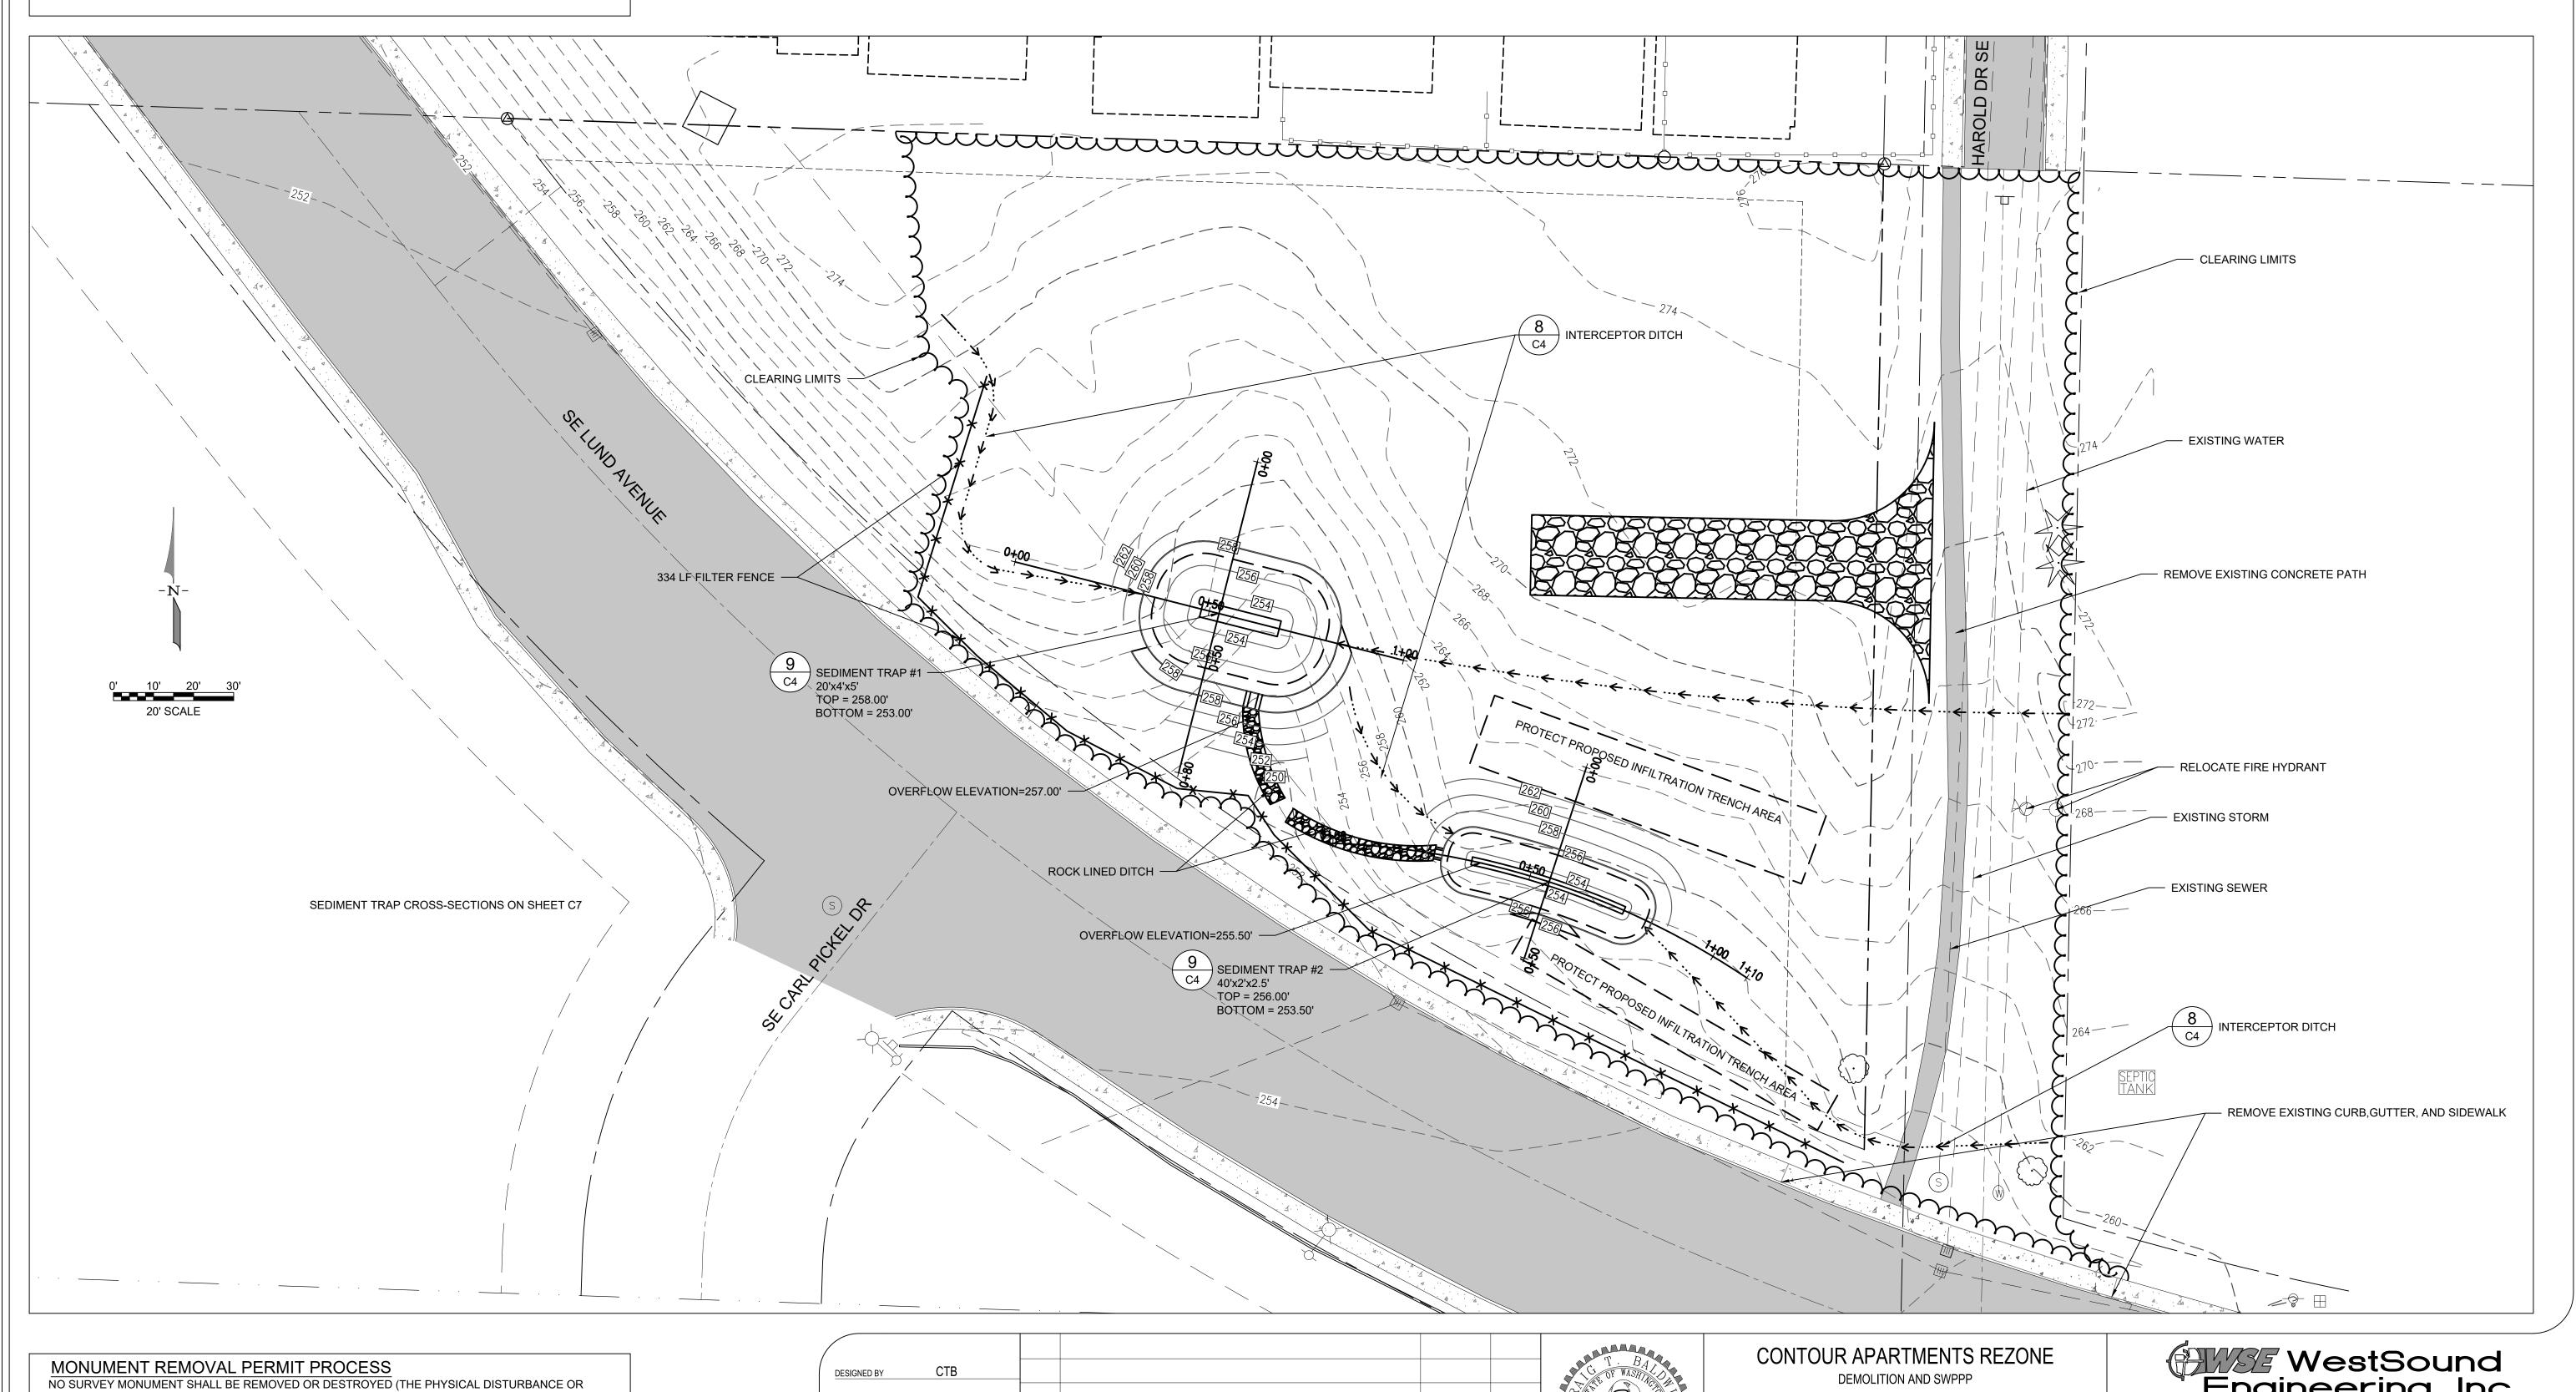

ANY KNOWN OR EXISTING SURVEY MONUMENTS." CONSTRUCTION SHALL NOT COMMENCE UNTIL WAC OUTLINED IN CHAPTER 332-120 IS COMPLIED WITH.

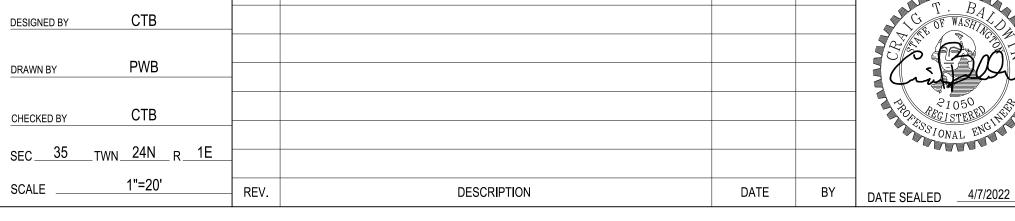

CONTOUR CONSTRUCTION GROUP

3206 HORSEHEAD BAY DRIVE NW GIG HARBOR, WA 98335 (206) 650 - 7435

WestSound Engineering, Inc ENGINEERING, PLANNING AND SURVEYING

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Port Orchard, Wa. 98366 Fax (360) 876-0439 http://www.wsengineering.com

JOB No. **2768.1**

SHT C3 OF 11 SHTS

EROSION AND SEDIMENT CONTROL NOTES:

(ALSO REFER TO CITY OF PORT ORCHARD STANDARDS AND SPECIFICATIONS CHAPTER 9 SURFACE WATER DRAINAGE):

27. APPROVAL OF THESE TEMPORARY EROSION AND SEDIMENT CONTROL (TESC) PLANS DOES NOT CONSTITUTE AN APPROVAL OF PERMANENT ROAD OR DRAINAGE DESIGN (E.G., SIZE AND LOCATION OF ROADS, PIPES, RESTRICTORS, CHANNELS, RETENTION FACILITIES, UTILITIES, ETC.). 28. THE IMPLEMENTATION OF THESE TESC PLANS AND THE CONSTRUCTION, MAINTENANCE REPLACEMENT, AND UPGRADING OF THESE TESC FACILITIES IS THE RESPONSIBILITY OF THE APPLICANT/CESCL UNTIL ALL CONSTRUCTION IS APPROVED.

29. THE BOUNDARIES OF THE CLEARING LIMITS SHOWN ON THESE PLANS SHALL BE CLEARLY FLAGGED BY A CONTINUOUS LENGTH OF SURVEY TAPE (OR FENCING, IF REQUIRED) PRIOR TO CONSTRUCTION. DURING THE CONSTRUCTION PERIOD, NO DISTURBANCE BEYOND THE CLEARING LIMITS SHALL BE PERMITTED. THE CLEARING LIMITS SHALL BE MAINTAINED BY THE APPLICANT/CESCL FOR THE DURATION OF CONSTRUCTION.

30. STABILIZED CONSTRUCTION ENTRANCES, IN ACCORDANCE WITH STANDARD DETAILS SHALL BE INSTALLED AT THE BEGINNING OF CONSTRUCTION AND MAINTAINED FOR THE DURATION OF THE PROJECT, ADDITIONAL MEASURES, SUCH AS CONSTRUCTED WHEEL WASH SYSTEMS OR WASH PADS, MAY BE REQUIRED TO ENSURE THAT ALL PAVED AREAS ARE KEPT CLEAN AND TRACK-OUT TO STREET

RIGHT-OF- WAY DOES NOT OCCUR FOR THE DURATION OF THE PROJECT. 31. THE TESC FACILITIES SHOWN ON THESE PLANS MUST BE CONSTRUCTED PRIOR TO ALL CLEARING AND GRADING TO ENSURE THAT THE TRANSPORT OF SEDIMENT TO SURFACE WATERS, DRAINAGE SYSTEMS, AND ADJACENT PROPERTIES IS REDUCED TO REQUIRED LEVELS.

32. THE TESC FACILITIES SHOWN ON THESE PLANS ARE THE MINIMUM REQUIREMENTS FOR ANTICIPATED SITE CONDITIONS. DURING THE CONSTRUCTION PERIOD, THESE TESC FACILITIES SHALL BE UPGRADED AS NEEDED FOR UNEXPECTED STORM EVENTS AND MODIFIED TO ACCOUNT FOR CHANGING SITE CONDITIONS (E.G., ADDITIONAL COVER MEASURES, ADDITIONAL SUMP PUMPS, RELOCATION OF DITCHES AND SILT FENCES, ADDITIONAL PERIMETER PROTECTION, ETC.), AS DIRECTED BY THE CITY ENGINEER. 33. THE TESC FACILITIES SHALL BE INSPECTED DAILY BY THE APPLICANT/CESCL AND MAINTAINED TO ENSURE CONTINUED PROPER FUNCTIONING, WRITTEN RECORDS SHALL BE KEPT OF WEEKLY REVIEWS OF THE TESC FACILITIES AND OF SAMPLES TAKEN DURING THE WET SEASON (OCTOBER 1 TO APRIL 30) AND OF MONTHLY REVIEWS DURING THE DRY SEASON (MAY 1 TO SEPTEMBER 30).

34. ANY AREAS OF EXPOSED SOILS, INCLUDING ROADWAY EMBANKMENTS, THAT WILL NOT BE DISTURBED FOR TWO DAYS DURING THE WET SEASON OR SEVEN DAYS DURING THE DRY SEASON SHALL BE IMMEDIATELY STABILIZED WITH THE APPROVED TESC METHODS (E.G., SEEDING, MULCHING, PLASTIC COVERING, ETC.).

35. ANY AREA NEEDING TESC MEASURES NOT REQUIRING IMMEDIATE ATTENTION SHALL BE ADDRESSED WITHIN SEVEN (7) DAYS.

36. THE TESC FACILITIES ON INACTIVE SITES SHALL BE INSPECTED AND MAINTAINED A MINIMUM OF ONCE A MONTH OR WITHIN TWENTY-FOUR (24) HOURS FOLLOWING A STORM EVENT. 37. AT NO TIME SHALL MORE THAN ONE (1) FOOT OF SEDIMENT BE ALLOWED TO ACCUMULATE WITHIN A

CATCH BASIN. ALL CATCH BASINS AND CONVEYANCE LINES SHALL BE CLEANED PRIOR TO FINAL INSPECTION. THE CLEANING OPERATION SHALL NOT FLUSH SEDIMENT-LADEN WATER INTO A DOWNSTREAM SYSTEM.


38. ANY PERMANENT FLOW CONTROL FACILITY USED AS A TEMPORARY SETTLING BASIN SHALL BE MODIFIED WITH THE NECESSARY EROSION CONTROL MEASURES AND SHALL PROVIDE ADEQUATE STORAGE CAPACITY. IF THE FACILITY IS TO FUNCTION ULTIMATELY AS AN INFILTRATION SYSTEM, THE TEMPORARY FACILITY MUST BE GRADED SO THAT THE BOTTOM AND SIDES ARE AT LEAST THREE (3) FEET ABOVE THE FINAL GRADE OF THE PERMANENT FACILITY.

39. WHERE STRAW MULCH FOR TEMPORARY EROSION CONTROL IS REQUIRED, IT SHALL BE APPLIED AT A MINIMUM THICKNESS OF 2 TO 3 INCHES.

40. PRIOR TO THE BEGINNING OF THE WET SEASON (OCTOBER 1), ALL DISTURBED AREAS SHALL BE REVIEWED TO IDENTIFY WHICH AREAS CAN BE SEEDED IN PREPARATION FOR THE WINTER RAINS. DISTURBED AREAS SHALL BE SEEDED WITHIN ONE WEEK OF THE BEGINNING OF THE WET SEASON. - A SKETCH MAP OF THOSE AREAS TO BE SEEDED AND THOSE AREAS TO REMAIN UNCOVERED SHALL BE SUBMITTED TO THE CITY OF PORT ORCHARD CITY ENGINEER. THE INSPECTOR CAN REQUIRE SEEDING OF ADDITIONAL AREAS IN ORDER TO PROTECT SURFACE WATERS, ADJACENT PROPERTIES, OR DRAINAGE FACILITIES.

│ EROSION AND SEDIMENT CONTROL NOTES

SEDIMENT TRAP DIMENSIONS TRAP# G 1.5' 4' 1' 1' 4' 6" 2'

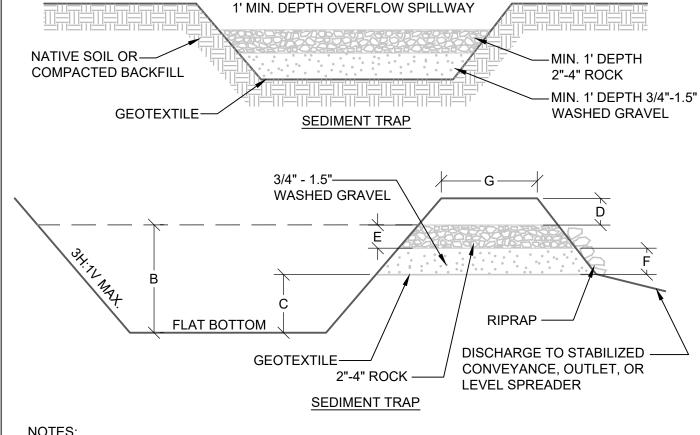

CONTOUR APARTMENTS REZONE

SWPPP NOTES AND DETAILS

TESC MAINTENANCE REQUIREMENTS:


- 1. EROSION AND SEDIMENTATION CONTROL FACILITIES SHALL BE INSPECTED AFTER EACH RAINFALL EVENT AND DAILY DURING PROLONGED RAINFALL.
- 2. NECESSARY REPAIRS OR REPLACEMENT OF FACILITIES SHALL BE ACCOMPLISHED PROMPTLY
- 3. SEDIMENT DEPOSITS SHALL BE REMOVED AFTER EACH STORM EVENT OR WHEN THE LEVEL OF

DEPOSITION REACHES APPROXIMATELY ONE-HALF THE MAXIMUM POTENTIAL DEPTH.

- 4. SEDIMENT DEPOSITS REMAINING IN PLACE AFTER THE ESC FACILITIES ARE NO LONGER REQUIRED SHALL BE DRESSED TO CONFORM TO THE EXISTING GRADE, PREPARED AND SEEDED.
- 5. TEMPORARY EROSION AND SEDIMENTATION CONTROL FACILITIES SHALL BE MAINTAINED BY


OWNER: DAVE BURK OWNER REP: DAVE BURK ADDRESS: 7583 CLOVER VALLEY ROAD SE ADDRESS: CITY, STATE, ZIP: PORT ORCHARD, WA 98367 CITY,STATE,ZIP: PHONE: 360-340-6636

2 TESC MAINTENANCE REQUIREMENTS

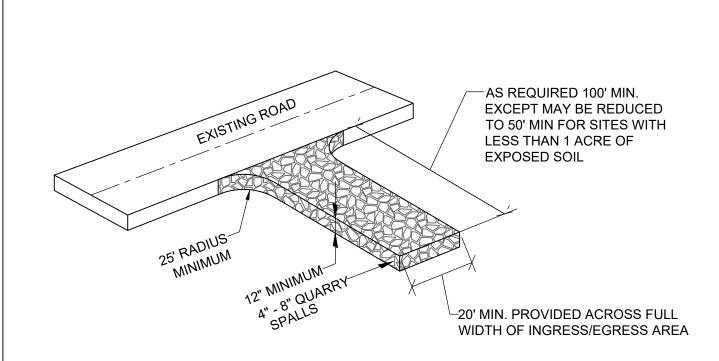

- SEPARATION GEOTEXTILE (MARAFI 180N) SHALL BE PLACED UNDER THE SPALLS TO PREVENT FINE SEDIMENT FROM PUMPING INTO THE ROCK PAD.
- 2. INSTALL ON FIRM COMPACTED SUBGRADE WHERE ABLE.
- 3. REFRESH SPALLS AS NEEDED TO MAINTAIN ENTRANCE IN ACCORDANCE WITH THIS DETAIL.
- 4. ANY SEDIMENT TRANSPORT OUTSIDE OF SITE AND ENTRANCE SHALL BE REMOVED AND THE AREA SWEPT FREE OF SEDIMENT.
- 5. LOOSE SPALLS THAT ARE TRANSPORTED OR DISPLACED TO ROADWAY SHALL BE COLLECTED AND RETURNED TO THE SITE.
- 6. NO ACCESS POINTS NOT PROVIDED WITH A CONSTRUCTION ENTRANCE SHALL BE USED DURING THE CONSTRUCTION ACTIVIY. PROVIDE FENCING TO RESTRICT ACCESS IF NEEDED.

$\widetilde{}$ 3 $\widetilde{}$ TEMPORARY CONSTRUCTION ENTRANCE

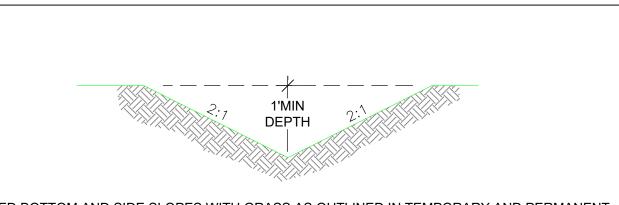


- SEED BOTTOM AND SIDE SLOPES WITH GRASS AS OUTLINED IN TEMPORARY AND PERMANENT HYDROSEEDING NOTES. CHANNELS HAVING A FLOWLINE SLOPE OF 6% OR GREATER SHALL BE **ROCK-LINED WITH RIPRAP.**
- 2. MINIMUM OF 1% SLOPE WITH POSITIVE DRAINAGE TO THE CATCH BASIN.
- INSPECT AFTER EVERY MAJOR STORM EVENT AND REPAIR AS NECESSARY.

8 INTERCEPTOR DITCH

SILT FENCE NOTES:


- FILTER FABRIC SHALL BE PURCHASED IN A CONTINUOUS ROLL AND CUT TO THE LENGTH OF THE BARRIER TO AVOID USE OF JOINTS. WHEN JOINTS ARE NECESSARY, FILTER CLOTH SHALL BE SPLICED TOGETHER ONLY AT A SUPPORT POST, WITH A MINIMUM 6-INCH OVERLAP, AND SECURELY FASTENED AT BOTH ENDS TO POSTS.
- POSTS SHALL BE SPACED A MAXIMUM OF 6 FEET APART AND DRIVEN SECURELY INTO THE GROUND (MINIMUM OF 30 INCHES).
- A TRENCH SHALL BE EXCAVATED APPROXIMATELY 8 INCHES WIDE AND 12 INCHES DEEP ALONG THE LINE OF POSTS AND UP SLOPE FROM THE BARRIER. THIS TRENCH SHALL BE BACKFILLED WITH WASHED GRAVEL.
- WHEN STANDARD STRENGTH FILTER FABRIC IS USED, A WIRE MESH SUPPORT FENCE SHALL BE FASTENED SECURELY TO THE UP SLOPE SIDE OF THE POSTS USING HEAVY-DUTY WIRE STAPLES AT LEAST I INCH LONG, TIE WIRES OR HOG RINGS. THE WIRE SHALL EXTEND INTO THE TRENCH A MINIMUM OF 4 INCHES AND SHALL NOT EXTEND MORE THAN 24 INCHES ABOVE THE ORIGINAL GROUND SURFACE.
- THE STANDARD STRENGTH FILTER FABRIC SHALL BE STAPLED OR WIRED TO THE FENCE, AND 20 INCHES OF THE FABRIC SHALL BE EXTENDED INTO THE TRENCH. THE FABRIC SHALL NOT EXTEND MORE THAN 24 INCHES ABOVE THE ORIGINAL GROUND SURFACE. FILTER FABRIC SHALL NOT BE STAPLED TO EXISTING TREES.
- WHEN EXTRA-STRENGTH FILTER FABRIC AND CLOSER POST SPACING IS USED, THE WIRE MESH SUPPORT FENCE MAY BE ELIMINATED. IN SUCH A CASE, THE FILTER FABRIC IS STAPLED OR WIRED DIRECTLY TO THE POSTS WITH ALL OTHER PROVISIONS OF ABOVE NOTES APPLYING.
- FILTER FABRIC FENCES SHALL NOT BE REMOVED BEFORE THE UPSLOPE AREA HAS BEEN PERMANENTLY STABILIZED.
- FILTER FABRIC FENCES SHALL BE INSPECTED IMMEDIATELY AFTER EACH RAINFALL AND AT LEAST DAILY DURING PROLONGED RAINFALL. ANY REQUIRED REPAIRS SHALL BE MADE IMMEDIATELY. SILT FENCES WILL BE INSTALLED PARALLEL TO ANY SLOPE CONTOURS.
- 10. CONTRIBUTING LENGTH TO FENCE WILL NOT BE GREATER THAN 100 FEET.
- 11. DO NOT INSTALL BELOW AN OUTLET PIPE OR WEIR.
- 12. INSTALL DOWN SLOPE OF EXPOSED AREAS.

13. DO NOT DRIVE OVER OR FILL OVER SILT FENCES.

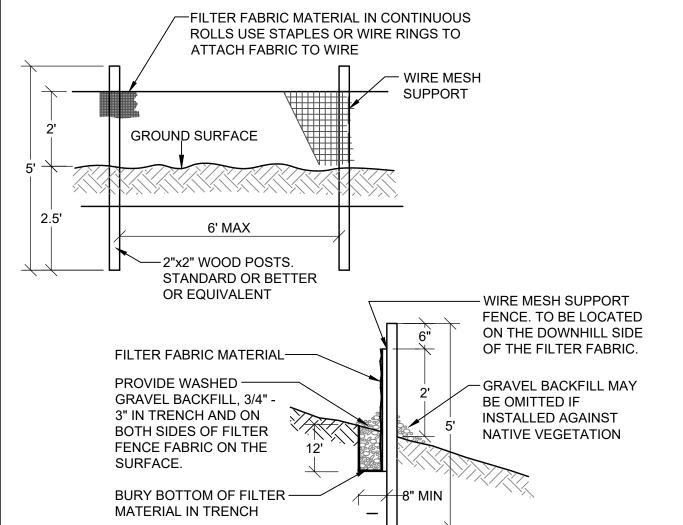

4 SILT FENCING DETAIL

COLLECTED MATERIAL

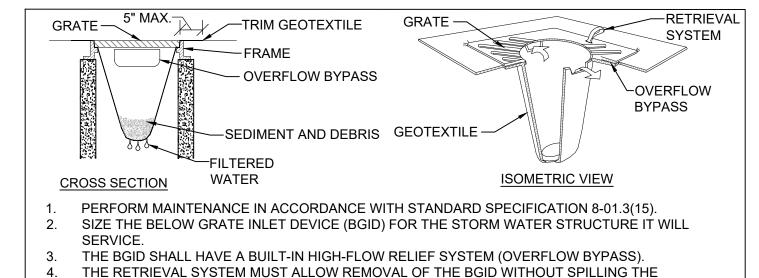

5 \ INLET PROTECTION SOCK DETAIL

SEEDING:

- 1. SEED MIXTURE SHALL BE 10% REDTOP, 40% ANNUAL RYE, 40% CHEWING FESCUE, AND 10%
- 2. SEED BEDS PLANTED BETWEEN MAY 1 AND OCTOBER 31 WILL REQUIRE IRRIGATION AND OTHER

WILL BE NECESSARY. (E.G., GEOTEXTILES, JUTE MAT, CLEAR PLASTIC COVERING).

- MAINTENANCE AS NECESSARY TO FOSTER AND PROTECT THE ROOT STRUCTURE. 3. FOR SEED BEDS PLANTED BETWEEN OCTOBER 31 AND APRIL 30, ARMORING OF THE SEED BED
- 4. BEFORE SEEDING, INSTALL NEEDED SURFACE RUNOFF CONTROL MEASURES SUCH AS GRADIENT TERRACES, INTERCEPTOR DIKES, SWALES, LEVEL SPREADERS AND SEDIMENT BASINS.
- 5. THE SEEDBED SHALL BE FIRM WITH A FAIRLY FINE SURFACE, FOLLOWING SURFACE
- 6. FERTILIZERS ARE TO BE USED ACCORDING TO SUPPLIERS RECOMMENDATIONS. AMOUNTS USED SHOULD BE MINIMIZED, ESPECIALLY ADJACENT TO WATER BODIES AND WETLANDS.

ROUGHENING, PERFORM ALL OPERATIONS ACROSS OR AT RIGHT ANGLES TO THE SLOPE.

6 SEEDING NOTES

MULCHING

- PREPARE SOIL AS FOR SEEDING
- 2. APPLY PER TABLE BELOW
- NETS AND MATS SHALL BE USED IN CONJUNCTION WITH MULCH ON SLOPES STEEPER THAN 2:1
- 4. WOOD FIBER CELLULOSE BLANKETS ARE CONSIDERED PROTECTIVE MULCHES AND CAN BE USED ALONE ON ERODIBLE SOILS AND DURING ALL TIMES OF THE YEAR.
- 5. USE HAY WHERE MULCH EFFECT IS TO BE MAINTAINED FOR MORE THAN 3 MONTHS HAY AND STRAW ARE SUBJECT TO WIND BLOWING UNLESS KEPT MOIST OR TIED DOWN.
- ANCHOR BY CRIMPING, DISCING, ROLLING OR PUNCHING INTO SOIL, COVERING WITH NETTING, SPRAYING WITH A CHEMICAL OR FIBER BINDER OR BY KEEPING MOIST
- WOOD FIBER CELLULOSE (PARTLY-DIGESTED WOOD FIBERS) SHALL BE USED FOR EROSION
- CONTROL ON CRITICAL AREAS, THE APPLICATION RATE SHOULD BE DOUBLED. APPLY WITH HYDROMULCHER, NO TIE DOWN IS REQUIRED. PACKAGED IN 100-LB. BAGS. NOT RECOMMENDED FOR HIGHLY ERODIBLE SOILS IN HOT WEATHER;
- 8. GRAVEL, CRUSHED STONE OR SLAG IS TO BE USED ON SHORT SLOPES AND AROUND WOODY PLANTS AND ORNAMENTALS. USE WHERE SUBJECT TO FOOT TRAFFIC.
- CORN STALKS SHREDDED INTO 4 6" LENGTHS MAY BE USED AS GENERAL MULCH.
- 10. WOOD CHIPS MAY BE USED AS GENERAL MULCH ON SLOPES LESS THAN 6%. 11. BARK CHIPS/SHREDDED BARK MAY BE USED AS GENERAL MULCH ON SLOPES LESS THAN 6%.
- AVOID TILLING BARK OR SAWDUST INTO SOIL

- 1. MULCHES SHOULD BE USED FOLLOWING TEMPORARY OR PERMANENT SEEDING. 2. MULCHING SHOULD IMMEDIATELY FOLLOW SEEDING IN AREAS WITH SLOPES STEEPER
- MULCHES SHOULD BE USED IN CLEARED AREAS THAT CANNOT BE IMMEDIATELY SEEDED.
- 4. MULCHES SHOULD BE USED ON EXPOSED SOILS (INCLUDING STOCKPILES WHICH ARE NOT
- FINAL GRADED WITHIN 15 DAYS) UNLESS COVERED WITH PLASTIC SHEETING MULCHED AREAS SHOULD BE CHECKED PERIODICALLY, ESPECIALLY FOLLOWING SEVERE
- STORMS, WHEN DAMAGED AREAS OF MULCH OR TIE-DOWN MATERIAL SHOULD BE REPAIRED.

MULCH MATERIALS, APPLICATION RATES, AND SPECIFICATIONS

MULCH MATERIAL	QUALITY STANDARDS	APPLICATION RATE PER 1000 SF	APPLICATION RATES PER ACRE	DEPTH OF APPLICATION
GRAVEL, CRUSHED STONE OR SLAG	WASHED 3/4 TO 1-1/2" SIZE	9 CU. YDS.	400 CU. YDS.	3 INCHES
HAY OR STRAW	AIR-DRIED; FREE FROM UNDESIRABLE SEED AND COARSE MATERIAL.	75 TO 100 LBS., 2-3 BALES	1.5 TO 2.5 TONS (90 TO 120 BALES)	LIGHTLY COVER ENTIRE SURFACE (MIN. 2")
WOOD FIBER CELLULOSE	DYED GREEN. NO GROWTH ORGANISM INHIBITING FACTORS	25 TO 30 POUNDS	1000 TO 1500 POUNDS	2 INCHES

7 MULCHING

CONTOUR APARTMENTS REZONE SWPPP NOTES AND DETAILS

CONTOUR CONSTRUCTION GROUP

3206 HORSEHEAD BAY DRIVE NW GIG HARBOR, WA 98335

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217 S.W. Wilkins Drive Phone (360) 876-3770 E-mail: wse@wsengineering.com

Port Orchard, Wa. 98366 Fax (360) 876-0439 http://www.wsengineering.com

JOB No. **2768.1**

SHT **C4** OF **11** SHTS

SEDIMENT TRAP

SEDIMENT TRAP CROSS-SECTIONS ON SHEET C7

2. ANY DAMAGE TO THE POND EMBANKMENT SLOPES SHALL BE REPAIRED.

1. SEDIMENT SHALL BE REMOVED FROM THIS TRAP WHEN IT REACHES 1-FT IN DEPTH.

DESIGNED BY

PWB DRAWN BY CHECKED BY

SEC 35 TWN 24N R 1E

DESCRIPTION

DATE SEALED 4/7/2022


(206) 650 - 7435

ONE-CALL (# 1-800-424-5555):

BURIED UTILITIES ARE SHOWN AS INDICATED ON RECORD MAPS FURNISHED BY OTHERS AND VERIFIED WHERE POSSIBLE BY FEATURES LOCATED IN THE FIELD. WESTSOUND ENGINEERING. ASSUMES NO LIABILITY FOR THE ACCURACY OF THOSE RECORDS, OR FOR THE FINAL LOCATION OF EXISTING UTILITIES IN AREAS CRITICAL TO DESIGN.

CONTOUR APARTMENTS REZONE

GRADING AND DRAINAGE PLAN

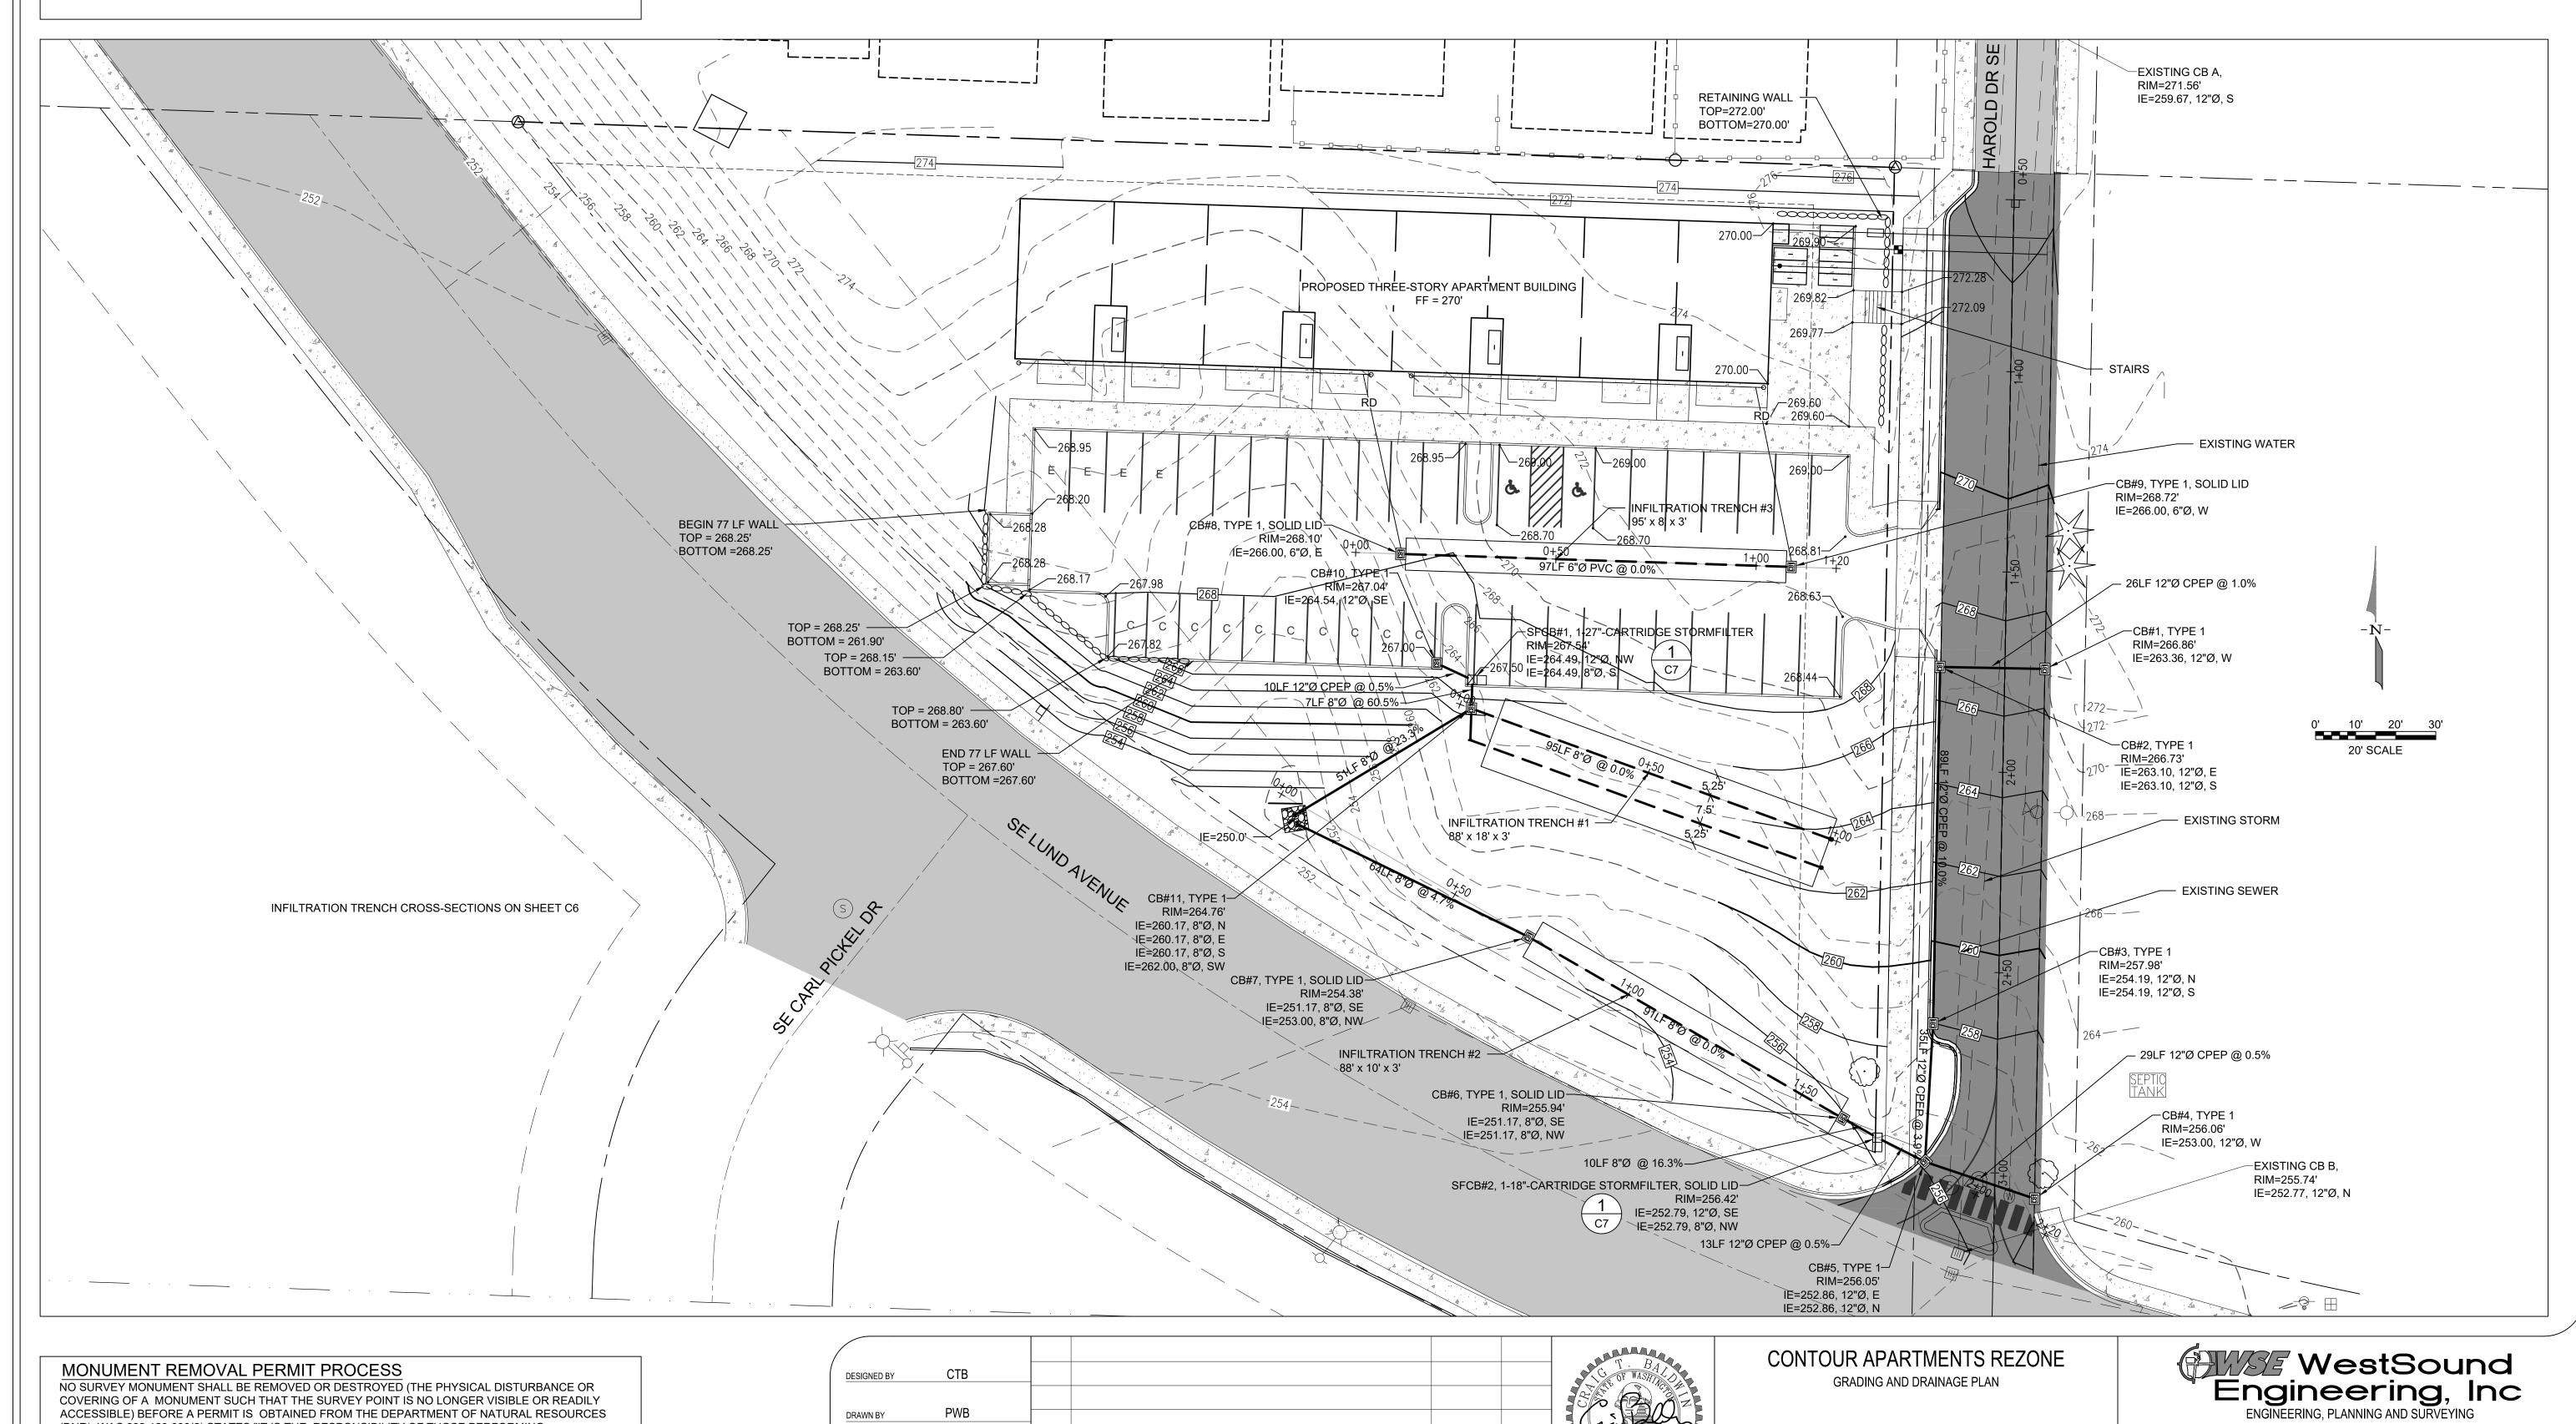

CONSTRUCTION WORK OR OTHER ACTIVITY (INCLUDING ROAD AND STREET RESURFACING PROJECTS) TO ADEQUATELY SEARCH THE RECORDS AND THE PHYSICAL AREA OF THE PROPOSED ANY KNOWN OR EXISTING SURVEY MONUMENTS." CONSTRUCTION SHALL NOT COMMENCE UNTIL WAC OUTLINED IN CHAPTER 332-120 IS COMPLIED WITH.



CHECKED BY

CONTOUR CONSTRUCTION GROUP

3206 HORSEHEAD BAY DRIVE NW GIG HARBOR, WA 98335 (206) 650 - 7435

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JOB No. **2768.1**

SHT **C5** OF **11** SHTS

NOTES:

1. CATCH BASINS SHALL BE

OR NOTED IN THE STANDARD

SPECIFICATIONS.

KNOCKOUTS.

CONSTRUCTED IN ACCORDANCE WITH

UNLESS OTHERWISE SHOWN ON PLANS

2. AS AN ACCEPTABLE ALTERNATIVE

TO REBAR, WELDED WIRE FABRIC

INCHES PER FOOT MAY BE USED.

FABRIC SHALL NOT BE PLACED IN

4. PRECAST BASES SHALL BE FURNISHED WITH CUTOUTS OR KNOCKOUTS. KNOCKOUTS SHALL HAVE A WALL THICKNESS OF 2" MIN. ALL

WALL IS LEFT INTACT.

BE PER MANUFACTURERS

SPECIFICATIONS.

COVER POSITION.

"D" SHAPE.

HAVING A MIN. AREA OF 0.12 SQUARE

WELDED WIRE FABRIC SHALL COMPLY

TO ASTM A497 (AASHTO M 221). WIRE

3. ALL REINFORCED CAST-IN-PLACE

PIPE SHALL BE INSTALLED IN FACTORY PROVIDED KNOCKOUTS. UNUSED KNOCKOUTS NEED NOT BE GROUTED IF

5. KNOCKOUTS OR CUTOUTS SHALL

6. ROUND KNOCKOUTS MAY BE ON ALL 4 SIDES, WITH MAX. DIAM. OF 20".

KNOCKOUTS MAY BE EITHER ROUND OR

THE TAPER ON THE SIDES OF THE

PRECAST BASE SECTION AND RISER

SECTION SHALL NOT EXCEED 1/2"/FT.

SHALL BE IN ACCORDANCE WITH

STANDARD DETAILS "THRU CURB

FRAME AND GRATE" OR "THRU CURB

FRAME AND VANED GRATE". MATING

ASSURE NON-ROCKING FIT WITH ANY

9. NON CONCRETE PIPES SHALL BE


INSTALLED WITH A SANDCOLLAR.

SURFACES SHALL BE FINISHED TO


CATCH BASIN FRAME AND GRATE

ASTM C478 (AASHTO M 199) & C890

HOOP

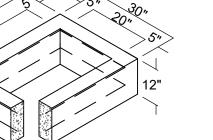



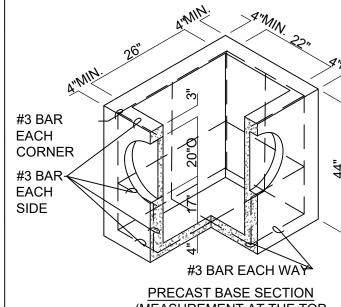

MEASUREMENT AT THE TOP OF THE BASE ∠ TYPE 1 CATCH BASIN

STRIPS


-4 EA. 1/4"x2"x5" UNIFORMLY SPACED AND WELDED TO





√ 3 \ TRASH RACK DETAIL

CONTOUR APARTMENTS REZONE

DRAINAGE NOTES AND DETAILS

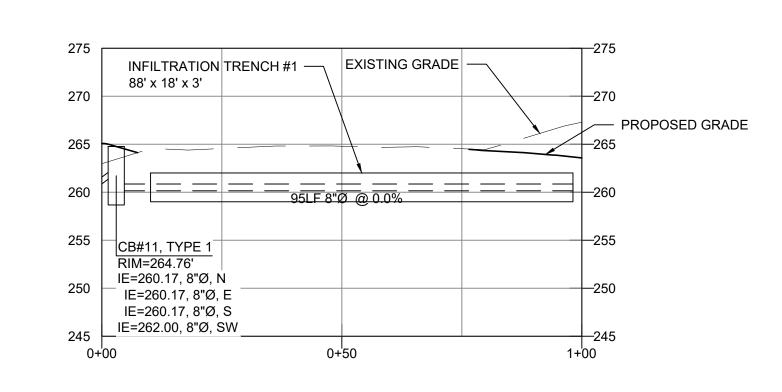

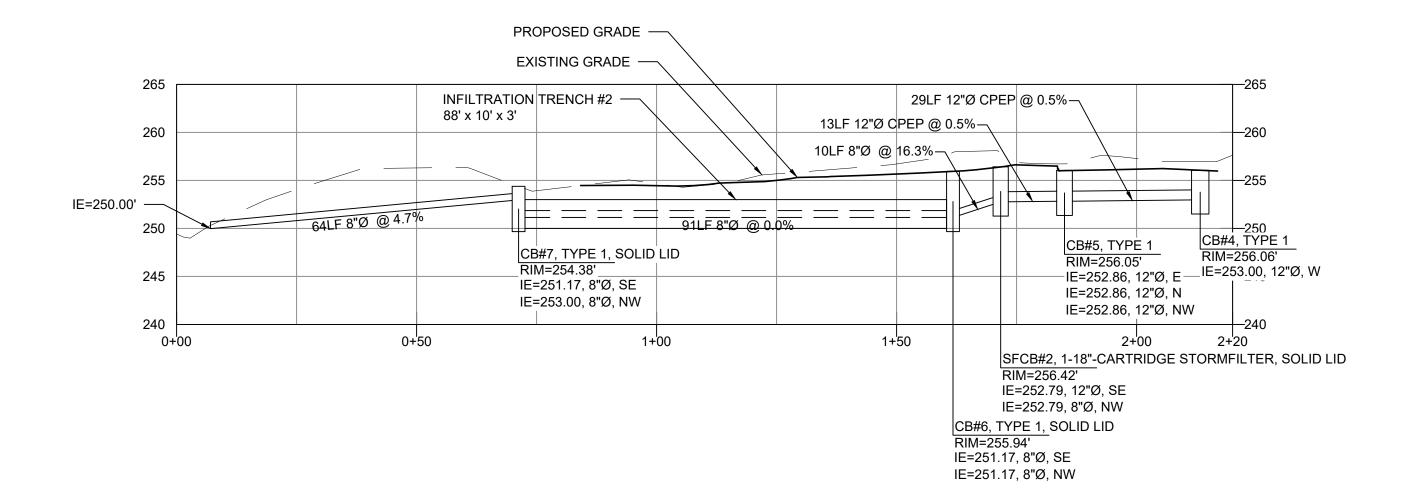

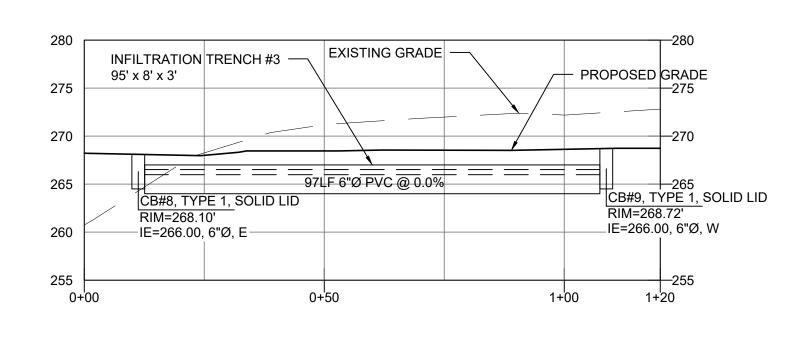

DESCRIPTION

5 \ INFILTRATION TRENCH CROSS-SECTIONS

DESIGNED BY

DRAWN BY

CHECKED BY

СТВ

SEC 35 TWN 24N R 1E

(ALSO REFER TO CITY OF PORT ORCHARD STANDARDS AND SPECIFICATIONS CHAPTER 9 SURFACE WATER DRAINAGE):

16. ALL STORM PIPE AND APPURTENANCES SHALL BE LAID IN ACCORDANCE WITH CITY OF PORT ORCHARD DESIGN AND CONSTRUCTION STANDARDS. THIS SHALL INCLUDE LEVELING AND COMPACTING THE TRENCH BOTTOM, THE TOP OF THE FOUNDATION MATERIAL AND ANY REQUIRED BEDDING TO A UNIFORM GRADE SO THAT THE ENTIRE DRAINAGE FACILITY IS

SUPPORTED BY A UNIFORMLY DENSE UNYIELDING BASE.

17. ALL STORM PIPE SHALL BE SUBJECT TO A LOW-PRESSURE AIR TEST IN ACCORDANCE WITH WSDOT STANDARD SPECIFICATION 7-04.3(1)F AND A VIDEO INSPECTION IN ACCORDANCE WITH THE PORT

18. STORM PIPE COVER, MEASURED FROM THE FINISHED GRADE ELEVATION TO THE TOP OF THE OUTSIDE SURFACE OF THE PIPE, SHALL BE 2 FEET MINIMUM, UNLESS AUTHORIZED BY THE CITY OF PORT ORCHARD CITY ENGINEER UNDER THE FOLLOWING CIRCUMSTANCES:

A. UNDER DRIVEWAYS THE PIPE COVER MAY BE REDUCED TO 1 FOOT MINIMUM IF THE 2-FEET CANNOT BE ACHIEVED AND THE COVER IS CONSISTENT WITH THE PIPE MANUFACTURER'S RECOMMENDATIONS. B. IN AREAS NOT SUBJECT TO VEHICULAR LOADS, SUCH AS LANDSCAPE PLANTERS AND YARDS, THE PIPE

COVER MAY BE REDUCED TO 1 FOOT MINIMUM. C. IF DUCTILE IRON PIPE OR C900 PIPE IS USED, THE PIPE COVER MAY BE REDUCED TO 1 FOOT MINIMUM. 19. STEEL PIPE SHALL BE GALVANIZED AND HAVE ASPHALT TREATMENT #1 OR BETTER INSIDE AND OUT (WSDOT STANDARD SPECIFICATION 9-05.4(3)).

20. ANY DRAINAGE STRUCTURE, SUCH AS A CATCH BASIN OR A MANHOLE, NOT RECEIVING SURFACE RUNOFF AND NOT LOCATED WITHIN A TRAVELED ROADWAY OR SIDEWALK SHALL HAVE A SOLID LOCKING LID. ANY DRAINAGE STRUCTURE ASSOCIATED WITH A PERMANENT RETENTION/DETENTION FACILITY, NOT RECEIVING SURFACE RUNOFF, SHALL HAVE A SOLID LOCKING LID.

21. ALL CATCH BASIN GRATES SHALL CONFORM TO THE CURRENTLY ADOPTED STORMWATER MANAGEMENT MANUAL AND THE WSDOT STANDARD PLANS WHEN LOCATED WITHIN THE RIGHT OF-WAY, AND SHALL INCLUDE A COMBINATION INLET FRAME (OPEN-CURB-FACE FRAME), WHEN LOCATED IN A SUMP CONDITION OR BEFORE AN INTERSECTION WITH A 4% GRADE OR ABOVE. A HERRINGBONE GRATE MAY BE USED OUTSIDE THE RIGHT-OF-WAY. ALL CATCH BASINS WITHIN THE GUTTER LINE SHALL BE INSTALLED IN ACCORDANCE WITH THE CITY OF PORT ORCHARD STANDARD DETAILS AS APPLICABLE. MAXIMUM CATCH BASIN HEIGHT FROM FINISHED GRADE TO PIPE INVERT SHAL BE PER THE APPLICABLE DETAIL.

22. FOR ANY CURB GRADE LESS THAN 0.8% (0.0080 FT/FT), INCLUDING CURB RETURNS, A PROFESSIONAL LAND SURVEYOR, CURRENTLY LICENSED IN THE STATE OF WASHINGTON, SHALL VERIFY THAT THE CURB FORMS OR STRING LINES ARE AT THE GRADES NOTED ON THE APPROVED PLANS PRIOR TO PLACEMENT OF CONCRETE. THE CONTRACTOR IS RESPONSIBLE FOR SURVEY COORDINATION AND COSTS 23. FOR ANY DRAINAGE PIPE GRADE LESS THAN 0.5% (0.0050 FT/FT), A PROFESSIONAL LAND SURVEYOR. CURRENTLY LICENSED IN THE STATE OF WASHINGTON, SHALL VERIFY THAT THE AS-BUILT PIPE MATCHES THE GRADES NOTED ON THE APPROVED PLANS PRIOR TO COMPLETION OF SUBGRADE. THE

24. ALL DRIVEWAY CULVERTS LOCATED WITHIN THE CITY OF PORT ORCHARD RIGHT-OF-WAY SHALL BE OF SUFFICIENT LENGTH TO PROVIDE A MINIMUM 3:1 SLOPE FROM THE EDGE OF THE DRIVEWAY TO THE BOTTOM OF THE DITCH. CULVERTS SHALL HAVE BEVELED END SECTIONS TO MATCH THE SIDE SLOPE 25. ROCK FOR EROSION PROTECTION OF DITCHES, WHERE REQUIRED, MUST BE OF SOUND QUARRY ROCK, PLACED TO A DEPTH OF ONE FOOT (1'), AND MUST MEET THE FOLLOWING SPECIFICATIONS: 100% MUST PASS THE 8" SIEVE, 40% MAXIMUM CAN PASS THE 3" SIEVE AND 10% MAXIMUM CAN PASS THE 3/4"

CONTRACTOR IS RESPONSIBLE FOR SURVEY COORDINATION AND COSTS.

26. DRAINAGE OUTLETS (STUB-OUTS) SHALL BE PROVIDED FOR EACH INDIVIDUAL LOT, EXCEPT FOR THOSE LOTS APPROVED FOR INFILTRATION BY THE CITY OF PORT ORCHARD. STUB-OUTS SHALL CONFORM TO THE FOLLOWING:

A. EACH OUTLET SHALL BE SUITABLY LOCATED AT THE LOWEST ELEVATION ON THE LOT TO SERVICE ALL FUTURE ROOF DOWNSPOUTS AND FOOTING DRAINS, DRIVEWAYS, YARD DRAINS, AND ANY OTHER SURFACE OR SUBSURFACE DRAINS NECESSARY TO RENDER THE LOTS SUITABLE FOR THEIR INTENDED USE. EACH OUTLET SHALL HAVE FREE-FLOWING, POSITIVE DRAINAGE TO AN


APPROVED STORMWATER CONVEYANCE SYSTEM OR TO AN APPROVED OUTFALL LOCATION. B. OUTLETS ON EACH LOT SHALL BE LOCATED WITH A FIVE-FOOT-HIGH, 2" X 4" STAKE MARKED "STORM" OR "DRAIN". THE STUB-OUT SHALL EXTEND ABOVE SURFACE LEVEL, BE VISIBLE, AND BE SECURED TO THE

C. PIPE MATERIAL SHALL BE IN ACCORDANCE WITH PORT ORCHARD DESIGN STANDARDS. IF NON-METALLIC. THE PIPE SHALL CONTAIN A WIRE OR USE OTHER ACCEPTABLE MEANS OF DETECTION. D. DRAINAGE EASEMENTS ARE REQUIRED FOR DRAINAGE SYSTEMS DESIGNED TO CONVEY FLOWS THROUGH INDIVIDUAL LOTS.

E. THE APPLICANT/CONTRACTOR IS RESPONSIBLE FOR COORDINATING THE LOCATIONS OF ALL STUB OU CONVEYANCE LINES WITH RESPECT TO OTHER UTILITIES (E.G., POWER, GAS, TELEPHONE, TELEVISION,

F. ALL INDIVIDUAL STUB-OUTS SHALL BE PRIVATELY OWNED AND MAINTAINED BY THE LOT HOMEOWNER

6 DRAINAGE NOTES

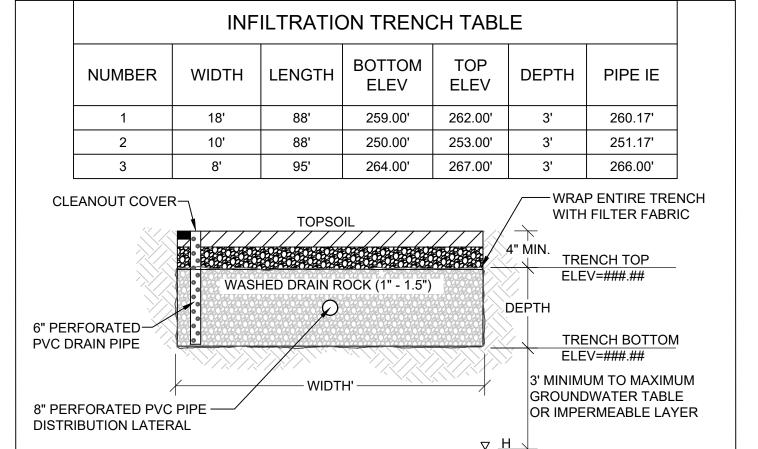

 ${f /4}$ ackslash INFILTRATION TRENCH SECTION

CONTOUR APARTMENTS REZONE DRAINAGE NOTES AND DETAILS

DATE SEALED ___4/7/2022

CONTOUR CONSTRUCTION GROUP

3206 HORSEHEAD BAY DRIVE NW GIG HARBOR, WA 98335 (206) 650 - 7435



217 S.W. Wilkins Drive Phone (360) 876-3770 E-mail: wse@wsengineering.com

Port Orchard, Wa. 98366 Fax (360) 876-0439 http://www.wsengineering.com

JOB No. **2768.1**


SHT **C6** OF **11** SHTS

ALL STEEL PARTS TO BE GALVANIZED AND ASPHALT COATED (TREATMENT I OR BETTER).

HOOPS


CONTOUR APARTMENTS REZONE

DRAINAGE NOTES AND DETAILS

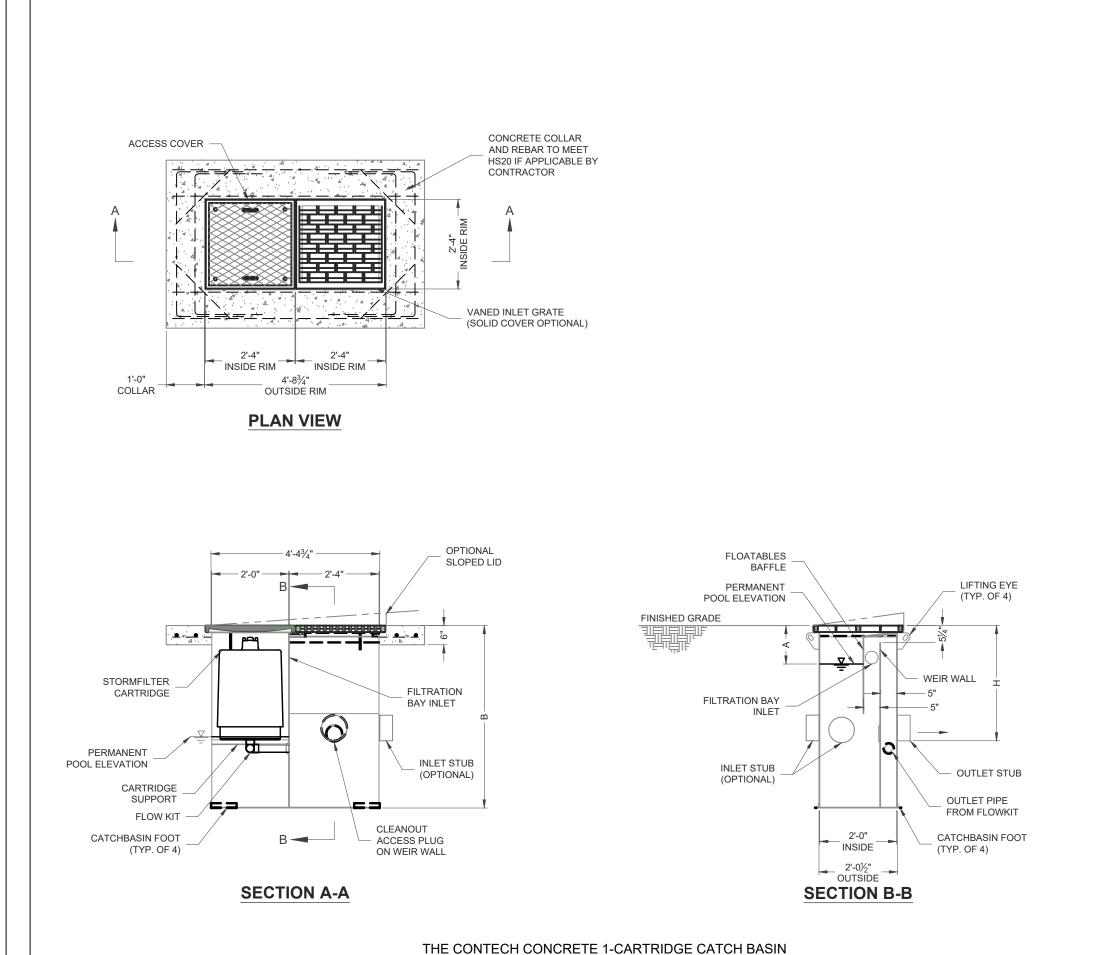

IS AN ACCEPTABLE ALTERNATIVE

1 CONTECH 1-CARTRIDGE STORMFILTER CATCH BASIN

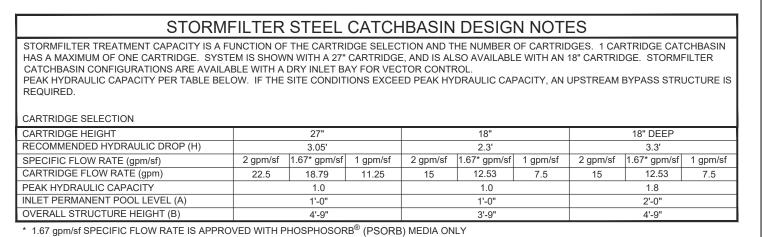

1. CONTECH TO PROVIDE ALL MATERIALS UNLESS NOTED OTHERWISE


- 2. FOR SITE SPECIFIC DRAWINGS WITH DETAILED STORMFILTER CATCHBASIN STRUCTURE DIMENSIONS AND WEIGHTS. PLEASE CONTACT YOUR
- CONTECH ENGINEERED SOLUTIONS LLC REPRESENTATIVE. www.contechES.com 3. STORMFILTER CATCHBASIN WATER QUALITY STRUCTURE SHALL BE IN ACCORDANCE WITH ALL DESIGN DATA AND INFORMATION CONTAINED IN
- 4. INLET SHOULD NOT BE LOWER THAN OUTLET. INLET (IF APPLICABLE) AND OUTLET PIPING TO BE SPECIFIED BY ENGINEER AND PROVIDED BY CONTRACTOR.
- 5. MANUFACTURER TO APPLY A SURFACE BEAD WELD IN THE SHAPE OF THE LETTER "O" ABOVE THE OUTLET PIPE STUB ON THE EXTERIOR SURFACE OF THE STEEL SFCB.
- 6. STORMFILTER CATCHBASIN EQUIPPED WITH 4 INCH (APPROXIMATE) LONG STUBS FOR INLET (IF APPLICABLE) AND OUTLET PIPING. STANDARD OUTLET STUB IS 8 INCHES IN DIAMETER. MAXIMUM OUTLET STUB IS 15 INCHES IN DIAMETER. CONNECTION TO COLLECTION PIPING CAN BE MADE
- USING FLEXIBLE COUPLING BY CONTRACTOR. 7. STEEL STRUCTURE TO BE MANUFACTURED OF 1/4 INCH STEEL PLATE. CASTINGS SHALL MEET AASHTO M306 LOAD RATING. TO MEET HS20 LOAD RATING ON STRUCTURE, A CONCRETE COLLAR IS REQUIRED. WHEN REQUIRED, CONCRETE COLLAR WITH #4 REINFORCING BARS TO BE PROVIDED
- 8. FILTER CARTRIDGES SHALL BE MEDIA-FILLED, PASSIVE, SIPHON ACTUATED, RADIAL FLOW, AND SELF CLEANING. RADIAL MEDIA DEPTH SHALL BE
- 7-INCHES. FILTER MEDIA CONTACT TIME SHALL BE AT LEAST 38 SECONDS. 9. SPECIFIC FLOW RATE IS EQUAL TO THE FILTER TREATMENT CAPACITY (gpm) DIVIDED BY THE FILTER CONTACT SURFACE AREA (sq ft)
- INSTALLATION NOTES


 A. ANY SUB-BASE, BACKFILL DEPTH, AND/OR ANTI-FLOTATION PROVISIONS ARE SITE-SPECIFIC DESIGN CONSIDERATIONS AND SHALL BE SPECIFIED BY
- B. CONTRACTOR TO PROVIDE EQUIPMENT WITH SUFFICIENT LIFTING AND REACH CAPACITY TO LIFT AND SET THE CATCHBASIN (LIFTING CLUTCHES
- C. CONTRACTOR TO TAKE APPROPRIATE MEASURES TO PROTECT CARTRIDGES FROM CONSTRUCTION-RELATED EROSION RUNOFF


1-CARTRIDGE CATCHBASIN					
STORMFILTER DATA					
STRUCTURE ID	STRUCTURE ID				
WATER QUALITY FLOW RATE (cfs)	WATER QUALITY FLOW RATE (cfs)				
PEAK FLOW RATE (<1 cfs)		0.53			
RETURN PERIOD OF PEAK FLOW (yrs)	RETURN PERIOD OF PEAK FLOW (yrs)				
CARTRIDGE HEIGHT (27", 18", 18" DEE	CARTRIDGE HEIGHT (27", 18", 18" DEÉP)				
CARTRIDGE FLOW RATE (gpm)	11.25				
MEDIA TYPE (PERLITE, ZPG, PSORB)	ZPG				
RIM ELEVATION	RIM ELEVATION				
PIPE DATA:	I.E.	DIAMETER			
INLET STUB	264.49'	12"			
OUTLET STUB	264.49'	8"			
CONFIGURATION OUTLET C	UTLET				
INLET (NLET) INL NLET	ET			
INLET	NLEI				
SLOPED LID		NO			
SOLID COVER		NO			
NOTES (SPECIAL PEGLUPENATUE)					
NOTES/SPECIAL REQUIREMENTS:					


1-CARTRIDGE CATCHBASIN				
STORMFILTER DATA				
STRUCTURE ID		SFCB#2		
WATER QUALITY FLOW RATE (cfs)		0.0130		
PEAK FLOW RATE (<1 cfs)		0.37		
RETURN PERIOD OF PEAK FLOW (yrs))	100		
CARTRIDGE HEIGHT (27", 18", 18" DEE	EP)	18"		
CARTRIDGE FLOW RATE (gpm)		7.5		
MEDIA TYPE (PERLITE, ZPG, PSORB)		ZPG		
RIM ELEVATION		256.42'		
PIPE DATA:	I.E.	DIAMETER		
INLET STUB	252.79'	12"		
OUTLET STUB	252.79'	8"		
CONFIGURATION				
OUTLET	DUTLET	- 1		
INLET (INL	ET		
INLET	INLET			
SLOPED LID		NO		
SOLID COVER		YES		
NOTES/SPECIAL REQUIREMENTS:				

245

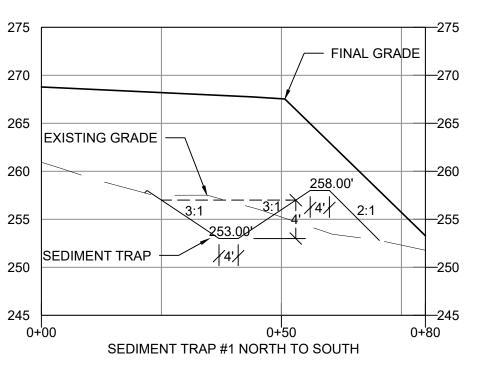

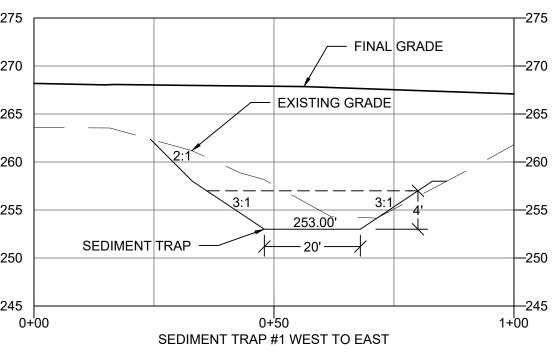


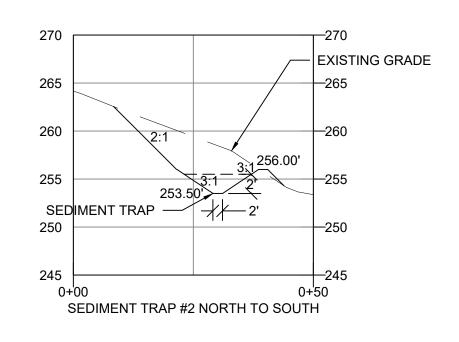

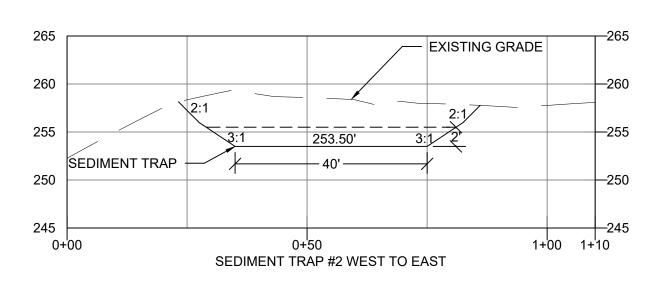

2 TEMPORARY SEDIMENT TRAP CROSS-SECTIONS

CTB DRAWN BY SEC 35 TWN 24N R 1E DESCRIPTION DATE SEALED <u>4/7/202</u>2

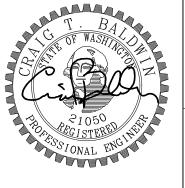

CONTOUR APARTMENTS REZONE DRAINAGE NOTES AND DETAILS

CONTOUR CONSTRUCTION GROUP

3206 HORSEHEAD BAY DRIVE NW GIG HARBOR, WA 98335 (206) 650 - 7435



217 S.W. Wilkins Drive Phone (360) 876-3770 E-mail: wse@wsengineering.com

Port Orchard, Wa. 98366 Fax (360) 876-0439 http://www.wsengineering.com

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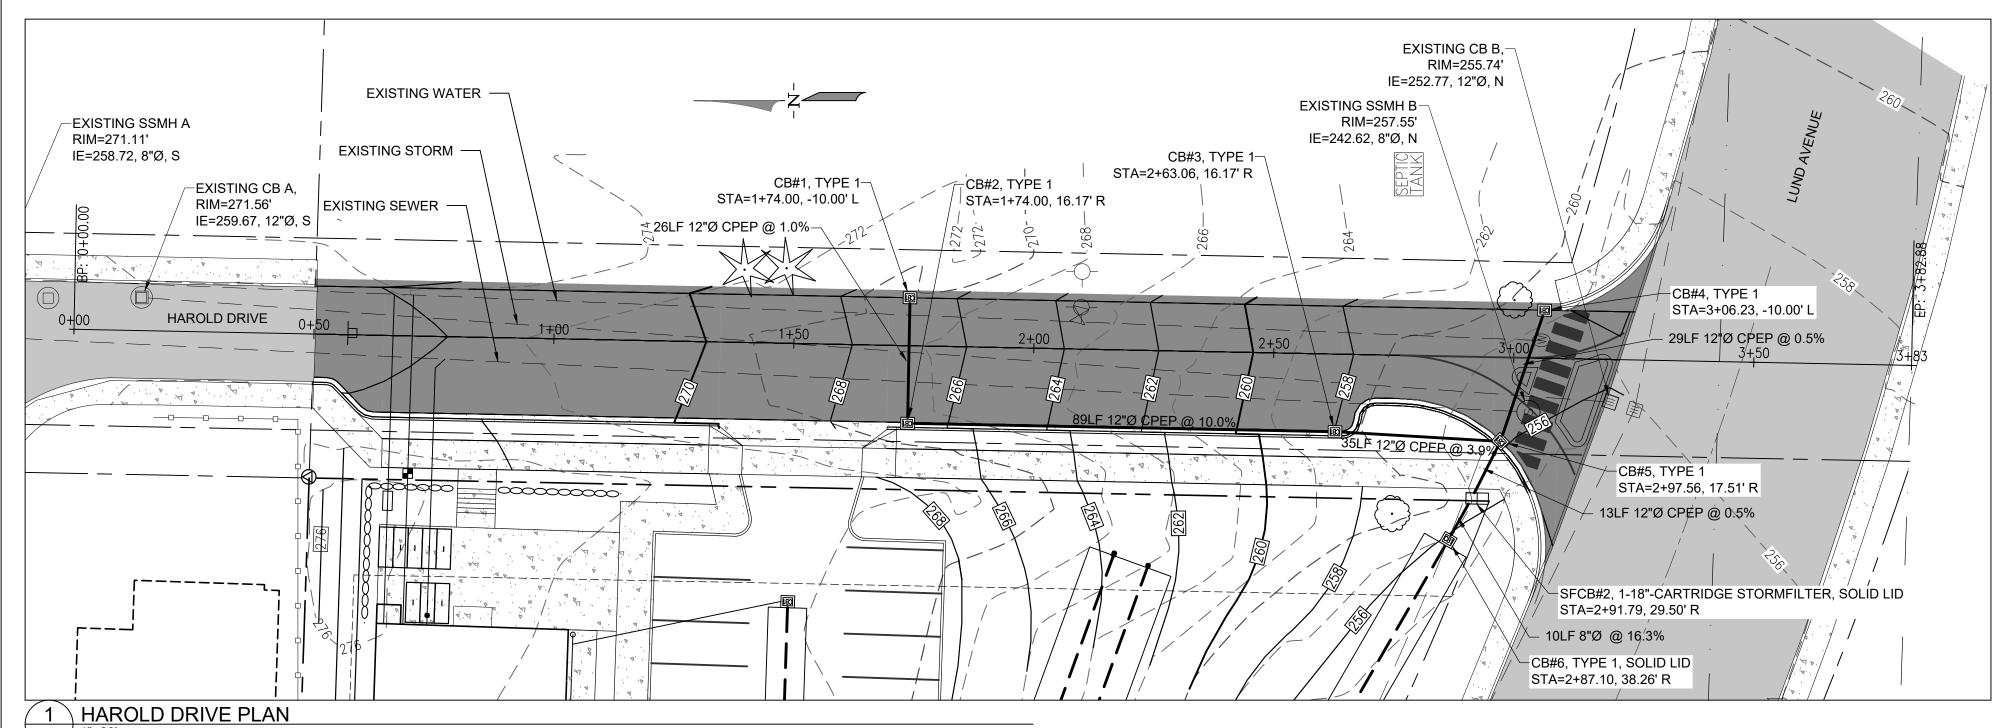
SHT **C7** OF **11** SHTS


ONE-CALL (# 1-800-424-5555):


BURIED UTILITIES ARE SHOWN AS INDICATED ON RECORD MAPS FURNISHED BY OTHERS AND VERIFIED WHERE POSSIBLE BY FEATURES LOCATED IN THE FIELD. WESTSOUND ENGINEERING, ASSUMES NO LIABILITY FOR THE ACCURACY OF THOSE RECORDS. OR FOR THE FINAL LOCATION OF EXISTING UTILITIES IN AREAS CRITICAL TO DESIGN.


CONTOUR APARTMENTS REZONE

HAROLD DRIVE PLAN AND PROFILE



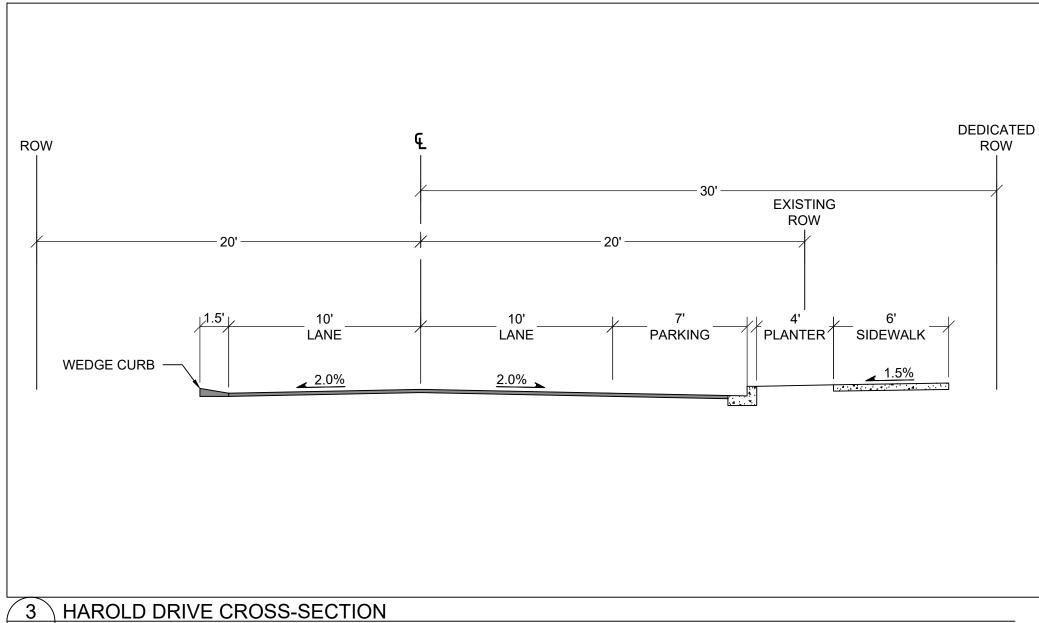

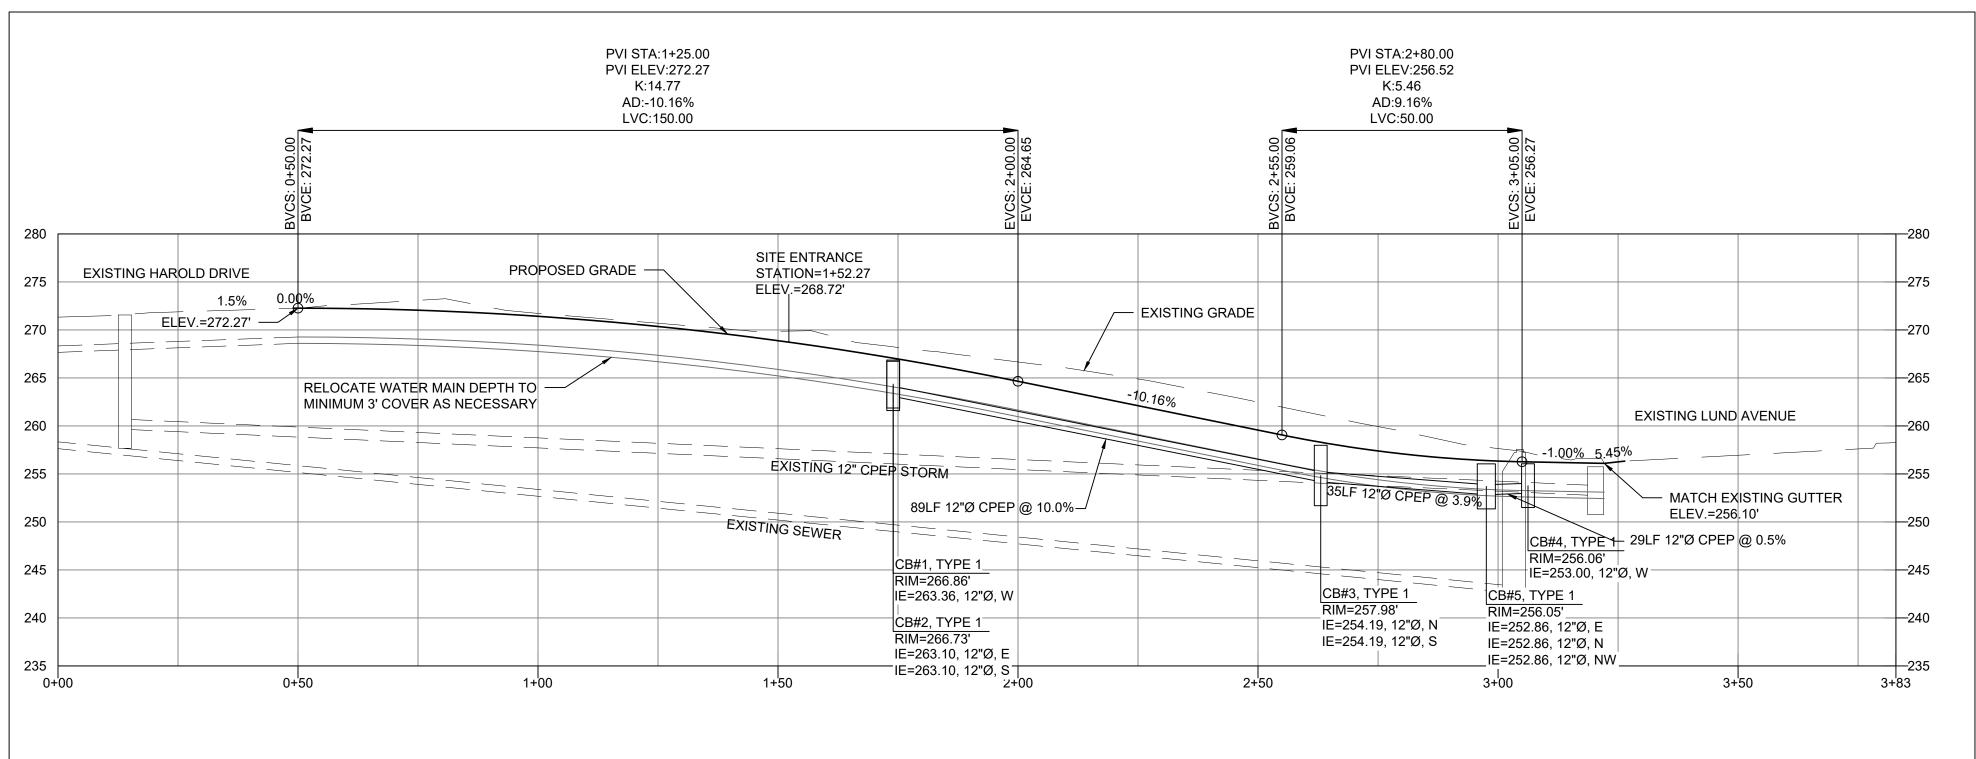


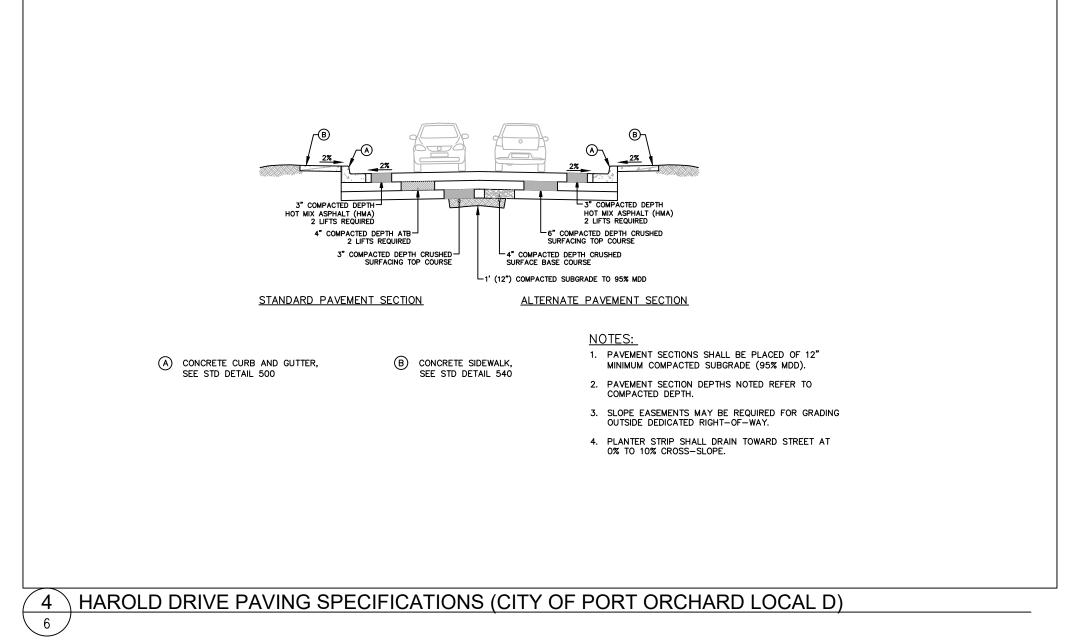

2 HAROLD DRIVE PROFILE 6 H: 1"=20', V: 1"=10'

MONUMENT REMOVAL PERMIT PROCESS

NO SURVEY MONUMENT SHALL BE REMOVED OR DESTROYED (THE PHYSICAL DISTURBANCE OR COVERING OF A MONUMENT SUCH THAT THE SURVEY POINT IS NO LONGER VISIBLE OR READILY ACCESSIBLE) BEFORE A PERMIT IS OBTAINED FROM THE DEPARTMENT OF NATURAL RESOURCES (DNR), WAC 332-120-030(2) STATES "IT IS THE RESPONSIBILITY OF THOSE PERFORMING CONSTRUCTION WORK OR OTHER ACTIVITY (INCLUDING ROAD AND STREET RESURFACING PROJECTS) TO ADEQUATELY SEARCH THE RECORDS AND THE PHYSICAL AREA OF THE PROPOSED CONSTRUCTION WORK OR OTHER ACTIVITY FOR THE PURPOSE OF LOCATING AND REFERENCING ANY KNOWN OR EXISTING SURVEY MONUMENTS." CONSTRUCTION SHALL NOT COMMENCE UNTIL WAC OUTLINED IN CHAPTER 332-120 IS COMPLIED WITH.

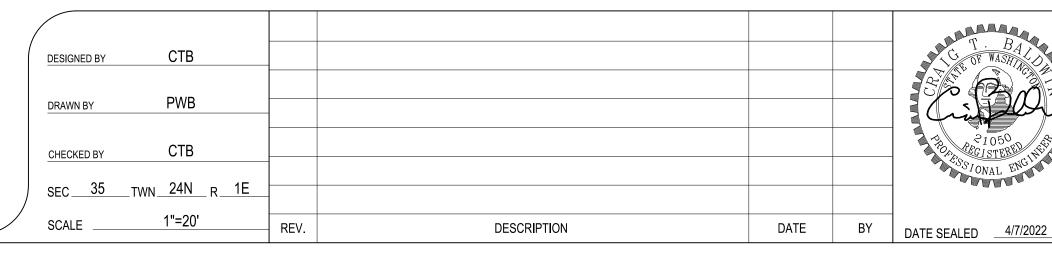

CONTOUR APARTMENTS REZONE HAROLD DRIVE PLAN AND PROFILE

CONTOUR CONSTRUCTION GROUP

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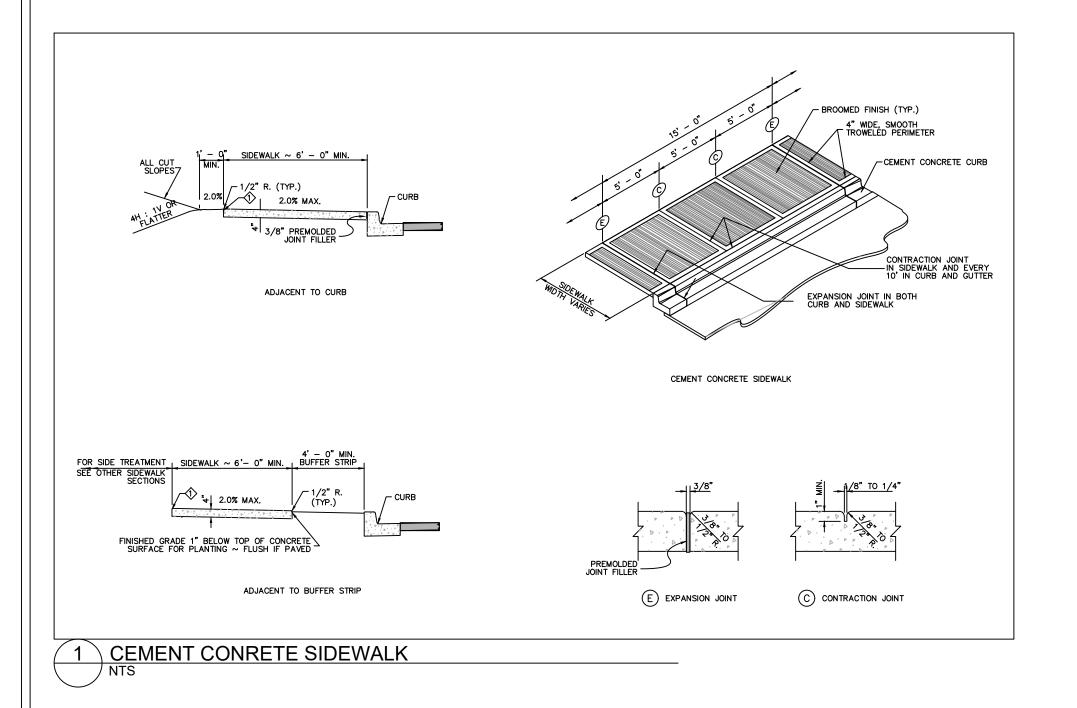
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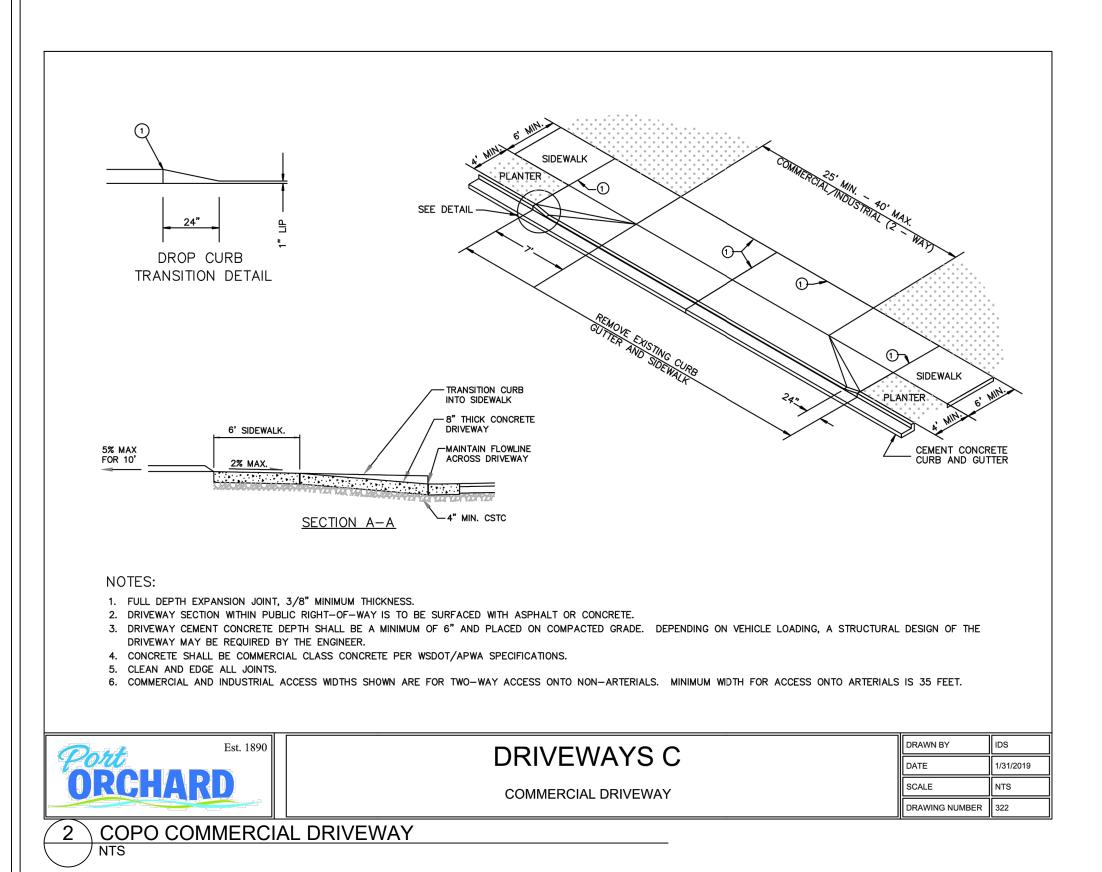
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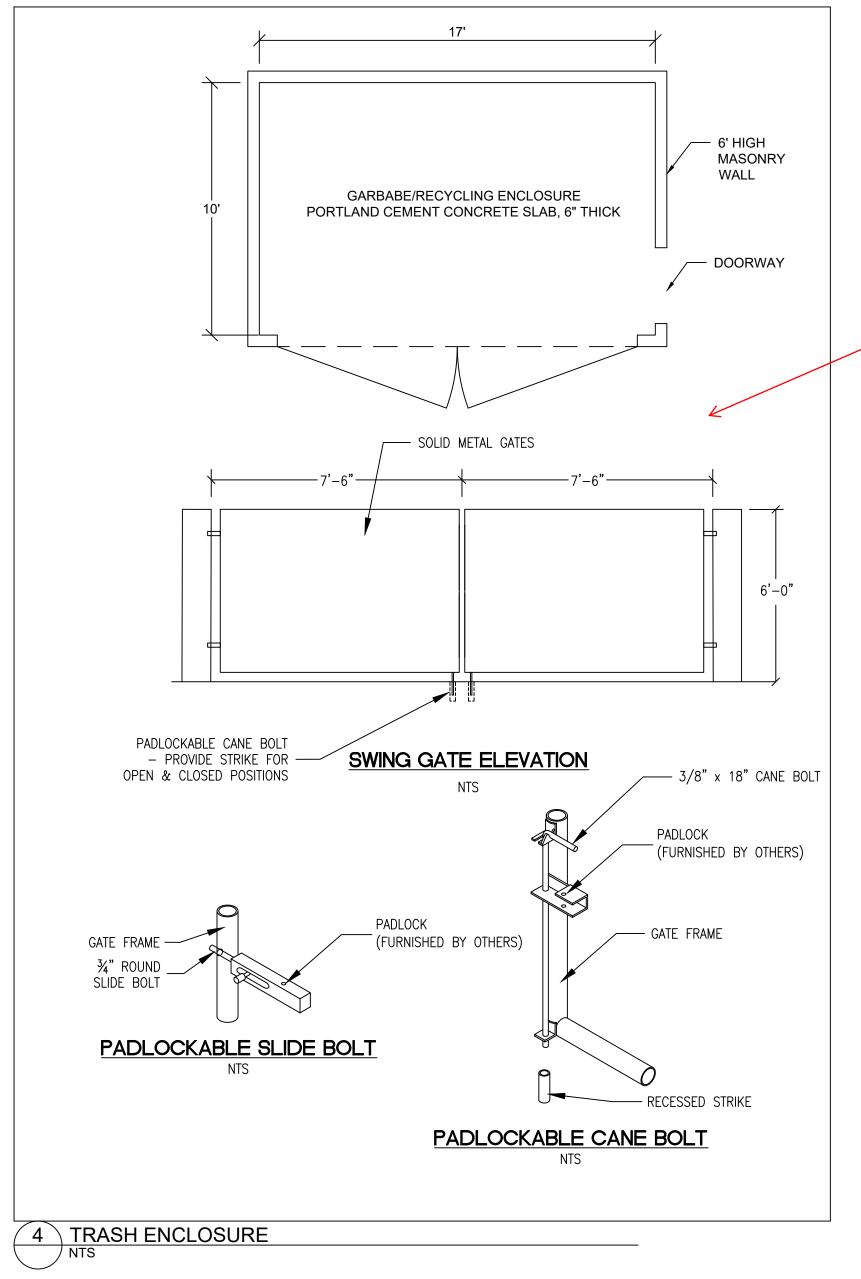
SHT **C8** OF **11** SHTS

CONTOUR APARTMENTS REZONE


ROAD NOTES AND DETAILS









- (3) Screening of Ground Related Service Areas and Mechanical Equipment.
- (a) Where screening of ground level service areas is called for, adhere to the following:
- (i) A structural enclosure must be constructed of masonry, heavy-gauge metal, or decay-resistant material that is also used with the architecture of the main building. The reviewing authority may allow materials other than those used for the main building if the finishes are similar in color and texture or if the proposed enclosure materials are more durable than those for the main structure. The walls must be sufficient to provide full screening from the affected roadway, pedestrian areas or adjacent use. The enclosure may use overlapping walls to screen dumpsters and other materials (see Figure 20.127.360(3) below).
- (ii) Gates must be made of heavy-gauge, site-obscuring material. Chain link or chain link with slats is not an acceptable material for enclosures or gates.
- (iii) Where the inside of service enclosures are visible from surrounding streets, walkways, and buildings, an opaque or semi-opaque horizontal cover or screen must be used to mitigate unsightly views. The horizontal screen/cover should be integrated into the enclosure design and compatible with adjacent development.
- (iv) Collection points must be located and configured so that the enclosure gate swing does not obstruct pedestrian or vehicle traffic, or does not require that a hauling truck project into any public right-of-way. Ensure that screening elements allow for efficient service delivery and removal operations.
- (v) The service area must be paved.
- (b) The sides and rear of service enclosures must be screened with landscaping at least five feet wide in locations visible from the street, parking lots, and walkways to soften views of the screening element and add visual interest.

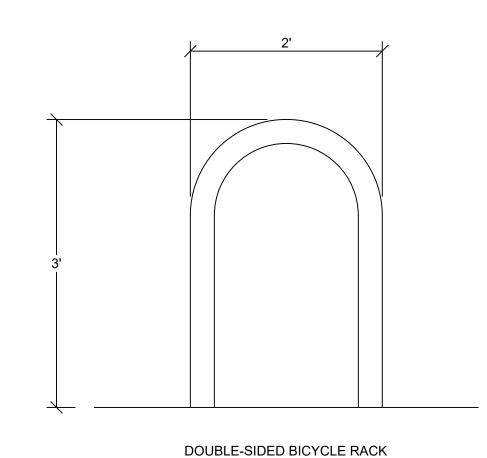

5 BICYCLE PARKING DETAILS

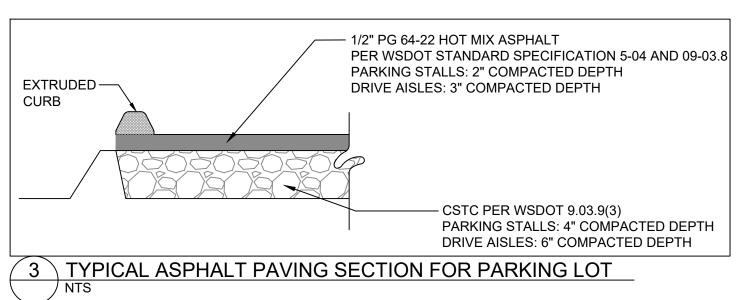

DESIGNED BY CTB	-				OF WASHING
DIMP					
DRAWN BY PWB					Cin Cin
CHECKED BY CTB					21050
					SSIONAL ENGLIS
SEC 35 TWN 24N R 1E					
SCALE	REV.	DESCRIPTION	DATE	BY	DATE SEALED <u>4/7/2022</u>
			1	ı	

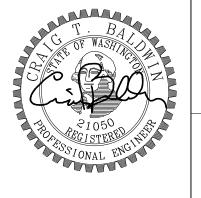

CONTOUR APARTMENTS REZONE ROAD NOTES AND DETAILS

CONTOUR CONSTRUCTION GROUP 3206 HORSEHEAD BAY DRIVE NW GIG HARBOR, WA 98335

(206) 650 - 7435



217 S.W. Wilkins Drive Phone (360) 876-3770 E-mail: wse@wsengineering.com


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SHT **C9** OF **11** SHTS

ONE-CALL (# 1-800-424-5555):
BURIED UTILITIES ARE SHOWN AS INDICATED ON RECORD MAPS FURNISHED BY OTHERS AND

CONTOUR APARTMENTS REZONE UTILITY PLAN



MONUMENT REMOVAL PERMIT PROCESS

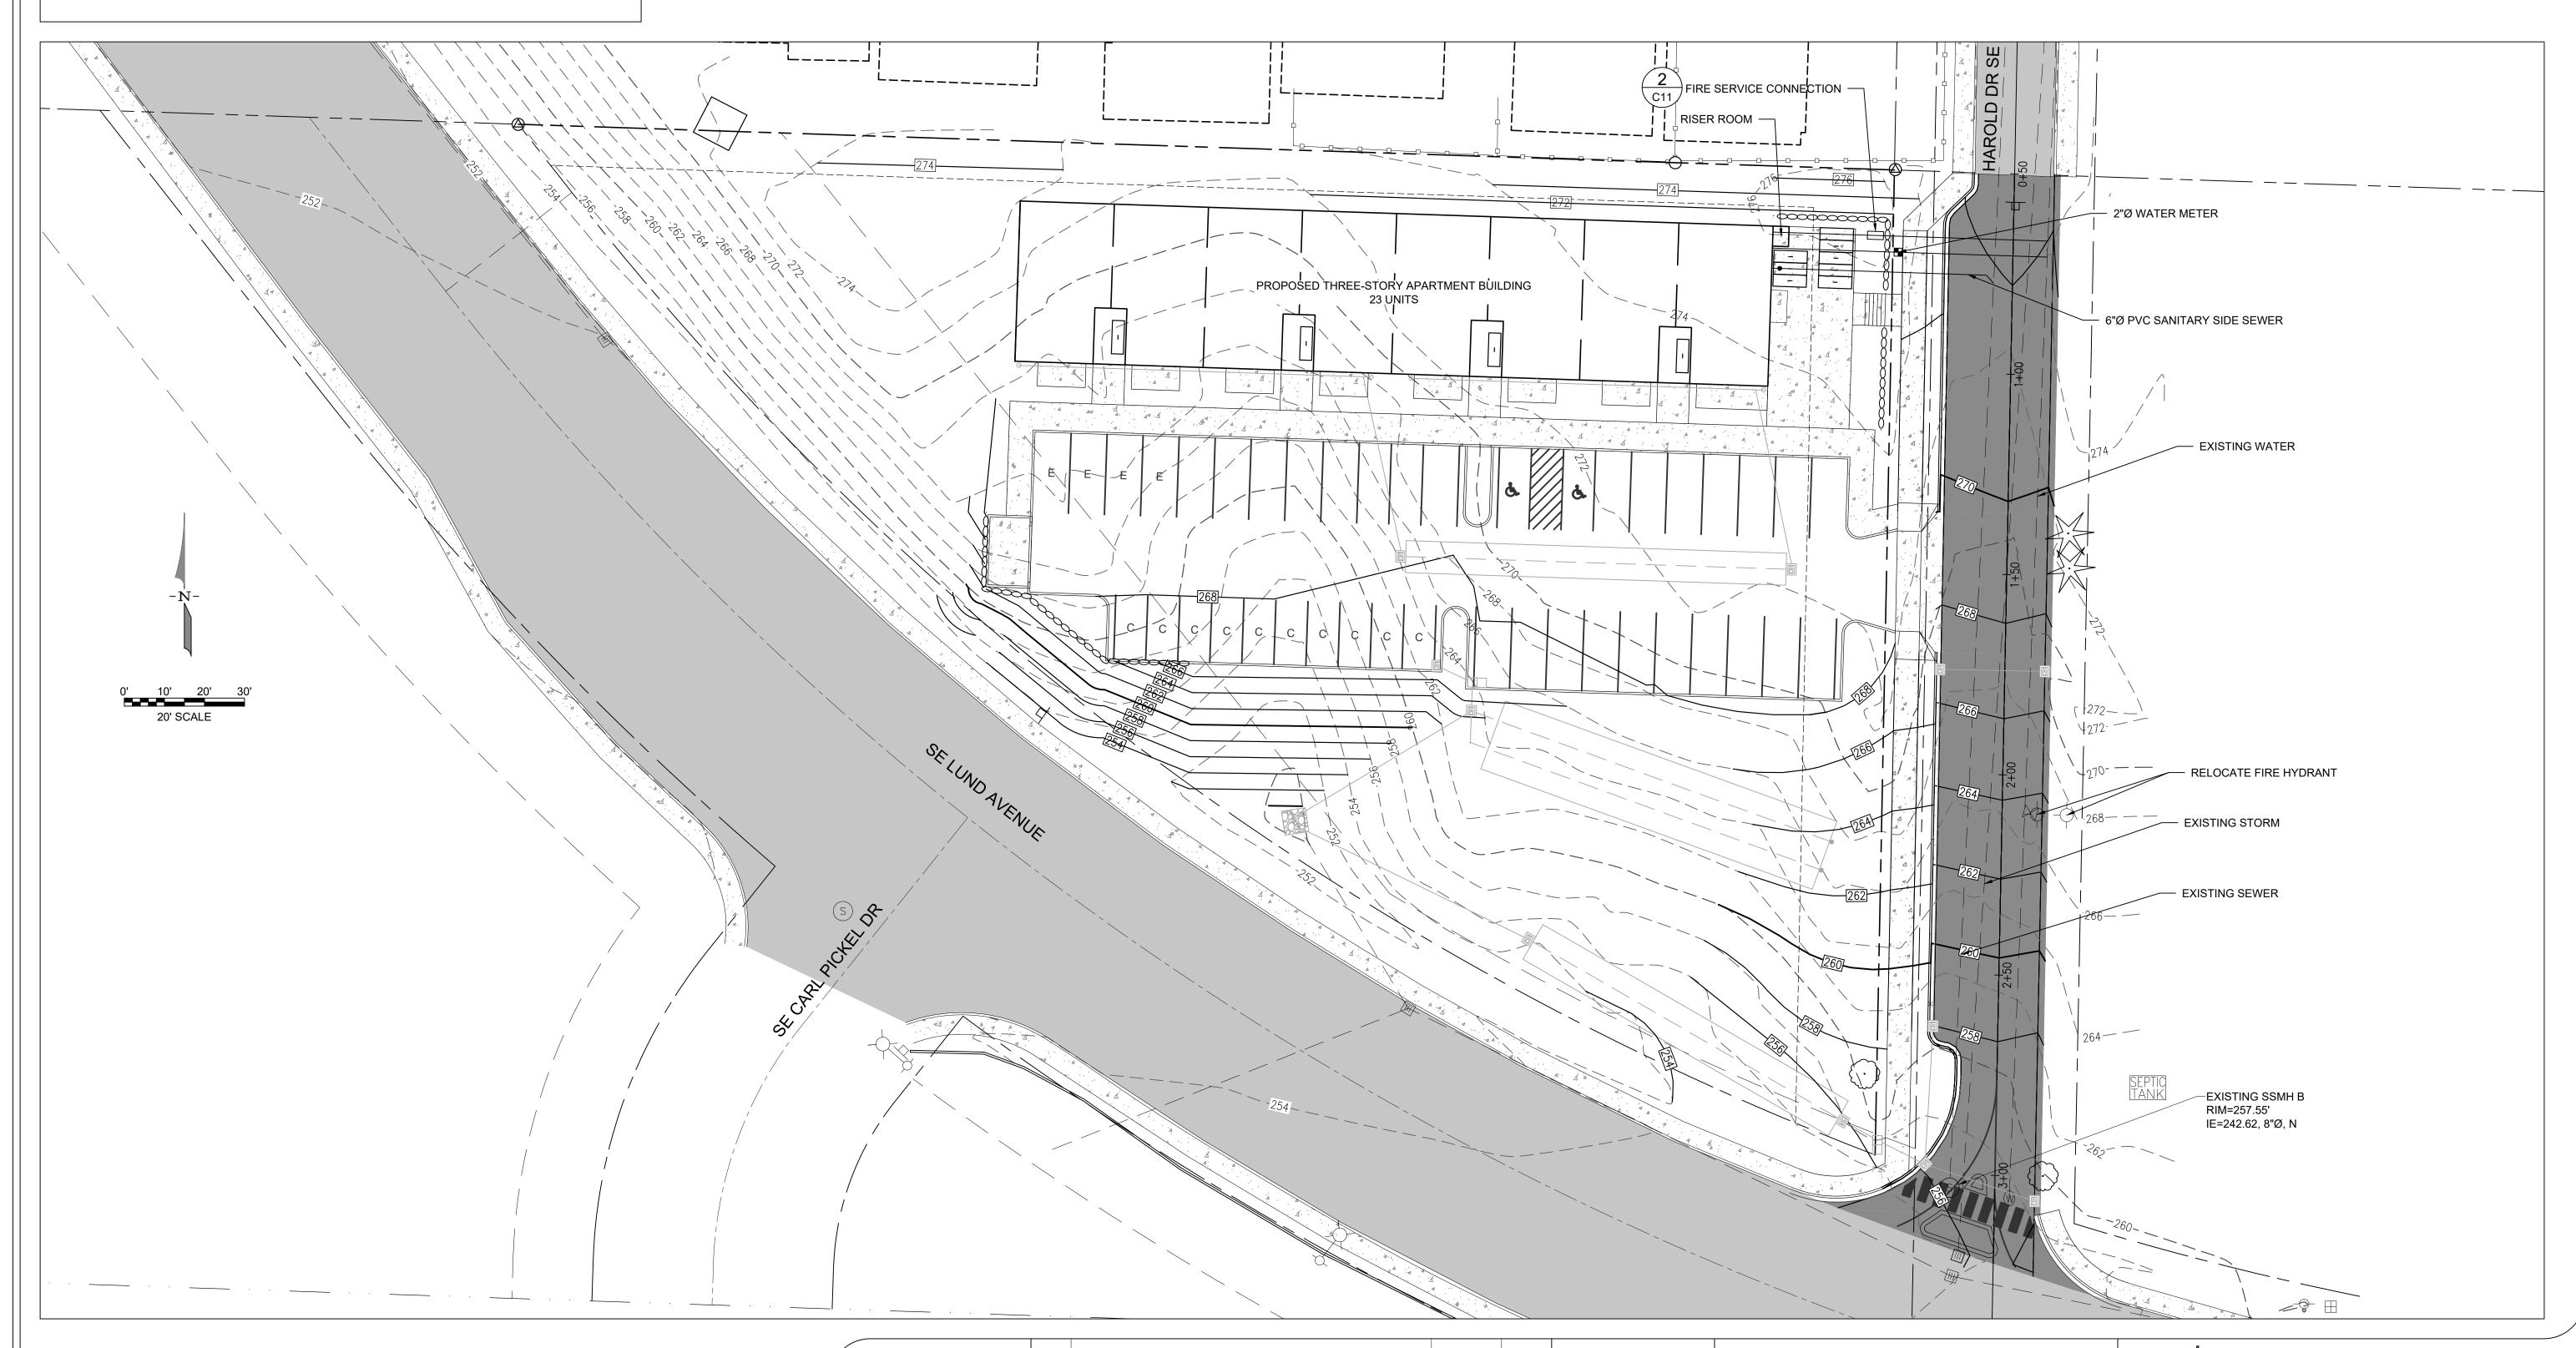NO SURVEY MONUMENT SHALL BE REMOVED OR DESTROYED (THE PHYSICAL DISTURBANCE OR CONSTRUCTION WORK OR OTHER ACTIVITY (INCLUDING ROAD AND STREET RESURFACING PROJECTS) TO ADEQUATELY SEARCH THE RECORDS AND THE PHYSICAL AREA OF THE PROPOSED ANY KNOWN OR EXISTING SURVEY MONUMENTS." CONSTRUCTION SHALL NOT COMMENCE UNTIL WAC OUTLINED IN CHAPTER 332-120 IS COMPLIED WITH.

DESIGNED BY CTB					
DIA/D					
DRAWN BY PWB					
CHECKED BY CTB					THO AND THE STREET
SEC 35 TWN 24N R 1E					
SCALE1"=20'	REV.	DESCRIPTION	DATE	BY	DATE SEA
		-			

CONTOUR APARTMENTS REZONE UTILITY PLAN

CONTOUR CONSTRUCTION GROUP

3206 HORSEHEAD BAY DRIVE NW GIG HARBOR, WA 98335 (206) 650 - 7435


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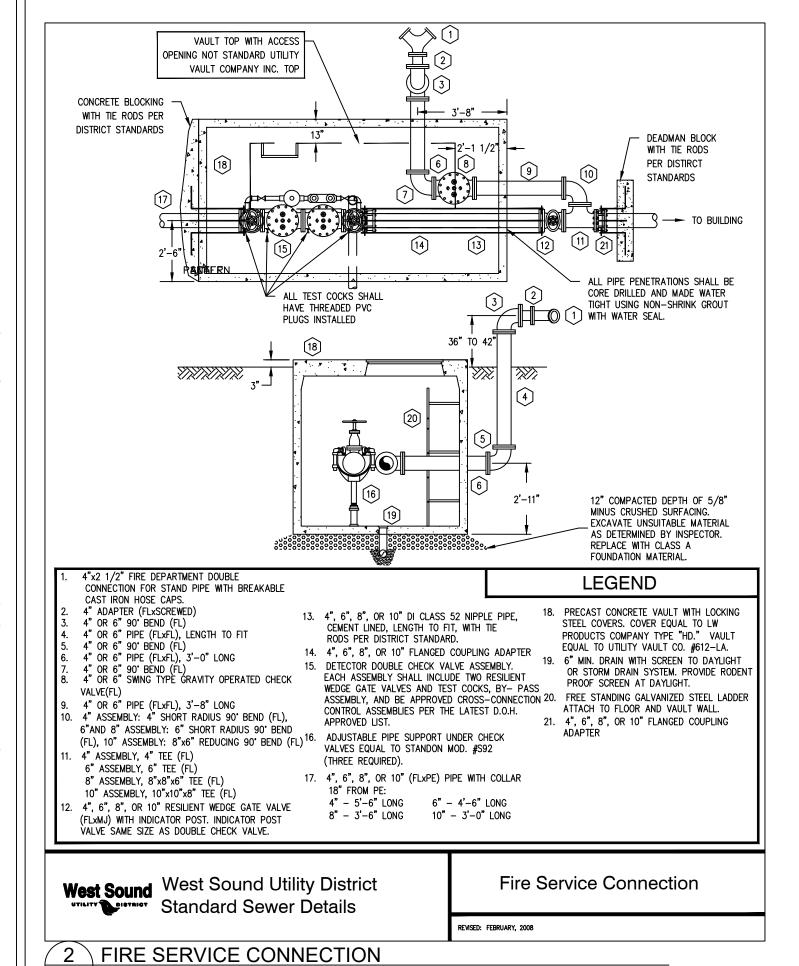
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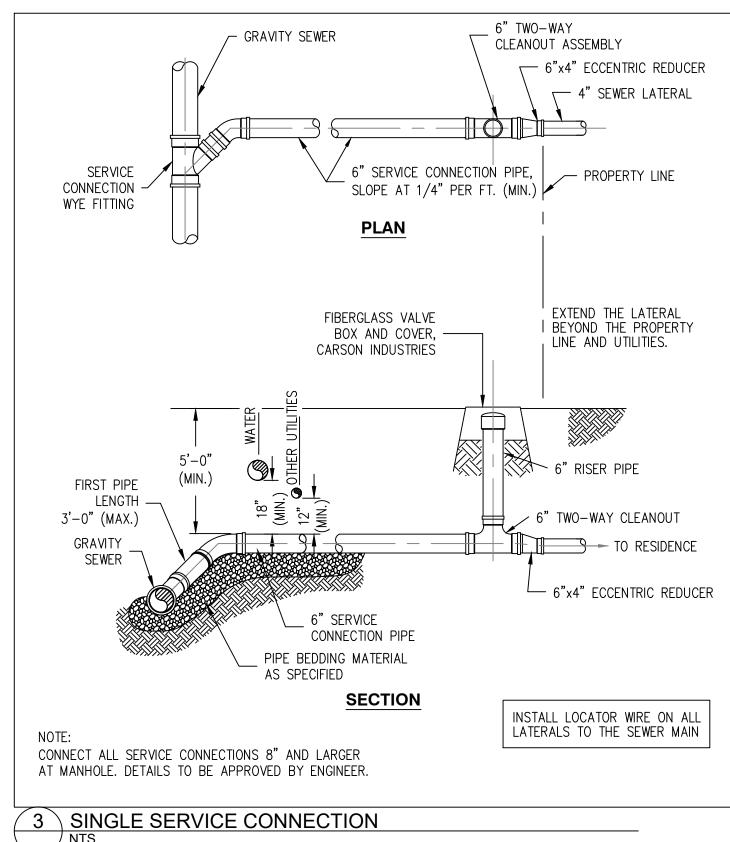
SHT **C10** OF **11** SHTS







CONTOUR APARTMENTS REZONE

WATER AND SANITARY SEWER NOTES AND DETAILS

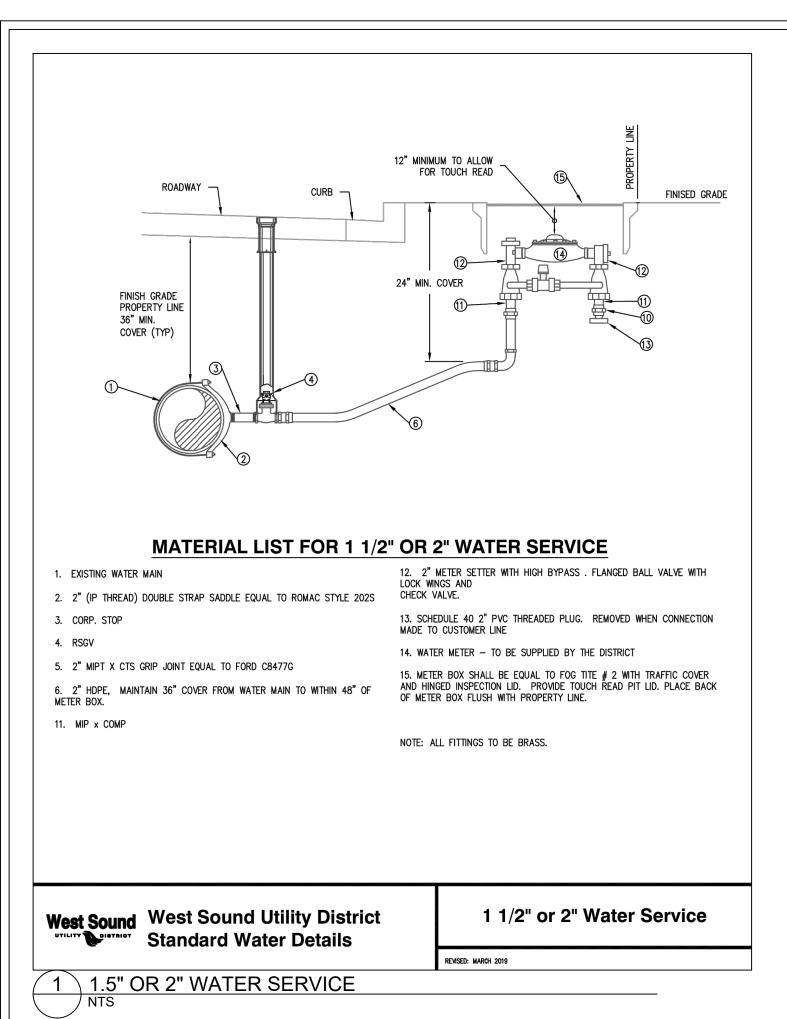

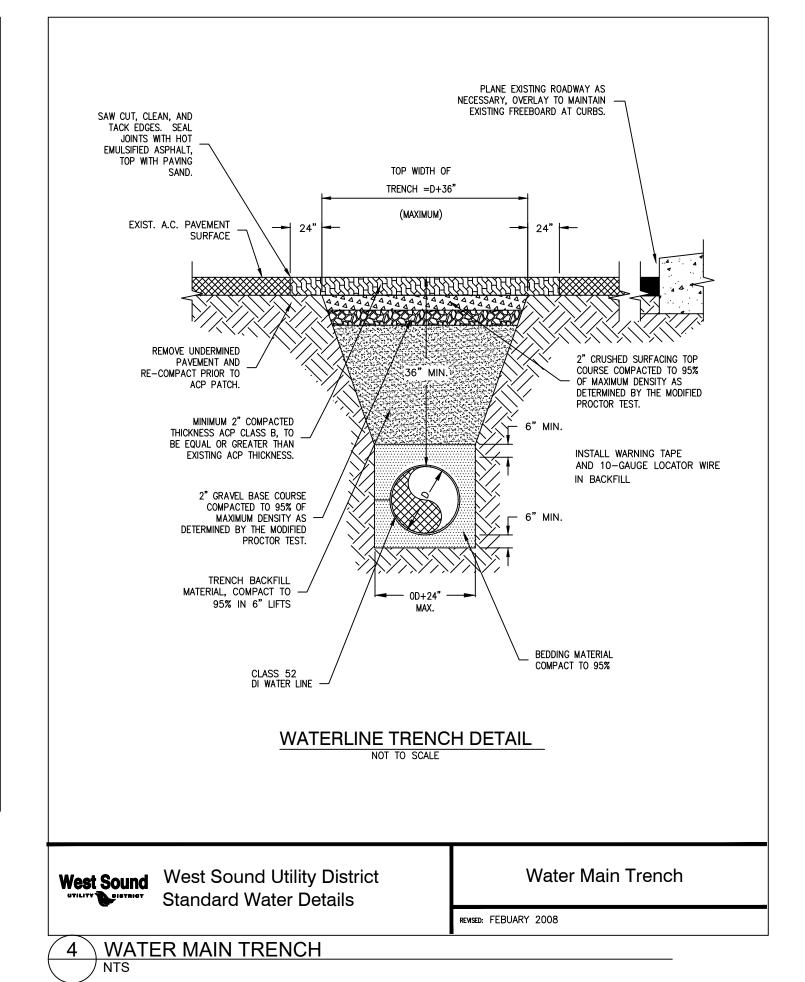

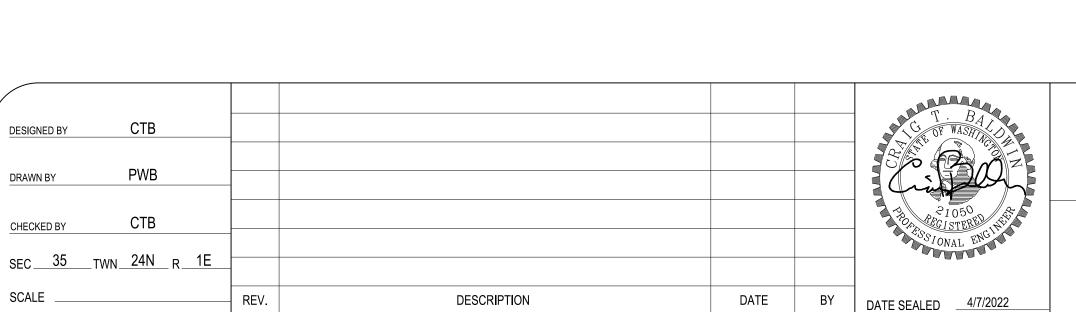

CONTOUR APARTMENTS REZONE WATER AND SANITARY SEWER NOTES AND DETAILS

CONTOUR CONSTRUCTION GROUP

3206 HORSEHEAD BAY DRIVE NW GIG HARBOR, WA 98335 (206) 650 - 7435

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JOB No. **2768.1**

SHT **C11** OF **11** SHTS