


Harbor Flats Residences at Loch Lomond



990 A Street, Suite K San Rafael, CA 9490 415.671.8892 tel.



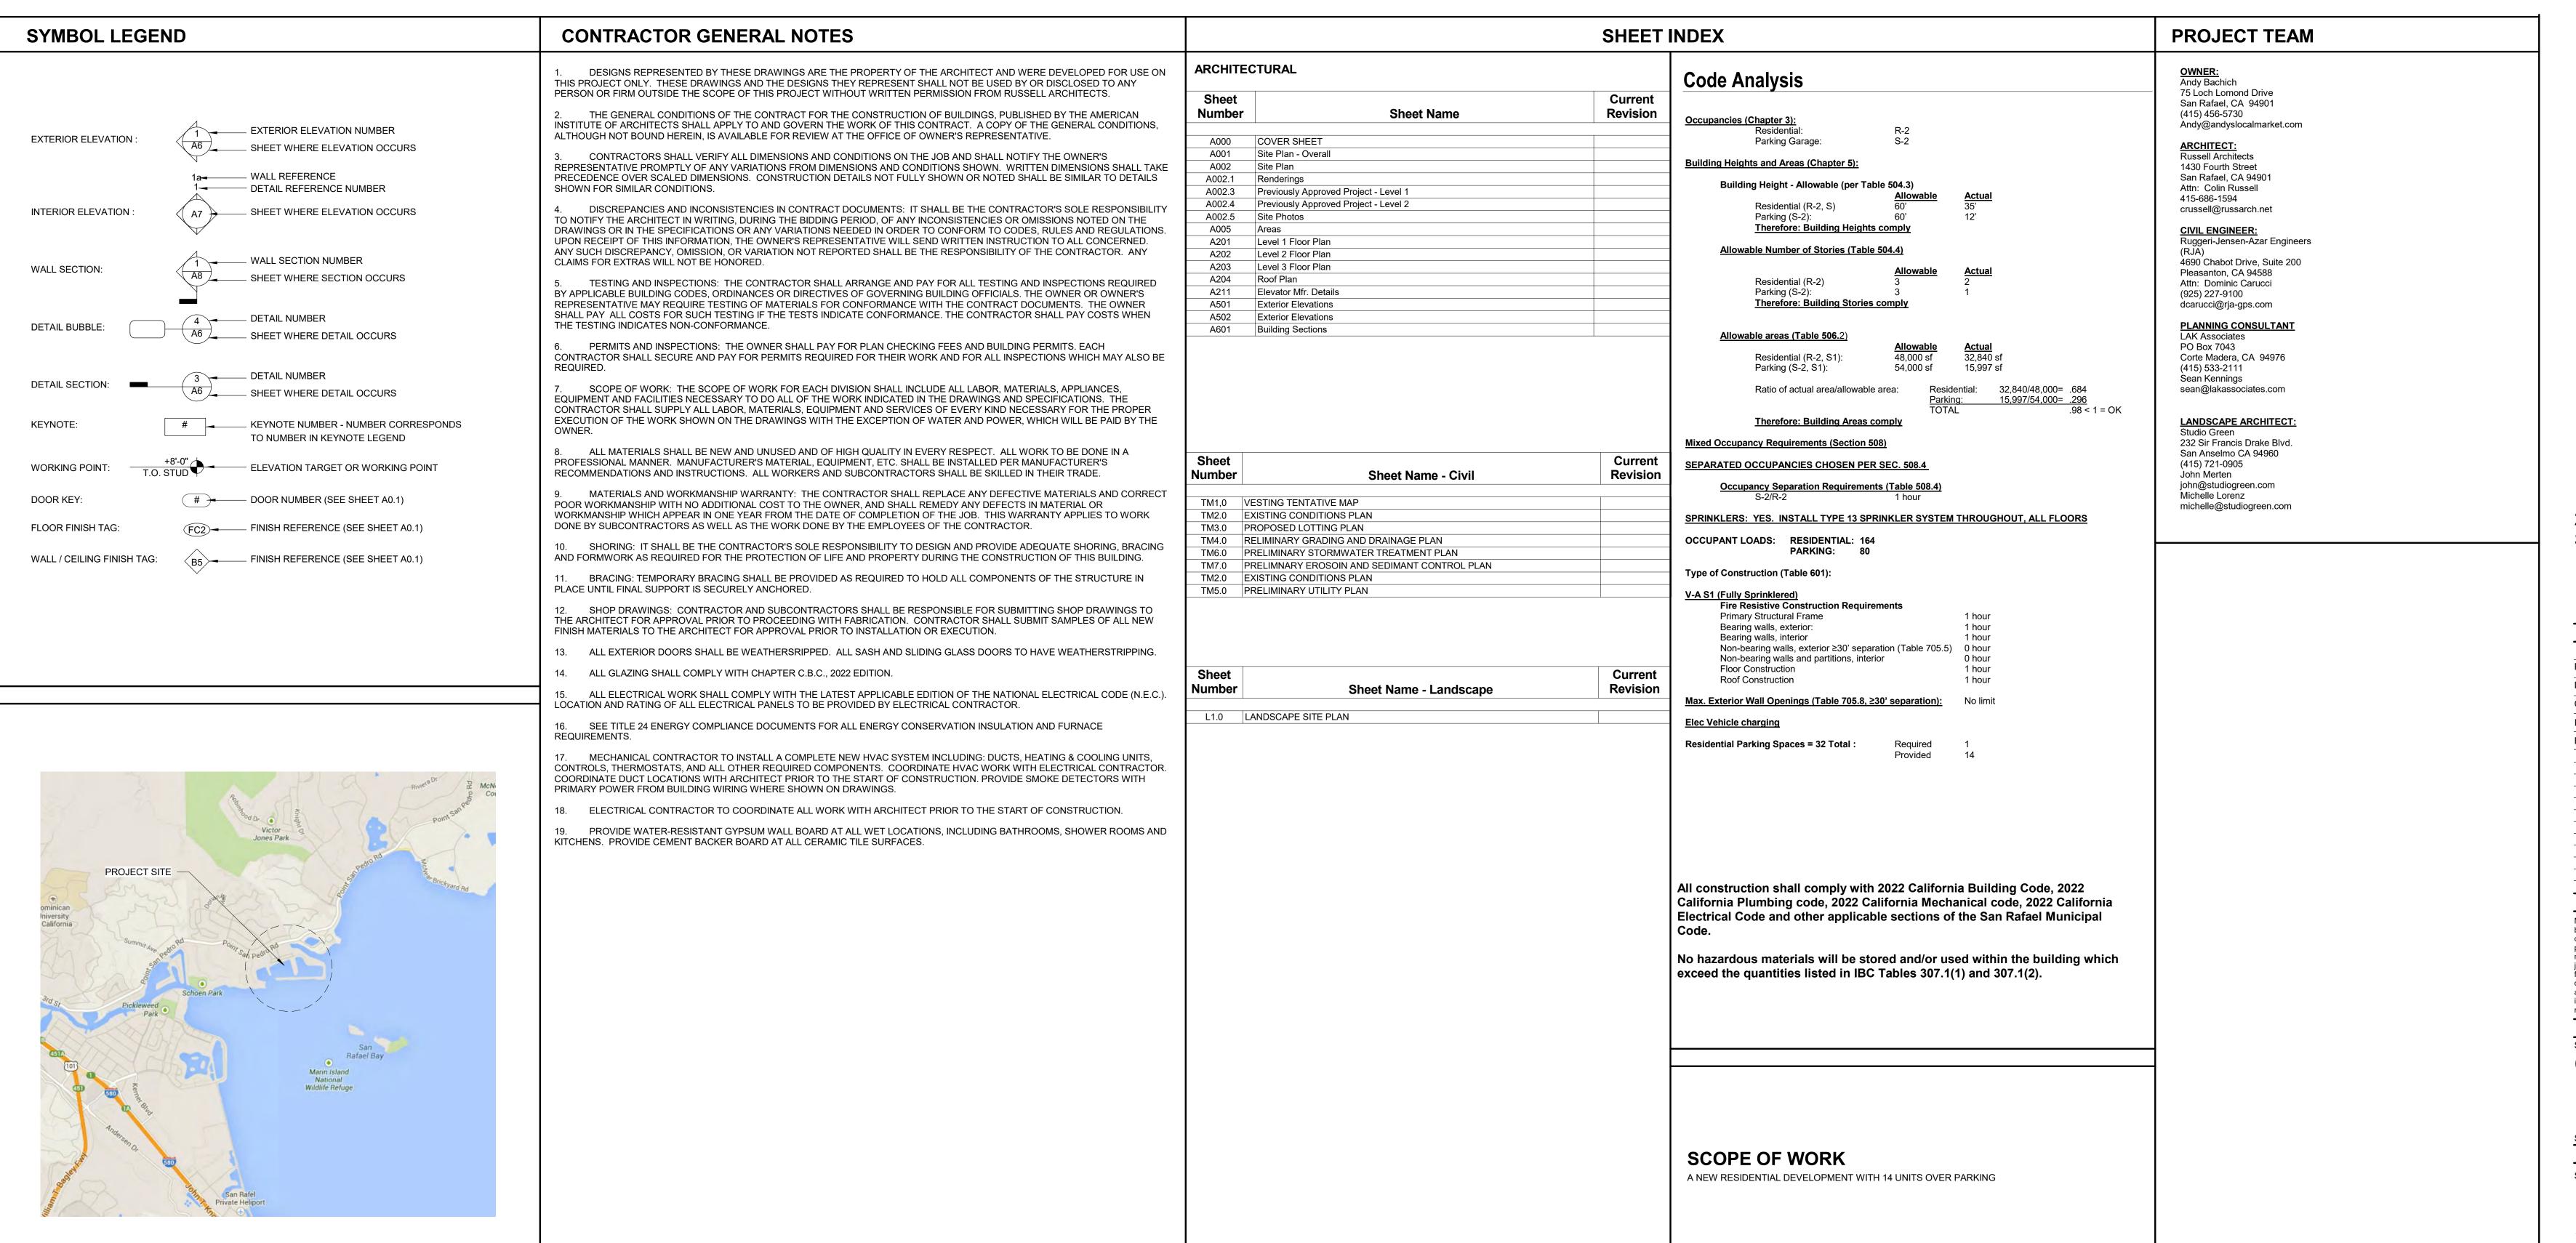

Harbor Flats at Loch Lomond

25 Loch Lomond Drive San Rafael, CA

Project No.:		223006
Drawn By:		SB/CR
Checked By:		CR
Issued Date:	PLANNING SUE	BMITTAL 4/17/25
Revisions		
No.	Description	Date


Material herein is for use by authorized contractors, bidders and subcontractors in connection with this project only. All dimensions an these drawings shall take precedence over scaled dimensions. Contractors shall be responsible to verify all dimensions and conditions on the job. Russell Architects must be notified of any variations from the dimensions and conditions shown by these drawings. Electronic files furnished by Russell Architects are strictly for reference only. Russell Architects shall be indemnified and held harmless for any and all modifications to such electronic files by others.

COVER SHEET

OOVER OHE

Sheet No:

A000

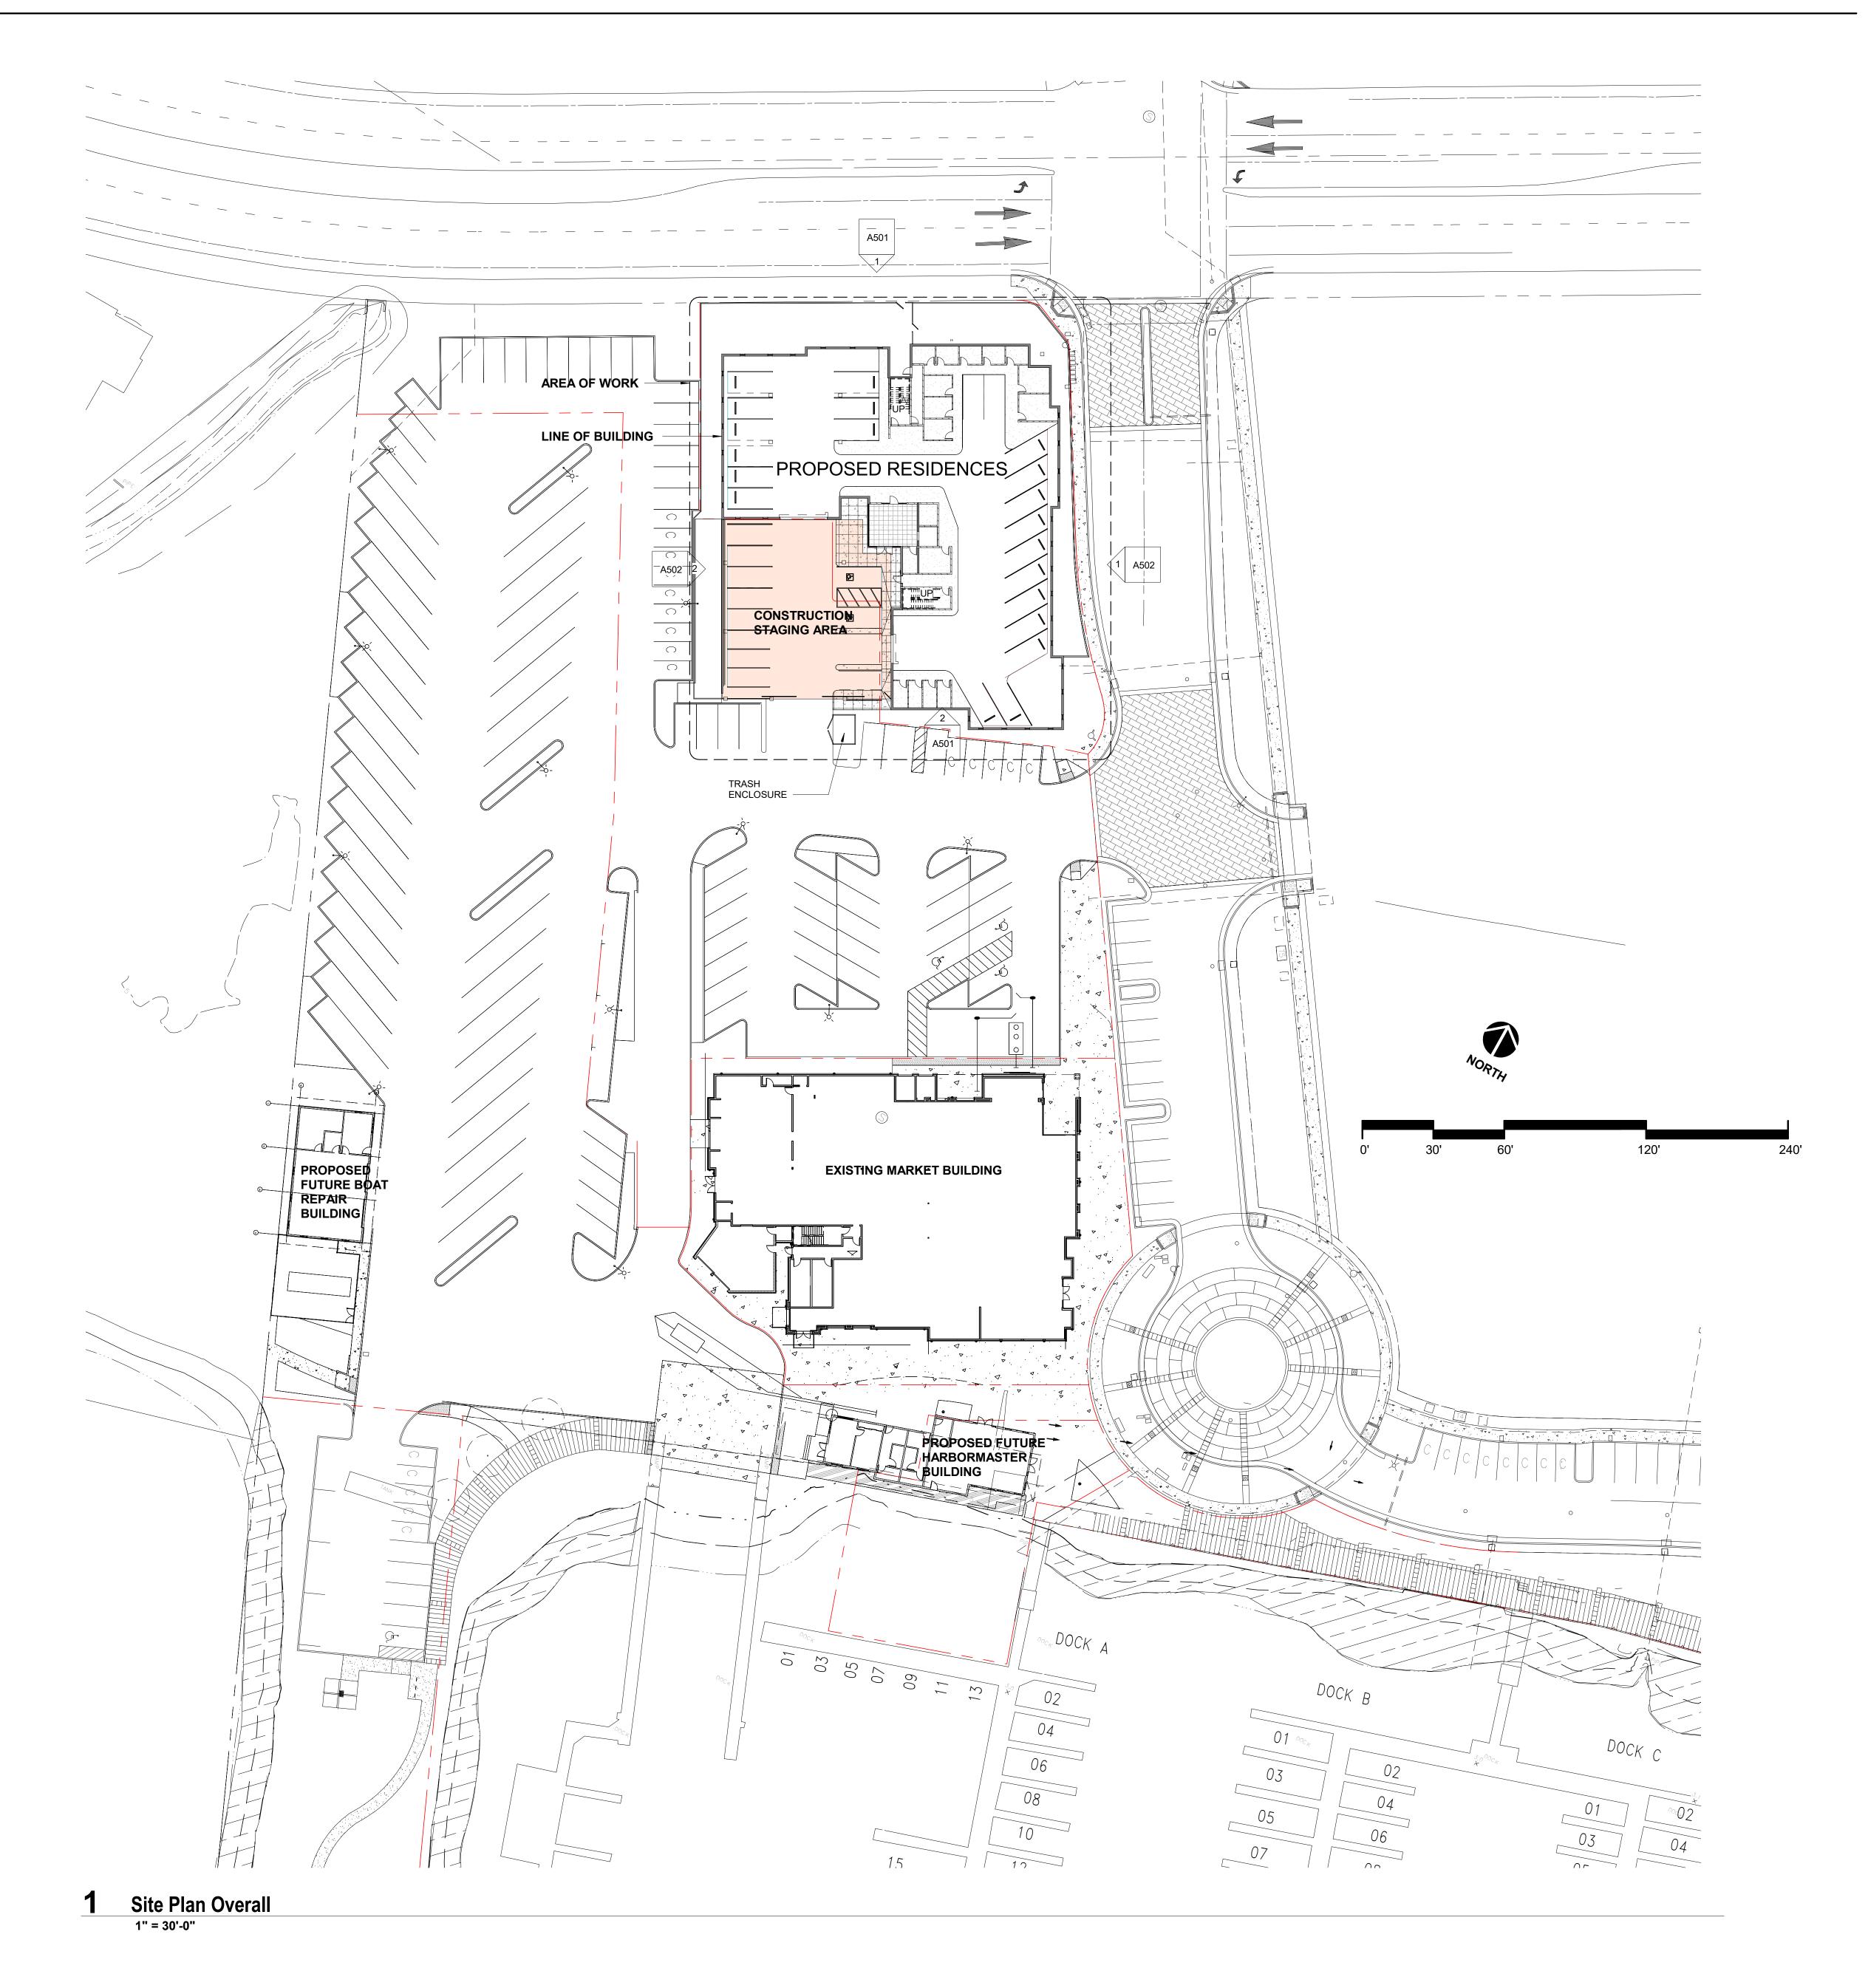





Harbor Flats at Loch Lomond

25 Loch Lomond Drive San Rafael, CA


Project No.:		22300
Drawn By:		Auth
Checked By:		Check
Issued Date:	PLANNING SUE	BMITTAL 4/17/2
Revisions		
No.	Description	Date

Material herein is for use by authorized contractors, bidders and subcontractors in connection with this project only. All dimensions an these drawings shall take precedence over scaled dimensions. Contractors shall be responsible to verify all dimensions and conditions on the job. Russell Architects must be notified of any variations from the dimensions and conditions shown by these drawings. Electronic files furnished by Russell Architects are strictly for reference only. Russell Architects shall be indemnified and held harmless for any and all modifications to such electronic files by others.

Site Plan - Overall

A001
Of Sheets

Scale: 1" = 30'-0"

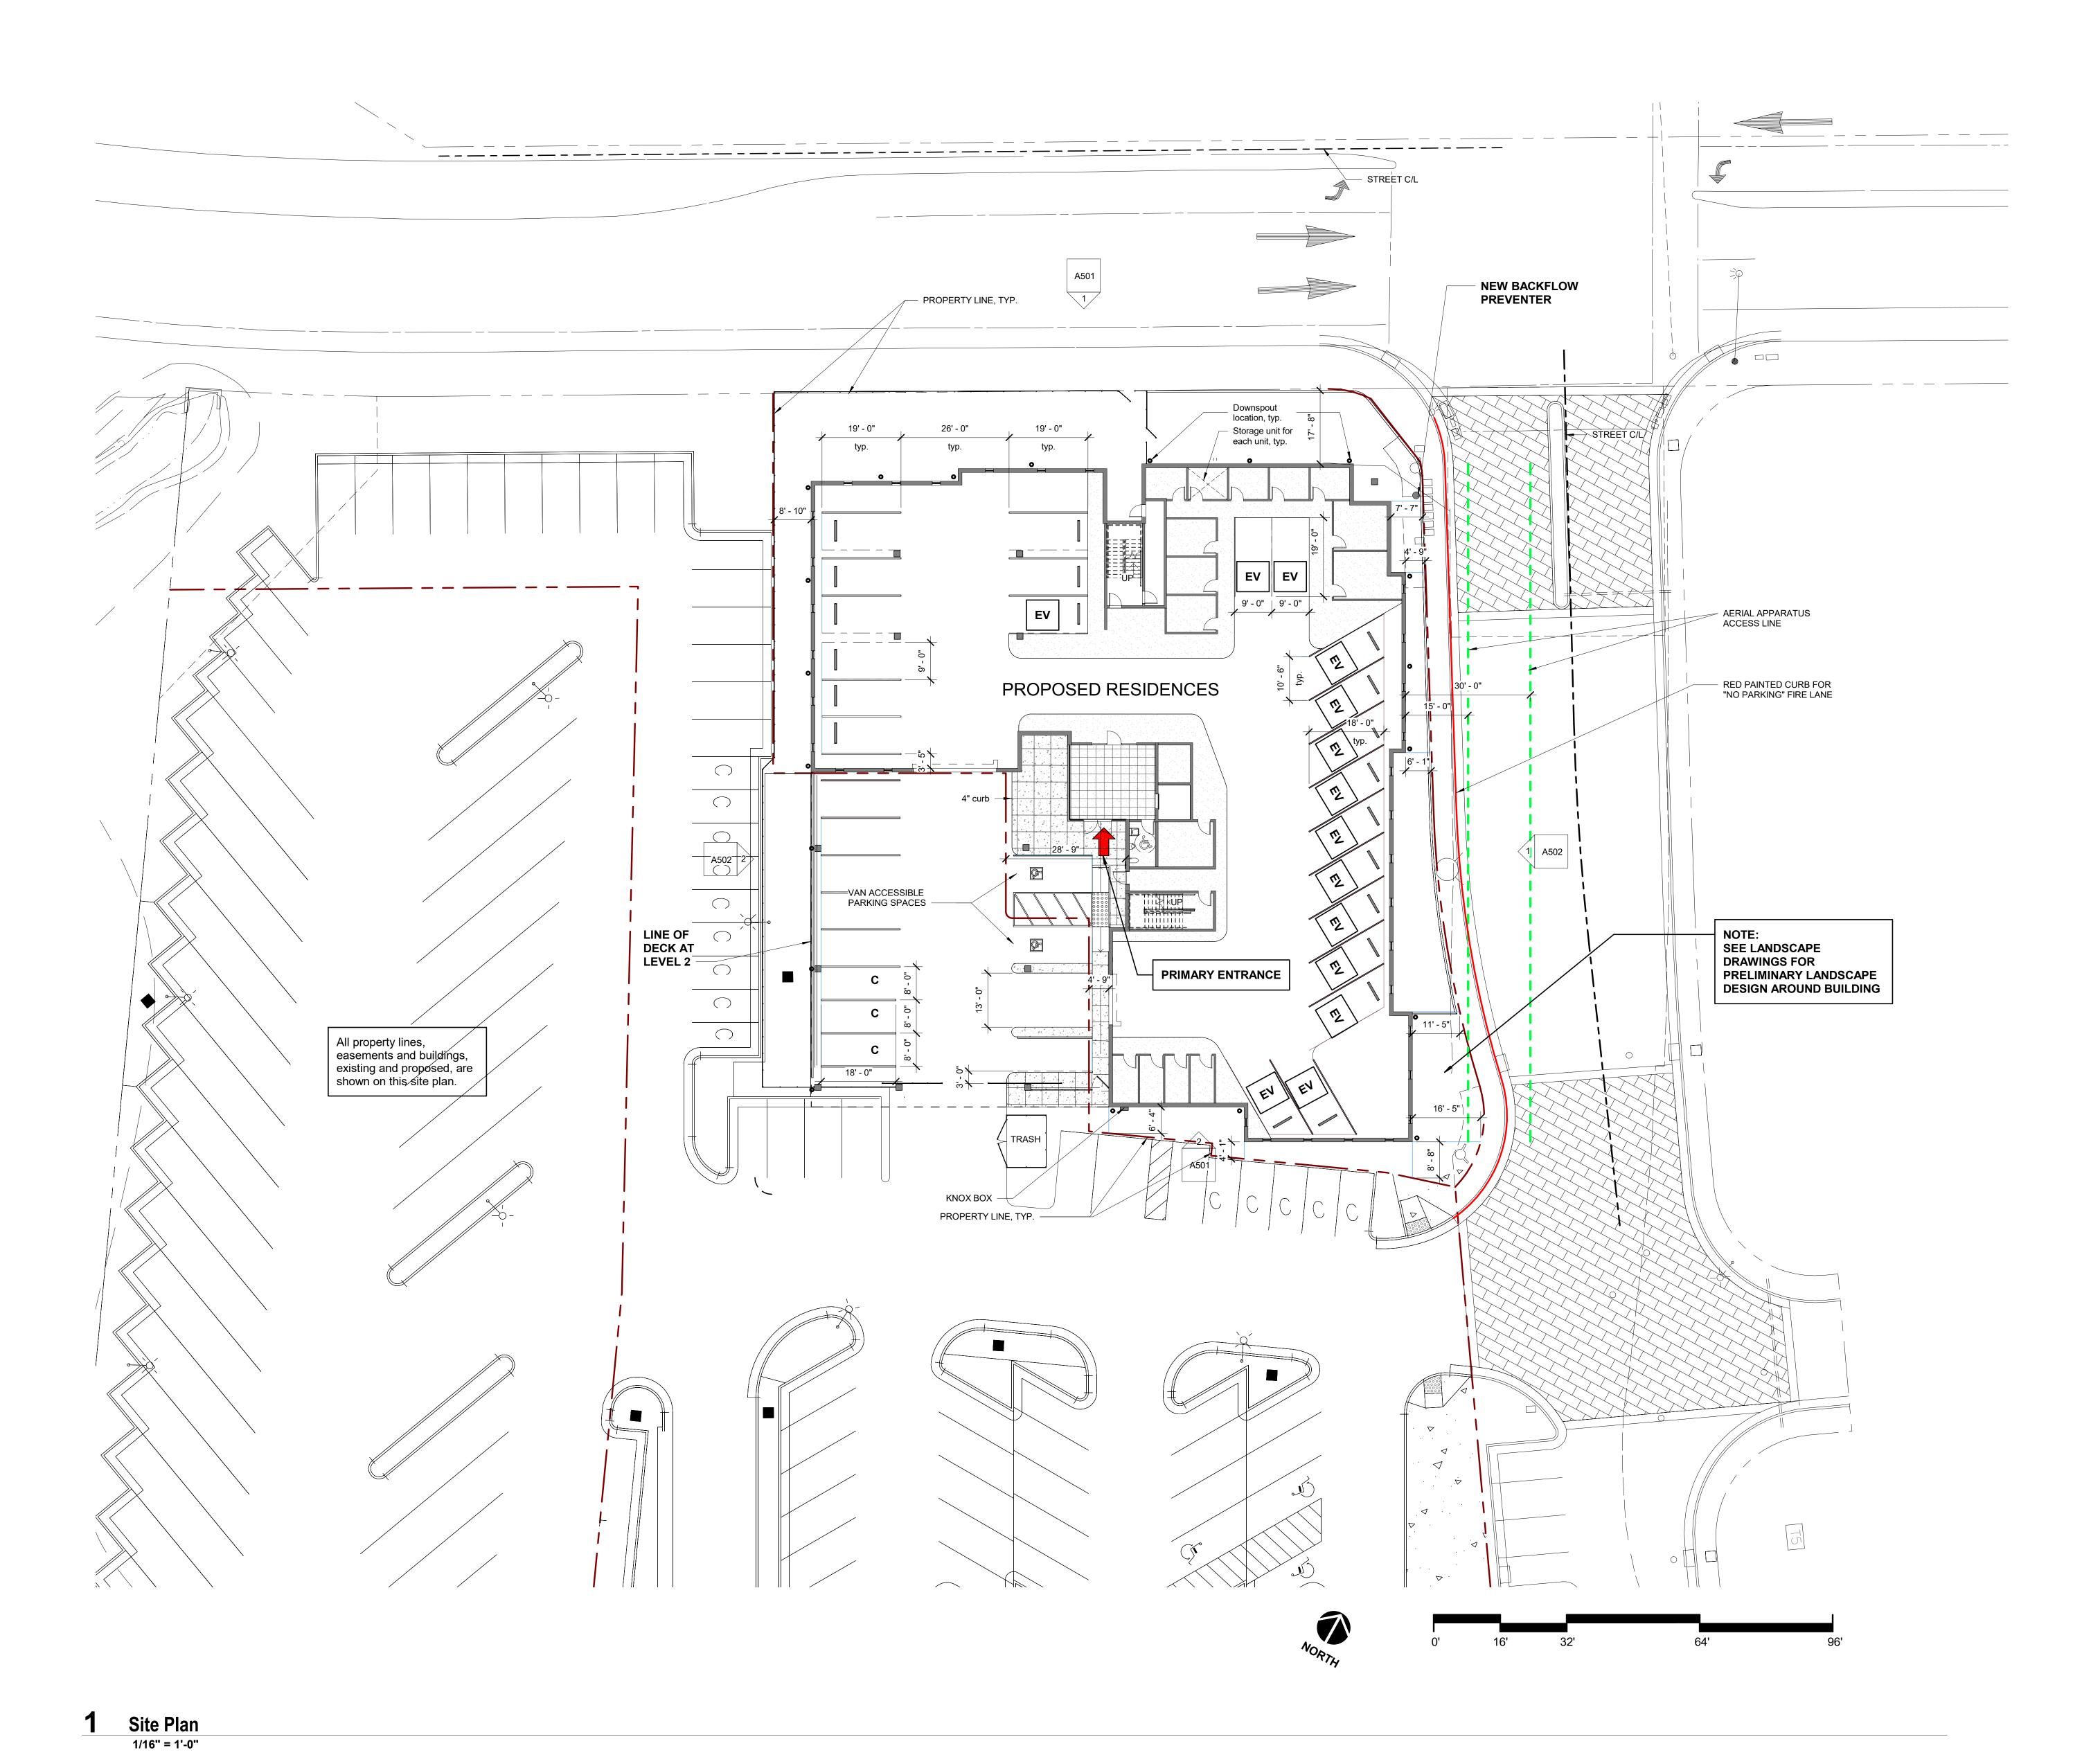





Harbor Flats at Loch Lomond

25 Loch Lomond Drive San Rafael, CA

Project No.:		223006
Drawn By:		Author
Checked By:		Checker
Issued Date:	PLANNING SUE	BMITTAL 4/17/25
Revisions		
No.	Description	Date

Material herein is for use by authorized contractors, bidders and subcontractors in connection with this project only. All dimensions an these drawings shall take precedence over scaled dimensions. Contractors shall be responsible to verify all dimensions and conditions on the job. Russell Architects must be notified of any variations from the dimensions and conditions shown by these drawings. Electronic files furnished by Russell Architects are strictly for reference only. Russell Architects shall be indemnified and held harmless for any and all modifications to such electronic files by others.

Sheet Title
Site Plan

Scale: 1/16" = 1'-0"

A002
















Harbor Flats at Loch Lomond

25 Loch Lomond Drive San Rafael, CA

Project No.:		2230
Drawn By:		Auth
Checked By:		Check
Issued Date:	PLANNING SU	BMITTAL 4/17/2
Revisions		
No.	Description	Date

Material herein is for use by authorized contractors, bidders and subcontractors in connection with this project only. All dimensions an these drawings shall take precedence over scaled dimensions. Contractors shall be responsible to verify all dimensions and conditions on the job. Russell Architects must be notified of any variations from the dimensions and conditions shown by these drawings. Electronic files furnished by Russell Architects are strictly for reference only. Russell Architects shall be indemnified and held harmless for any and all modifications to such electronic files by others.


Renderings

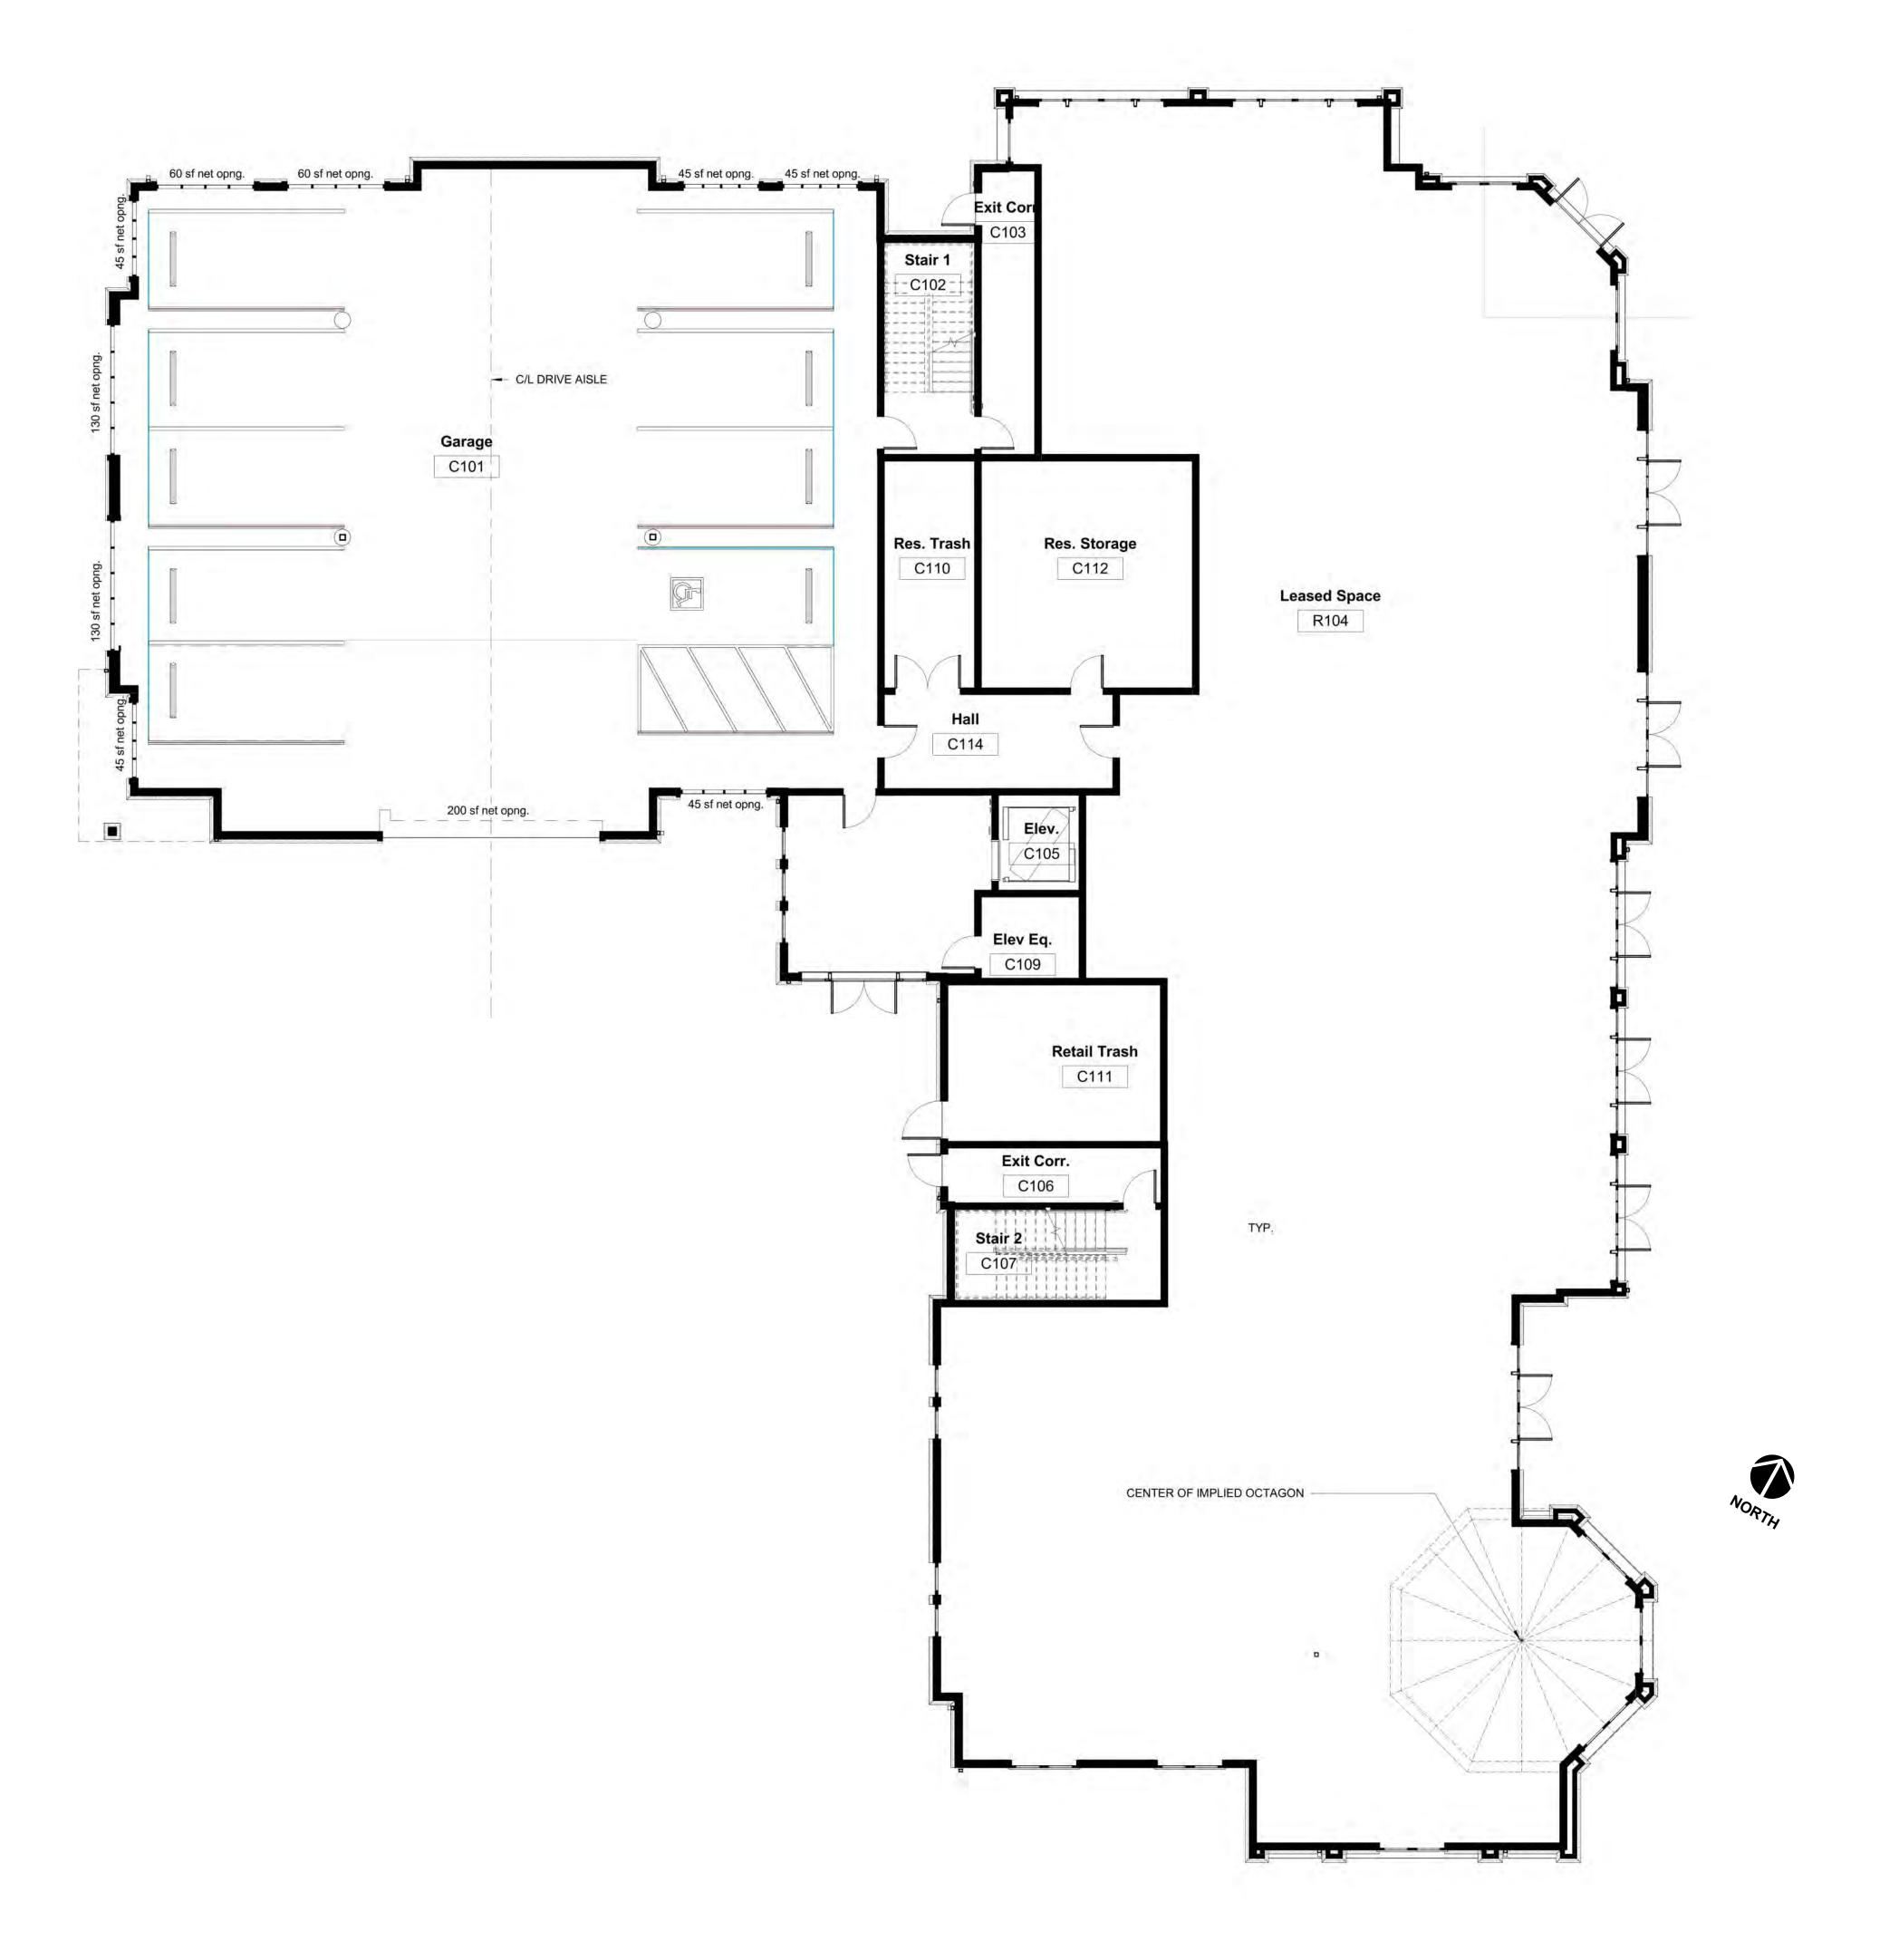

Previously Approved Plan Level 1
12" = 1'-0"



990 A Street, Suite K San Rafael, CA 94901 415.671.8892 tel. 415.594.0857 fax

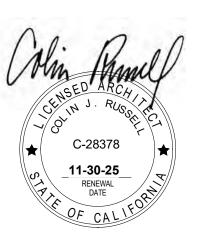


Harbor Flats at Loch Lomond


25 Loch Lomond Drive San Rafael, CA

Project No.:		22300
Drawn By:		Autho
Checked By:		Checke
Issued Date:	PLANNING SUE	3MITTAL 4/17/2
Revisions		
No.	Description	Date

Material herein is for use by authorized contractors, bidders and subcontractors in connection with this project only. All dimensions an these drawings shall take precedence over scaled dimensions. Contractors shall be responsible to verify all dimensions and conditions on the job. Russell Architects must be notified of any variations from the dimensions and conditions shown by these from the dimensions and conditions shown by these drawings. Electronic files furnished by Russell Architects are strictly for reference only. Russell Architects shall be indemnified and held harmless for any and all modifications to such electronic files by others.

Previously
Approved Project
- Level 1
Scale: 12" = 1'-0"

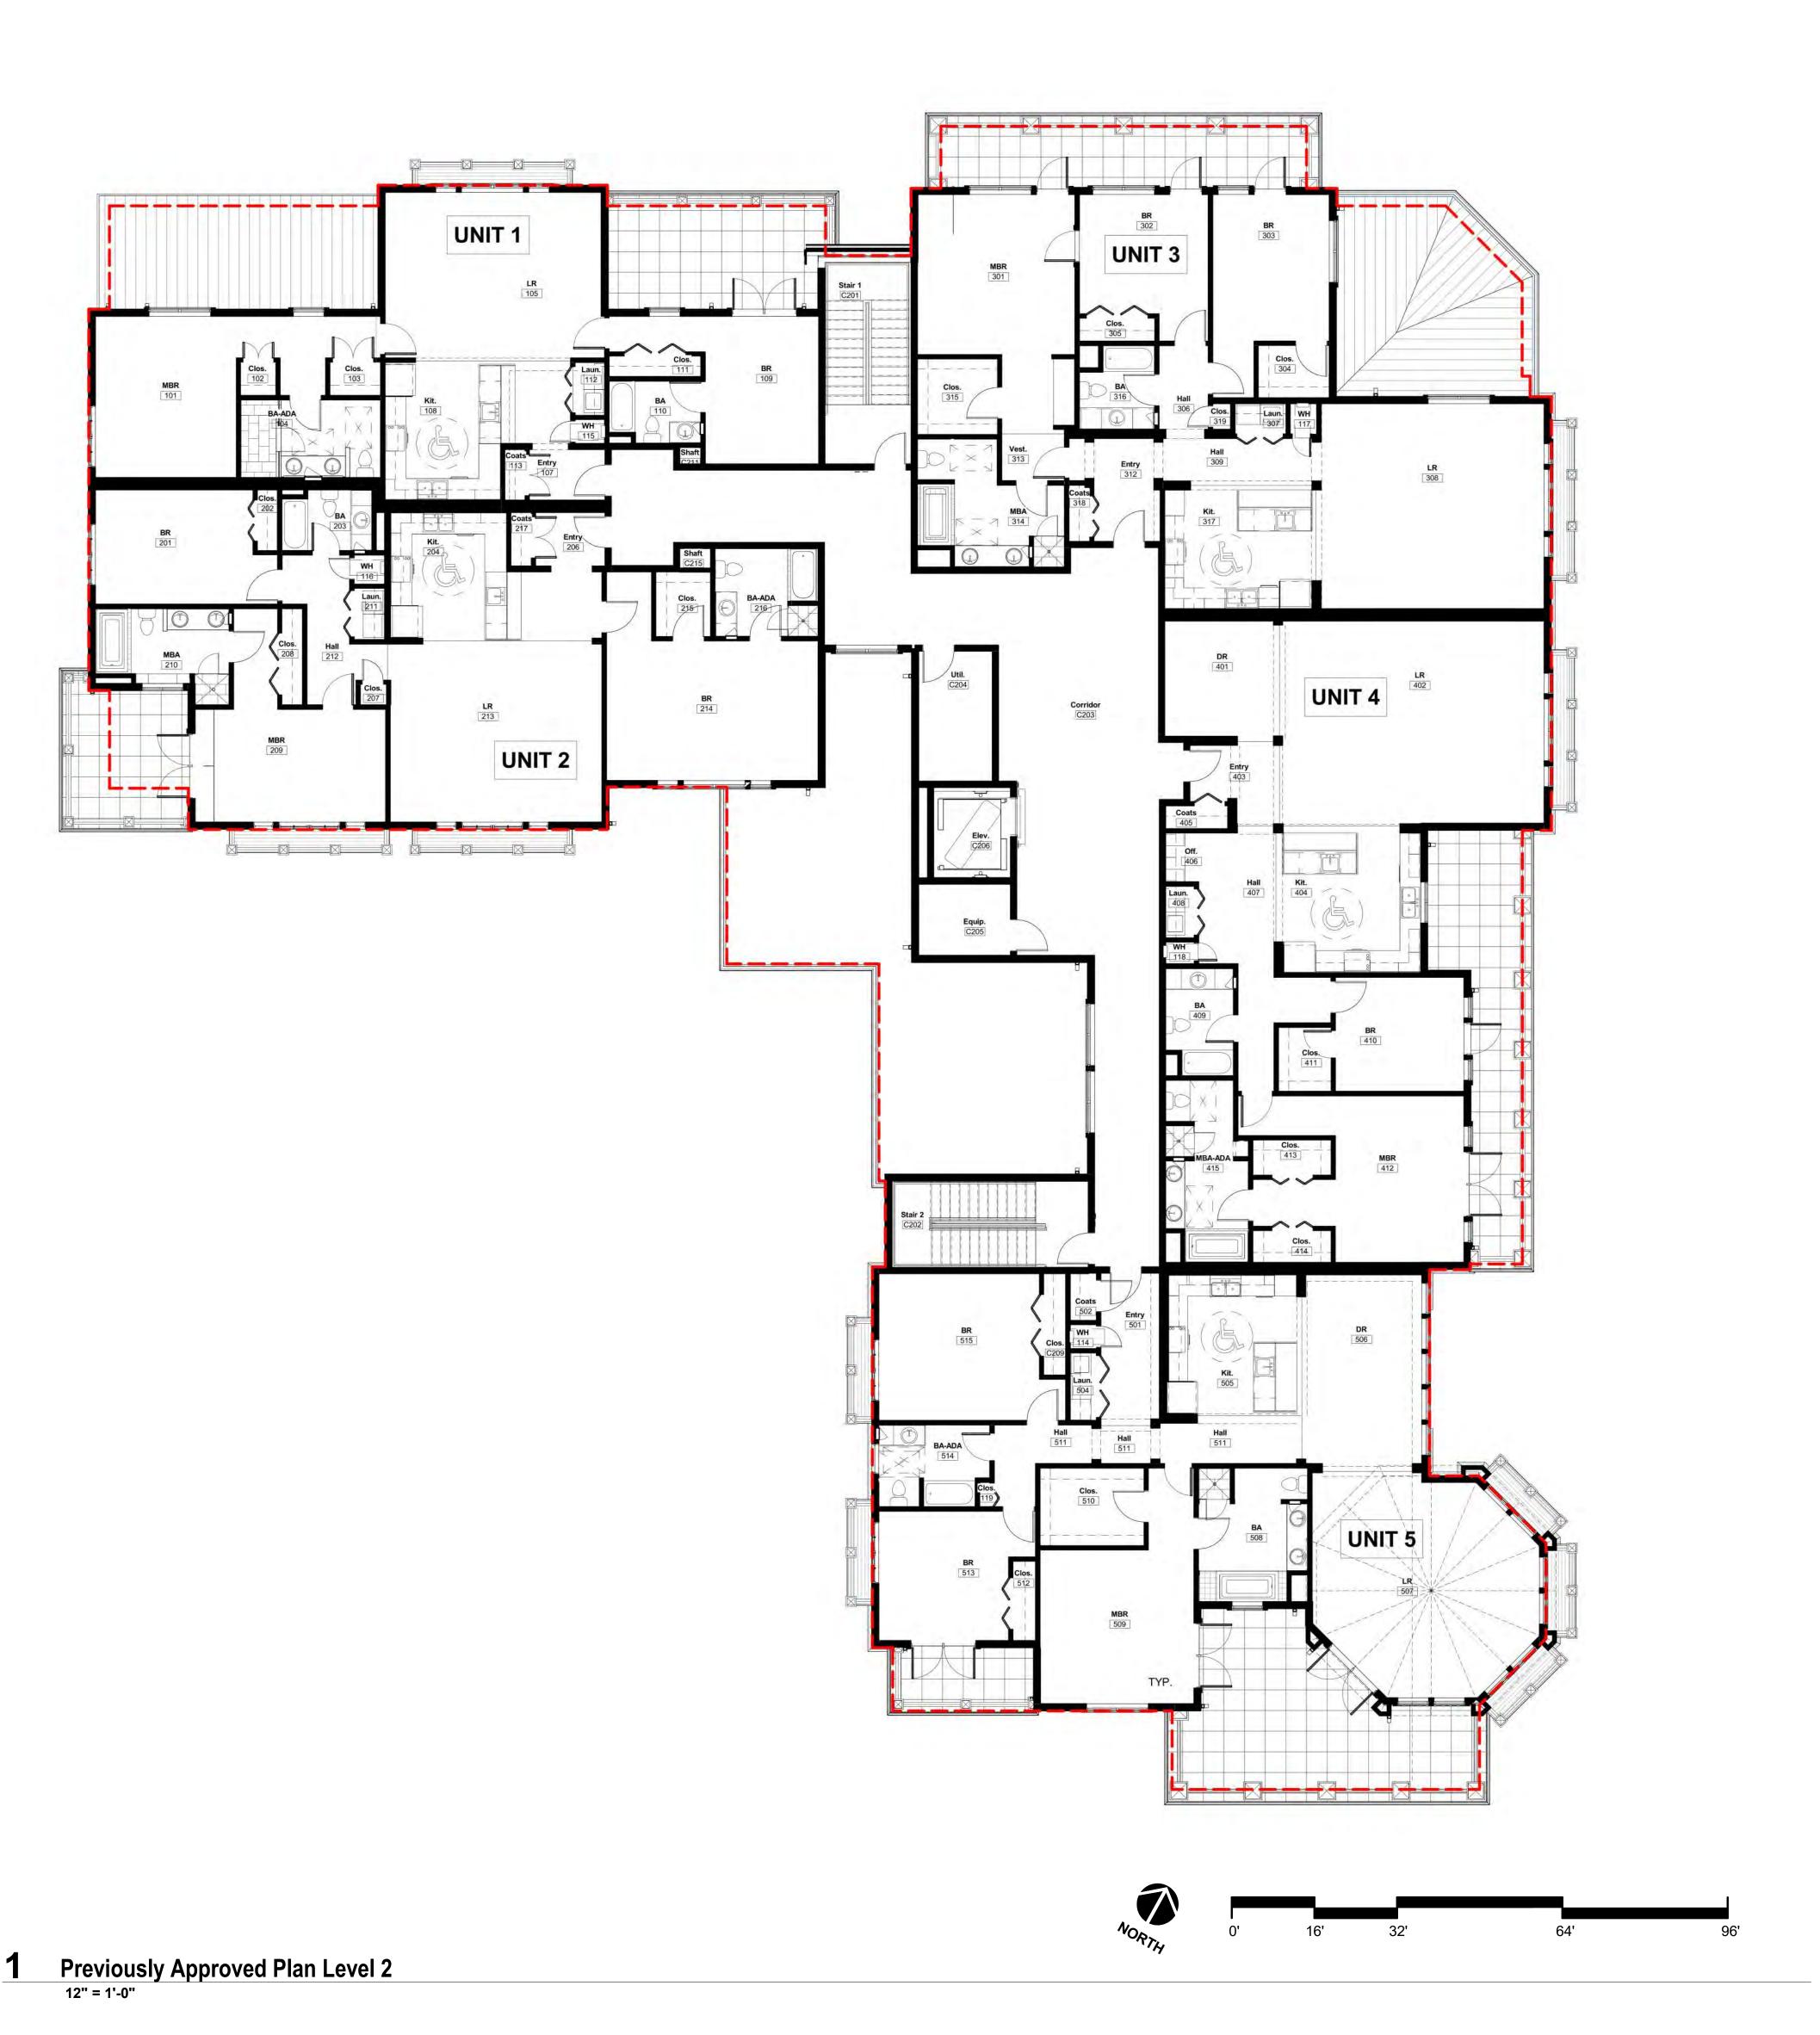

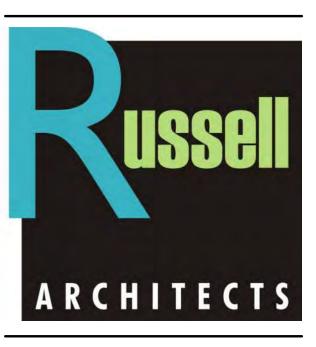



Harbor Flats at Loch Lomond

25 Loch Lomond Drive San Rafael, CA

Project No.:		22300
Drawn By:		Autho
Checked By:		Checke
Issued Date:	PLANNING SUE	3MITTAL 4/17/2
Revisions		
No.	Description	Date

Material herein is for use by authorized contractors, bidders and subcontractors in connection with this project only. All dimensions an these drawings shall take precedence over scaled dimensions. Contractors shall be responsible to verify all dimensions and conditions on the job. Russell Architects must be notified of any variations from the dimensions and conditions shown by these from the dimensions and conditions shown by these drawings. Electronic files furnished by Russell Architects are strictly for reference only. Russell Architects shall be indemnified and held harmless for any and all modifications to such electronic files by others.

Previously Approved Project - Level 2 Scale: 12" = 1'-0"

A002.4
Of Sheets







ARCHITECTS

990 A Street, Suite K San Rafael, CA 94901 415.671.8892 tel. 415.594.0857 fax








Harbor Flats at Loch Lomond


25 Loch Lomond Drive San Rafael, CA


Project No.:		2230
Drawn By:		Auth
Checked By:		Check
Issued Date:	PLANNING SUE	BMITTAL 4/17/2
Revisions		
No.	Description	Date

Material herein is for use by authorized contractors, bidders and subcontractors in connection with this project only. All dimensions an these drawings shall take precedence over scaled dimensions. Contractors shall be responsible to verify all dimensions and conditions on the job. Russell Architects must be notified of any variations from the dimensions and conditions shown by these drawings. Electronic files furnished by Russell Architects are strictly for reference only. Russell Architects shall be indemnified and held harmless for any and all modifications to such electronic files by others.

Sheet Title
Site Photos

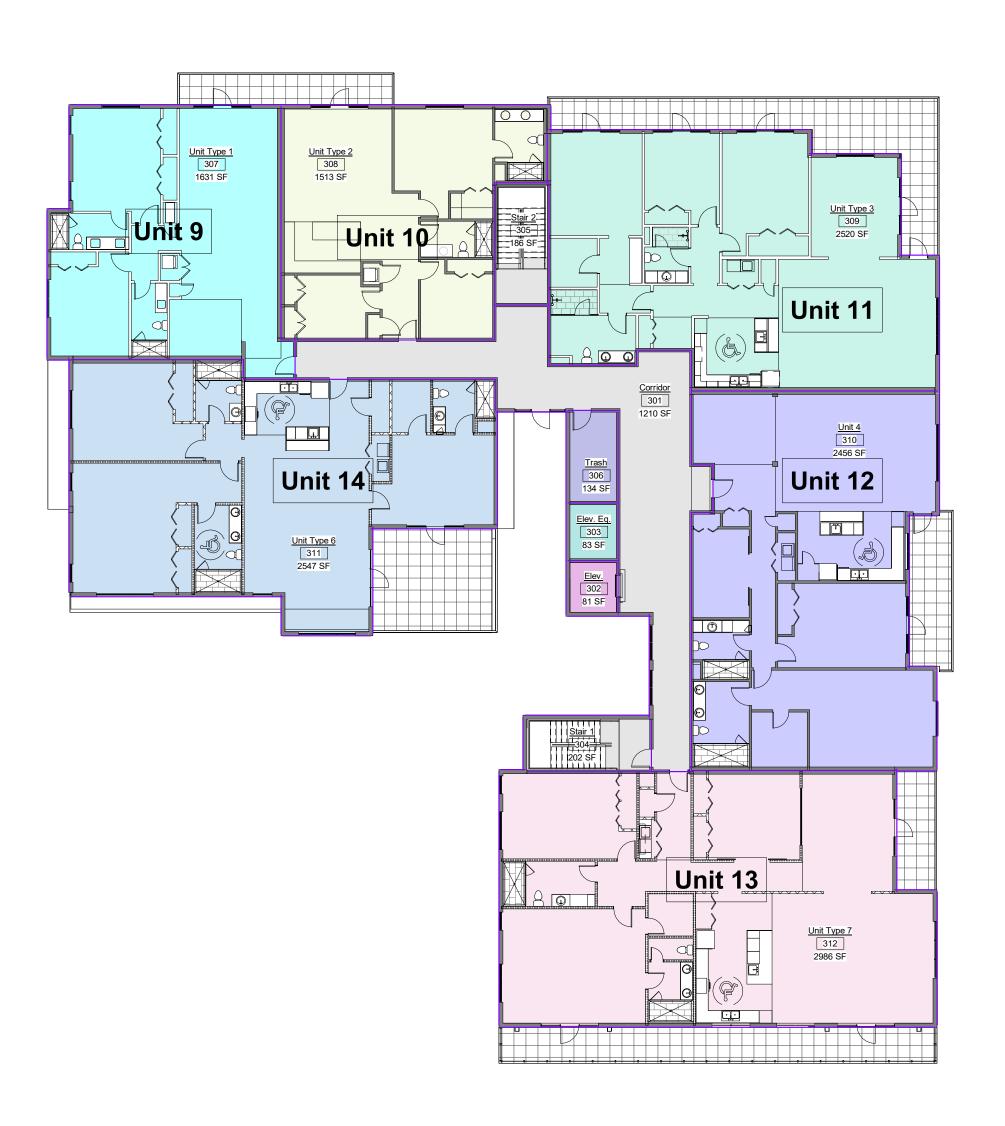

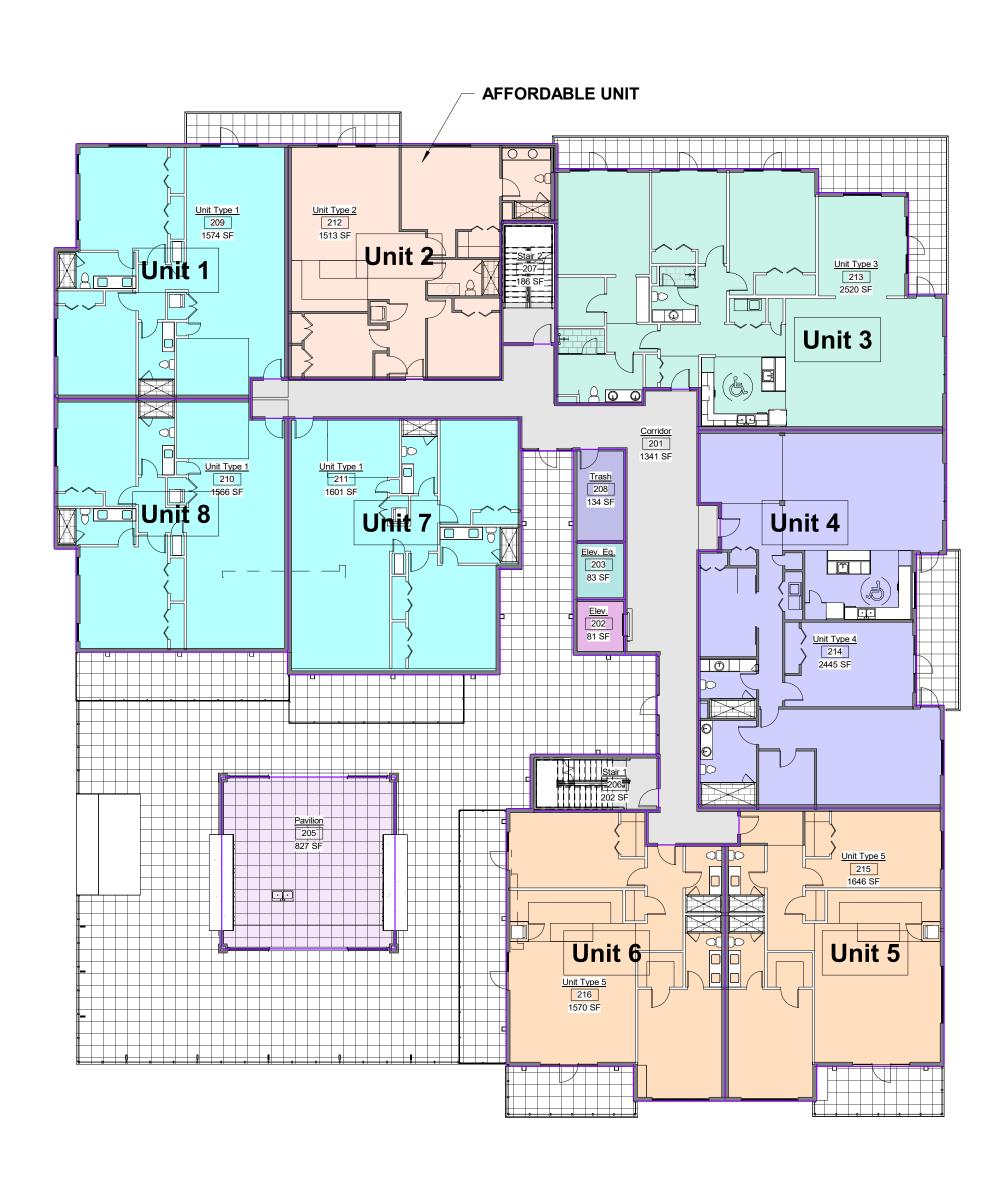

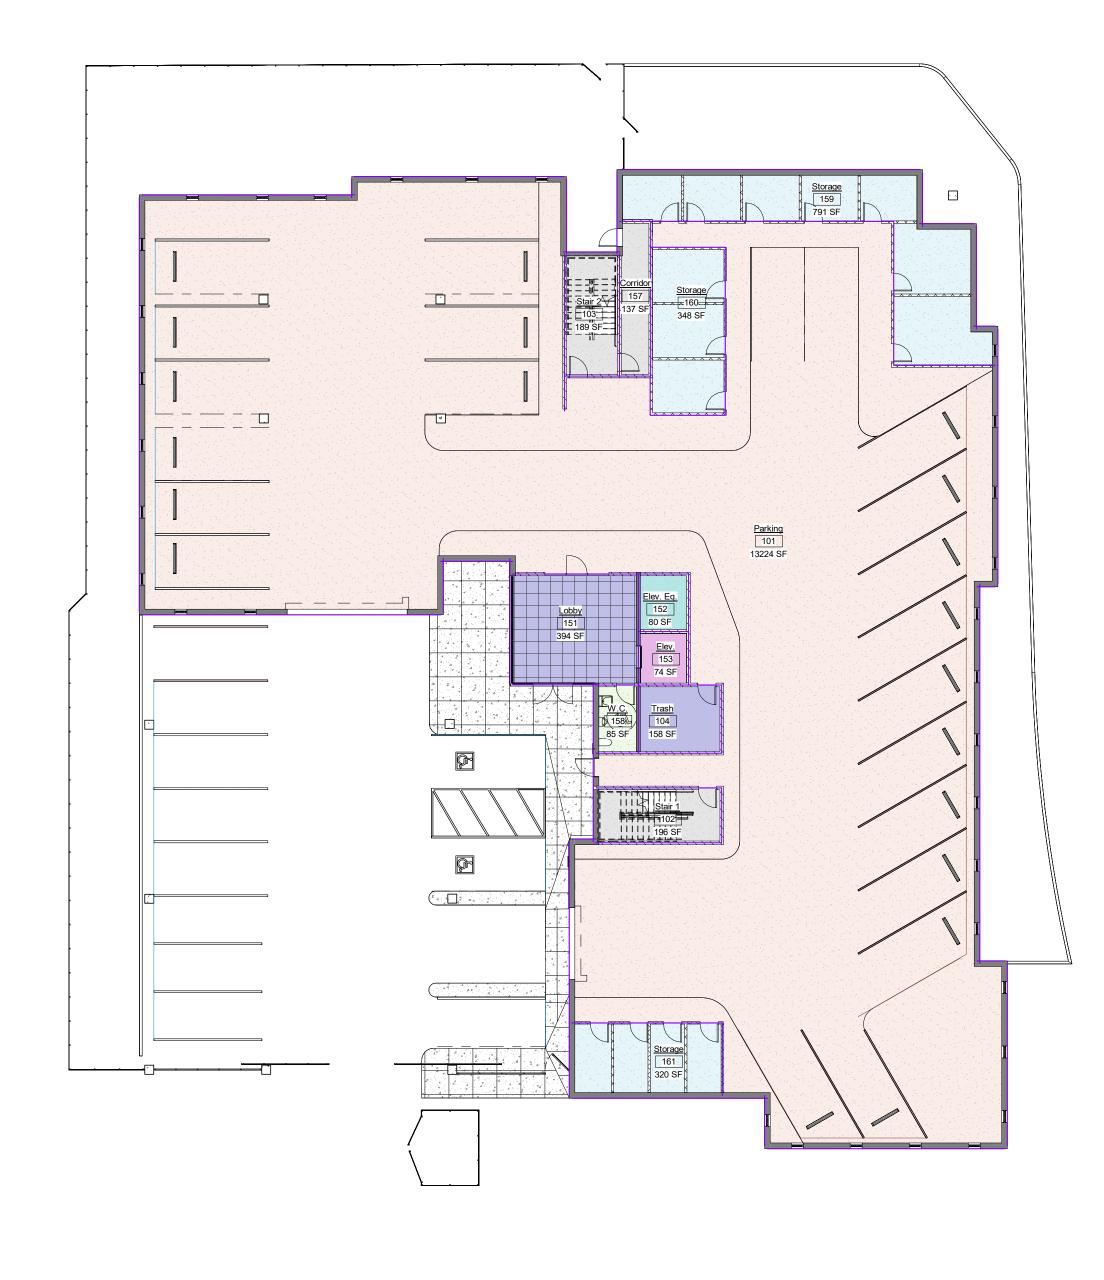





Harbor Flats at Loch Lomond

3 Level 3 Areas

2 Level 2 Areas 1/16" = 1'-0"

		OC	CUPANT LOA	D BY AREA		
Level	Number	Name	Area	Occ Load Factor	Occupant Load	Exit Width Req'd (inches)
evel 1	101	Parking	13224 SF	200	66.12	13.2
evel 1	102	Stair 1	196 SF	200	0.98	0.2
evel 1		Stair 2	189 SF	200	0.94	0.2
evel 1		Trash	158 SF	200	0.79	0.2
evel 1	151	Lobby	394 SF	200	1.97	0.4
evel 1	152	Elev. Eq.	80 SF	200	0.40	0.1
evel 1	153	Elev.	74 SF	200	0.37	0.1
evel 1		Corridor	137 SF	200	0.68	0.1
evel 1	158	W.C.	85 SF	200	0.43	0.1
evel 1		Storage	791 SF	200	3.96	0.8
evel 1	160	Storage	348 SF	200	1.74	0.3
evel 1	161	Storage	320 SF	200	1.60	0.3
-01011	101	otorago	15997 SF	200	79.99	16.0
evel 2	201	Corridor	1341 SF	200	6.71	1.3
evel 2		Elev.	81 SF	200	0.40	0.1
evel 2		Elev. Eq.	83 SF	200	0.42	0.1
evel 2		Pavilion	827 SF	200	4.14	0.8
evel 2		Stair 1	202 SF	200	1.01	0.2
evel 2		Stair 2	186 SF	200	0.93	0.2
evel 2		Trash	134 SF	200	0.67	0.1
evel 2		Unit Type 1	1574 SF	200	7.87	1.6
evel 2		Unit Type 1	1566 SF	200	7.83	1.6
evel 2		Unit Type 1	1601 SF	200	8.01	1.6
evel 2		Unit Type 2	1513 SF	200	7.57	1.5
evel 2		Unit Type 3	2520 SF	200	12.60	2.5
evel 2	214	Unit Type 4	2445 SF	200	12.22	2.4
evel 2		Unit Type 5	1646 SF	200	8.23	1.6
evel 2		Unit Type 5	1570 SF	200	7.85	1.6
		, ,,	17291 SF		86.45	17.3
evel 3	301	Corridor	1210 SF	200	6.05	1.2
evel 3		Elev.	81 SF	200	0.40	0.1
evel 3		Elev. Eq.	83 SF	200	0.42	0.1
evel 3		Stair 1	202 SF	200	1.01	0.2
evel 3		Stair 2	186 SF	200	0.93	0.2
evel 3		Trash	134 SF	200	0.67	0.1
evel 3		Unit Type 1	1631 SF	200	8.15	1.6
evel 3		Unit Type 2	1513 SF	200	7.57	1.5
evel 3		Unit Type 3	2520 SF	200	12.60	2.5
evel 3		Unit 4	2456 SF	200	12.28	2.5
evel 3		Unit Type 6	2547 SF	200	12.73	2.5
		Unit Type 7	2986 SF	200	14.93	3.0
evel 3	012	Utilit Type 1	2300 01	200	I T .33	0.0

48837 SF

244.19 48.8

Grand total

1 Level 1 Areas

			Schedule (Gross Building)	
Level	Number	Name	Area	
Level 1	157	Corridor	137 SF	
Level 1	153	Elev.	74 SF	
Level 1	152	Elev. Eq.	80 SF	
Level 1	151	Lobby	394 SF	
Level 1	101	Parking	13224 SF	
Level 1	102	Stair 1	196 SF	
Level 1	103	Stair 2	189 SF	
Level 1	159	Storage	791 SF	
Level 1	160	Storage	348 SF	
Level 1	161	Storage	320 SF	
Level 1	104	Trash	158 SF	
Level 1	158	W.C.	85 SF	
2010. 1	1.00		15997 SF	
Level 2	201	Corridor	1341 SF	
Level 2	202	Elev.	81 SF	
Level 2	203	Elev. Eq.	83 SF	
Level 2	205	Pavilion	827 SF	
Level 2	206	Stair 1	202 SF	
Level 2	207	Stair 2	186 SF	
Level 2	208	Trash	134 SF	
Level 2	209	Unit Type 1	1574 SF	
Level 2	210	Unit Type 1	1566 SF	
Level 2	211	Unit Type 1	1601 SF	
Level 2	212	Unit Type 2	1513 SF	
Level 2	213	Unit Type 3	2520 SF	
Level 2	214	Unit Type 4	2445 SF	
Level 2	215	Unit Type 5	1646 SF	
Level 2	216	Unit Type 5	1570 SF	
LOVOI Z	210	Sim Type 0	17291 SF	
Level 3	301	Corridor	1210 SF	
Level 3	302	Elev.	81 SF	
Level 3	303	Elev. Eq.	83 SF	
Level 3	304	Stair 1	202 SF	
Level 3	305	Stair 2	186 SF	
Level 3	306	Trash	134 SF	
Level 3	310	Unit 4	2456 SF	
Level 3	307	Unit Type 1	1631 SF	
Level 3	308	Unit Type 2	1513 SF	
Level 3	309	Unit Type 3	2520 SF	
Level 3	311	Unit Type 6	2547 SF	
Level 3	312	Unit Type 7	2986 SF	

25 Loch Lomond Drive San Rafael, CA


Project No.:		223
Drawn By:		
Checked By:		
Issued Date:	PLANNING SUE	3MITTAL 4/17
Revisions		
No.	Description	Date

Material herein is for use by authorized contractors, bidders and subcontractors in connection with this project only. All dimensions an these drawings shall take precedence over scaled dimensions. Contractors shall be responsible to verify all dimensions and conditions on the job. Russell Architects must be notified of any variations from the dimensions and conditions shown by these drawings. Electronic files furnished by Russell Architects are strictly for reference only. Russell Architects shall be indemnified and held harmless for any and all modifications to such electronic files by others.

Sheet Title Areas

Scale: 1/16" = 1'-0"

AOO5

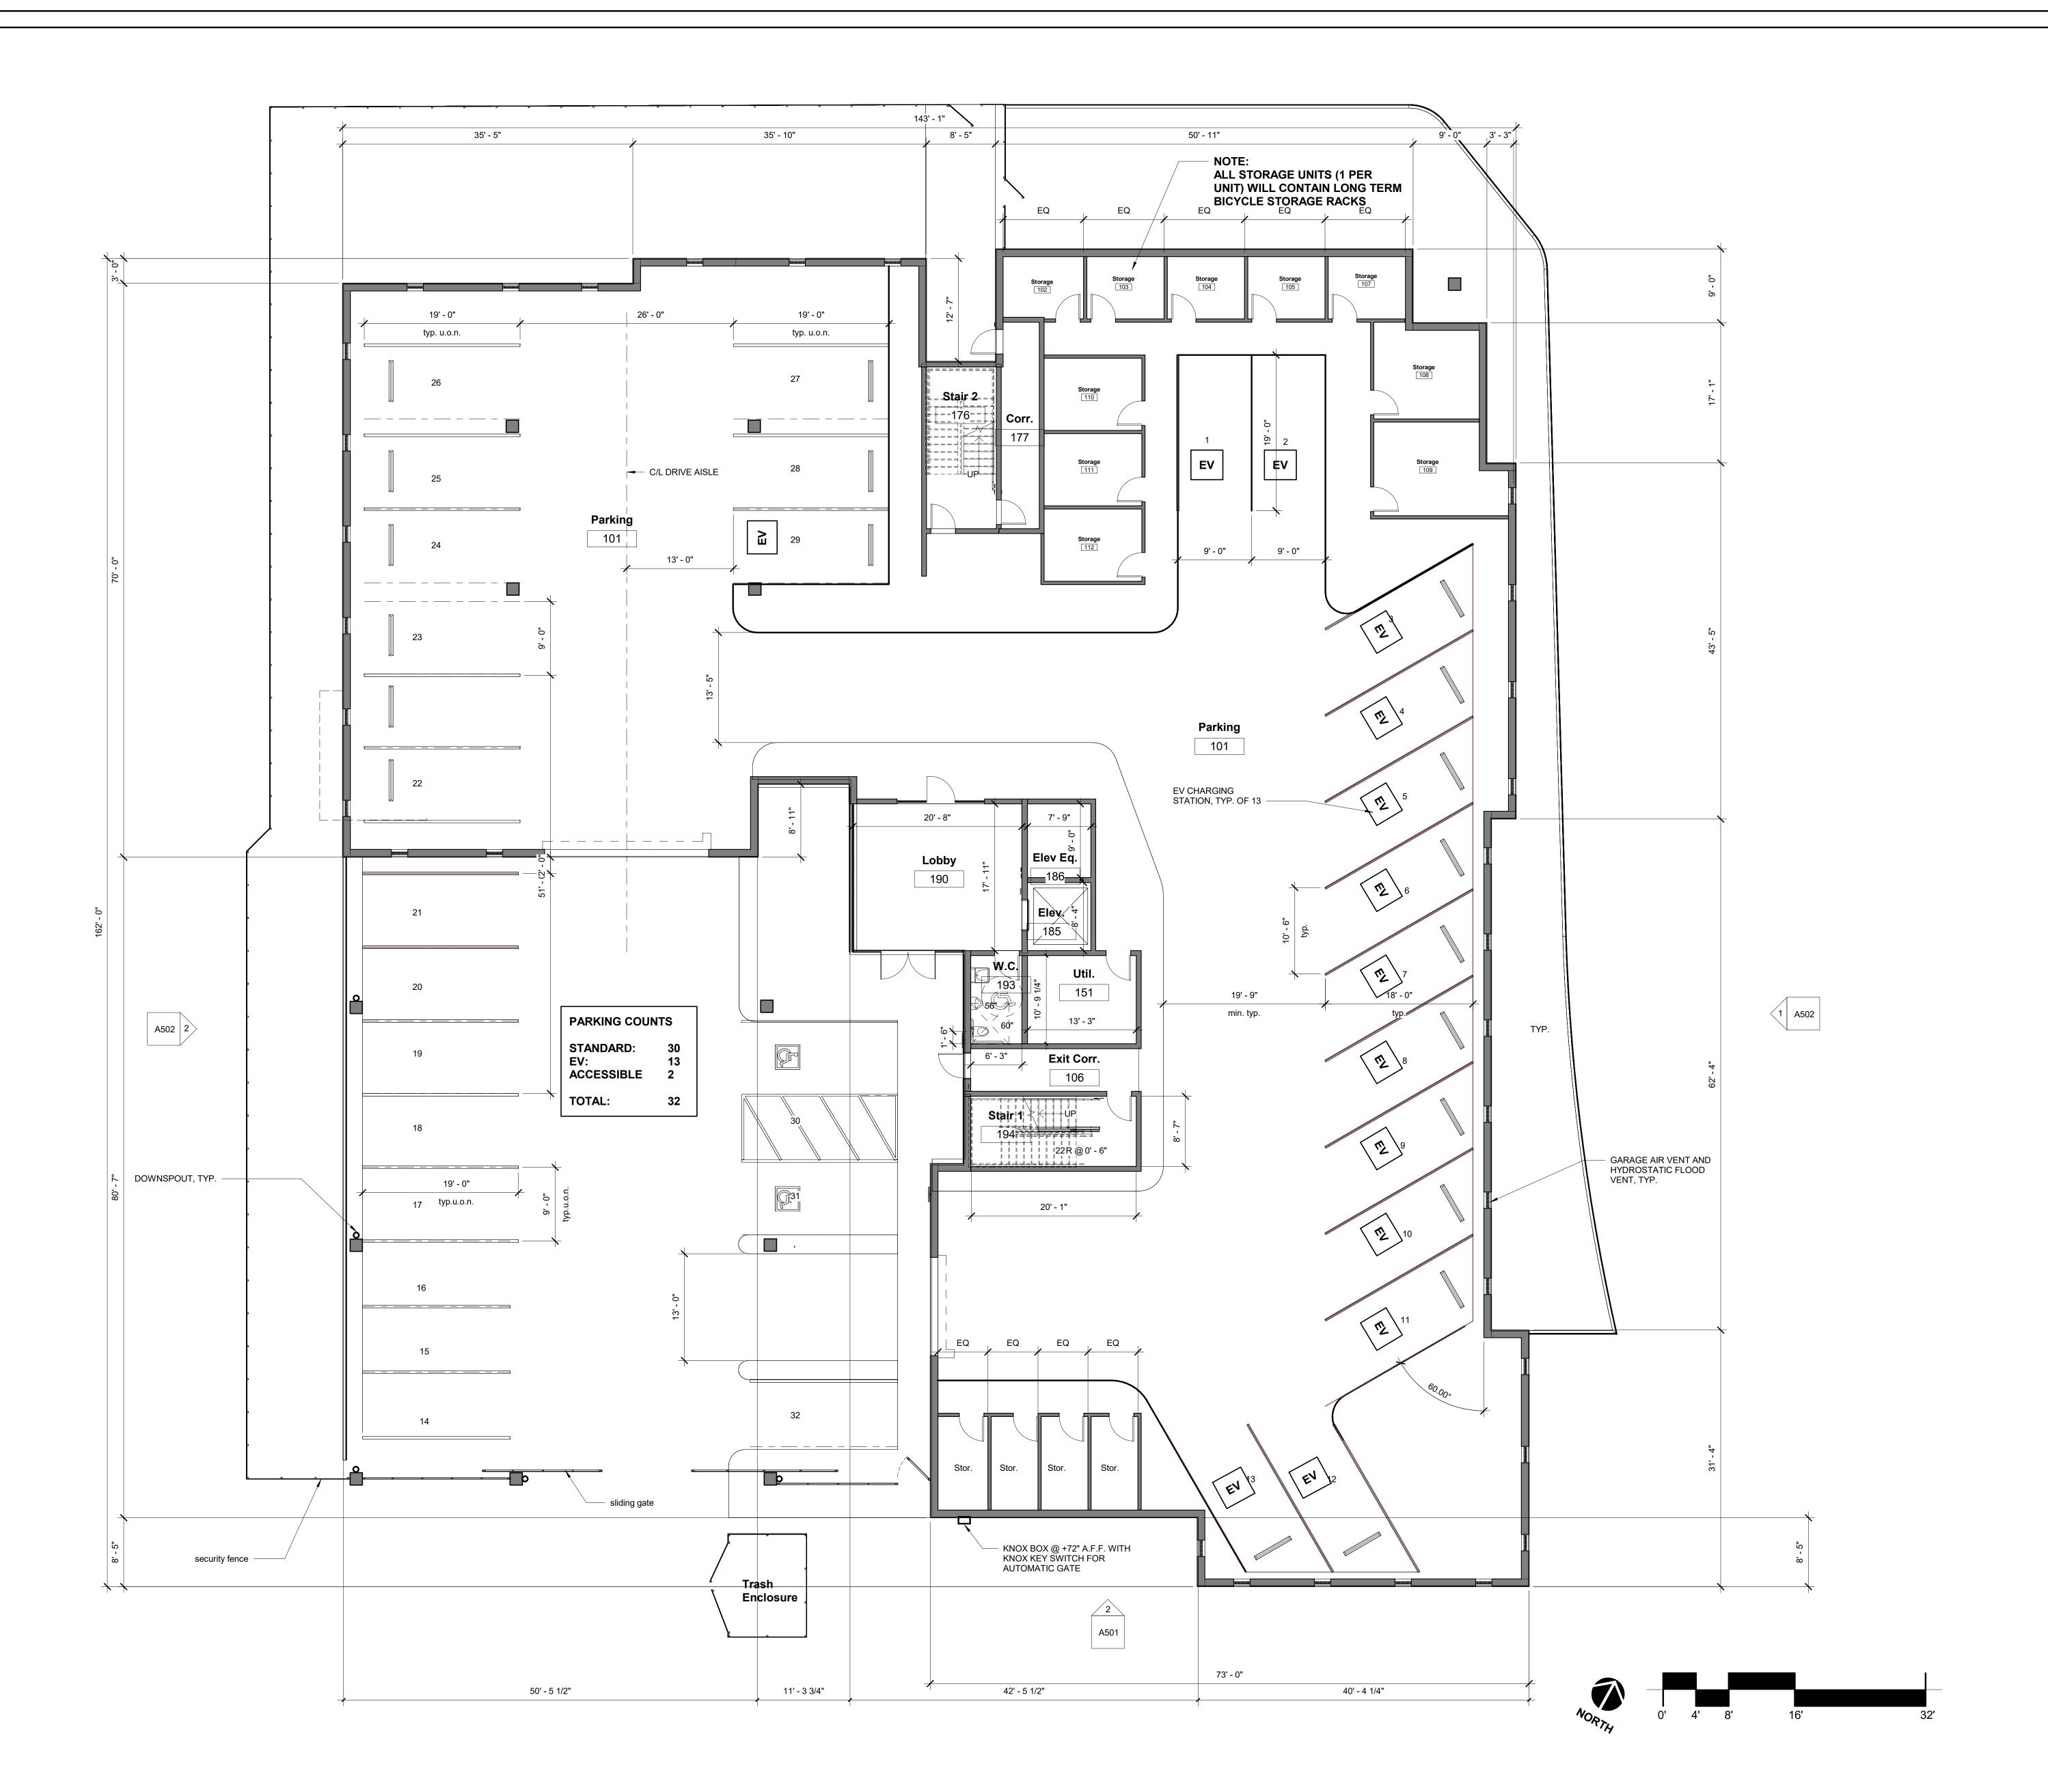





Harbor Flats at Loch Lomond

25 Loch Lomond Drive San Rafael, CA

Checked By: Che Issued Date: PLANNING SUBMITTAL 4/1 Revisions	
Issued Date: PLANNING SUBMITTAL 4/1 Revisions	Aut
Revisions	Chec
	PLANNING SUBMITTAL 4/17
No Description Date	
Tro. Becomption Bate	escription Date

Material herein is for use by authorized contractors, bidders and subcontractors in connection with this project only. All dimensions an these drawings shall take precedence over scaled dimensions. Contractors shall be responsible to verify all dimensions and conditions on the job. Russell Architects must be notified of any variations from the dimensions and conditions shown by these drawings. Electronic files furnished by Russell Architects are strictly for reference only. Russell Architects shall be indemnified and held harmless for any and all modifications to such electronic files by others.

Level 1 Floor Plan


A201

Sheets

Scale: 1/8" = 1'-0"





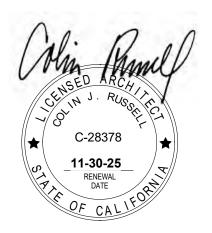

Harbor Flats at Loch Lomond

25 Loch Lomond Drive San Rafael, CA

Project No.: 223006

Drawn By: Author

Checked By: Checker

Issued Date: PLANNING SUBMITTAL 4/17/25

Revisions

No. Description Date

Material herein is for use by authorized contractors, bidders and subcontractors in connection with this project only. All dimensions an these drawings shall take precedence over scaled dimensions. Contractors shall be responsible to verify all dimensions and conditions on the job. Russell Architects must be notified of any variations from the dimensions and conditions shown by these drawings. Electronic files furnished by Russell Architects are strictly for reference only. Russell Architects shall be indemnified and held harmless for any and all modifications to such electronic files by others.

Level 2 Floor Plan

Scale: 1/8" = 1'-0"

A202

. . .

1 Level 2
1/8" = 1'-0"







Harbor Flats at Loch Lomond

25 Loch Lomond Drive San Rafael, CA

Checked By:		Chec
Issued Date:	PLANNING SUE	BMITTAL 4/17
Revisions		
No.	Description	Date

Material herein is for use by authorized contractors, bidders and subcontractors in connection with this project only. All dimensions an these drawings shall take precedence over scaled dimensions. Contractors shall be responsible to verify all dimensions and conditions on the job. Russell Architects must be notified of any variations from the dimensions and conditions shown by these drawings. Electronic files furnished by Russell Architects are strictly for reference only. Russell Architects shall be indemnified and held harmless for any and all modifications to such electronic files by others.


Level 3 Floor Plan

Scale: 1/8" = 1'-0"

Sheet No

A203

1 Level 3
1/8" = 1'-0"

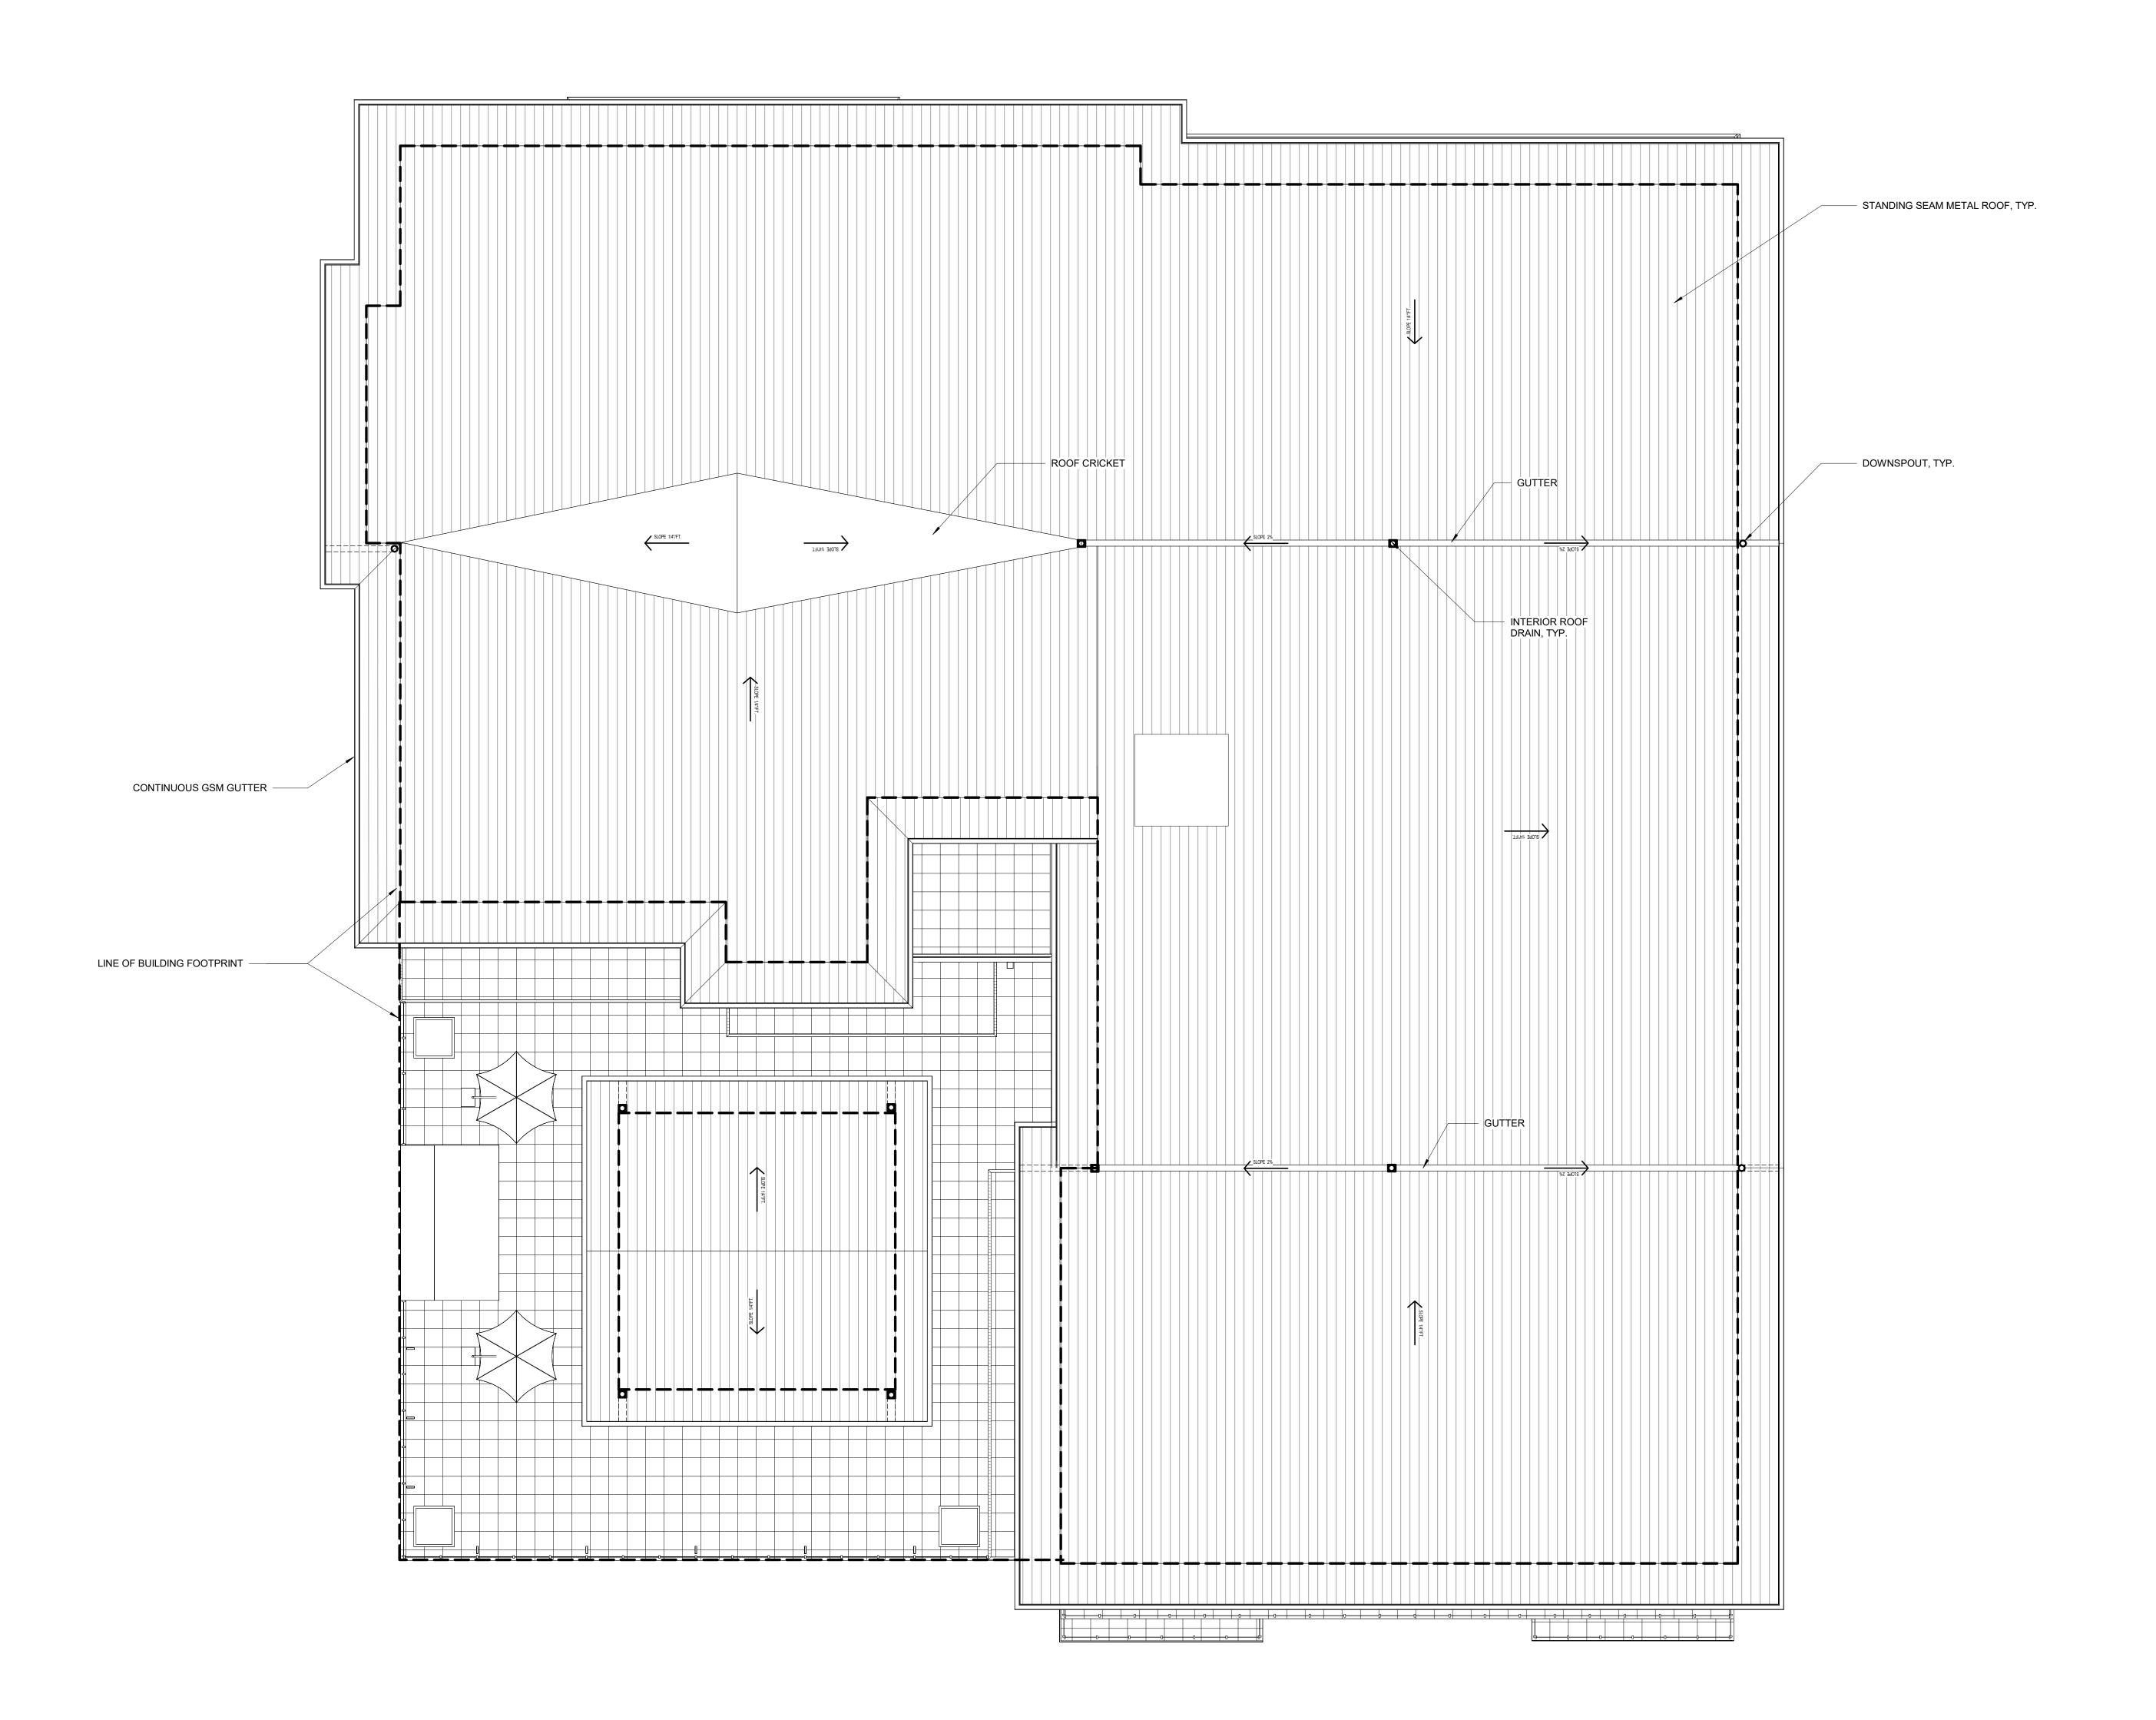





Harbor Flats at Loch Lomond

25 Loch Lomond Drive San Rafael, CA

Project No.: 223006

Drawn By: Author

Checked By: Checker

Issued Date: PLANNING SUBMITTAL 4/17/25

Revisions

No. Description Date


Material herein is for use by authorized contractors, bidders and subcontractors in connection with this project only. All dimensions an these drawings shall take precedence over scaled dimensions. Contractors shall be responsible to verify all dimensions and conditions on the job. Russell Architects must be notified of any variations from the dimensions and conditions shown by these drawings. Electronic files furnished by Russell Architects are strictly for reference only. Russell Architects shall be indemnified and held harmless for any and all modifications to such electronic files by others.

Roof Plan

Scale: 1/8" = 1'-0"

A204

Roof
1/8" = 1'-0"

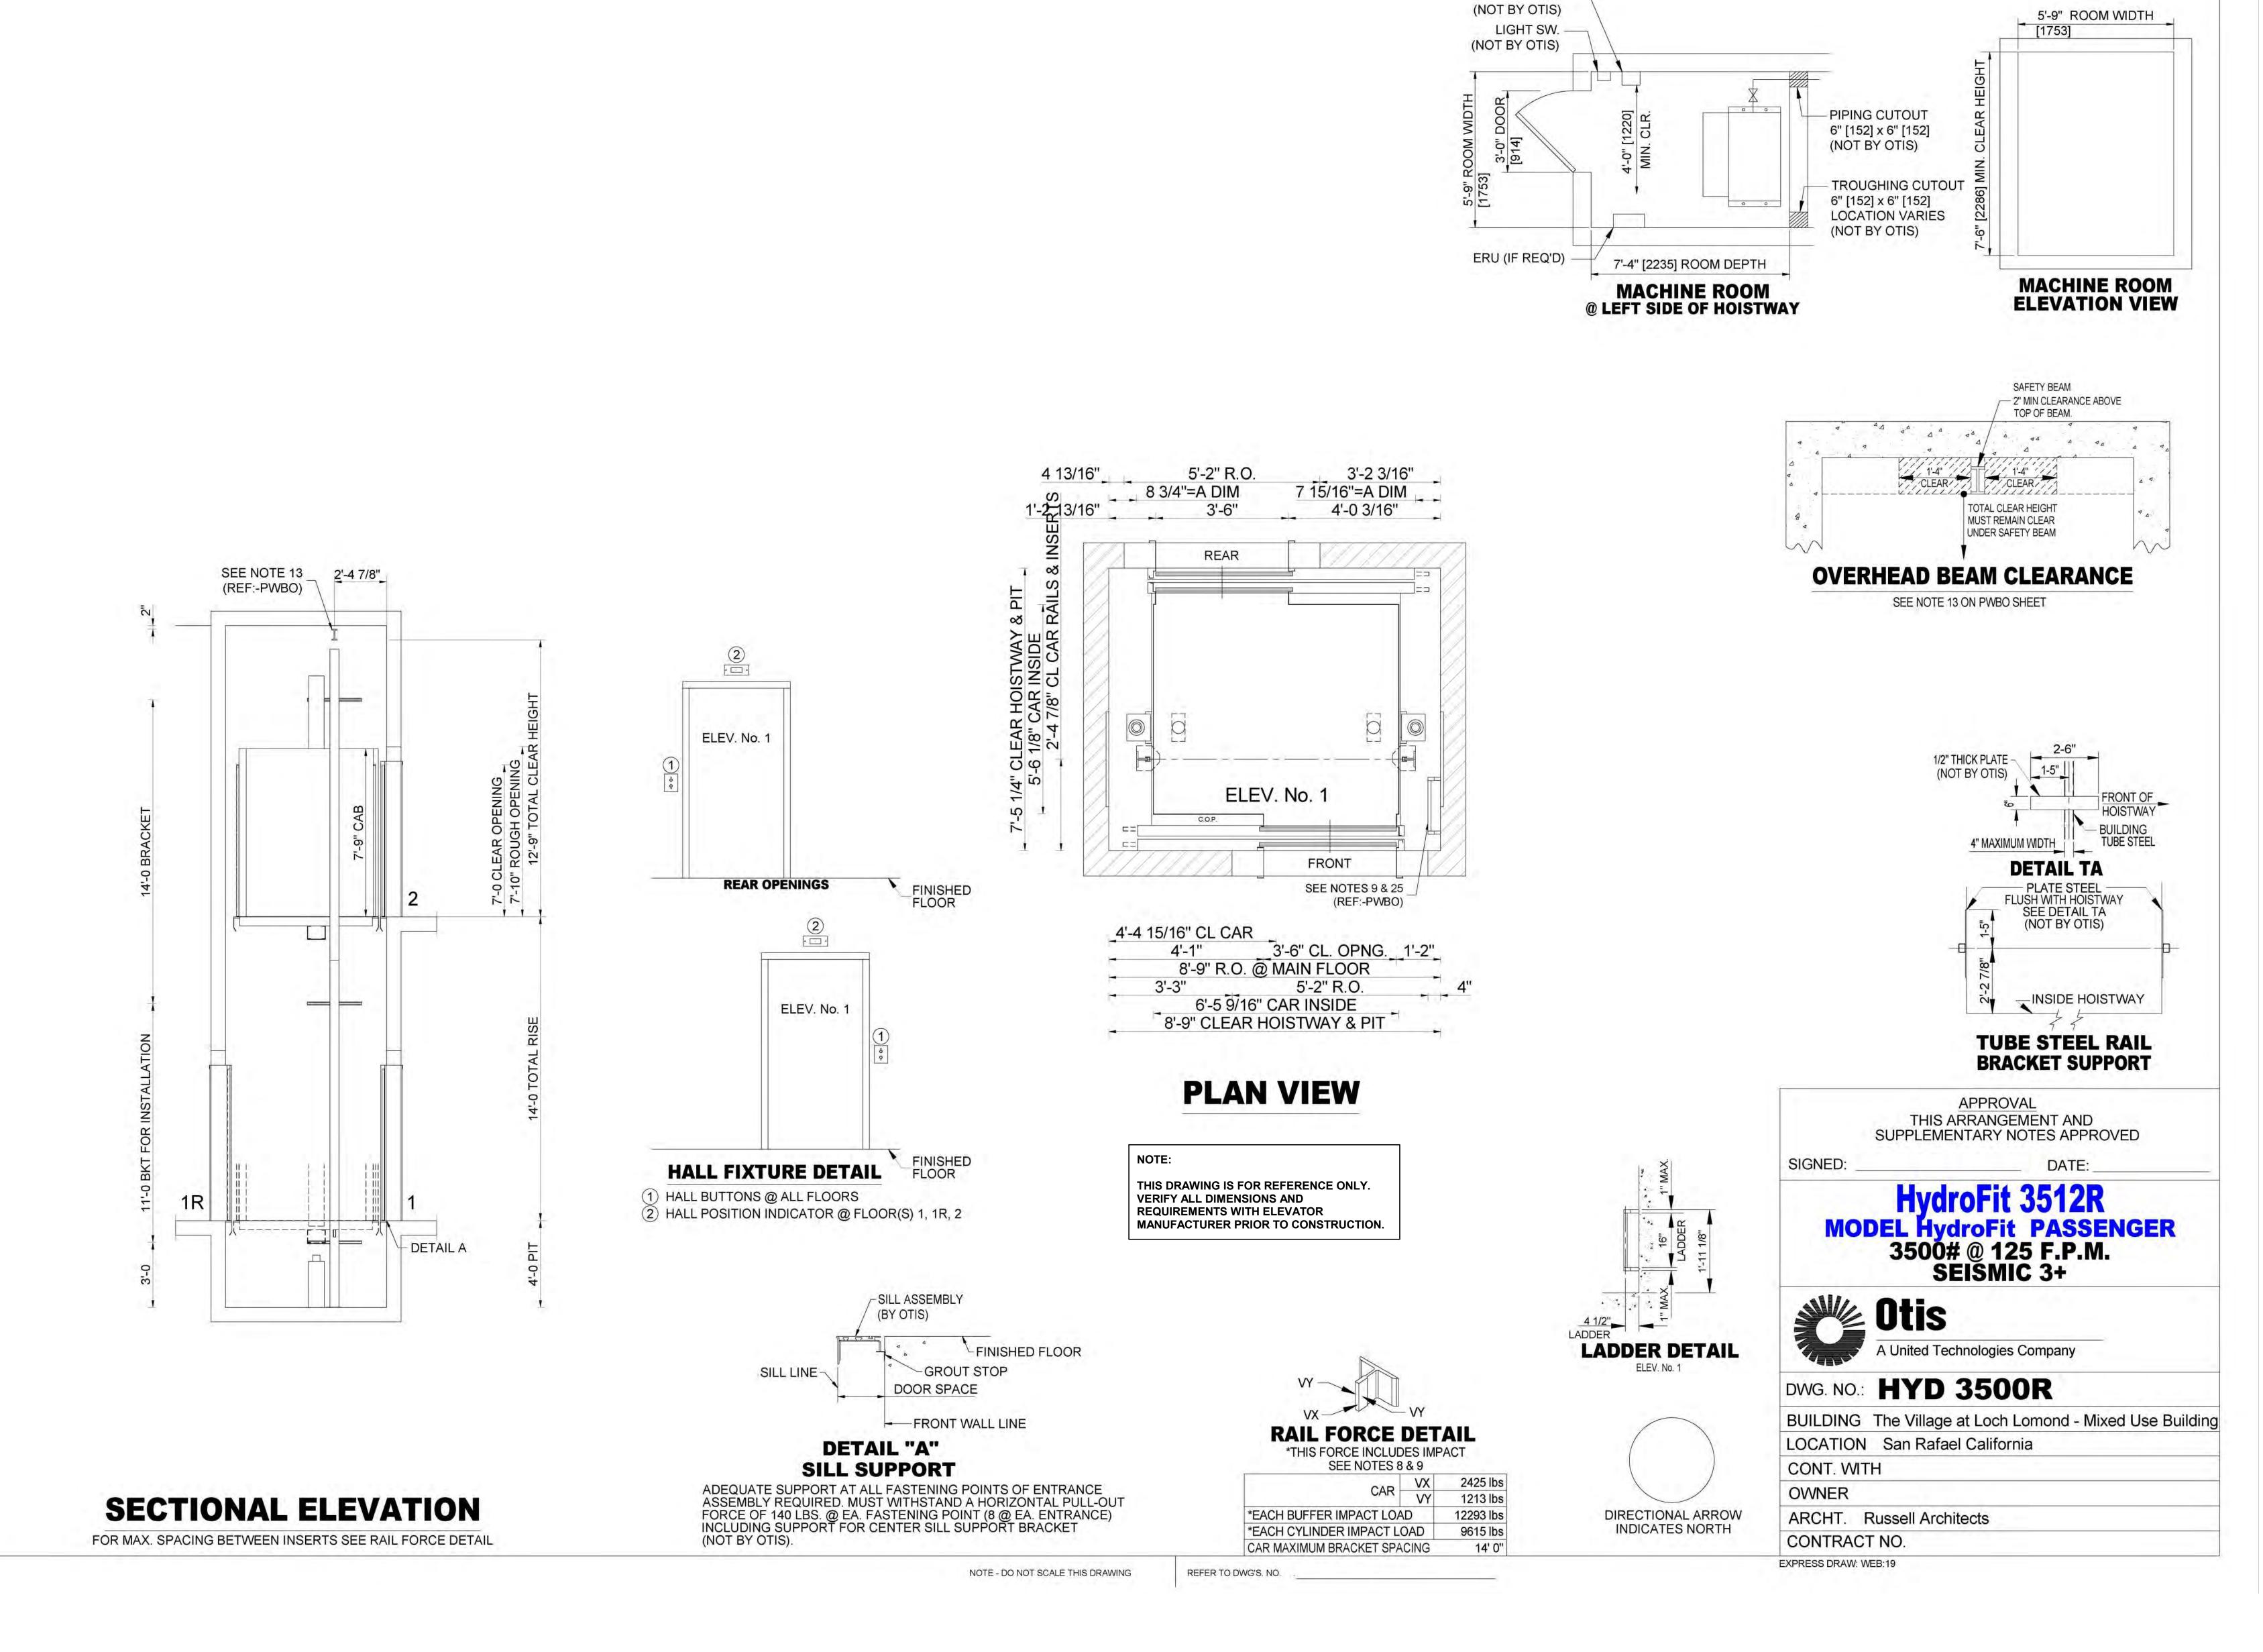

MAINLINE -



990 A Street, Suite K San Rafael, CA 94901 415.671.8892 tel. 415.594.0857 fax




Harbor Flats at **Loch Lomond**

Project No.:		22300
Drawn By:		Autho
Checked By:	Checke	
Issued Date:	PLANNING SUBMITTAL 4/17/2	
Revisions		
No.	Description	Date

responsible to verify all dimensions and conditions on the job. Russell Architects must be notified of any variations drawings. Electronic files furnished by Russell Architects are strictly for reference only. Russell Architects shall be indemnified and held harmless for any and all modifications to such electronic files by others.

Elevator Mfr. **Details**

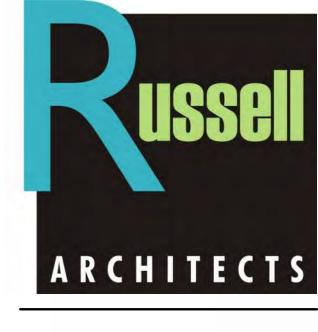



Harbor Flats at **Loch Lomond**

25 Loch Lomond Drive San Rafael, CA


	223006
	Autho
	Checke
PLANNING SUE	BMITTAL 4/17/25
Description	Date

Material herein is for use by authorized contractors, bidders and subcontractors in connection with this project only. All dimensions an these drawings shall take precedence over scaled dimensions. Contractors shall be responsible to verify all dimensions and conditions on the job. Russell Architects must be notified of any variations from the dimensions and conditions shown by these drawings. Electronic files furnished by Russell Architects are strictly for reference only. Russell Architects shall be indemnified and held harmless for any and all modifications to such electronic files by others.


Sheet Title Exterior

Elevations

Scale: 1/8" = 1'-0"

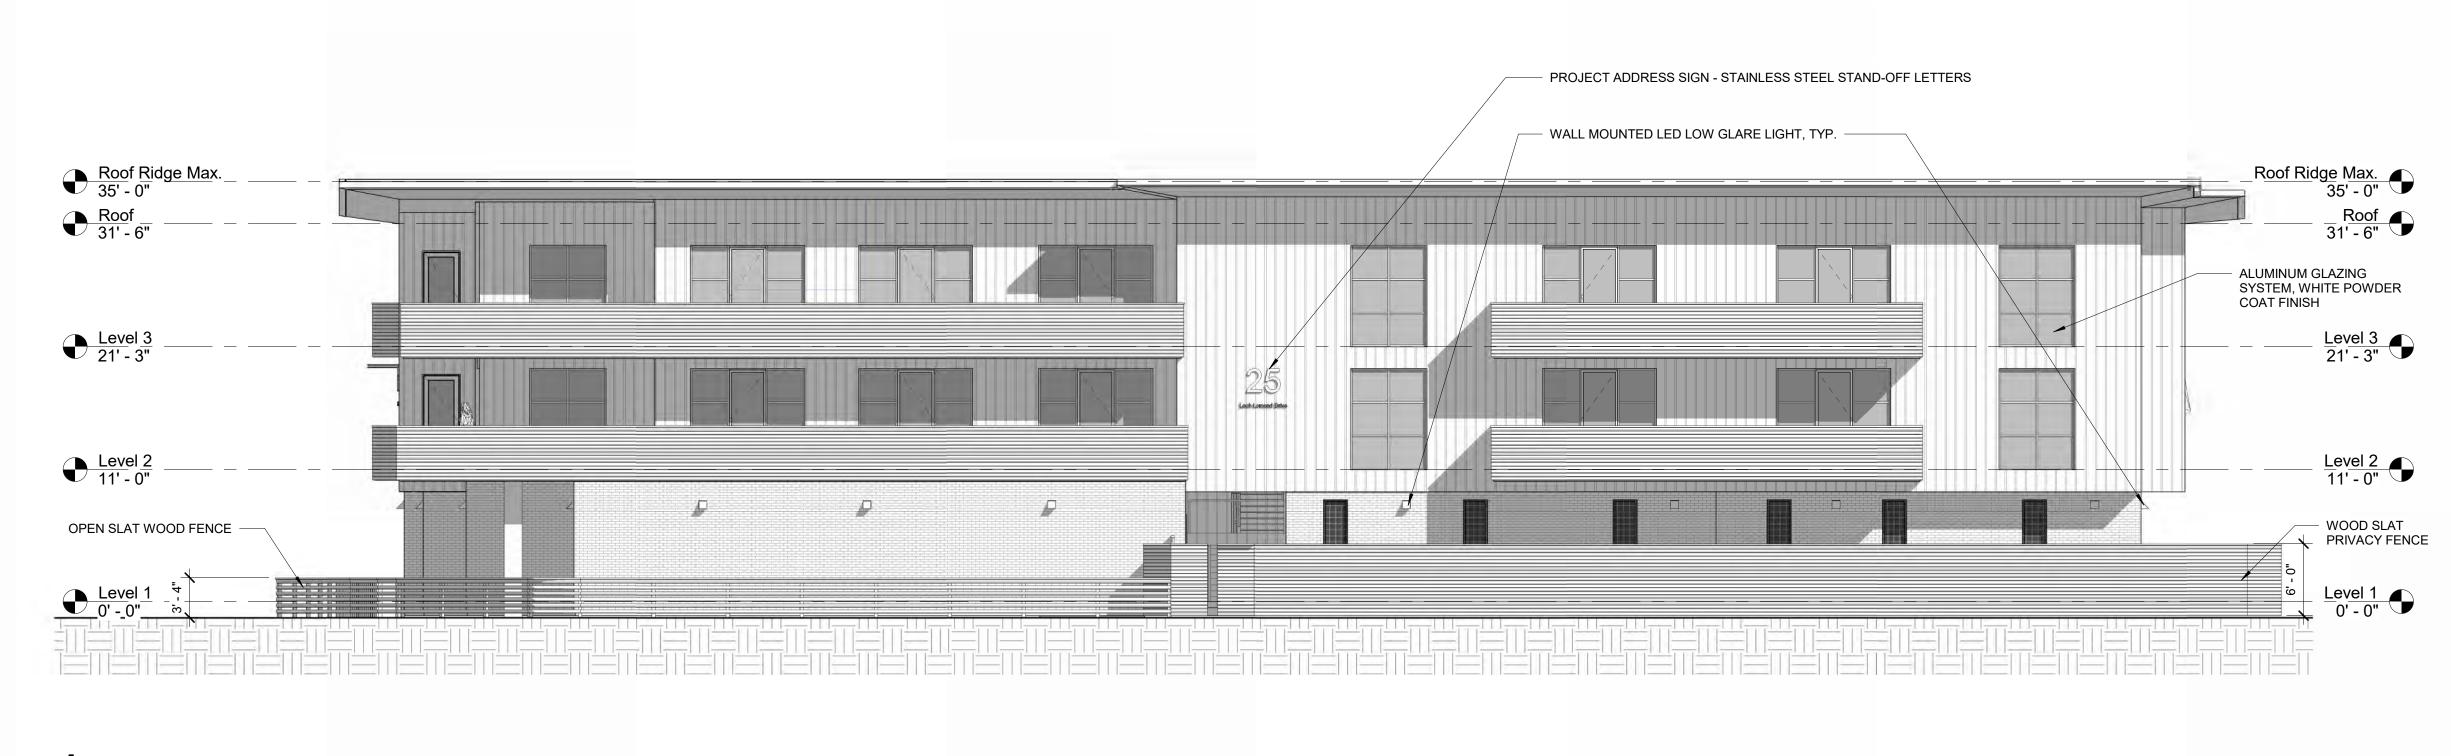


North 1/8" = 1'-0"

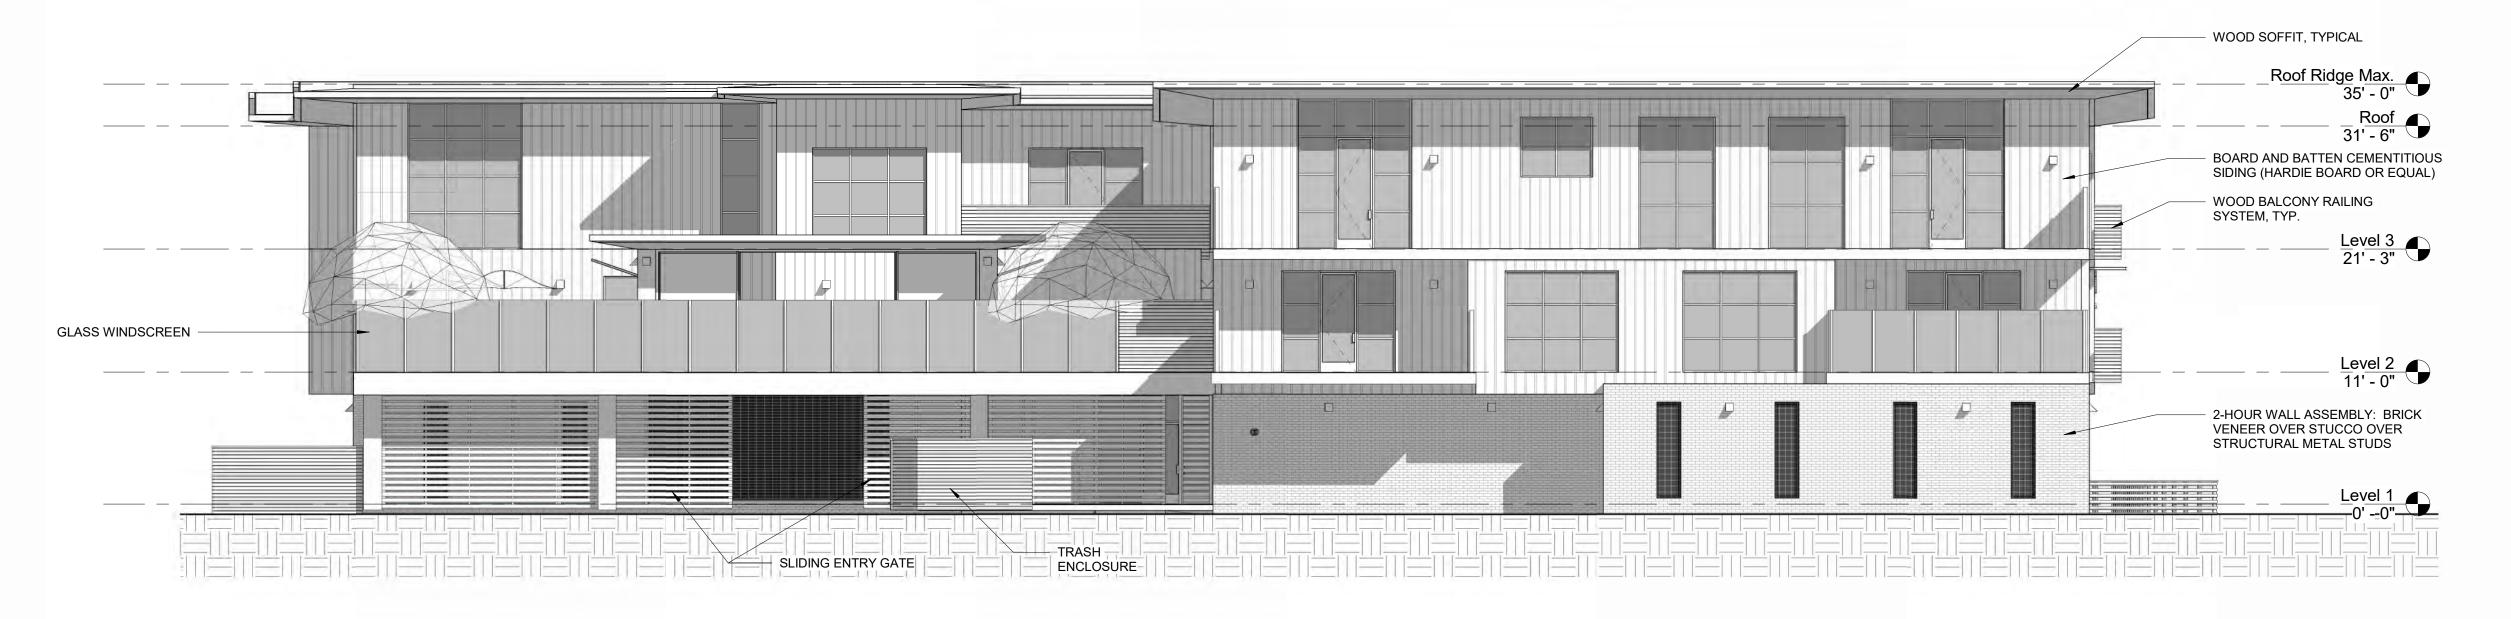


1/8" = 1'-0"





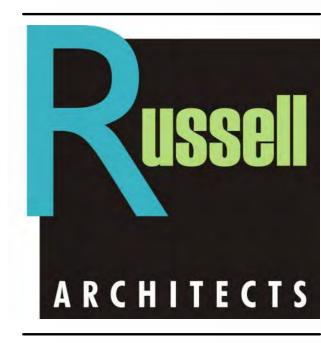

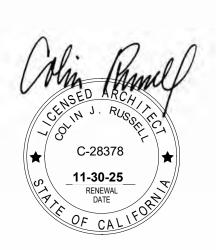

Harbor Flats at Loch Lomond

25 Loch Lomond Drive San Rafael, CA

Project No.:		223006
Drawn By:		Author
Checked By:		Checker
Issued Date:	PLANNING SUI	BMITTAL 4/17/25
Revisions		
No.	Description	Date

Material herein is for use by authorized contractors, bidders and subcontractors in connection with this project only. All dimensions an these drawings shall take precedence over scaled dimensions. Contractors shall be responsible to verify all dimensions and conditions on the job. Russell Architects must be notified of any variations from the dimensions and conditions shown by these drawings. Electronic files furnished by Russell Architects are strictly for reference only. Russell Architects shall be indemnified and held harmless for any and all modifications to such electronic files by others.

Sheet Title

Exterior

Elevations


Scale: 1/8" = 1'-0"

A502

Of Sheets




Section - Longitudinal

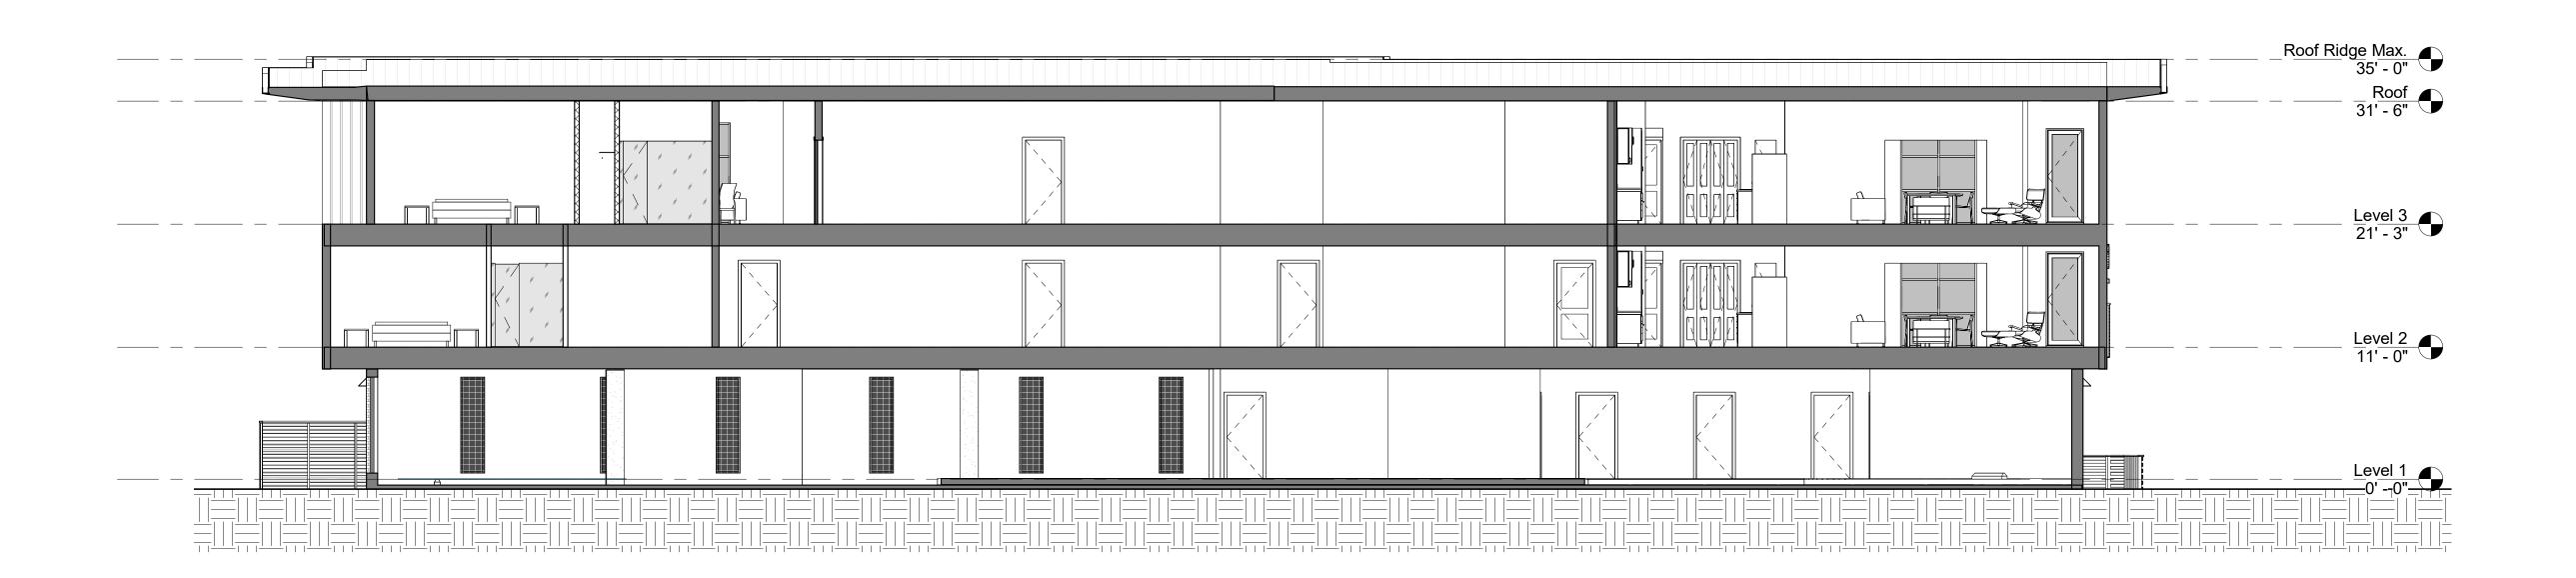

Section - Transverse 1/8" = 1'-0"



990 A Street, Suite K San Rafael, CA 94901 415.671.8892 tel. 415.594.0857 fax

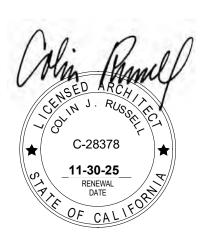

Harbor Flats at **Loch Lomond**

25 Loch Lomond Drive San Rafael, CA

Project No.:		223006
Drawn By:		Autho
Checked By:		Checke
Issued Date:	PLANNING SUE	BMITTAL 4/17/2
Revisions		
No.	Description	Date

Material herein is for use by authorized contractors, bidders and subcontractors in connection with this project only. All dimensions an these drawings shall take precedence over scaled dimensions. Contractors shall be responsible to verify all dimensions and conditions on the job. Russell Architects must be notified of any variations from the dimensions and conditions shown by these drawings. Electronic files furnished by Russell Architects are strictly for reference only. Russell Architects shall be indemnified and held harmless for any and all modifications to such electronic files by others.

Building Sections

Scale: 1/8" = 1'-0"

BENCHMARK

BENCHMARK IS COUNTY BENCHMARK 3625, SET IN N.E CORNER OF WALKWAY ON BRIDGE OVER WALNUT CREEK AT INTERSECTION WALNUT BOULEVARD, CHERRY LANE, AND WALDEN ROAD.

ELEVATION: 111.982 (NAVD 88)

	$I \subseteq I$	
- (-		
-		

PROPOSED	DESCRIPTION	EXISTING
	TRACT BOUNDARY	
	LOT LINE	
	RIGHT OF WAY	
	CENTER LINE	
	MATCH LINE	
	RETAINING WALL	
	EASEMENT LINE	
< 12"SD	STORM DRAIN	<u>EX 12"SD</u> } -
<u>8"SS</u>	SANITARY SEWER	<u>EX 12"SS</u>
12"W	POTABLE WATER	
8"W(R)	RECYCLED WATER	——————————————————————————————————————

EARTH OR GRASS SWALE VALLEY GUTTER STORM WATER INLET DROP INLET AREA DRAIN BUBBLE UP MANHOLE

SANITARY SEWER LATERAL

WATER SERVICE WITH METER BOX ———— BACKFLOW DEVICE WATER VALVE AIR RELEASE VALVE POST INDICATOR VALVE FIRE DEPARTMENT CONNECTION SINGLE ARM STREET LIGHT DOUBLE ARM STREET LIGHT POST TOP LIGHT PEDESTRIAN LIGHT MONUMENT TRAFFIC SIGN STREET NAME SIGN

SANITARY SEWER CLEAN OUT

****----

MINIMUM OVERHEAD



HYDROMOD VAULT

CONTOUR ELEVATIONS

NEW ASPHALT PAVEMENT

BIO-RETENTION AREA IN LANDSCAPE AREA

BIO-RETENTION AREA ADJACENT TO SIDEWALK

SPOT ELEVATION


ABBREVIATIONS		
AGGREGATE BASE	Р	PAD ELEVATION
ASPHALT CONCRETE	PAE	PRIVATE ACCESS EASEMENT
AREA DRAIN	PAV	PAVEMENT
BEGINNING OF CURVE	PL	PROPERTY LINE
BACK OF CURVE	PIEE	PRIVATE VEHICULAR AND PEDESTRI
BOUNDARY		INGRESS AND EGRESS EASEMENT
BOTTOM	PSSE	PRIVATE SANITARY SEWER EASEME
BACK OF SIDEWALK	PSDE	PRIVATE STORM DRAIN EASEMENT
BOTTOM OF WALL	PWLE	PRIVATE WATER LINE EASEMENT
CENTER LINE	PUE	PUBLIC UTILITY EASEMENT
DROP INLET	PVC	POLYVINYL CHLORIDE PIPE
DRAINAGE MANAGEMENT AREA	RET	CURB RETURN
DWELLING UNITS	RW	RIGHT OF WAY
END OF CURVE	SD	STORM DRAIN
EASEMENT	SF	SQUARE FEET
EMERGENCY VEHICLE ACCESS EASEMENT	SL	STREET LIGHT
EXISTING	SNS	STREET NAME SIGN
FACE OF CURB	SS	SANITARY SEWER
FINISHED FLOOR	SSCO	SANITARY SEWER CLEANOUT
FINISHED GRADE	STD	STANDARD
FIRE HYDRANT	SWE	PUBLIC SIDEWALK EASEMENT
FLOW LINE	SWK	SIDEWALK
GRADE BREAK	SWI	STORM WATER INLET
HIGH POINT	TC	TOP OF CURB
INVERT ELEVATION	TCM	TREATMENT CONTROL MEASURE
LATERAL	TG	TOP OF GRATE
LINEAR FOOT	TW	TOP OF WALL
LOW POINT	TYP	TYPICAL
JOINT TRENCH	W	WATER LINE
MAXIMUM	WLE	WATER LINE EASEMENT
MANHOLE	WM	WATER METER


WATER SERVICE

VESTING TENTATIVE MAP HARBOR FLATS

MARIN COUNTY, CALIFORNIA

FOR: ANDY'S LOCAL MARKET

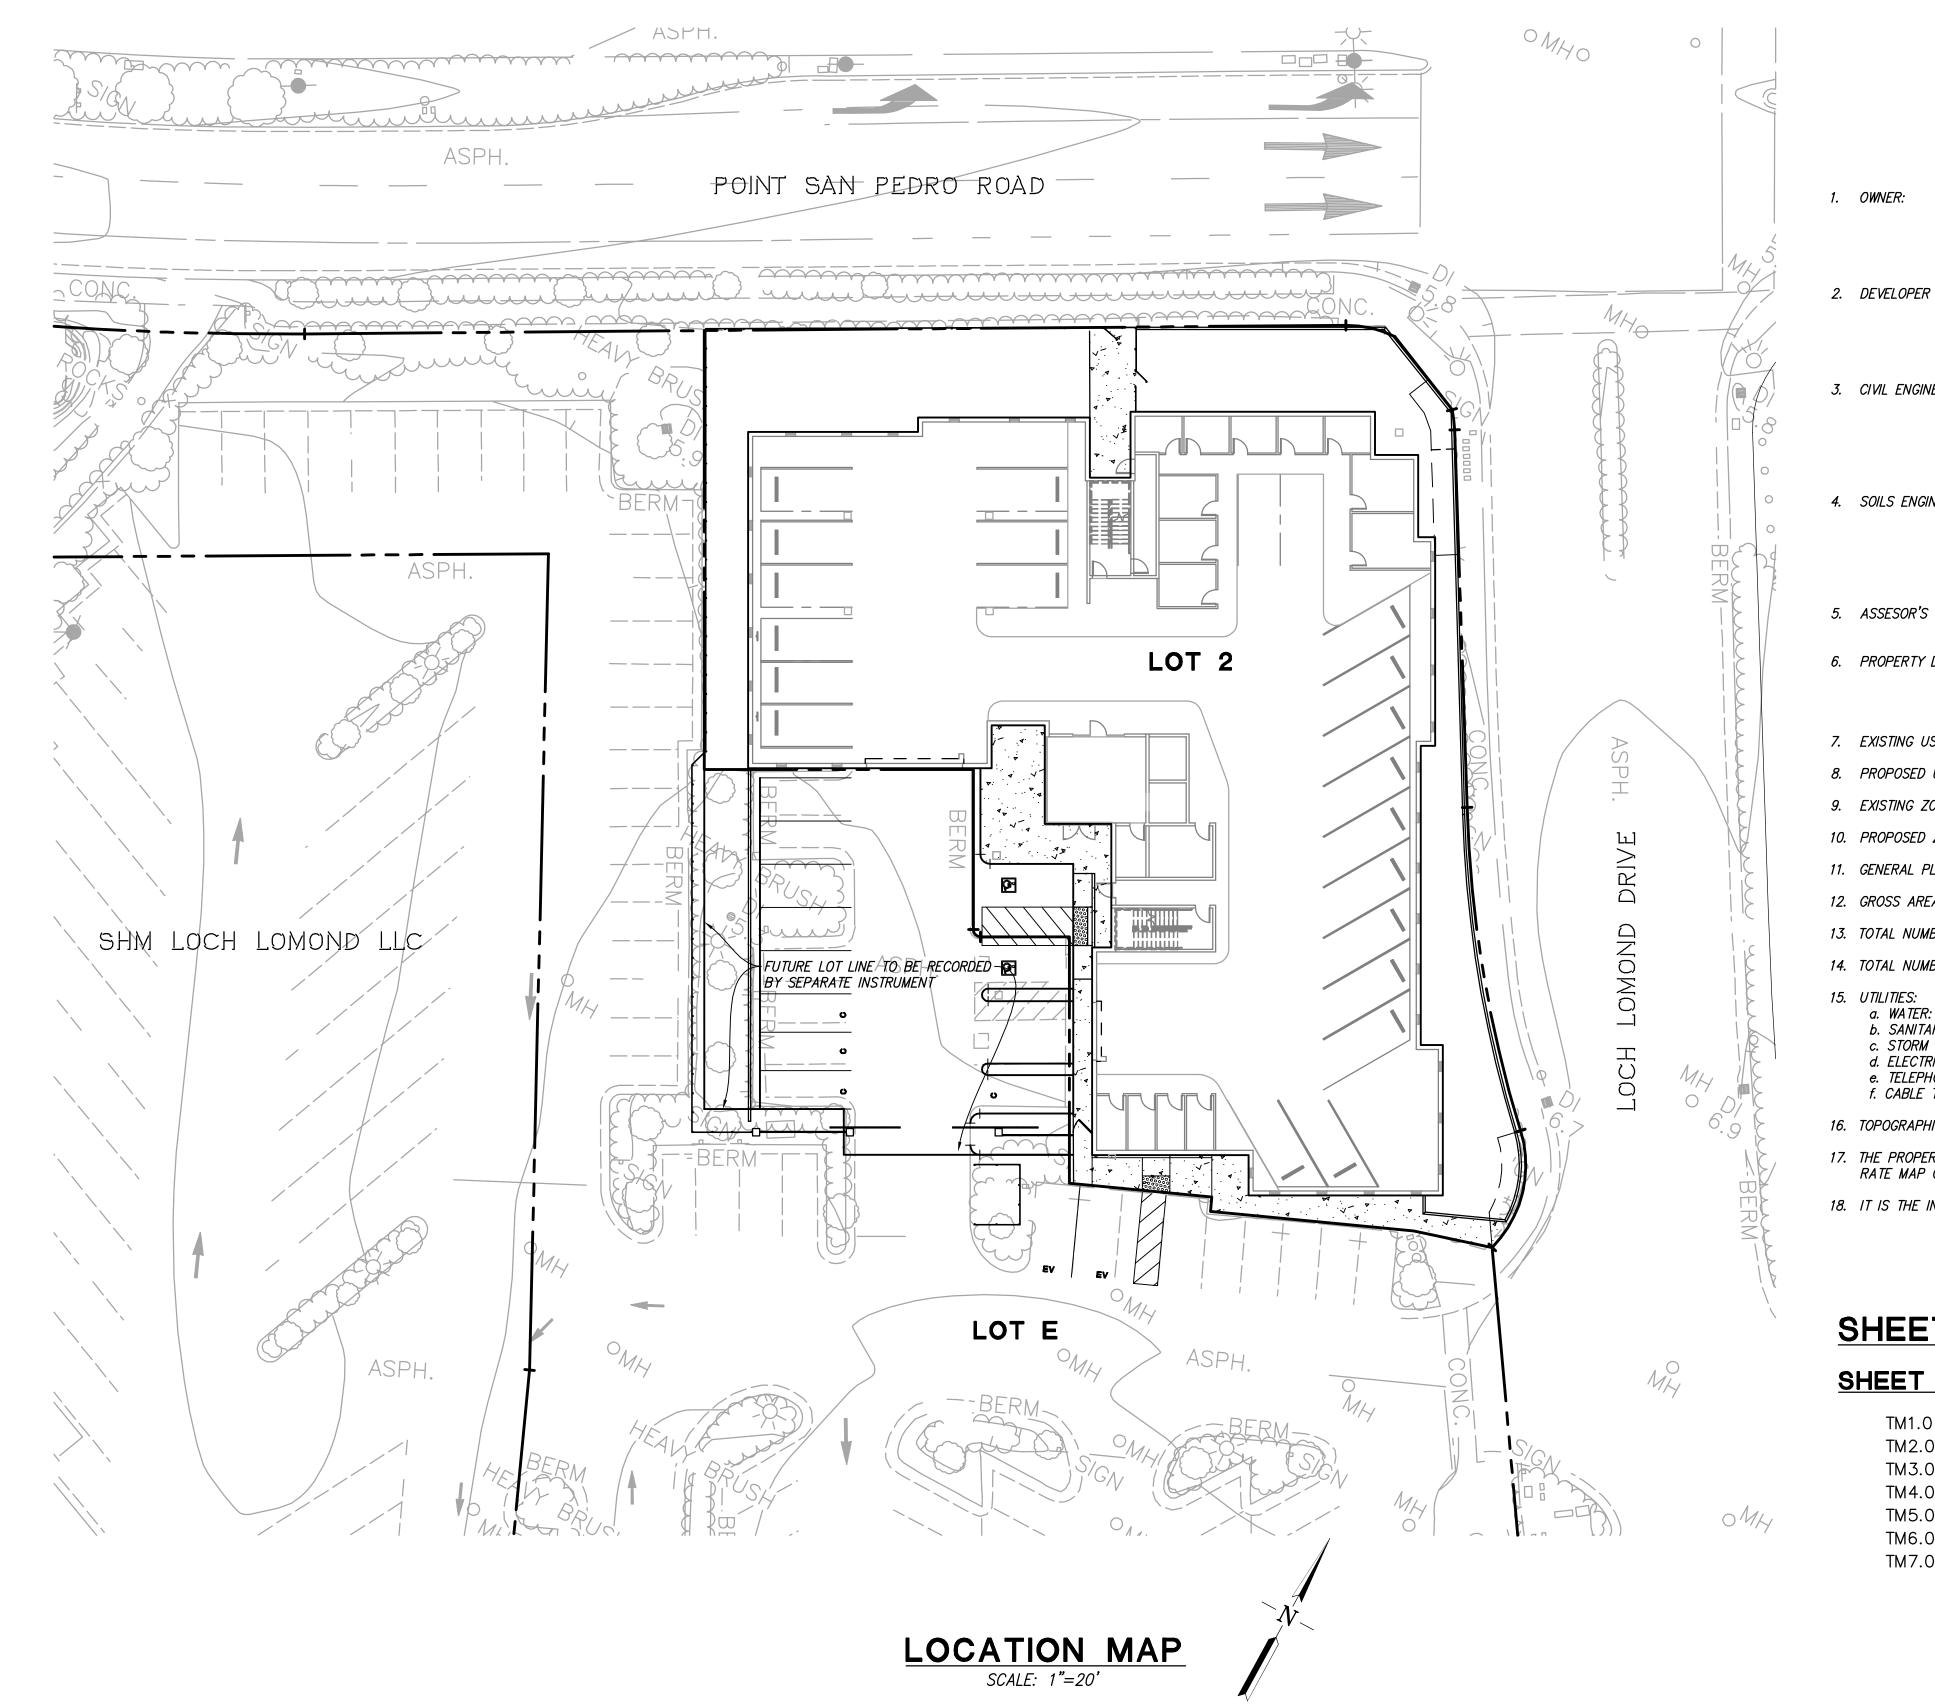

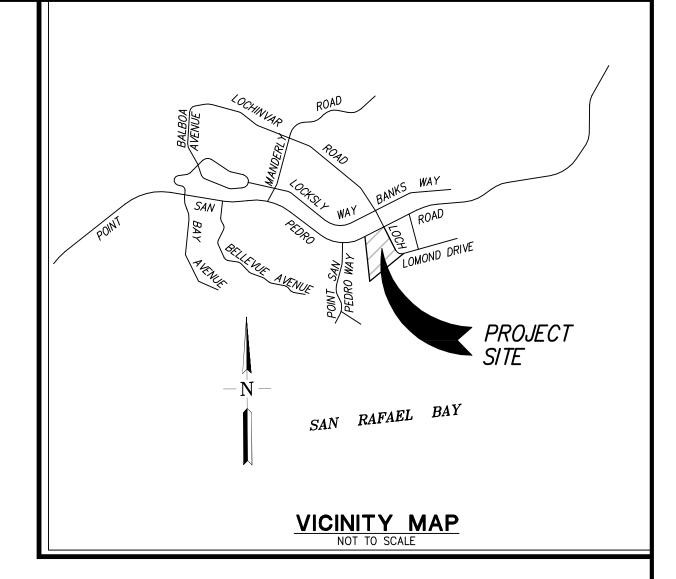

ANDY BACHICH 75 LOCH LOMOND SAN RAFAEL, CA 94901 (415) 456-5730 CONTACT: ANDY BACHICH

CONTACT: COLIN BLY

ANDY BACHICH 75 LOCH LOMOND SAN RAFAEL, CA 94901 (415) 456-5730 CONTACT: ANDY BACHICH

RUGGERI-JENSEN-AZAR 3. CIVIL ENGINEER: 4690 CHABOT DRIVE, SUITE 200 PLEASANTON, CA 94588 (925) 227-9100 CONTACT: DOMINIC CARUCCI, RCE 85585

MILLER PACIFIC ENGINEERING GROUP 4. SOILS ENGINEER: 504 REDWOOD BLVD., SUITE 220 SAN FRANCISCO, CA 94133 (415) 433-4672

016-070-14, 016-070-15 5. ASSESOR'S PARCEL NUMBERS:

6. PROPERTY DESCRIPTION:

OWNER:

LOTS 2 AND E, AS SHOWN ON THE MAP ENTITLED "VILLAGE AT LOCH LOMOND MARINA, PHASE 1" RECORDED MARCH 16, 2015 IN BOOK 2015 OF MAPS AT PAGE 12 (SERIES NO. 2015-0002827), IN THE OFFICE OF THE COUNTY RECORDER OF MARIN COUNTY, CALIFORNIA.

COMMERCIAL USE

7. EXISTING USE: 8. PROPOSED USE: RESIDENTIAL PD(1860)-Z04-002 9. EXISTING ZONING: PD(1860)-Z04-002 10. PROPOSED ZONING:

11. GENERAL PLAN LAND DESIGNATION: NEIGHBORHOOD COMMERCIAL MIXED USE 0.53± ACRES 12. GROSS AREA:

13. TOTAL NUMBER OF LOTS: 14. TOTAL NUMBER OF UNITS:

15. UTILITIES: MARIN MUNICIPAL WATER DISTRICT a. WATER: SAN RAFAEL SANITATION DISTRICT b. SANITARY SEWER: CITY OF SAN RAFAEL c. STORM DRAIN: PACIFIC GAS AND ELECTRICAL d. ELECTRIC: e. TELEPHONE:

16. TOPOGRAPHIC INFORMATION SHOWN IS BASED ON AERIAL SURVEY PREPARED IN MARCH 2021.

COMCAST

17. THE PROPERTY IS WITHIN ZONE X-AREAS DETERMINED TO BE OUTSIDE 500-YEAR FLOOD PLAIN AS SHOWN IN FLOOD INSURANCE RATE MAP COMMUNITY-PANEL NUMBER 06041C0476E, DATED MARCH 16, 2016

18. IT IS THE INTENT OF THE DEVELOPER TO FILE CONDOMINIUM PLANS AFTER THE FINAL MAP APPROVAL.

SHEET INDEX

f. CABLE TV:

SHEET NO. DESCRIPTION


COVER SHEET TM2.0 EXISTING CONDITIONS PLAN PROPOSED LOTTING PLAN


TM4.0 PRELIMINARY GRADING AND DRAINAGE PLAN TM5.0 PRELIMINARY UTILITY PLAN PRELIMINARY STORMWATER TREATMENT PLAN

PRELIMINARY EROSION AND SEDIMENT CONTROL PLAN

RUGGERI-JENSEN-AZAR ENGINEERS • PLANNERS • SURVEYORS 4690 CHABOT DRIVE, SUITE 200 PLEASANTON, CA 94588 PHONE: (925) 227-9100 FAX: (925) 227-9300

TM1.0

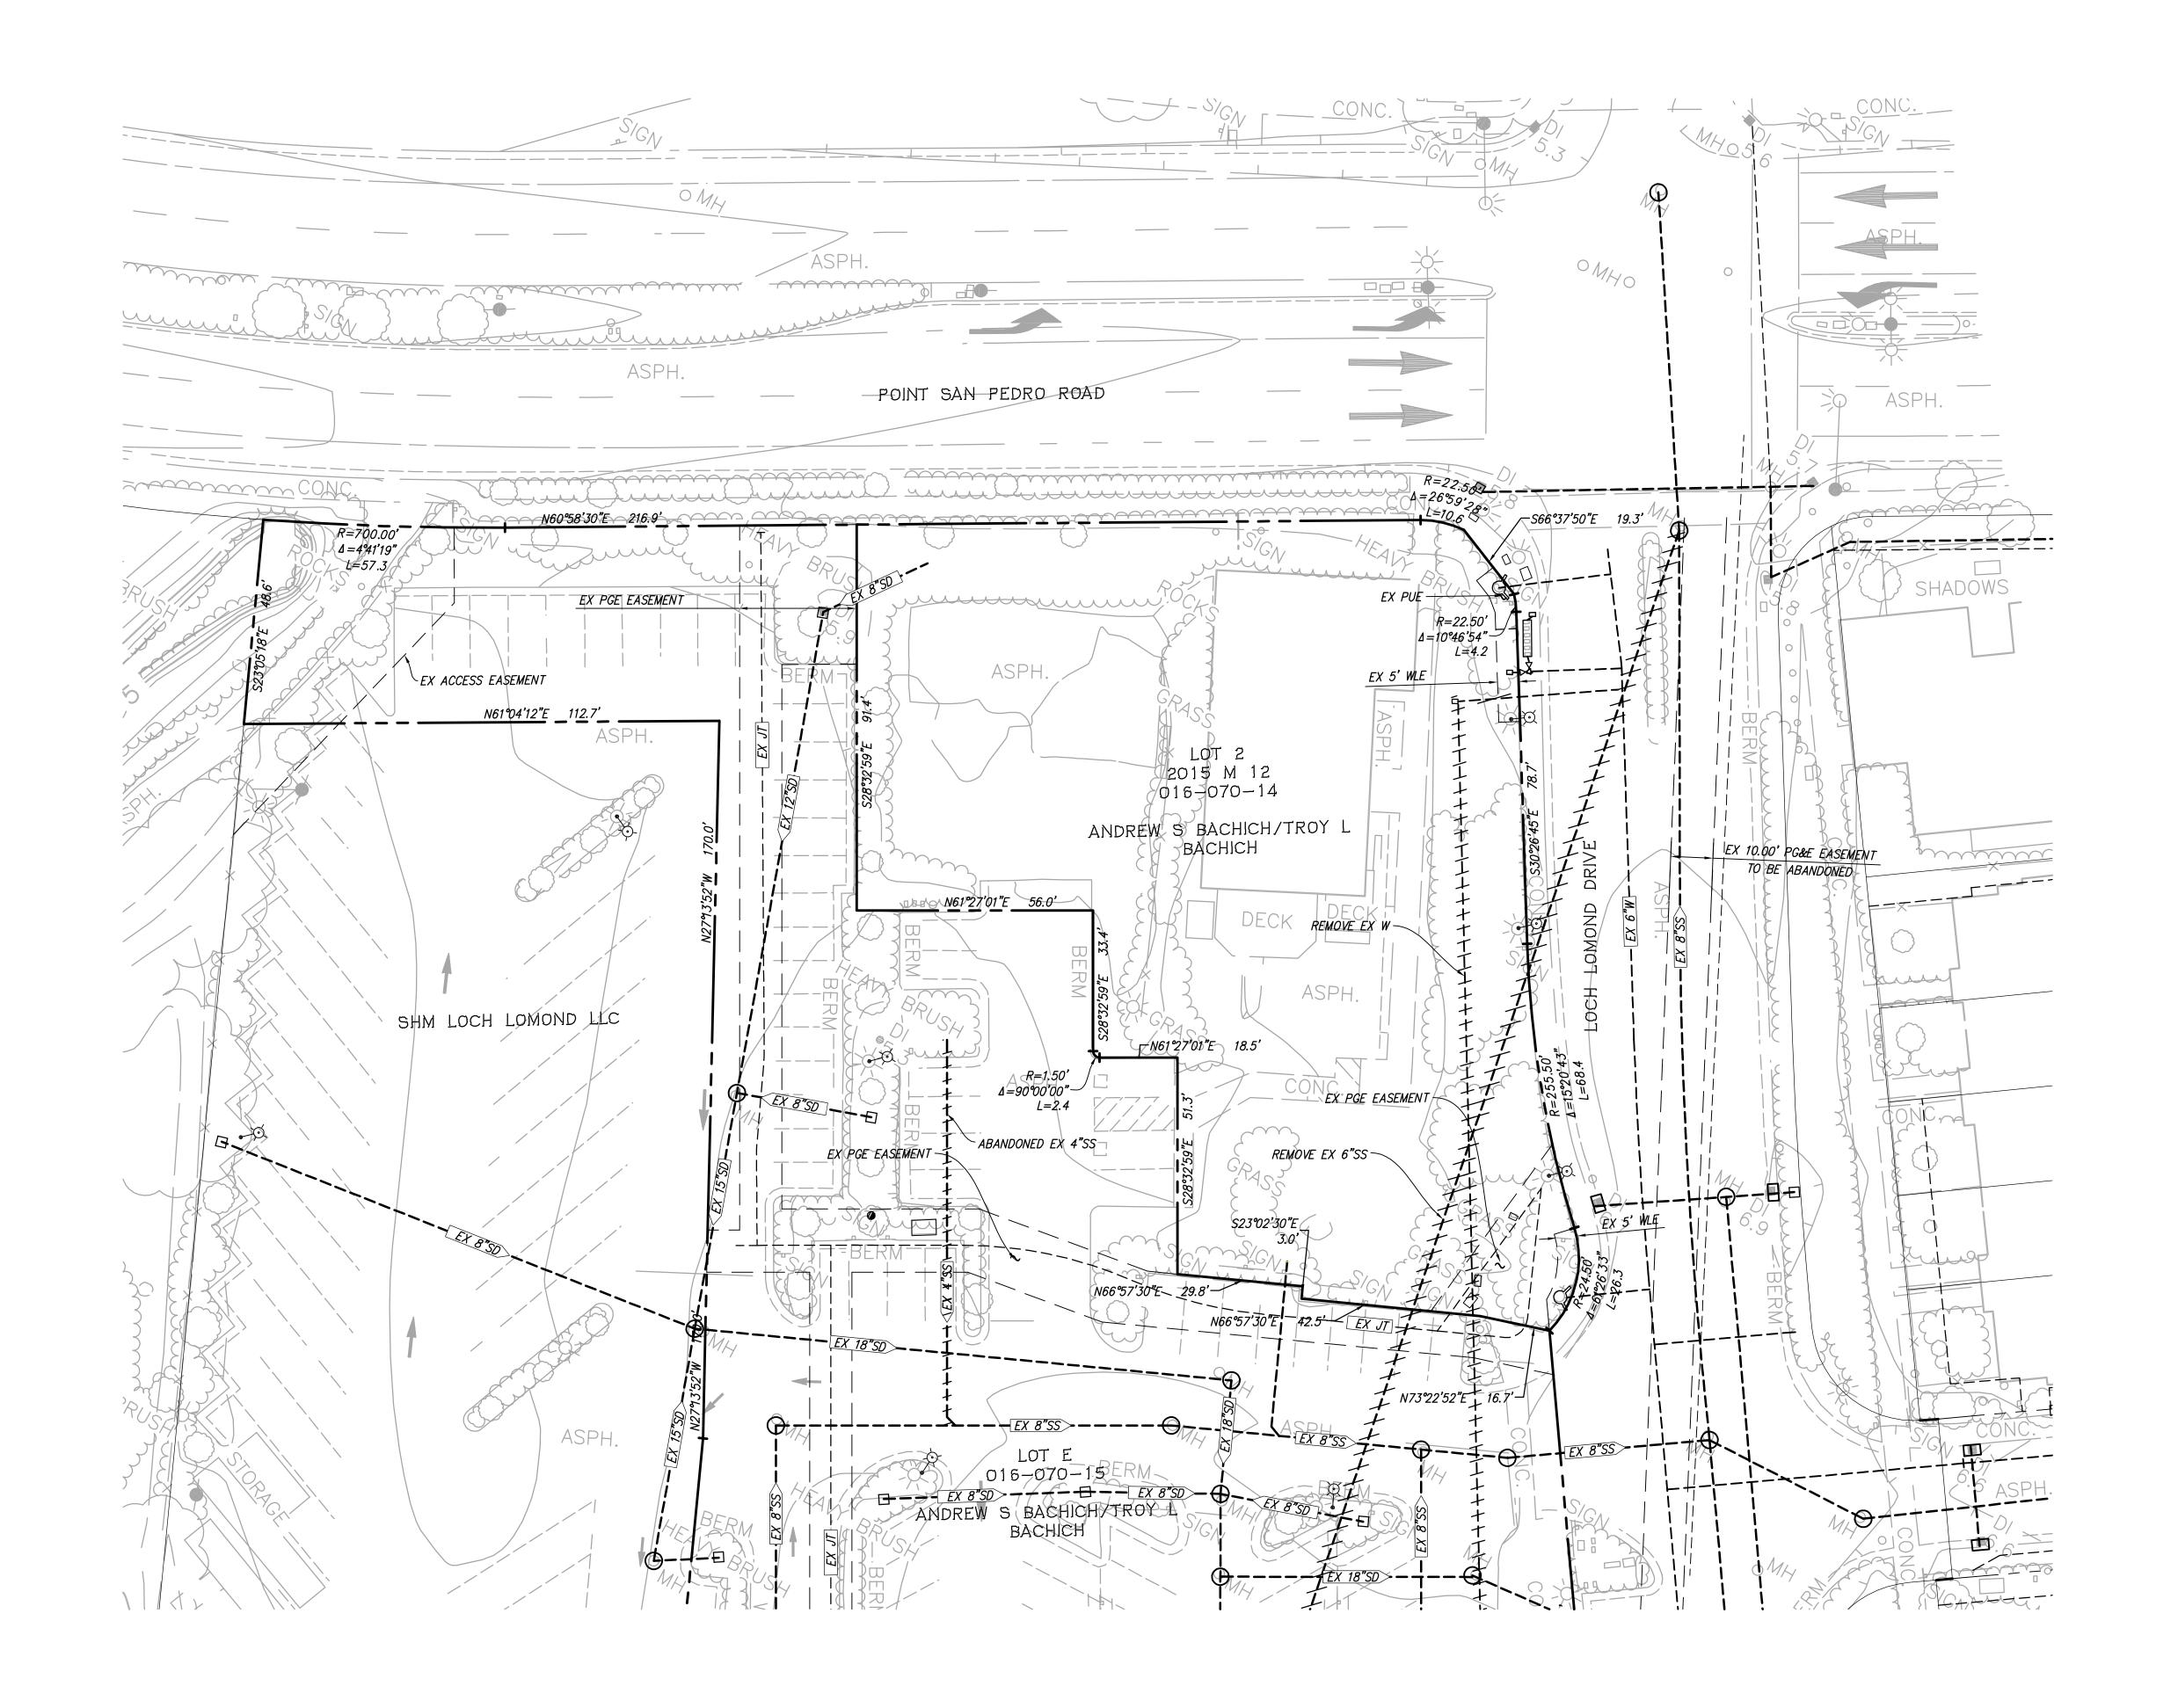


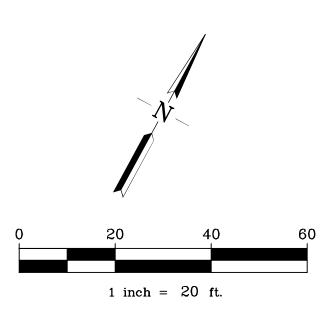

EXISTING CONDITIONS PLAN

HARBOR FLATS

CITY OF SAN RAFAEL, MARIN COUNTY, CALIFORNIA
FOR: TRUMARK HOMES

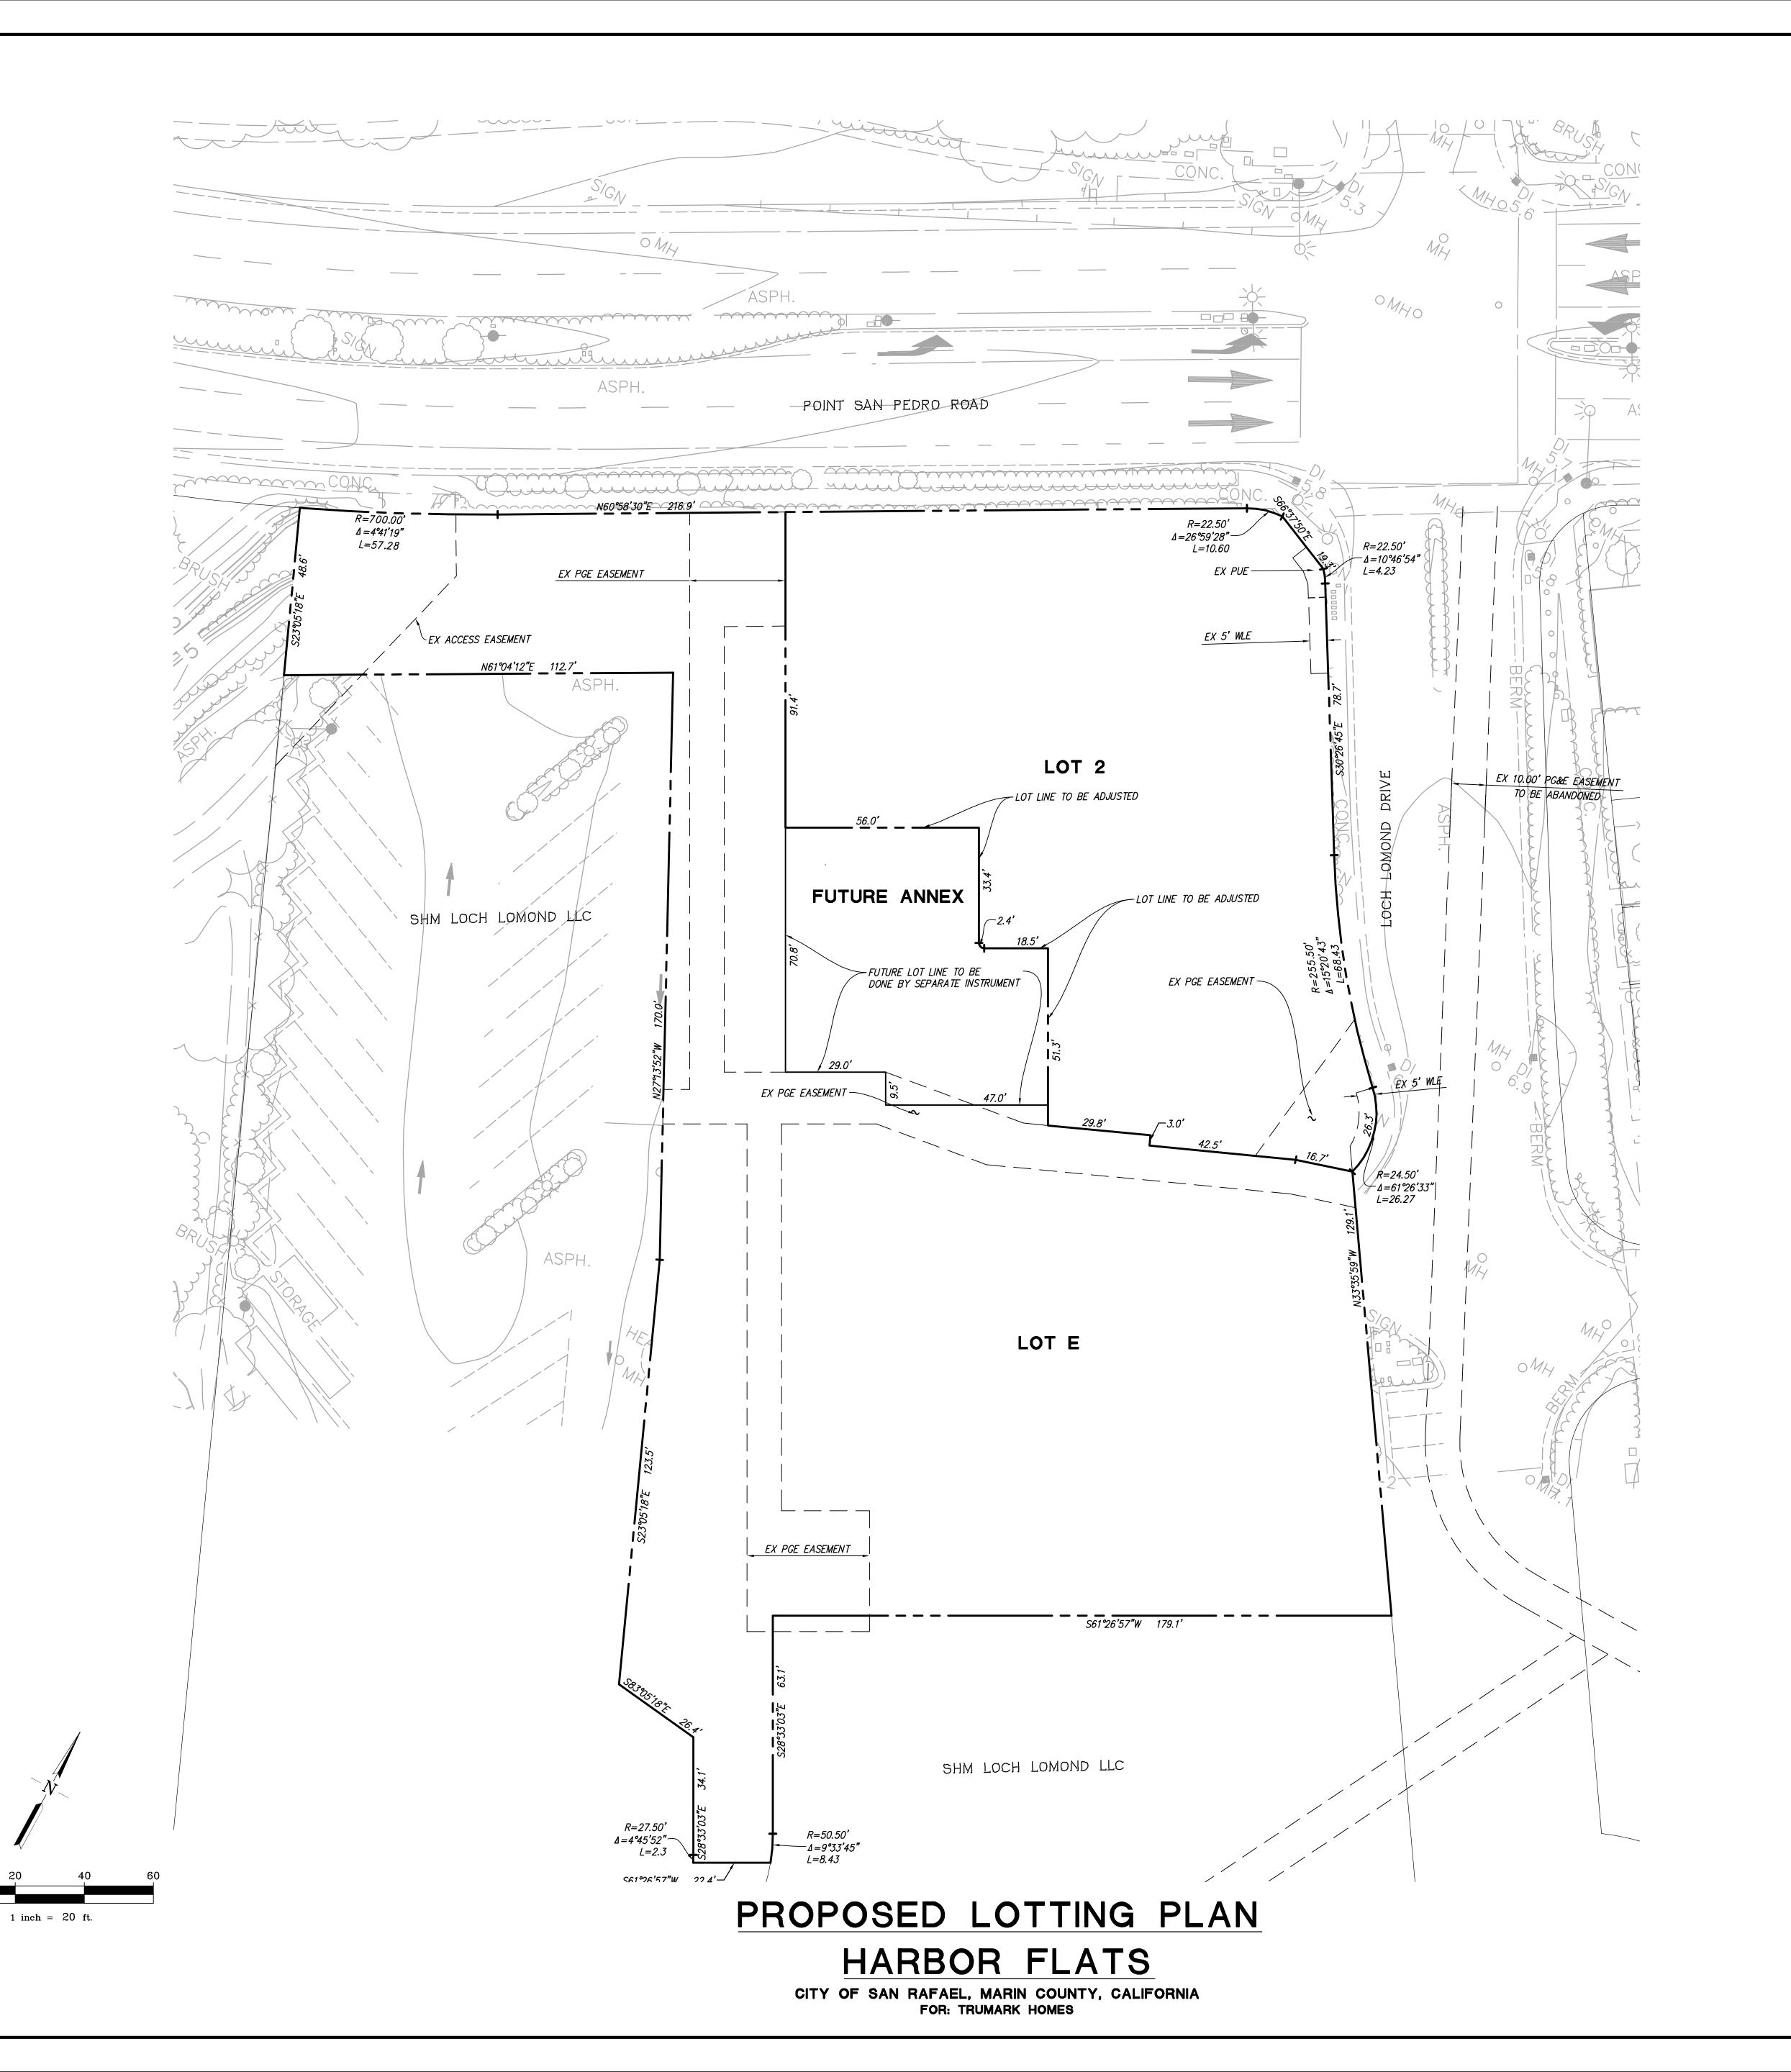



LOT AREA TABLE LOT # AREA (SF) 41,315 FUTURE ANNEX 5,128

> **RUGGERI-JENSEN-AZAR** ENGINEERS PLANNERS SURVEYORS
> 4690 CHABOT DRIVE, SUITE 200 PLEASANTON, CA 94588
> PHONE: (925) 227-9100 FAX: (925) 227-9300

DATE: APRIL 16, 2025

TM3.0

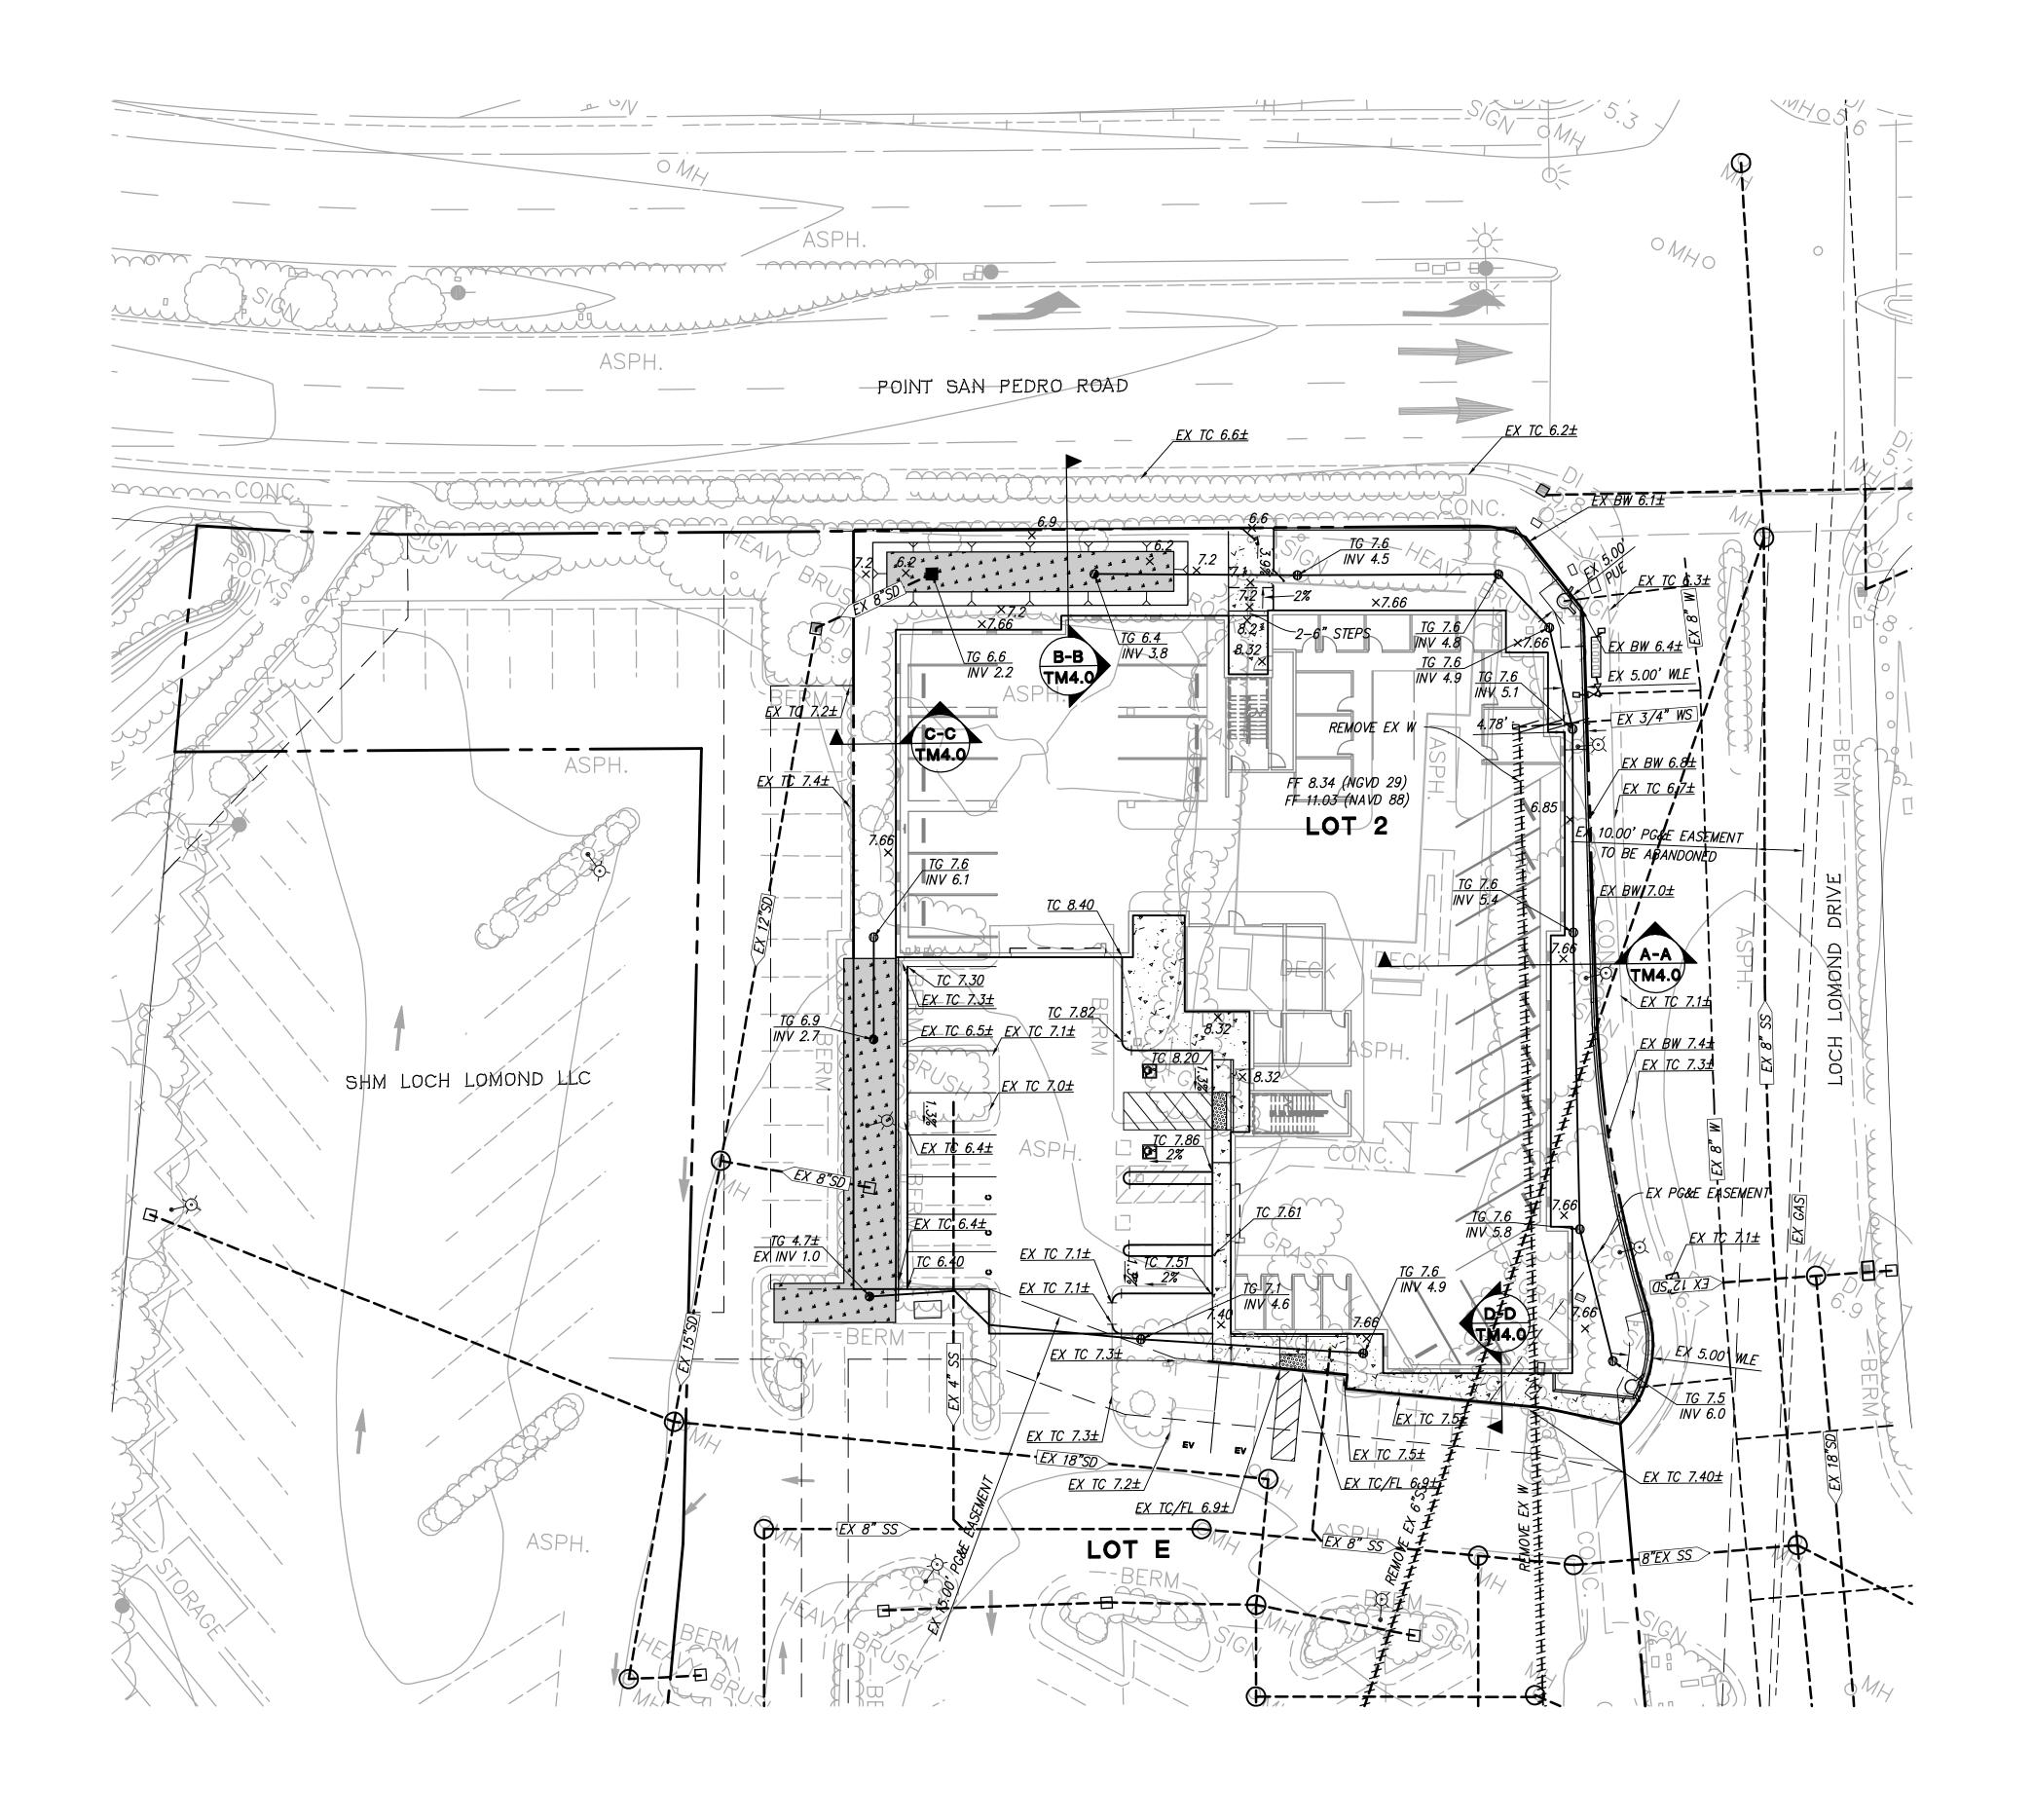

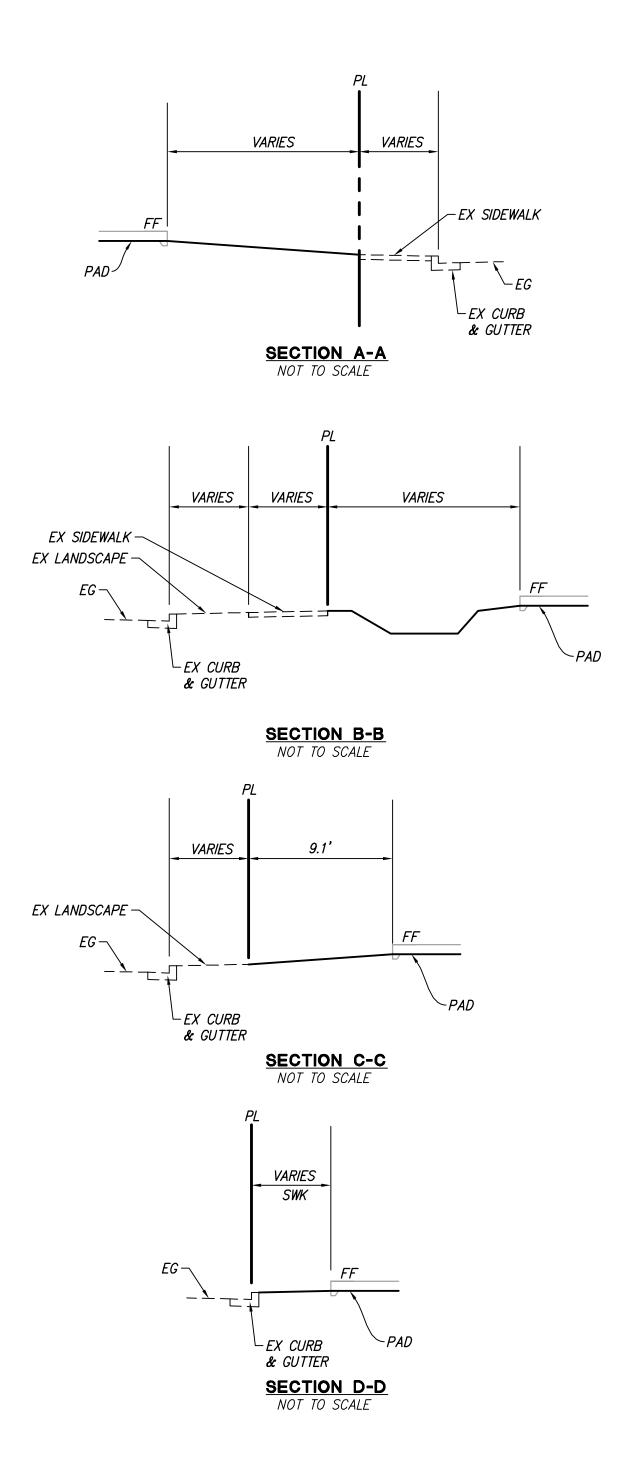


ESTIMATED EARTHWORK QUANTITIES

ITEMS	CUT (C.Y.)	FILL (C.Y.)
DEMOLITION (SEE NOTE 3 BELOW)	(500)	0
LOTS (ANDY MARKET)	700	0
LOTS (BOAT REPAIR & HARBOR MASTER)	0	200
STREETS	3,500	300
TRENCH SPOIL	1,150	0
C.3 SPOILS	<i>750</i>	0
LANDSCAPING/WALKWAYS	0	<i>350</i>
SHRINKAGE (ASSUME 15%)	0	150
TOTAL	6,100	1,000
1. ALL QUANTITIES SHOWN ON THIS	PLAN ARE APPROXIMATE,	CALCULATED CUT

- AND FILL ARE TO "ROUGH GRADE" AND EXISTING GROUND. THE ACTUAL AMOUNT OF EARTH MOVED IS VARIABLE DEPENDENT ON COMPACTION, CONSOLIDATION, STRIPPING REQUIREMENTS, AND THE CONTRACTOR'S METHOD OF OPERATION.
- 2. THE CONTRACTOR SHALL VERIFY ALL EARTHWORK QUANTITIES BEFORE START OF WORK. THE CONTRACTOR SHALL CONTACT THE CIVIL ENGINEER WITH ANY 3. DEMOLITION MATERIAL TO BE OFFHAULED BY THE CONTRACTOR.

BEFORE EXCAVATING CALL U.S.A. UNDERGROUND SERVICE ALERT 800-227-2600 TOLL FREE

48 HOURS BEFORE ALL PLANNED WORK OPERATIONS

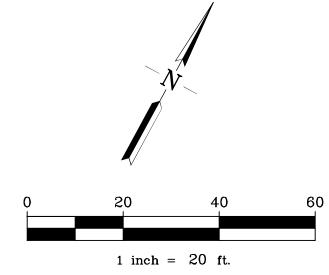



PRELIMINARY GRADING AND DRAINAGE PLAN

HARBOR FLATS

CITY OF SAN RAFAEL, MARIN COUNTY, CALIFORNIA FOR: TRUMARK HOMES

TM4.0

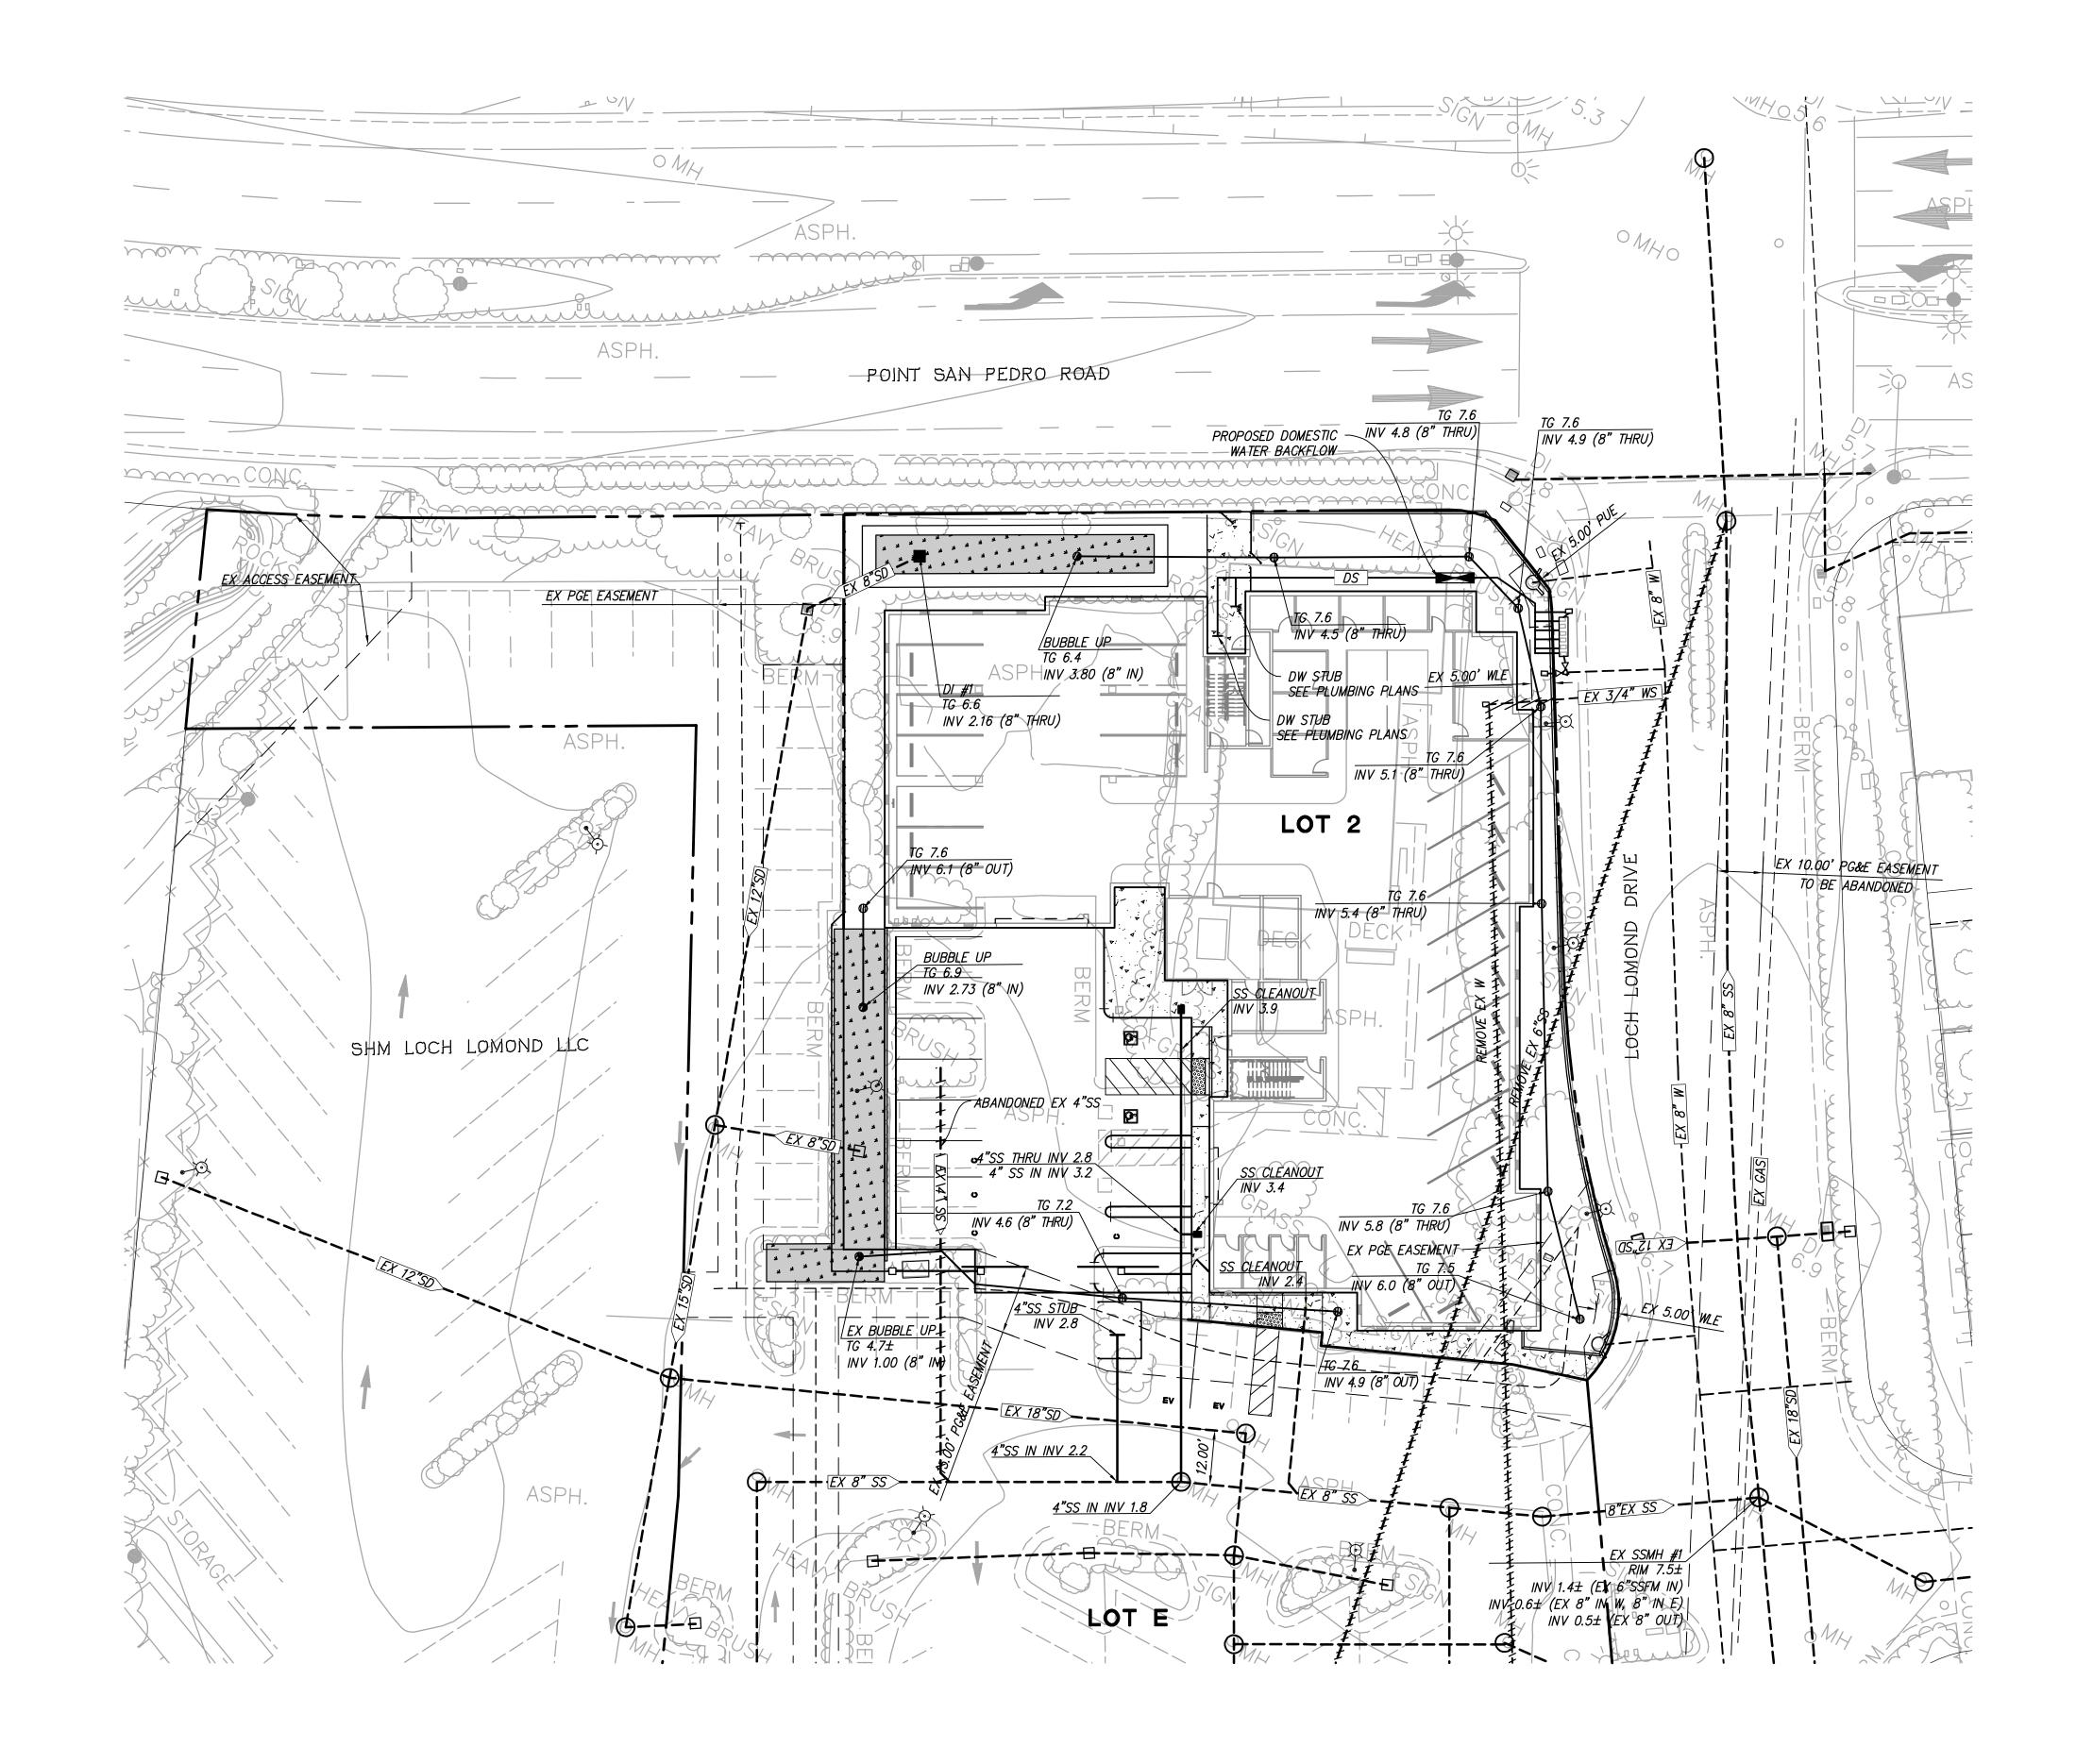

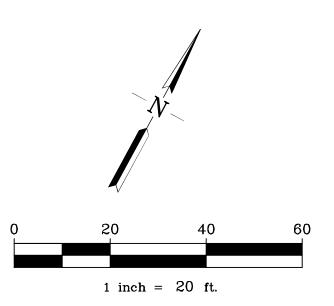


PRELIMINARY UTILITY PLAN

HARBOR FLATS

CITY OF SAN RAFAEL, MARIN COUNTY, CALIFORNIA FOR: TRUMARK HOMES

DATE: APRIL 16, 2025

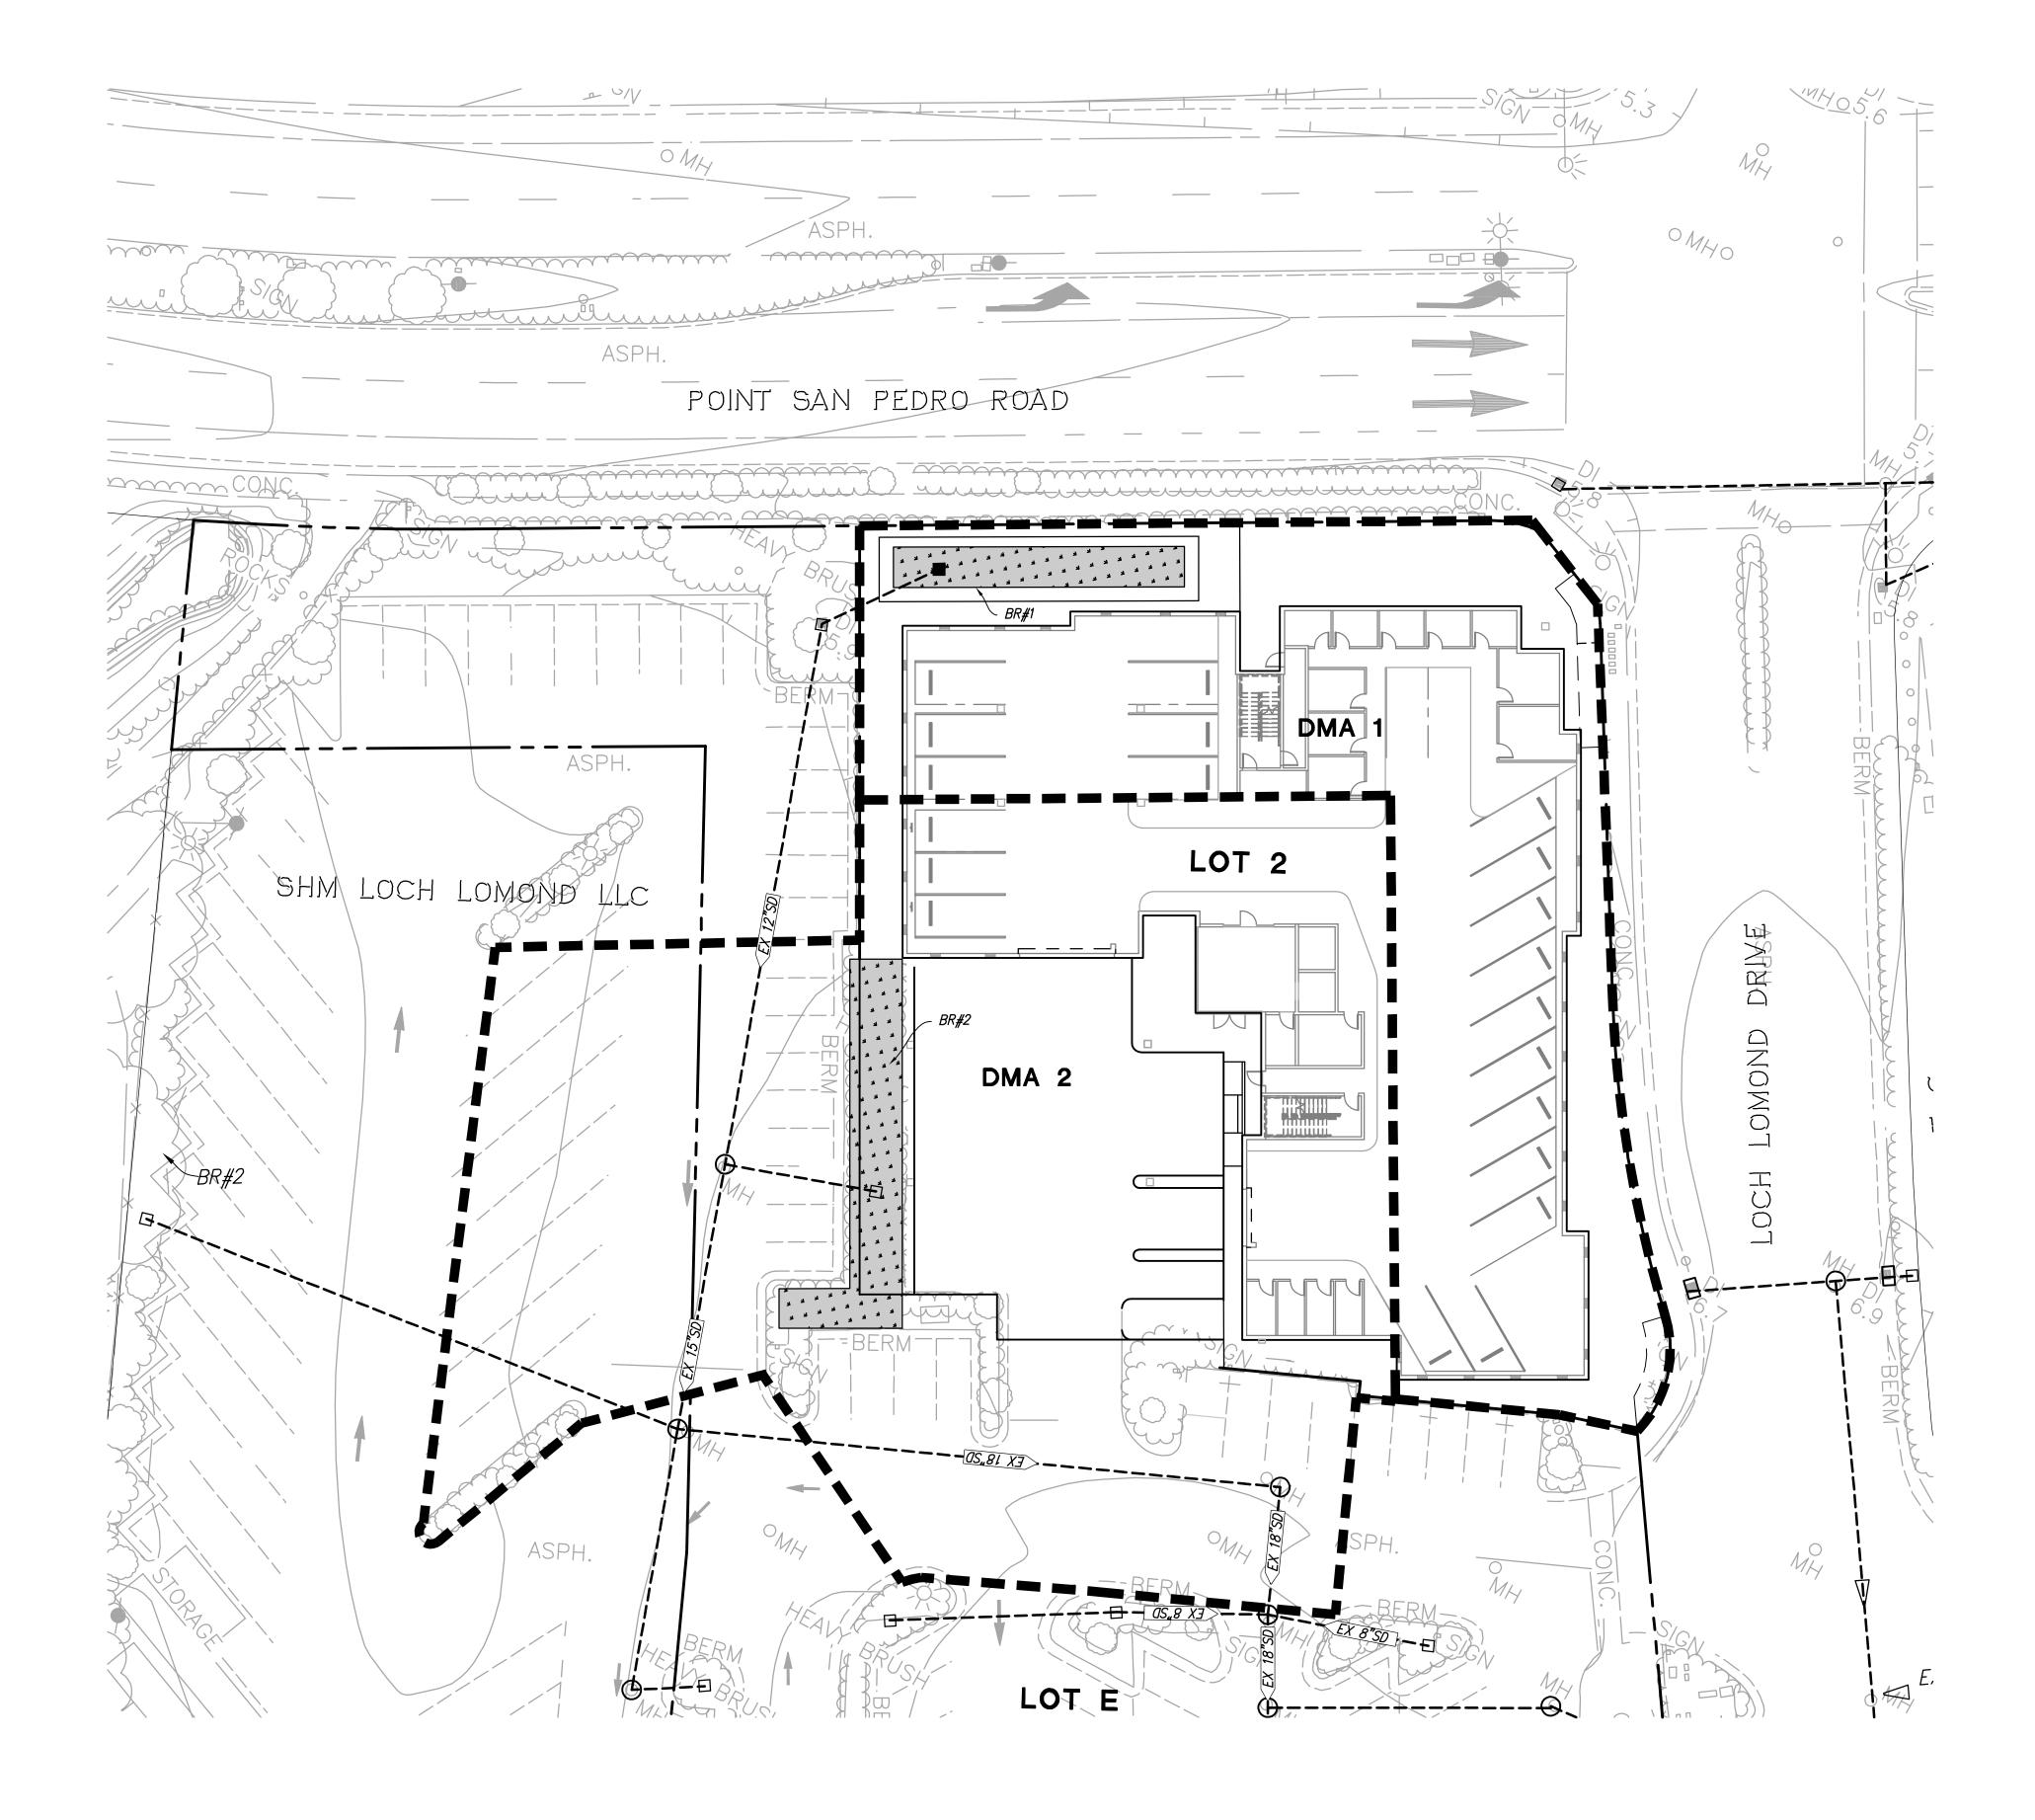


LEGEND

BIO-RETENTION (BR)


DRAINAGE MANAGEMENT AREA BOUNDARY

	STORMWATER TREATMENT CALCULATIONS						
AREA ID	SURFACE TYPE	TOTAL AREA AREA (SF)	IMPERVIOUS AREA (SF)	EFFECTIVE LANDSCAPE AREA (SF)	TREATMENT AREA REQUIRED (SF)	TREATMENT AREA PROVIDED (SF)	
DMA 1	ROOF/PAV	15,423	10,421	500	437	522	
DMA 2	ROOF/PAV	27,170	23,811	<i>336</i>	966	985	


- 1. THE ABOVE CALCULATIONS ARE BASED ON THE CONTRA COSTA CLEAN WATER PROGRAM, STORMWATER C.3 GUIDEBOOK, DATED JUNE 21, 2017, AND THE FOLLOWING CRITERIA: a. EFFECTIVE IMPERVIOUS AREA = IMPERVIOUS AREA + 10% OF PERVIOUS AREA
- b. 0.2 INCHES/HOUR RAINFALL INTENSITY ON 100% OF EFFECTIVE IMPERVIOUS AREA. c. SOIL FOR TREATMENT MEDIUM WITH A 5 INCHES/HOUR INFILTRATION RATE.
- 2. SIZING FACTOR OF 0.04 NOTED ABOVE IS CALCULATED BASED ON THE FOLLOWING CRITERIA: a. SIZING FACTOR=(0.2 IN/HR)/(5 IN/HR)=0.04

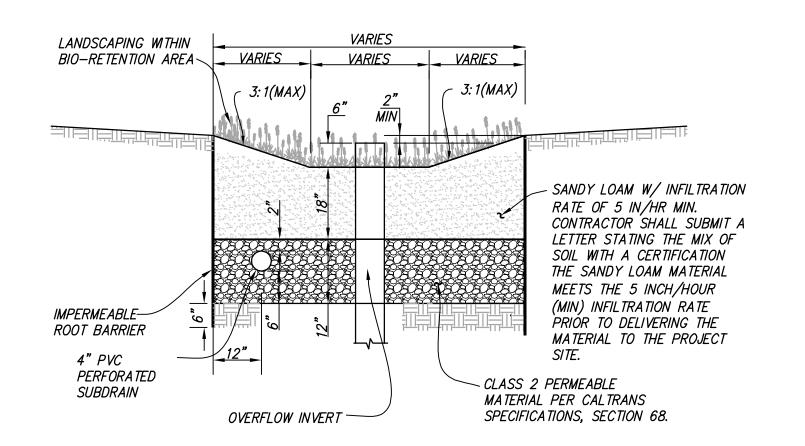

BIO-RETENTION AREA AT LANDSCAPE

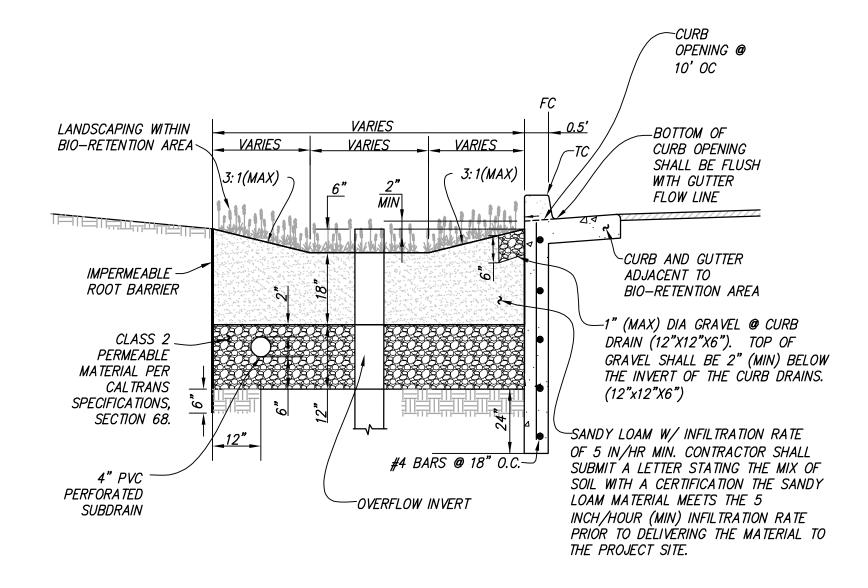

BIO-RETENTION AREA ADJACENT TO CURB

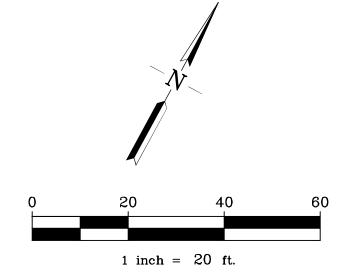

PRELIMINARY STORMWATER TREATMENT PLAN

HARBOR FLATS


CITY OF SAN RAFAEL, MARIN COUNTY, CALIFORNIA FOR: TRUMARK HOMES


TM6.0

EROSION & SEDIMENT CONTROL NOTES


<u>GENERAL</u>


- 1. EROSION AND SEDIMENT CONTROL MEASURES INCLUDING BUT NOT LIMITED TO RUN-ON AND RUNOFF CONTROL, EFFECTIVE SITE MANAGEMENT, AND ONSITE STORM WATER MANAGEMENT THROUGH ALL PHASES OF CONSTRUCTION SHALL BE UTILIZED AT THE SITE AT ALL TIME, YEAR ROUND, UNTIL THE SITE IS FULLY STABILIZED BY LANDSCAPING OR THE INSTALLATION OF PERMANENT EROSION CONTROL MEASURES.
- 2. NO STORM WATER SHALL BE ALLOWED TO DRAIN DIRECTLY INTO THE EXISTING STORM DRAIN SYSTEM BEFORE THE ONSITE STORM DRAIN SYSTEM IS INSTALLED.
- 3. AFTER THE NEW ONSITE STORM SYSTEM IS INSTALLED, THE STORM WATER INLETS SHALL BE INSTALLED AS SOON AS PRACTICAL. EROSION CONTROL DEVICES SHALL BE AT AROUND THOSE CATCH BASINS AS SHOWN ON THESE PLANS
- 4. SHOULD THE PROPOSED ONSITE STORM SYSTEM NOT BE INSTALLED BY SEPTEMBER 15, TEMPORARY SEDIMENT BASINS SHALL BE INSTALLED AROUND THE OPENINGS OF ANY EXISTING STORM PIPES WHICH DRAIN THE SITE.
- 5. THE NAME, ADDRESS AND 24 HOUR TELEPHONE NUMBER OF THE PERSON RESPONSIBLE FOR IMPLEMENTATION OF EROSION AND SEDIMENTATION CONTROL PLAN SHALL BE PROVIDED TO THE CITY OF SAN RAFAEL.
- 6. A MINIMUM OF 50' OF DRAIN ROCK, 2" TO 3" DIAMETER OR LARGER, AT A MINIMUM DEPTH OF 8", SHALL BE INSTALLED AT EACH DRIVEWAY ENTRANCE TO THE SITE (DETAIL ON THIS SHEET). THIS DOES NOT NEED TO BE DONE AT DRIVEWAYS WHICH WILL BE CLOSED BY IMMOVABLE BARRICADES DURING CONSTRUCTION.
- 7. ALL EROSION CONTROL MEASURES SHALL BE MAINTAINED UNTIL DISTURBED AREAS ARE STABILIZED. CHANGES TO THIS EROSION CONTROL PLAN SHALL BE MADE TO MEET FIELD CONDITIONS ONLY WITH THE APPROVAL OF OR AT THE DIRECTION OF THE PROJECT QSD (QUALIFIED SWPPP DEVELOPER) AND/OR THE CITY ENGINEER.
- 8. ALL PAVED AREAS SHALL BE KEPT CLEAR OF EARTH MATERIALS AND DEBRIS. THE SITE SHALL BE MAINTAINED SO AS TO MINIMIZE SEDIMENT LADEN RUNOFF FROM ENTERING ANY STORM DRAINAGE SYSTEM.
- 9. THE EROSION CONTROL PLAN COVERS ONLY THE FIRST WINTER DURING WHICH CONSTRUCTION IS TO TAKE PLACE. PLANS ARE TO BE RESUBMITTED PRIOR TO SEPTEMBER 1ST OF EACH SUBSEQUENT YEAR UNTIL THE SITE IMPROVEMENTS ARE ACCEPTED BY THE CITY.
- 10. IT IS THE RESPONSIBILITY OF THE CONTRACTOR TO INSPECT AND REPAIR ALL EROSION CONTROL FACILITIES AT THE END OF EACH WORK DAY DURING THE RAINY
- 11. ADDITIONAL EROSION CONTROL MEASURES MAY BE REQUIRED DURING GRADING OPERATION, BEFORE OCTOBER 1 AND PRIOR TO INSTALLATION OF STORM DRAINAGE SYSTEM. SUCH ADDITIONAL MEASURES WILL BE CONTINGENT UPON THE STAGE OF GRADING OPERATIONS. THE CONTRACTOR SHALL IMPLEMENT ANY ADDITIONAL EROSION CONTROL MEASURES AS REQUIRED BY THE PROJECT STORM WATER POLLUTION PREVENTION PLAN AND AS REQUIRED BY THE STATE WATER BOARD, MARIN COUNTY STORMWATER POLLUTION PREVENTION PROGRAM, AND CITY OF SAN RAFAEL FOR CONSTRUCTION ACTIVITY.
- 12. ALL EROSION CONTROL DEVICES TO BE REMOVED AND DISPOSED OF OFF-SITE BY CONTRACTOR AFTER SITE IS FULLY STABILIZED BY LANDSCAPING OR THE INSTALLATION OF PERMANENT EROSION CONTROL MEASURES.
- 13. THE CONTRACTOR SHALL PERFORM FINAL CLEANUP OF THE JOB SITE TO THE SATISFACTION OF THE CITY OF SAN RAFAEL.

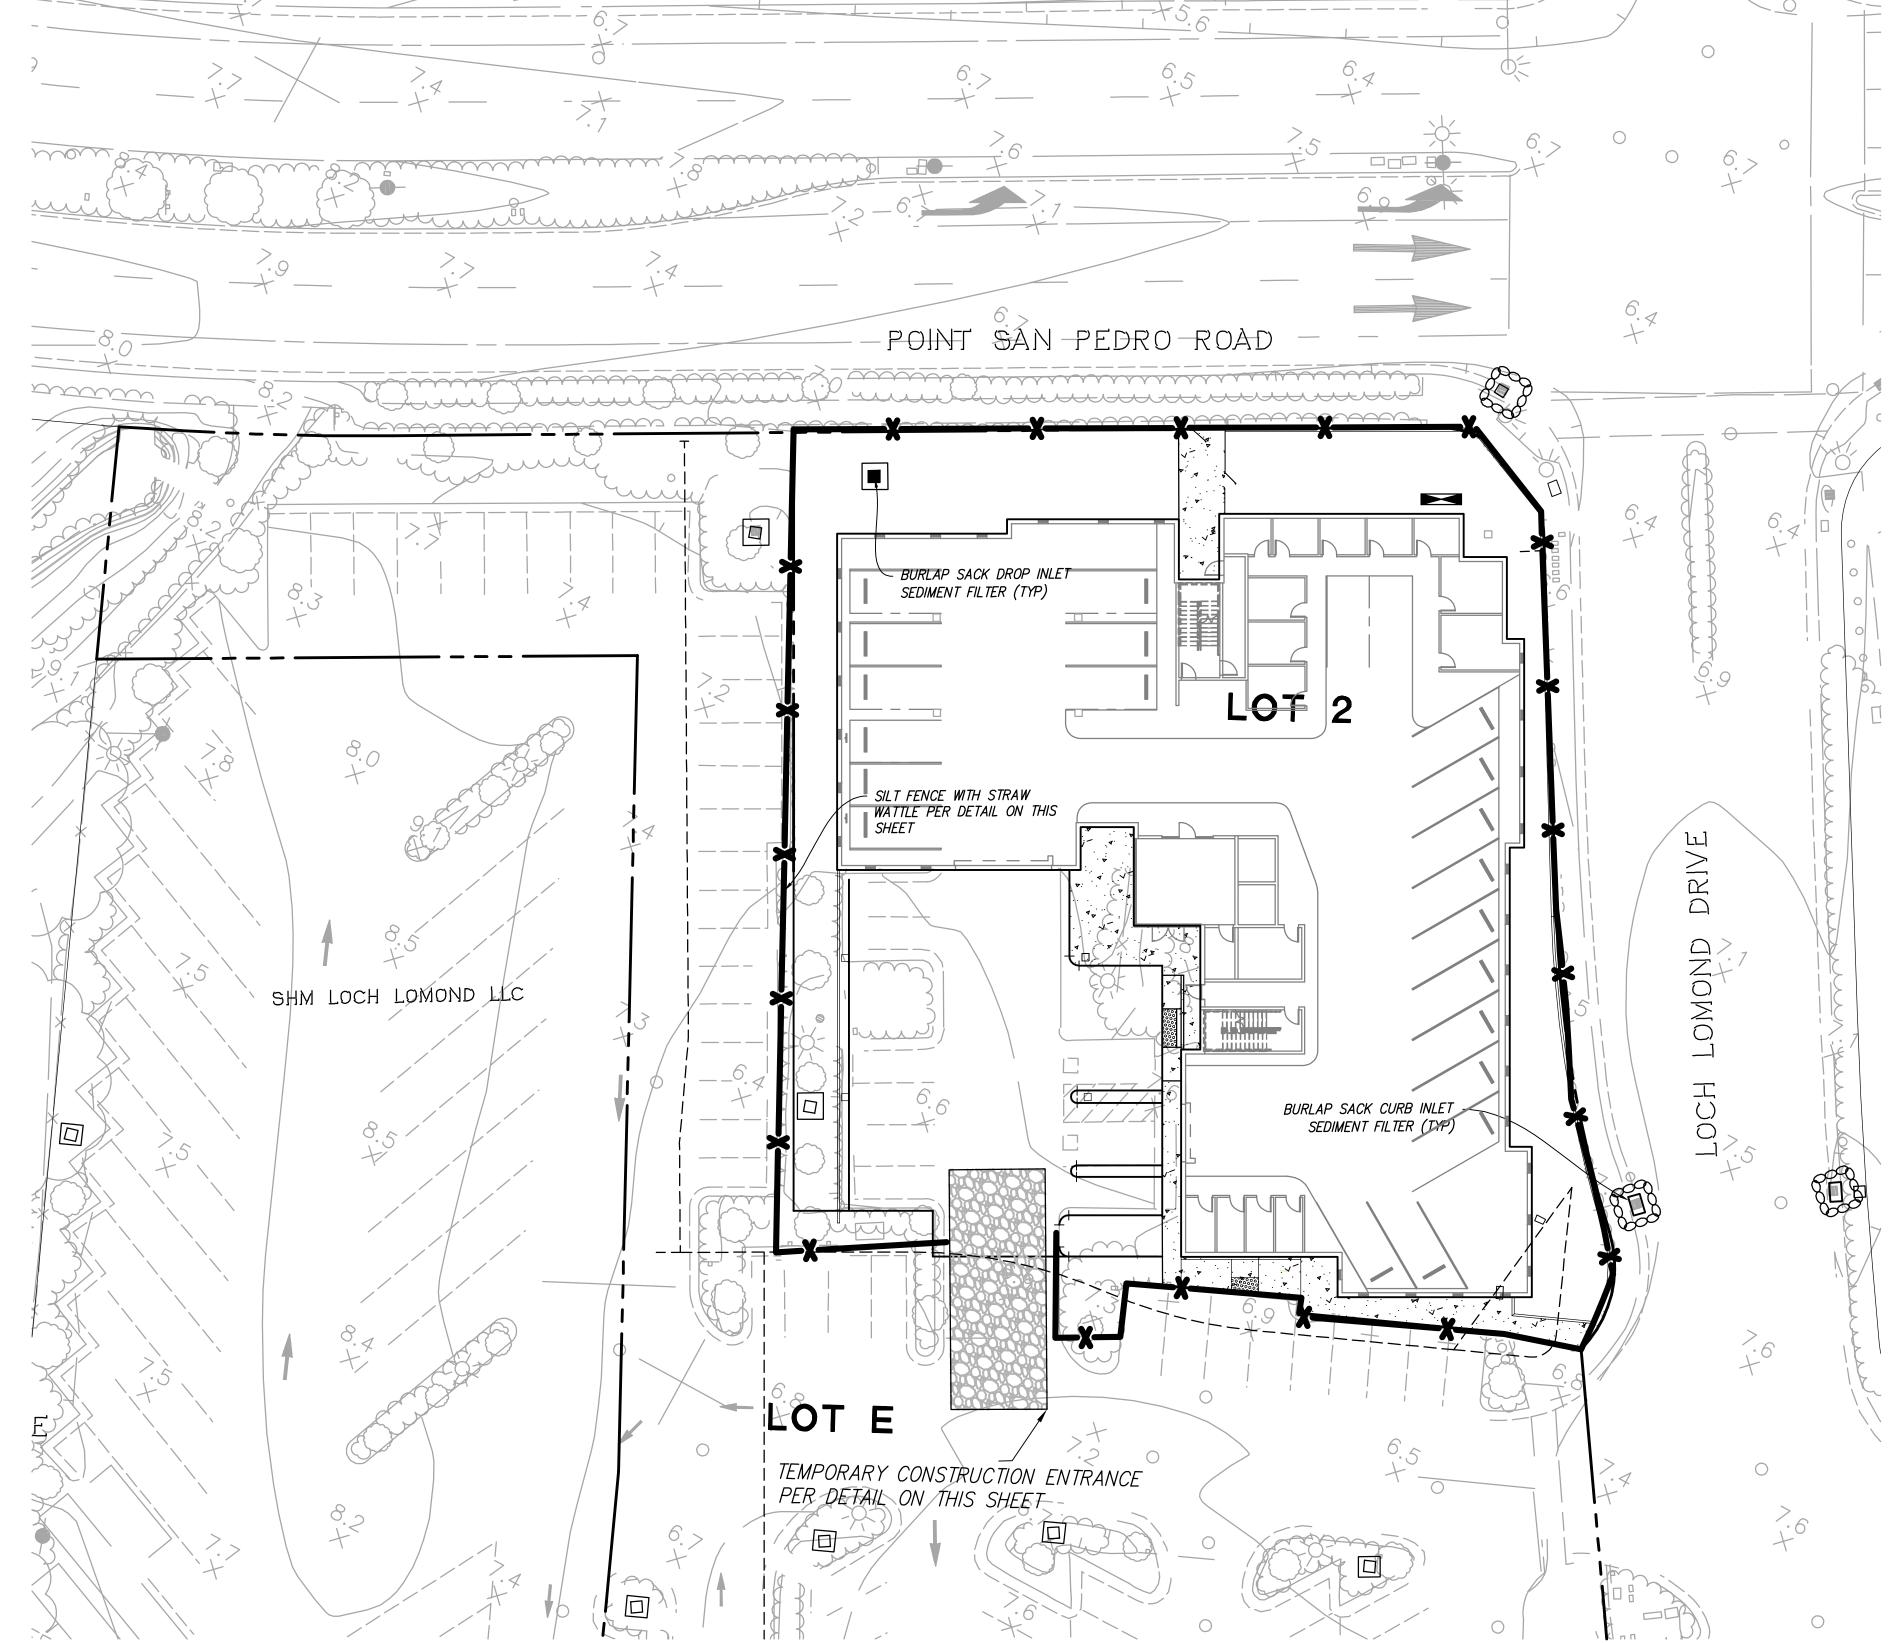

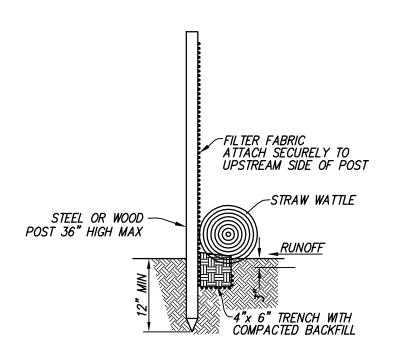

SILT FENCE WITH STRAW WATTLE DETAIL

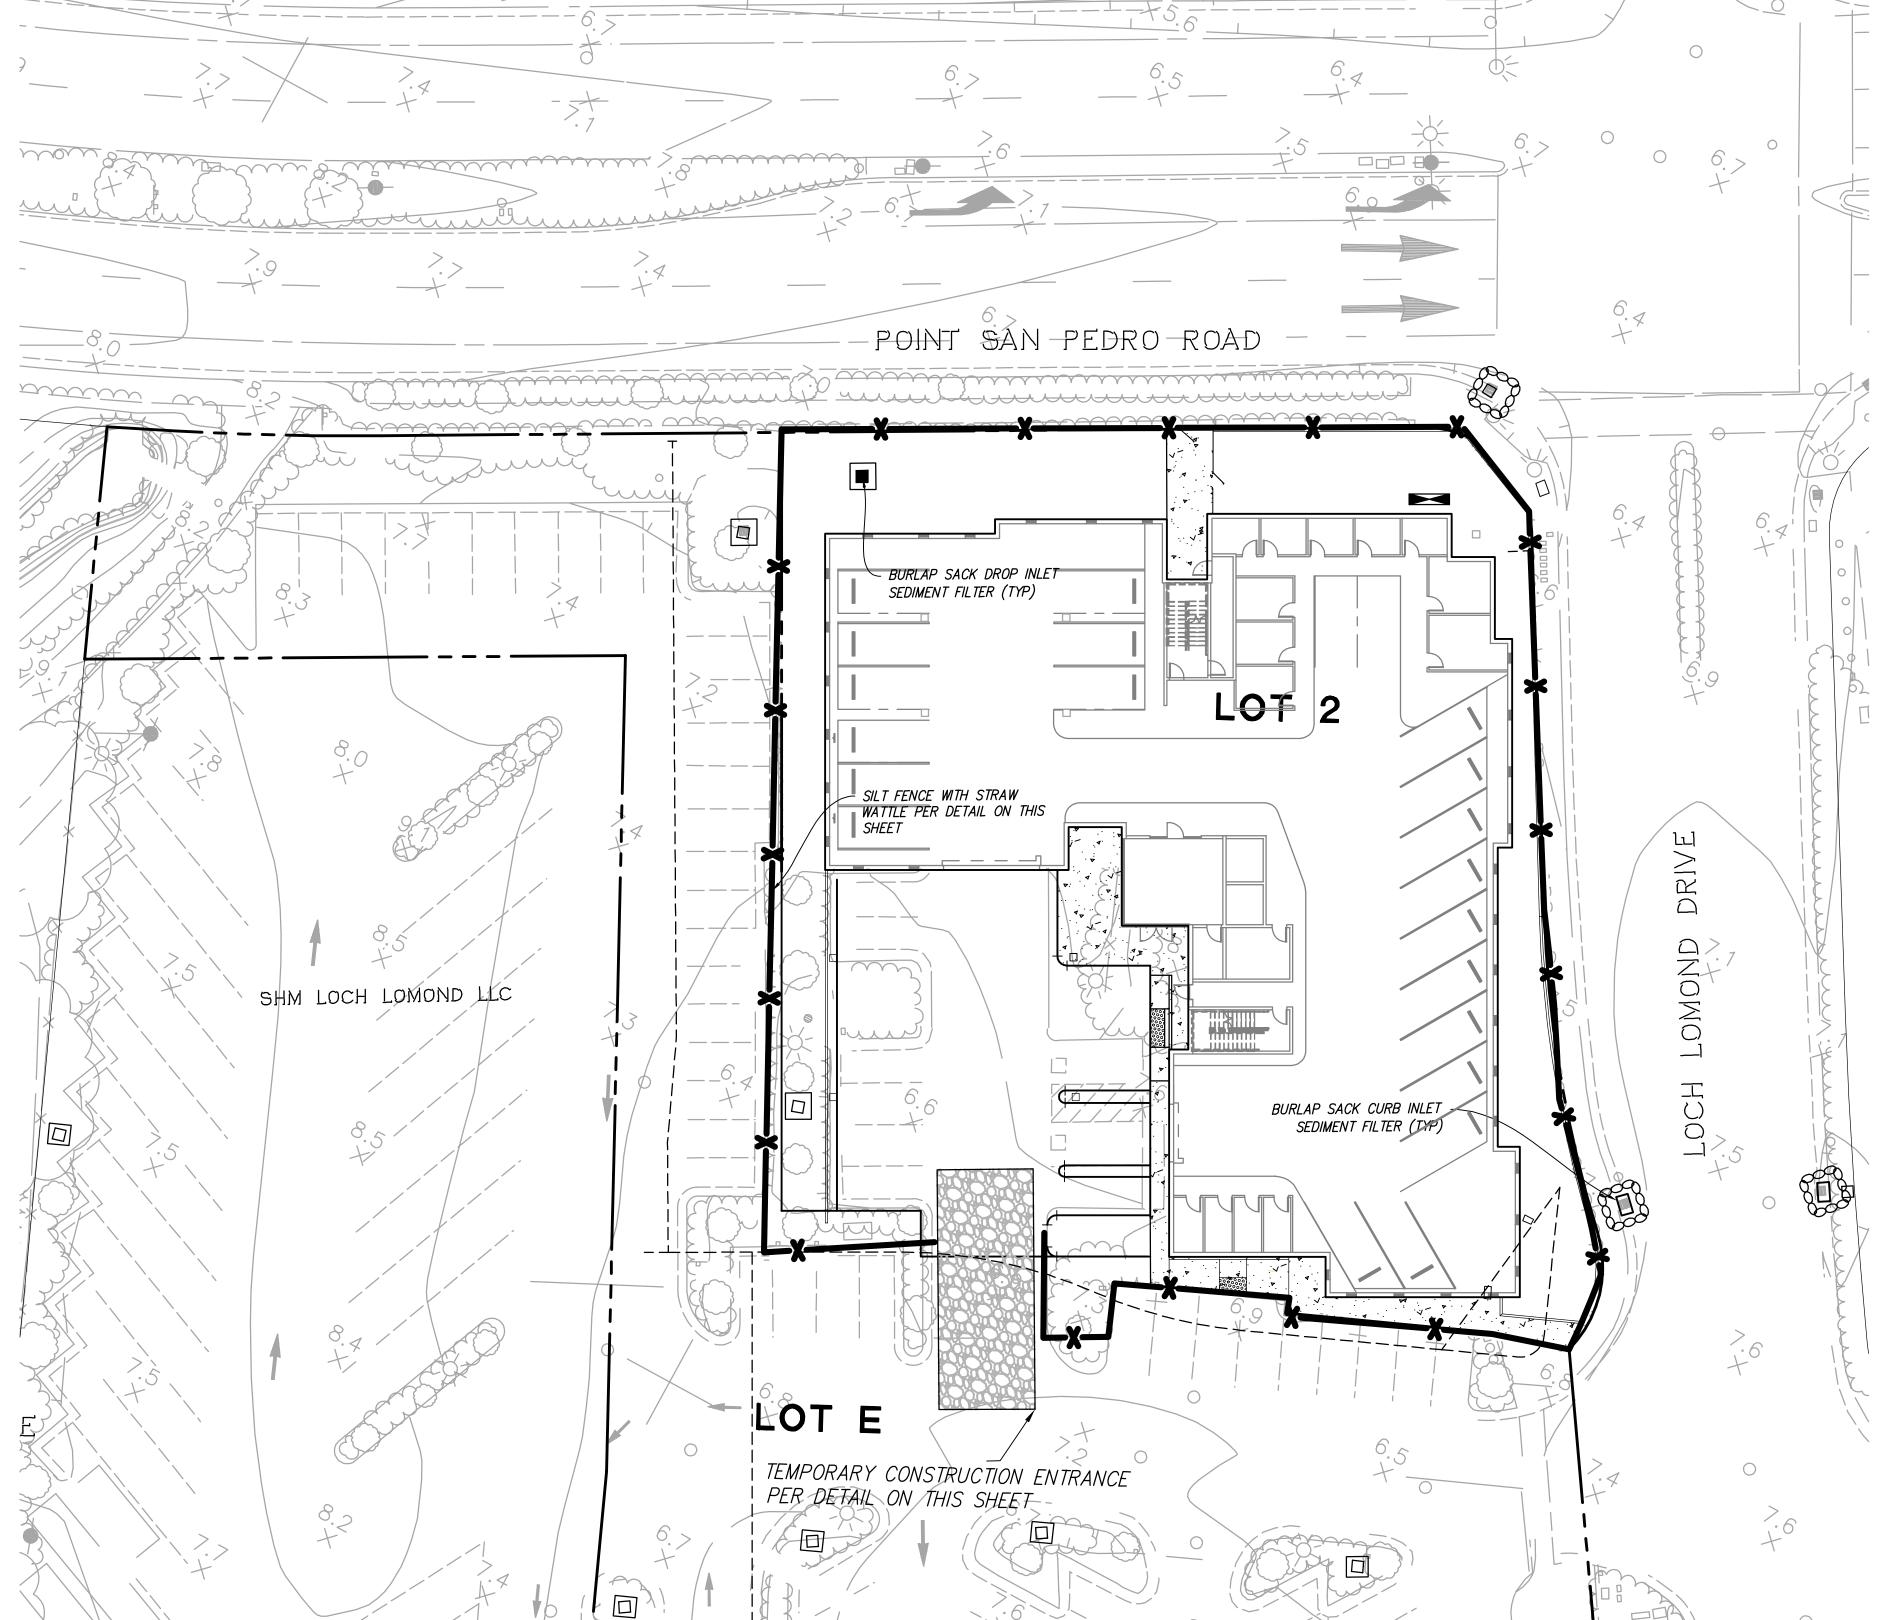

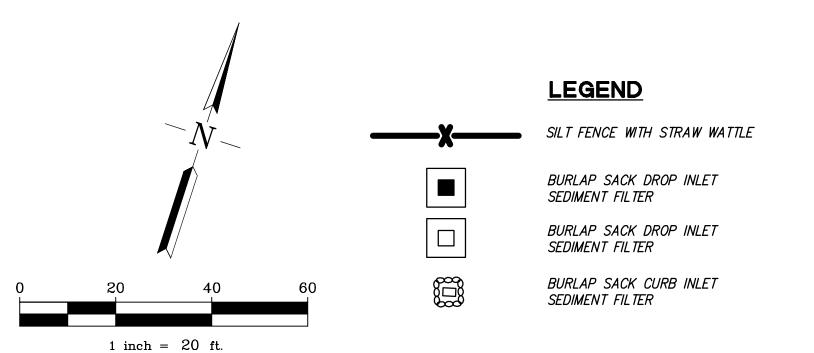

INSTALL SILT SACK — DROP INLET FILTER MATERIAL -BURLAP BAGS FILLED WITH GRADED ROCK

1. THICKNESS OF FILLED BAGS WHEN LAID FLAT SHALL NOT EXCEED 4".

2. ENSURE THERE ARE NO GAPS BETWEEN THE BAGS.

3. REMOVE ACCUMMULATED SILT, DIRT, AND DEBRIS BEFORE IT EXCEEDS 2" THICK AROUND THE INLET. 4. INSPECT INLET PROTECTION DAILY DURING EXTENDED RAINFALL PERIODS AND BEFORE AND AFTER EACH RAIN EVENT.

(NO FINES), NO SMALLER THAN 1/2" IN SIZE; SURROUND DROP INLET ALL SIDES TWO SACK

BURLAP SACK DROP INLET SEDIMENT FILTER DETAIL

STORM WATER INLET APPROVED EQUAL


1. THICKNESS OF FILLED BAGS WHEN LAID FLAT SHALL NOT


2. ENSURE THERE ARE NO GAPS BETWEEN THE BAGS OR BETWEEN THE BAGS AND THE FACE OF CURB. R. REMOVE ACCUMMULATED SILT, DIRT, AND DEBRIS BEFORE IT EXCEEDS 2" THICK IN THE GUTTER. 4. INSPECT INLET PROTECTION DAILY DURING EXTENDED RAINFALL PERIODS AND BEFORE AND AFTER EACH RAIN EVENT.

-BURLAP BAGS FILLED WITH GRADED ROCK (NO FINES), NO SMALLER THAN 1/2" IN SIZE; SURROUND STORM WATER INLET ALL THREE

BURLAP SACK CURB INLET SEDIMENT FILTER DETAIL

NOT TO SCALE

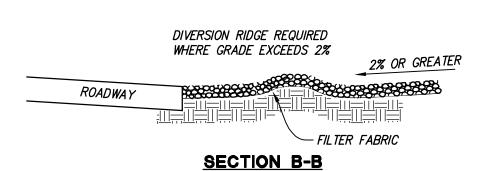

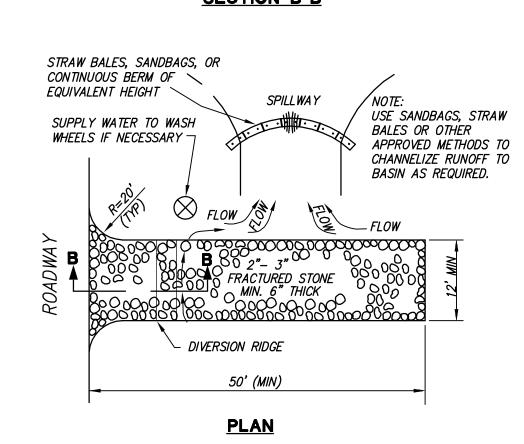

- 1. THE ENTRANCE SHALL BE MAINTAINED IN A CONDITION THAT WILL PREVENT TRACKING DRESSING, REPAIR AND/OR CLEANOUT OF ANY MEASURES USED TO TRAP SEDIMENT.
- 2. WHEN NECESSARY, WHEELS SHALL BE CLEANED PRIOR TO ENTRANCE ONTO PUBLIC RIGHT-OF-WAY.
- CRUSHED STONE THAT DRAINS INTO AN APPROVED SEDIMENT TRAP OR SEDIMENT

3. WHEN WASHING IS REQUIRED, IT SHALL BE DONE ON AN AREA STABILIZED WITH


TEMPORARY CONSTRUCTION ENTRANCE DETAIL

PRELIMINARY EROSION AND SEDIMENT CONTROL PLAN HARBOR FLATS

CITY OF SAN RAFAEL, MARIN COUNTY, CALIFORNIA FOR: TRUMARK HOMES



TM7.0

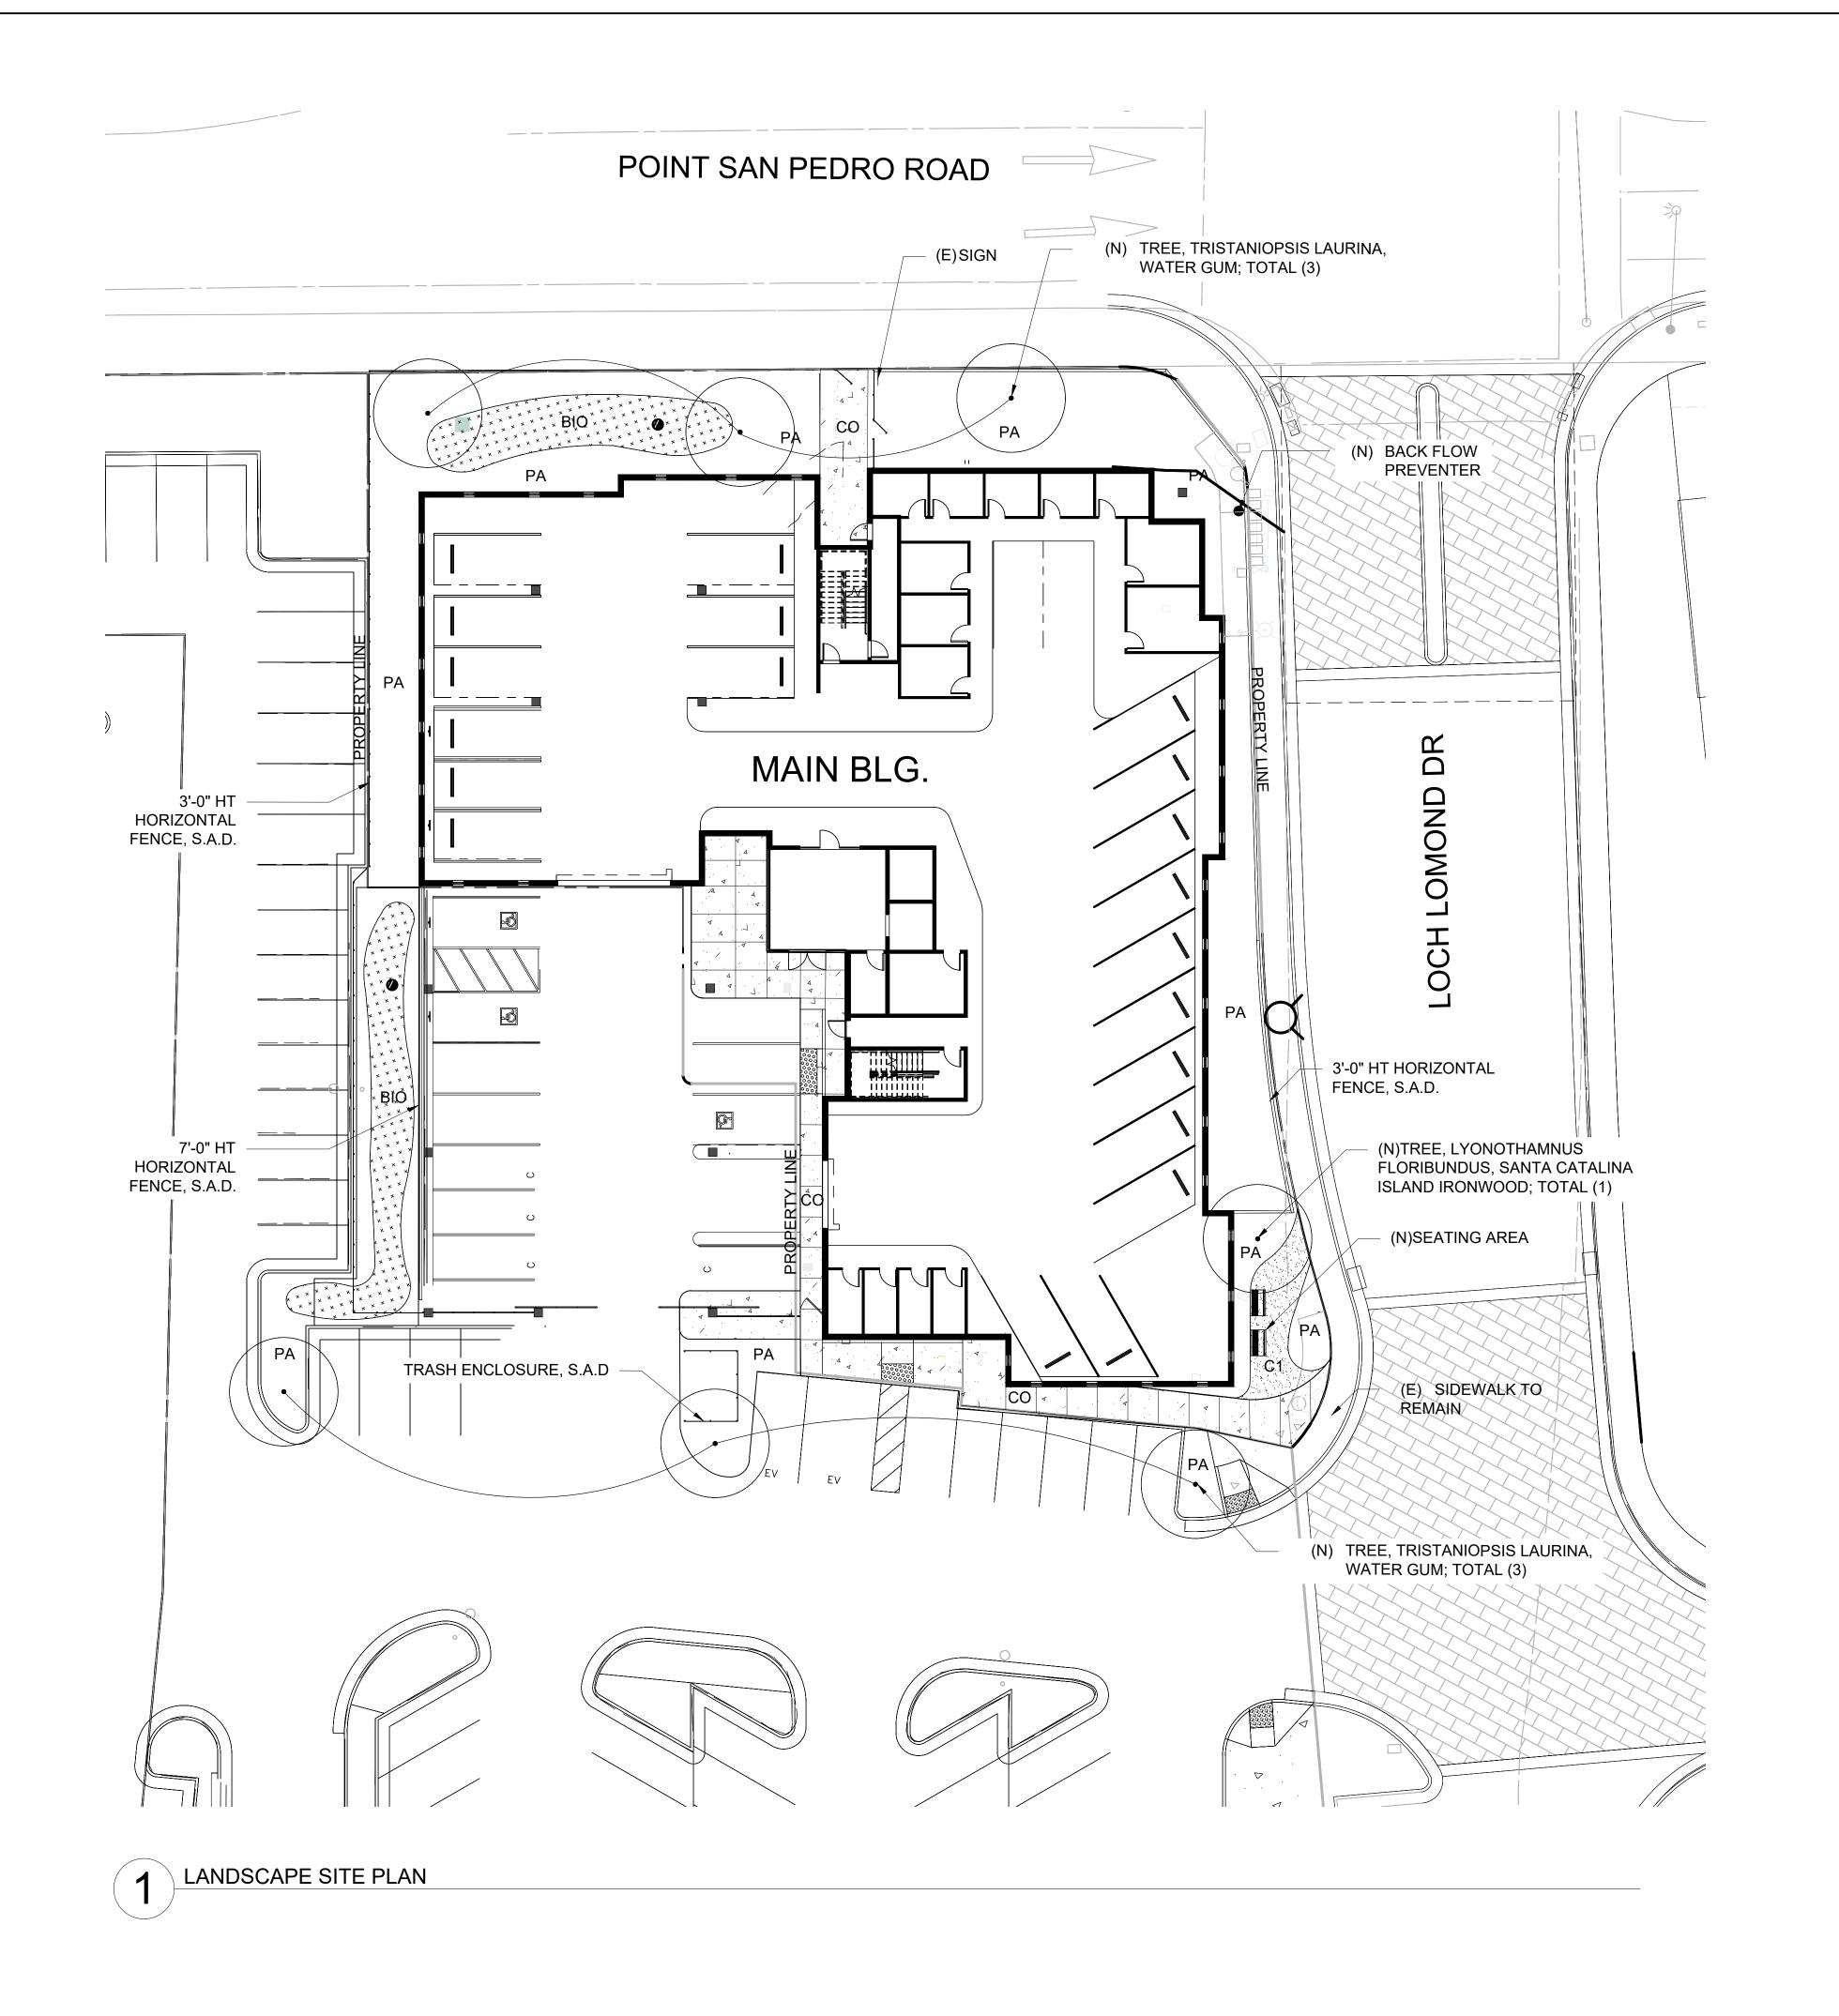


MATERIALS SCHEDULE

- CONCRETE
- C1 GRANITE CRETE, COLOR TBD
- PA PLANTING AREA
- BIO PLANTING AREA

TREES



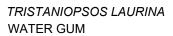



LYONOTHAMUNUS FLORIBUNDUS SANTA CATALINA ISLAND IRONWOOD

SHRUB PLANTING



DIETES BIOCOLOR FORTNIGHT LILY

LIMONIUM PEREZII SEA LAVENDER

MULENBERGIA DUBIA

SCALE: 1/16" = 1'-0"



COFFEEBERRY

YANKEE POINT CEANOTHUS


BIORETENTION PLANTING

CHONDROPETALUM TECTORUM CAPE RUSH



STUDIO GREE

Landscape Architecture 232 Sir Francis Drake Blvd. San Anselmo, CA 94960 Phone: (415) 721-0905 Fax: (415) 721-0910 web: studiogreen.com Email: info@studiogreen.com

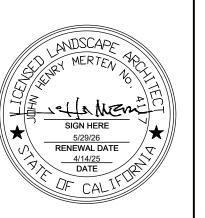

PROGRESS SET NOT FOR CONSTRUCTION

Issue: Date: 4/16/2025 PLANNING

LANDSCAPE SITE PLAN

> Drawn by: MH Checked by: JM

Project Narrative

Harbor Flats at Loch Lomond ("the Project") is a proposed new residential development to be located at 25 Loch Lomond Drive in San Rafael, CA ("the Property"). The Property is approximately .54 acres in size. The Project proposes fourteen (14) new residential units, 1 unit is proposed to be offered at the low-income affordability level. The Project reaches a maximum height of 35', with ground-level parking and two stories of residential units. Amenities for the residents include decks/patios and an open-air common area with a pavilion on the second floor. Andy's Market and a children's playground are located in close proximity.

The Project is a qualified housing development governed by:

- SB 330 (The Housing Crisis Act);
- State Density Bonus Law (Cal. Government Code § 65915; and
- Housing Accountability Act (Cal. Government Code § 65589.5.

I. General Plan and Zoning

The zoning for the Property is established by PD 1860, which governs the Loch Lomond Village project. Per the PD, the Property is already authorized for a mixed-use project with 5 residential units. However, the Property is designated as Neighborhood Commercial Mixed-Use (NC) in San Rafael's General Plan 2040, which has a higher density range of 8.7 – 24.2 units per net acre. Accordingly, there is a discrepancy between the density allowed by PD 1860 and that allowed by the Property's general plan land use designation.

The Project is a "housing development" as defined by Cal. Government Code § 65915(i) and, because the Project will provide 10% of its units as Below Market Rate units, it qualifies as a State Density Bonus project pursuant to Cal. Government Code § 65915 ("SDBL"). Government Code § 65915(o)(6) defines "maximum allowable residential density" or "base density" in relevant part as:

"the **greatest number of units allowed** under the zoning ordinance, specific plan, or land use element of the general plan, or, if a range of density is permitted, means the greatest number of units allowed by the specific zoning range, specific plan, or land use element of the general plan applicable to the project." (Emphasis added.)

Therefore, pursuant to the above definition, the maximum allowable residential density is the greatest number of units allowed per the governing land use controls, including if there is a range of density set forth in the land use element in General Plan. Therefore, the density for the Property is 24.2 units per acre and the allowable base density for the Project is 13 units. There is no need to amend the Property's PD to allow for the greater density of the General Plan because the greater density is allowed by the SDBL. Furthermore, as will be discussed below, there is no need to amend the Property's PD to allow a 100% residential project because that use requirement can be waived via a concession.

II. State Density Bonus Law

As a SDBL project that will provide 10% of its units at the Low-Income level, the Project is eligible for a 20% density bonus of two units, however, the Project is designed to only utilize one density bonus unit, for a total of 14 units. The Project has been designed to meet the development standards of PD-1860, however, the Project is entitled to one incentive or concession and unlimited waivers of development standards that would preclude its development at the permitted density.

Government Code § 65915(o)(2) defines "Development standard" as:

"a site or construction condition, including, but not limited to, a height limitation, a setback requirement, a floor area ratio, an onsite open-space requirement, a minimum lot area per unit requirement, or a parking ratio that applies to a residential development pursuant to any ordinance, general plan element, specific plan, charter, or other local condition, law, policy, resolution, or regulation that is adopted by the local government or that is enacted by the local government's electorate exercising its local initiative or referendum power, whether that power is derived from the California Constitution, statute, or the charter or ordinances of the local government."

California case law has established that waivers must be granted for development projects as designed if the project satisfies the criteria of the SDBL. (See Wollmer v. City of Berkeley (2011) 193 Cal. App. 4th 1329; Bankers Hill 150 v. City of San Diego (2022) 74 Cal. App. 5th 755). The SDBL establishes that granting appropriate development standard waivers is mandatory, "In no case may a city, county, or city and county apply any development standard that will have the effect of physically precluding the construction of a development meeting the criteria of subdivision (b) at the densities or with the concessions or incentives permitted by this section." (Cal. Gov't Code §65915(e)(1).) Additionally, the local agency can only deny a waiver if the waiver or reduction shall have a specific adverse impact upon health or safety and for which there is no feasible method to satisfactorily mitigate or avoid the impact; would have an adverse impact on any real property that is listed in the California Register of Historical Resources; or the waiver or reduction would be contrary to state or federal law. (Id.)

The Project is requesting one incentive/concession (hereinafter referred to collectively as "concession") under Government Code Section 65915(d) to waive the mixed-use requirement and provide residential units only. A concession is defined at Section 65915(k) as:

- A reduction in site development standards or a modification of zoning code or architectural design requirements, such as a reduction in setback or minimum square footage requirements; or
- Approval of mixed-use zoning; or
- Other regulatory incentives or concessions which actually result in identifiable and actual cost reductions.

Any requested concession must be approved by the local agency unless it makes a written finding, based upon substantial evidence, that: A. The concession or incentive does not result in "identifiable and actual cost reductions" to provide for affordable housing; B. The concession or incentive would have a specific, adverse impact on public health, safety or on any property listed in the California Register of Historical Resources; and C. The concession or incentive would be contrary to state or federal law. (Cal. Gov't Code §65915(d)(1)(A)-(C).) An applicant seeking a concession pursuant to the SDBL "is not required to establish that cost reductions will result. Instead, '[t]he city . . . shall bear the burden of proof for the denial of a requested concession or incentive.' (Cal. Government Code § 65915(d)(4)." (Schreiber v. City of Los Angeles (2021) 69 Cal.App.5th 549, 555). Demand and rents for commercial space are objectively near all-time lows. Furthermore, the requested reduction in square footage requirements is specifically identified as an example of a concession in the statute. Finally, the findings necessary for denial of the requested concession cannot be made.

In sum, an amendment to the PD is not necessary for the Project because both the increased density and the concession concerning the requirement to provide commercial space are allowed pursuant to the State Density Bonus Law.

III. Affordable Housing

The Project will provide 10% of its units at the Low-Income Affordability level. This complies with San Rafael's Affordable Housing requirement set forth in Resolution 14890. For projects that provide 2-15 units only, the project only needs to comply with the primary requirement of providing 10% of the units at BMR levels. This results in a requirement for 1.3 BMR units. If the number of units required results in a fraction below .5, the developer can pay the pro-rated in lieu fee. Accordingly, the Project will provide 1 BMR unit and pay the pro-rated fee.

IV. <u>SB 330</u>

The Project applicant submitted a complete Preliminary Application pursuant to SB 330 on September 10, 2024. The primary effect of submitting the Preliminary Application is that the Project is only subject to San Rafael's ordinances, policies, standards, and fees in place as of that date.

SB 330 also prevents jurisdictions from conducting more than 5 public hearings in connection with the approval of a housing development project that is in compliance with the applicable objective general plan and zoning standards in effect at the time an application is deemed complete. The five hearings¹, which do not include hearings related to CEQA law, are counted from the deemed-complete date of the development application.

V. Housing Accountability Act

The Housing Accountability Act significantly restricts a local agency's ability to deny housing projects that are consistent with objective standards. Furthermore, "the receipt of a density bonus, incentive, concession, waiver, or reduction of development standards," pursuant to the State Density Bonus Law, "shall not constitute a valid basis on which to find a proposed housing development project is inconsistent, not in compliance, or not in conformity, with an applicable plan, program, policy, ordinance, standard, requirement."

A proposed housing development project is not inconsistent with the applicable zoning standards and criteria and shall not require a rezoning (or amendment) if the housing development project is consistent with the objective general plan standards and criteria, but the zoning for the project site is inconsistent with the general plan.

Once it is established that a project complies with applicable objective standards, a city's discretion to disapprove or reduce the density of the project is very limited. Government Code section 65589.5(j)(1) establishes that a development project that complies with objective standards can

[&]quot;Hearing" includes any public hearing, workshop, or similar meeting, including any appeal, conducted by the city or county with respect to the housing development project, including any meeting relating to Section 65915, whether by the legislative body of the city or county, the planning agency established pursuant to Section 65100, or any other agency, department, board, commission, or any other designated hearing officer or body of the city or county, or any committee or subcommittee thereof. "Hearing" does not include a hearing to review a legislative approval, including any appeal, required for a proposed housing development project, including, but not limited to, a general plan amendment, a specific plan adoption or amendment, or a zoning amendment, or any hearing arising from a timely appeal of the approval or disapproval of a legislative approval. (Cal. Gov't Code 65905.5(b)(2).

only be disapproved, or approved at a lower density, based upon written findings supported by a preponderance of the evidence on the record that both of the below conditions exist:

- "(A) The housing development project would have a specific adverse impact upon the public health or safety unless the project is disapproved or approved upon the condition that the project be developed at a lower density. As used in this paragraph, a "specific, adverse impact" means a significant, quantifiable, direct, and unavoidable impact, based on objective, identified written public health or safety standards, policies, or conditions as they existed on the date the application was deemed complete.
- (B) There is no feasible method to satisfactorily mitigate or avoid the adverse impact identified . . . other than the disapproval of the housing development project or the approval of the project upon the condition that it be developed at a lower density."

Pursuant to section 65589.5(a)(3), it is the intent of the Legislature that the conditions that would have a specific, adverse impact "arise infrequently." Accordingly, other than determining noncompliance with applicable objective standards, this is the only manner in which the Project could be denied or reduced by the local agency.

VI. Entitlements Requested

The Project will seek a Major Environmental and Design Review permit, which findings are set forth at 14.25.090.

- A. That the project design is in accord with the general plan, the objectives of the zoning ordinance and the purposes of this chapter;
- B. That the project design is consistent with all applicable site, architecture and landscaping design criteria and guidelines for the district in which the site is located;
- C. That the project design minimizes adverse environmental impacts; and
- D. That the project design will not be detrimental to the public health, safety or welfare, nor materially injurious to properties or improvements in the vicinity.

The Project's design complies with many key plans and policies of the San Rafael General Plan 2040 as provided below:

Policy LU-3.3: Housing Mix

Encourage a diverse mix of housing choices in terms of affordability, unit type, and size, including opportunities for both renters and owners.

Policy CDP-4.5: Higher Density Design

Encourage high-quality architecture and landscape design in new higher-density housing and mixed use projects. Such projects should be designed to be compatible with nearby buildings and respect the character-defining features of the surrounding neighborhood or district.

Policy CDP- 4.6: Open Space in Multi-Family Housing

Require private outdoor areas such as decks and patios, as well as common space areas, in new multi-family development and mixed use housing. Common open space may include recreation facilities, gathering places, and site amenities such as picnic and play areas.

Policy H-4.3: Affordable Housing Requirements

Require the inclusion of affordable housing units in market-rate housing projects. Ensure that affordable housing requirements are economically viable, do not negatively affect overall housing production, and provide sufficient flexibility for the private sector. When new affordable units are created, pursue deed restriction and affordability terms of at least 55 years so that fewer tenants are at risk of being displaced in any given year.

Policy H-4.14: Commercial to Residential Conversion

Encourage the adaptive reuse of older commercial buildings, including office and retail buildings, for housing.