

T1.1-Sheet Index			
Sheet #	Sheet Description	Page	
T1.1	TITLE SHEET	1	
A1.1	SITE PLAN	2	
A1.2	POLE ELEVATIONS / PHOTO SIMS, PROPOSED	3	
A1.3	PHOTO SIMULATIONS	4	
D1.1	CONSTRUCTION DETAILS	5	
D1.2	ELECTRICAL DETAILS	6	
D1.3	EQUIPMENT SPECIFICATIONS	7	
D1.4	PGE EQUIPMENT SHUT-DOWN PROCEDURE	8	



CROWN CASTLE 695 RIVER OAKS PARKWAY SAN JOSE,

RECORD DRAWINGS ISSUE DATE: 02.26.

Shift Companies, LLC PHOENIX, ARIZONA 8501 ph: 480.264.0829 fax: 480.264.0163

IT IS FORBIDDEN WITHOUT THE WRITTEN

I .	FENIVIIOSION O	FINE OWNER.
	RELEASE	
	DATE	SUBMITTAL
	02.26.19	1ST SUBMITTAL
	03.19.19	2ND SUBMITTAL
	11.14.19	RESUBMITTAL

RE	REVISIONS				
NO.	DATE	COMMENT			

PROJECT NAME

NODE LOCATION MAP

SAN FRANCISCO BAY EXPANSION -58 SITES

NODE NUMBER

SFB004m1

NODE ADDRESS

ACROSS 304 MISSION AVE SAN RAFAEL, CA

HUB AREA

SF40XC103

SHIFT JOB NUMBER

DRAWN BY: RA 150601

IN HOUSE

CHECKED BY: CM SHEET TITLE

TITLE SHEET

SHEET NUMBER

1 OF 8

PLOT SCALE: 1:1 @ 24"x36"; 1:2 @ 11"x17"

PAGE

PROJECT NAME: SAN FRANCISCO BAY EXPANSION - 58 SITES ACROSS 304 MISSION AVE, SAN RAFAEL, CA PROJECT ADDRESS:

PROJECT TYPE: EXIST. WOOD JPA POLE

CUSTOMER NODE ID #: SF90XS3T5 CROWN NODE ID #: SFB004m1 **HUB NAME:** SF40XC103

COORDINATES: LAT: 37.972172 LONG: -122.515749

CROWN CASTLE BILLING / SCU #: 479641

PROJECT TEAM

ARCHITECT OWNER INFO Company: CROWN CASTLE Company: SHIFT CONSULTING Address: 3334 N. 20TH ST. Address: 695 RIVER OAKS PARKWAY PHOENIX, AZ 85016 SAN JOSE, CA 95134

Phone Number: 480.264.0829 Phone Number: 707.756.2030 Fax Number: 480.264.0163 Fax Number: CHRIS MYERS Contact: JOHN GRIFFITHS Contact:

STRUCTURAL

RF ENGINEER Company: CROWN CASTLE Company: STRUKTUR STUDIO, LLC Address: 1525 N. GRANITE REEF RD., STE. 9 Address: 695 RIVER OAKS PARKWAY SCOTTSDALE, AZ 85257 SAN JOSE, CA 95134

Phone Number: 480.425.2250 Fax Number: 480.425.2225 Contact: DAVID LUNENG

Phone Number: 408.468.5546 Fax Number: ERNESTO FIGUEROA Contact:

PROJECT SUMMARY JURISDICTION: APPLICANT: SAN RAFAEL PUBLIC WORKS **CROWN CASTLE 695 RIVER** OAKS PARKWAY SAN 111 MORPHEW ST. SAN RAFAEL, CA 94901 JOSE, CA 95134 PHONE: 415.485.3355

HANDICAPPED REQUIREMENTS: -FACILITY IS UNMANNED AND NOT FOR HUMAN HABITATION.

GENERAL ORDER (GO) 95, RULE 94 2012 INTERNATIONAL BUILDING CODE (IBC) -HANDICAPPED ACCESS 2014 NATIONAL ELECTRICAL CODE (NEC)

REQUIREMENTS ARE NOT REQUIRED. PLUMBING REQUIREMENTS:

FACILITY HAS NO PLUMBING

POWER COMPANY: PACIFIC GAS AND ELECTRIC (PG&E)


PROJECT DESCRIPTION


THIS PROJECT WILL CONSIST OF ADDING A NEW WOOD POLE-TOP EXTENSION AND CANISTER ANTENNA TO THE TOP OF THE POLE. A SIDE-MOUNTED EQUIPMENT CHASSIS WILL ALSO BE INSTALLED TO THE EXISTING POLE. THE EQUIPMENT CHASSIS WILL CONTAIN THE FOLLOWING:

(1) NEW RADIO UNIT (1) FIBER ENCLOSURE BOX

(1) ELECTRICAL LOAD CENTER / DISTRIBUTION PANEL


(1) ELECTRICAL POWER METER

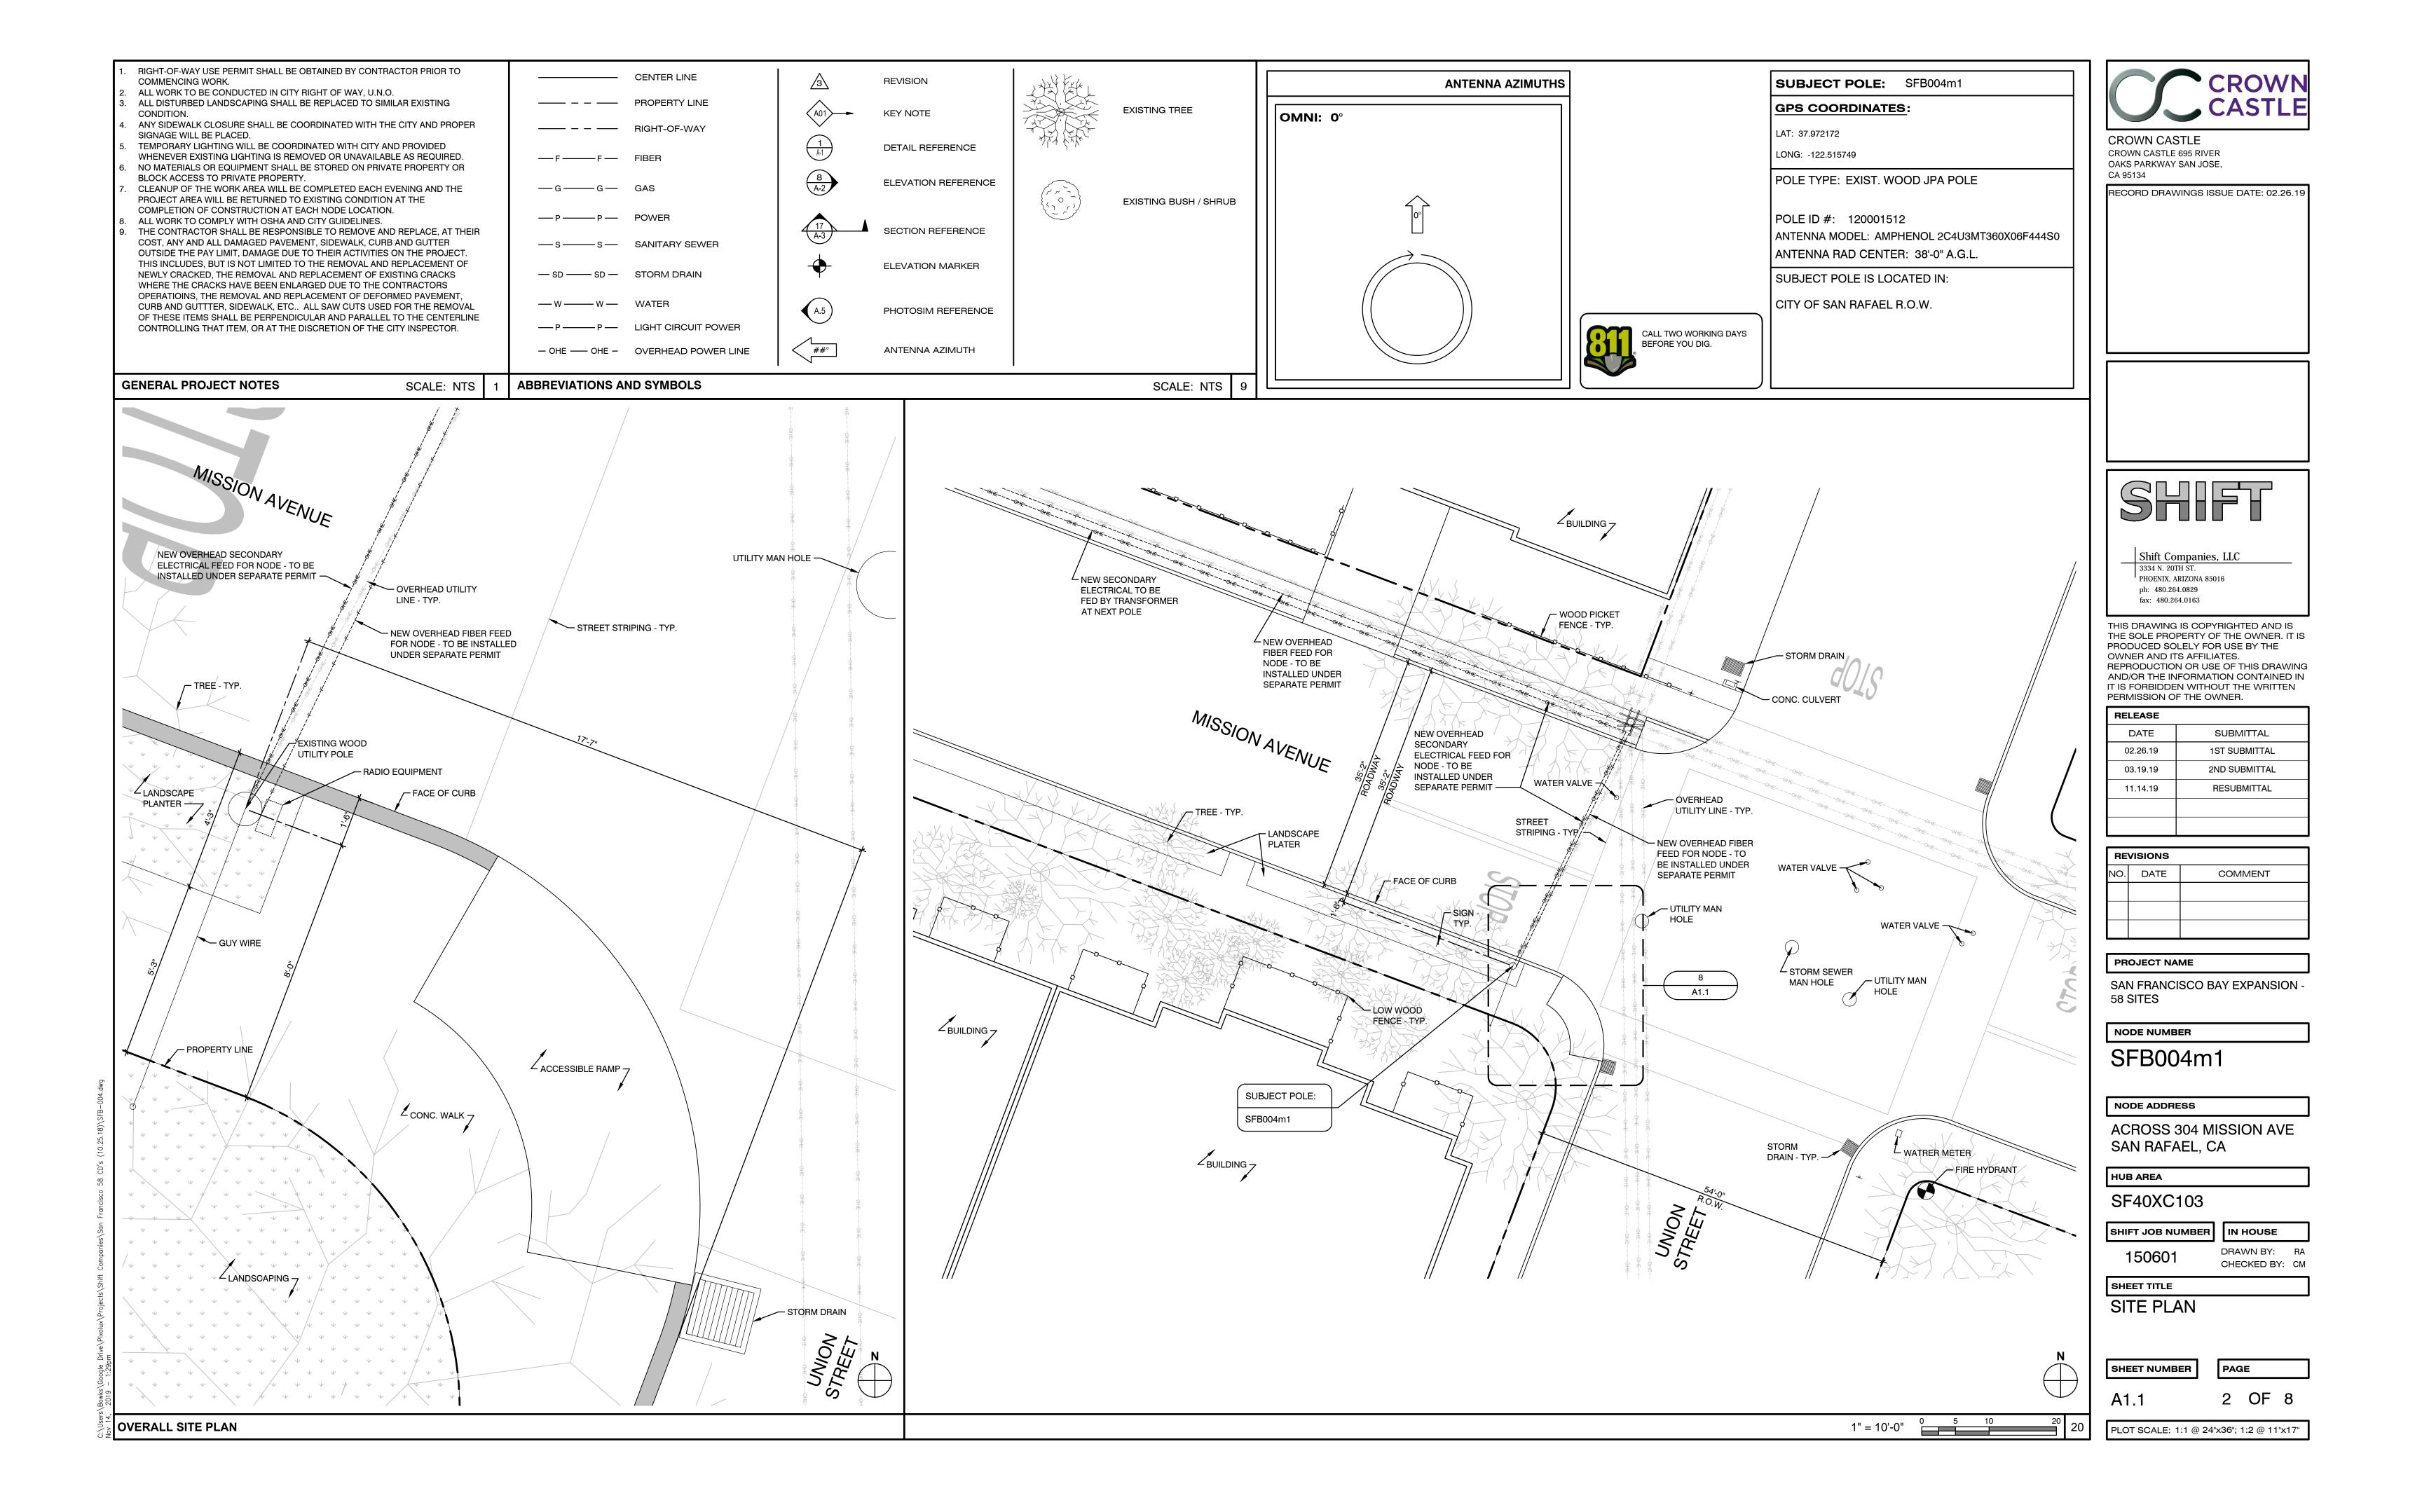

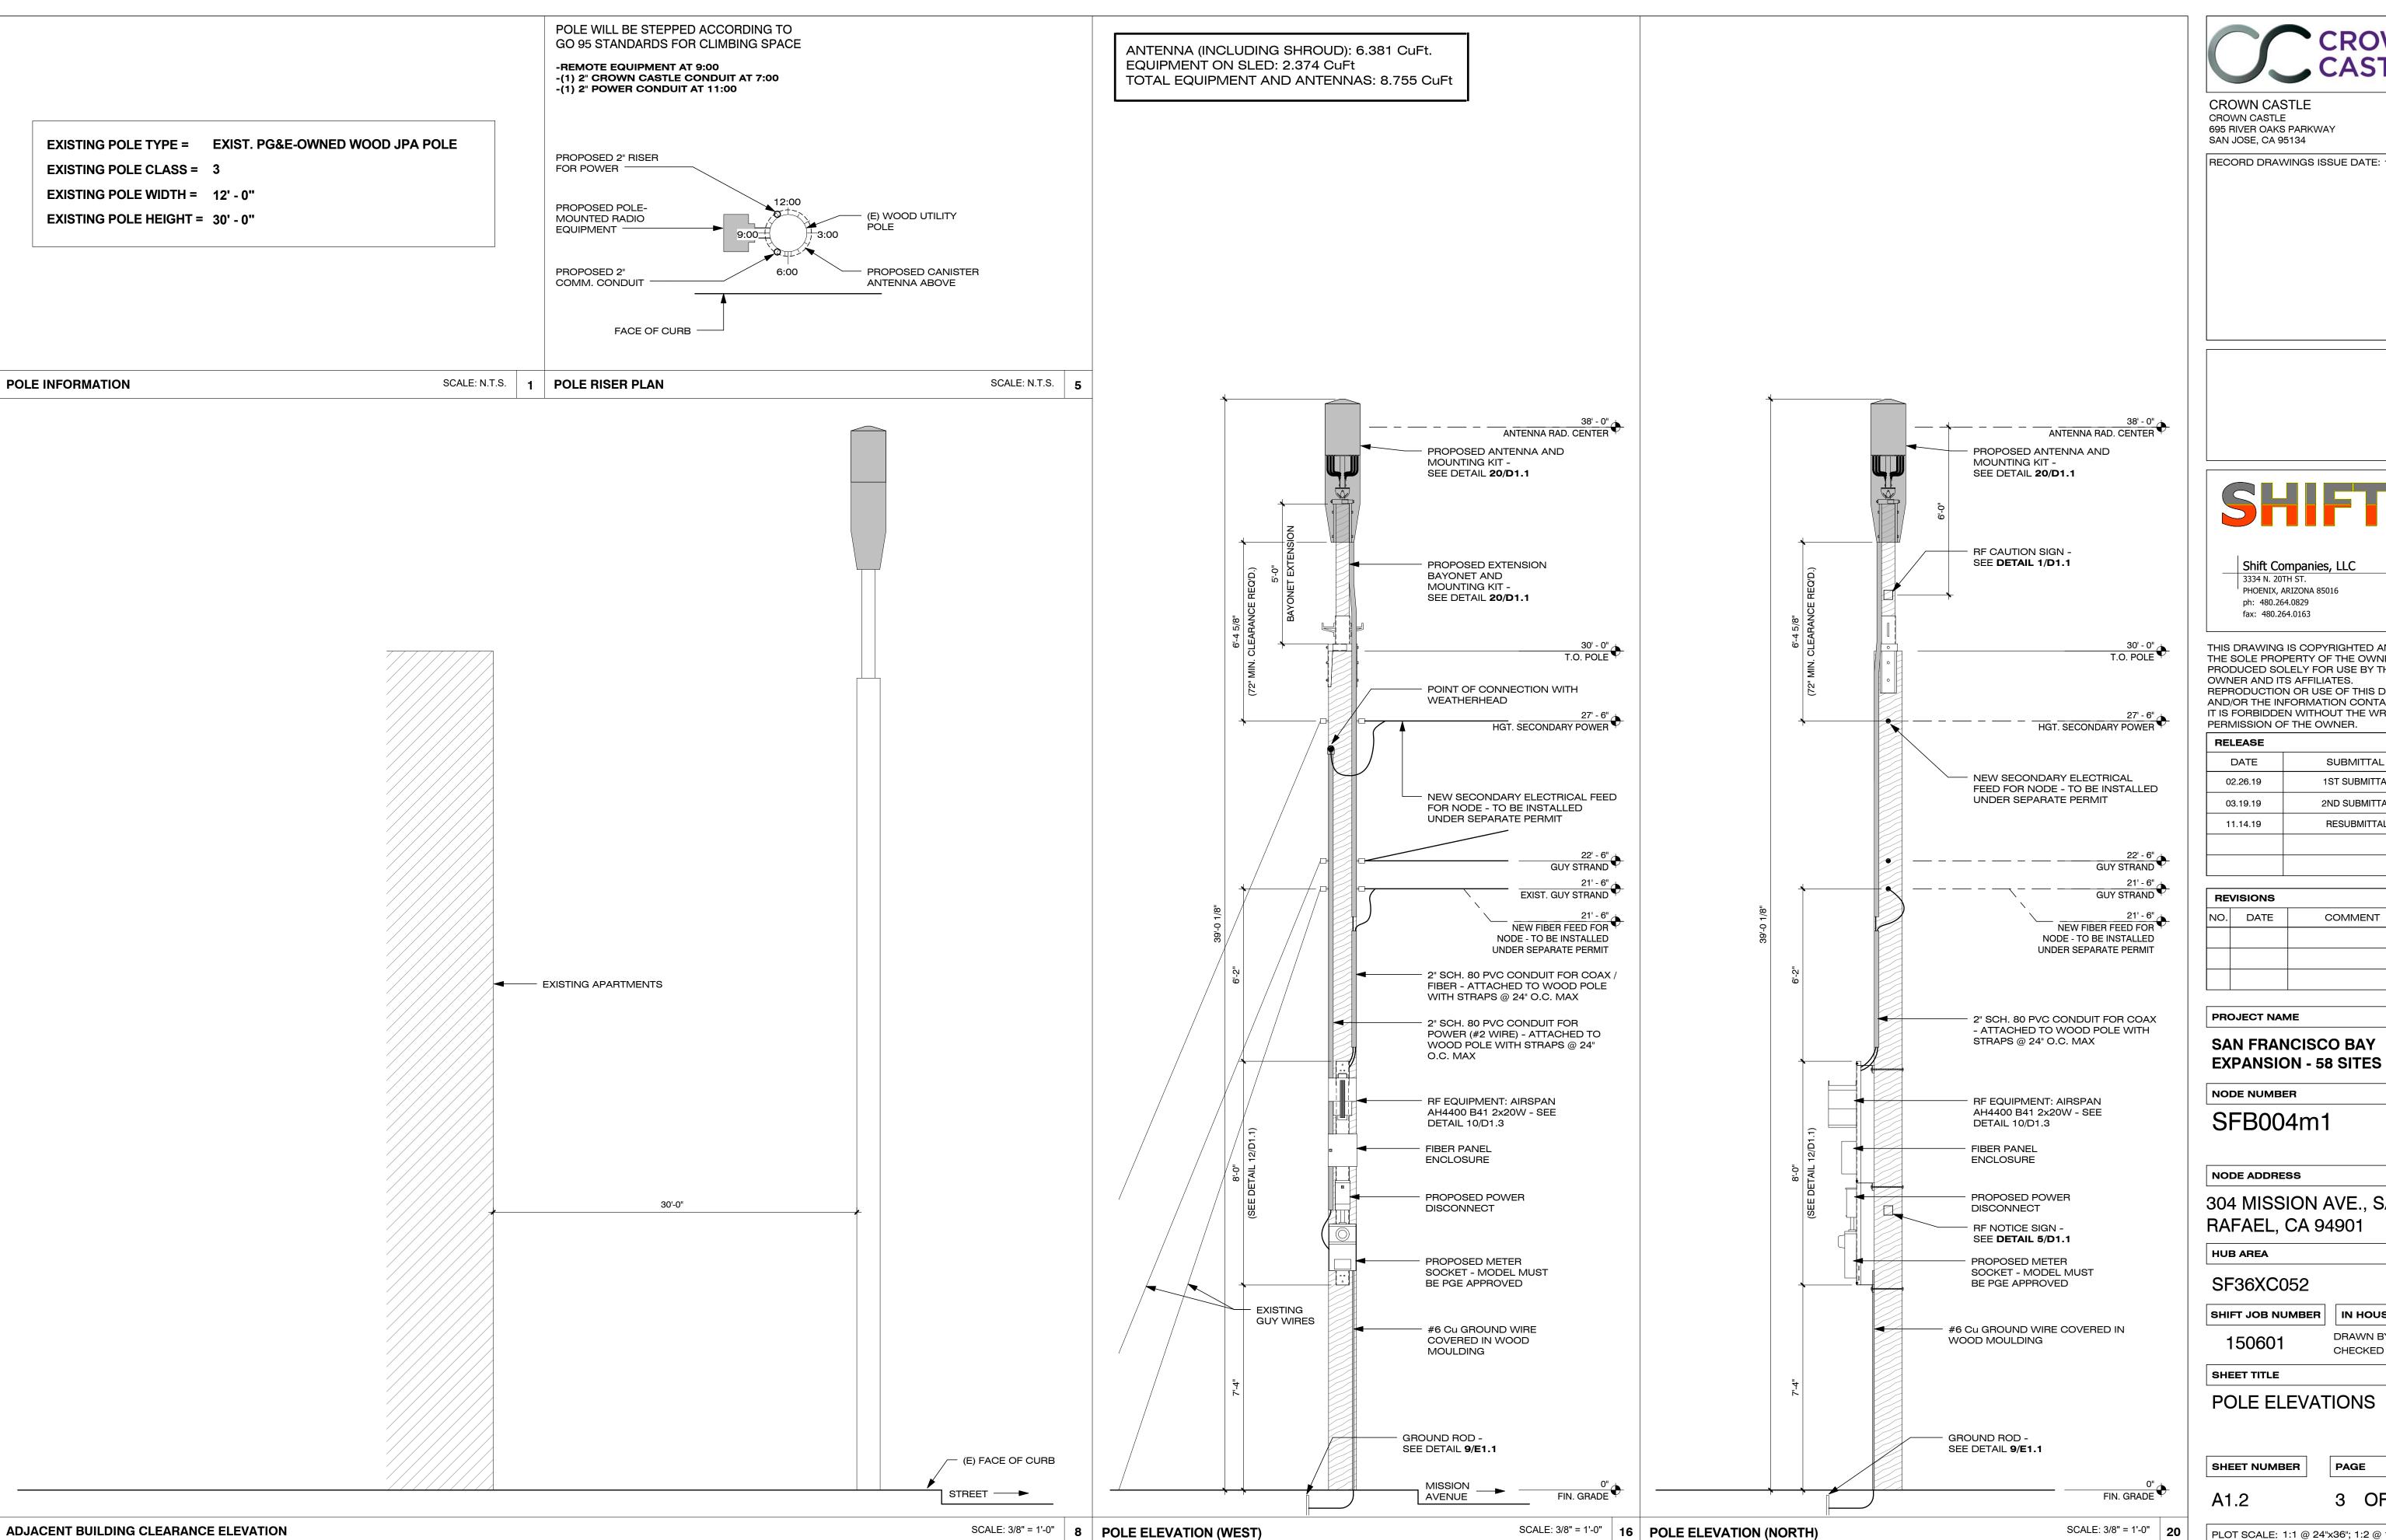



RECORD DRAWINGS ISSUE DATE: 11.14.19

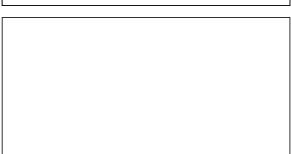




THIS DRAWING IS COPYRIGHTED AND IS THE SOLE PROPERTY OF THE OWNER. IT IS PRODUCED SOLELY FOR USE BY THE REPRODUCTION OR USE OF THIS DRAWING AND/OR THE INFORMATION CONTAINED IN IT IS FORBIDDEN WITHOUT THE WRITTEN PERMISSION OF THE OWNER.

PERIVISSION O	PERIVISSION OF THE OWNER.		
RELEASE			
DATE	SUBMITTAL		
02.26.19	1ST SUBMITTAL		
03.19.19	2ND SUBMITTAL		
11.14.19	RESUBMITTAL		

RE	VISIONS	
NO.	DATE	COMMENT

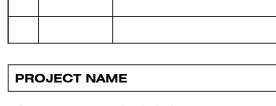



304 MISSION AVE., SAN


IN HOUSE DRAWN BY: MB CHECKED BY: RA

3 OF 8

PLOT SCALE: 1:1 @ 24"x36"; 1:2 @ 11"x17"

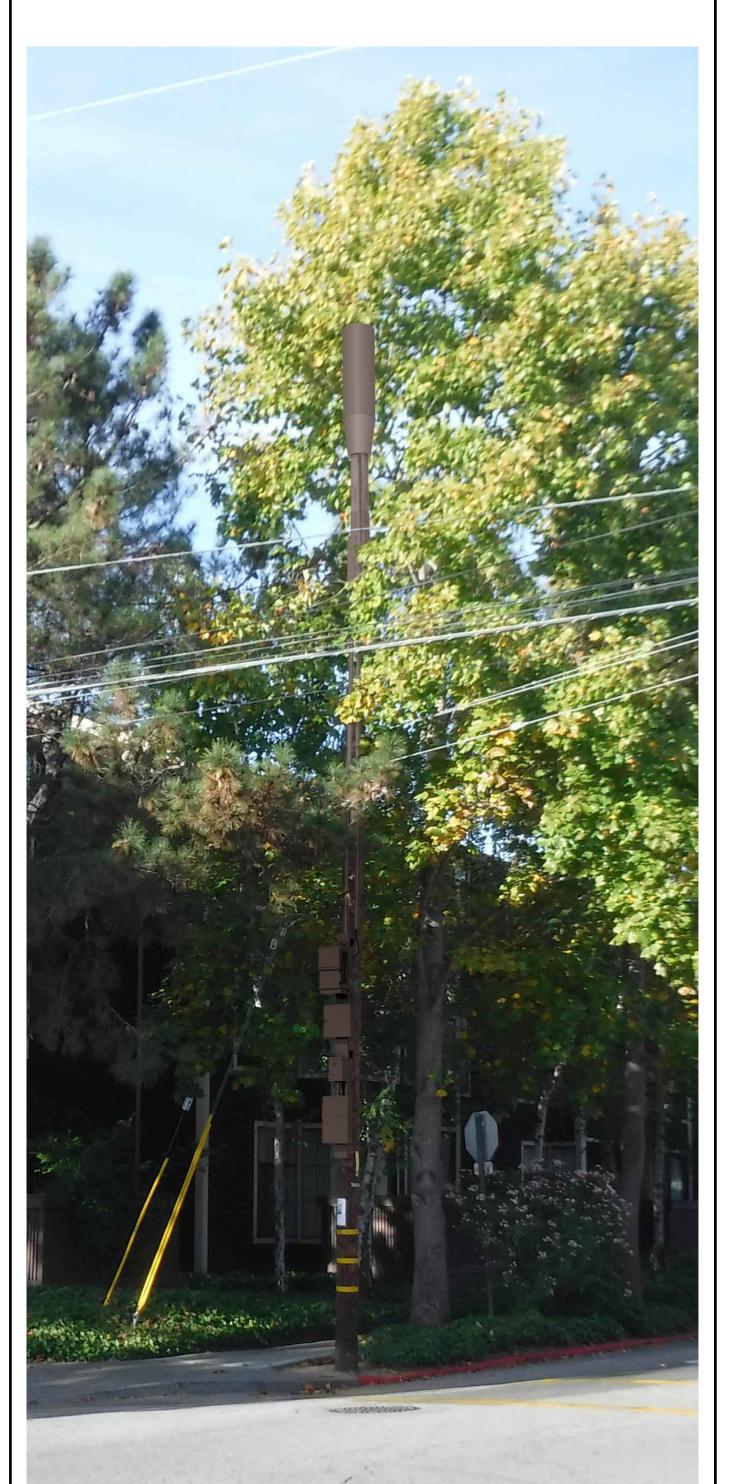

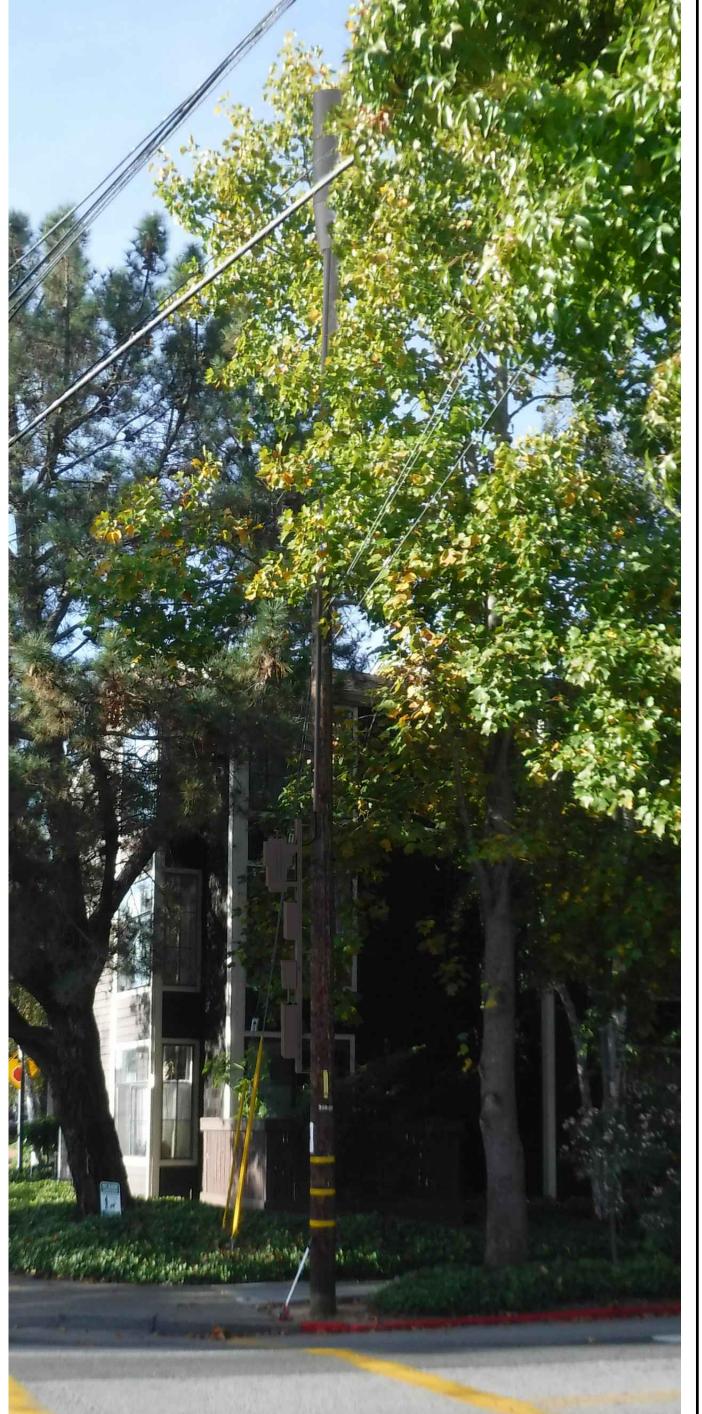

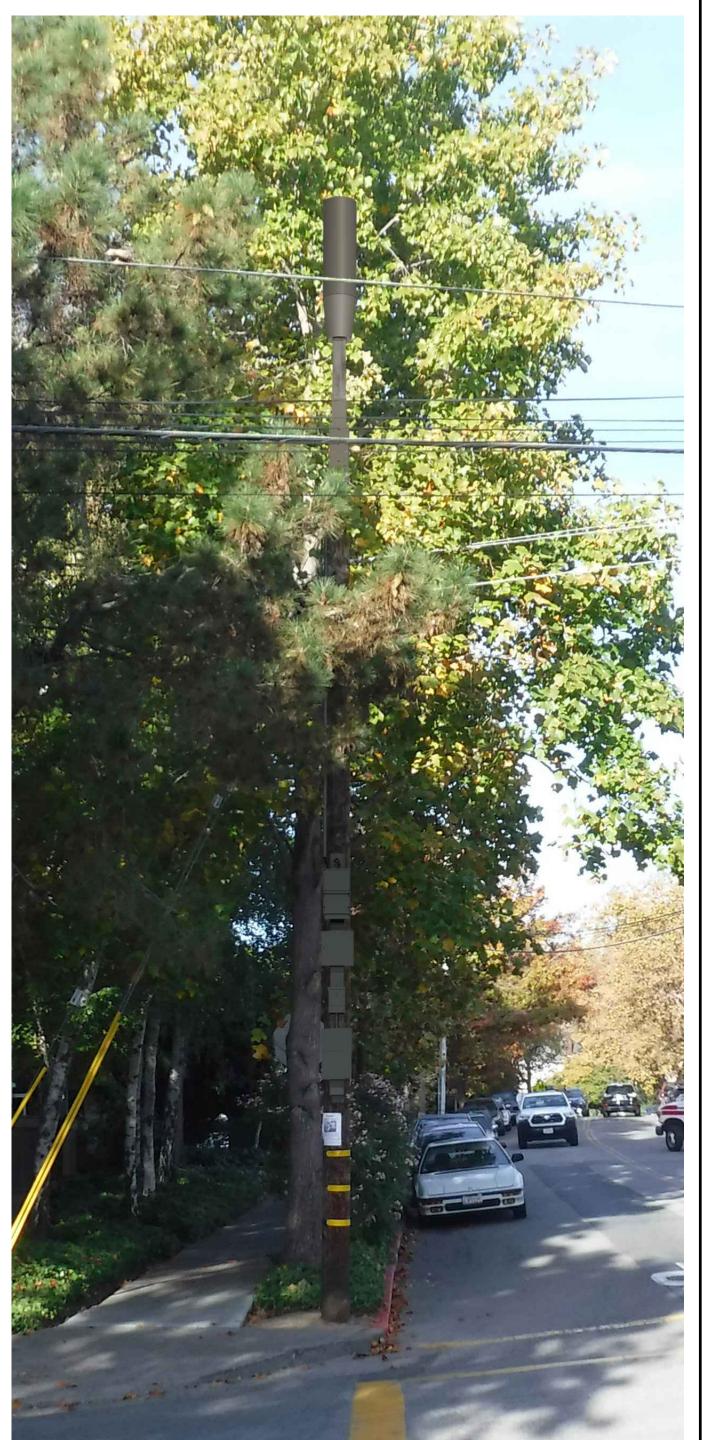



CROWN CASTLE CROWN CASTLE 695 RIVER OAKS PARKWAY SAN JOSE, CA 95134

RECORD DRAWINGS ISSUE DATE: 02.26.19



Shift Companies, LLC
3334 N. 20TH ST.
PHOENIX, ARIZONA 85016 ph: 480.264.0829

fax: 480.264.0163

THIS DRAWING IS COPYRIGHTED AND IS
THE SOLE PROPERTY OF THE OWNER. IT IS
PRODUCED SOLELY FOR USE BY THE
OWNER AND ITS AFFILIATES.
REPRODUCTION OR USE OF THIS DRAWING
AND/OR THE INFORMATION CONTAINED IN
IT IS FORBIDDEN WITHOUT THE WRITTEN
PERMISSION OF THE OWNER.

RELEASE		
DATE	SUBMITTAL	
02.26.19	1ST SUBMITTAL	
03.19.19	2ND SUBMITTAL	
11.14.19	RESUBMITTAL	

RE	REVISIONS				
NO.	DATE	COMMENT			

PROJECT NAME

SAN FRANCISCO BAY EXPANSION -58 SITES

NODE NUMBER

SFB004m1

NODE ADDRESS

ACROSS 304 MISSION AVE SAN RAFAEL, CA

HUB AREA

SF40XC103

SHIFT JOB NUMBER IN HOUSE

DRAWN BY: RA 150601 CHECKED BY: CM

SHEET TITLE

PHOTO SIMULATIONS

SHEET NUMBER

PAGE

4 OF 8

PLOT SCALE: 1:1 @ 24"x36"; 1:2 @ 11"x17"

POLE PHOTO SIMULATION - VIEW 1 (EXISTING)


POLE PHOTO SIMULATION - VIEW 1 (PROPOSED) SCALE: NTS

SCALE: NTS

8 POLE PHOTO SIMULATION - VIEW 2 (PROPOSED)

SCALE: NTS 16 POLE PHOTO SIMULATION - VIEW 3 (PROPOSED)

SCALE: NTS 20

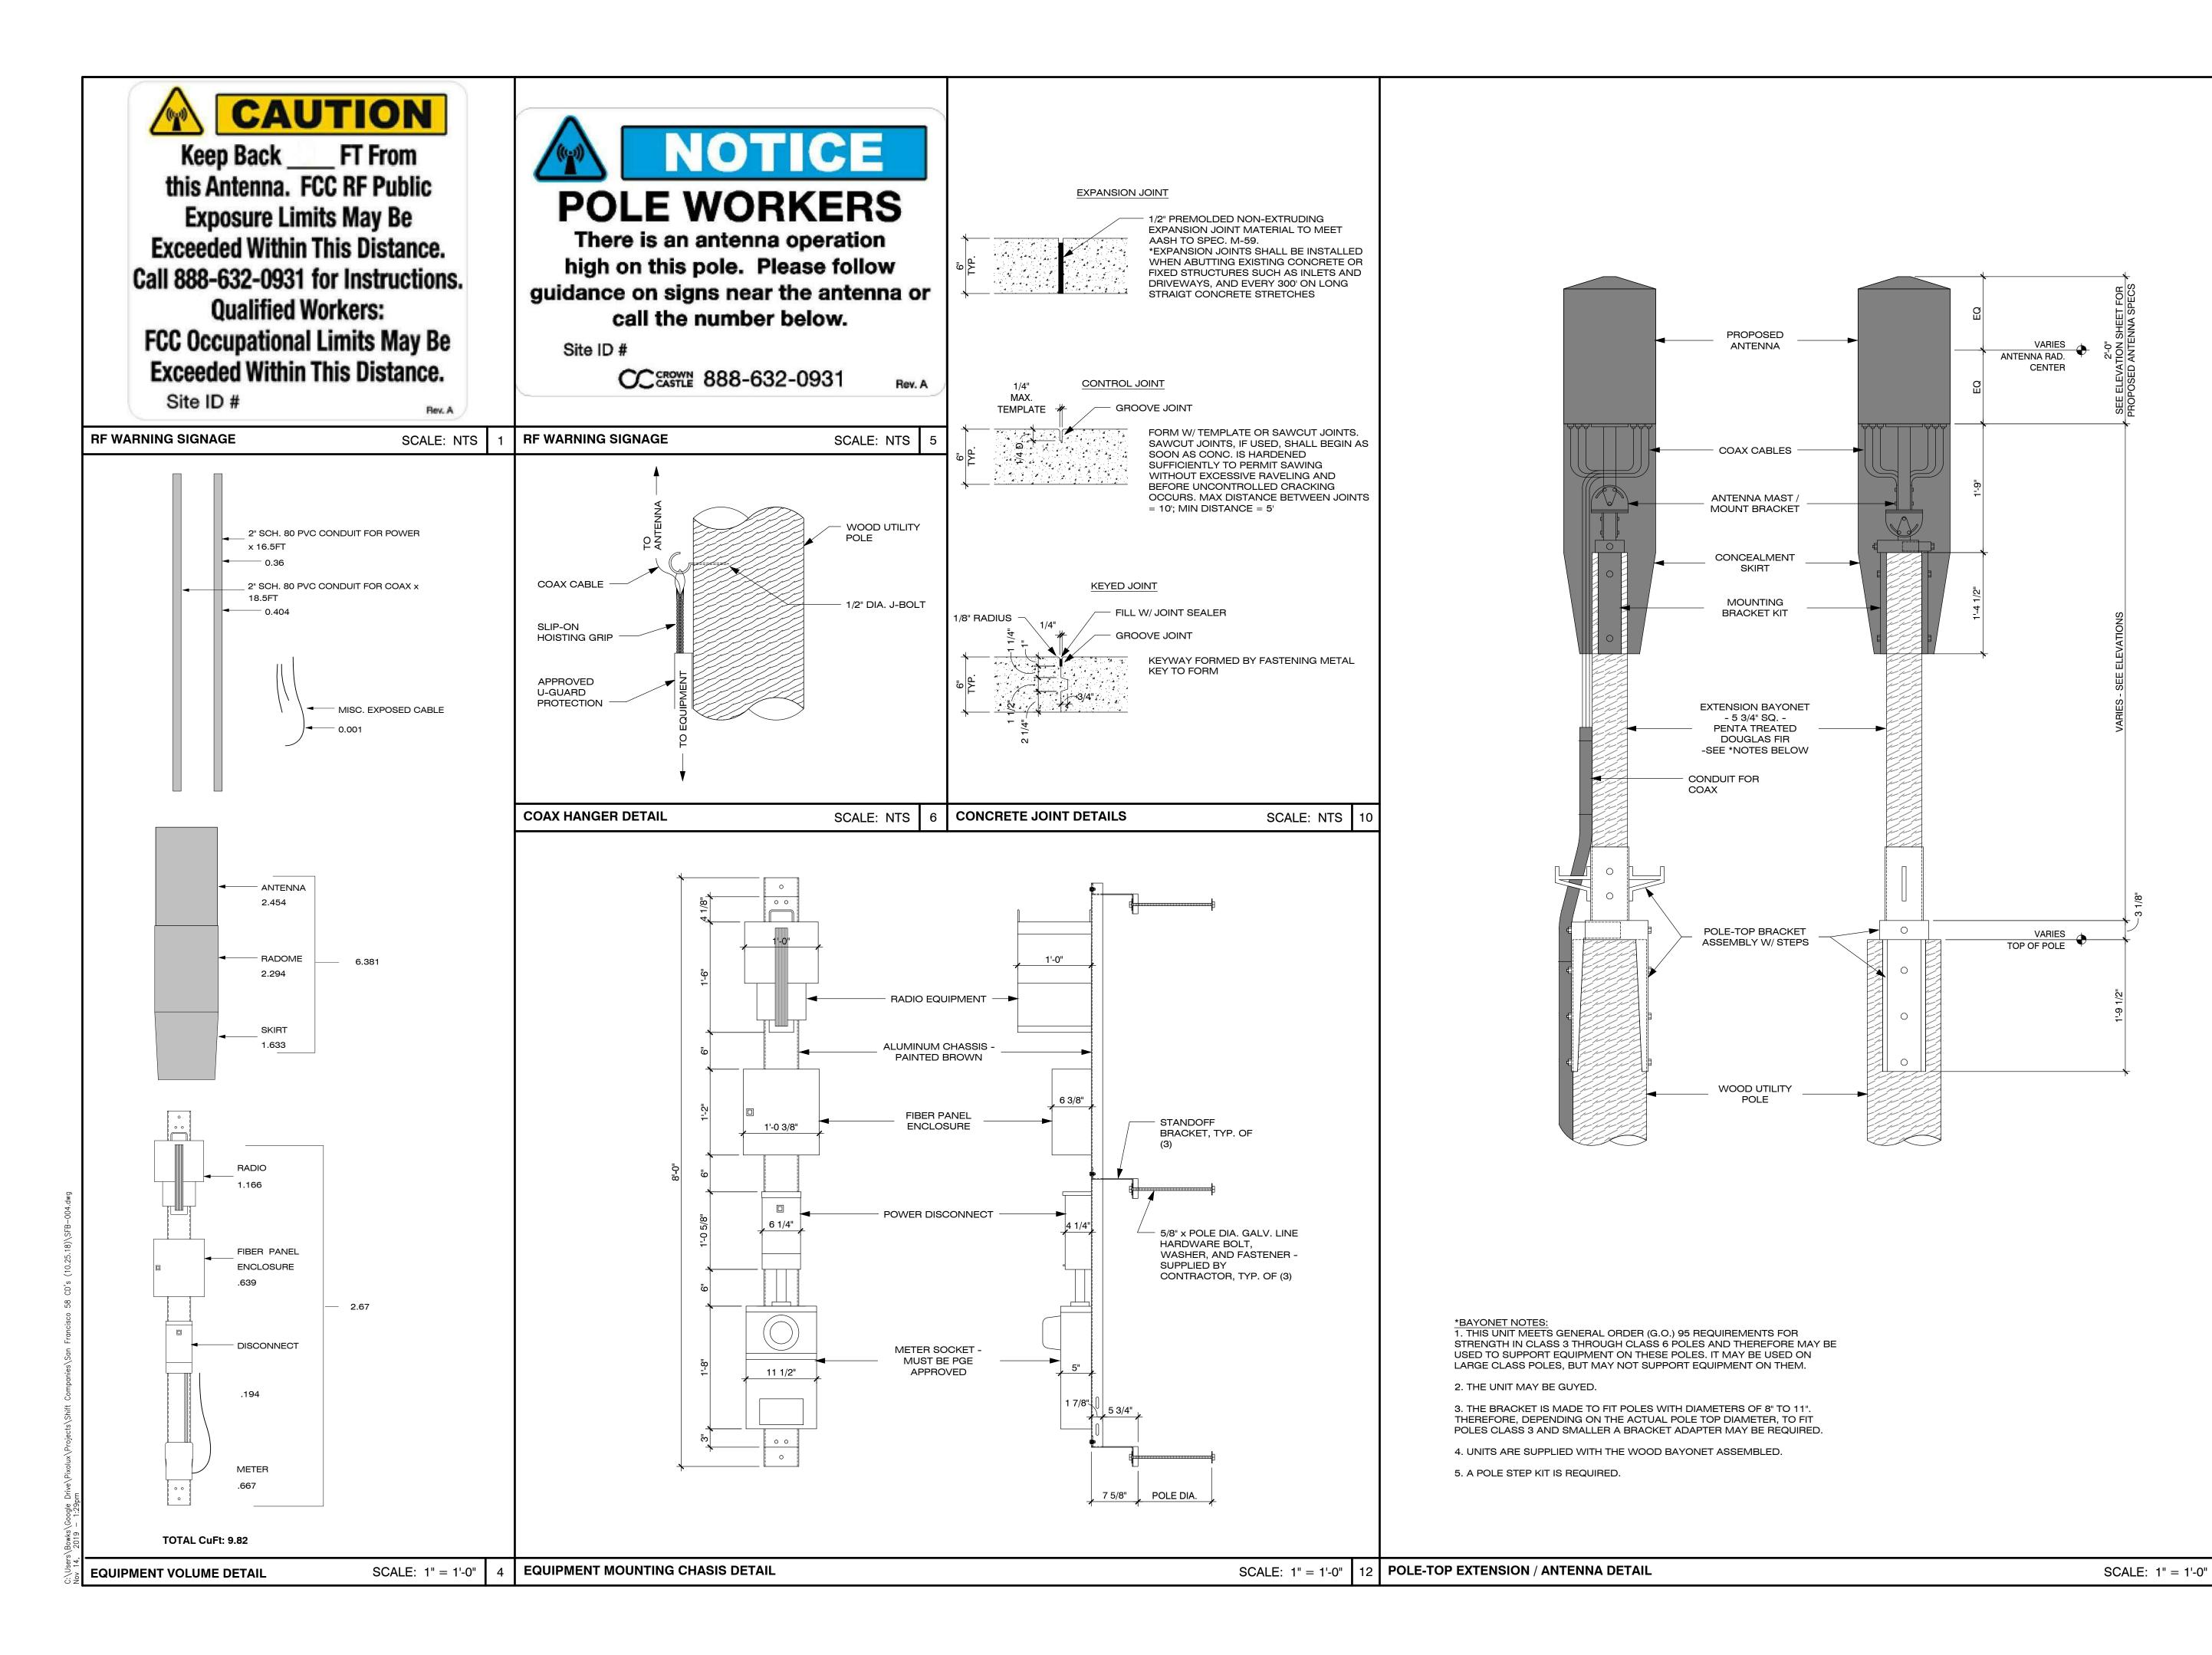



CROWN CASTLE CROWN CASTLE 695 RIVER OAKS PARKWAY SAN JOSE,

RECORD DRAWINGS ISSUE DATE: 02.26.19





fax: 480.264.0163

THIS DRAWING IS COPYRIGHTED AND IS
THE SOLE PROPERTY OF THE OWNER. IT IS
PRODUCED SOLELY FOR USE BY THE
OWNER AND ITS AFFILIATES.
REPRODUCTION OR USE OF THIS DRAWING
AND/OR THE INFORMATION CONTAINED IN
IT IS FORBIDDEN WITHOUT THE WRITTEN
PERMISSION OF THE OWNER.

PERIVISSION OF THE OWNER.			
RELEASE			
DATE	SUBMITTAL		
02.26.19	1ST SUBMITTAL		
03.19.19	2ND SUBMITTAL		
11.14.19	RESUBMITTAL		

RE	REVISIONS				
NO.	DATE	COMMENT			

PROJECT NAME

SAN FRANCISCO BAY EXPANSION -58 SITES

NODE NUMBER

SFB004m1

NODE ADDRESS

ACROSS 304 MISSION AVE SAN RAFAEL, CA

HUB AREA

SF40XC103

SHIFT JOB NUMBER

150601 DRAWN BY: RA CHECKED BY: CM

IN HOUSE

SHEET TITLE


CONSTRUCTION DETAILS

SHEET NUMBER

5 OF 8

PAGE

PLOT SCALE: 1:1 @ 24"x36"; 1:2 @ 11"x17"

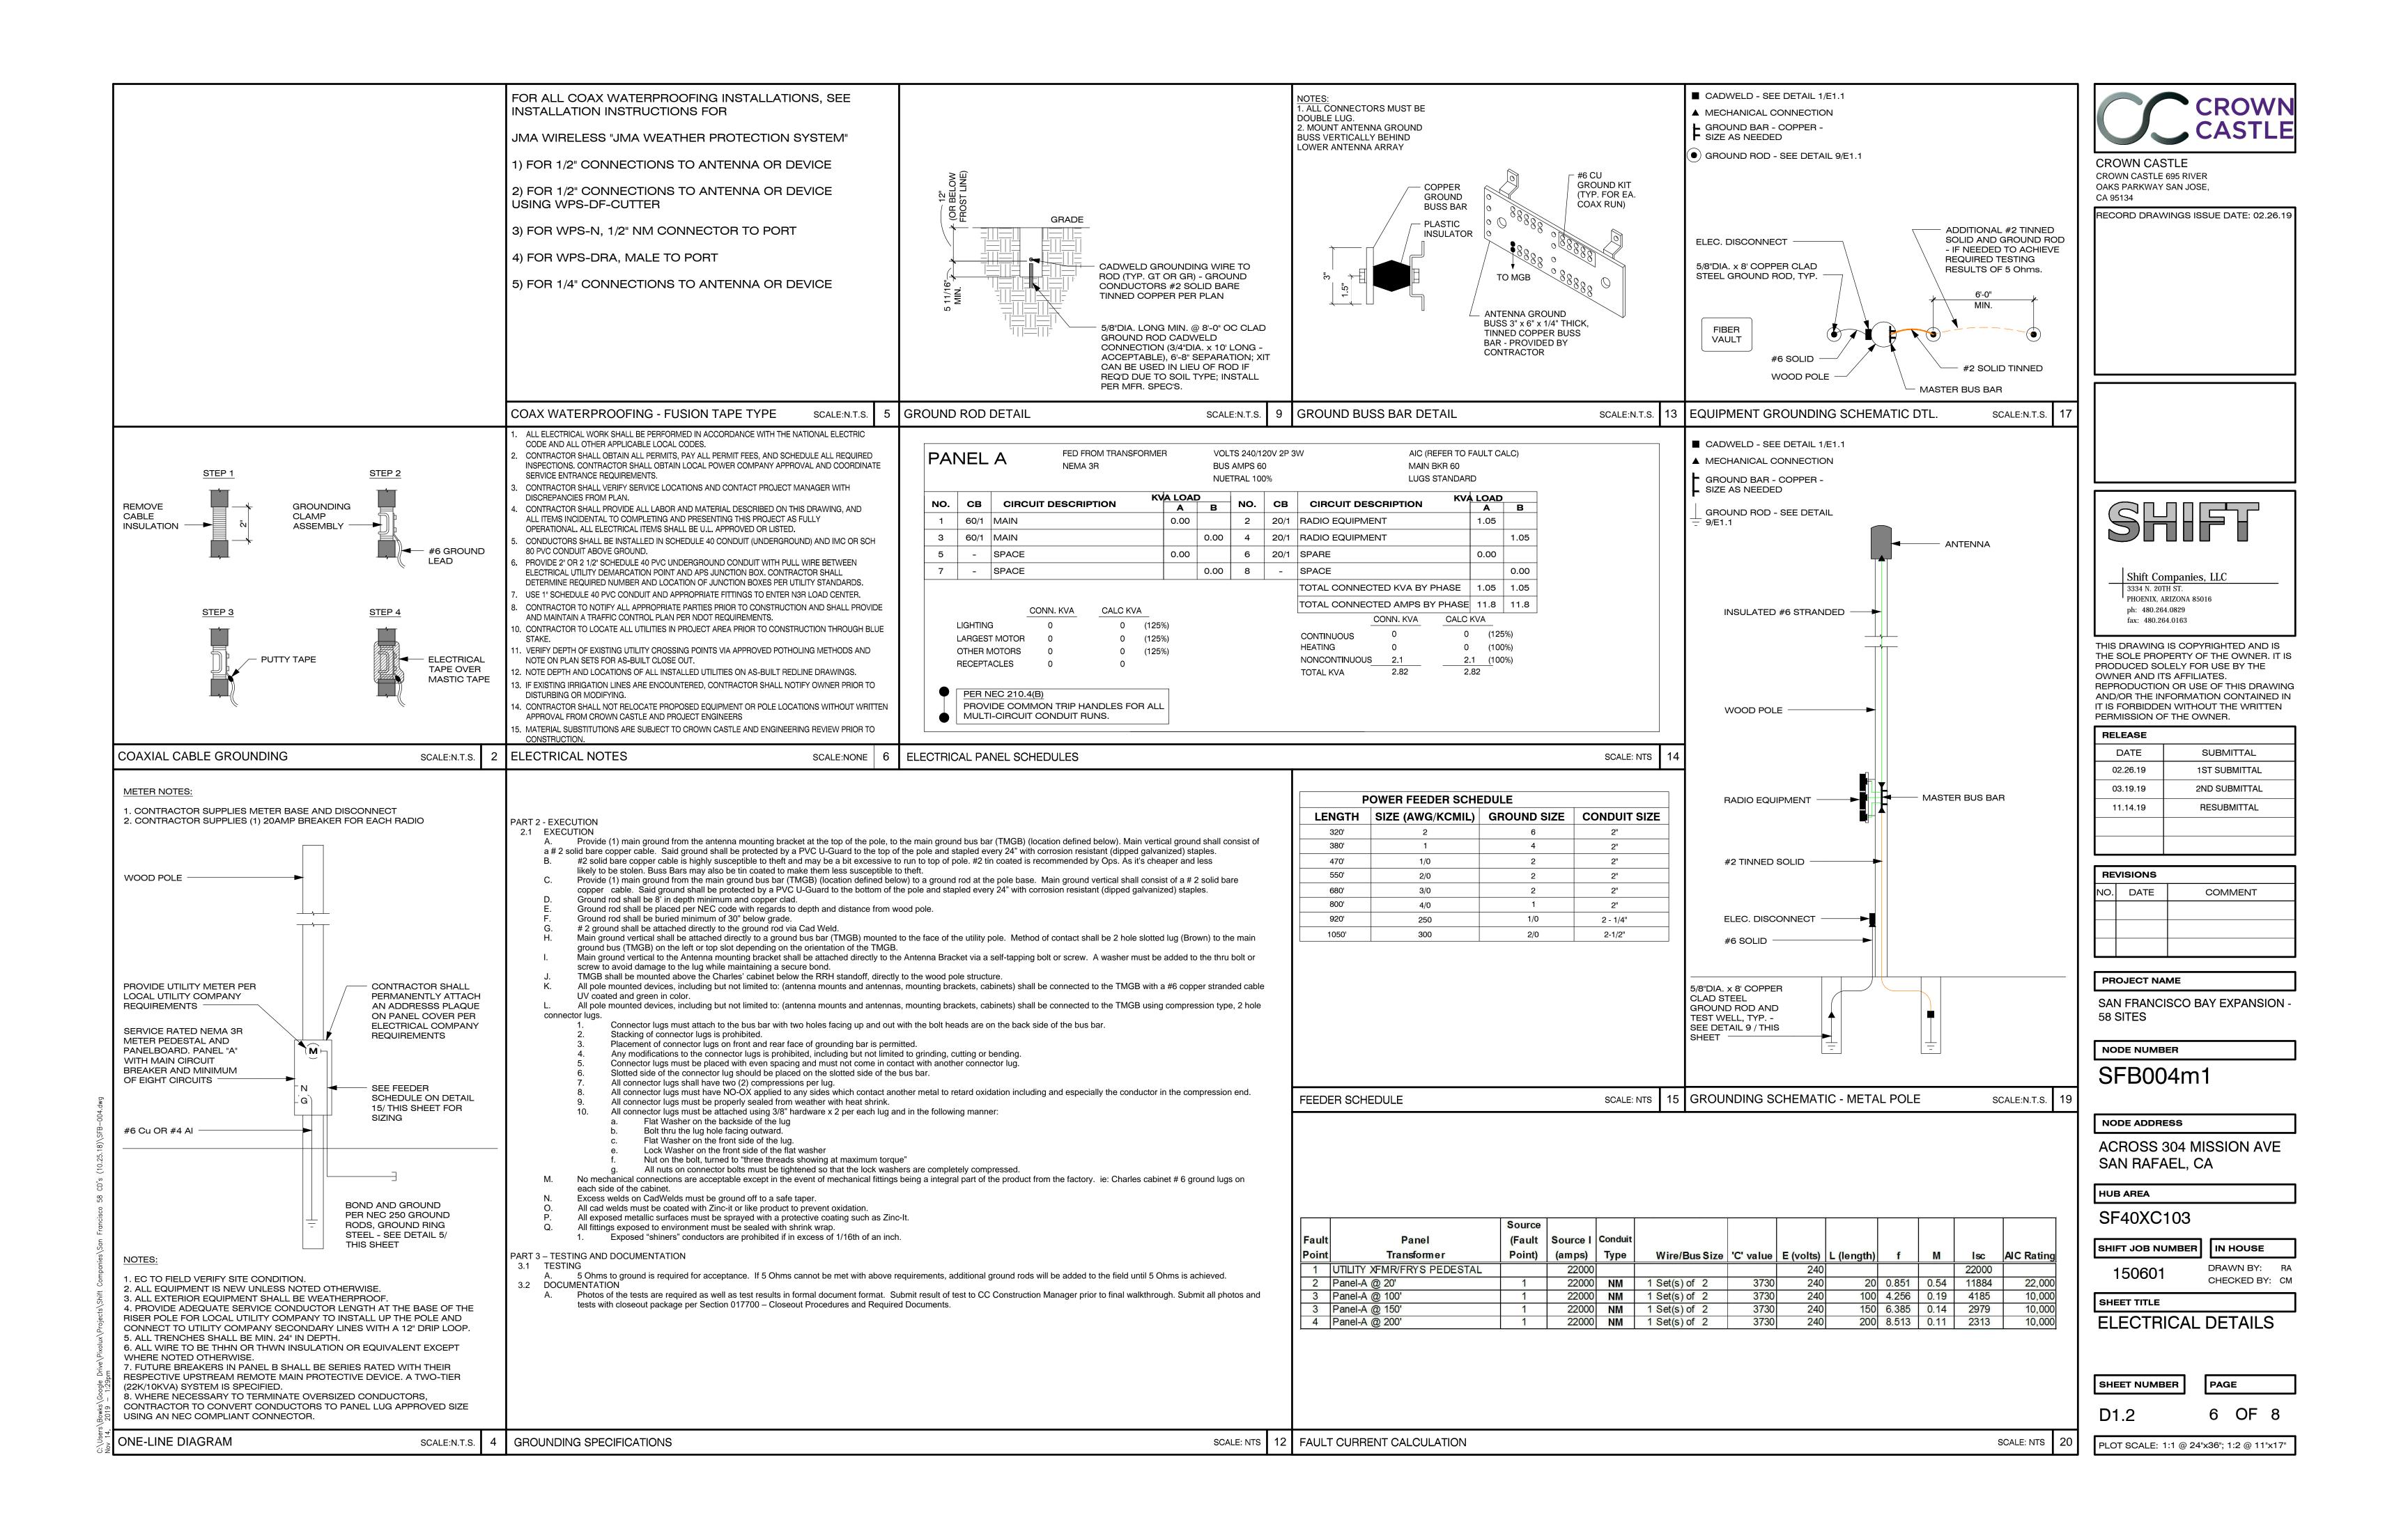

High Capacity Outdoor LTE-Advanced eNodeB

AirHarmony 4400 is part of Airspan's carrier-class LTE Advanced small cell eNodeB family. AirHarmony 4400 is a Macro-class product that supports 3GPP's Long Term Evolution (LTE) eNodeB specifications, providing highspeed data, mobility, Voice over LTE, and broadcast/multicast services in order to meet the demands of the LTE Mobile Carriers.

AirHarmony 4400 is a compact, easy to install Macro-class eNodeB, allowing an operator to deploy LTE broadband services using existing infrastructure or Street Furniture. AirHarmony 4400 has two 20W (43dBm) transmit channels and four receive channels. AirHarmony 4400 supports single or dual carrier up to 2x 20MHz.



AirHarmony 4400 supports 3GPP LTE Broadband access technologies; Airspan's 3GPP LTE implementation is compliant with the 3GPP standards and has interoperable S1 and X2 interfaces and supports commercial GCF tested UE devices, including Smartphones, Dongles and Tablet

The Power of HETNETS

As operators struggle to cope with growing customer demand for higher throughput, they are discovering that layering small base stations into a macro cell coverage area, enables a significant increase in network capacity by filling in coverage gaps and addressing actual traffic distribution where demand is highest. AirHarmony 4400 is ideal for these networks, delivering high data rates where needed most, whether at the macro cell edge or closer to the user base, maximizing coverage and customer satisfaction.

Broadband Access

AirHarmony-4400 supports 3GPP LTE Broadband access technologies; Airspan's 3GPP LTE implementation is compliant with the 3GPP standards and has interoperable S1 and X2 interfaces and supports commercial GCF tested UE devices, including Smartphones, Dongles and Tablet computers.

Integrated Backhaul

AirHarmony also supports tight integration with iBridge or iRelay, Airspan's small cell backhaul product. AirHarmony plus iRelay creates a single install process for LTE Access and Backhaul, and enables "Just add Power" plug and play deployment method saving deployment CAPEX and OPEX.

Page 1 of 8

RADIO SPEC.

Physical

Variant	Dimensions ¹ (H x W x D)		
Main Unit w/o filters	509 x 262 x 210 mm / 20.0 x 10.3 x 8.3 inch		
Main Unit with external filters	509 x 262 x 305 mm / 20.0 x 10.3 x 12.0 inch		
Cavity Filter Set (4 filters in 2 sets of 2 filters each)	229 x 120 x 39.0 / 9.01 x 4.72 x 1.53 inch (2 units)		

Variant	Weight	
Main Unit w/o filters / duplexers	19 Kg / 41.89 Lbs.	
Main Unit with filter set	24 Kg / 52.9 Lbs.	
Universal mounting bracket	3 Kg / 6.6 Lbs.	
Quadruple Filter Set (B41)	6 Kg / 13.2 Lbs.	

One	ratio	Ica	Tal	erar	

Туре	Details	Standard Compliance
Operating temperature	-40°C to 55°C / -40°F to 131°F	ETSI 300 019 1-4
Operating humidity	5% - 100% non-condensing	ETSI 300 019 1-4
Storage temperature	-40°C to 70° C / -40°F to 158°F	N/A
Storage humidity	5% - 100% non-condensing	ETSI 300 019 1-4
Rain and dust ingress protection	IP66	N/A
	70-106 kPa as well as:	
Operational altitude	From -60m to 1800m @ 40°C	ETSI 300 019 1-4
	From 1800m to 4000m @ 30°C	
Solar radiation	1120 W/m ²	ETSI 300 019 1-4

Dimensions excludes connectors height and protruding screws Page 2 of 8

DISCONNECT

Sharles LT-CFTT2424

2.3 Routing Cable into the Unit

Twenty-four adapter ports are provided inside the enclosure. These ports open to the top and bottom and are numbered (1 through 24).

Grommets on the bottom of the enclosure allow fiber routing (Figure 4). An optional conduit kit is available that provides protection for fibers as they enter

the enclosure (97-000012-A, sold separately). For kit mounting instructions, see the documentation that ships with the kit. 2.3.1 Feed Cable

Airspan

SCALE: N.T.S. | 10 |

SCALE: N.T.S. | **12** |

- 1. Insert the connectorized feed cable into the CFTT-2424 through the
- 2. Use local practice for securing cable. Three strain relief brackets are Connect the fibers to the adapter ports that face the top of the CFTT-

2.3.2 Drop Cable

Figure 4 CFTT-2424 Grommets Insert the first 12 connectorized drop cables into the CFTT-2424 through the left-most grommet. Use the right-most grommet to

Use local practice for securing cable. Three strain relief brackets are provided. Connect the fibers to the adapter ports that face the bottom of the CFTT-2424. Check the numbering to ensure that the fibers are

TECHNICAL ASSISTANCE AND REPAIR SERVICE

For questions on product repair or if technical assistance is required, contact Charles Technical Support.

techserv@charlesindustries.com (email)

http://www.charlesindustries.com/techserv.htm

connected to the correct ports.

4. WARRANTY & CUSTOMER SERVICE

Charles Industries, Ltd. offers a one-year warranty on the housing and a one-year warranty on the optical components. The Charles warranty is limited to the operation of the hardware as described in this documentation and does not cover equipment which may be integrated by a third party. The terms and conditions applicable to any specific sale of product shall be defined in the resulting sales contract. For questions on warranty or other customer service assistance, contact your Charles Customer Service Representative.

mktserv@charlesindustries.com (email) http://www.charlesindustries.com/main/telecom_sales_support.htm

FIBER ENCLOSURE SPEC.

SPECIFICATIONS

Physical		
Weight	Approx. 6.0 lbs. as shipped	
Available Colors	CFTT-2424LCUXPB: Onyx Black CFTT-2424LCUXPG: Gray CFTT-2424LCUXP7: Beige	
Kits and Replacement Parts		
Fiber Conduit Adapter Kit	97-000012-A	_

Sharles

LT-CFTT2424 1st Printing, April 3, 2018

CROWN CASTLE

CA 95134

CROWN CASTLE 695 RIVER

OAKS PARKWAY SAN JOSE,

RECORD DRAWINGS ISSUE DATE: 02.26.19

Charles Industries CFTT-2424 Series Fiber Enclosure

1. GENERAL INTRODUCTION

1.1 Document Purpose

This document provides installation instructions for the Charles Industries' CFTT-2424 series fiber enclosures. Figure 1 shows the front view of the CFTT-2424.

General Description and Installation

1.2 Product Purpose

GROMMETS FOR FIBER ENTRY

LEFT AND RIGHT GROMMETS HAVE A 1.10" OPENING. CENTER GROMMET HAS A 1.35" OPENING

> The CFTT-2424 provides a means of managing fiber optics service cable. The enclosure houses 24 fiber adapter ports. Feed and drop fibers enter the enclosure and are connected to these ports. The CFTT-2424 is designed for mounting on a pole or wall.



Figure 1 CFTT-2424 Fron

2. INSTALLATION

2.1 Warnings and Precautions

- Follow all national safety codes, OSHA requirements, and local environmental, workplace and company codes, safety procedures
- and practices. Only authorized trained personnel shall install the unit.

2.2 Mounting the CFTT-2424 on a Pole

The CFTT-2424 ships with the enclosure attached to the pole mounting bracket. To mount the unit, first remove the enclosure from the bracket by removing the hardware from the four attachment points as shown in Figure 2

The bracket has two mounting options.

Charles is a registered trademark of Charles Industries.

2C4U3MT360X06Fxys0

Connector Description

Low Band #1

 Omni configuration with 18 connectors Ideal for Small Cell / DAS applications

 This antenna meets the requirements of the U-NII Available for order with a grey, brown or black radome

• Option 1: use the two holes in the center of the bracket to mount a pair of lag bolts into the pole.


• Option 2: use the four obround slots at the sides of the bracket to mount to the pole using straps.

See Figure 3 for locations of mounting holes and slots. Use local practice for mounting the bracket to the pole. All hardware for mounting to the pole is customer

MULTI BAND | OMNI | CANISTER ANTENNA | X-POL | FIXED TILT | 610 MM (24.0 IN)

696-960 MHz

Once the bracket is securely on the pole, re-attach the enclosure onto the PEM studs using the hardware removed previously.

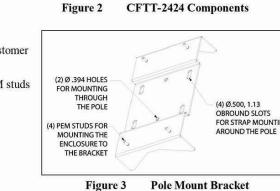

©Copyright 2018 Charles Industries, Ltd. All Rights reserved. Printed in the United States of America. Availability of features and technical specifications herein are subject to change without notice.

(2x) 696-960 / (4x) 1695-2700 / (2x) 3550-3700 / (1x) 5150-5925 MHz

Page 1 of 2

SCALE: N.T.S. | **18**

PERMISSION OF THE OWNER. RELEASE DATE SUBMITTAL 02.26.19 1ST SUBMITTAL 03.19.19 2ND SUBMITTAL

Shift Companies, LLC

THIS DRAWING IS COPYRIGHTED AND IS THE SOLE PROPERTY OF THE OWNER. IT IS

REPRODUCTION OR USE OF THIS DRAWING

AND/OR THE INFORMATION CONTAINED IN

IT IS FORBIDDEN WITHOUT THE WRITTEN

PRODUCED SOLELY FOR USE BY THE

PHOENIX, ARIZONA 85016

3334 N. 20TH ST.

ph: 480.264.0829 fax: 480.264.0163

OWNER AND ITS AFFILIATES.

REVISIONS COMMENT

RESUBMITTAL

PROJECT NAME

SAN FRANCISCO BAY EXPANSION

NODE NUMBER

SFB004m1

NODE ADDRESS

ACROSS 304 MISSION AVE SAN RAFAEL, CA

HUB AREA

SF40XC103

SHIFT JOB NUMBER IN HOUSE DRAWN BY: RA 150601

SHEET TITLE

EQUIPMENT SPECIFICATIONS

SHEET NUMBER

SCALE: N.T.S. **20**

PAGE

7 OF 8

CHECKED BY: CM

PLOT SCALE: 1:1 @ 24"x36"; 1:2 @ 11"x17"

Low Band #2 696-960 MHz (2x) 4.3-10 Female Mid Band #1 1695-2700 MHz (2x) 4.3-10 Female Mid Band #2 BITT PITTE Mid Band #3 1695-2700 MHz (2x) 4.3-10 Female Mid Band #4 High Band #1 (2x) 4.3-10 Female 3550-3700 MHz (2x) 4.3-10 Female High Band #2 High Band #3 5150-5925 MHz (2x) 4.3-10 Female ■ P1 ■ P2 ■ O1 Electrical Characteristics ■ Y1 ■ Y2 ■ Y3 ■ Y4 (2x) 3550-3700 5150-5925 Frequency Bands (MHz) 696-806 806-960 1695-1880 1850-1990 1920-2200 2300-2700 $(2x) \pm 45^{\circ}$ $(4x) \pm 45^{\circ}$ Polarization Horizontal Beamwidth 360° 360° Vertical Beamwidth 96.9° ± 26.7 72° ± 21.7° | 38.3° ± 7.8° | 33.8° ± 8.2° | 33.4° ± 6.2° | 29.0° ± 5.1° | 40.2° ± 4.6° | 21.3° ± 5.9° $\begin{vmatrix} 4.2 \pm 0.9 & 3.9 \pm 0.7 & 6.1 \pm 0.7 & 6.2 \pm 0.7 & 6.1 \pm 0.9 & 6.8 \pm 1.1 & 5.3 \pm 0.6 & 4.8 \pm 1.0 \end{vmatrix}$ Gain (dBi) 6.9 7.0 7.9 5.1 4.6 6.8 Electrical Downtilt (°) (y) 2, 4, 6 ≤ 1.5:1 ≤ 1.5:1 ≤ 1.5:1 N/A N/A N/A 25 dB 25 dB Isolation 28 dB 28 dB 28 dB IM3 (2x20W carrier) < -153 dBc < -153 dBc N/A N/A (4x) 500 W (8x) 300 W (4x) 100 W (2x) 50 W Input Power U-NII Compliant ---Number of Sectors and/or Pattern Shape Direct Ground Mechanical Characteristics 610 x 371 mm 24.0 x 14.6 in Weight without Mounting Bracket Kit 25 lbs 2.3 ft³ Antenna Volume Survival Wind Speed 150 mph 0.22 m² 2.4 ft² Wind Area 43 lbf Wind Load (160 km/hr or 100 mph) Quoted performance parameters are provided to offer typical, peak or range values only and may vary as a result of normal testing, manufacturing and operational conditions. Extreme

(2x) 4.3-10 Female


REV100918NA www.amphenol-antennas.com **ANTENNA SPEC.**

METER SPEC. SCALE: N.T.S. **16**

DISCONNECT MUST BE APPROVED BY PG&E

METER MUST BE APPROVED BY PG&E



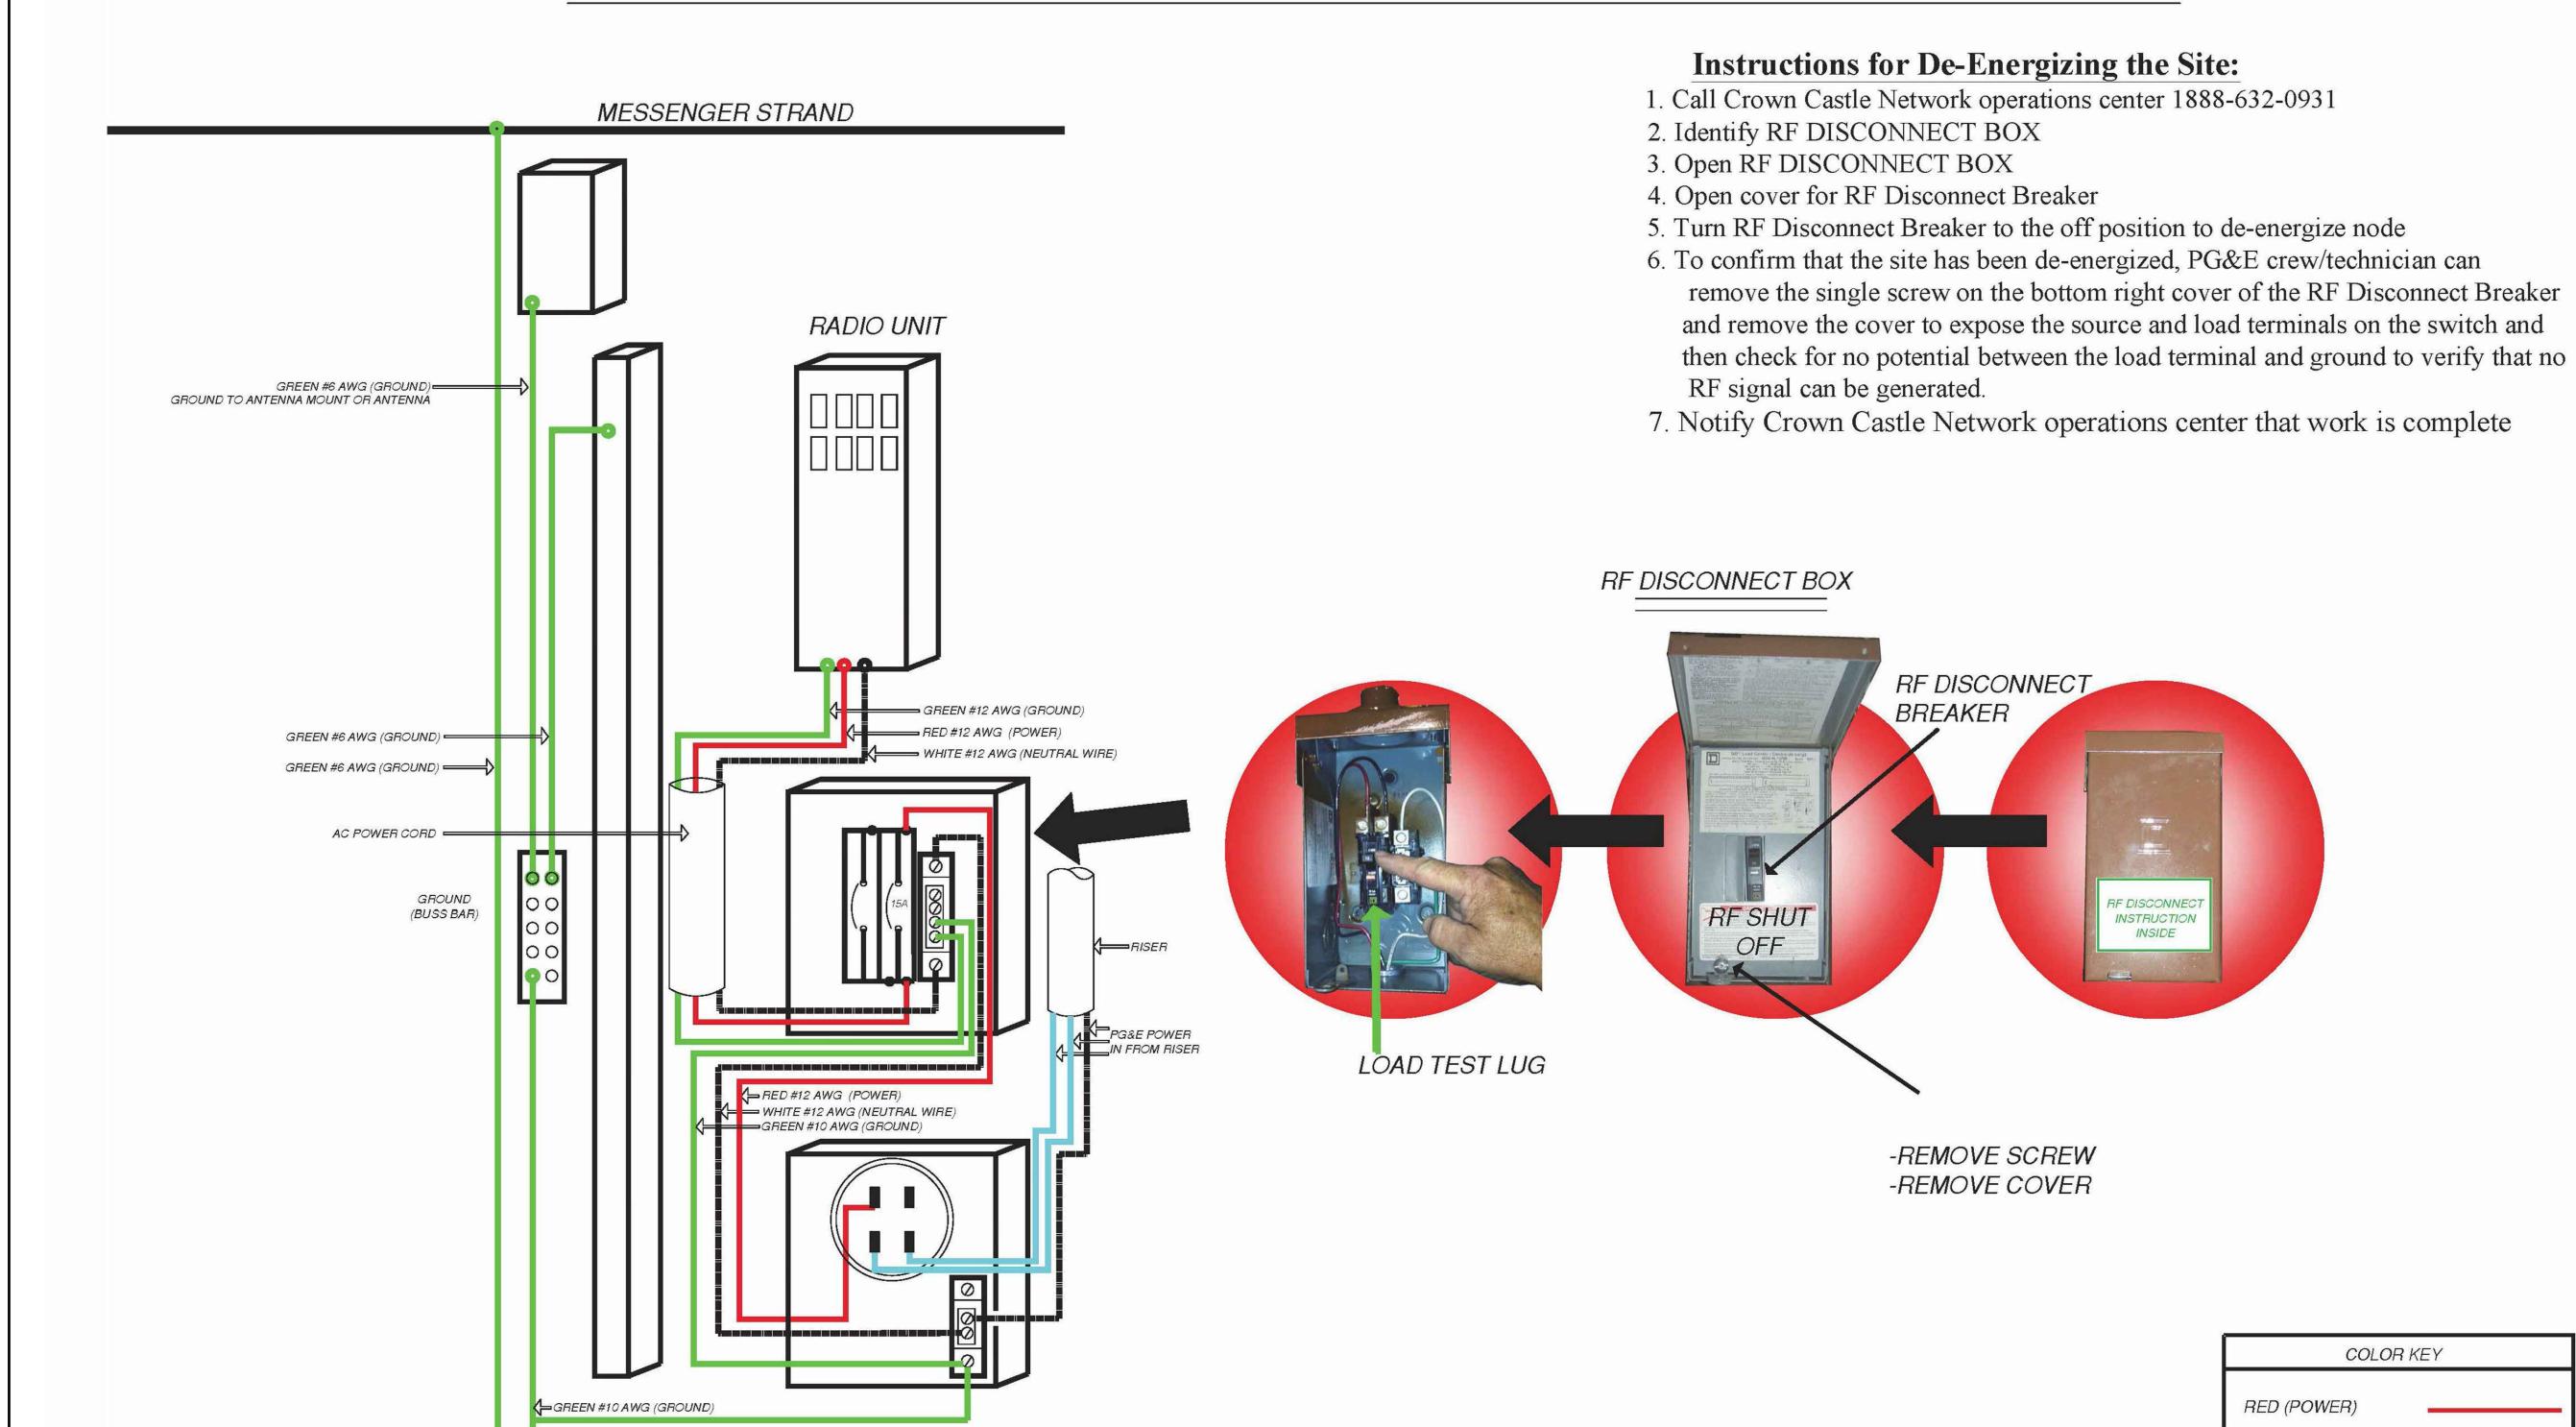

⊈EARTH GROUND

←GREEN #6 AWG (GROUND)

(2) 5/8" X 8' COPPER CLAD GROUND ROD. CROWN

CROWN CASTLE CROWN CASTLE 695 RIVER OAKS PARKWAY SAN JOSE,

RECORD DRAWINGS ISSUE DATE: 02.26.1

SHIFT

Shift Companies, LLC
3334 N. 20TH ST.
PHOENIX, ARIZONA 85016
ph: 480.264.0829
fax: 480.264.0163

THIS DRAWING IS COPYRIGHTED AND IS
THE SOLE PROPERTY OF THE OWNER. IT IS
PRODUCED SOLELY FOR USE BY THE
OWNER AND ITS AFFILIATES.
REPRODUCTION OR USE OF THIS DRAWING
AND/OR THE INFORMATION CONTAINED IN
IT IS FORBIDDEN WITHOUT THE WRITTEN

RELEASE		
DATE	SUBMITTAL	
02.26.19	1ST SUBMITTAL	
03.19.19	2ND SUBMITTAL	
11.14.19	RESUBMITTAL	

RE	REVISIONS				
NO.	DATE	COMMENT			

PROJECT NAME

SAN FRANCISCO BAY EXPANSION 58 SITES

NODE NUMBER

SFB004m1

NODE ADDRESS

ACROSS 304 MISSION AVE SAN RAFAEL, CA

HUB AREA

SF40XC103

SHIFT JOB NUMBER IN HOUSE

150601 DRAWN BY: RA CHECKED BY: CM

SHEET TITLE

GREEN (GROUND)

BLACK / DASHED

(NEUTRAL)

BLUE (PG&E POWER)

A) ANTENNA AND MOUNTING BRACKET

B) NODE EQUIPMENT

C) RF DISCONNECT BOX

D) POLE MOUNTING CHANNEL

E) B-LINE 114TB METER SOCKET

PGE EQUIPMENT
SHUT-DOWN
PROCEDURE

SHEET NUMBER

8 OF 8

PAGE

PLOT SCALE: 1:1 @ 24"x36"; 1:2 @ 11"x17"