


New Residence, Residence Remodel with New ADU & Lot Line Adjustment For:



Arterberry

52/54 Fremont Street San Rafael CA 94965 A.P.N.: 012-043-11& 12

A.P.N 012-043-11 &12

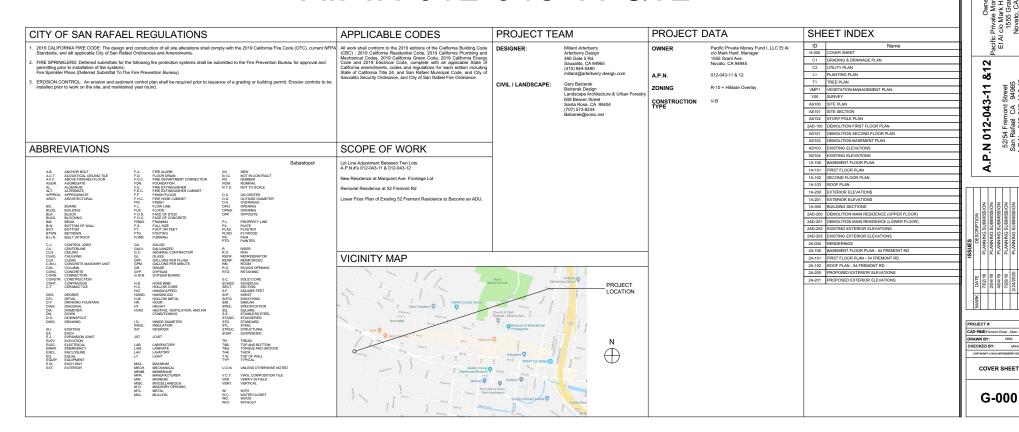

DIVISION 1 - GENERAL REQUIREMENTS

- RILES, RECULATIONS, All undy eath conform to the 2016 delition of the California Building Code (CBQ) 2016 California Building Code (CBQ) 2016 California Burriump and Medinandam Codes, 2016 California Come Building Standards Code, 2016 California Come Building Standards Code, 2016 California Come Building Standards Code, 2016 California Codes and 4010 Electrical Code, complete with his all populates State of California amendments codes and regulations for each delton including State of California Title 24, and San Rathael Municipal Code.
- CONTRACTOR Shall be responsible for construction in conformance with the approved plans, specifications, and all code requirements under which the plans and specifications were approved.
- ARCHITECTURAL DRAWINGSAND SPECIFICATIONS: In the case of an inconsistency between Architectural Drawings, Specifications and Calculations or within either document, the inconsistency shall be reported to the Architect prior to the Contrador commercing work. The better quality or greater quantity of Work shall be provided in accordance with the Architect's interpretation.
- BIGNETERNO DRAWINGS AND SPECIFICATIONS. In the case of an inconsistency between Architectural Drawings, Secretifications and Edisplandson sand Edisplands (Documents, or within an Specifications and Cabulations, theweve different Explanering/Document Documents, or within an document, the Inconsistency and that the proposal or has Architect prior to the Contrador commercing work. The better quality or greater quantity of Work, shall be provided in accordance with the Architect Explaner/Consultant in elempretation.
- MEASUREMENTS: Do not scale drawings. Contractor shall verify all dimensions shown on the drawings, any discrepancy shall be reported to the Architect prior to commencement of related to
- Protect annular spaces around pipes, electric cables, rodents. (4.406.1) conduits at exterior walls against the passage of

DEMOLITION NOTES

- Contractor shall carefully check the stability of all elements of the building before doing any work binnolition to the existing structure. The contractor shall brace or strengthen any portions of the structure that may be weekened by demolorion or construction activities. The contractor shall extract the strength was the contractor shall be responsible for jobsite safety and preservation of existing construction not stated for demolition.
- Contractor shall verify with owner or architect any item to be salvaged item will be the sole responsibility of the contractor. . Damage to any s

All demolifien and removal work shall conform to all applicable codes and regulations. The Contractor shall bear sole responsibility for dentryling, testing and disposing of any hazardous materials encountered in the demolifien process it accordance with all applicable codes, ordinances and

Removal of wall finishes, floor finishes, and ceiling finishes shall include all material down to framing, exterior sheathing or subfloor.

DUST MITIGATION PLAN

- in plan to the City. This plan shall wailability of needed equipment construction activities should
- FINAL GRADES shall be treated with an appropriate dust suppressant, covered or seeded as early as practical. y mewind.

 SWEEP STREETS DAILY: of all mud and debris carried out from the site onto the adjacent road, ince this material can be pulverized and later resuspended by vehicle traffic.

 ALL MATERIALS TRANSPORTED BY TRCK shall be covered or wetled down prior to exiling the

CONSTRUCTION MANAGEMENT PLAN

- CONSTRUCTION MANAGEMENT COORD NATOR: The name and phone number of a Construction Management Coordinator shall be posted at the site and shall be available to respond to complaints and questions from acen residents.
- HOURS OF OPERATION: Work at the site shall be limited to the hours of 8:00.4M to 4:30 PM, Mondays through Fridays, and 9:00.4M through 4:00 PM on Salurdays, No work shall be permitted on Sundays and Holidays without prior approval from the Community Development Agency.
- CONSTRUCTION VEHICLES: All material deliveries and removal from the construction site shall follow a roule, both to and from the site, agreed upon by the Community Development Agency and the Construction Management Coordinator. It is the Contractors responsibility to see that these locations and routes are arthered to.
- TRAFFIC MANAGRIENT: vehicular table sala not les delayed for more time of minutes for more time four consecution days. Access for emergency vehicules alla la maintained at all time (immuni 12-0, in with). Tattle management measures shall include the Soloving A, Traffic control measures such as fau persons, signale, etc. a bible buildized to emisse that vehicular that pud pediction moment will contribue to cours saledy during construction periods. It is the went of additional construction is contribue to cour saledy during construction periods. It is the went of additional construction is contribue to cour saledy during construction periods. It is the went of additional construction is contribued to cour saledy during construction periods. It is the went of additional construction in contribue to course and the sale responsibility of unital Contribution to contribution is
- A minimum of 65% of the constr 4.106.3 ction waste shall be diverted to recycling or salvage per calgreer
- Cover duct openings (4.504.1) openings during construction

RAILING NOTES

- IS TRANKY HANDRALS. Stalls in mounted 54-39 shows the treat crising and shall start nith a wall or terminate into rever loss (CGC 1112). Handraid assembles and list aske to reside a single conventrated and of 2010 pounds (in (19 M), applied in any direction at any port along the log, and have alteriment devices and supporting shoulure to itended this boarding to appropriate shruchrail elements of the building, (CBC 1607 Z.1.1).
- GUARDRALS shall be a minimum of 42° above walking surface and be in complete accordance will CBC 1013.2 Guardral assembles shall be able to resist a single concentrated load of 200 pounds CBC 1013.2 Applied in any direction at any pound along the top, and there altachment devices and supporting structure to transfer this loading to appropriate structural elements of the building. (CBC
- PICKET SPACING: Open guards shall have balusters or ornamental patterns such that a 4 inch diameter sphere cannot pass through any opening. (CBC 1013.3)

RISE AND RUN: The minimum tread dimension shall be 10 inches. The maximum variation of 3/8 inch. (CBC 1009.3 1009.3.2)

ENERAL EXISTING CONDITION NOTES

EXISTING CONDITIONS: It is the contractors responsibility to verify all applicable existing conditions, including but not limited to waiter damage, termite damage, object, of any other faming or stuctural issues that may vary from those shaven on the drawings, and report any discrepancies to the Architect prior to commencement of related work.

TREE PROTECTION NOTES

- CONDITIONS OF APPROVAL FOR PROTECTING TREES DURING CONSTRUCTION: Adequate protection shall be provided during the construction period for any protected which are to remain standing, heasured observed reconstruction period papercy in consideration of the size, species, condition & location of the protected trees to remain, may include any of the following:
- PROTECTED PREMIETER: Before the size of cleaning accession, constitution or drift work on the size, any "production feet demand entitingued by the work shall be securely fectored at the "production premieter," health size effect are outsit mins of the branches of until production (exp is not a size of the size of the
- EMCROACHING ON THE PROTECTION PERMITTER Winners to proposed development or other sits work will emcount upon the problemate primaters for only protected from posed measures malt has taken to allow the could be breather and other results and unitarity. Any processings calling, litting or to allow the could be breather and other problemate and unitarity and problemate problemate and the problemate and any problemate the ast any time. No braining or use of explainment with an open farme shall occur make or which the problemate permission.
- No STORAGE OR DUMPRISC of cut pact chemicals or other additionate that may be familiful to treat sails occur within the produced permitter of any producted text or any other busines on their where the adultances may enter the producted permitter. No heavy construction equipment or construction materials shall be operated or stored within the producted permitter. Where sail and to be anticated to any producted tree, occept as needed to support the tree. No entry, other than the big aboving the botancial desirations, natified the attraction can be producted to the or sign, other than the big aboving the botancial desirations, natified the attraction can be producted to the or sign.
- BUILDUP OF DUST: Periodically during construction, the leaves of the protected trees shall be sprayed thoroughly with water to prevent buildup of dust of other pollution that would inhibit inspire

- Coastal Live Oak (Quercus Agrifolia) measuring 12" C.B.H. or larger Heritage Trees
 Dedicated Trees
- measuring 12" C.B.H. or larger

- DEFINITION OF AN UNDESIRABLE TREE: One of the in Blue Game Ecologicus (Eurolypius Glooulus)

 1. Blue Game Ecologicus (Eurolypius Glooulus)

 2. Monterey Prine (Praus Radata)

 3. Monterey Oppress (Cupressus Macrocarpa)

 4. Coast Redwood (Sequios Sammerivens)

 5. Blackwood Acada (Acade Mislamouylon)

 6. Blackwood Acada (Acade Mislamouylon)

 6. Blackwood Acada (Acade Mislamouylon)

- If ANY DAMAGE TO PROTECTED TREE SHOULD OCCUR during or as result of work on the site, to contract belief or come shall prompt, shift has do of caudi damage. If sure proceedure, cannot be preserved in a health y state, the reviewing agency shall require the replacement of any probability terminody with another titted or teres on the same site deemed adequate to compensate of the took of the time that is removed.
- 7. CDEFANITION OF A PROTECTED TREE: Product those tot
 7. Com all property.
 A. Cossell Live Osk. (Outcrus Aprilola) measuring
 B. Heritage Trees
 C. Dedicated Trees
 C. Dedicated Trees
 C. Derivate undedwarkoped property, a tree measuring
 J. All trees and shrubs on oilly owned property
 4. No undestrable was its probeded thereity
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DIVISION 3 - CONCRETE

DIVISION 4 - MASONRY

DIVISION 5 - METALS

DIVISION 6 - WOOD, PLASTICS & COMPOSITES

- PRESSURE TREATED: Any area framed with pressure treated material, the connection hardware must be hot-dispect zino-coated. Fasteriers in preservative treated vivoid must be approved silicon bronze, or copper, stairfess steel or not-dispect zino-coated steel. This includes the foundation plates TREATED LUMBER: All wood, including posts, within 6 inches of the ground shall be pres or foundation-grade redwood.
- CUT OR NOTCHED WOOD: Any cut or notched wood shall be sealed with epoxy sealer.
- SOLES AND PALTES: Where jumbing healing or other pipes are placed in or partially placed in a partian, necessitating the culting of belief or plates, a meal fie not less than 16 gauge gelvanobad and 11/2" while seal the filterance to each plate across and to each side of the opening with not less state 11/2" while seal the filterance to each plate across and to each side of the opening with not less state 16/4 mais. FRE BLOCKING Provide fire ablocking at ceilings, floors, furnd down ceilings, showers, softles, and at conceased and openings not to exceed (if mannium. CBC 10%).

DIVISION 7 - THERMAL & MOISTURE PROTECTION

NSULATION NOTES INSULATION: Provide minimum R

. METAL FLASHING shall be

MOISTURE PROTECTION NOTES VAPOR BARRIER shall be roll-on urethane

- TUBSHOWER ENCLOSURE Provide cement, fizer-cement or glass mall gypsum backers (non-absorbent surface) for tile base in strowers & buts per CBC 25092, to a height of T2" minimum above the drain inlet. CBC 2011 and 2152 (but required where inlegral fiberglass units extending 72" above drain inlet are clearly specified on the plans).
- Install capillary break and vapor retarder at slab on grade foundations. (4.505.2)

EGRESS NOTES **DIVISION 8 - OPENINGS**

 EGRESS WINDOW: Every sleeping room shall be per CBC 1026: minimum net dear opening height of 24 inches. minimum net dear opening width of 20 inches. minimum net clear opening width of 20 inches. minimum net clear openable area of 5,7 sq. ft. maximum finished sill height of 44 inches.

GLASS NOTES GLASS: All glass shall conform with huma s as per CBC, 2406

DIVISION 9 - FINISHES

GENERAL FINISH NOTES

- TYPE "X" GYPSUM: Type "X" gypsum board is to be space under stairs.
- STUCCO: Provide 26-gauge (min) galvanized walls. PAINTING: Provide 1 coat primer and 2 finish weep screed at the foundation plate line at all stucco and exterior
- A minimum of 80% of the floor area receiving resilien ring shall comply with (Calgreen 4.504.4)
- Adhesives, sealants and caulks shall be compliant with VOC and other toxic compound limits, 4.504.2.1) with VOC limits. (Calgreen . (Calgre
- Aerosol paints and coatings shall be compliant with product weighted MIR limits for ROC and compounds. (Calgreen 4.504.2.3) Verification of compliance shall be provided.

- Carpet and carpet systems shall be compliant with VOC limits. (Calgreen 4.504.3)

- deboard, medium density fiberboard (MDF) and hardwood plywood used comply with low formaldehyde emission standards. (Calgreen 4.504.5)
- **DIVISION 10 SPECIALTIES** NOT USED
- **DIVISION 12 FURNISHINGS** DIVISION 11 - EQUIPMENT NOT USED
- **DIVISION 14 CONVEYING EQUIPMENT** DIVISION 13 - SPECIAL CONSTRUCTION NOT USED NOT USED

DIVISION 21 - FIRE SUPPRESSION NOT USED

DIVISION 22 - PLUMBING

NOT USED

NOT USED

NOT USED

- FIXTURE LOCATIONS: Confirm location of all fixtures and outlets with Architect
- PLUMBING VENTS: All new plumbing vents shall terminate not less than 3:-0" from any property vents must also terminate at least 4 below, 1" above, and 4" horizontally from any door or operativendow or at inets.
- SHOWER VALVES: Provide shower and tub-shower combinations with individual control pressure balance or the thermostatic mixing valve type. CPC 420.0 RELIEF VALVE: Provide water heater pressure/temperature relief valve with drain to outside of building or other approved location. CPC 608 No part of drain may be installed where it would be subject to freezing. CPC 608.5
- BACKFLOW PREVENTION: Provide a non-removable backflow pre-bibbs and lawn sprinkler/irrigation systems. CPC 603.4
- METAL WATER PIPING and other interior metal piping shall be bonded to the service equipment enclosure pursuant to CEC 250-80 (a) & (b). The points of attachments to the bonding jumper shall be
- SEISMIC ANCHORAGE: Provide seismic anchorage fo straps within the upper and lower one-third of unit, with I 510.5

NEW FIXTURE FLOW RATES per Calgreen 4.303.1 a. water closels: 1.2 gal./flush b. shower heads: 2.0 gal./min. c. lavatory faucets: 1.2 gal./min. d. kitchen faucets: 1.8 gal./min.

DIVISION 23 - HVAC

VENTILATION NOTES

- BATHACOMEXHAUST FANS shall be connected directly to cutside and be capable of 5 air changes to per hour, (DBC 1703) TERMINATION of all environmental air ducts shall be a minimum of 3-0° for any opening into the building. Exhaust air went to have back draft damper.
- PLLMBRG VENTS: All new plumbing vents shall terminate not less than 3-0" from any property lift vents must also terminate at least 4" below, i" above, and 4" horizontally from any door or operable window or air inet.

4.507.2. HVAC system enforcing agency must

CAD FIBS Fremont Road DRAWN BY: Mr

- Duct systems to be sized and designed, and equipment selected per Calgreen installers must be trained and certified and special inspectors employed by the be qualified per Calgreen 4.507.2.
- 3. VENT STRIP at roof-edge venting shall be Cor-a-vent RS-400, or equal
- INSECT SCREEN: All insect screen at eave vents shall be openings 1/4" in dimension, unless otherwise noted. GENERAL NOTES

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		ISSUES
MARK	DATE	DESCRIPTION
	7/02/18	PLANNING SUBMISSION
	2/04/19	PLANNING SUBMISSION
	4/04/19	PLANNING SUBMISSION
	7/26/19	PLANNING SUBMISSION
	2/24/2020	PLANNING SUBMISSION
	9/24/2020	PLANNING SUBMISSION

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A.P.N 012-043-11 &12 52/54 Fremont Street San Rafael CA 94965 A.P.N.: 012-043-11 & 12

Owner: Pacific Private Money Fund I, LLC Et Al c/o Mark Hanf, Manager 1555 Grant Ave. Novato, CA 94945

495 Gate 5 Rd. Studio E

Arterberry

- KITCHEN CIRCUIT: Provide at least two separate 20 amp circuits for small appliances in kitchen, pantry, drining room and similar areas, with no other outlets on the circuits. CEC 210-11 (c)(1), 210-52 (b)
- LAUNDRY CIRCUIT: Provide a dedicated 30-amp circuit serving dryer in addition to one separate 20-amp circuit serving other laundry appliances. CEC 220-4(c)
- 5. BATH OUTLETS: Provide at least one 20 amp circuit for bathroom outlets with no other outlets on the
- 6. CLOTHES CLOSET LAMPS. Light fixture clearances shall conform to CEC 410-8.
- 7 I LUMINAIRE FEFICACY All installed luminaires shall be high-efficacy. CEnerC 150 0(k)1 A
- 8. The following table defines high efficacy lighting CEnerC Table 150.0-A.

HIGH EFFICIENCY LIGHT SOURCES

Light sources other than those installed in ceiling recessed downlight luminaires, ar efficacy and are not required to comply with Reference Joint Appendix JA8.

1. Pin-based linear or compact fluorescent light sources using electronic ballasts

2. Pulse-start metal halide.

- Pulse-start metal naioe.
 High pressure sodium
 GU-24 sockets containing light sources other than LEDs
 Luminaires with hardwired high frequency generator and induction lamp
 Inseparable SSL luminaires othat are installed outdoors
 Inseparable SSL luminaires ordinaing octored light sources that are installed to provide

Light sources shall be certified to the Commission as High Efficacy Light Sources in accordance with

Light sources shall be certained to the Commission is right Tendacy Light Sources an accordance with Reference Joint Repoint USA and marked as in meeting JAA. Note that calling recessed downlight burniaries shall not have screw bases regardless of lamp type as described in Section 150.0(k)1C. 6. U3-4 socket containing LED light sources 10. Any light source not otherwise listed in the table and certified to the Commission as complying with Joint Appendix 8.

9 BATHROOMS GARAGE LAUNDRY & LITHLITY ROOM LIGHTING - At least one luminaire in each of

RECESSED LIGHTING FIXTURES shall be rated as air-tight (AT) and, when installed in an insulated ceiling, shall have an approved zero clearance insulation cover (IC). (2013 CA Title 24 Section 150)

LIGHT FIXTURES in tub or shower enclosures or other wet/damp locations shall be labeled "suitable for damp locations". CEC 410-4(a)

12. OUTLETS: In every habitable room an electrical outlet shall be installed so that no point along the floor line in a wall space is more than six feet measured horizontally, from any outlet in that space, including any wall space two feet or more in width, the wall space occupied by fixed panels in exterior walls, and fixed room dividers. NEC Article 210-52.

13. NEW OUTLETS (including receptacles, switches, lighting, and hard-wired smoke detectors) in bedrooms, hallways, living rooms, dining rooms, kitchens, and similar areas must be on circuits protected with a combination arc-fault breaker. (2013 CEC 210.12)

RECEPTACLES installed in the following locations must be GFCI protected: exterior, garage, bathrooms, and above the kitchen countertop. (2013 CEC 210.12).

LOAD CALCLATIONS: Contractor to submit electrical load calculations for the sizing of the electrical panels to the building department for approval prior to installation.

16. SMCKE DETECTORS: Smoke detectors shall be powered by building wiring with battery back-up. Provide smoke detectors in the following areas (as applicable): at each story and basement: - within each bedroom and centrally located in the condor or area giving access to each sleeping area. - in each room where non-bedroom celling heights exceed the hall celling height by more than 2.

17. CARBON MONOXIDE alarms are to be installed outside each bedroom per CRC 315.2

18. ALL 125 volt, 15- and 20- ampere receptacle outlets shall be listed tamper resistant receptacles per

DIVISION 31 - EARTHWORK

EXCAVATION NOTES

- Refer to architectural and structural drawings for exact dimensions: details of foundation systems: floor plans, etc.
- Utilities shown are diagrammatic and show only delivery to building, internal site utilities are not depicted. All work shall conform to respective utility company's specifications. Provide sleeve through walls as required to accommodate underground utilities.

GRADING NOTES

- Contractor shall verify existing contours and general site conditions and report any discrepancies to architect prior to start of work.
- 2. Grading shall be performed as recommended by the geotechnical investigation
- Unless noted otherwise, all retaining walls shall have a waterproof membrane on the backside: back fill
 with cushed rock and place a minimum 4" diameter perforated pipe at bottom. Provide positive
 drainage to safe discharge away from building. Provide cleanouts at dead ends and at turns greater
 than 45 degrees.
- 4. Provide sleeves through walls as necessary to accommodate all underground utilities.
- Provide slope of 5% (or 2% for impervious surfaces) within 10 feet of dwelling's foundations per CBC1804.3 and CGBC 4.106.3.

DIVISION 32 - EXTERIOR IMPROVEMENTS

DRAIN PIPE: Provide a 4 inch perforated pipe (holes down) Behind every retaining wall and perimeter footing set in drain rock. Provide clean-outs at dead ends and at turns greater than 45 degrees.

DIVISION 32 - EXTERIOR IMPROVEMENTS (continued)

Minimum Erosion/Sediment Control Measures For Small Construction Projects 1 -12-12-15 10

Clack with prior total Planting are in restrict the parameter of the param

not directly on soil.

"Use para-yeave blags, (or similar product) around <u>direct index</u> located both onsite and in gutter as a <u>leat line of defenses.</u>

10 Pilez port-porty near stabilized site entrance, behind the curb and away from gutters, atom drain index, and water both of the curb of the control of

as practical.

(13) Prevent equipment fluid leaks onto ground by placing drip pans or plastic tarps under equipment.

onstruction activities to reduce erosion potential. Sediment and erosion control shall be continually glout the rainy season (October 15st – April 15st) and must remain effective through the construction vases. Inspect and maintain Best Management Practices (BMPs) before and after rain events. Set

Wet Slope Lining Silt Fence rb 10 1d 4 4 4 Plan Type "Below Grade" Plan Type "Akese Grade" Site Entrance Concrete Washout

Catch Basins with If you require materials in alternative formats, please contact: 415-473-4381 voice/TTY or disabilityaccess@co.marin.ca.us

DIVISION 32 - EXTERIOR IMPROVEMENTS (continued)

A Guide to Straw Wattle Installation

Proper installation of the straw wattle is essential in order to insure the success of the product. Straw wattles are designed for low surface flows, not to exceed 1 ds for small areas. While they work well on stream banks, they should not be placed in the path of high water flow. On slopes, wattles should be installed on contour with a slight downward angle at the end of the row in order to however, straw wattles should always be installed in shallow tenches according to the guidelines given below. Running lengths of wattles should be abouted firmly to ensure no leakage at the abutments. Guidelines reparding vertical spacing are given below. The wattles should be produced successful to the ground according to the quickled success of the installation.

SPACING - DOWNSLOPE

Vertical spacing for slope installations should be determined by site conditions: slope gradient and soil type are the main factors.

A good rule-of-thumb is:

- 1:1 slopes = 10 feet apart 2-1 slones = 20 feet apart
- 3:1 slopes = 30 feet apart
 4:1 slopes = 40 feet apart, etc.

However, adjustments may have to be made for the soil type:

For soft, loamy soils - adjust the rows closer together.
 For hard, rocky soils - adjust the rows further apart.



TRENCHING
Use a hand tool such as a maddox or pick to score the ground. Using a shovel, dig the trench to the ose a naint too south as a meature or tip of the south are ground. Osing a showing the electric of the medded depth. Soil from excavating the trenches can be placed on the uphilit, or flow side, of the trench to be used during installation.

For soft, loamy soils: dig a 3-5 inch trench.

For hard, rocky soils: dig a 2-3 inch trench.

Lay the first straw wattle snugly in the trench. No daylight should be seen under the wattle. Pack

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- 20 foot wattle uses 5 stakes 12 foot wattle uses 4 stakes


Stakes should be driven through the middle of the wattle, leaving 2-3 inches of the stake protrucing above the wattle. A heavy sediment load will tend to pick the wattle up and could pull it off the stakes if they are driven down too but, I may be necessary to make a hole in the wattle with the pick end of your maddox in order to get the stake through the straw. When straw wattles are used for fat ground applications, drive the stakes straight down, when installing wattles on stopes, drive

Drive the first end stake of the second wattle at an angle toward the first wattle in order to help abut them tightly together. If you have difficulty driving the stake into extremely hard or rocky slopes, a pilot bar may be needed to begin the stake hole.

FLAT GROUND APPLICATIONS
For installations along sidewalks or behind curbs it may not be necessary to stake the wattles, however, trenches must still be dug. If you have not yet back-filled behind the sidewalk or curb, by the wattle snuggly against it first, then backfill behind the wattle. Your trench is donel For installations account storm darins and ninlest, trenches and staking will be needed.

Fit wattle in trench snugly up against the sidewalk or curb. Around storm drains or inlets, the wattle should be back 1–1% ft. and should direct water flow toward the angle of drainage. If all drainage angles into the inlet, snake the wattle all the way around the inlet, using more than one wattle if needed.

STANING
We recommend using wood stakes or willow cuttings, rather than metal pins, to secure the straw
wattles. Wood stakes will eventually bio-degrade, and willow cuttings will grow and provide extra
stabilization. Be sure to use a stake that is long enough to profrude several inches above the wattle:
18" is a good length for hard, rocky soil. For soft, loamy soil use a 24" stake for greater security. The diameter of the stake should be approximately 1" for ease of driving through the wattle.

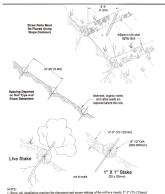

Arterberry

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PROJECT #: CAD RIME:Fremont Road - Main - 01-20 DRAWN BY: CHECKED BY: MNA

> GENERAL NOTES G-002

ABBREVIATIONS

AB ARCH	AGGREGATE BASE ARCHITECT (URAL)	HORZ	HORIZONTAL
BD	BOARD	INV	PIPE INVERT
BLDG BLK	BUILDING BLOCK	JT	JOINT TRENCH
BOT	BOTTOM BACK OF SIDEWALK	LF	LINEAR FOOT
BTWN BSL BW	BETWEEN BUILDING SETBACK LINE BOTTOM OF WALL	MMWD ME MAX MIN	MARIN MUNICIPAL WATER DISTRICT MATCH EXISTING MAXIMUM MINIMUM
CL CLR CO	CENTERLINE CLEAR (ANCE) CLEANOUT	NTS	NOT TO SCALE
CONC	CONCRETE CONSTRUCTION	OC	ON CENTER (S)
CONT	CONTINUOUS OR CONTINUE CUBIC YARD	PERF PL PT	PERFORATE (D) PROPERTY LINE POINT
DL DI DIM	DRAINLINE DROP INLET DIMENSION	PUE PVC	PUBLIC UTILITY EASEMENT POLYVINYL CHLORIDE
DS DW DWG	DOWNSPOUT DRIVEWAY DRAWING	RC RPBP	RELATIVE COMPACTION REDUCED PRESSURE BACKFLOW PREVENTS
EL EQ ESMT EX, EXIST EG EXT	ELEVATION EQUAL EASEMENT EXISTING EXISTING EXISTING EXTERIOR	S SCH SF SHT SQ SS SS SSCO	SLOPE SCHEDULE SQUARE FEET SHEET SQUARE SANITARY SEWER SANITARY SEWER CLEANOUT
FF FG FL FND FT	FINISHED FLOOR FINISHED GRADE FLOW LINE FOUNDATION FOOT	STD TC TEL TG TW	STANDARD TOP OF CURB TELEPHONE TOP OF GRATE TOP OF WALL
HDR HT	HEADER HEIGHT	TYP	TYPICAL
HP HP	HEIGHT HIGH POINT	UON	UNLESS OTHERWISE NOTED
		VERT	VERTICAL


GRADING NOTES:


- ALL DOWNSPOUTS SHALL BE CONNECTED TO BE DRAIN LINEWITH A MINIMUM SLOPE OF 1% AND DISCHARGED INTO BIO-RETENTION AREA.
- STORM DRAIN PIPE SHALL BE RCP, PVC, OR HDPE (MEETING CALTRANS SECTION 64 SPECIFICATIONS)
- 3. CONTRACTOR SHALL VERIFY ALL QUANTITIES PRIOR TO BID.
- 4. REFER TO ANY GEOTECHNICAL RECOMMENDATIONS THAT MAY BE A PART OF THIS PROJECT.
- 5. ALL DISTURBED AREAS SHALL BE SEEDED WITH EROSION CONTROL SEED MIX, SEE SPECIFICATIONS FOR ADDITIONAL INFORMATION. VEGETATED SWALES SHALL USE THE SAME SEED MIX AND APPLICATION RATES.
- 6. OLANTITIES SHOWN ARE ESTIMATES ONLY. SITE CONDITIONS, RECOMMENDATIONS OF THE SOILS ENGINEER, MEANS AND METHODS, ETC. CAN RESULT IN SUSTAINTALLY DIFFERENT VALUES, CONTRACTOR SHALL BE RESPONSIBLE FOR THE ACTUAL VOLUME. EXCESS MATERIAL TO BE HAULED OF TO AN APPROVED SITE.

CUT 629 C.Y. CUT FILL 5 C.Y. FILL

TOTAL 624 C.Y. CUT


- PROVIDE POSITIVE DRAINAGE TO PREVENT PONDING OF WATER AT UNDER FLOOR AREA, USE 3° 0 SCH, 80 PVC DRAIN LINE THROUGH FOUNDATION FOOTING AT LOWEST CORNER WITH 1% MIN. SLOPE DISCHARGING INTO APPROPRIATE AREA. THESE DRAINS ARE SEPARATE FROM ANY FOUNDATION DRAINS.
- 8. SLOPE PAVING 2% MIN. AWAY FROM BUILDING.
- 9. PRIOR TO CONSTRUCTION VERIFY FOUNDATION SECTIONS WITH STRUCTURAL ENGINEERING PLANS.
- THE CONTRACTOR SHALL VERIFY THE NUMBER AND LOCATION OF STEPS AND LANDINGS IN THE FIELD PRIOR TO CONSTRUCTION.
- 11. ALL WORK WITHIN THE PUBLIC RIGHT-OF-WAY REQUIRES AN EXCAVATION/ENCROACHMENT PERMIT.
- 12. THE PROPERTY OWNER SHALL MAINTAIN THE DRAINAGE SYSTEM SUCH THAT DRAINAGE SYSTEM SHALL NOT ADVERSELY IMPACT THE NEIGHBORING PROPERTIES OR ANY NATURAL WATER COURSE.

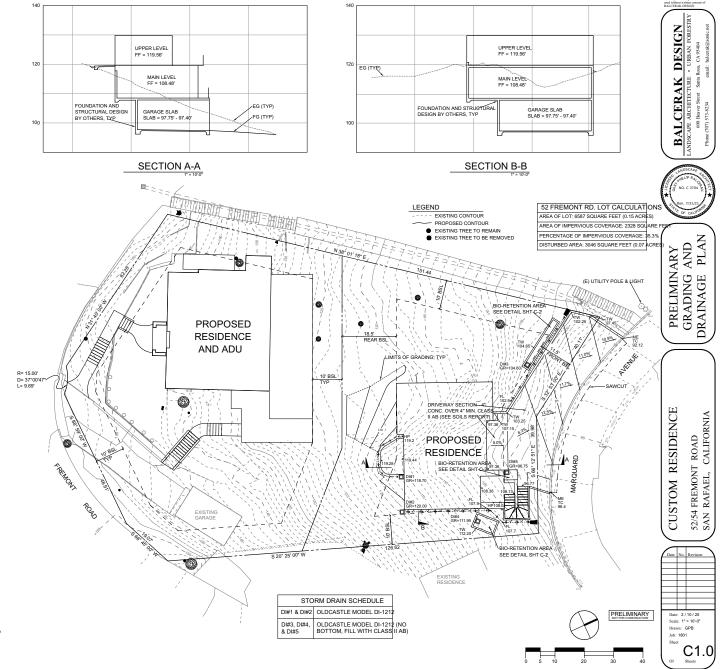

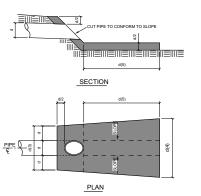



NOTES: 1. CLASS #3 ROCK, PLACE PER CALTRANS SECTION 72 METHOD B 2. SLOPES SHALL BE 1:1 MAXIMUM

STORM DRAINLINE OUTFALL DETAIL

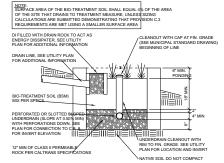

FLOW-THROUGH PLANTER DETAIL

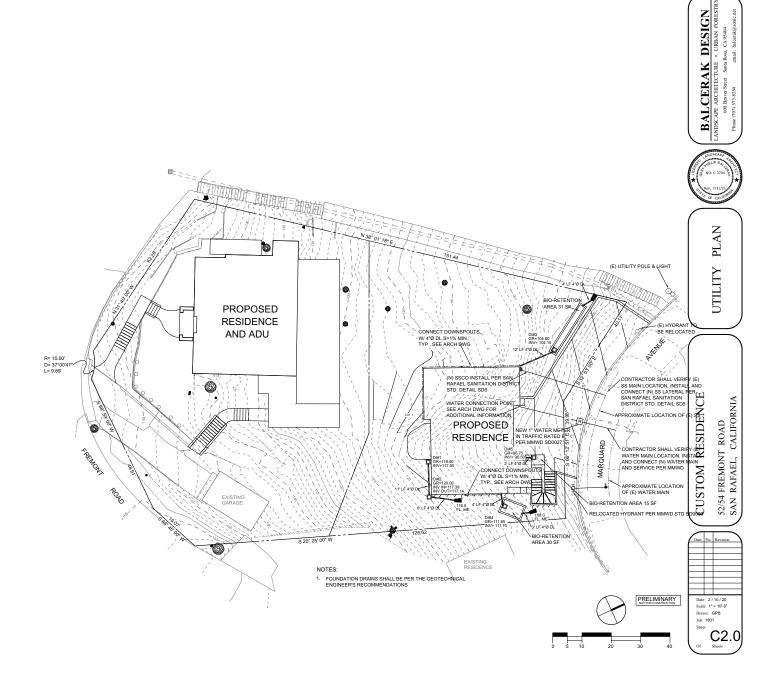

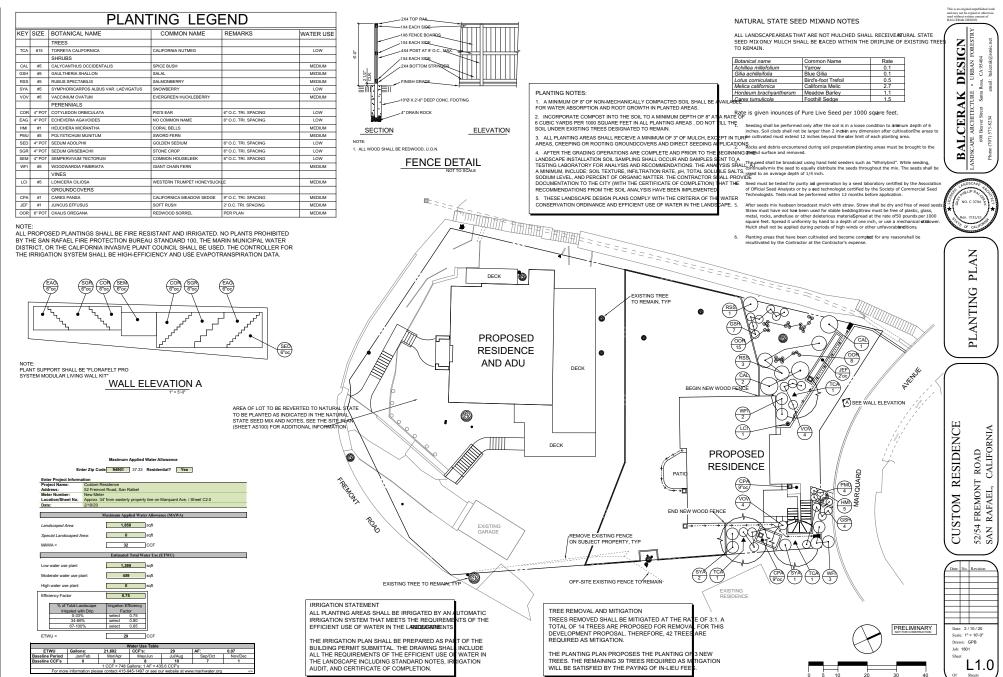

10:40 AM 2/20/20

TREES PROPOSED FOR REMOVAL

				SED I OIL		7 IL
Tree	Species	Diameter	Vigor	Structure	Status	Notes
5	Coast Redwood (Sequoia sempervire)hs	37.3"	Good	Fair	Remove	Has±3' high by 2 wide fire scar on downslope side offee. Cavity extends ±15' 2' inside, woundwood noted at edges of cav Tagged a #90.
6	Coast Redwood (Sequoia sempervire)ns	17.0"	Good	Fair	Remove	This tree has metalhook in the upper trunk with a bar through it and connects to tree #/ which also has a hook for the bappears to have been an old swing.
7	Coast Redwood (Sequia semperviren)s	18.8"	Good	Fair	Remove	Cavity noted on upslope side 2t6gh and 10 wide, ± 6" deep.
8	Coast Redwood (Sequoia sempervire)ns	23.2"	Good	Good	Remove	Many suckers at base, common for the specific No overt defects noted agged as #91.
9	Coast Redwood (Sequoia sempervire)ns	19.5"	Good	Good	Remove	Many suckers at base, common for the specific No overt defects noted.
10	Coast Redwood (Sequoia sempervire)ns	19.8"	Good	Good	Remove	Many suckers at base, common for the spe No overt defects oted. Tree has been used a a pole to attach old electrical wiring.
11	Coast Redwood (Sequoia sempervire)s	35.3"	Good	Good	Remove	Trunk bifurcates at 7 off steep grade. Many suckersat basecommon for the specialised a third trunk on the up slopaidethat was removed at ± 2.9ff grade no decay evident Old fire scar on downslope side of trunk, no decay evident.
13	Cherry Plum (Prunus cerasifer)a	8.2"	Fair	Poor	Remove	CaHPC has identified this tree as a species limited concern, and therefore removal is recommended.
14	Cherry Plum (Prunus cerasifer)a	10.7" at 14" off grade	Fair	Poor	Remove	Cal-IPC has identified this tree as a species of limited concern, and therefore removal is recommended.
15	Cherry Plum (Prunus cerasifer)a	5.2"	Good	Good	Remove	Cal-IPC has identified this tree as a species limited concern, and therefore removal is recommended.
16	CherryPlum (Prunus cerasifer)a	5.6"	Fair	Fair	Remove	Cal-IPC has identified this tree as a species limited concern, and therefore removal is recommended.
17	Coast Redwood (Sequoia sempervire)ns	9.5"	Fair/Poor	Good	Remove	Suppressed by Tree #16any suckersit base common for the species. No overt defects noted.
18	Coast Redwood (Sequoia sempervire)ns	26.3"	Good	Good	Remove	No overt defects note@dany suckers at base common for the species.
19	California Bay (Umbellularia californica)	4.2"; 7.3"; 3.2"	Fair	Poor	Remove	Tree once had many more trunks most hav been removedDecay on downslope side of t trunk. Thinly foliated largest trunk is growing towards proposed residend@his tree had becovered with lvy, but is has been killed off.

1. SEE ARBORIST'S REPORT PREPARED BY BALCERAK DESIGN, REVISED FEBRUARY 17, 2020

2. NO EXISTING TREE, DESIGNATED TO REMAIN, SHALL BE TRIMMED OR PRUNED WITHOUT PRIOR APPROVAL BY THE PROJECT ARBORIST.

3. NOTIFY PROJECT ARBORIST IN ANY CASE WHERE CONTRACTOR FEELS GRADING OR OTHER CONSTRUCTION CALLED FOR BY CONTRACT DOCUMENTS MAY DAMAGE EXISTING TREES THAT ARE SCHEDULED TO REMAIN.

4. FINAL LOCATION OF TREE PROTECTION FENCING SHALL BE DETERMINED BY FIELD STAKING OF THE IMPROVEMENTS, AND ADJUSTING FENCE TO PROVIDE MAXIMUM PROTECTION. FINAL LOCATION AND EXTENT OF FENCING SHALL BE APPROVED BY THE

PROJECT ARBORIST. FENCING SHALL REMAIN INTACT AND SHALL ONLY BE ALTERED WITH

FOR ADDITIONAL INFORMATION.

THE APPROVAL OF THE PROJECT ARBORIST.

TREE PROTECTION NOTES: THE TREE PROTECTION FENCING SHALL BE INSTALLED PRIOR TO STARTING ANY CONSTRUCTION ACTIVITY. THE TREE PROTECTION FENCE SHALL NOT BE ALTERED WITHOUT WRITTEN APPROVAL FROM THE PROJECT ARBORIST. DESIGN 2 NO PRIINING OF THE EXISTING TREES IS ANTICIPATED FOR THE CONSTRUCTION OF THIS 2. NO PROMING OF THE EASTING TREES IS AN INJERTALE FOR THE CONSTRUCTION OF THIS PROJECT. SHOULD PRUNING BE REQUIRED THE PROJECT ARBORIST SHALL BE NOTIFIED FOR APPROVAL PRIOR TO PERFORMING ANY PRUNING. TENSAR PLASTIC FENCING - CUT OR FOLD AT POSTS AS NEEDED TO CONFORM TO TERRAIN 3. THE CONTRACTOR SHALL BE RESPONSIBLE FOR INFORMING ALL SUBCONTRACTORS AND INDIVIDUALS WHO WILL BE WORKING ON SITE OF THE TREE PROTECTION REQUIREMENTS. CONDITIONS OF APPROVAL FOR THE PROJECT. BALCERAK ROOT PRUNING NOTES: ELECTRICAL TIES, TIE WIRE FLIP TIES OR EQUIVALENT 1. TREES LOCATED CLOSEST TO THE IMPROVEMENTS REQUIRE THE GREATEST I. THESE TOCKHED LOUGHST TO THEY ARE TO BE RETAINED LONG-TERM TO CARE DURING CONSTRUCTION IF THEY ARE TO BE RETAINED LONG-TERM TO PROVIDE THE GREATEST OPPORTUNITY TO PRESERVE THESE TREES, THE PROJECT ARBORIST SHOULD BE PRESERVE WHEN THE EXCAVATION OCURS, TO PROVIDE GUIDANCE TO THE CONTRACTOR AND TO OBSERVE THE EXTENT OF ROOT DAMAGE 2. WHERE INDICATED ON THE PLAN THE ROOT MASS OF TREES DESIGNATED TO REMAIN SHALL BE SEVERED WITH A ROOT PRINCER MACHINE WITH SHARP BLADES) TO A DEPTH DETERMINED BY PROJECT ARBORIST PRIOR TO GRADING. NOTE: STANDARD FARM QUALITY "T" POST, WITHOUT BLADES @ 8' O.C., MAX. 3. TO PREVENT ROOT DESICCATION USE MOIST BURLAP, OR OTHER APPROVED THE REPORT AND ADMINISTRATION OF THE REPORT AND ADMINISTRATION OF THE EXPOSED SIDE SURPACE. THIS ROOT PROTECTION FOR THE EXPOSED SIDE SURPACE. I OP PREVENT MOUT DESICCATION USE MOIST BURLAP, OR OTHER APPROVE MATERIAL, TO COVER THE EXPOSED SOIL SURFACE. THIS ROOT PROTECTION MATERIAL SHALL NOT BE ALLOWED TO DRY OUT AND SHALL REMAIN IN PLACE UNTIL FINAL BACKFILL OF THE SOIL OCCURS. 4. NO WOUND DRESSING OF ANY KIND SHALL BE APPLIED TO THE TREES TREE PROTECTION FENCE DETAIL PLAN TREE **PROPOSED** RESIDENCE AND ADU TREE PROTECTION FENCE, SEE DETAIL FOLLOW THE ROOT PRUNING NO FOR EXCAVATION IN THIS AREA RESIDENCE F ROAD CALIFORNIA PROPOSED RESIDENCE FREMONT | RAFAEL, C TREE PROTECTION CUSTOM 52/54] SAN I LEGEND - - - - EXISTING CONTOUR PROPOSED CONTOUR EXISTING TREE TO REMAIN ■ EXISTING TREE TO BE REMOVED PRELIMINARY NOT FOR CONSTRUCTION Scale: 1" = 10'-0" Drawn: GPB Job: 1801

		PLAN ⁻	TING LEGI	END	
KEY	SIZE	BOTANICAL NAME	COMMON NAME	REMARKS	WATER USE
		TREES			
TCA	#15	TORREYA CALIFORNICA	CALIFORNIA NUTMEG		LOW
		SHRUBS			
CAL	#5	CALYCANTHUS OCCIDENTALIS	SPICE BUSH		MEDIUM
GSH	#5	GAULTHERIA SHALLON	SALAL		MEDIUM
RSS	#5	RUBUS SPECTABILIS	SALMONBERRY		MEDIUM
SYA	#5	SYMPHORICARPOS ALBUS VAR. LAEVIGATUS	SNOWBERRY		LOW
VOV	#5	VACCINIUM OVATUM	EVERGREEN HUCKLEBERRY		MEDIUM
		PERENNIALS			
COR	4" POT	COTYLEDON ORBICULATA	PIG'S EAR	6" O.C. TRI. SPACING	LOW
EAG	4" POT	ECHEVERIA AGAVOIDES	NO COMMON NAME	6" O.C. TRI. SPACING	LOW
HMI	#1	HEUCHERA MICRANTHA	CORAL BELLS		MEDIUM
PMU	#5	POLYSTICHUM MUNITUM	SWORD FERN		MEDIUM
SED	4" POT	SEDUM ADOLPHII	GOLDEN SEDIUM	6" O.C. TRI. SPACING	LOW
SGR	4" POT	SEDUM GRISEBACHII	STONE CROP	6" O.C. TRI. SPACING	LOW
SEM	4" POT	SEMPERVIVUM TECTORUM	COMMON HOUSELEEK	6" O.C. TRI. SPACING	LOW
WFI	#5	WOODWARDIA FIMBRIATA	GIANT CHAIN FERN		MEDIUM
		VINES			
LCI	#5	LONICERA CILIOSA	WESTERN TRUMPET HONEYSUCK	LE	MEDIUM
		GROUNDCOVERS			
CPA	#1	CAREX PANSA	CALIFORNICA MEADOW SEDGE	9" O.C. TRI. SPACING	MEDIUM
JEF	#1	JUNCUS EFFUSUS	SOFT RUSH	2' O.C. TRI. SPACING	MEDIUM
OOR	6" POT	OXALIS OREGANA	REDWOOD SORREL	PER PLAN	MEDIUM

ALL PROPOSED PLANTINGS SHALL BE FIRE RESISTANT AND IRRIGATED. NO PLANTS PROHIBITED BY THE SAN RAFAEL FIRE PROTECTION BUREAU STANDARD 100, THE MARIN MUNICIPAL WATER DISTRICT, OR THE CALIFORNIA INVASIVE PLANT COUNCIL SHALL BE USED. THE CONTROLLER FOR THE IRRIGATION SYSTEM SHALL BE HIGH-EFFICIENCY AND USE EVAPOTRANSPIRATION DATA.

NATURAL STATE SEED MIXAND NOTES

ALL LANDSCAPEAREAS THAT ARE NOT MULCHED SHALL RECEIVE ATURAL STATE SEED MIX ONLY MULCH SHALL BE PLACED WITHIN THE DRIPLINE OF EXISTING TREES TO REMAIN.

Botanical name	Common Name	Rate
Achillea millefolium	Yarrow	0.1
Gilia achilleifolia	Blue Gilia	0.1
Lotus corniculatus	Bird's-foot Trefoil	0.5
Melica californica	California Melic	2.7
Hordeum brachyantherum	Meadow Barley	1.1
Carey tumulicola	Foothill Sedge	1.5

Rate is given inounces of Pure Live Seed per 1000 square feet.

VEGETATION MANAGEMENT PLAN NARRATIVE

THIS SITE IS REMNANT OF A REDWOOD (SECLIDIA SEMPERVIRENS) FOREST, WITH CALIFORNIA RAY This 31 is a Reinwit OP A REUVIOU (SEQUID) AS SUPERVINEARY FOREST, WITH CALLPOWNLO SET (IMBELLULARIA CALIFORNICA) AS AN ASSOCIATE. DUE TO THE SHADED THE UNDERSTORY CONSISTS OF GRASSES AND FORES. THE SUBJECT PROPERTY HAS A NORTHEAST ASPECT SLOPE. IT APPEARS THAT THERE IS AMPLE SO IM MOSTURE AVAILABLE YEAR ROUND.

BECAUSE OF THE STAND OF TREES AND THE ASPECT ALL OF THE TREES HAVE NATURALLY LIMBED-UP THEIR CROWN, MOST TREES DO NOT EXHIBIT PERMANENT SCAFFOLD BRANCHES UNTIL ±25 ABOVE NATURAL GRADE. SOME OF THE TREES EXPOSED TO MORE HAVE BRANCHES LOWER, BUT ARE STILL ± 10' ABOVE NATURAL GRADE.

THE LANDSCAPE DESIGN IS CONSISTENT WITH THE MARIN MUNICIPAL WATER DISTRICT THE LANGUAGE DESIGN IS CONSISTENT WITH THE MARKING MUNICIPAL WAS LEVED SICK. REQUIREMENT, AND THE CITY OF SAN RAPAGE FOR LANGUAGE DESIGN, TO PROVIDE A MORE TRADITIONAL SUBURBAN FRONT YARD ORNAMENTAL PLANTS INCLIDING TREES, SHRINGS PERENNIAS, AND GROUNDCOVERS HAVE BEEN USED. NO LANGUAGHING IN THE REAR YARD IS PROPOSED AT THIS TIME, HOWEVER ALL FUTURE LANDSCAPING SHALL BE CONSISTENT WITH THE REQUIREMENTS OF THIS PLAN AND APPLICABLE FIRE STANDARDS.

LONG TERM MAINTENANCE SCHEDULES AND GOALS.

ALL TREE LIMBS OVER 2" DIAMETER SHALL BE REMOVED 15'-20' ABOVE THE GROUND SURFACE.

ANY PORTION OF A TREE THAT IS WITHIN 10' OF A STOVEPIPE OR CHIMNEY SHALL BE REMOVED. NO DEAD OR DYING LIMBS SHALL BE ALLOWED TO OVERHANG ANY BUILDING. TREES THAT OVERHANG ROADWAYS SHALL BE PRUNED TO ASSURE A MINIMUM VERTICAL CLEARANCE OF 15'-0".

ALL COMBUSTIBLE DEBRIS. INCLUDING LEAVES. SHALL BE REMOVED FROM THE ROOF AND GUTTERS NO LESS THAN ONCE EVERY SIX MONTHS.

ALL WEEDS AND GRASSES SHALL BE MOWED REGULARLY; IN NO INSTANCE SHALL THEIR HEIGHT EXCEED 12".

ALL DEAD AND DYING VEGETATION WITHIN THE DEFENSIBLE SPACE ZONE SHALL BE REMOVED NO LESS THAN EVERY SIX MONTHS.

ALL MOTORIZED MAINTENANCE EQUIPMENT, INCLUDING SAWS AND MOWERS, SHALL BE EQUIPPED WITH SPARK ARRESTORS. EXERCISE CARE AND CHECK FOR ROCKS PRIOR TO MOWING TO PREVENT MOWER BLADES FROM SPARKING.

REFERENCES

KENT D. 2005 FIRESCAPING: CREATING FIRE-RESISTANT LANDSCAPES, GARDENS AND PROPERTIES IN CALIFORNIA'S DIVERSE ENVIRONMENTS. BERKELEY CA, WILDERNESS PRESS.

EAST BAY MUNICIPAL UTILITY DISTRICT, 2003. FIRESCAPE: LANDSCAPING TO REDUCE FIRE HAZARD. OAKLAND CA, ADMINISTRATION DEPARTMENT EBMUD.

PLANTING NOTES:

A MINIMUM OF 8" OF NON-MECHANICALLY COMPACTED SOIL SHALL BE FOR WATER ABSORPTION AND ROOT GROWTH IN PLANTED AREAS.

2. INCORPORATE COMPOST INTO THE SOIL TO A MINIMUM DEPTH OF 8" A A RATE OF 6 CUBIC YARDS PER 1000 SQUARE FEET IN ALL PLANTING AREAS . DO NOT SOIL UNDER EXISTING TREES DESIGNATED TO REMAIN

3. ALL PLANTING AREAS SHALL RECIEVE A MINIMUM OF 3" OF MULCH, EXCEPT IN TURF AREAS, CREEPING OR ROOTING GROUNDCOVERS AND DIRECT SEEDING A PLICATIONS.

4 AFTER THE GRADING OPERATIONS ARE COMPLETE AND PRIOR TO THE BEGINNING THE 4. AFTER THE GRADING OPERATIONS ARE COMPLETE AND FINDER TO THE DEGINNING THE LANDSCAPE INSTALLATION SOIL SAMPLING SHALL OCCUR AND SAMPLES SENT TO A TESTING LABORATORY FOR ANALYSIS AND RECOMMENDATIONS. THE ANALYSIS SHALL, AT A MINIMUM, INCLUDE: SOIL TEXTURE, INFILTRATION RATE, pH, TOTAL SOLUBLE SALTS, SODIUM LEVEL, AND PERCENT OF ORGANIC MATTER. THE CONTRACTOR SIALL PROVIDE DOCUMENTATION TO THE CITY (WITH THE CERTIFICATE OF COMPLETION). THAT THE RECOMMENDATIONS FROM THE SOIL ANALYSIS HAVE BEEN IMPLEMENTED.

5. THESE LANDSCAPE DESIGN PLANS COMPLY WITH THE CRITERIA OF T WATER CONSERVATION ORDINANCE AND EFFICIENT USE OF WATER IN THE LANI

Total Hazard Points 1

Minimum Horizontal Clearance Requirement in fe30' x 30' x 50'

DESIGN

BALCERAK


F ROAD CALIFORNIA


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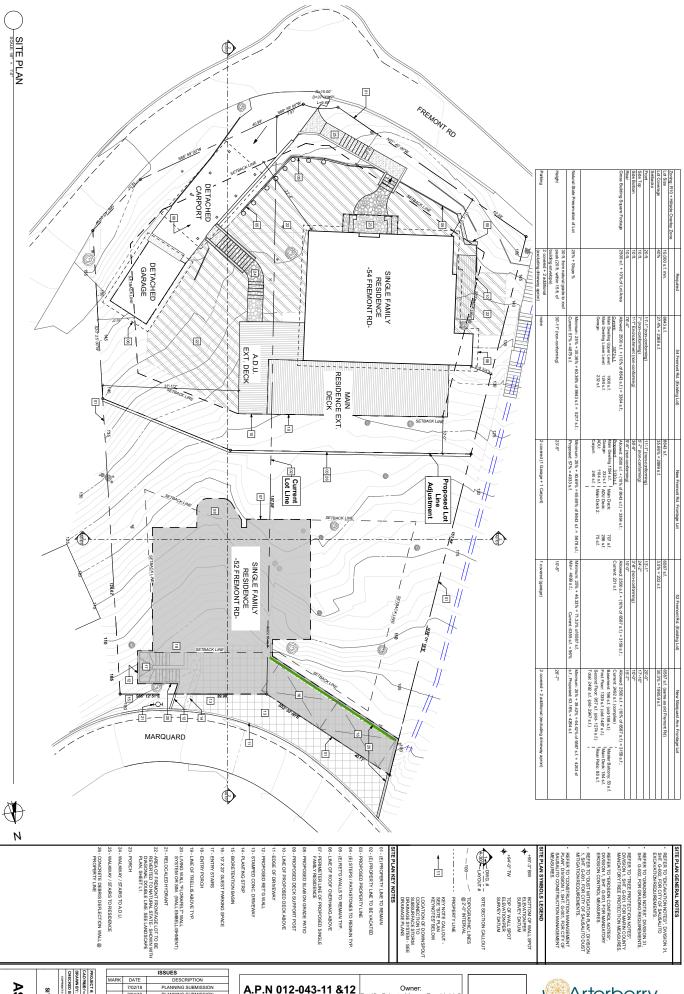
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Hazard Points

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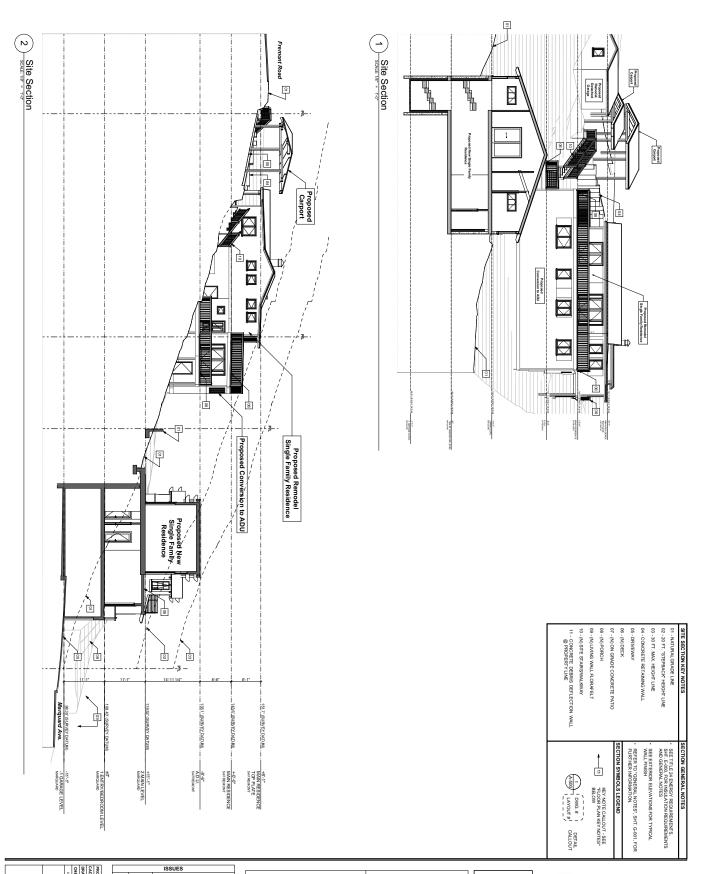


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MARK	DATE	DESCRIPTION
	7/02/18	PLANNING SUBMISSION
	2/04/19	PLANNING SUBMISSION
	4/04/19	PLANNING SUBMISSION
	7/26/19	PLANNING SUBMISSION
	2/24/2020	PLANNING SUBMISSION
	9/24/2020	PLANNING SUBMISSION

A.P.N 012-043-11 &12 52/54 Fremont Street San Rafael CA 94965 A.P.N.: 012-043-11 & 12 Owner: Pacific Private Money Fund I, LLC Et Al c/o Mark Hanf, Manager 1555 Grant Ave. Novato, CA 94945

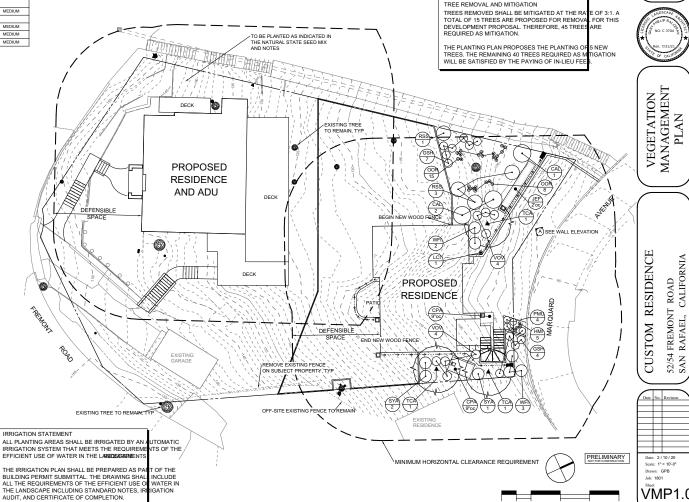

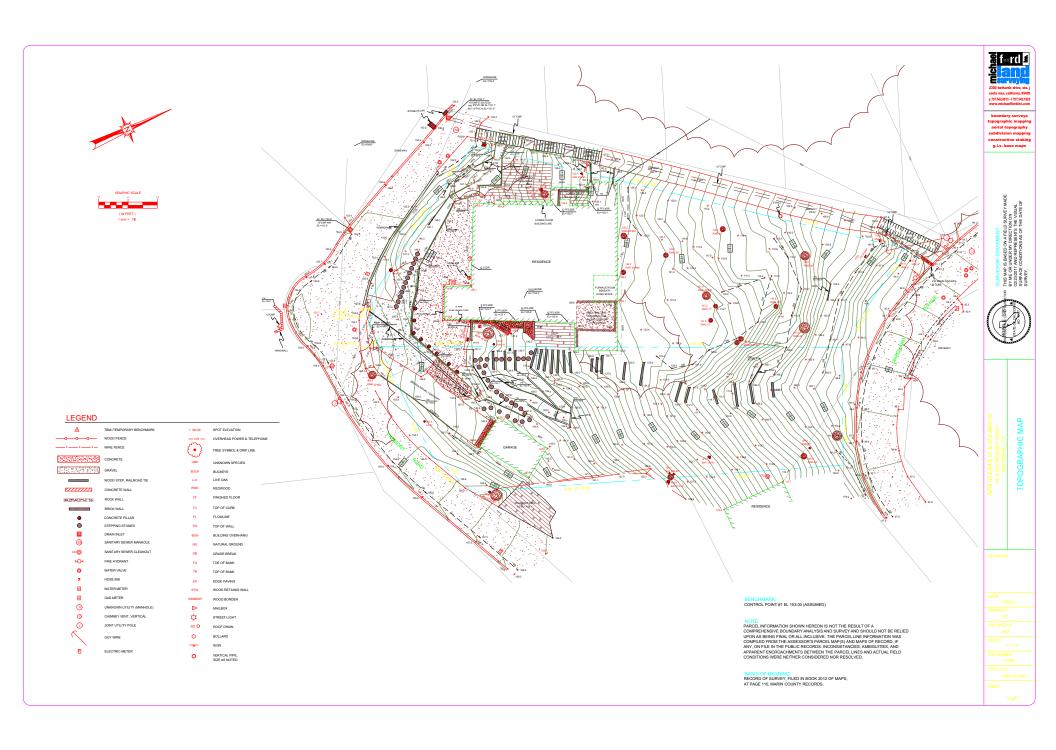


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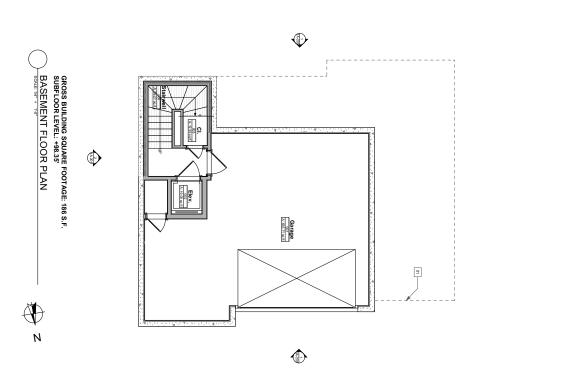
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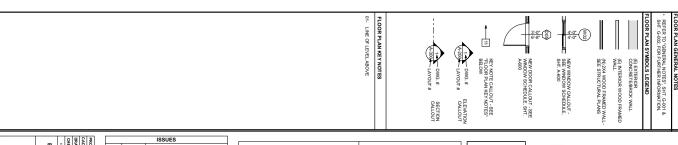
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	2/04/19	PLANNING SUBMISSION
	4/04/19	PLANNING SUBMISSION
	7/26/19	PLANNING SUBMISSION
	2/24/2020	PLANNING SUBMISSION
	9/24/2020	PLANNING SUBMISSION

A.P.N 012-043-11 &12

52/54 Fremont Street San Rafael CA 94965 A.P.N.: 012-043-11 & 12 Owner: Pacific Private Money Fund I, LLC Et Al c/o Mark Hanf, Manager 1555 Grant Ave. Novato, CA 94945



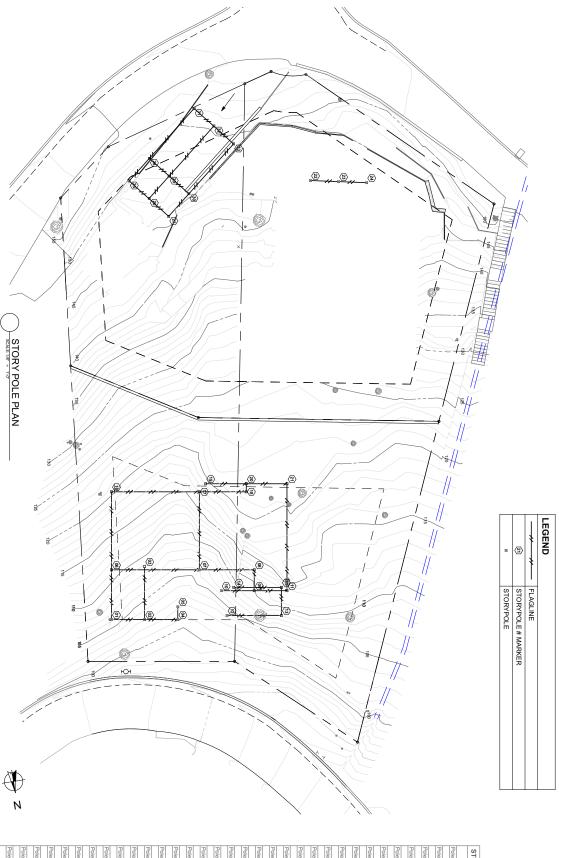



1A-100	BASEMENT FLOOR PLAN	COPYRIGHT 0 2018 ARTERBERRY DESIGN	CHECKED BY: MNA	DRAWNBY: MNA	CAD RIDE Fremont Road - Main - 01-2	PROJECT #: 18	
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MARK	DATE	DESCRIPTION
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	2/04/19	PLANNING SUBMISSION
	4/04/19	PLANNING SUBMISSION
	7/26/19	PLANNING SUBMISSION
	2/24/2020	PLANNING SUBMISSION
	9/24/2020	PLANNING SUBMISSION


A.P.N 012-043-11 &12 52/54 Fremont Street San Rafael CA 94965 A.P.N.: 012-043-11 & 12


Owner: Pacific Private Money Fund I, LLC Et Al c/o Mark Hanf, Manager 1555 Grant Ave. Novato, CA 94945



495 Gate 5 Rd, Studio E, Sausalito, CA 94965 Phone: 415 944-5480 M

Millard@Arterberry-Design.com

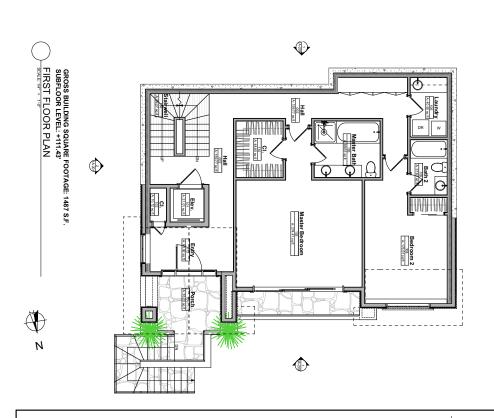

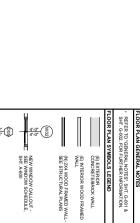

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1A-101	FIRST FLOOR PLAN	COPPRIGHT 0 2016 ARTERBERRY DE SIGN	CHECKED BY: MNA	DRAWN BY: MNA	CAD RIDE Fremont Road - Main - 01-2	PROJECT#: 180	

		ISSUES
MARK	DATE	DESCRIPTION
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	4/04/19	PLANNING SUBMISSION
	7/26/19	PLANNING SUBMISSION
	2/24/2020	PLANNING SUBMISSION
	9/24/2020	PLANNING SUBMISSION

A.P.N 012-043-11 &12

Owner: Pacific Private Money Fund I, LLC Et Al c/o Mark Hanf, Manager 1555 Grant Ave. Novato, CA 94945 52/54 Fremont Street San Rafael CA 94965 A.P.N.: 012-043-11 & 12




NEW DOOR CALLOUT - SEE A600 WOODW SCHEDLE, SHT.

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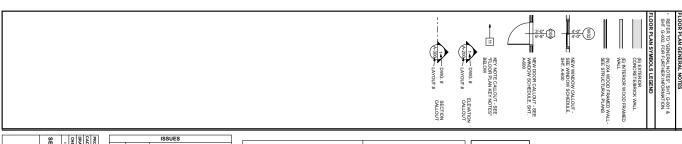
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SECTION

KEY NOTE CALLOUT - SEE "FLOOR PLAN KEY NOTES" BELOW





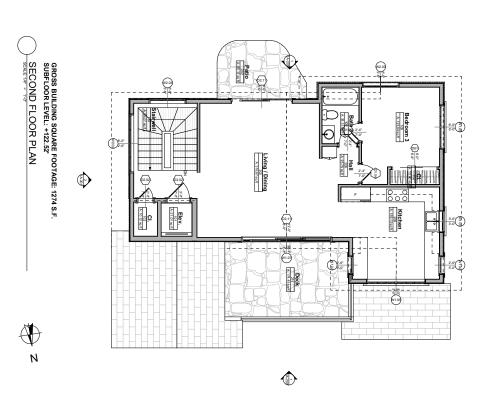

1A-	SECOND FLOOR PLAN	COPPRIGHT 0 2018 AL	CHECKED BY:	DRAWN BY:	CAD FINE Framont	PROJECT #:
-102	OOR PLAN	ALL MERCAL DE SIGN	MNA	MNA	nt Road - Main - 01-20-2	1805

MARK	DATE	DESCRIPTION
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	2/04/19	PLANNING SUBMISSION
	4/04/19	PLANNING SUBMISSION
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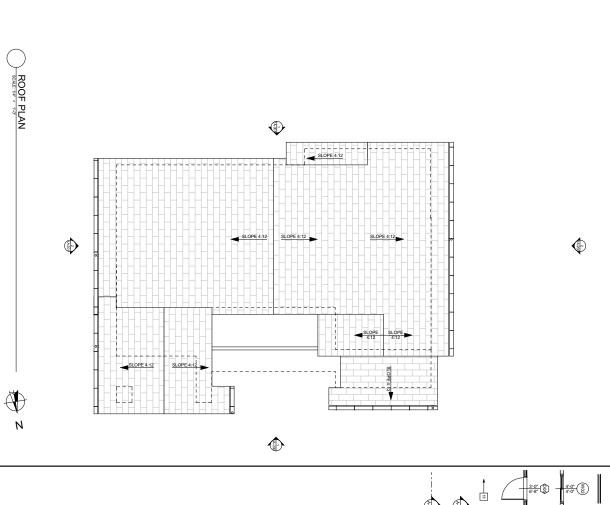
A.P.N 012-043-11 &12 52/54 Fremont Street San Rafael CA 94965 A.P.N.: 012-043-11 & 12

Owner: Pacific Private Money Fund I, LLC Et Al c/o Mark Hanf, Manager 1555 Grant Ave. Novato, CA 94945



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	7/26/19	PLANNING SUBMISSION
	2/24/2020	PLANNING SUBMISSION
	9/24/2020	PLANNING SUBMISSION

A.P.N 012-043-11 &12 52/54 Fremont Street San Rafael CA 94965 A.P.N.: 012-043-11 & 12

Owner: Pacific Private Money Fund I, LLC Et Al c/o Mark Hanf, Manager 1555 Grant Ave. Novato, CA 94945



495 Gate 5 Rd, Studio E, Sausalito, CA 94965 Phone: 415 944-5480 Millard@Arterbe





01- (E) GRADELINE
02- DRIVEWAY
03- LIVING WALL (GREEN WALL)
04- ENTRY STARS
05- PORCH
06- PATIOSLAB
07- DECK

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KEY NOTE CALLOUT - SEE "FLOOR PLAN KEY NOTES" BELOW

R ELEVATION SYMBOLS LEGEND

PROJECT K

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EXTERIOR ELEVATION

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		ISSUES
MARK	DATE	DESCRIPTION
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	7/26/19	PLANNING SUBMISSION
	2/24/2020	PLANNING SUBMISSION
	9/24/2020	PLANNING SUBMISSION

A.P.N 012-043-11 &12

52/54 Fremont Street San Rafael CA 94965 A.P.N.: 012-043-11 & 12 Owner: Pacific Private Money Fund I, LLC Et Al c/o Mark Hanf, Manager 1555 Grant Ave. Novato, CA 94945



EAST ELEVATION

SOME 1/4" = 1/0"

SOUTH ELEVATION

		ISSUES
MARK	DATE	DESCRIPTION
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	2/04/19	PLANNING SUBMISSION
	4/04/19	PLANNING SUBMISSION
	7/26/19	PLANNING SUBMISSION
	2/24/2020	PLANNING SUBMISSION
	9/24/2020	PLANNING SUBMISSION

A.P.N 012-043-11 &12 52/54 Fremont Street San Rafael CA 94965 A.P.N.: 012-043-11 & 12

Owner: Pacific Private Money Fund I, LLC Et AI c/o Mark Hanf, Manager 1555 Grant Ave. Novato, CA 94945




495 Gate 5 Rd, Studio E, Sausalito, CA 94965 Phone: 415 944-5480

07- DECK

03- LIVING WALL (GREEN WALL) 04- ENTRY STAIRS

Millard@Arterberry-Design.com

KEY NOTE CALLOUT - SEE "FLOOR PLAN KEY NOTES" BELOW

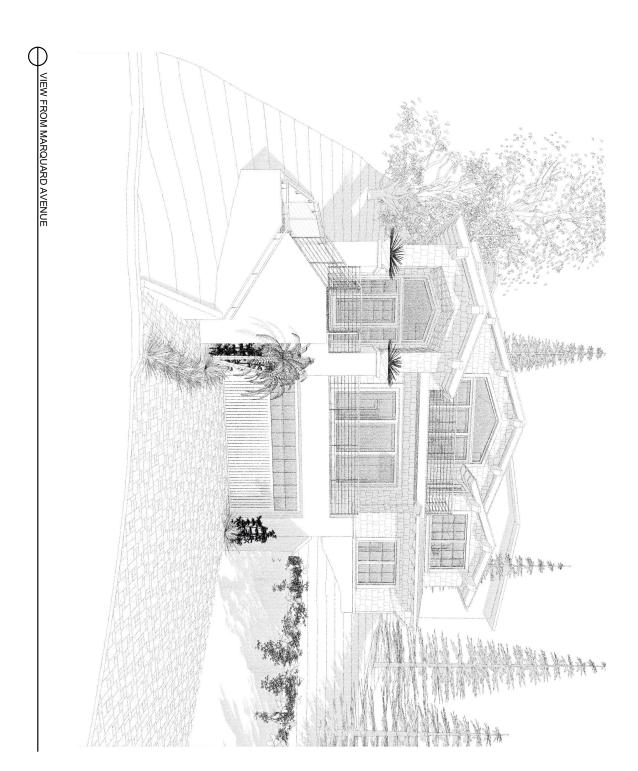




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	7/26/19	PLANNING SUBMISSION
	2/24/2020	PLANNING SUBMISSION
	9/24/2020	PLANNING SUBMISSION

A.P.N 012-043-11 &12

52/54 Fremont Street San Rafael CA 94965 A.P.N.: 012-043-11 & 12 Owner: Pacific Private Money Fund I, LLC Et Al c/o Mark Hanf, Manager 1555 Grant Ave. Novato, CA 94945



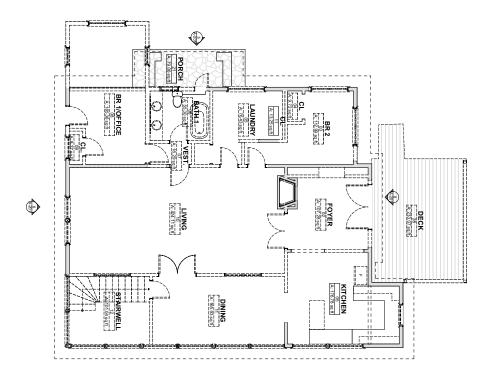



MOLITION PLAN SYMBOLS LEGENE KEY NOTE CALLOUT - SEE "DEMOLITION PLAN KEY NOTES" BELOW TO BE REMOVED (E) WALL TO BE DEMOLISHED (E) INTERIOR WALL TO REM (E) EXTERIOR WALL TO I

2AD-200	DEMOLITION MAIN RESIDENCE (UPPER FLOOR)	COMMISSION STOR WALLE OF LINCOLAND CO	CHECKED BY: MN.	DRAWN BY: MNA	CAD FINE Fremont Road - Main	PROJECT #:	
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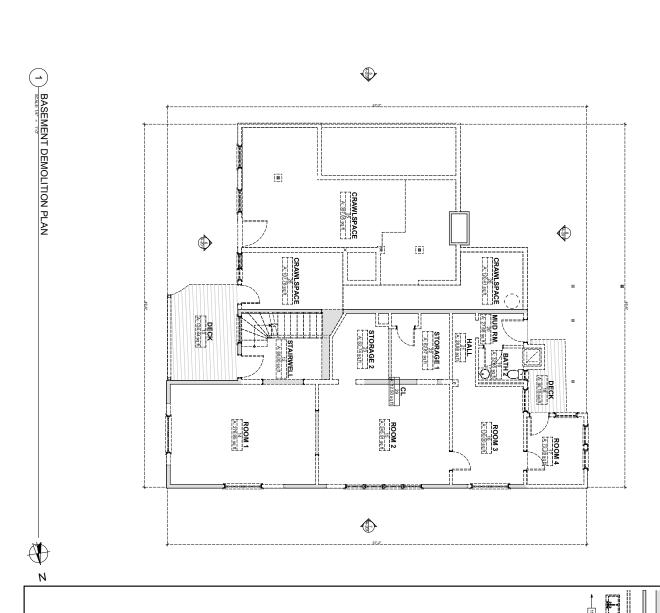
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MARK	DATE	DESCRIPTION
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	7/26/19	PLANNING SUBMISSION
	2/24/2020	PLANNING SUBMISSION
	9/24/2020	PLANNING SUBMISSION

A.P.N 012-043-11 &12 52/54 Fremont Street San Rafael CA 94965 A.P.N.: 012-043-11 & 12

Owner: Pacific Private Money Fund I, LLC Et Al c/o Mark Hanf, Manager 1555 Grant Ave. Novato, CA 94945



REFER TO "DEMOLITION NOTES", DIVISION SHT. G-001, FOR DEMOLITION REQUIREMEN



2AD-201

MARK	DATE	DESCRIPTION
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	2/04/19	PLANNING SUBMISSION
	4/04/19	PLANNING SUBMISSION
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	2/24/2020	PLANNING SUBMISSION
	9/24/2020	PLANNING SUBMISSION

ISSUES


A.P.N 012-043-11 &12 52/54 Fremont Street San Rafael CA 94965 A.P.N.: 012-043-11 & 12

Owner: Pacific Private Money Fund I, LLC Et AI c/o Mark Hanf, Manager 1555 Grant Ave. Novato, CA 94945



KEY NOTE CALLOUT - SEE "DEMOUTION PLAN KEY NOTES" BELOW TO BE REMOVED (E) WALL TO BE DEMOLISHED (E) INTERIOR WALL TO REM (E) EXTERIOR WALL TO

REFER TO "DEMOLITION NOTES", DIVISION SHT. G-001, FOR DEMOLITION REQUIREMEN MOLITION PLAN SYMBOLS LEGENI

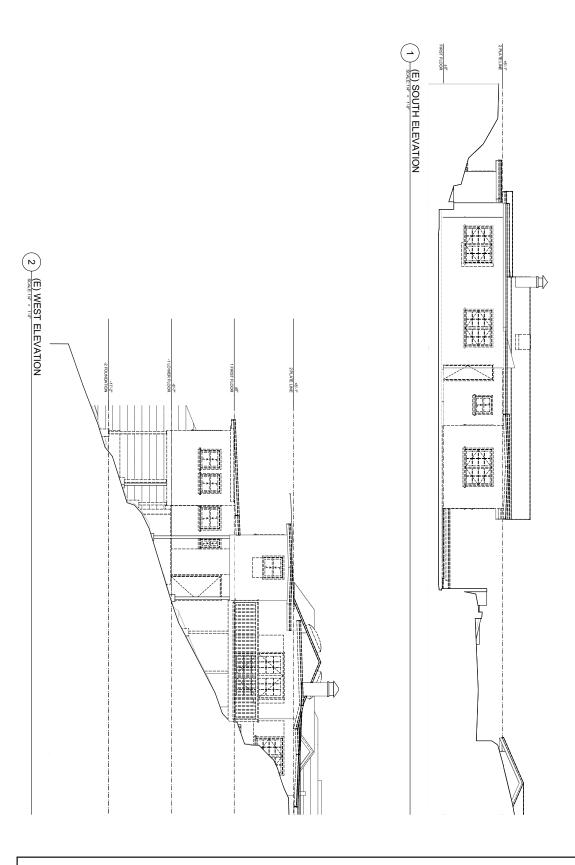

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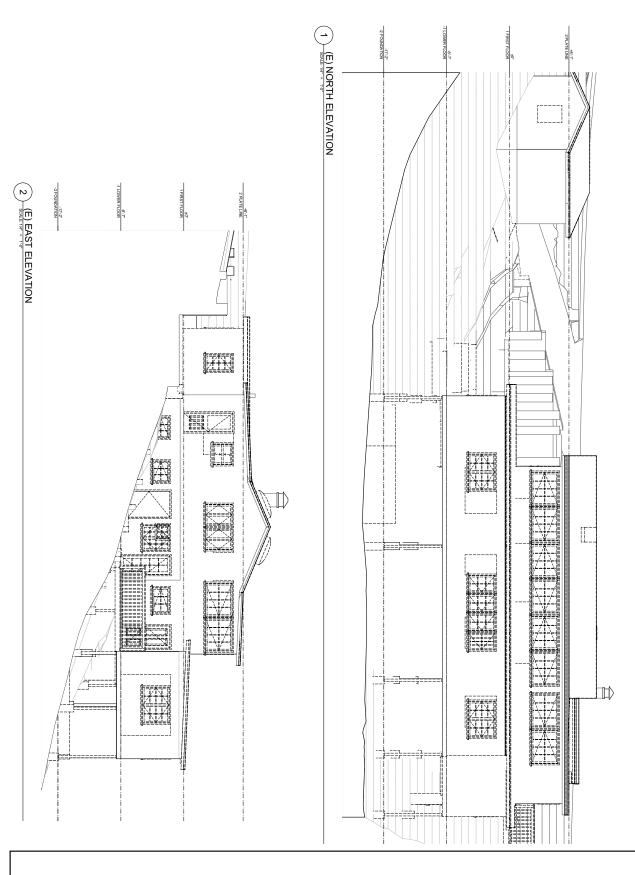
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	7/26/19	PLANNING SUBMISSION
	2/24/2020	PLANNING SUBMISSION
	9/24/2020	PLANNING SUBMISSION

A.P.N 012-043-11 &12 52/54 Fremont Street San Rafael CA 94965 A.P.N.: 012-043-11 & 12

Owner: Pacific Private Money Fund I, LLC Et Al c/o Mark Hanf, Manager 1555 Grant Ave. Novato, CA 94945





EXISTING ELEVATION SYMBOLS. LEGEND

EXISTING ELEVATION SYMBOLS. LE

2AD-203	EXISTING EXTERIOR ELEVATIONS	COPPRIGHT 0 2018 ARTERBERR	CHECKED BY: N	DRAWNBY: MNA	CAD RINE Fremont Road - M.	PROJECT #:	
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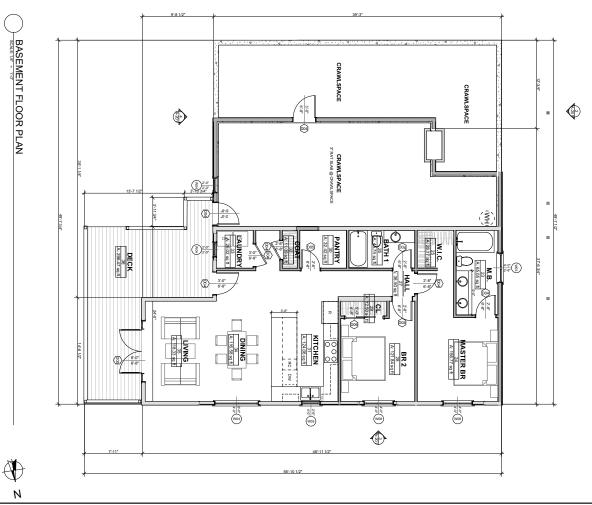
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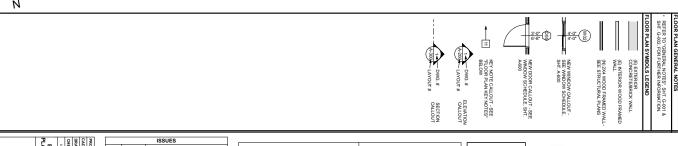
A.P.N 012-043-11 &12 52/54 Fremont Street San Rafael CA 94965 A.P.N.: 012-043-11 & 12

Owner: Pacific Private Money Fund I, LLC Et Al c/o Mark Hanf, Manager 1555 Grant Ave. Novato, CA 94945










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	MARK	DATE	DESCRIPTION
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		2/04/19	PLANNING SUBMISSION
		4/04/19	PLANNING SUBMISSION
		7/26/19	PLANNING SUBMISSION
		2/24/2020	PLANNING SUBMISSION
		9/24/2020	PLANNING SUBMISSION

A.P.N 012-043-11 &12 52/54 Fremont Street San Rafael CA 94965 A.P.N.: 012-043-11 & 12

Owner: Pacific Private Money Fund I, LLC Et AI c/o Mark Hanf, Manager 1555 Grant Ave. Novato, CA 94945



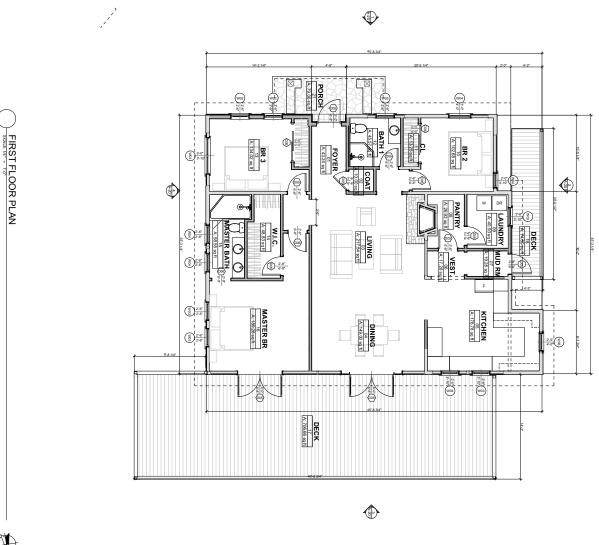

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RECERT TO CHEREAU NOTES

- RETER TO CHEREAU NOTES SHIT GOAD &
FILOOR PLAN SYMBOLS LEGEND

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2A-101	FIRST FLOOR PLAN - 54 FREMONT RD	COPYRIGHT 0 2018 ARTERBERRY DE SOA	CHECKED BY: MNA	DRAWN BY: MNA	CAD RINE Fremont Road - Main -	PROJECT #:
	N - 54	NOR B	۸		n - 01-20-2	1806

MARK	DATE	DESCRIPTION
	7/02/18	PLANNING SUBMISSION
	2/04/19	PLANNING SUBMISSION
	4/04/19	PLANNING SUBMISSION
	7/26/19	PLANNING SUBMISSION
	2/24/2020	PLANNING SUBMISSION
	9/24/2020	PLANNING SUBMISSION

A.P.N 012-043-11 &12 52/54 Fremont Street San Rafael CA 94965 A.P.N.: 012-043-11 & 12

2 Owner:
Pacific Private Money Fund I, LLC
Et Al c/o Mark Hanf, Manager
1555 Grant Ave.
Novato, CA 94945



495 Gate 5 Rd, Studio E, Sausalito, CA 94965 Phone: 415 944-5480 M

Millard@Arterberry-Design.com

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RECENTION BELLEVINOUS SET CALLOUT SEE WINDOW SCHEDULE. SHT. ABOU DOWN SCHEDULE. SHT. ABOU SCHEDU

2A-	ROOF PLAN - 54 FREMONT RD	COPPRIGHT 0 2018 AJ	CHECKED BY:	DRAWN BY:	CAD FINE Fremont	PROJECT #:	
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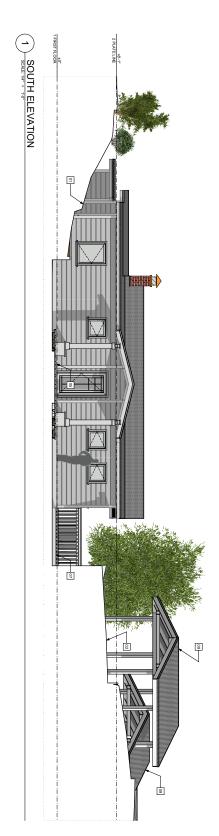
MARK	DATE	DESCRIPTION
	7/02/18	PLANNING SUBMISSION
	2/04/19	PLANNING SUBMISSION
	4/04/19	PLANNING SUBMISSION
	7/26/19	PLANNING SUBMISSION
	2/24/2020	PLANNING SUBMISSION
	9/24/2020	PLANNING SUBMISSION


A.P.N 012-043-11 &12 52/54 Fremont Street San Rafael CA 94965 A.P.N.: 012-043-11 & 12

Owner: Pacific Private Money Fund I, LLC Et Al c/o Mark Hanf, Manager 1555 Grant Ave. Novato, CA 94945



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EXTERIOR ELEVATIONNEY NOTES

ENTERIOR ELEVATI

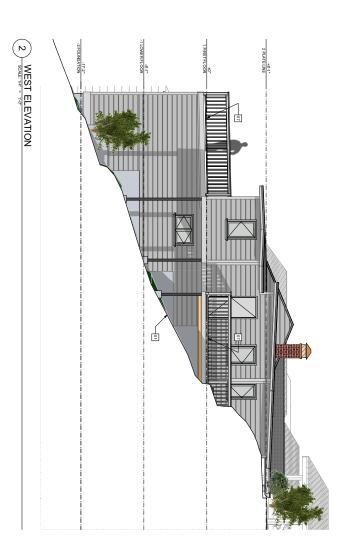
2A-200	PROPOSED EXTERIOR ELEVATIONS	COPYRIGHT © 2018 ARTH RESIDENT DE SIGN	CHECKED BY: MNA	DRAWN BY: MNA	CAD FIBUE Fremont Road - Main - 01-20-20	PROJECT#: 1806	-	

MARK	DATE	DESCRIPTION
	7/02/18	PLANNING SUBMISSION
	2/04/19	PLANNING SUBMISSION
	4/04/19	PLANNING SUBMISSION
	7/26/19	PLANNING SUBMISSION
	2/24/2020	PLANNING SUBMISSION
	9/24/2020	PLANNING SUBMISSION

A.P.N 012-043-11 &12 52/54 Fremont Street San Rafael CA 94965 A.P.N.: 012-043-11 & 12

Owner: Pacific Private Money Fund I, LLC Et AI c/o Mark Hanf, Manager 1555 Grant Ave. Novato, CA 94945



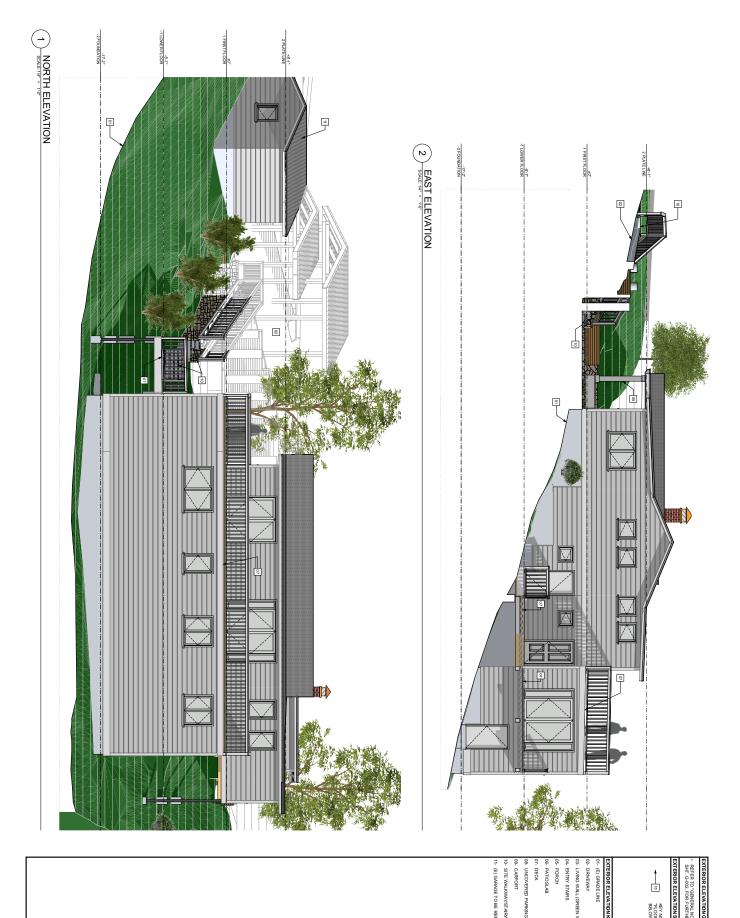

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MARK	DATE	DESCRIPTION
	7/02/18	PLANNING SUBMISSION
	2/04/19	PLANNING SUBMISSION
	4/04/19	PLANNING SUBMISSION
	7/26/19	PLANNING SUBMISSION
	2/24/2020	PLANNING SUBMISSION
	9/24/2020	PLANNING SUBMISSION

A.P.N 012-043-11 &12 52/54 Fremont Street San Rafael CA 94965 A.P.N.: 012-043-11 & 12

Owner: Pacific Private Money Fund I, LLC Et Al c/o Mark Hanf, Manager 1555 Grant Ave. Novato, CA 94945




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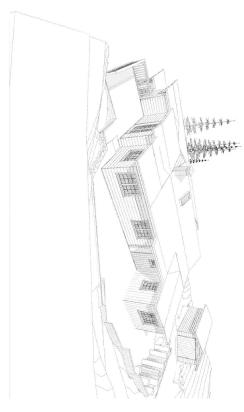
Millard@Arterberry-Design.com

KEY NOTE CALLOUT - SEE "FLOOR PLAN KEY NOTES" BELOW


EXISTING VIEW OF 54 FREMONT ROAD



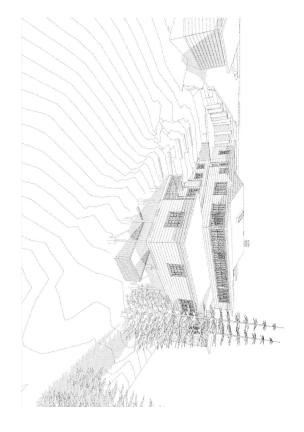




PROPOSED VIEW OF 54 FREMONT ROAD

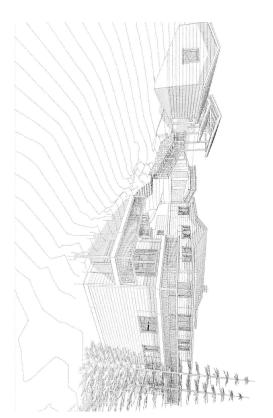

(2) PROPOSED VIEW FROM FREMONT ROAD

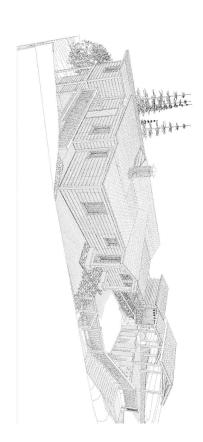

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RENDERINGS	REND
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ISSUES		
MARK	DATE	DESCRIPTION
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	2/04/19	PLANNING SUBMISSION
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A.P.N 012-043-11 &12

52/54 Fremont Street San Rafael CA 94965 A.P.N.: 012-043-11 & 12 Owner: Pacific Private Money Fund I, LLC Et Al c/o Mark Hanf, Manager 1555 Grant Ave. Novato, CA 94945

