

New Residence, Residence Remodel with New ADU & Lot Line Adjustment For:



A.P.N 012-043-11 &12

CITY OF SAN RAFAEL REGULATIONS	APPLICABLE CODES	PROJECT TEA	AM	PROJECT	DATA	SH	EET INDEX
2016 CALIFORNIA FIRE CODE: The design and construction of all site alterations shall comply with the 2019 California Fire Code (CFC Standards, and all applicable City of San Rafael Ordinances and Amendments. FIRE SPRINKLERS: Deferred submittals for the following fire protection systems shall be submitted to the Fire Prevention Bureau for a permitting prior to installation of the systems: Fire Sprinkler Plans (Deferred Submittal To The Fire Prevention Bureau) EROSION CONTROL: An erosion and sediment control plan shall be required prior to issuance of a grading or building permit. Erosion installed prior to work on the site, and maintained year round.	c), current NFPAAll work shall conform to the 2019 editions of the California Building Code (CBC): 2019 California Residential Code, 2019 California Plumbing and Mechanical Codes, 2019 California Green Code, 2019 California Energy Code and 2019 Electrical Code, complete with all applicable State of California amendments, codes and regulations for each edition including State of California Title 24, and San Rafael Municipal Code, and City of Sausalito Security Ordinance, and City of San Rafael Fire Ordinance.	DESIGNER:	Millard Arterberry Arterberry Design 495 Gate 5 Rd. Sausalito, CA 94965 (415) 944-5480 millard@arterberry-design.com Gary Balcerak Balcerak Design Landscape Architecture & Urban Forestry 608 Beaver Street Santa Rosa, CA 95404 (707) 573-8234 Balcerak@sonic.net	OWNER A.P.N. ZONING CONSTRUCTION TYPE	Pacific Private Money Fund I, LLC Et Al c/ o Mark Hanf, Manager 1555 Grant Ave. Novato, CA 94945 012-043-11 & 12 R-10 + Hillside Overlay V-B	VMP1 V00 AS100 AS101 AS102 1A-100	GRADING & DRAINAGE PLAN UTILITY PLAN PLANTING PLAN PLANTING PLAN TREE PLAN VEGETATION MANAGEMENT PLAN SURVEY SITE PLAN SITE SECTION STORY POLE PLAN BASEMENT FLOOR PLAN
A.B. ANCHOR BOLT A.C.T. ACOUSTICAL CEILING TILE A.F. ABOVE FINISHED FLOOR A.G. AGGREGATE A.L ALUMINUM A.L ALUMINUM A.L. ALTERNATE APPROXIMATE APPROXIMATE APPROXIMATE APPROXIMATE B.D. FIN. FOUNDATION ALT. ARCHITECTURAL ARCHITECTURAL B.D. BOARD BLDG. BUILDING BLK. BLOCK BLKG. BLOCKING BW. BEAM BEAM FRMG. FRAMING BW. BOTTOM OF WALL BW. BOTTOM OF WALL BW. BOTTOM BTW. BETWEEN BUILD INF BTW. BETWEEN FTG. FOOTING BULL SIZE BOT. BOTTOM BLUR. BUILT UP ROOF FURR. FURRING BULL SIZE BOT. BOTTOM FTG. FOOTING BULL SIZE PLUSTER PTD. FLOOR PTD. NOT TO SCALE AND NOM. NOMINAL N.T.S. NOT TO SCALE AND. NOM. NOMINAL N.T.S. NOT TO SCALE A.C. FIRE EXTINGUISHER CABINET O.D. OUTSIDE DIAMETER O.D. OPG. OPENING BLKG. BLOCKING FILR FLOOR OPP. OPPOSITE BW. BOTTOM OF WALL FS. FULL SIZE PL PROPERTY LINE BTW. BOTTOM OF WALL FS. FULL SIZE PL PLATE BOT. BOTTOM FTG. FOOTING PLWD. PLYWOOD BUND. PLYWOOD PTD. PAINTED C.J. CONTROL JOINT GA. GAUGE DEATH OF THE ALARM PTD. PAINTED DATE: DA	SCOPE OF WORK Lot Line Adjustment Between Two Lots: A.P.N.#'s 012-043-11 & 012-043-12 New Residence at Marquard Ave. Frontage Lot Remodel Residence at 52 Fremont Rd Lower Floor Plan of Existing 52 Fremont Residence to Become an ADU.					1A-102 1A-103 1A-200 1A-201 1A-300 2AD-200 2AD-201 2AD-202 2AD-203 2A-000 2A-100 2A-101 2A-102	FIRST FLOOR PLAN SECOND FLOOR PLAN ROOF PLAN EXTERIOR ELEVATIONS EXTERIOR ELEVATIONS BUILDING SECTIONS DEMOLITION MAIN RESIDENCE (UPPER FLOOR) DEMOLITION MAIN RESIDENCE (LOWER FLOOR) EXISTING EXTERIOR ELEVATIONS EXISTING EXTERIOR ELEVATIONS RENDERINGS BASEMENT FLOOR PLAN - 54 FREMONT RD FIRST FLOOR PLAN - 54 FREMONT RD ROOF PLAN - 54 FREMONT RD PROPOSED EXTERIOR ELEVATIONS
C.L CENTERLINE GALV GALVANIZED R. RISER C.C. CELING G.C. CELING G.C. CEMERAL CONTRACTOR R.D. RUN REFR. REFRISERATOR C.L. C	Ath St HOP To Jack in the Box Starbuck of	Church of Saint Raphael / Mission San Museum of International Propaganda Walgreens SMART San Rafael The Stand Sta	PROJECT LOCATION N State of the state of t			2A-201	PROPOSED EXTERIOR ELEVATIONS

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RESIDENTIAL DESIGN
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ito, CA 94965

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Owner:
Private Money Fund I, LLC
c/o Mark Hanf, Manager
1555 Grant Ave.
Novato, CA 94945

/54 Fremont Street Rafael CA 94965 N.: 012-043-11 & 12

 DATE
 DESCRIPTION

 7/02/18
 PLANNING SUBMISSION

 2/04/19
 PLANNING SUBMISSION

 4/04/19
 PLANNING SUBMISSION

 2/24/2020
 PLANNING SUBMISSION

 9/24/2020
 PLANNING SUBMISSION

 11/20/2020
 PLANNING SUBMISSION

PROJECT #:	1805						
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CHECKED BY:	MNA						
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DIVISION 1 - GENERAL REQUIREMENTS

GENERAL NOTES

- 1. RULES & REGULATIONS: All work shall conform to the 2016 editions of the California Building Code (CBC): 2016 California Residential Code, 2016 California Plumbing and Mechanical Codes, 2016 California Green Building Standards Code, 2016 California Energy Code and 2016 Electrical Code, complete with all applicable State of California amendments, codes and regulations for each edition including State of California Title 24, and San Rafael Municipal Code.
- 2. CONTRACTOR Shall be responsible for construction in conformance with the approved plans, specifications, and all code requirements under which the plans and specifications were approved.
- 3. ARCHITECTURAL DRAWINGS AND SPECIFICATIONS: In the case of an inconsistency between Architectural Drawings, Specifications and Calculations or within either document, the inconsistency shall be reported to the Architect prior to the Contractor commencing work. The better quality or greater quantity of Work shall be provided in accordance with the Architect's interpretation.
- 4. ENGINEERING DRAWINGS AND SPECIFICATIONS: In the case of an inconsistency between Architectural Drawings, Specifications and Calculations and Engineering/Consultant Drawings, Specifications and Calculations, between different Engineering/Consultant Documents, or within any document, the inconsistency shall be reported to the Architect prior to the Contractor commencing work. The better quality or greater quantity of Work shall be provided in accordance with the Architect/Engineer/Consultant's interpretation.
- 5. MEASUREMENTS: Do not scale drawings. Contractor shall verify all dimensions shown on the drawings, any discrepancy shall be reported to the Architect prior to commencement of related work.
- 6. Protect annular spaces around pipes, electric cables, conduits at exterior walls against the passage of rodents. (4.406.1)

DEMOLITION NOTES

- 1. Contractor shall carefully check the stability of all elements of the building before doing any work on or demolition to the existing structure. The contractor shall brace or strengthen any portions of the structure that may be weakened by demolition or construction activities. The contractor shall be solely responsible for jobsite safety and preservation of existing construction not slated for demolition.
- 2. All demolition and removal work shall conform to all applicable codes and regulations. The Contractor shall bear sole responsibility for identifying, testing and disposing of any hazardous materials encountered in the demolition process in accordance with all applicable codes, ordinances and regulations.
- 3. Contractor shall verify with owner or architect any item to be salvaged and reused. Damage to any such item will be the sole responsibility of the contractor.
- 4. Removal of wall finishes, floor finishes, and ceiling finishes shall include all material down to framing, exterior sheathing or subfloor.

DUST MITIGATION PLAN

- 1. The Contractor shall submit a satisfactory construction dust mitigation plan to the City. This plan shall specify the methods of control that will be utilized, demonstrate the availability of needed equipment and personnel, and identify a responsible individual who can modify construction activities should complaints be received by the City.
- 2. The construction dust mitigation plan shall, at a minimum, include the following: A. HIGH WINDS: Suspension of earthmoving or other dust-producing activities during periods of high winds when dust control measures are unable to avoid visible dust plumes. B. DUST PLUMES: Provide equipment and staffing for watering of all portions of the site subject to vehicle or equipment travel or disturbance. An appropriate dust palliative or suppressant, added to water before application would vary according to the moisture level of the soils on the site, but should be frequent enough to avoid visible dust plumes. C. STOCKPILES: Water or cover stockpiles of debris, soil, sand or other materials that can be blown
- D. SWEEP STREETS DAILY: of all mud and debris carried out from the site onto the adjacent road. since this material can be pulverized and later resuspended by vehicle traffic.

E. ALL MATERIALS TRANSPORTED BY TRCK shall be covered or wetted down prior to exiting the

F. FINAL GRADES shall be treated with an appropriate dust suppressant, covered or seeded as early as practical.

CONSTRUCTION MANAGEMENT PLAN

- 1. JOB SIGN: A sign shall be placed at the jobsite to notify the residence of the prime contractor and major subcontractor and related phone numbers.
- 2. CONSTRUCTION MANAGEMENT COORDINATOR: The name and phone number of a Construction Management Coordinator shall be posted at the site and shall be available to respond to complaints and questions from area residents.
- 3. HOURS OF OPERATION: Work at the site shall be limited to the hours of 8:00 AM to 4:30 PM, Mondays through Fridays, and 9:00 AM through 4:00 PM on Saturdays. No work shall be permitted on Sundays and Holidays without prior approval from the Community Development Agency.
- 4. CONSTRUCTION VEHICLES: All material deliveries and removal from the construction site shall follow a route, both to and from the site, agreed upon by the Community Development Agency and the Construction Management Coordinator. It is the Contractors responsibility to see that these locations and routes are adhered to.
- 5. TRAFFIC MANAGEMENT: vehicular traffic shall not be delayed for more than 5 minutes for more than four consecutive days. Access for emergency vehicles shall be maintained at all times (minimum 12-0 in width). Traffic management measures shall include the following: A. Traffic control measures such as flag persons, signage, etc. shall be utilized to ensure that vehicular traffic and pedestrian movement will continue to occur safely during construction periods. B. In the event of additional construction is occurring on the street it is the responsibility of both/all Contractors to coordinate all construction activities to avoid conflict in deliveries and/or construction activities. Coordination shall be made with the notification of the Public Works Department.
- 6. A minimum of 65% of the construction waste shall be diverted to recycling or salvage per Calgreen 4.106.3
- 7. Cover duct openings and other related air distribution component openings during construction (4.504.1)

RAILING NOTES

- 1. STAIRWAY HANDRAILS: Shall be mounted 34"-38" above the tread nosing and shall return to the wall or terminate into newel posts (CBC 1012.1). Handrail assemblies shall be able to resist a single concentrated load of 200 pounds (0.89 N), applied in any direction at any point along the top, and have attachment devices and supporting structure to transfer this loading to appropriate structural elements of the building. (CBC 1607.7.1.1).
- 2. GUARDRAILS shall be a minimum of 42" above walking surface and be in complete accordance with CBC 1013.2. Guardrail assemblies shall be able to resist a single concentrated load of 200 pounds (0.89 N), applied in any direction at any point along the top, and have attachment devices and supporting structure to transfer this loading to appropriate structural elements of the building. (CBC 1607.7.1.1).
- 3. PICKET SPACING: Open guards shall have balusters or ornamental patterns such that a 4 inch diameter sphere cannot pass through any opening. (CBC 1013.3)

STAIR NOTES

1. RISE AND RUN: The minimum tread dimension shall be 10 inches. The maximum riser shall be 7.75 inches with a maximum variation of 3/8 inch. (CBC 1009.3 1009.3.2)

GENERAL EXISTING CONDITION NOTES

EXISTING CONDITIONS: It is the contractors responsibility to verify all applicable existing conditions, including but not limited to water damage, termite damage, dry-rot, of any other framing or structural issues that may vary from those shown on the drawings, and report any discrepancies to the Architect prior to commencement of related work.

TREE PROTECTION NOTES

- 1. CONDITIONS OF APPROVAL FOR PROTECTING TREES DURING CONSTRUCTION: Adequate protection shall be provided during the construction period for any protected which are to remain standing. Measures deemed necessary by the reviewing agency in consideration of the size, species, condition & location of the protected trees to remain, may include any of the following:
- 2. PROTECTED PERIMETER: Before the start of clearing, excavation, construction or other work on the site, any "protected tree" deemed endangered by the work shall be securely fenced off at the "protected perimeter", which shall be either the outer limits of the branches of such protected tree (drip line) or such greater limits as may be established by the reviewing agency. Such fences shall remain in place for the duration of such work. All protected trees to be removed shall be clearly marked. A plan shall be established for the removal and disposal of logs, brush, earth and other debris which will avoid injury to any protected tree.
- 3. ENCROACHING ON THE PROTECTED PERIMETER: Where the proposed development or other site work will encroach upon the protected perimeter of any protected tree, special measures shall be taken to allow the roots to breathe and obtain water and nutrients. Any excavating, cutting, filling or compaction of the existing ground surface within the protected perimeter shall be minimized. No asphalt or other paving material shall be added. No change in the existing ground level shall occur within 4 feet of the base of any protected tree at any time. No burning or use of equipment with an open flame shall occur near or within the protected perimeter.
- 4. NO STORAGE OR DUMPING of oil, gas chemicals or other substances that may be harmful to trees shall occur within the protected perimeter of any protected tree, or any other location on site where the substances may enter the protected perimeter. No heavy construction equipment or construction materials shall be operated or stored within the protected perimeter. Wires shall not be attached to any protected tree, except as needed to support the tree. No sign, other than the tag showing the botanical classification, shall be attached to any protected tree.
- 5. BUILDUP OF DUST: Periodically during construction, the leaves of the protected trees shall be sprayed thoroughly with water to prevent buildup of dust of other pollution that would inhibit inspiration.
- 6. IF ANY DAMAGE TO PROTECTED TREE SHOULD OCCUR during or as a result of work on the site, the contractor, builder or owner shall promptly notify the city of such damage. If such protected tree cannot be preserved in a healthy state, the reviewing agency shall require the replacement of any protected tree removed with another tree or trees on the same site deemed adequate to compensate for the loss of the tree that is removed.
- 7. DEFINITION OF A PROTECTED TREE: Protect those trees listed below.
 - On all property:
 - Coastal Live Oak (Quercus Agrifolia) measuring 12" C.B.H. or larger Heritage Trees
 - Dedicated Trees
 - On private underddeveloped property, a tree measuring 12" C.B.H. or larger
 - All trees and shrubs on city owned property
- No undesirable tree is a protected tree
- 8. DEFINITION OF AN UNDESIRABLE TREE: One of the following. Blue Gum Eucalyptus (Eucalyptus Globulus)
- Monterey Pine (*Pinus Radiata*)
- Monterey Cypress (Cupressus Macrocarpa)
- Coast Redwood (Sequoia Semervirens)
- Blackwood Acacia (Acacia Melanoxylon)
- Bailey Acacia (Acacia Baileyana)
- Green Wattle (Acacia Aecurrens)

DIVISION 8 - OPENINGS

EGRESS NOTES

- 1. EGRESS WINDOW: Every sleeping room shall be provided with an emergency egress window or door
- minimum net clear opening height of 24 inches
- minimum net clear opening width of 20 inches.
- minimum net clear operable area of 5.7 sq. ft. maximum finished sill height of 44 inches.

GLASS NOTES

1. GLASS: All glass shall conform with human impact and safety requirements as per CBC. 2406

DIVISION 9 - FINISHES

GENERAL FINISH NOTES

- 1. TYPE "X" GYPSUM: Type "X" gypsum board is to be used at all walls and soffits of enclosed usable
- 2. PAINTING: Provide 1 coat primer and 2 finish coats of paint at all interior and exterior surfaces.
- 3. STUCCO: Provide 26-gauge (min) galvanized weep screed at the foundation plate line at all stucco
- 4. A minimum of 80% of the floor area receiving resilient flooring shall comply with (Calgreen 4.504.4)
- 5. Adhesives, sealants and caulks shall be compliant with VOC and other toxic compound limits. (Calgreer 4.504.2.1)

6. Paints, stains and other coatings shall be compliant with VOC limits. (Calgreen 4.504.2.2)

- 7. Aerosol paints and coatings shall be compliant with product weighted MIR limits for ROC and other toxic compounds. (Calgreen 4.504.2.3) Verification of compliance shall be provided.
- 8. Carpet and carpet systems shall be compliant with VOC limits. (Calgreen 4.504.3)
- 9. Particleboard, medium density fiberboard (MDF) and hardwood plywood used in interior finish systems shall comply with low formaldehyde emission standards. (Calgreen 4.504.5)

DIVISION 10 - SPECIALTIES

NOT USED

DIVISION 11 - EQUIPMENT

NOT USED

DIVISION 12 - FURNISHINGS

NOT USED

NOT USED

DIVISION 13 - SPECIAL CONSTRUCTION

DIVISION 14 - CONVEYING EQUIPMENT NOT USED

DIVISION 21 - FIRE SUPPRESSION NOT USED

DIVISION 5 - METALS

DIVISION 6 - WOOD, PLASTICS & COMPOSITES FRAMING NOTES

DIVISION 3 - CONCRETE

DIVISION 4 - MASONRY

- 1. TREATED LUMBER: All wood, including posts, within 6 inches of the ground shall be pressure treated or foundation-grade redwood.
- 2. PRESSURE TREATED: Any area framed with pressure treated material, the connection hardware must be hot-dipped zinc-coated. Fasteners in preservative treated wood must be approved silicon bronze, or copper, stainless steel or hot-dipped zinc-coated steel. This includes the foundation plates.
- 3. CUT OR NOTCHED WOOD: Any cut or notched wood shall be sealed with epoxy sealer.
- 4. SOLES AND PLATES: Where plumbing, heating or other pipes are placed in or partially placed in a partition, necessitating the cutting of soles or plates, a metal tie not less than 16 gauge galvanized and 1 1/2" wide shall be fastened to each plate across and to each side of the opening with not less than six 16d nails. FIRE BLOCKING: Provide fire blocking at ceilings, floors, furred down ceilings, showers, soffits, and at concealed draft openings not to exceed 10' maximum. CBC 708

DIVISION 7 - THERMAL & MOISTURE PROTECTION

INSULATION NOTES

1. INSULATION: Provide minimum R-13 insulation in all new walls and R-30 insulation in all new roofs.

FLASHING NOTES

METAL FLASHING shall be copper or galvanized steel, unless otherwise noted.

MOISTURE PROTECTION NOTES

- 1. VAPOR BARRIER shall be roll-on urethane membrane per Division7 (or approved equal).
- 2. TUB/SHOWER ENCLOSURE: Provide cement, fiber-cement or glass mat gypsum backers (nonabsorbent surface) for tile base in showers & tubs per CBC 2509.2, to a height of 72" minimum above the drain inlet. CBC 807.1 and 2512 (Not required where integral fiberglass units extending 72" above drain inlet are clearly specified on the plans).
- 3. Install capillary break and vapor retarder at slab on grade foundations. (4.505.2)
- 4. Check moisture content of building materials used in wall and floor framing before enclosure. (4.505.3)

DIVISION 22 - PLUMBING

PLUMBING NOTES

- FIXTURE LOCATIONS: Confirm location of all fixtures and outlets with Architect
- 2. PLUMBING VENTS: All new plumbing vents shall terminate not less than 3'-0" from any property line vents must also terminate at least 4' below, 1' above, and 4' horizontally from any door or operable window or air inlet.
- 3. RELIEF VALVE: Provide water heater pressure/temperature relief valve with drain to outside of building or other approved location. CPC 608 No part of drain may be installed where it would be subject to freezing. CPC 608.5
- 4. SHOWER VALVES: Provide shower and tub-shower combinations with individual control valves of the pressure balance or the thermostatic mixing valve type. CPC 420.0

5. BACKFLOW PREVENTION: Provide a non-removable backflow prevention device on all exterior hose

- bibbs and lawn sprinkler/irrigation systems. CPC 603.4 6. METAL WATER PIPING and other interior metal piping shall be bonded to the service equipment
- enclosure pursuant to CEC 250-80 (a) & (b). The points of attachments to the bonding jumper shall be accessible.
- 7. SEISMIC ANCHORAGE: Provide seismic anchorage for new and/or existing water heater tanks with straps within the upper and lower one-third of unit, with lower strap at least 4" above controls. CPC 510.5
- 8. NEW FIXTURE FLOW RATES per Calgreen 4.303.1:
- a. water closets: 1.28 gal./flush 2.0 gal./min. b. shower heads: 1.2 gal./min. c. lavatory faucets:

DIVISION 23 - HVAC

1.8 gal./min. d. kitchen faucets:

VENTILATION NOTES

- 1. BATHROOM EXHAUST FANS shall be connected directly to outside and be capable of 5 air changes per hour. (CBC 1203.3) TERMINATION of all environmental air ducts shall be a minimum of 3'-0" from any opening into the building. Exhaust air vent to have back draft damper.
- PLUMBING VENTS: All new plumbing vents shall terminate not less than 3'-0" from any property line vents must also terminate at least 4' below, 1' above, and 4' horizontally from any door or operable window or air inlet.

DUCTING NOTES

- 1. Duct systems to be sized and designed, and equipment selected per Calgreen 4.507.2. HVAC system installers must be trained and certified and special inspectors employed by the enforcing agency must be qualified per Calgreen 4.507.2.
- 3. VENT STRIP at roof-edge venting shall be Cor-a-vent RS-400, or equal.
- 4. INSECT SCREEN: All insect screen at eave vents shall be corrosion resistant metal mesh with mesh openings 1/4" in dimension, unless otherwise noted

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GENERAL NOTES

ELECTRICAL NOTES

- 1. GROUNDING ELECTRODE SYSTEM: Electrician shall provide and locate the grounding electrode system conforming to CEC 250-81.
- 2. SMOKE DETECTORS: Contractor shall verify the existence of or install smoke detectors and carbon monoxide detectors in accordance with state law, notes below, and drawings. Alarms shall receive their primary power from the building wiring and shall be equipped with a battery backup. Alarms in existing areas where access to the area of the ceiling is not possible may be powered by a D/C battery
- 3. KITCHEN CIRCUIT: Provide at least two separate 20 amp circuits for small appliances in kitchen, pantry, dining room and similar areas, with no other outlets on the circuits. CEC 210-11 (c)(1), 210-52
- 4. LAUNDRY CIRCUIT: Provide a dedicated 30-amp circuit serving dryer in addition to one separate 20-amp circuit serving other laundry appliances. CEC 220-4(c)
- 5. BATH OUTLETS: Provide at least one 20 amp circuit for bathroom outlets with no other outlets on the circuit. CEC 210-52(d).
- 6. CLOTHES CLOSET LAMPS. Light fixture clearances shall conform to CEC 410-8.
- 7. LUMINAIRE EFFICACY All installed luminaires shall be high-efficacy. CEnerC 150.0(k)1.A
- 8. The following table defines high efficacy lighting CEnerC Table 150.0-A.

HIGH EFFICIENCY LIGHT SOURCES

Light sources other than those installed in ceiling recessed downlight luminaires, are classified as high efficacy and are not required to comply with Reference Joint Appendix JA8.

- 1. Pin-based linear or compact fluorescent light sources using electronic ballasts
- 2. Pulse-start metal halide. 3. High pressure sodium
- 4. GU-24 sockets containing light sources other than LEDs
- 5. Luminaires with hardwired high frequency generator and induction lamp

these spaces shall be controlled by a vacancy sensor CEnerC 150.0(k)2.J.

Inseparable SSL luminaires that are installed outdoors 7. Inseparable SSL luminaires containing colored light sources that are installed to provide

decorative lighting

- Light sources shall be certified to the Commission as High Efficacy Light Sources in accordance with Reference Joint Appendix JA8 and marked as meeting JA8. 8. All light sources in ceiling recessed downlight luminaires. Note that ceiling recessed downlight luminaires shall not have screw bases regardless of lamp type as described in Section 150.0(k)1C.
- 9. GU-24 sockets containing LED light sources 10. Any light source not otherwise listed in the table and certified to the Commission as complying
- with Joint Appendix 8. 9. BATHROOMS, GARAGE, LAUNDRY & UTILITY ROOM LIGHTING - At least one luminaire in each of
- 10. RECESSED LIGHTING FIXTURES shall be rated as air-tight (AT) and, when installed in an insulated
- ceiling, shall have an approved zero clearance insulation cover (IC). (2013 CA Title 24 Section 150) 11. LIGHT FIXTURES in tub or shower enclosures or other wet/damp locations shall be labeled "suitable
- for damp locations". CEC 410-4(a) 12. OUTLETS: In every habitable room an electrical outlet shall be installed so that no point along the floor

line in a wall space is more than six feet measured horizontally, from any outlet in that space, including

- any wall space two feet or more in width, the wall space occupied by fixed panels in exterior walls, and fixed room dividers. NEC Article 210-52. 13. NEW OUTLETS (including receptacles, switches, lighting, and hard-wired smoke detectors) in
- bedrooms, hallways, living rooms, dining rooms, kitchens, and similar areas must be on circuits protected with a combination arc-fault breaker. (2013 CEC 210.12)

14. RECEPTACLES installed in the following locations must be GFCI protected: exterior, garage.

panels to the building department for approval prior to installation.

- bathrooms, and above the kitchen countertop. (2013 CEC 210.12). 15. LOAD CALCLATIONS: Contractor to submit electrical load calculations for the sizing of the electrical
- 16. SMOKE DETECTORS: Smoke detectors shall be powered by building wiring with battery back-up. Provide smoke detectors in the following areas (as applicable): - at each story and basement. - within each bedroom and centrally located in the corridor or area giving access to each sleeping area. - in each room where non-bedroom ceiling heights exceed the hall ceiling height by more than 2'.
- 17. CARBON MONOXIDE alarms are to be installed outside each bedroom per CRC 315.2
- 18. ALL 125 volt, 15- and 20- ampere receptacle outlets shall be listed tamper resistant receptacles per CEC 406.11

DIVISION 31 - EARTHWORK

EXCAVATION NOTES

- 1. Refer to architectural and structural drawings for exact dimensions: details of foundation systems: floor
- 2. Utilities shown are diagrammatic and show only delivery to building, internal site utilities are not depicted. All work shall conform to respective utility company's specifications. Provide sleeve through walls as required to accommodate underground utilities.

GRADING NOTES


- 1. Contractor shall verify existing contours and general site conditions and report any discrepancies to architect prior to start of work.
- 2. Grading shall be performed as recommended by the geotechnical investigation.
- 3. Unless noted otherwise, all retaining walls shall have a waterproof membrane on the backside: back fill with crushed rock and place a minimum 4" diameter perforated pipe at bottom. Provide positive drainage to safe discharge away from building. Provide cleanouts at dead ends and at turns greater than 45 degrees.
- 4. Provide sleeves through walls as necessary to accommodate all underground utilities.
- 5. Provide slope of 5% (or 2% for impervious surfaces) within 10 feet of dwelling's foundations per CBC1804.3 and CGBC 4.106.3.

DIVISION 32 - EXTERIOR IMPROVEMENTS

SITE DRAINAGE NOTES

1. DRAIN PIPE: Provide a 4 inch perforated pipe (holes down) Behind every retaining wall and perimeter footing set in drain rock. Provide clean-outs at dead ends and at turns greater than 45 degrees.

DIVISION 32 - EXTERIOR IMPROVEMENTS (continued)

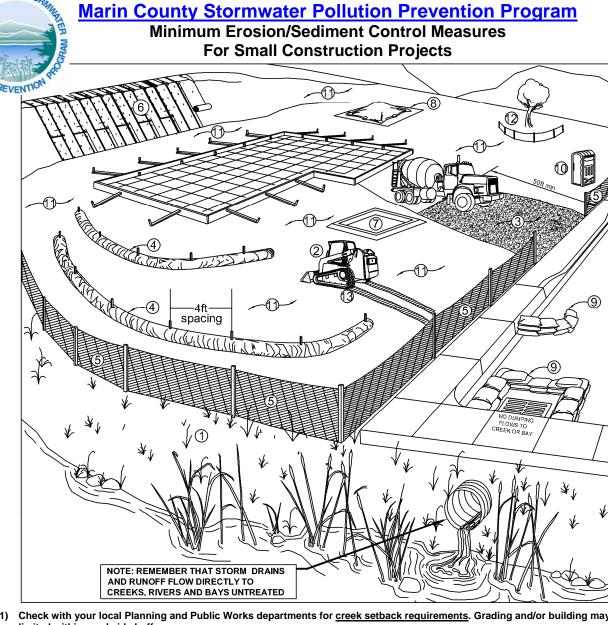

- (1) Check with your local Planning and Public Works departments for creek setback requirements. Grading and/or building may be limited within creekside buffers
- (2) During grading phase, track-walk up and down slopes (not parallel to them).
- (3) *Stabilize site entrance and temporary driveway use 3-4" crushed rock for a minimum of 50' (or as far as possible) to prevent tracking soil offsite. This can be used in conjunction with a tire wash or rumble plates
- (4) *Use straw wattles along contours of short slopes or slopes 3:1 or flatter, keyed into ground at least 3" deep (typically 25' apart). (5) *Install silt fence along contours as secondary measure to keep sediment onsite and to minimize vehicle and foot traffic beyond limits of site disturbance. Silt fencing must be keyed in.
- (6) *Install erosion control blankets (or equivalent) on any disturbed site with 3:1 slopes or steeper, keyed into the ground at least 3". (7) *Construct a concrete washout site adjacent to stabilized entrance. Clean as needed and remove at end of project.
- (8) Cover all stockpiles and landscape material and burm properly with straw wattles or sand bags. Keep behind silt fence, away from water bodies. Hazardous materials must be kept in closed containers that are covered and utilize secondary containment
- (9) *Use pea-gravel bags, (or similar product) around drain inlets located both onsite and in gutter as a last line of defense. (10) Place port-a-potty near stabilized site entrance, behind the curb and away from gutters, storm drain inlets, and water bodies.
- (11) Cover all exposed soil with straw mulch and tackifier (or equivalent) (12) Existing vegetation should be preserved as much as possible. Areas of disturbed soil/vegetation should be revegetated as soon
- (13) Prevent equipment fluid leaks onto ground by placing drip pans or plastic tarps under equipment.

Note: Schedule construction activities to reduce erosion potential. Sediment and erosion control shall be continually maintained throughout the rainy season (October 15th – April 15th) and must remain effective through the construction and landscape phases. Inspect and maintain Best Management Practices (BMPs) before and after rain events. *See reverse for detail drawings. Visit www.mcstoppp.org for more information on construction site management.

Extra strength filter fabric needed Mats/blankets should be installed vertically downslope Staple blankets sufficiently to Attach filter fabric side of post with wire support fence compacted backfill Silt fence shall be placed level along slope contours to maximize ponding efficiency with the ends curved uphill to Improve ability to retain water. Inspect and repair fence after each storm event and remove sediment when Erosion Blanket ecessary - 9" (225mm) maximum recommended storage height. Note: Actual layout determined in the fiel Removed sediment shall be deposited to off-site and can be permanently stabilized Silt Fence Installation Without Trenching NOT TO SCALE along contour -Supply Water to Wash — Min 50' (15m). The entrance shall be maintained to prevent sediment tracking or flowing onto public right-of-ways. This may require top dressing, repair and/or cleanout or other measures that trap sediment. When necessary, wheels shall be cleaned prior to entering public Type "Below Grade" When washing is required, it shall be done on an area stabilized with crushed stone that drains into an approved sediment trap or sediment basin. Rumble plates or tire wash can be added. Site Entrance **Concrete Washout** Gravel Bags

If you require materials in alternative formats, please contact: 415-473-4381 voice/TTY or disabilityaccess@co.marin.ca.us

(preferable to sand bags near inlets)

DIVISION 32 - EXTERIOR IMPROVEMENTS (continued)

A Guide to Straw Wattle Installation Proper installation of the straw wattle is essential in order to insure the success of the product. Straw wattles are designed for low surface flows, not to exceed 1 cfs for small areas. While they work well on stream banks, they should not be placed in the path of high water flow. On slopes, wattles should be installed on contour with a <u>slight</u> downward angle at the end of the row in order to prevent ponding at the mid-section. No overall slope preparation is needed prior to installation; however, straw wattles should <u>always</u> be installed in shallow trenches according to the guidelines given below. Running lengths of wattles should be abutted firmly to ensure no leakage at the abutments. Guidelines regarding vertical spacing are given below. The wattles should be pinned securely to the ground according to instructions in order to insure their stability and the success of the installation. <u>SPACING - DOWNSLOPE</u> Vertical spacing for slope installations should be determined by site conditions: slope gradient and soil type are the main factors.

A good rule-of-thumb is:

- 1:1 slopes = 10 feet apart • 2:1 slopes = 20 feet apart
- 3:1 slopes = 30 feet apart 4:1 slopes = 40 feet apart, etc.
- However, adjustments may have to be made for the soil type:
- For soft, loamy soils adjust the rows closer together.
- For hard, rocky soils adjust the rows further apart.

Use a hand tool such as a maddox or pick to score the ground. Using a shovel, dig the trench to the needed depth. Soil from excavating the trenches can be placed on the uphill, or flow side, of the trench to be used during installation.

- For soft, loamy soils: dig a 3-5 inch trench.
- For hard, rocky soils: dig a 2-3 inch trench.

Lay the first straw wattle snugly in the trench. **No daylight should be seen under the wattle.** Pack soil from trenching against the wattle on the uphill side. When installing running lengths of straw wattles, you must butt the second wattle tightly against the first wattle. DO NOT overlap the ends on top of each other. Overlapping behind each other has been done with some success. Stake the straw wattles at each end and four foot on center.

For example:

- 25 foot wattle uses 6 stakes
- 20 foot wattle uses 5 stakes 12 foot wattle uses 4 stakes

Stakes should be driven through the middle of the wattle, leaving 2-3 inches of the stake protruding above the wattle. A heavy sediment load will tend to pick the wattle up and could pull it off the stakes if they are driven down too low. It may be necessary to make a hole in the wattle with the pick end of your maddox in order to get the stake through the straw. When straw wattles are used for flat ground applications, drive the stakes straight down; when installing wattles on slopes, drive the stakes perpendicular to the slope.


Drive the first end stake of the second wattle at an angle toward the first wattle in order to help abut them tightly together. If you have difficulty driving the stake into extremely hard or rocky slopes, a pilot bar may be needed to begin the stake hole.

FLAT GROUND APPLICATIONS

For installations along sidewalks or behind curbs it may not be necessary to stake the wattles, however, trenches must still be dug. If you have not yet back-filled behind the sidewalk or curb, lay the wattle snuggly against it first, then backfill behind the wattle. Your trench is done! For installations around storm drains and inlets, trenches and staking will be needed.

Fit wattle in trench snugly up against the sidewalk or curb. Around storm drains or inlets, the wattle should be back 1-11/2 ft. and should direct water flow toward the angle of drainage. If all drainage angles into the inlet, snake the wattle all the way around the inlet, using more than one wattle if

We recommend using wood stakes or willow cuttings, rather than metal pins, to secure the straw wattles. Wood stakes will eventually bio-degrade, and willow cuttings will grow and provide extra stabilization. Be sure to use a stake that is long enough to protrude several inches above the wattle: 18" is a good length for hard, rocky soil. For soft, loamy soil use a 24" stake for greater security. The diameter of the stake should be approximately 1" for ease of driving through the wattle.

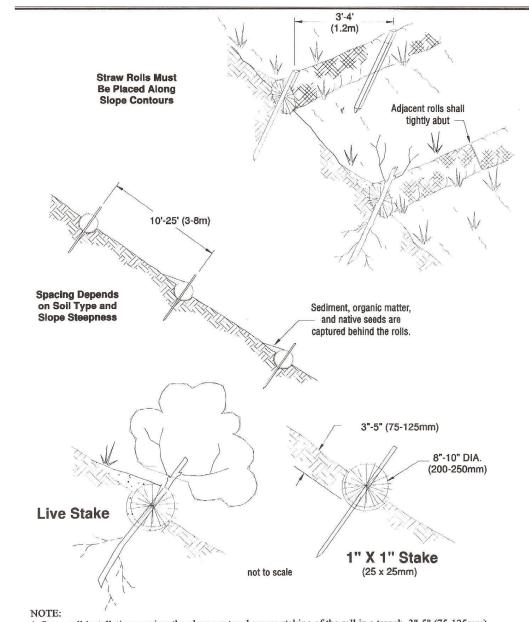

1. Straw roll installation requires the placement and secure staking of the roll in a trench, 3"-5" (75-125mm) deep, dug on contour. runoff must not be allowed to run under or around rol

2

0

7

0

PROJECT #: CAD18115E:remont Road22 - Main - 11-20-2020 DRAWN BY: **CHECKED BY:** COPYRIGHT © 2018 ARTERBERRY DESIGN

GENERAL NOTES

G-002

ABBREVIATIONS

AB ARCH	AGGREGATE BASE ARCHITECT (URAL)	HORZ	HORIZONTAL
BD	BOARD	INV	PIPE INVERT
BLDG BLK	BUILDING BLOCK	JT	JOINT TRENCH
BOT BS	BOTTOM BACK OF SIDEWALK	LF	LINEAR FOOT
BTWN BSL BW	BETWEEN BUILDING SETBACK LINE BOTTOM OF WALL	MMWD ME MAX MIN	MARIN MUNICIPAL WATER DISTRICT MATCH EXISTING MAXIMUM MINIMUM
CL CLR CO	CENTERLINE CLEAR (ANCE) CLEANOUT	NTS	NOT TO SCALE
CONC CONST	CONCRETE CONSTRUCTION	OC	ON CENTER (S)
CONT CY	CONTINUOUS OR CONTINUE CUBIC YARD	PERF PL	PERFORATE (D) PROPERTY LINE
DL DI DIM	DRAINLINE DROP INLET DIMENSION	PT PUE PVC	POINT PUBLIC UTILITY EASEMENT POLYVINYL CHLORIDE
DS D/W DWG	DOWNSPOUT DRIVEWAY DRAWING	RC RPBP	RELATIVE COMPACTION REDUCED PRESSURE BACKFLOW PREVENTER
EL EQ ESMT EX, EXIST EG EXT	ELEVATION EQUAL EASEMENT EXISTING EXISTING GRADE EXTERIOR	S SCH SF SHT SQ SS SSCO	SLOPE SCHEDULE SQUARE FEET SHEET SQUARE SANITARY SEWER SANITARY SEWER CLEANOUT
FF FG	FINISHED FLOOR FINISHED GRADE	STD	STANDARD
FL FND FT	FLOW LINE FOUNDATION FOOT	TC TEL TG TW	TOP OF CURB TELEPHONE TOP OF GRATE TOP OF WALL
HDR HT	HEADER HEIGHT	TYP	TYPICAL
HP	HIGH POINT	UON	UNLESS OTHERWISE NOTED
		VERT	VERTICAL

GRADING NOTES:


- 1. ALL DOWNSPOUTS SHALL BE CONNECTED TO A 4"Ø DRAIN LINE, WITH A MINIMUM SLOPE OF 1% AND DISCHARGED INTO BIO-RETENTION AREA.
- 2. STORM DRAIN PIPE SHALL BE RCP, PVC, OR HDPE (MEETING CALTRANS SECTION 64 SPECIFICATIONS)
- 3. CONTRACTOR SHALL VERIFY ALL QUANTITIES PRIOR TO BID.
- 4. REFER TO ANY GEOTECHNICAL RECOMMENDATIONS THAT MAY BE A PART OF THIS PROJECT.
- 5. ALL DISTURBED AREAS SHALL BE SEEDED WITH EROSION CONTROL SEED MIX, SEE SPECIFICATIONS FOR ADDITIONAL INFORMATION. VEGETATED SWALES SHALL USE THE SAME SEED MIX AND APPLICATION RATES.
- 6. QUANTITIES SHOWN ARE ESTIMATES ONLY. SITE CONDITIONS, RECOMMENDATIONS OF THE SOILS ENGINEER, MEANS AND METHODS, ETC. CAN RESULT IN SUBSTANTIALLY DIFFERENT VALUES. CONTRACTOR SHALL BE RESPONSIBLE FOR THE ACTUAL VOLUME. EXCESS MATERIAL TO BE HAULED OFF TO AN APPROVED SITE.

CUT 629 C.Y. CUT 5 C.Y. FILL TOTAL 624 C.Y. CUT

- 7. PROVIDE POSITIVE DRAINAGE TO PREVENT PONDING OF WATER AT UNDER FLOOR AREA. USE 3" Ø SCH. 80 PVC DRAIN LINE THROUGH FOUNDATION FOOTING AT LOWEST CORNER WITH 1% MIN. SLOPE DISCHARGING INTO APPROPRIATE AREA. THESE DRAINS ARE SEPARATE FROM ANY FOUNDATION DRAINS.
- 8. SLOPE PAVING 2% MIN. AWAY FROM BUILDING.

PRIOR TO CONSTRUCTION.

- 9. PRIOR TO CONSTRUCTION VERIFY FOUNDATION SECTIONS WITH STRUCTURAL ENGINEERING PLANS. 10. THE CONTRACTOR SHALL VERIFY THE NUMBER AND LOCATION OF STEPS AND LANDINGS IN THE FIELD
- 11. ALL WORK WITHIN THE PUBLIC RIGHT-OF-WAY REQUIRES AN EXCAVATION/ENCROACHMENT PERMIT.
- 12. THE PROPERTY OWNER SHALL MAINTAIN THE DRAINAGE SYSTEM SUCH THAT DRAINAGE SYSTEM SHALL NOT ADVERSELY IMPACT THE NEIGHBORING PROPERTIES OR ANY NATURAL WATER COURSE.

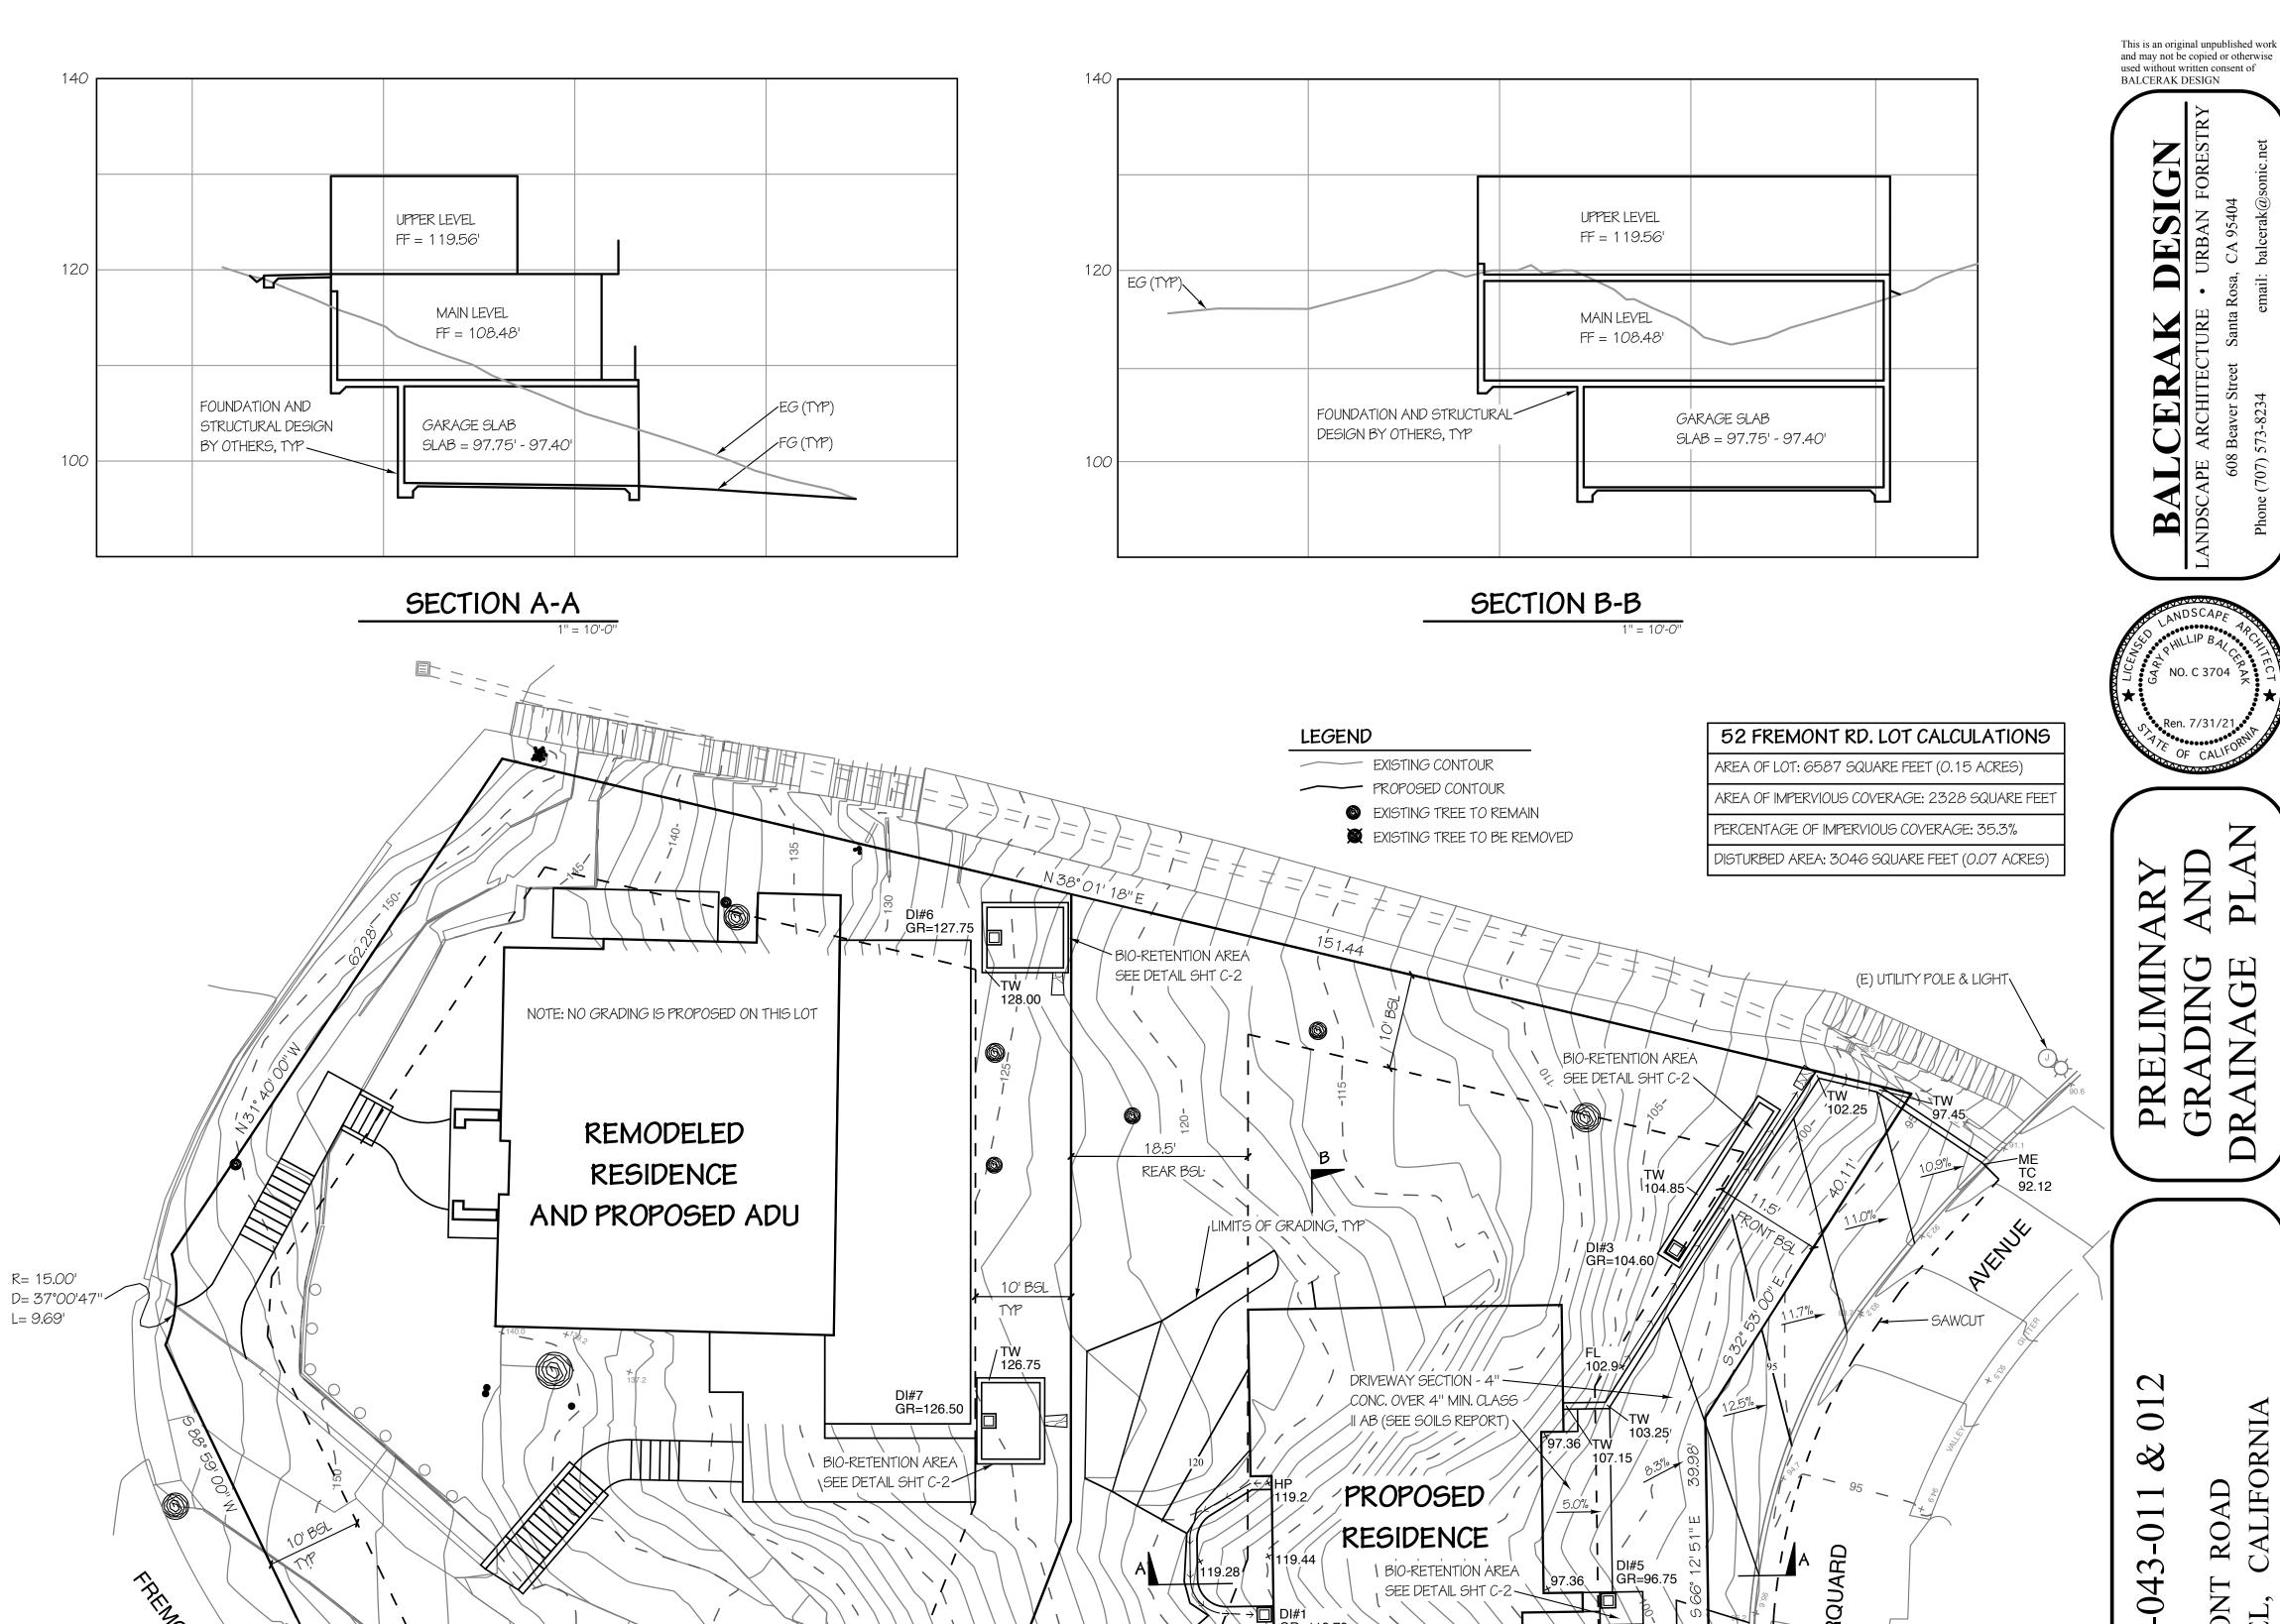

ON SUBJECT PROPERTY, TYP

DI#3 - DI#7

OFF-SITE EXISTING FENCE TO REMAIN

STORM DRAIN SCHEDULE

OLDCASTLE MODEL DI-1212 (NO

BOTTOM, FILL WITH CLASS II AB)

DI#1 & DI#2 OLDCASTLE MODEL DI-1212

GARAGE

2

52/54 SAN


Date: 11/4/20 Scale: 1" = 10'-0" Drawn: GPB Job: 1801

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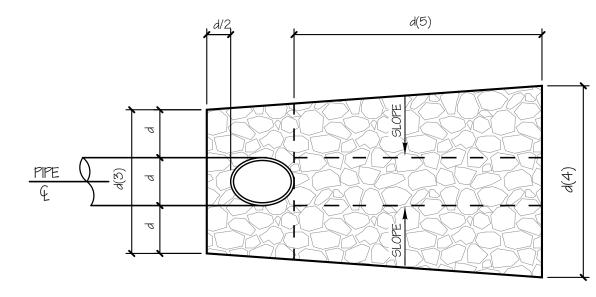
BIO-RETENTION AREA

SEE DETAIL SHT C-2

RESIDENCE

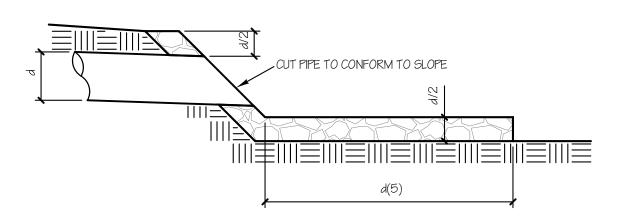

SECTION



PLAN


NOTES:

CLASS #3 ROCK, PLACE PER CALTRANS SECTION 72 METHOD B
 SLOPES SHALL BE 1:1 MAXIMUM


STORM DRAINLINE OUTFALL DETAIL

NOT TO SCALE


NOTE:
SURFACE AREA OF THE BIO-TREATMENT SOIL SHALL EQUAL 4% OF THE AREA
OF THE SITE THAT DRAINS TO TREATMENT MEASURE, UNLESS SIZING
CALCULATIONS ARE SUBMITTED DEMONSTRATING THAT PROVISION C.3
REQUIREMENTS ARE MET USING A SMALLER SURFACE AREA

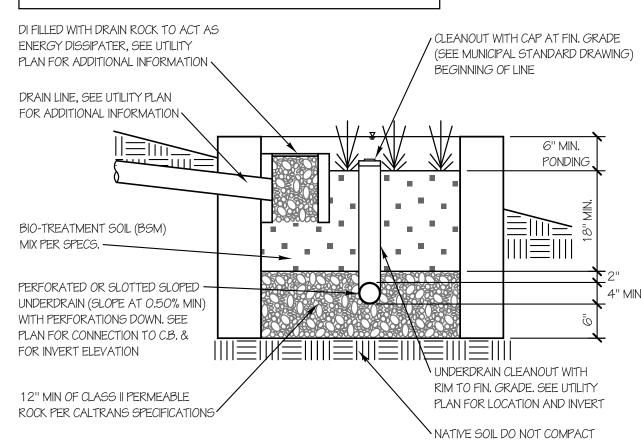

FLOW-THROUGH PLANTER DETAIL NOT TO SCALE

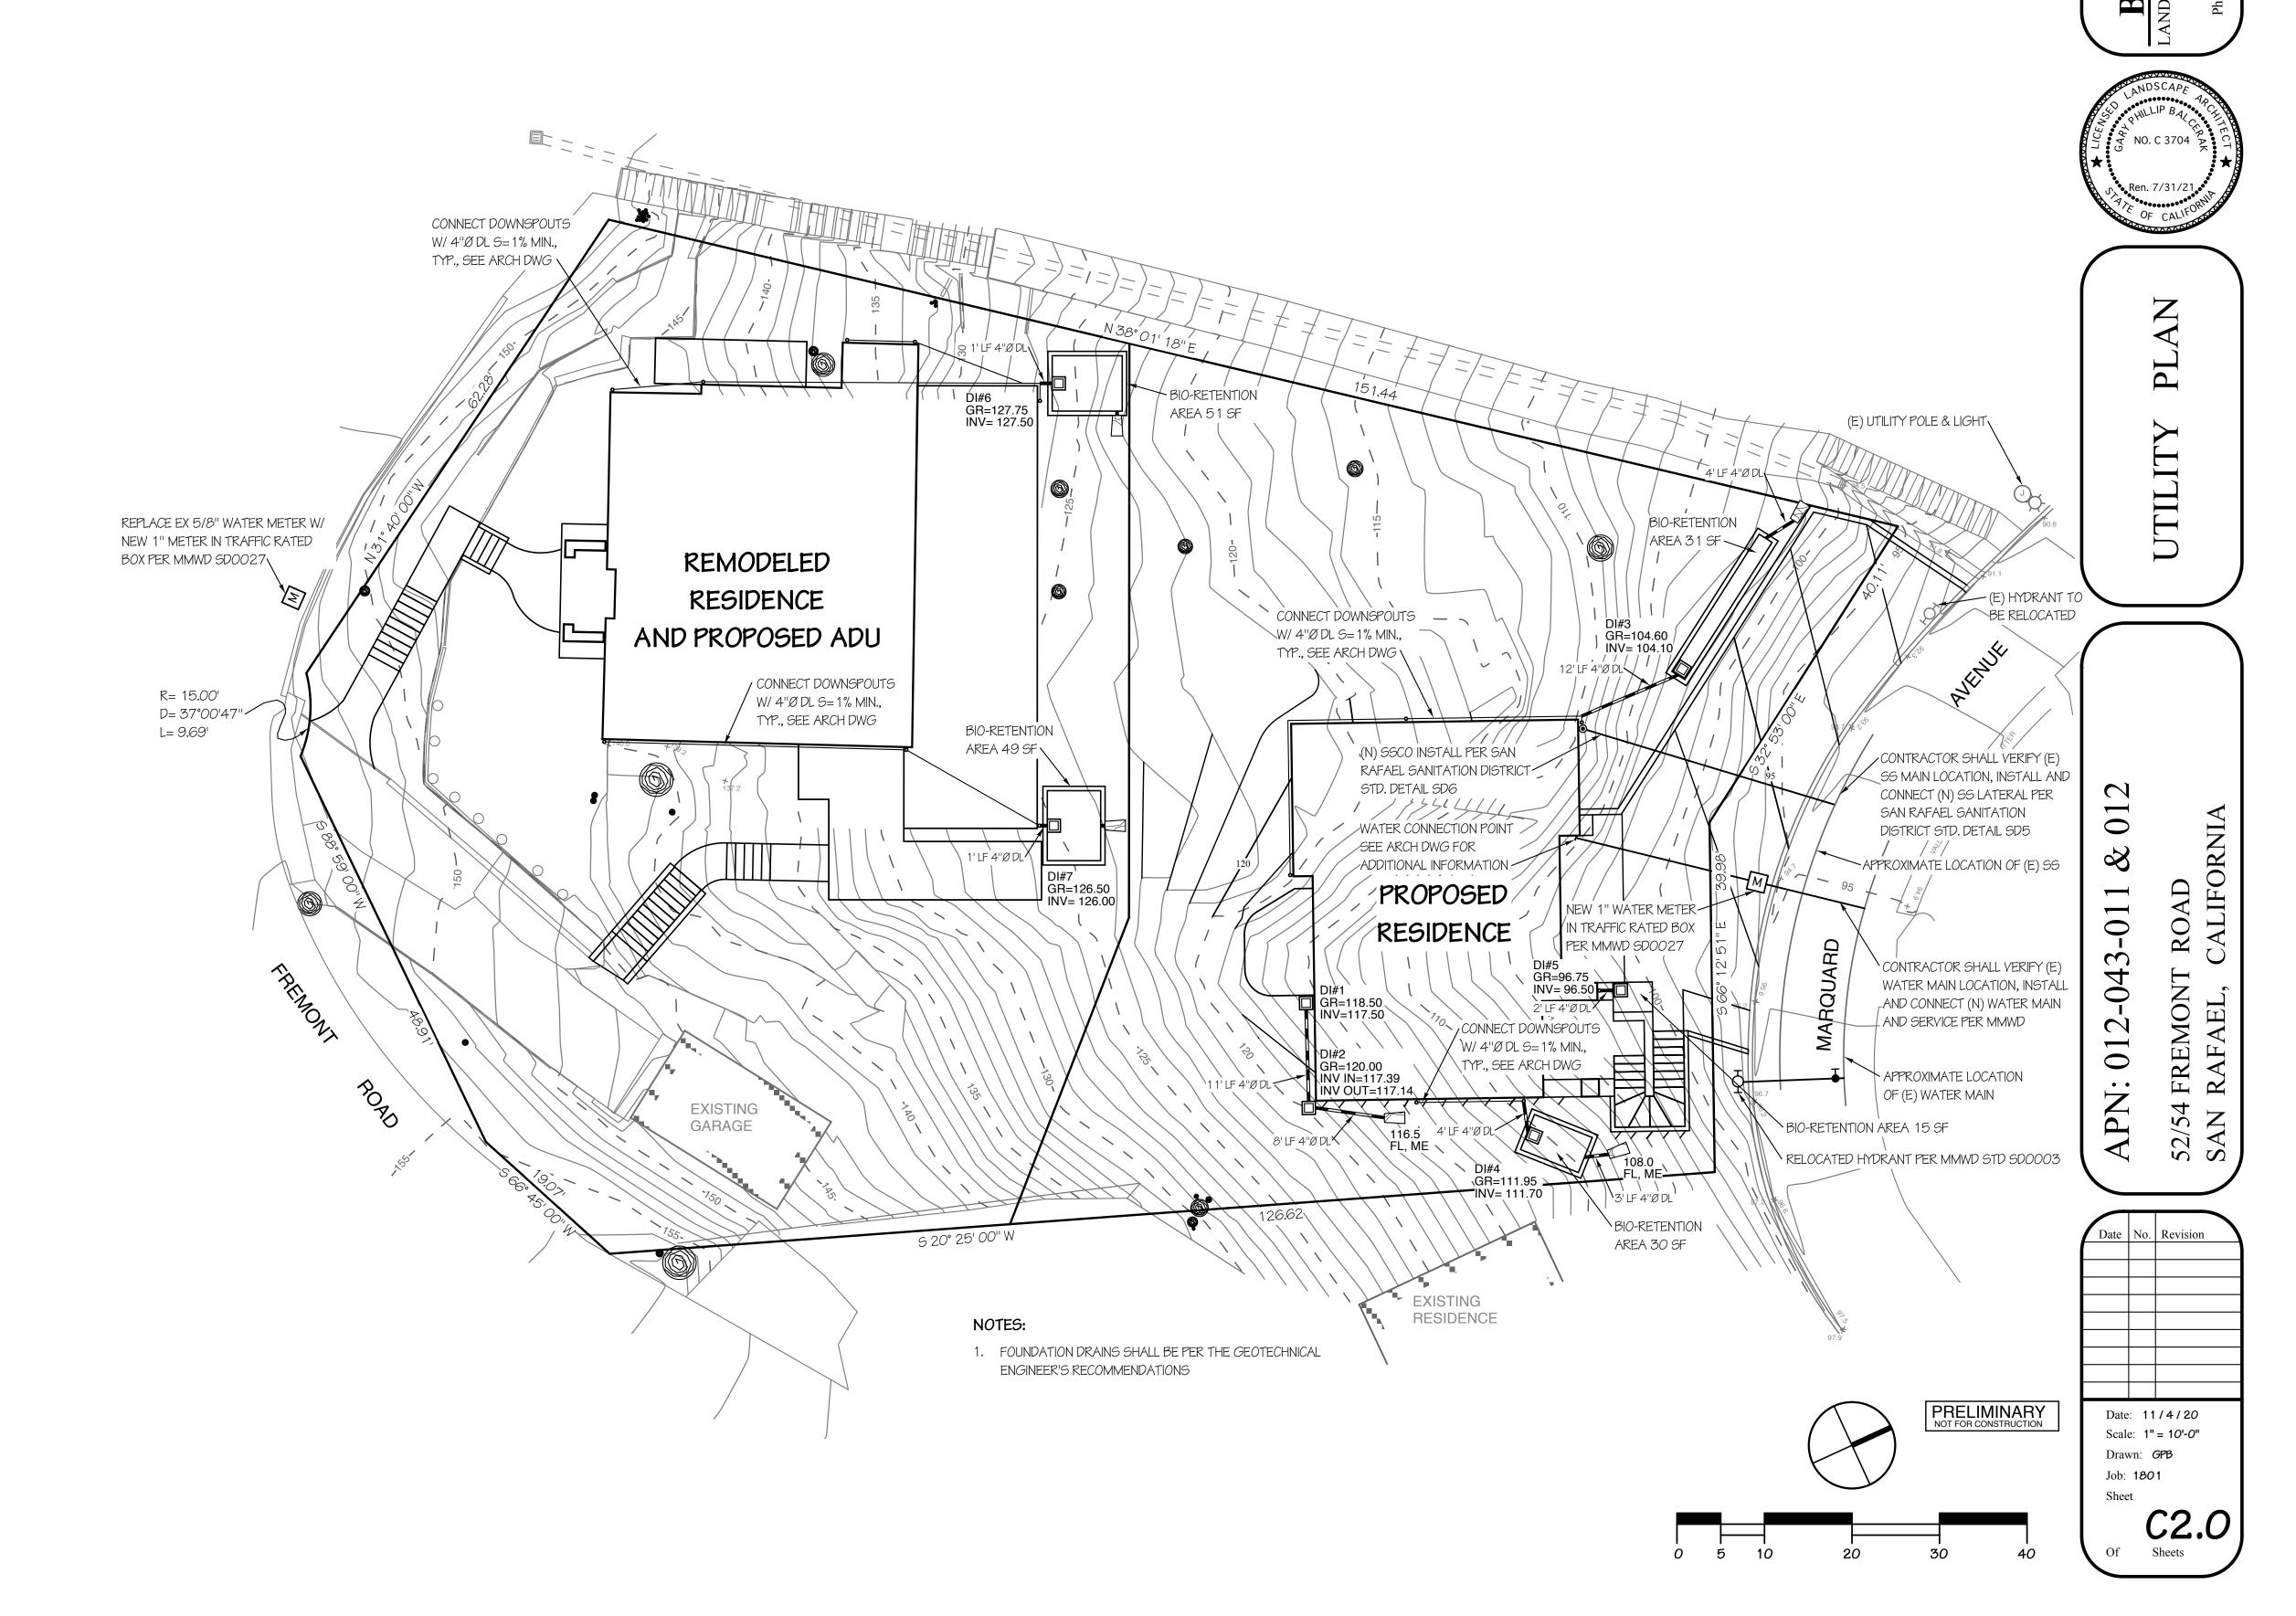


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PLANT SUPPORT SHALL BE "FLORAFELT PRO SYSTEM MODULAR LIVING WALL KIT"

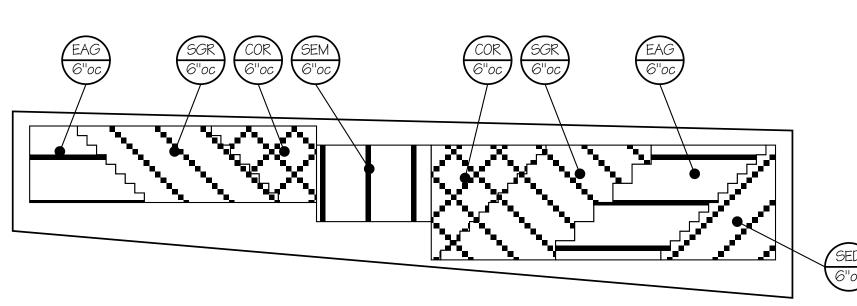WALL ELEVATION A



PLANTING NOTES:

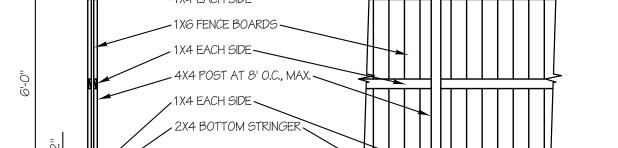1. A MINIMUM OF 8" OF NON-MECHANICALLY COMPACTED SOIL SHALL BE AVAILABLE

2. INCORPORATE COMPOST INTO THE SOIL TO A MINIMUM DEPTH OF 8" AT A RATE OF

3. ALL PLANTING AREAS SHALL RECIEVE A MINIMUM OF 3" OF MULCH, EXCEPT IN TURF

AREAS, CREEPING OR ROOTING GROUNDCOVERS AND DIRECT SEEDING APPLICATIONS.

LANDSCAPE INSTALLATION SOIL SAMPLING SHALL OCCUR AND SAMPLES SENT TO A

A MINIMUM, INCLUDE: SOIL TEXTURE, INFILTRATION RATE, pH, TOTAL SOLUBLE SALTS,

DOCUMENTATION TO THE CITY (WITH THE CERTIFICATE OF COMPLETION) THAT THE

RECOMMENDATIONS FROM THE SOIL ANALYSIS HAVE BEEN IMPLEMENTED.

SODIUM LEVEL, AND PERCENT OF ORGANIC MATTER. THE CONTRACTOR SHALL PROVIDE

4. AFTER THE GRADING OPERATIONS ARE COMPLETE AND PRIOR TO THE BEGINNING THE

TESTING LABORATORY FOR ANALYSIS AND RECOMMENDATIONS. THE ANALYSIS SHALL, AT

6 CUBIC YARDS PER 1000 SQUARE FEET IN ALL PLANTING AREAS. DO NOT TILL THE

FOR WATER ABSORPTION AND ROOT GROWTH IN PLANTED AREAS.

SOIL UNDER EXISTING TREES DESIGNATED TO REMAIN.

-10"ØX2'-6" DEEP CONC. FOOTING 4" DRAIN ROCK

SECTION ELEVATION

1. ALL WOOD SHALL BE REDWOOD, U.O.N.

NATURAL STATE SEED MIX AND NOTES

ALL LANDSCAPE AREAS THAT ARE NOT MULCHED SHALL RECEIVE NATURAL STATE SEED MIX. ONLY MULCH SHALL BE PLACED WITHIN THE DRIPLINE OF EXISTING TREES TO REMAIN.

Botanical name	Common Name	Rate
Achillea millefolium	Yarrow	0.1
Gilia achilleifolia	Blue Gilia	0.1
Lotus corniculatus	Bird's-foot Trefoil	0.5
Melica californica	California Melic	2.7
Hordeum brachyantherum	Meadow Barley	1.1
Carex tumulicola	Foothill Sedge	1.5

Rate is given in ounces of Pure Live Seed per 1000 square feet.

- 1. Seeding shall be performed only after the soil is in a loose condition to a minimum depth of 6 inches. Soil clods shall not be larger than 2 inches in any dimension after cultivation. The areas to be cultivated must extend 12 inches beyond the outer limit of each planting area.
- 2. Rocks and debris encountered during soil preparation in planting areas must be brought to the ground surface and removed.
- 3. The seed shall be broadcast using hand held seeders such as "Whirlybird". While seeding, continually mix the seed to equally distribute the seeds throughout the mix. The seeds shall be raked to an average depth of 1/4 inch.
- 4. Seed must be tested for purity and germination by a seed laboratory certified by the Association of Official Seed Analysts or by a seed technologist certified by the Society of Commercial Seed Technologists. Tests must be performed within 12 months before application.
- Straw must have not have been used for stable bedding. Straw must be free of plastic, glass, metal, rocks, and refuse or other deleterious material. Spread at the rate of 50 pounds per 1000 square feet. Spread it uniformly by hand to a depth of one inch, or use a mechanical straw blower.

5. THESE LANDSCAPE DESIGN PLANS COMPLY WITH THE CRITERIA OF THE WATER After seeds mix has been broadcast mulch with straw. Straw shall be dry and free of weed seeds. CONSERVATION ORDINANCE AND EFFICIENT USE OF WATER IN THE LANDSCAPE. Mulch shall not be applied during periods of high winds or other unfavorable conditions. Planting areas that have been cultivated and become compacted for any reason shall be recultivated by the Contractor at the Contractor's expense. DECK EXISTING TREE TO REMAIN, TYP REMODELED RESIDENCE AND PROPOSED ADU DECK BEGIN NEW WOOD FENCE~ A SEE WALL ELEVATION DECK PROPOSED RESIDENCE PATIO END NEW WOOD FENCE GARAGE

IRRIGATION STATEMENT

ALL PLANTING AREAS SHALL BE IRRIGATED BY AN AUTOMATIC IRRIGATION SYSTEM THAT MEETS THE REQUIREMENTS OF THE EFFICIENT USE OF WATER IN THE LANDSCAPE REQUIREMENTS.

EXISTING TREE TO REMAIN, TYP

THE IRRIGATION PLAN SHALL BE PREPARED AS PART OF THE BUILDING PERMIT SUBMITTAL. THE DRAWING SHALL INCLUDE ALL THE REQUIREMENTS OF THE EFFICIENT USE OF WATER IN THE LANDSCAPE INCLUDING STANDARD NOTES, IRRIGATION AUDIT, AND CERTIFICATE OF COMPLETION.

TREE REMOVAL AND MITIGATION

ON SUBJECT PROPERTY, TYP

OFF-SITE EXISTING FENCE TO REMAIN.

TREES REMOVED SHALL BE MITIGATED AT THE RATE OF 3:1. A TOTAL OF 14 TREES ARE PROPOSED FOR REMOVAL FOR THIS DEVELOPMENT PROPOSAL. THEREFORE, 42 TREES ARE REQUIRED AS MITIGATION.

RESIDENCE

THE PLANTING PLAN PROPOSES THE PLANTING OF 3 NEW TREES. THE REMAINING 39 TREES REQUIRED AS MITIGATION WILL BE SATISFIED BY THE PAYING OF IN-LIEU FEES.

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Date: 11/4/20 Scale: 1'' = 10'-0''Drawn: GPB Job: 1801

52/ SA

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FRAK DESIGN
HITECTURE • URBAN FORE

BALCERAK

LANDSCAPE ARCHITECTURE

608 Beaver Street Santa Ro



MAWA

2-043-011 & 012

APN: 012-043-0 52/54 FREMONT RO. SAN RAFAEL, CAL

Date No. Revision

Date: 11/4/20
Scale: NONE
Drawn: GPB
Job: 1801
Sheet

Maximum Applied Water Allowance

Enter Zip Code 94901 37.33 Residential? Yes

Enter Project Information

Project Name: Custom Residence
Address: 52 Fremont Road, San Rafael

Meter Number: New Meter
Location/Sheet No. Approx. 34' from easterly property line on Marquard Ave. / Sheet C2.0

Date: 11/4/20

Date: 11/4/20

Maximum Applied Water Allowance (MAWA)

Landscaped Area: 1,858 sqft

Special Landscaped Area: 0 sqft

MAWA = 32 CCF

Estimated Total Water Use (ETWU)

Low water use plant 1,399 sqft

Moderate water use plant 459 sqft

High water use plant 0 sqft

Comparison of Comparison o

ETWU | Gallons: | 18,700 | CCF's: | 25 | AF: | 0.06 |

Baseline Period	Jan/Feb	Mar/Apr	May/Jun	Jul/Aug	Sep/Oct	Nov/Dec
Baseline CCF's	0	2	7	9	6	1
1	CCF = 748	Gallons; 1	AF = 435.6	CCF's		
For more information please contact 415-945-1497 or see our website at www.marinwater.org	6/1					

Maximum Applied Water Allowance

Enter Zip Code 94901 37.33 Residential? Yes

Enter Project Information

Project Name: Residence Remodel
Address: 54 Fremont Road, San Rafael

Meter Number: New Meter
Location/Sheet No. Approx. 56' from northwest corner of property line on Fremont Road / Sheet C2.0

Date: 11/4/20

Maximum Applied Water Allowance (MAWA)

793 sqft **0** sqft Special Landscaped Area: 13 CCF Estimated Total Water Use (ETWU) **511** sqft Low water use plant **282** sqft Moderate water use plant High water use plant 0.85 Efficiency Factor % of Total Landscape | Irrigation Efficiency Irrigated with Drip 0-33% 34-66% 12 CCF ETWU =

Water Use Table								
ETWU	Gallons:	8,976	CCF's:	12	AF:	0.03		
Baseline Period	Jan/Feb	Mar/Apr	May/Jun	Jul/Aug	Sep/Oct	Nov/Dec		
Baseline CCF's	0	1	4	4	3	0		
1 CCF = 748 Gallons; 1 AF = 435.6 CCF's								
For more	e information plea	ase contact 415-	945-1497 or see	our website at w	www marinwater or	G 6/16		

PRELIMINARY NOT FOR CONSTRUCTION

PM 11/4/2

TREES PROPOSED FOR RE	MOVAL	TREE PROTECTION NOTES:	This is an original unpublished work and may not be copied or otherwise used without written consent of BALCERAK DESIGN
	tatus Notes	1. THE TREE PROTECTION FENCING SHALL BE INSTALLED PRIOR TO STARTING ANY	
	emove Has ± 3' high by 2' wide fire scar on	CONSTRUCTION ACTIVITY. THE TREE PROTECTION FENCE SHALL NOT BE ALTERED WITHOUT WRITTEN APPROVAL FROM THE PROJECT ARBORIST.	1 1 - 1
(Sequoia sempervirens)	downslope side of tree. Cavity extends ± 1' to 2' inside, woundwood noted at edges of cavity.	2. NO PRUNING OF THE EXISTING TREES IS ANTICIPATED FOR THE CONSTRUCTION OF THIS	GN FOREST
	Tagged as #90.	PROJECT. SHOULD PRUNING BE REQUIRED THE PROJECT ARBORIST SHALL BE NOTIFIED FOR APPROVAL PRIOR TO PERFORMING ANY PRUNING.	N Fo
6 Coast Redwood 17.0" Good Fair Red (Sequoia sempervirens)	This tree has a metal hook in the upper trunk with a bar through it and connects to tree #7,	3. THE CONTRACTOR SHALL BE RESPONSIBLE FOR INFORMING ALL SUBCONTRACTORS AND	ESI RBAN CA 95404 balcerak@
	which also has a hook for the bar. Appears to have been an old swing.	INDIVIDUALS WHO WILL BE WORKING ON SITE OF THE TREE PROTECTION REQUIREMENTS AND	UR UR ii: bz
	emove Cavity noted on upslope side 2.5' high and 10"	CONDITIONS OF APPROVAL FOR THE PROJECT. NOTES:	E ema
(Sequoia sempervirens) 8 Coast Redwood 23.2" Good Good Re	wide, ± 6" deep. emove Many suckers at base, common for the species.	ROOT PRUNING NOTES: 1. SEE ARBORIST'S REPORT PREPARED BY BALCERAK DESIGN, REVISED FEBRUARY 17, 2020	RAK ITTECTURE Street Santa
(Sequoia sempervirens)	No overt defects noted. Tagged as #91.	1. TREES LOCATED CLOSEST TO THE IMPROVEMENTS REQUIRE THE GREATEST FOR ADDITIONAL INFORMATION.	TEC Itreet
9 Coast Redwood 19.5" Good Good Re (Sequoia sempervirens)	Many suckers at base, common for the species. No overt defects noted.	CARE DURING CONSTRUCTION IF THEY ARE TO BE RETAINED LONG-TERM. TO PROVIDE THE GREATEST OPPORTUNITY TO PRESERVE THESE TREES, THE PROJECT 2. NO EXISTING TREE, DESIGNATED TO REMAIN, SHALL BE TRIMMED OR PRUNED WITHOUT PRIOR APPROVAL BY THE PROJECT ARBORIST.	
10 Coast Redwood 19.8" Good Good Re (Sequoia sempervirens)	emove Many suckers at base, common for the species. No overt defects noted. Tree has been used as	ARBORIST SHOULD BE PRESENT WHEN THE EXCAVATION OCCURS, TO PROVIDE) 573-
	a pole to attach old electrical wiring.	3. NOTIFY PROJECT ARBORIST IN ANY CASE WHERE CONTRACTOR FEELS GRADING OR 2. WHERE INDICATED ON THE PLAN THE ROOT MASS OF TREES DESIGNATED TO OTHER CONSTRUCTION CALLED FOR BY CONTRACT DOCUMENTS MAY DAMAGE EXISTING	(707)
11 Coast Redwood 35.3" Good Good Red (Sequoia sempervirens)	Trunk bifurcates at \pm 7' off steep grade. Many suckers at base, common for the species. Had a	REMAIN SHALL BE SEVERED WITH A ROOT PRUNER MACHINE (WITH SHARP TREES THAT ARE SCHEDULED TO REMAIN. BLADES) TO A DEPTH DETERMINED BY PROJECT ARBORIST PRIOR TO GRADING.	B/A DSC
	third trunk on the up slope side that was removed at ± 2.5 ' off grade, no decay evident.	4. FINAL LOCATION OF TREE PROTECTION FENCING SHALL BE DETERMINED BY FIELD 3. TO PREVENT ROOT DESICCATION USE MOIST BURLAP, OR OTHER APPROVED 4. FINAL LOCATION OF TREE PROTECTION FENCING SHALL BE DETERMINED BY FIELD STAKING OF THE IMPROVEMENTS, AND ADJUSTING FENCE TO PROVIDE MAXIMUM	
	Old fire scar on downslope side of trunk, no decay evident.	MATERIAL, TO COVER THE EXPOSED SOIL SURFACE. THIS ROOT PROTECTION PROTECTION. FINAL LOCATION AND EXTENT OF FENCING SHALL BE APPROVED BY THE	
	emove Cal-IPC has identified this tree as a species of	PROJECT ARBORIST. FENCING SHALL REMAIN INTACT AND SHALL ONLY BE ALTERED WITH UNTIL FINAL BACKFILL OF THE SOIL OCCURS. THE APPROVAL OF THE PROJECT ARBORIST.	ANDSCAPE AP
(Prunus cerasifera)	limited concern, and therefore removal is recommended.	4. NO WOUND DRESSING OF ANY KIND SHALL BE APPLIED TO THE TREES.	No. c 3704 P CT
14 Cherry Plum 10.7" at 14" Fair Poor Re (Prunus cerasifera) off grade	emove Cal-IPC has identified this tree as a species of limited concern, and therefore removal is		★ 10.03704 × 11
	recommended.		Ren. 7/31/21
15 Cherry Plum 5.2" Good Good Re (Prunus cerasifera)	emove Cal-IPC has identified this tree as a species of limited concern, and therefore removal is	TREE PROTECTION FENCE, SEE DETAIL	OF CALIFORNIA
	recommended.		
16 Cherry Plum 5.6" Fair Re (Prunus cerasifera)	Cal-IPC has identified this tree as a species of limited concern, and therefore removal is		
17 Coast Redwood 9.5" Fair/Poor Good Re	recommended. emove Suppressed by Tree #18. Many suckers at base,		
(Sequoia sempervirens)	common for the species. No overt defects		
18 Coast Redwood 26.3" Good Good Re	emove No overt defects noted. Many suckers at base,		
(Sequoia sempervirens)	common for the species.		I Id
19 California Bay 4.2"; 7.3"; Fair Poor Re (Umbellularia californica) 3.2"	been removed. Decay on downslope side of the	APPLY TREE TRUNK PROTECTION DETAIL TO THIS TREE	口
	trunk. Thinly foliated, largest trunk is growing towards proposed residence. This tree had been		REE
	covered with Ivy, but is has been killed off.		
		KEMODELED T KEMODELED T T T T T T T T T	
		RESIDENCE	
		AND PROPOSED ADU Tree Protection Fence, See Detail	
		#6 T T T PRINING NOTES	
		#7 TO LEGY THE RECOVERING IN THIS AREA	\\\\\\\\\\\\\\\\\\\\\\\\\\\\\\\\\\\\\\
			/
			12
		\\\\\\\\\\\\\\\\\\\\\\\\\\\\\\\\\\\\\\	
		RESIDENCE / / / / / / / / / / / / / / / / / / /	
,			$\begin{bmatrix} C & 3 \\ C & 3 \end{bmatrix}$
		TREE PROTECTION TREE PROTECTION TREE PROTECTION	7 2
	The state of the s	FENCE, SEE DETAIL	2- 4E
EXISTING TREE TO BE PROTECTED			01 (E) (E)
			:: \frac{1}{2} \
1/4" MIN THICK CLOSED-CELL	TENCAR RIACTIC FENCING. CUT	EXISTING GARAGE #17	Q
FOAM PAD (OR APPROVED EQUAL) BETWEEN BARK AND 2X4 BOARDS	TENSAR PLASTIC FENCING - CUT OR FOLD AT POSTS AS NEEDED TO CONFORM TO TERRAIN		S. S. A.
	TO SOLIN SIGNITO I ZING INV	**************************************	
RAP TREE TRUNK WITH 2X4 BOARDS, PROTECT TRUNK FROM DAMAGE WHILE PLACING BOARDS,			
PROVIDE PROTECTION ALL THE WAY AROND THE TREE TRUNK ————————————————————————————————————	ELECTRICAL TIES, TIE WIRE FLIP		Date No. Revision
SECURE 2X4 BOARDS WITH STRAPS AS	TIES OR EQUIVALENT		
REQUIRED, DO NOT TIGHTEN STRAPS TO THE POINT THAT THE BARK OF THE TREE IS DAMAGED		LEGEND EXISTING RESIDENCE	
NOTES.		EXISTING CONTOUR	
NOTES: 1. PROJECT ARBORIST SHALL DETERMINE THE HEIGHT OF TRUNK PROTECTION REQUIRED. PROJECT ARBORIST SHALL APPROVE ALL TREE PROTECTION MEASURES PRIOR TO	STANDARD FARM QUALITY "T" POST, WITHOUT BLADES	PROPOSED CONTOUR	
BEGINING ANY CONSTRUCTION.	@ 8' O.C., MAX.	EXISTING TREE TO REMAIN EXISTING TREE TO BE REMOVED PRELIMIN NOT FOR CONSTR	JARY Date: 11/4/20
 PROTECT BARK AT ALL TIMES - INSPECT TRUNK PROTECTION ROUTINELY TO ASSURE NO BARK DAMAGE HAS OCCURRED AND THAT THE 2X4 BOARDS CONTINUE TO PROVIDE THE REQUIRED 	 TREE PROTECTION FENCING SHALL BE A MINIMUM OF 4' IN HEIGHT AT ALL LOCATIONS, AND SHALL FORM A CONTINUOUS BARRIER WITHOUT ENTRY POINTS AROUND ALL INDIVIDUAL TREES, OR GROUPS OF TREES. 	A NOT FOR CONSTR	Scale: 1" = 10'-0"
PROTECTION — NOTIFY PROJECT ARBORIST IMMEDIATELY IF DAMAGE HAS OCCURRED 3. NO PRUNING SHALL OCCUR EXCEPT AT THE DIRECTION OF THE PROJECT ARBORIST	FENCING SHALL SERVE AS A BARRIER TO PREVENT ENCROACHMENT OF ANY TYPE OF CONSTRUCTION ACTIVITIES, EQUIPMENT, MATERIALS STORAGE, OR PERSONNEL.	$\bigvee \bigvee$	Drawn: <i>GPB</i> Job: 1801
OF THE FROM THE COOK ENDER FAIL THE PINEOTION OF THE FROMEOT ANDUNOT			Sheet
TREE TRUNK PROTECTION DETAIL	TREE PROTECTION FENCE DETAIL		
NOT TO SCALE	NOT TO SCALE	0 5 10 20 30	40 Of Sheets

KEY	SIZE	BOTANICAL NAME	COMMON NAME	REMARKS	WATER USE
		TREES			
CUS	#15	CORYLUS CORNUTA	WESTERN HAZELNUT		LOW
		SHRUBS			
CAL	*	CALYCANTHUS OCCIDENTALIS	SPICE BUSH		MEDIUM
<i>G</i> 5H	#5	GAULTHERIA SHALLON	SALAL		MEDIUM
R55	*	RUBUS SPECTABILIS	SALMONBERRY		MEDIUM
SYA	*	SYMPHORICARPOS ALBUS VAR. LAEVIGATUS	SNOWBERRY		LOW
VOV	*	VACCINIUM OVATUM	EVERGREEN HUCKLEBERRY		MEDIUM
		PERENNIALS			
COR	4" POT	COTYLEDON ORBICULATA	PIG'S EAR	6" O.C. TRI. SPACING	LOW
EAG	4" POT	ECHEVERIA AGAVOIDES	NO COMMON NAME	6" O.C. TRI. SPACING	LOW
НМІ	#1	HEUCHERA MICRANTHA	CORAL BELLS		MEDIUM
OOR	6" POT	OXALIS OREGANA	REDWOOD SORREL		MEDIUM
PMU	#1	POLYSTICHUM MUNITUM	SWORD FERN		MEDIUM
SED	4" POT	SEDUM ADOLPHII	GOLDEN SEDIUM	6" O.C. TRI. SPACING	LOW
SGR	4" POT	SEDUM GRISEBACHII	STONE CROP	6" O.C. TRI. SPACING	LOW
SEM	4" POT	SEMPERVIVUM TECTORUM	COMMON HOUSELEEK	6" O.C. TRI. SPACING	LOW
WFI	*	WOODWARDIA FIMBRIATA	GIANT CHAIN FERN		MEDIUM
		VINES			
LCI	#5	LONICERA CILIOSA	WESTERN TRUMPET HONEYSUCKLE		MEDIUM
		GROUNDCOVERS			
CPA	#1	CAREX PANSA	CALIFORNICA MEADOW SEDGE	9" O.C. TRI. SPACING	MEDIUM
JEF	#1	JUNCUS EFFUSUS	SOFT RUSH	2' O.C. TRI. SPACING	MEDIUM
JPA	#1	JUNCUS PATENS	CALIFORNIA RUSH	2' O.C. TRI. SPACING	LOW
			•	•	

PLANT SIZES NOTED WITH * SHALL BE #5 SIZE FOR 52 FREMONT ROAD AND #15 SIZE FOR 54 FREMONT ROAD.

ALL PROPOSED PLANTINGS SHALL BE FIRE RESISTANT AND IRRIGATED. NO PLANTS PROHIBITED BY THE SAN RAFAEL FIRE PROTECTION BUREAU STANDARD 100, THE MARIN MUNICIPAL WATER DISTRICT, OR THE CALIFORNIA INVASIVE PLANT COUNCIL SHALL BE USED. THE CONTROLLER FOR THE IRRIGATION SYSTEM SHALL BE HIGH-EFFICIENCY AND USE EVAPOTRANSPIRATION DATA.

NATURAL STATE SEED MIX AND NOTES

ALL LANDSCAPE AREAS THAT ARE NOT MULCHED SHALL RECEIVE NATURAL STATE SEED MIX. ONLY MULCH SHALL BE PLACED WITHIN THE DRIPLINE OF EXISTING TREES TO REMAIN.

Botanical name	Common Name	Rate
Achillea millefolium	Yarrow	0.1
Gilia achilleifolia	Blue Gilia	0.1
Lotus corniculatus	Bird's-foot Trefoil	0.5
Melica californica	California Melic	2.7
Hordeum brachyantherum	Meadow Barley	1.1
Carex tumulicola	Foothill Sedge	1.5

Rate is given in ounces of Pure Live Seed per 1000 square feet.

VEGETATION MANAGEMENT PLAN NARRATIVE

THIS SITE IS REMNANT OF A REDWOOD (SEQUOIA SEMPERVIRENS) FOREST, WITH CALIFORNIA BAY (UMBELLULARIA CALIFORNICA) AS AN ASSOCIATE. DUE TO THE SHADED THE UNDERSTORY CONSISTS OF GRASSES AND FORBS. THE SUBJECT PROPERTY HAS A NORTHEAST ASPECT SLOPE. IT APPEARS THAT THERE IS AMPLE SOIL MOISTURE AVAILABLE YEAR ROUND.

BECAUSE OF THE STAND OF TREES AND THE ASPECT ALL OF THE TREES HAVE NATURALLY LIMBED-UP THEIR CROWN, MOST TREES DO NOT EXHIBIT PERMANENT SCAFFOLD BRANCHES UNTIL ± 25' ABOVE NATURAL GRADE. SOME OF THE TREES EXPOSED TO MORE HAVE BRANCHES LOWER, BUT ARE STILL ± 10' ABOVE NATURAL GRADE.

THE LANDSCAPE DESIGN IS CONSISTENT WITH THE MARIN MUNICIPAL WATER DISTRICT REQUIREMENTS, AND THE CITY OF SAN RAFAEL, FOR LANDSCAPE DESIGN. TO PROVIDE A MORE TRADITIONAL SUBURBAN FRONT YARD ORNAMENTAL PLANTS INCLUDING TREES, SHRUBS, PERENNIALS, AND GROUNDCOVERS HAVE BEEN USED. NO LANDSCAPING IN THE REAR YARD IS PROPOSED AT THIS TIME, HOWEVER ALL FUTURE LANDSCAPING SHALL BE CONSISTENT WITH THE REQUIREMENTS OF THIS PLAN AND APPLICABLE FIRE STANDARDS.

LONG TERM MAINTENANCE SCHEDULES AND GOALS

ALL TREE LIMBS OVER 2" DIAMETER SHALL BE REMOVED 15'-20' ABOVE THE GROUND SURFACE.

ANY PORTION OF A TREE THAT IS WITHIN 10' OF A STOVEPIPE OR CHIMNEY SHALL BE REMOVED. NO DEAD OR DYING LIMBS SHALL BE ALLOWED TO OVERHANG ANY BUILDING. TREES THAT OVERHANG ROADWAYS SHALL BE PRUNED TO ASSURE A MINIMUM VERTICAL CLEARANCE OF 15'-0".

ALL COMBUSTIBLE DEBRIS, INCLUDING LEAVES, SHALL BE REMOVED FROM THE ROOF AND GUTTERS NO LESS THAN ONCE EVERY SIX MONTHS.

ALL WEEDS AND GRASSES SHALL BE MOWED REGULARLY; IN NO INSTANCE SHALL THEIR HEIGHT

ALL DEAD AND DYING VEGETATION WITHIN THE DEFENSIBLE SPACE ZONE SHALL BE REMOVED NO LESS THAN EVERY SIX MONTHS.

ALL MOTORIZED MAINTENANCE EQUIPMENT, INCLUDING SAWS AND MOWERS, SHALL BE EQUIPPED WITH SPARK ARRESTORS. EXERCISE CARE AND CHECK FOR ROCKS PRIOR TO MOWING TO PREVENT MOWER BLADES FROM SPARKING.

REFERENCES

KENT, D., 2005. FIRESCAPING: CREATING FIRE-RESISTANT LANDSCAPES, GARDENS, AND PROPERTIES IN CALIFORNIA'S DIVERSE ENVIRONMENTS. BERKELEY CA, WILDERNESS PRESS.

EAST BAY MUNICIPAL UTILITY DISTRICT, 2003. FIRESCAPE: LANDSCAPING TO REDUCE FIRE HAZARD. OAKLAND CA, ADMINISTRATION DEPARTMENT EBMUD.

PLANTING NOTES:

1. A MINIMUM OF 8" OF NON-MECHANICALLY COMPACTED SOIL SHALL BE AVAILABLE FOR WATER ABSORPTION AND ROOT GROWTH IN PLANTED AREAS.

2. INCORPORATE COMPOST INTO THE SOIL TO A MINIMUM DEPTH OF 8" AT A RATE OF 6 CUBIC YARDS PER 1000 SQUARE FEET IN ALL PLANTING AREAS. DO NOT TILL THE SOIL UNDER EXISTING TREES DESIGNATED TO REMAIN.

3. ALL PLANTING AREAS SHALL RECIEVE A MINIMUM OF 3" OF MULCH, EXCEPT IN TURF AREAS, CREEPING OR ROOTING GROUNDCOVERS AND DIRECT SEEDING APPLICATIONS.

4. AFTER THE GRADING OPERATIONS ARE COMPLETE AND PRIOR TO THE BEGINNING THE LANDSCAPE INSTALLATION SOIL SAMPLING SHALL OCCUR AND SAMPLES SENT TO A TESTING LABORATORY FOR ANALYSIS AND RECOMMENDATIONS. THE ANALYSIS SHALL, AT A MINIMUM, INCLUDE: SOIL TEXTURE, INFILTRATION RATE, pH, TOTAL SOLUBLE SALTS, SODIUM LEVEL, AND PERCENT OF ORGANIC MATTER. THE CONTRACTOR SHALL PROVIDE DOCUMENTATION TO THE CITY (WITH THE CERTIFICATE OF COMPLETION) THAT THE RECOMMENDATIONS FROM THE SOIL ANALYSIS HAVE BEEN IMPLEMENTED.


5. THESE LANDSCAPE DESIGN PLANS COMPLY WITH THE CRITERIA OF THE WATER CONSERVATION ORDINANCE AND EFFICIENT USE OF WATER IN THE LANDSCAPE.


Hazard	1	2	3	4	5	6	7	8	Point
Points									
Aspect	NE E	NW,N	SE, W	S	SW				
Slope	$\bigg) \bigg($	0-10		11-20		21-30		(31+)	
Fuel (Specimen	Hardw	Grass	Mostly	Mostly	Pyrophoric	Conifer	Conifer	
0-30	Garden	ood		Grass	Brush	Hardwoods		w/brush	
	$\langle \langle \rangle \rangle$					Chaparral		understory	
Fuel /	Grass,	Mostly		Pyrophoric	Conifer				
31-100	Mostly	Brush		Hardwoods	with brush				
\	Grass			Chaparral	understory				

Minimum Horizontal Clearance Requirement in feet 30' x 30' x 50'

Hazard Points:

1 2 3 4 5 6 7	8 9 10 11 12 13 14	15 16 17 18 19 20 21 22 23 24 25
30x30x30 ft.	30x30x50 ft.	50x50x100 ft.

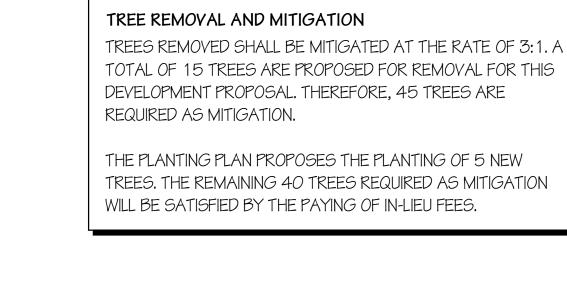

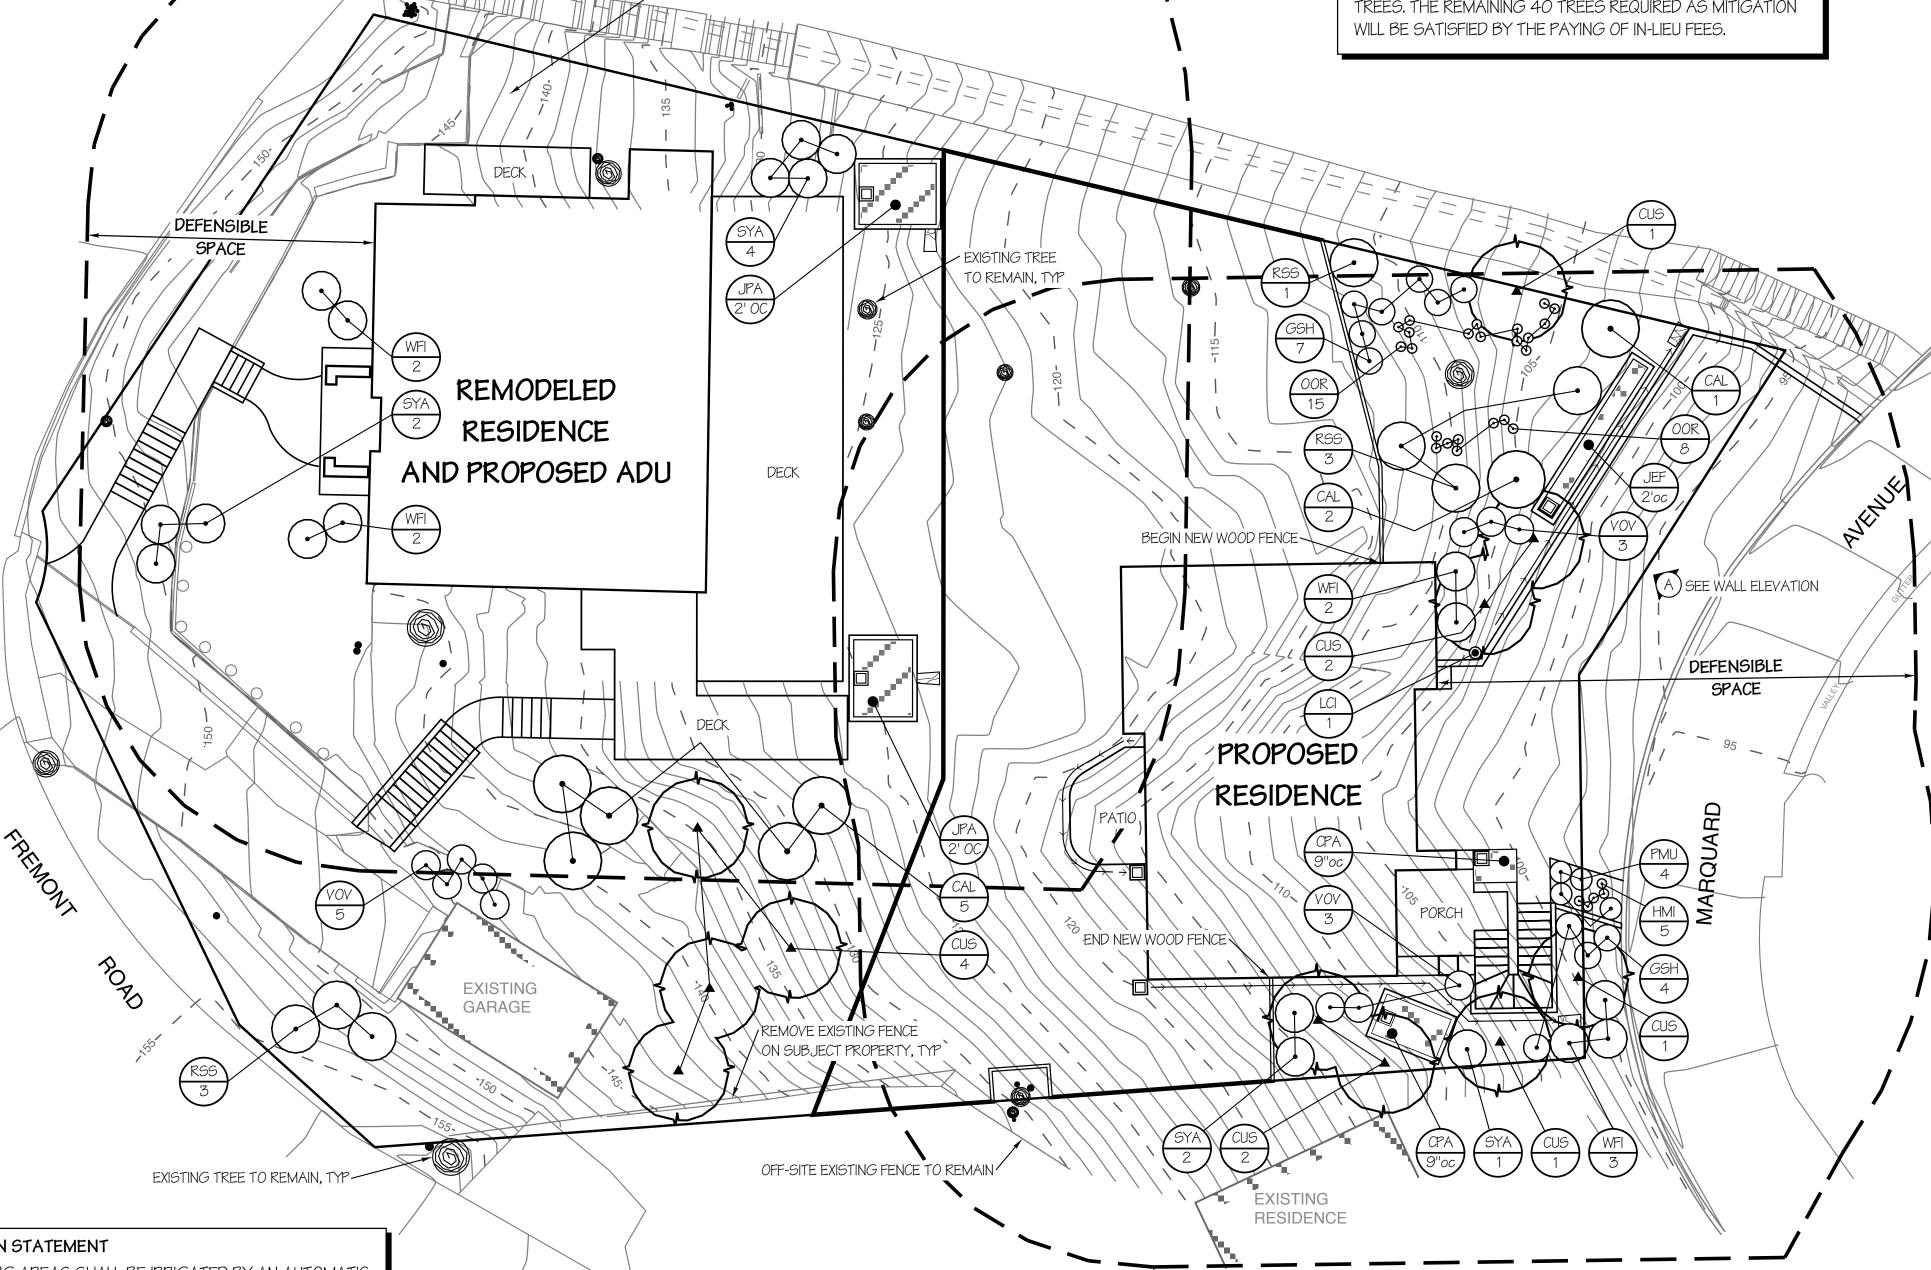

O BE PLANTED AS INDICATED IN THE NATURAL STATE SEED MIX

IRRIGATION STATEMENT

ALL PLANTING AREAS SHALL BE IRRIGATED BY AN AUTOMATIC IRRIGATION SYSTEM THAT MEETS THE REQUIREMENTS OF THE EFFICIENT USE OF WATER IN THE LANDSCAPE REQUIREMENTS.

THE IRRIGATION PLAN SHALL BE PREPARED AS PART OF THE BUILDING PERMIT SUBMITTAL. THE DRAWING SHALL INCLUDE ALL THE REQUIREMENTS OF THE EFFICIENT USE OF WATER IN THE LANDSCAPE INCLUDING STANDARD NOTES, IRRIGATION AUDIT, AND CERTIFICATE OF COMPLETION.

MINIMUM HORIZONTAL CLEARANCE REQUIREMENT

Date: 11/4/20 Scale: 1" = 10'-0"

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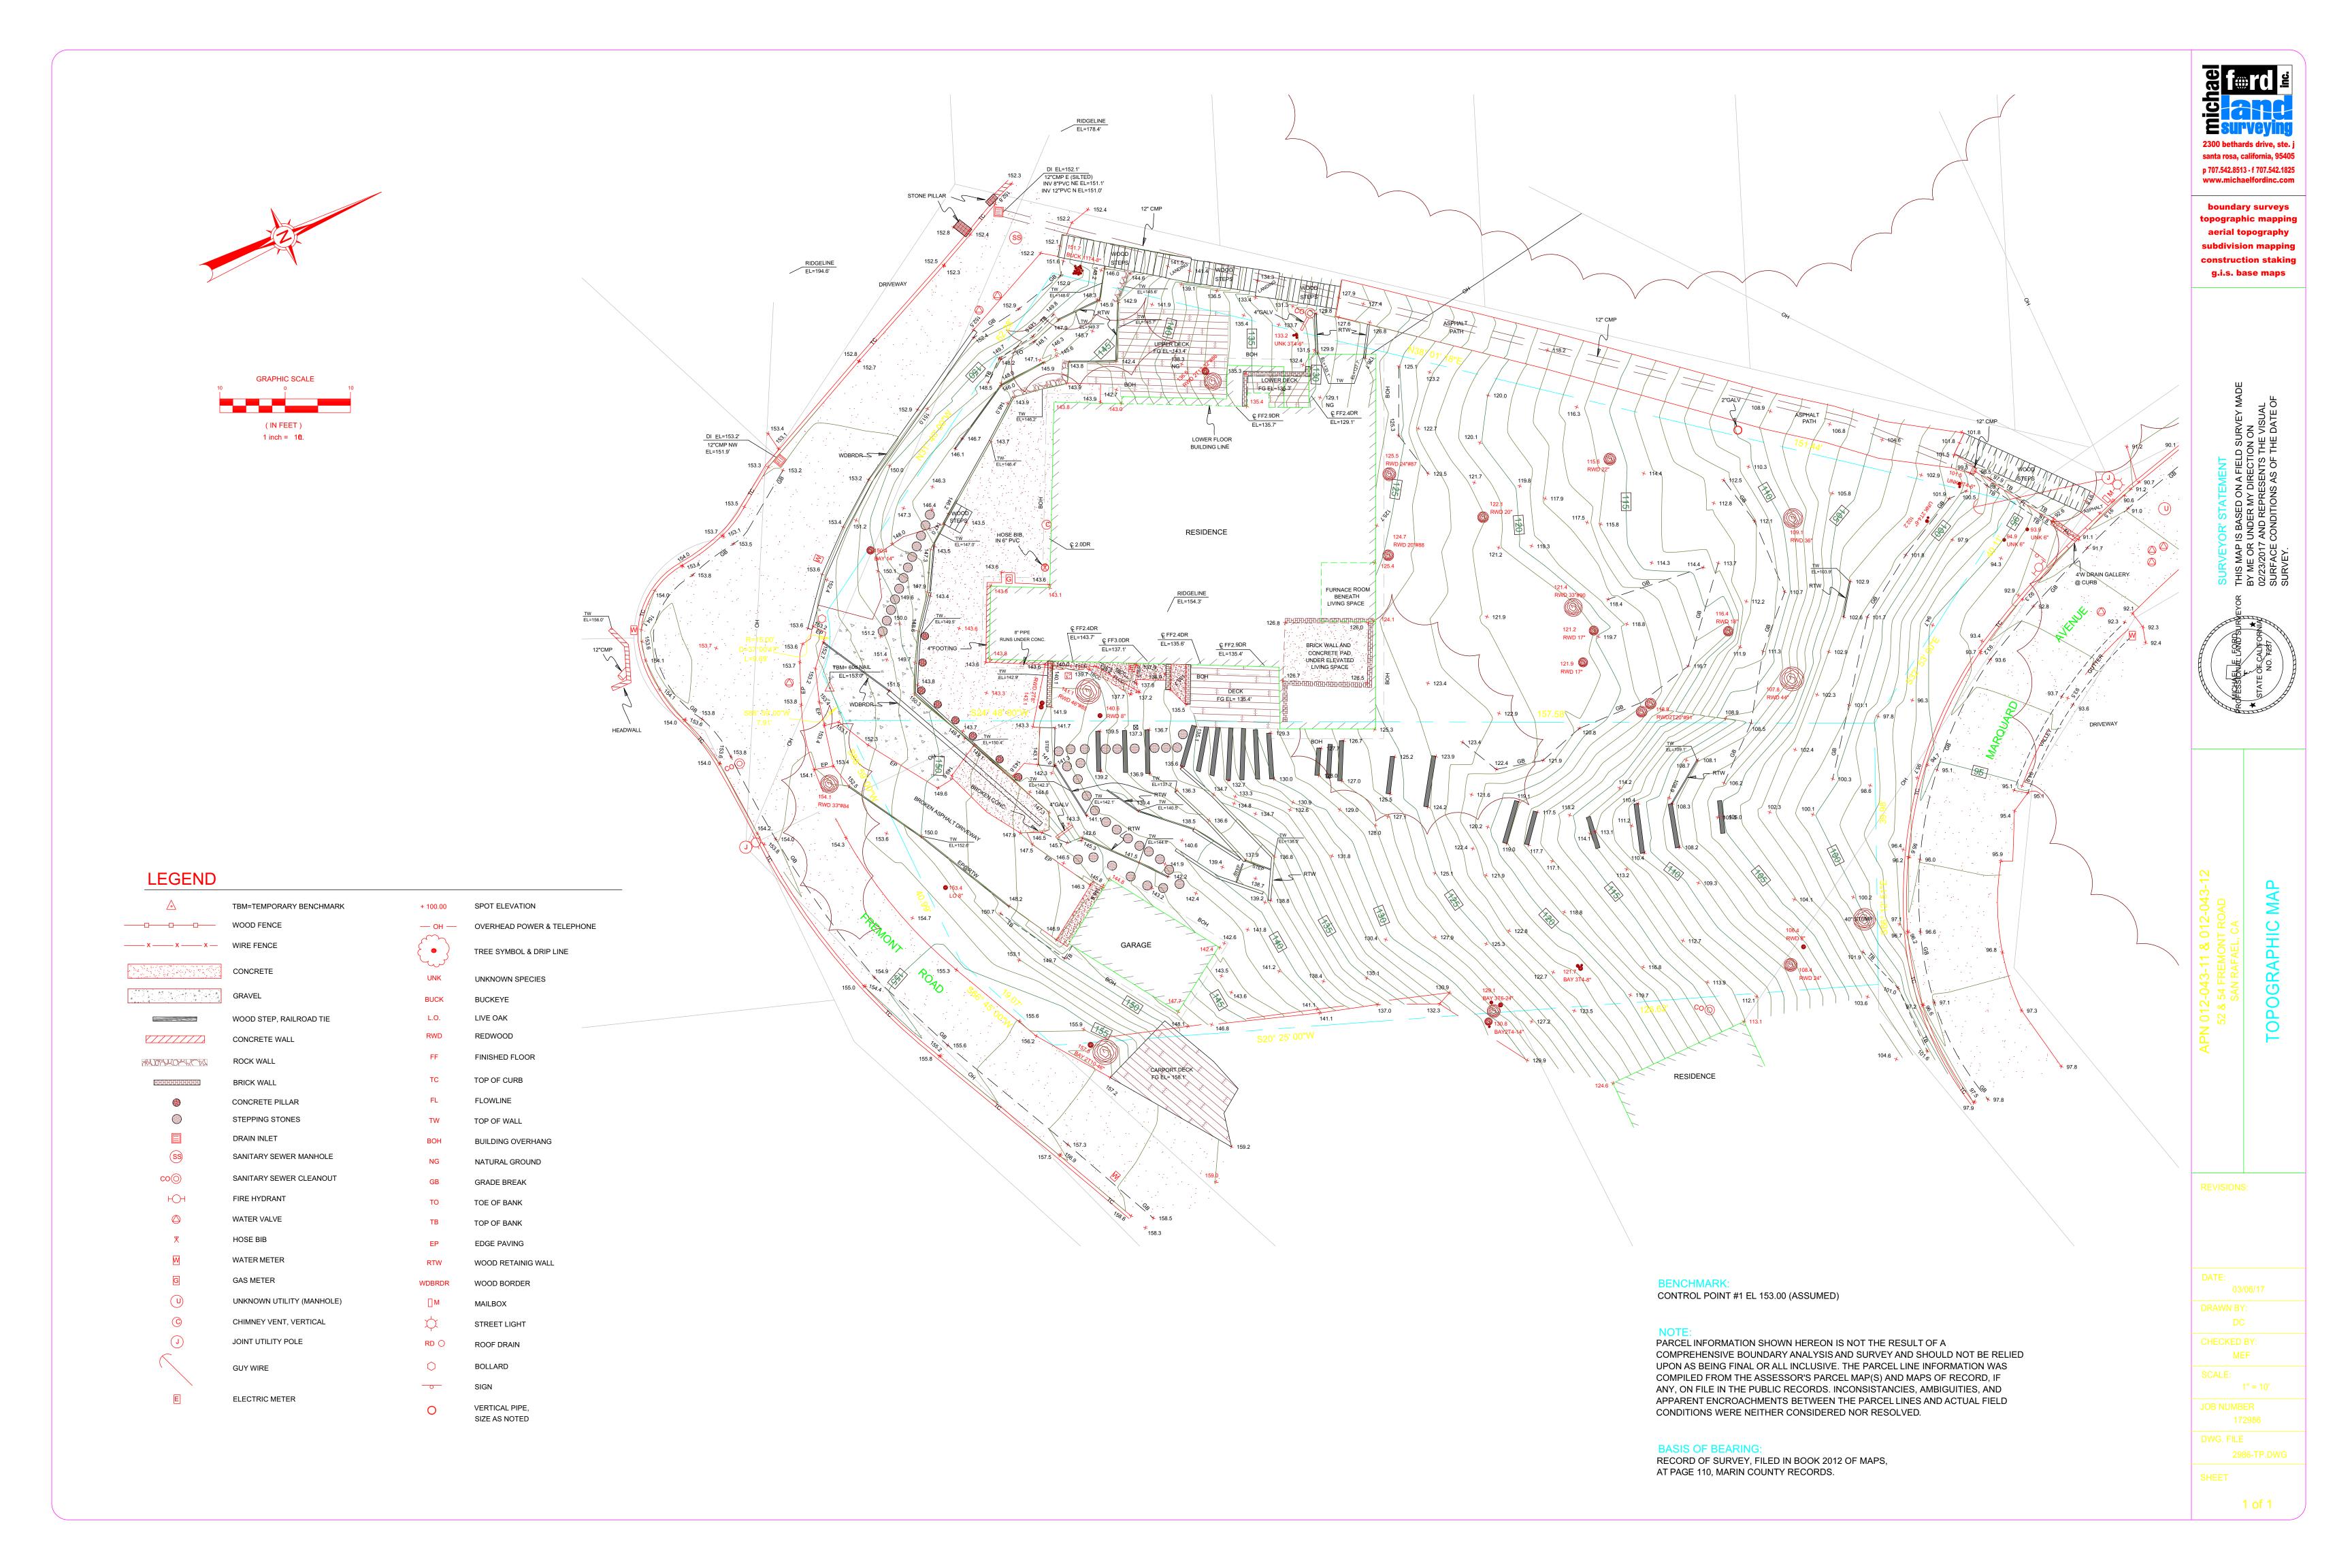
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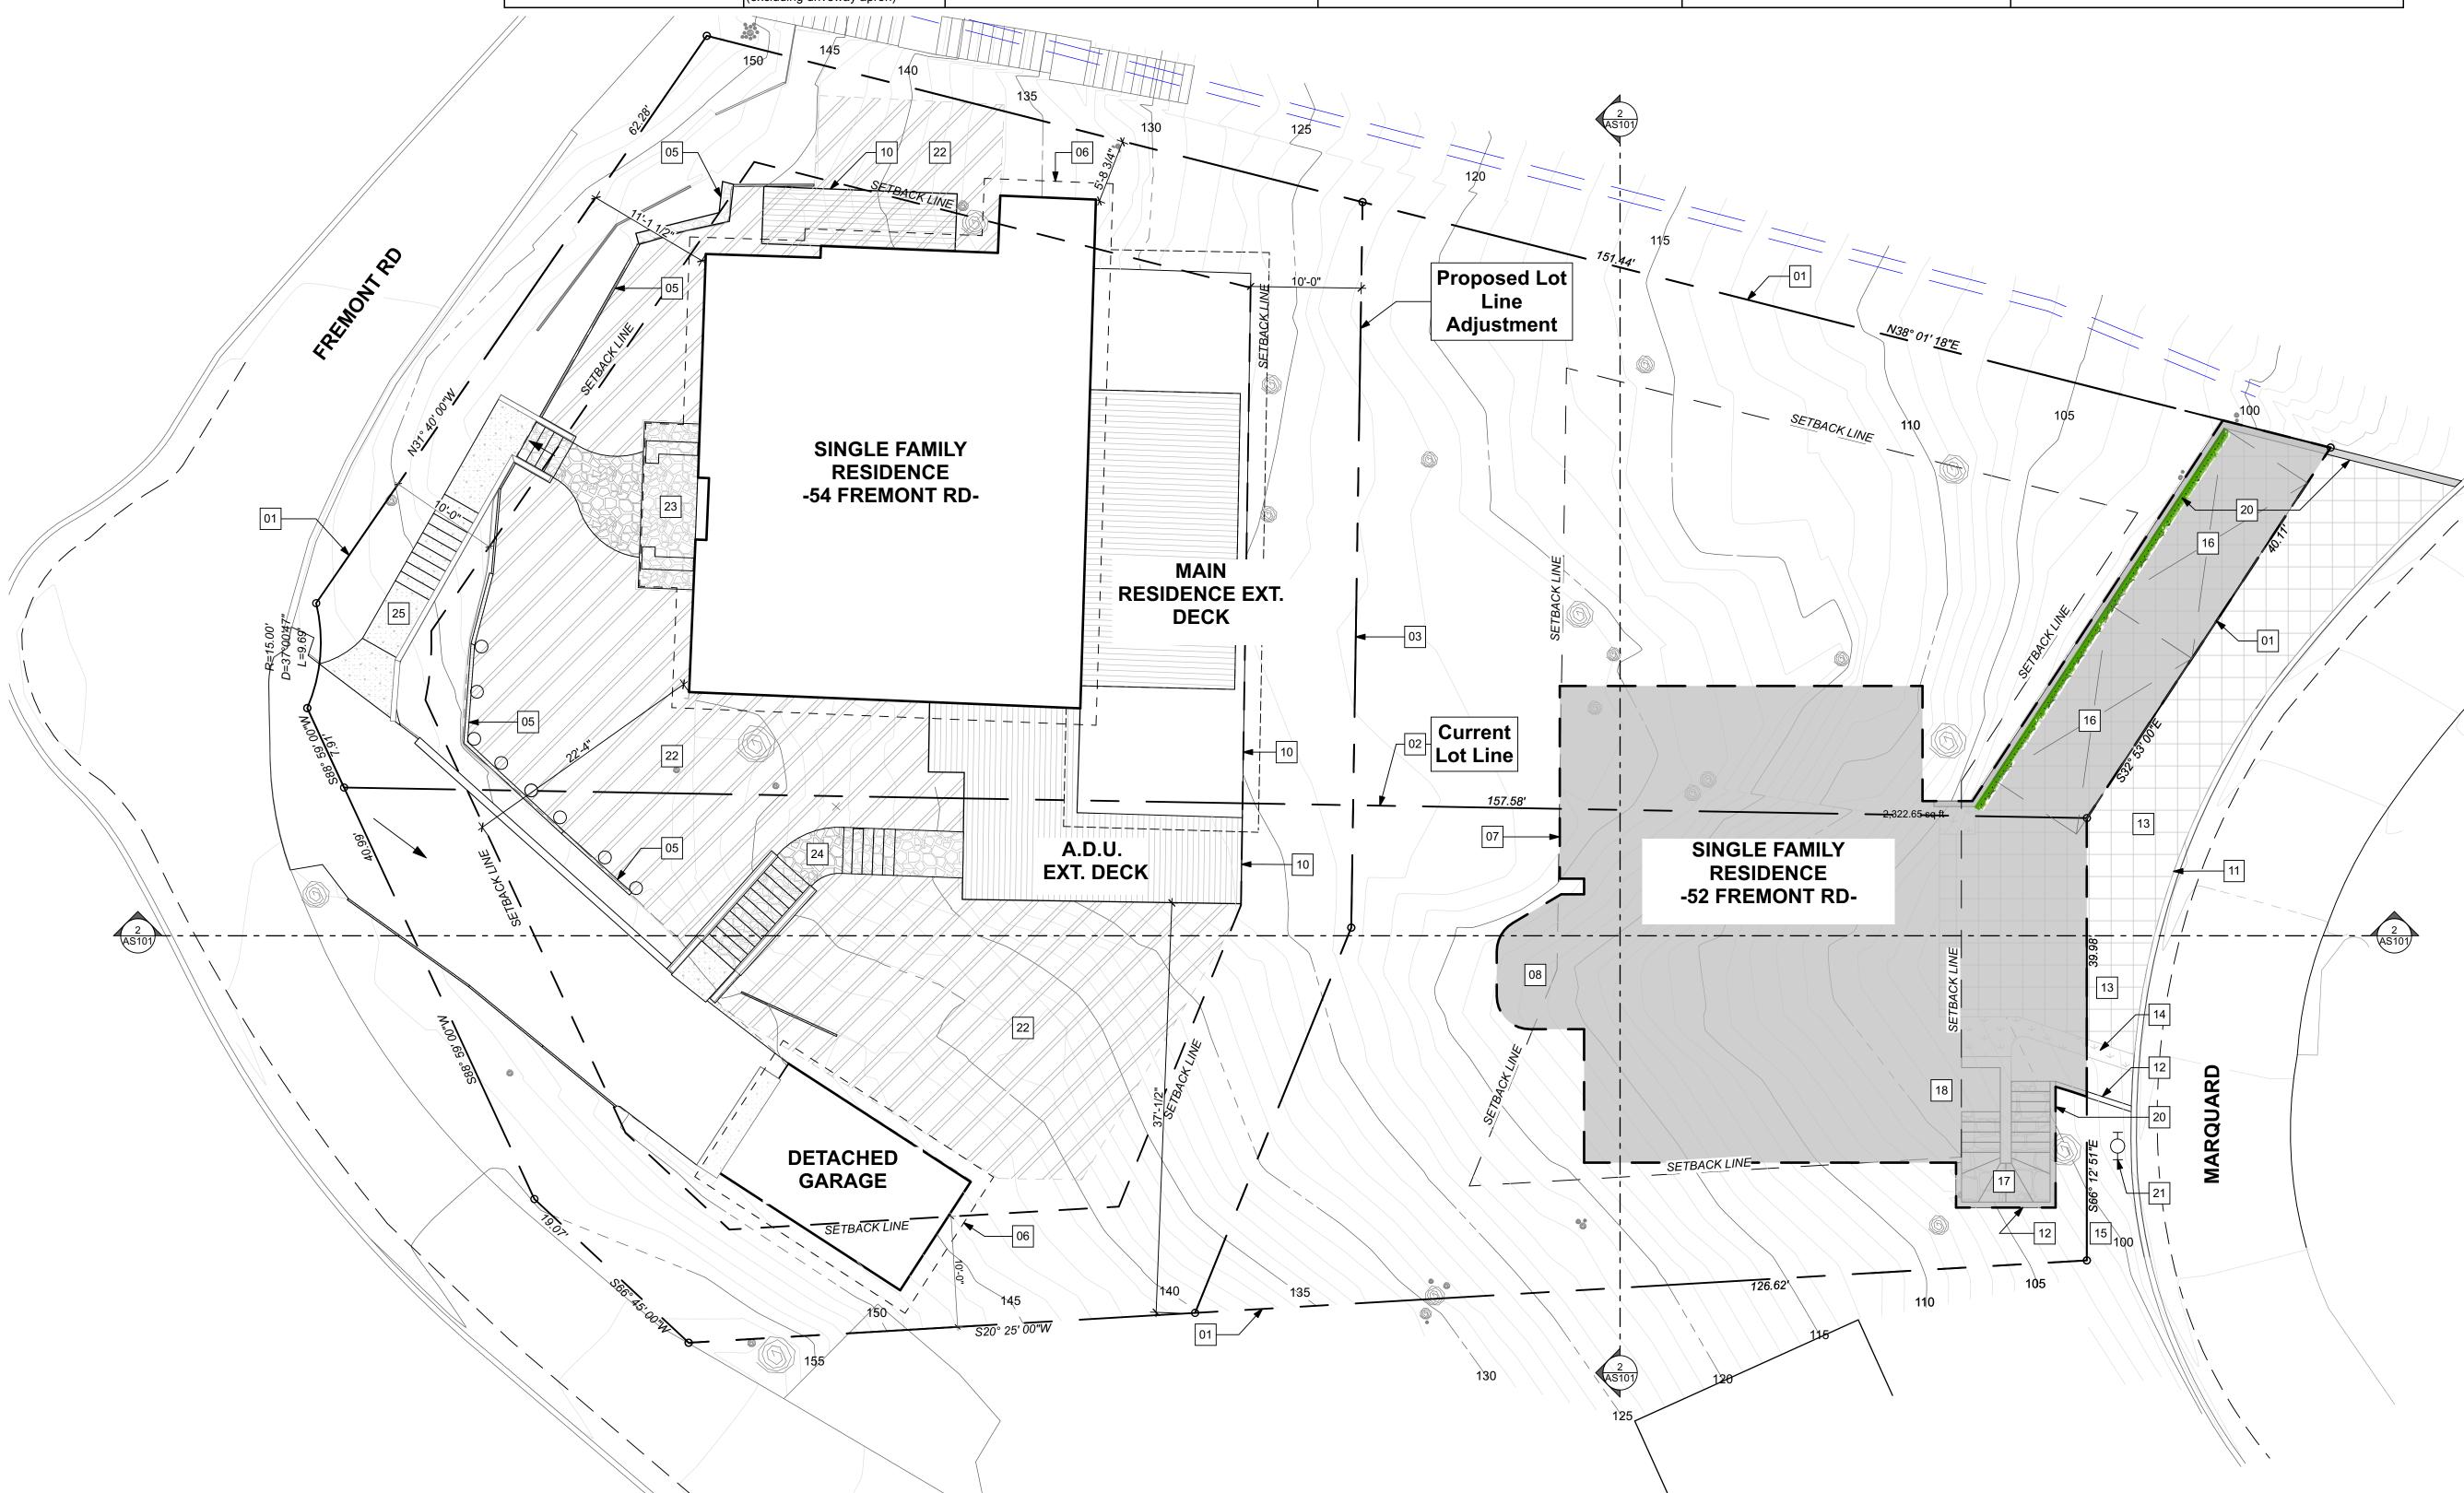
Drawn: GPB Job: 1801

PRELIMINARY NOT FOR CONSTRUCTION

VMP1.0



	Required	54 Fremont Rd. (Existing Lot)	New Fremont Rd. Frontage Lot	52 Fremont Rd. (Existing Lot)	New Marquard Ave. Frontage Lot	
Zoning: R10 + Hillside Overlay Zone						
Lot Size	10,000 s.f. min.	8643 s.f.	8643 s.f.	6587 s.f.	6587 s.f. (same as old Fremont Rd)	
Lot Coverage	40%	27.4% = 2368 s.f.	35.66% = 2899 s.f.	3.5% = 232 s.f.	30.3% = 1995.9 s.f.	
Setbacks						
ront	20 ft.	11'-1" (non-conforming)	11'-1" (non-conforming)	13'-1"	20'-0"	
Side Top	10 ft.	7" (non-conforming)	5'-7" (non-conforming)	24'-2"	17'-10"	
Side Bottom	10 ft.	1'-1" Encroachment (non-conforming)	36'-9"	3'-8" (non-conforming)	10'-0"	
Rear	10 ft.	76'-4"	9'-6" (non-conforming)	10'-0"	15'-7"	
Gross Building Square Footage	2500 s.f. + 10% of Lot Area	Allowed: 2500 s.f. + (10% of 8643 s.f.) = 3364 s.f.; Current: 3072 s.f. Main Dwelling Upper Level: 1600 s.f. Main Dwelling Lower Level: 1240 s.f. Garage: 232 s.f.	Allowed: 2500 s.f. + (10% of 8643 s.f.) = 3364 s.f.; Proposed: 3130 s.f. Main Dwelling:1554 s.f. Garage: 232 s.f. ADU: 1104 s.f. Carport: 240 s.f. Main Deck: 707 s.f. 296 s.f. Main Deck 2: 75 s.f.	Allowed: 2500 s.f. + (10% of 6587 s.f.) = 3159 s.f.; Current: 231 s.f.	Allowed: 2500 s.f. + (10% of 6587 s.f.) = 3158 s.f.; Current: 2492 s.f. (complies) Basement: 196 s.f. (old-186 s.f.) First Floor: 1339 s.f. (old-1487 s.f.) Second Floor: 957 s.f. (old- 1274 s.f.) Total: 2492 s.f. (old- 2947 s.f.)	
Natural State Preservation of Lot	25% + Slope %	Minimum: 25% + 35.36% = 60.36% of 8643 s.f. = 5217 s.f.; Current: 57% = 4875 s.f.	Minimum: 25% + 40.69% = 65.69% of 8643 s.f. = 5678 s.f.; Proposed: 57% = 4933 s.f.	Minimum: 25% + 46.33% = 71.33% of 6587 s.f. Min= 4699 s.f.; Current: 6355 s.f. = 96%	Minimum: 25% + 39.42% = 64.42% of 6587 s.f. = 4243 sf s.f.; Proposed: 63.16% = 4264 s.f.	
Height	30 ft. from natural grade to roof peak (20 ft. within 15 ft. of building envelope)	30'-11" (non-conforming)	23'-5"	10'-8"	26'-7"	
Parking	2 covered + 2 additional (excluding driveway apron)	none	2 covered (1 Garage + 1 Carport)	1 covered (garage)	2 covered + 2 additional (excluding driveway apron)	



SITE PLAN

SITE PLAN GENERAL NOTES

- REFER TO "EXCAVATION NOTES", DIVISION 31, SHT. G-002, FOR CITY OF SAUSALITO EXCAVATION REQUIREMENTS.
- REFER TO "GRADING NOTES", DIVISION 31, SHT. G-002, FOR GRADING REQUIREMENTS.
- REFER TO "TREE PROTECTION NOTES", DIVISION 1, SHT. G-001, FOR MARIN COUNTY
- MANDATORY TREE PROTECTION MEASURES. REFER TO "EROSION CONTROL NOTES", DIVISION 1, SHT. G-001, FOR MANDATORY
- REFER TO "DUST MITIGATION PLAN", DIVISION 1, SHT. G-001, FOR CITY OF SAUSALITO DUST MITIGATION REQUIREMENTS.

EROSION CONTROL MEASURES.

REFER TO "CONSTRUCTION MANAGEMENT PLAN", DIVISION 1, SHT. G-001, FOR CITY OF SAUSALITO CONSTRUCTION MANAGEMENT MEASURES.

SITE PLAN SYMBOLS LEGEND

BOTTOM OF WALL SPOT ELEVATION PER SURVEY DATUM

> TOP OF WALL SPOT **ELEVATION PER** SURVEY DATUM

DWG. # A-300 LAYOUT # SITE SECTION CALLOUT

TOPOGRAPHIC LINES —100— @ 2'-0" INTERVAL

--- — -- PROPERTY LINE

KEY NOTE CALLOUT -◄ 11 SEE "SITE PLAN **KEYNOTES" BELOW**

> LOCATION OF DOWNSPOUT CONNECTION TO SUBSURFACE STORM DRAINAGE SYSTEM - SEE DRAINAGE PLANS

SITE PLAN KEY NOTES

01 - (E) PROPERTY LINE TO REMAIN

02 - (E) PROPERTY LINE TO BE VACATED

03 - PROPOSED PROPERTY LINE

04 - (E) STEPS / PATHSTONES TO REMAIN TYP.

05 - (E) RET'G WALLS TO REMAIN TYP.

06 - LINE OF ROOF OVERHANG ABOVE

07 - PERIMETER LINE OF PROPOSED SINGLE

FAMILY RESIDENCE

08 - PROPOSED SLAB ON GRADE PATIO

09 - PROPOSED DECK SUPPORT POST

10 - LINE OF PROPOSED DECK ABOVE

11 - EDGE OF DRIVEWAY

12 - PROPOSED RET'G WALL

13 - STAMPED CONC. DRIVEWAY

14 - PLANTING STRIP

15 - BIORETENTION BASIN

16 - 10' X 20' GUEST PARKING SPACE

17 - ENTRY STAIRS

18 - ENTRY PORCH

19 - LINE OF TRELLIS ABOVE TYP.

20 - LIVING WALL "FLORAFELT" WALL SYSTEM OR SIM. (WALL EMBELLISHMENT)

21 - RELOCALED HYDRANT

22 - AREA OF FREMONT FRONTAGE LOT TO BE REVERTED TO NATURAL STATE - SHOWN WITH DIAGONAL DOUBLE LINE. SEE LANDSCAPE PLAN, SHEET L1.

23 - PORCH

24 - WALKWAY / STAIRS TO A.D.U.

25 - WALKWAY / STAIRS TO RESIDENCE

PROJECT #: CAD16115#:remont Road22 - Main - 11-20-2020 DRAWN BY: CHECKED BY: COPYRIGHT © 2018 ARTERBERRY DESIGN

SITE PLAN


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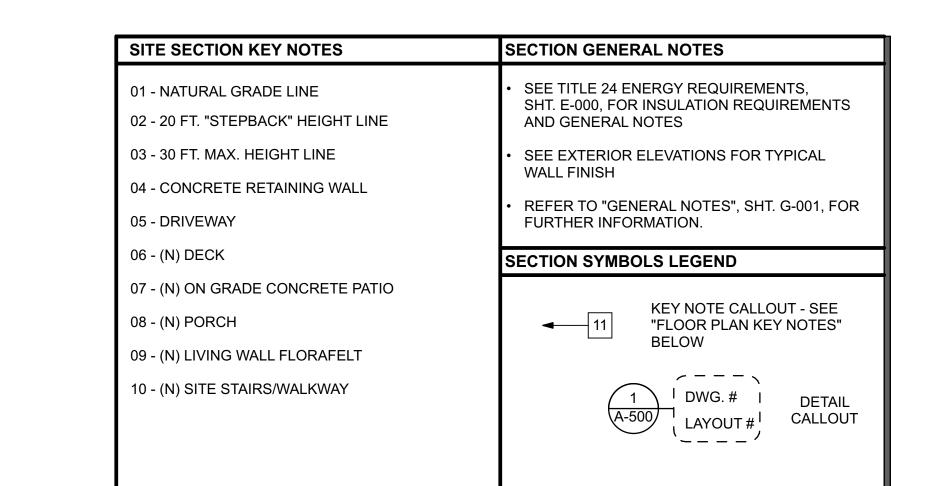
52/54 Fremont San Rafael CA A.P.N.: 012-043-

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Q Z





Owner:
vate Money Fund I, LLC
b Mark Hanf, Manager
555 Grant Ave.
vato, CA 94945

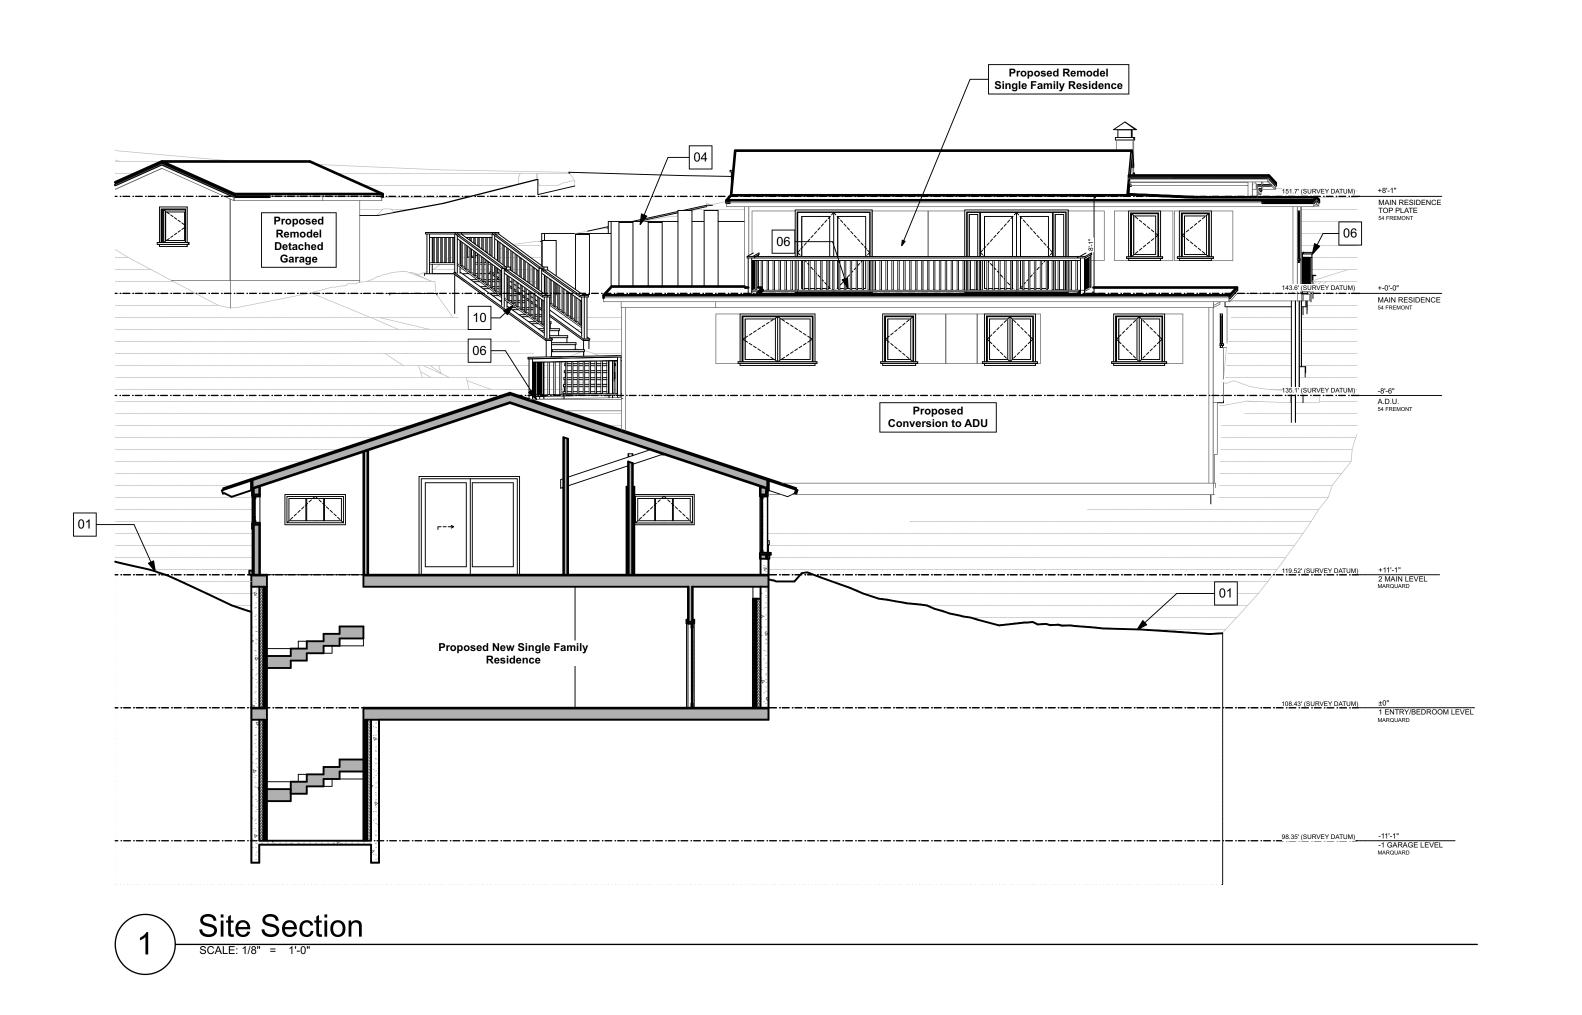Fremont Street afael CA 94965 012-043-11 & 12

.P.N 012-043-1

BMISSION 52/54 F
BMISSION San Rafa
BMISSION A.P.N.: 0

ISSUES	DESCRIPTION	PLANNING SUBMISSION						
	DATE	7/02/18	2/04/19	4/04/19	7/26/19	2/24/2020	9/24/2020	11/20/2020
	MARK							

PROJECT #: 1805


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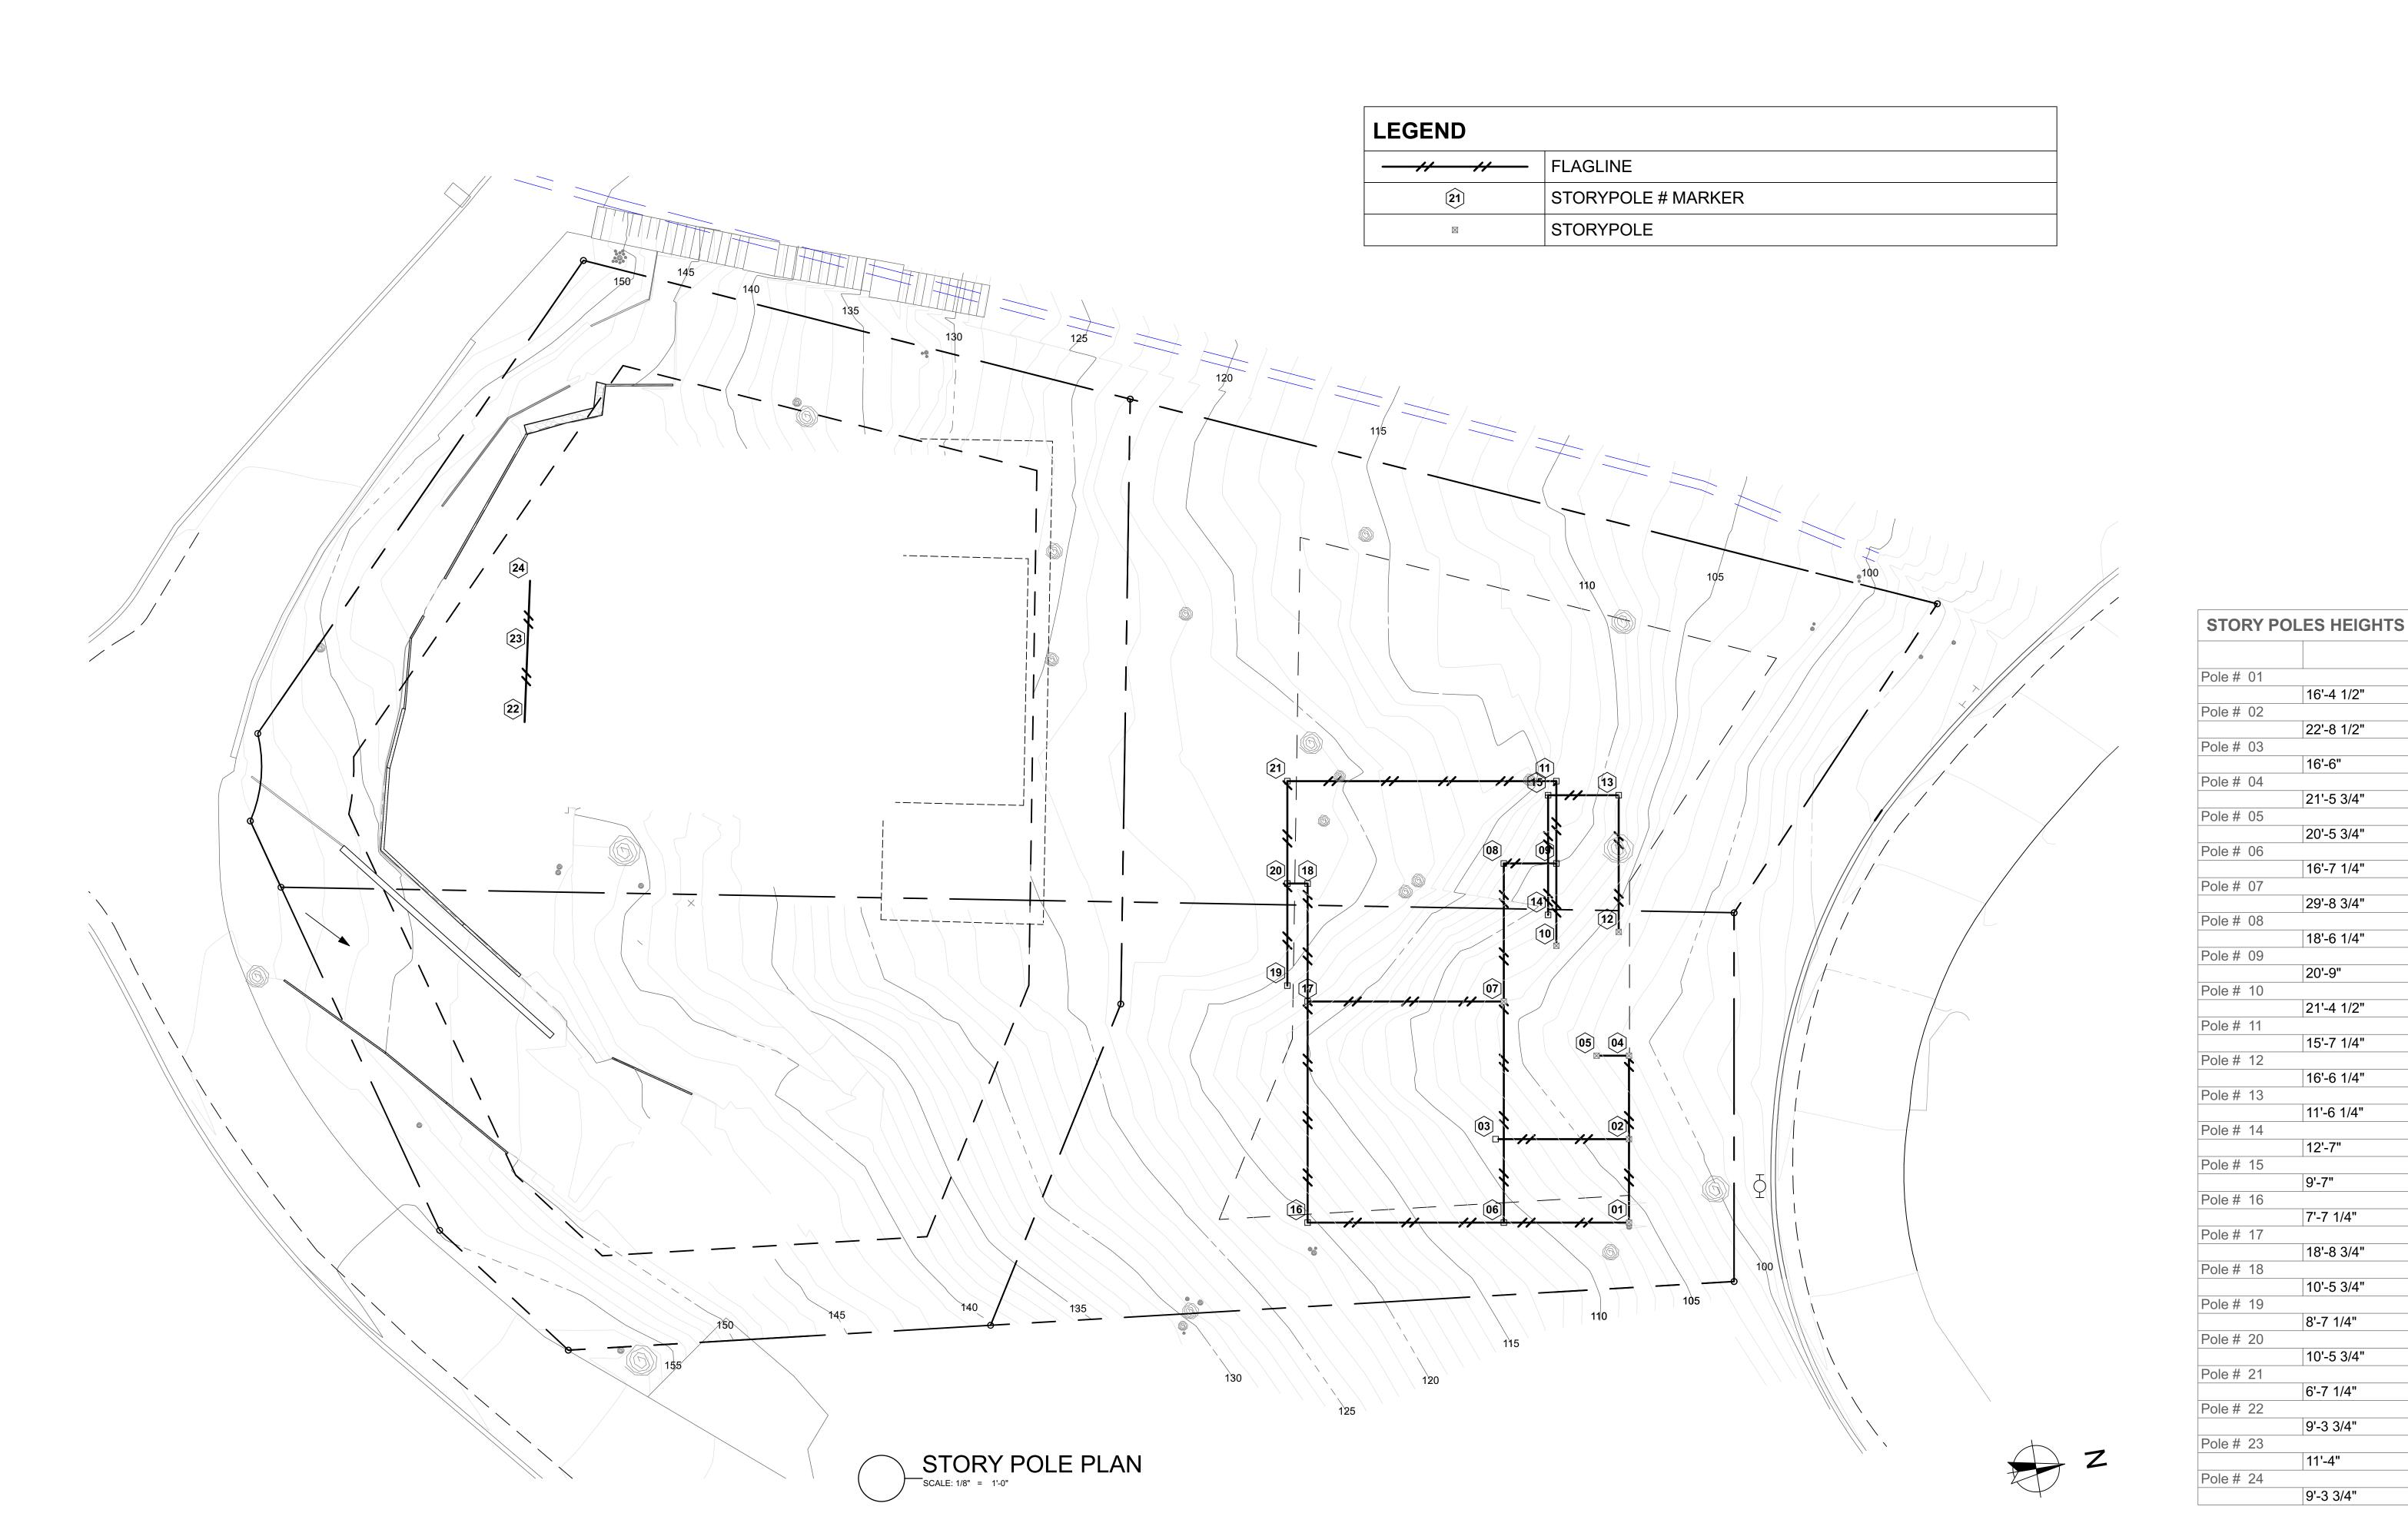
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AS101







&12 A.P.N 012-043-1

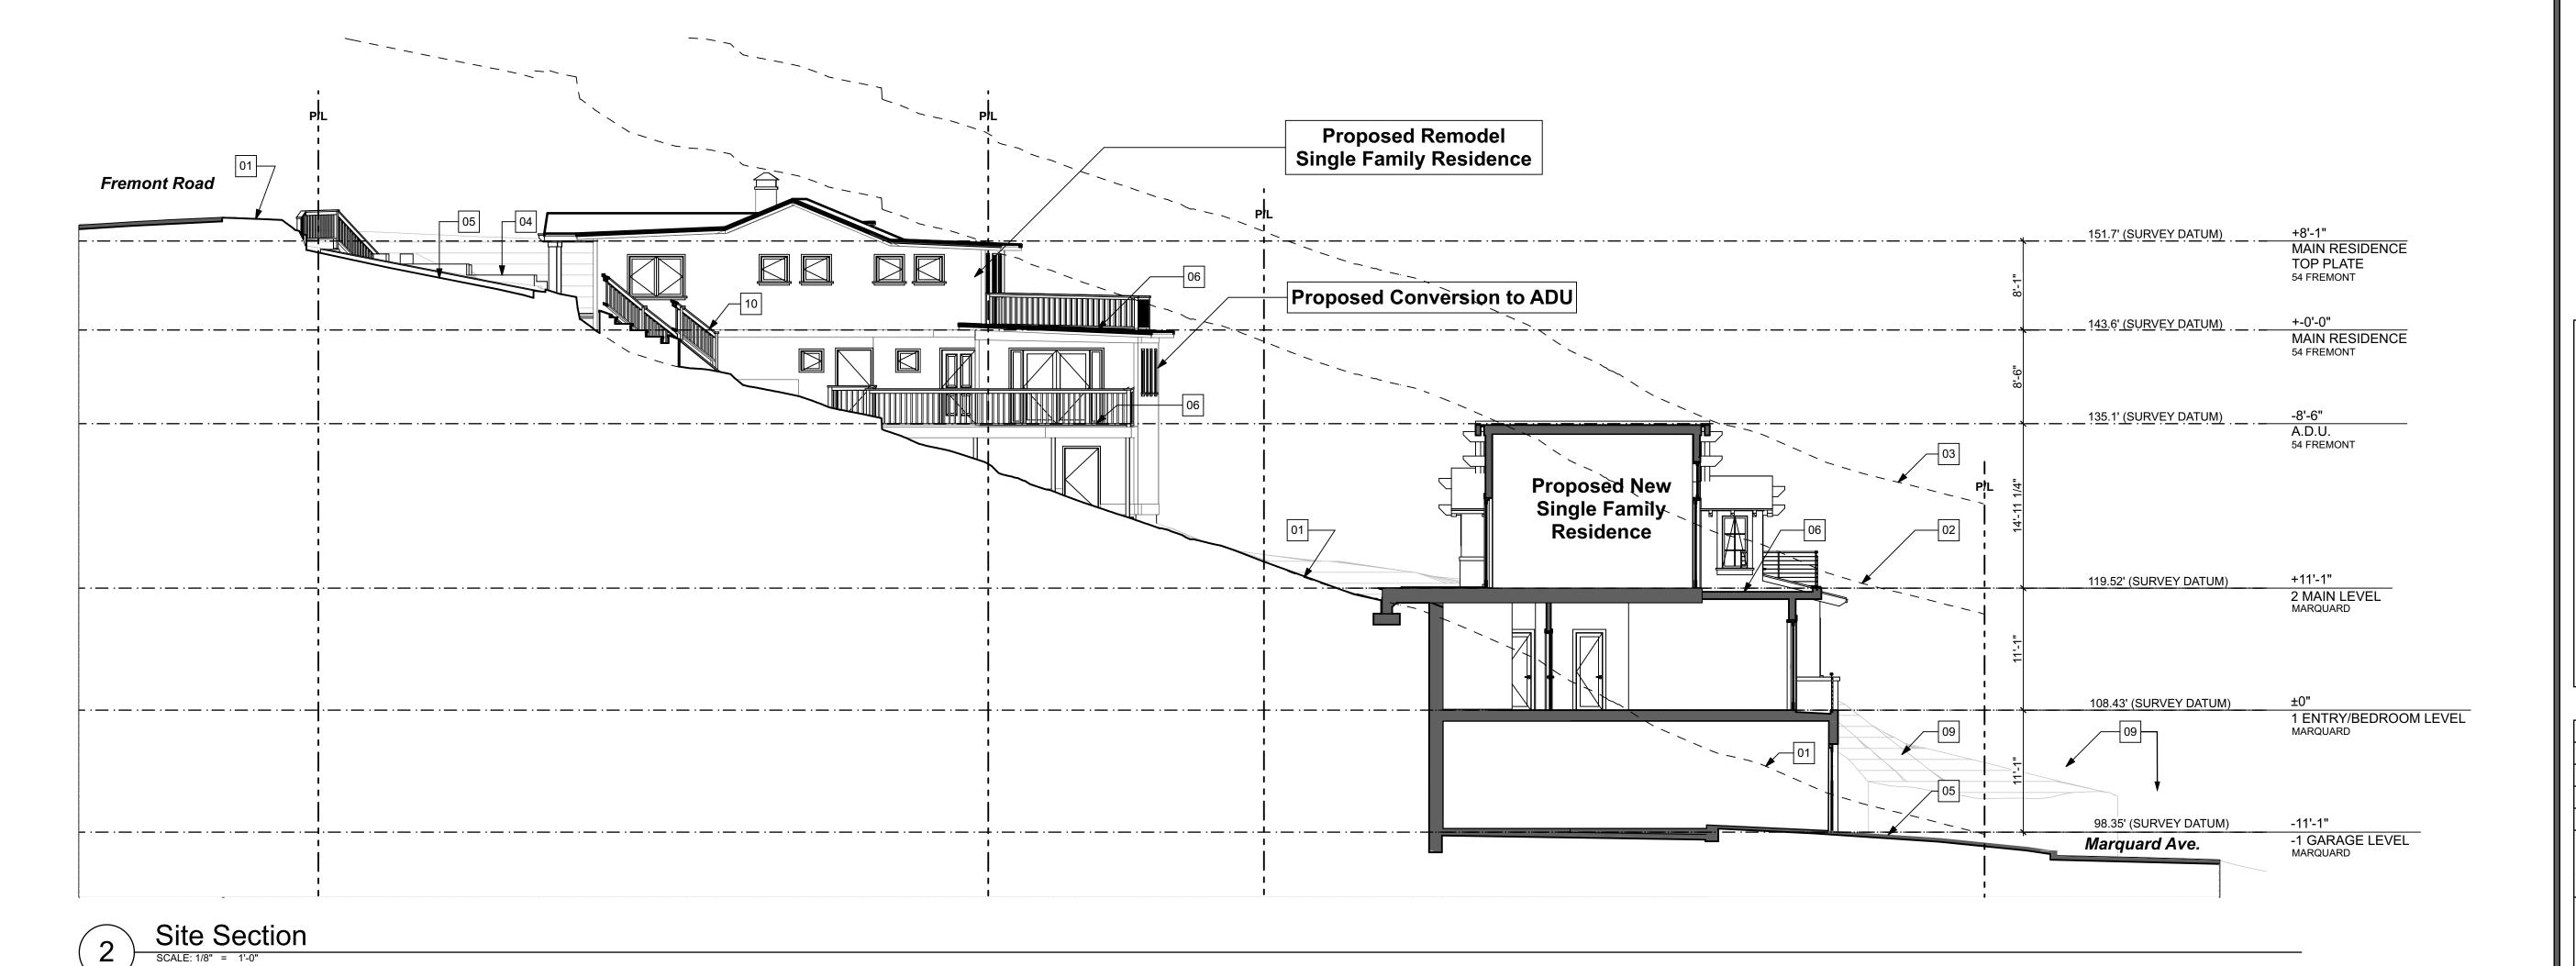16'-4 1/2"

22'-8 1/2"

21'-5 3/4"

20'-5 3/4"

16'-7 1/4"

29'-8 3/4"

18'-6 1/4"

21'-4 1/2"

15'-7 1/4"

16'-6 1/4"

11'-6 1/4"

12'-7"

9'-7"

7'-7 1/4"

18'-8 3/4"

10'-5 3/4"

8'-7 1/4"

10'-5 3/4"

6'-7 1/4"

9'-3 3/4"

11'-4"


9'-3 3/4"

20'-9"

16'-6"

AS102



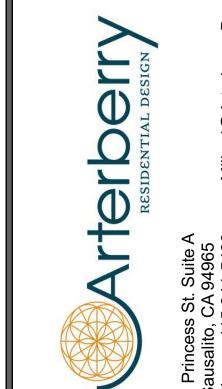

nd I, LLC anager 15

Pacific Private Money Fund I, Et Al c/o Mark Hanf, Manag 1555 Grant Ave. Novato, CA 94945

> 52/54 Fremont Street San Rafael CA 94965

A.P.N 012-043-1

		ISSUES
~	DATE	DESCRIPTION
	7/02/18	PLANNING SUBMISSION
	2/04/19	PLANNING SUBMISSION
	4/04/19	PLANNING SUBMISSION
	7/26/19	PLANNING SUBMISSION
	2/24/2020	PLANNING SUBMISSION
	9/24/2020	PLANNING SUBMISSION
	11/20/2020	PLANNING SUBMISSION

PROJECT #: 1805


CAD 1815E:remont Road22 - Main - 11-20-202

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RENDERINGS





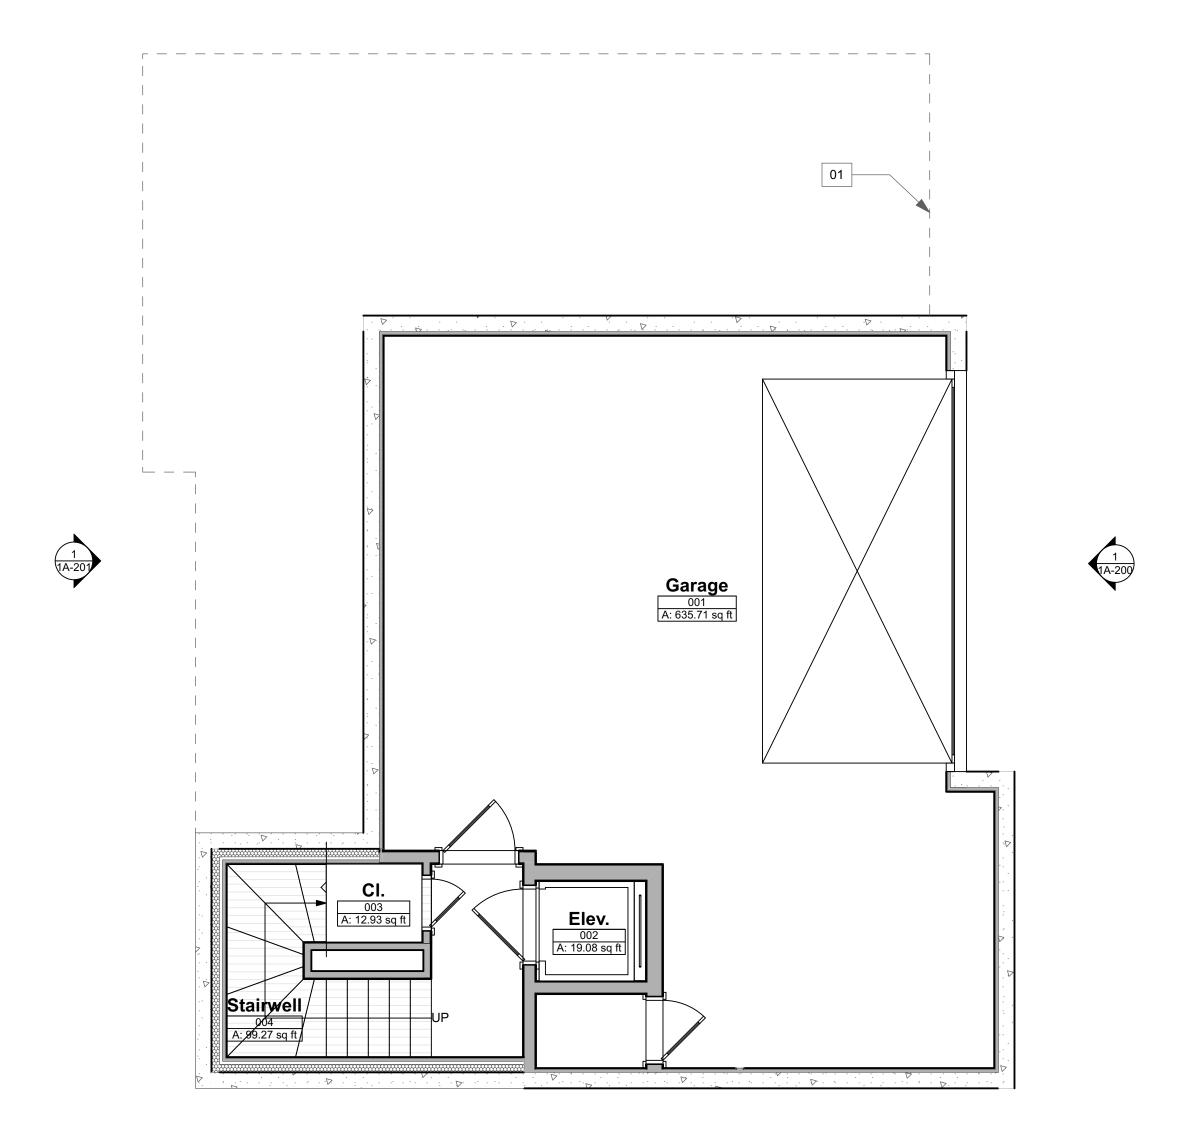


GROSS BUILDING SQUARE FOOTAGE: 186 S.F. SUBFLOOR LEVEL: +98.35'

BASEMENT FLOOR PLAN

SCALE: 1/4" = 1'-0"



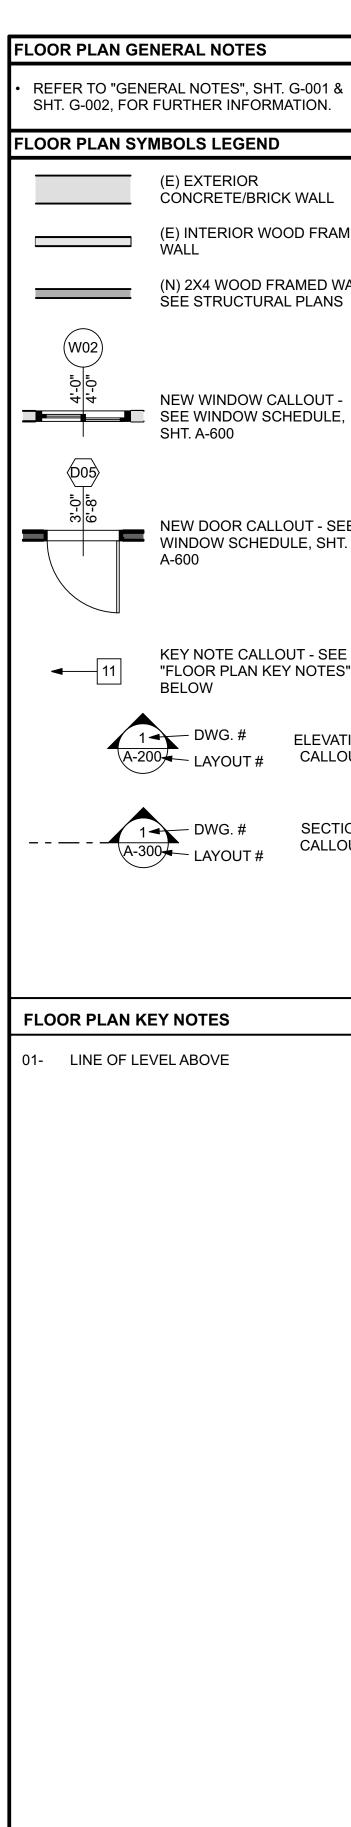


(E) EXTERIOR CÓNCRETE/BRICK WALL (E) INTERIOR WOOD FRAMED (N) 2X4 WOOD FRAMED WALL -SEE STRUCTURAL PLANS NEW WINDOW CALLOUT - SEE WINDOW SCHEDULE, SHT. A-600 NEW DOOR CALLOUT - SEE WINDOW SCHEDULE, SHT. KEY NOTE CALLOUT - SEE "FLOOR PLAN KEY NOTES" **ELEVATION** CALLOUT SECTION CALLOUT A.P.N 012-043-1

PROJECT #:	1805					
CAD16115E:remont Road22 - Main - 11-2						
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CHECKED BY:	MNA					
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DACEMEN	IT EL COD					

BASEMENT FLOOR PLAN



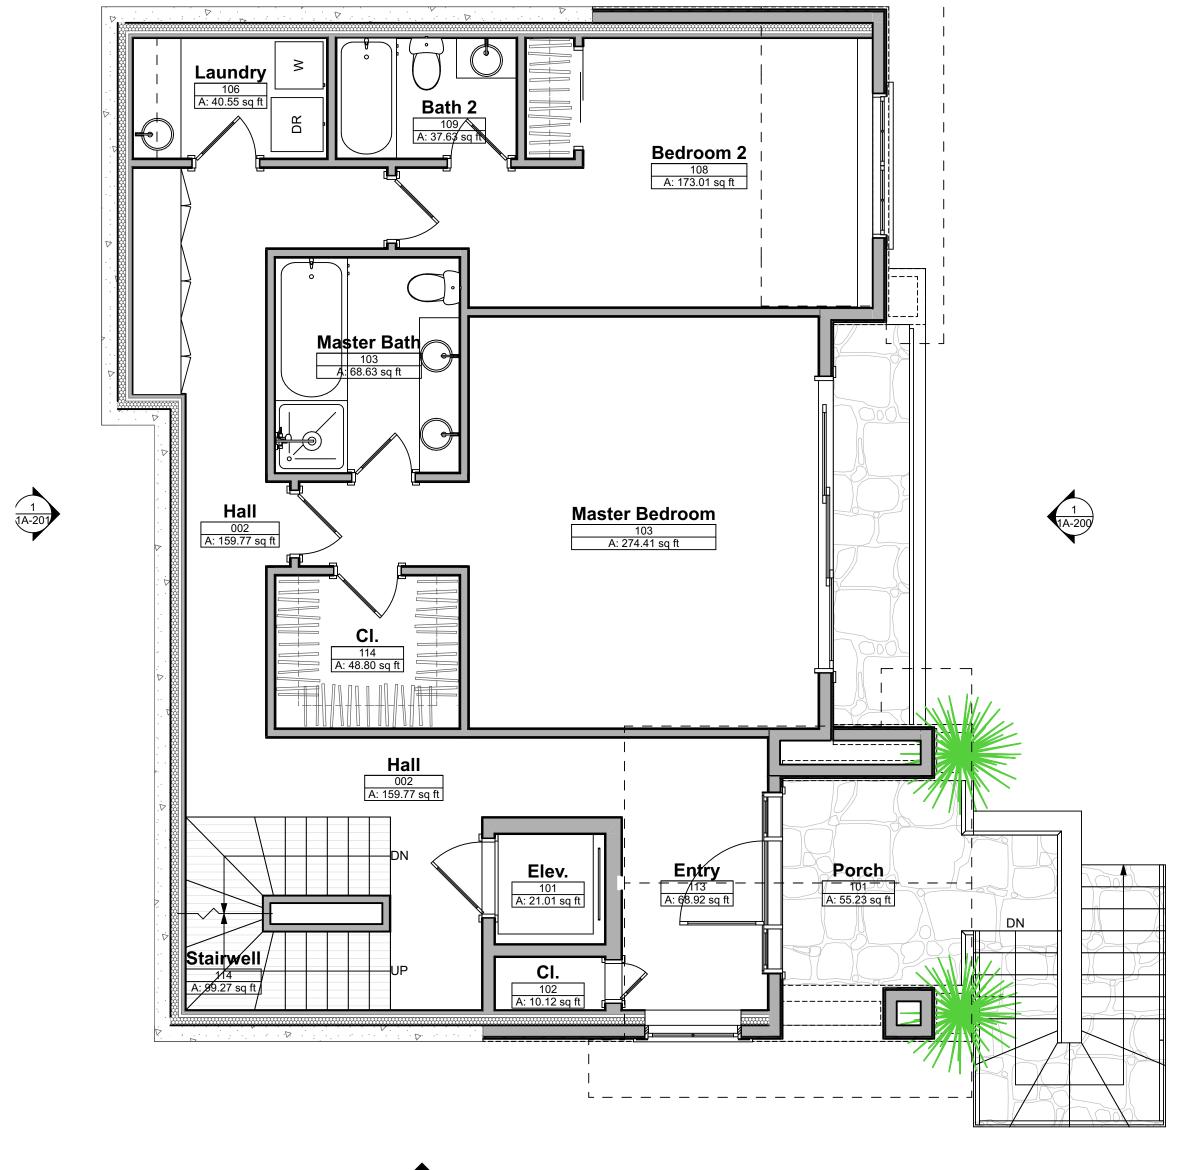

2 1A-201

GROSS BUILDING SQUARE FOOTAGE: 1487 S.F. SUBFLOOR LEVEL: +111.43'

FIRST FLOOR PLAN
SCALE: 1/4" = 1'-0"



**REFER TO "GENERAL NOTES", SHT. G-001 & SHT. G-002, FOR FURTHER INFORMATION.

FLOOR PLAN SYMBOLS LEGEND

(E) EXTERIOR CONCRETE/BRICK WALL

(E) INTERIOR WOOD FRAMED WALL-SEE STRUCTURAL PLANS

NEW WINDOW CALLOUT - SEE WINDOW SCHEDULE, SHT. A-600

NEW DOOR CALLOUT - SEE WINDOW SCHEDULE, SHT. A-600

KEY NOTE CALLOUT - SEE "FLOOR PLAN KEY NOTES" BELOW

A-200

DWG. #**

ELEVATION CALLOUT #**

LAYOUT #**

CALLOUT

**CALLOUT*

.P.N 012-043-11 &12 Pacific Pri

SECTION CALLOUT

| SSUES | DESCRIPTION | 7/02/18 | PLANNING SUBMISSION | 4/04/19 | PLANNING SUBMISSION | 7/26/19 | PLANNING SUBMISSION | 2/24/2020 | PLANNING SUBMISSION | 9/24/2020 | PLANNING SUBMISSION | 11/20/2020 | PLANNING SUBMISSION | PLANNING SUBMISSION | 11/20/2020 | PLANNING SUBMISSION | PLANNI

PROJECT #: 1805

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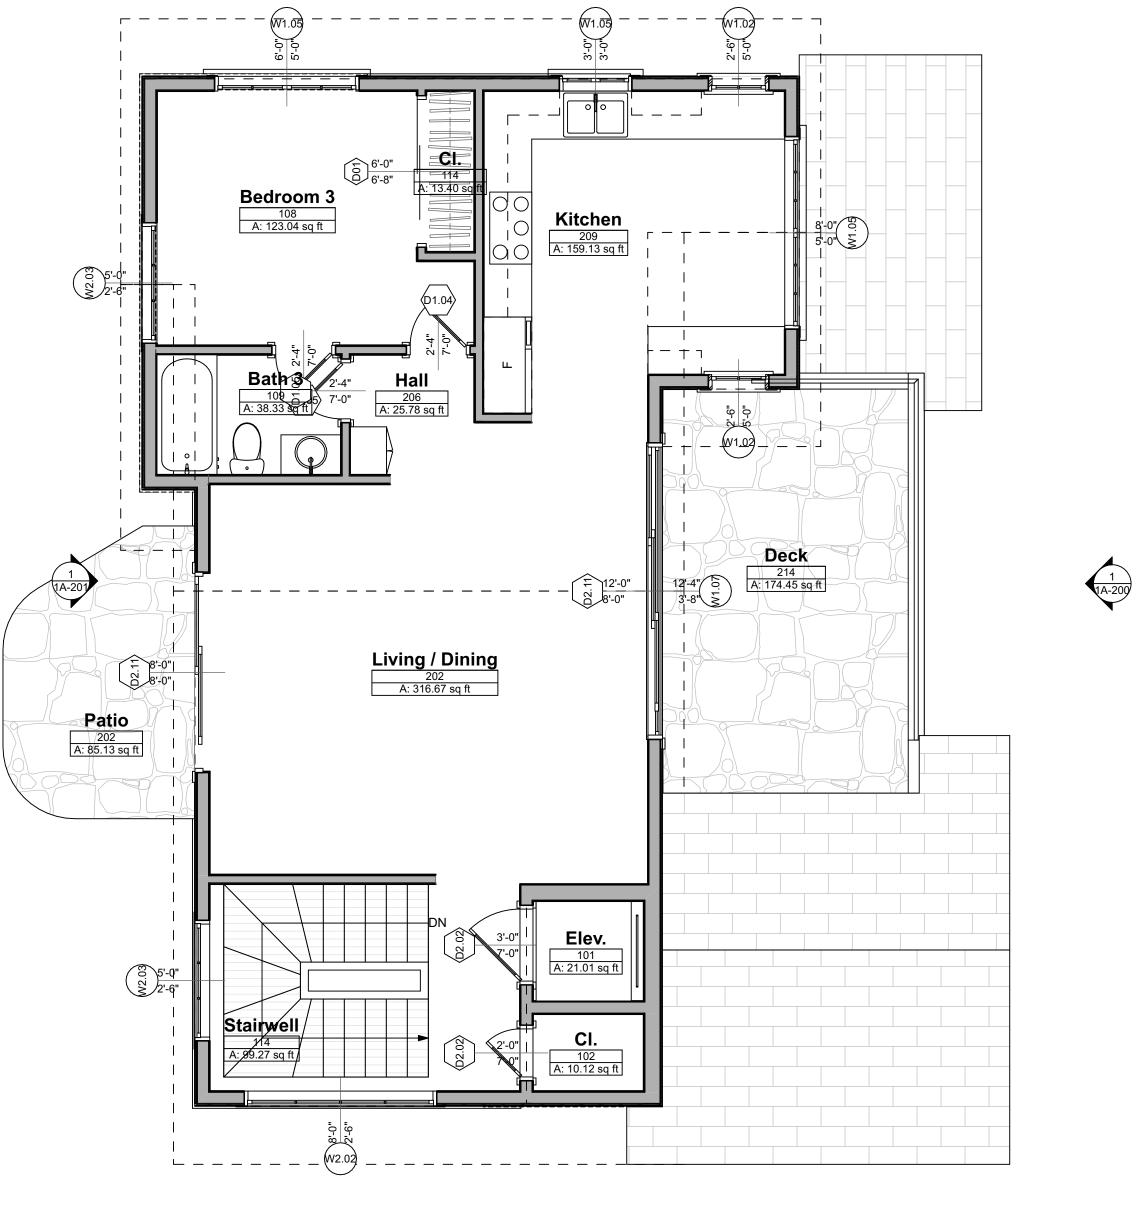
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FIRST FLOOR PLAN






GROSS BUILDING SQUARE FOOTAGE: 1274 S.F. SUBFLOOR LEVEL: +122.52'

SECOND FLOOR PLAN

SCALE: 1/4" = 1'-0"



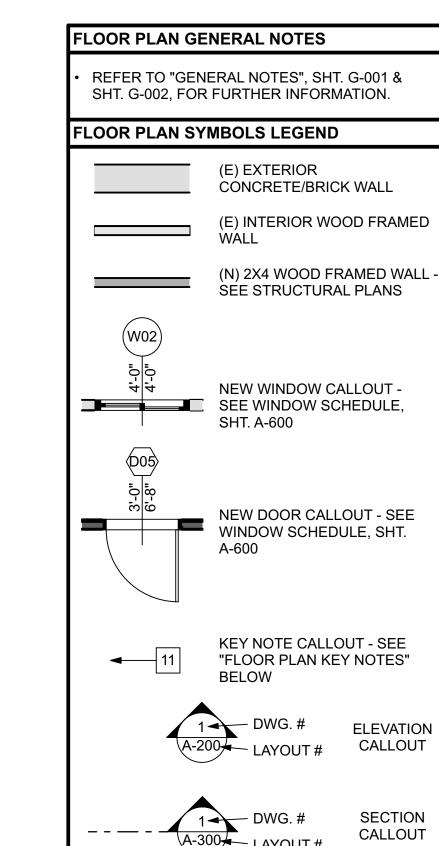


(E) INTERIOR WOOD FRAMED (N) 2X4 WOOD FRAMED WALL -SEE STRUCTURAL PLANS NEW DOOR CALLOUT - SEE WINDOW SCHEDULE, SHT. KEY NOTE CALLOUT - SEE "FLOOR PLAN KEY NOTES"

A.P.N 012-043-1

PROJECT #:	1805						
CAD1BIL5E:remont Road22 - Main - 11-20-							
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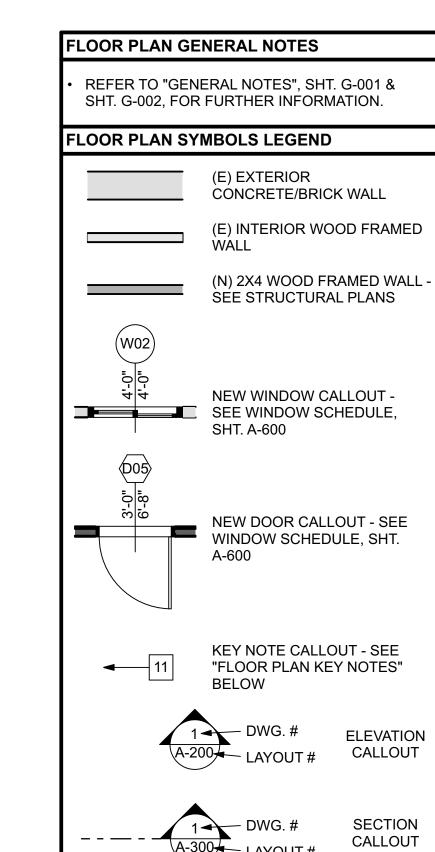
SECOND FLOOR PLAN





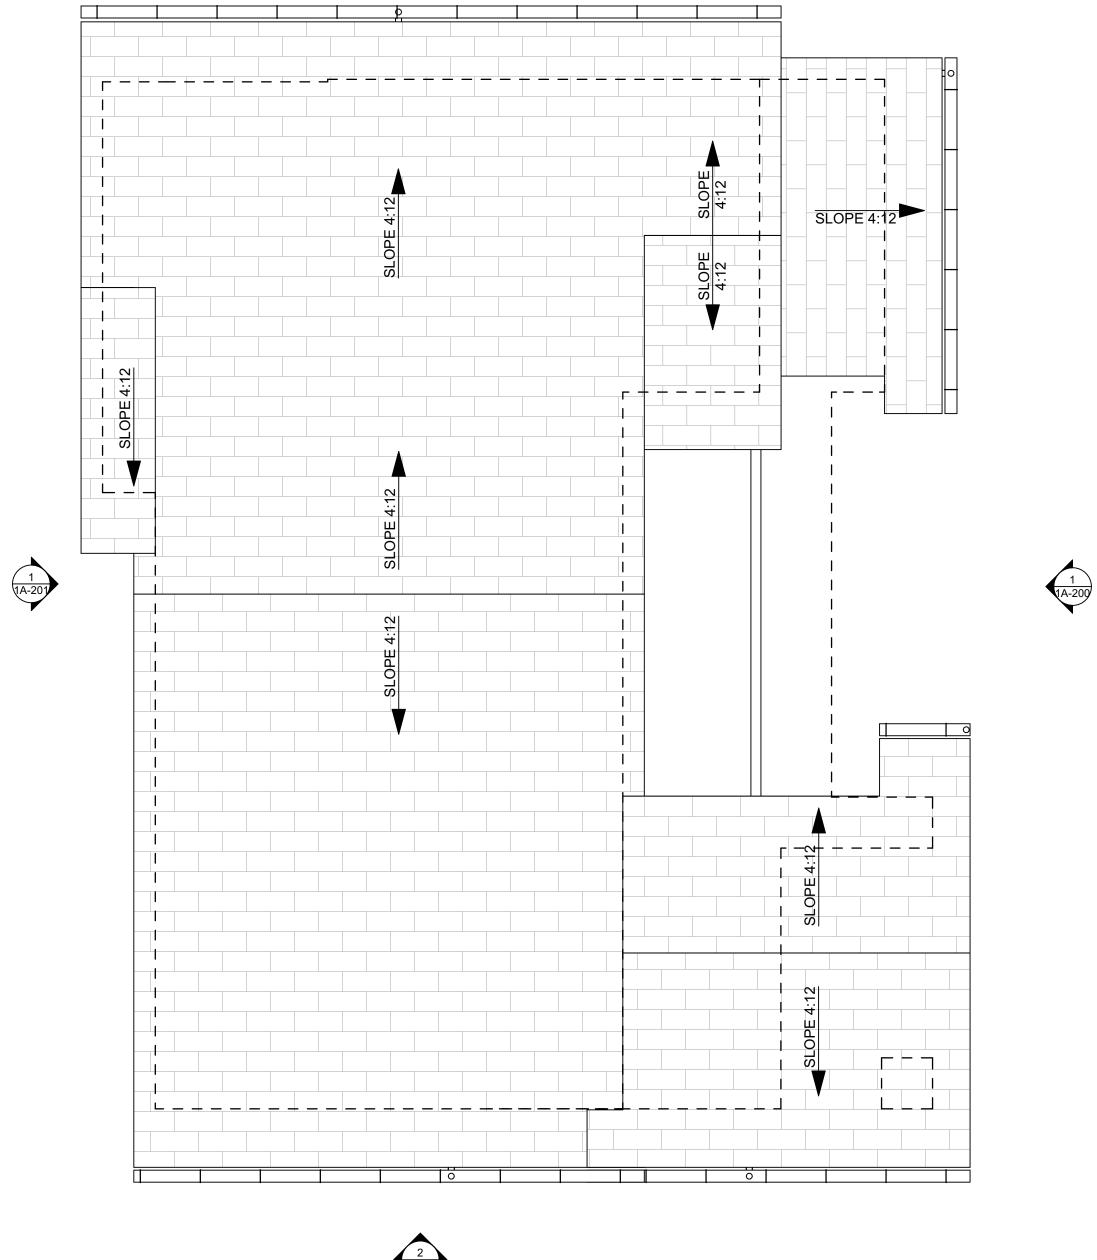





A.P.N 012-043-11 &12

Pacific Private Money Fund I, LLC


Et Al c/o Mark Hanf, Manager


52/54 Fremont Street San Rafael CA 94965 A.P.N.: 012-043-11 & 12


DESCRIPTION	PLANNING SUBMISSION						
DATE	7/02/18	2/04/19	4/04/19	7/26/19	2/24/2020	9/24/2020	11/20/2020
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PROJECT #:	1805				
CAD18115E:remont Road22 - Main - 11-20					
DRAWN BY:	MNA				
CHECKED BY:	MNA				
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ROOF PLAN





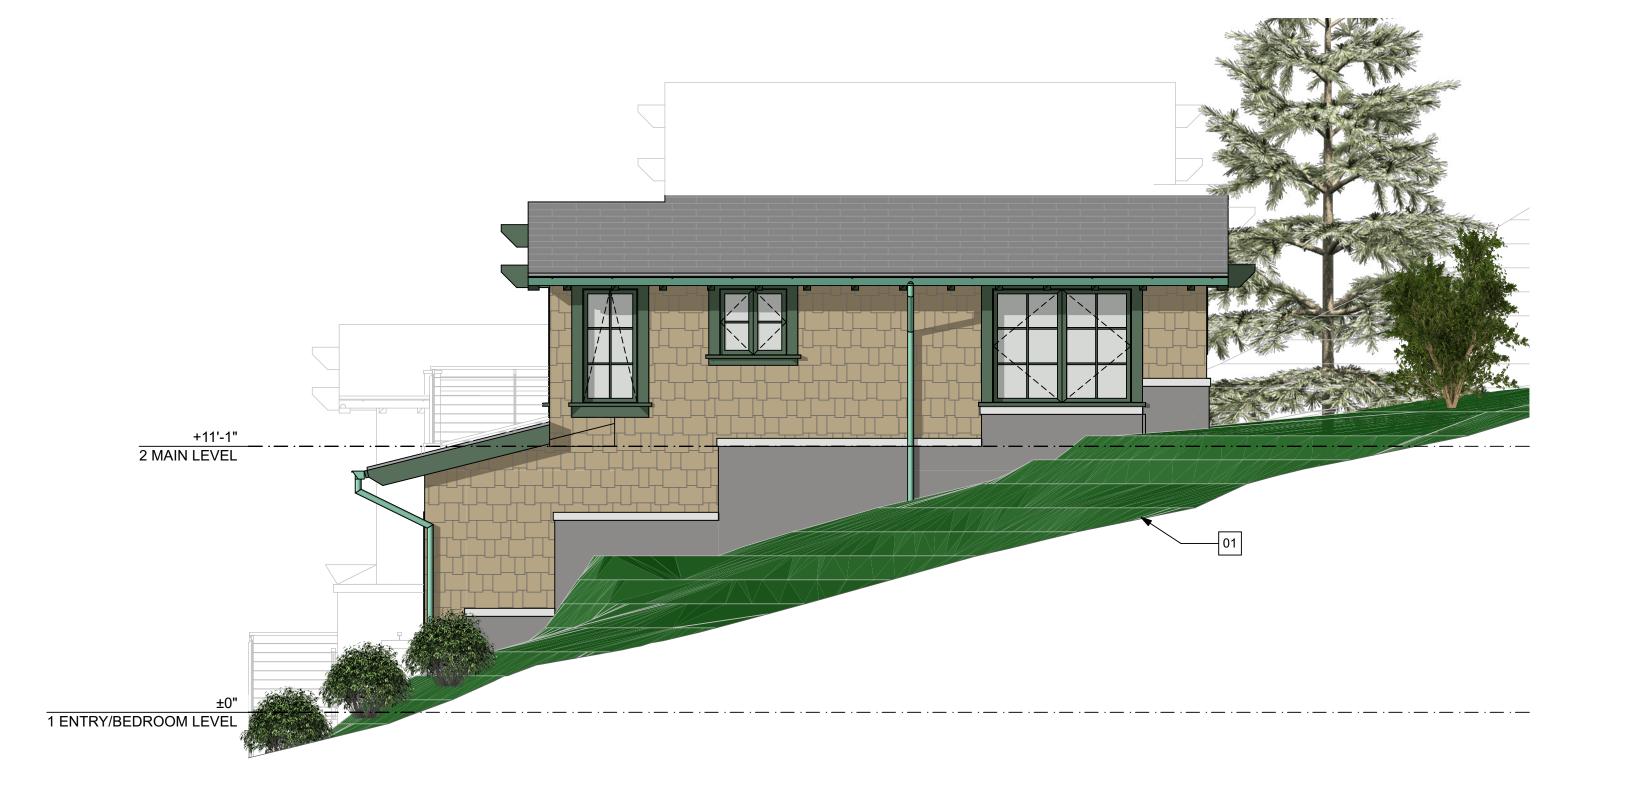

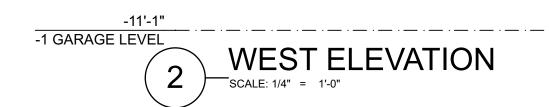EXTERIOR ELEVATION GENERAL NOTES

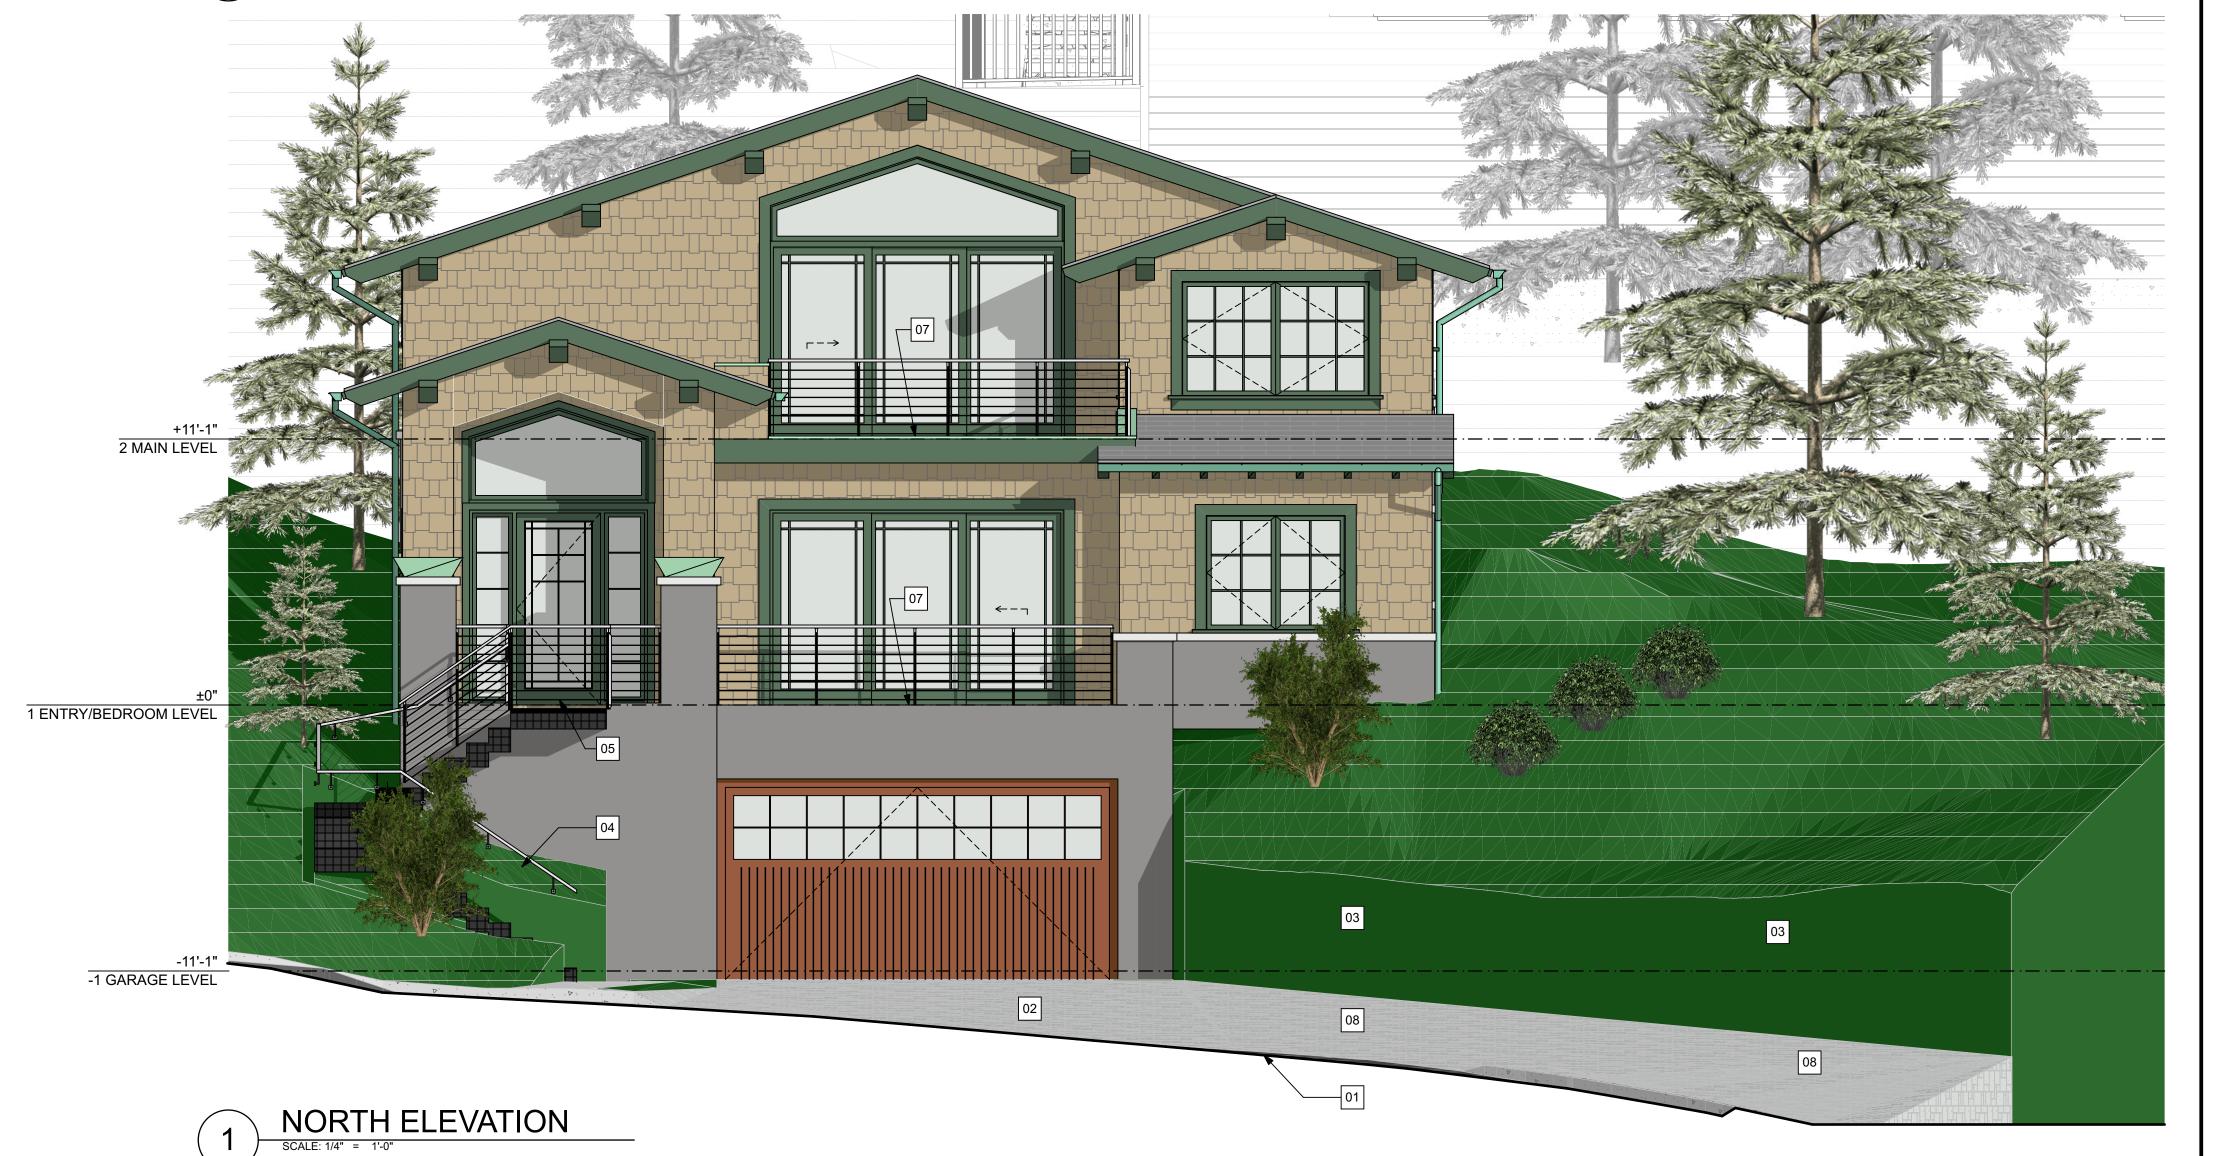• REFER TO "GENERAL NOTES", SHT. G-001 & SHT. G-002, FOR FURTHER INFORMATION.

EXTERIOR ELEVATION SYMBOLS LEGEND



KEY NOTE CALLOUT - SEE "FLOOR PLAN KEY NOTES" BELOW

EXTERIOR ELEVATION KEY NOTES

- 01- (E) GRADE LINE
- 02- DRIVEWAY
- 03- LIVING WALL (GREEN WALL)
- 04- ENTRY STAIRS
- 05- PORCH
- 06- PATIO SLAB
- 07- DECK
- 08- UNCOVERED PARKING SPACE



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Fund I, LLC ;, Manager tve. 4945

Pacific Private Money Fun-Et Al c/o Mark Hanf, Mar 1555 Grant Ave. Novato, CA 94945

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A.P.N 012-043-1


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52/54 Fremon San Rafael CA A.P.N.: 012-043

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	2/04/19	PLANNING SUBMISSION
	4/04/19	PLANNING SUBMISSION
	7/26/19	PLANNING SUBMISSION
	2/24/2020	PLANNING SUBMISSION
	9/24/2020	PLANNING SUBMISSION
	11/20/2020	PLANNING SUBMISSION

PROJECT #: 1805							
CAD 18115E:remont Road22 - Main - 11-20-							
DRAWN BY: MNA							
CHECKED BY: MNA							
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EXTERIOR ELEVATIONS



EXTERIOR ELEVATION GENERAL NOTES

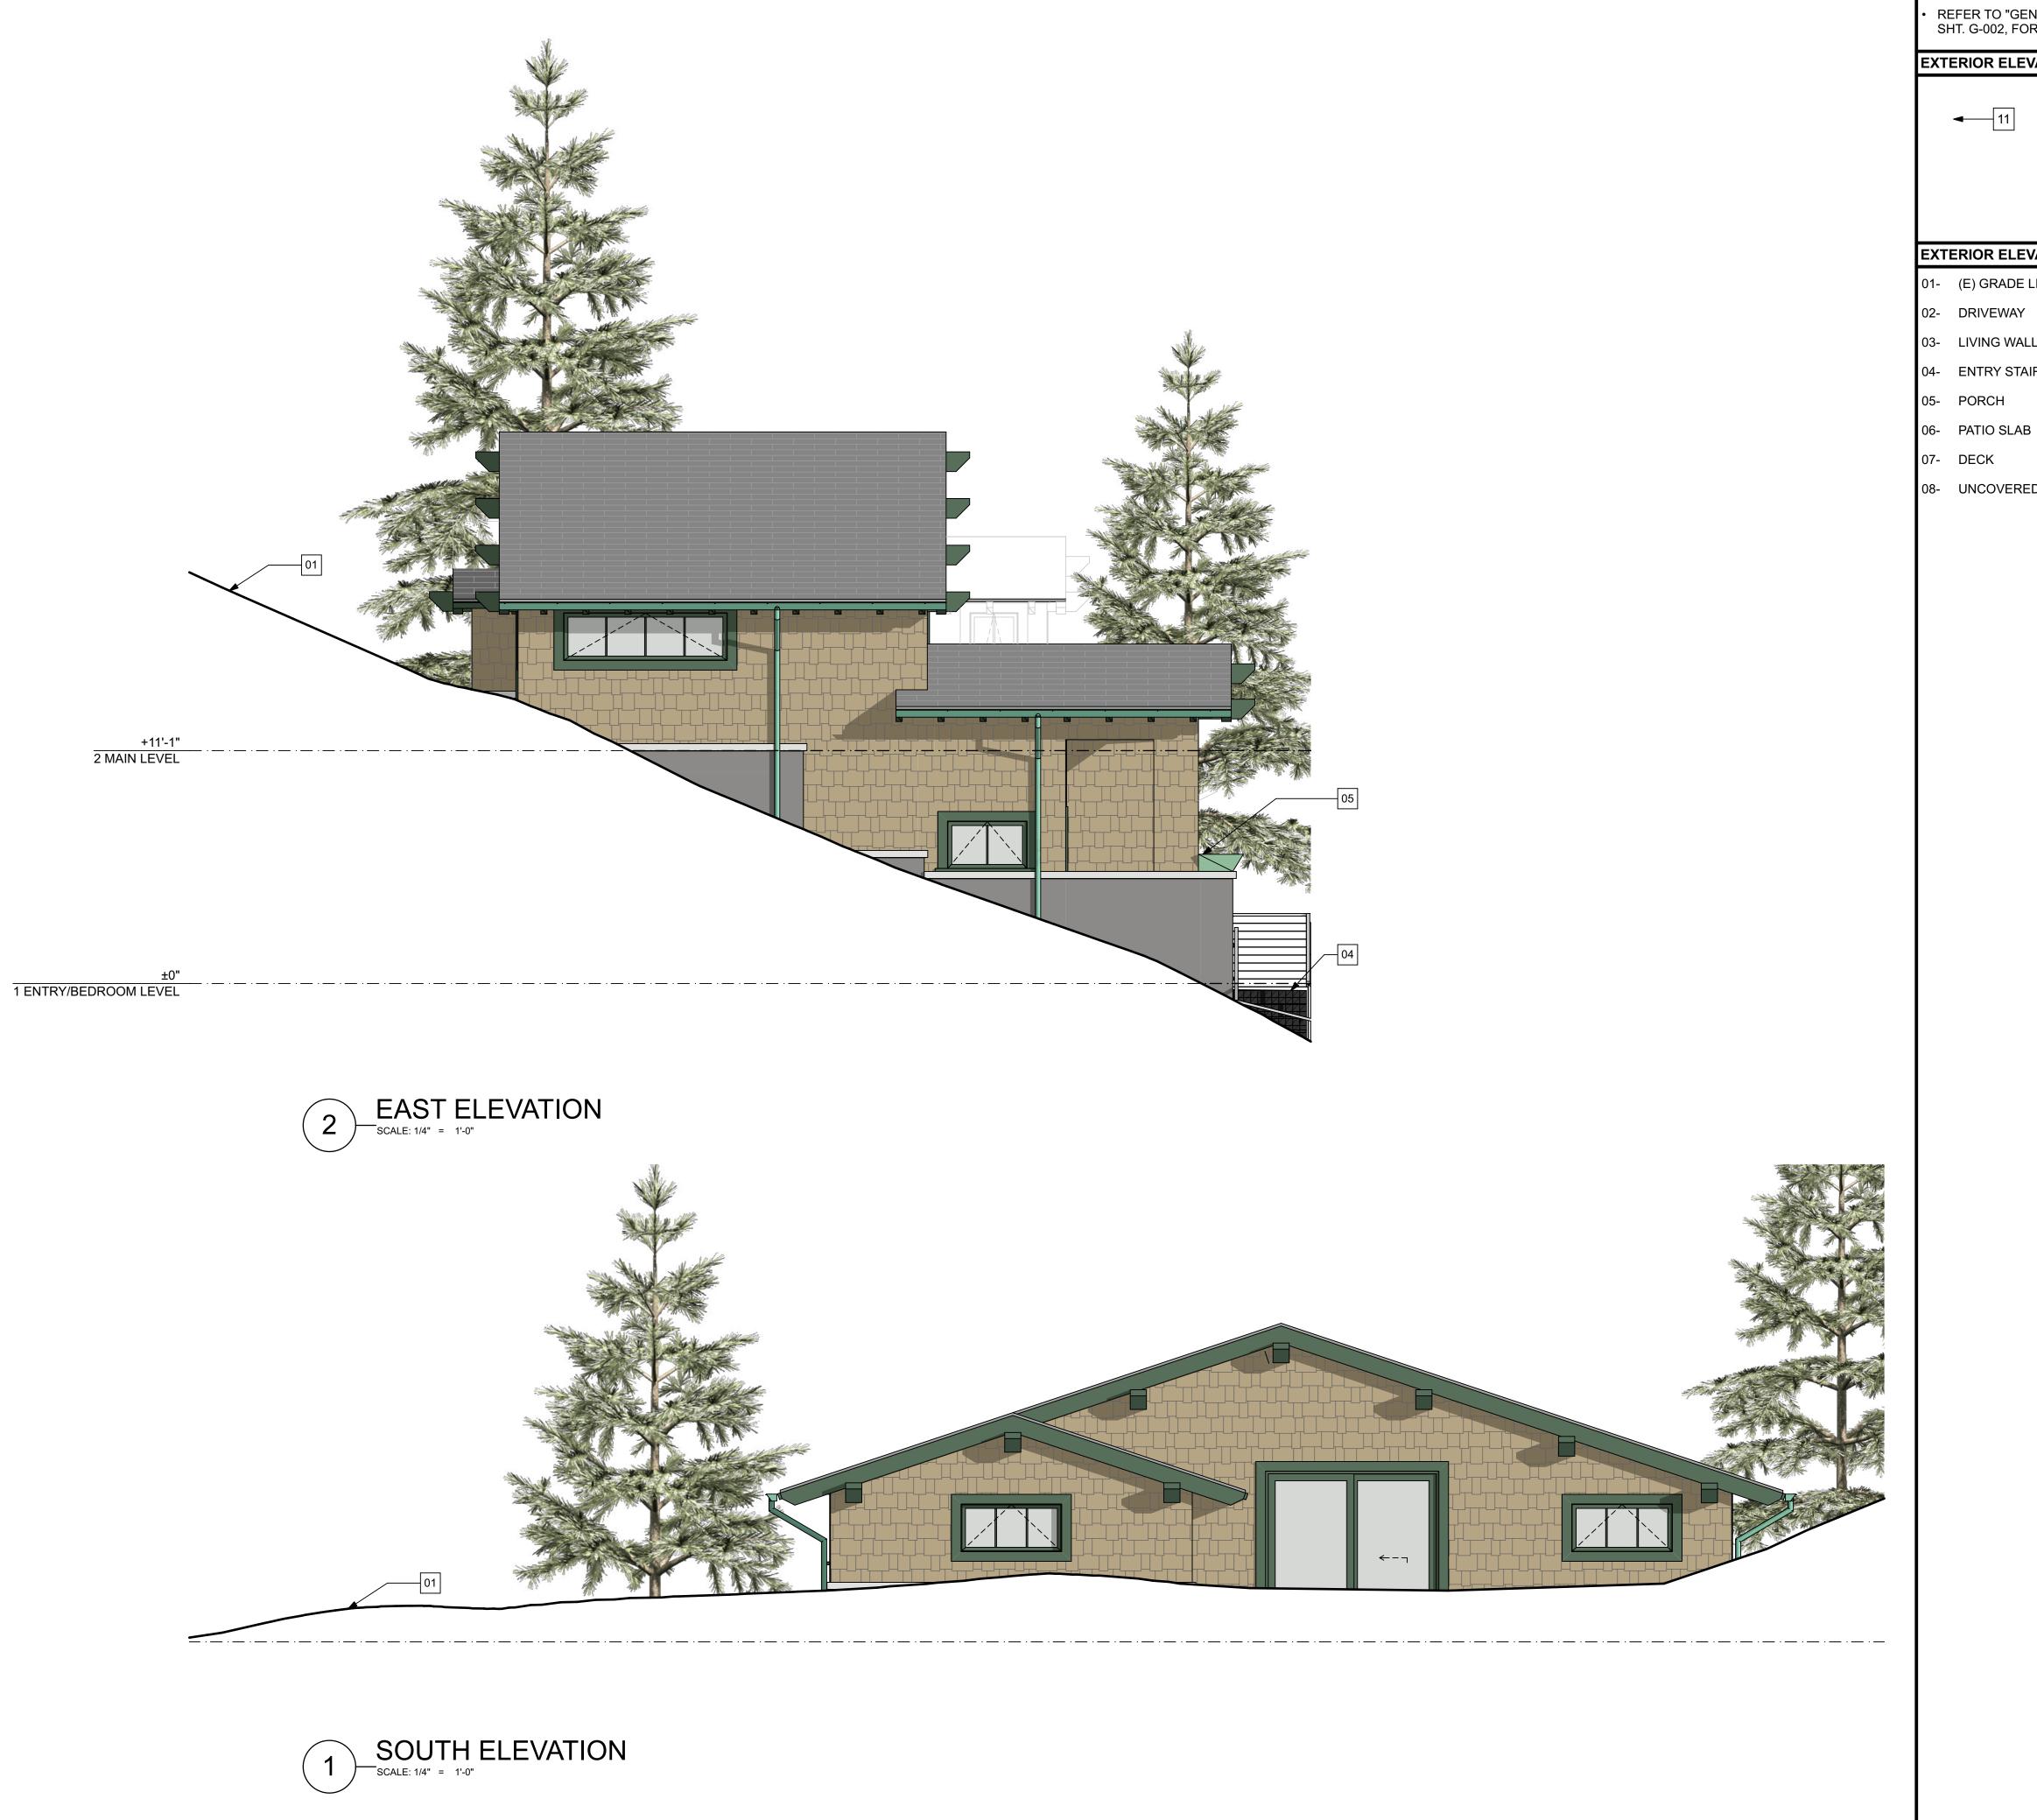• REFER TO "GENERAL NOTES", SHT. G-001 & SHT. G-002, FOR FURTHER INFORMATION.

EXTERIOR ELEVATION SYMBOLS LEGEND



KEY NOTE CALLOUT - SEE "FLOOR PLAN KEY NOTES" BELOW

EXTERIOR ELEVATION KEY NOTES

- 01- (E) GRADE LINE
- 02- DRIVEWAY
- 03- LIVING WALL (GREEN WALL)
- 04- ENTRY STAIRS
- 05- PORCH
- 07- DECK
- 08- UNCOVERED PARKING SPACE




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	DATE	7/02/18	2/04/19	4/04/19	7/26/19	2/24/2020	9/24/2020	11/20/2020
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- 1	PROJECT #:	1805					
- 1	CAD18115E:remont Road2	CAD 16115E:remont Road22 - Main - 11-20					
- 1	DRAWN BY:	INA					
- 1	CHECKED BY:	MNA					
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EXTERIOR ELEVATIONS



DEMOLITION PLAN GENERAL NOTES

 REFER TO "DEMOLITION NOTES", DIVISION 1, SHT. G-001, FOR DEMOLITION REQUIREMENTS.

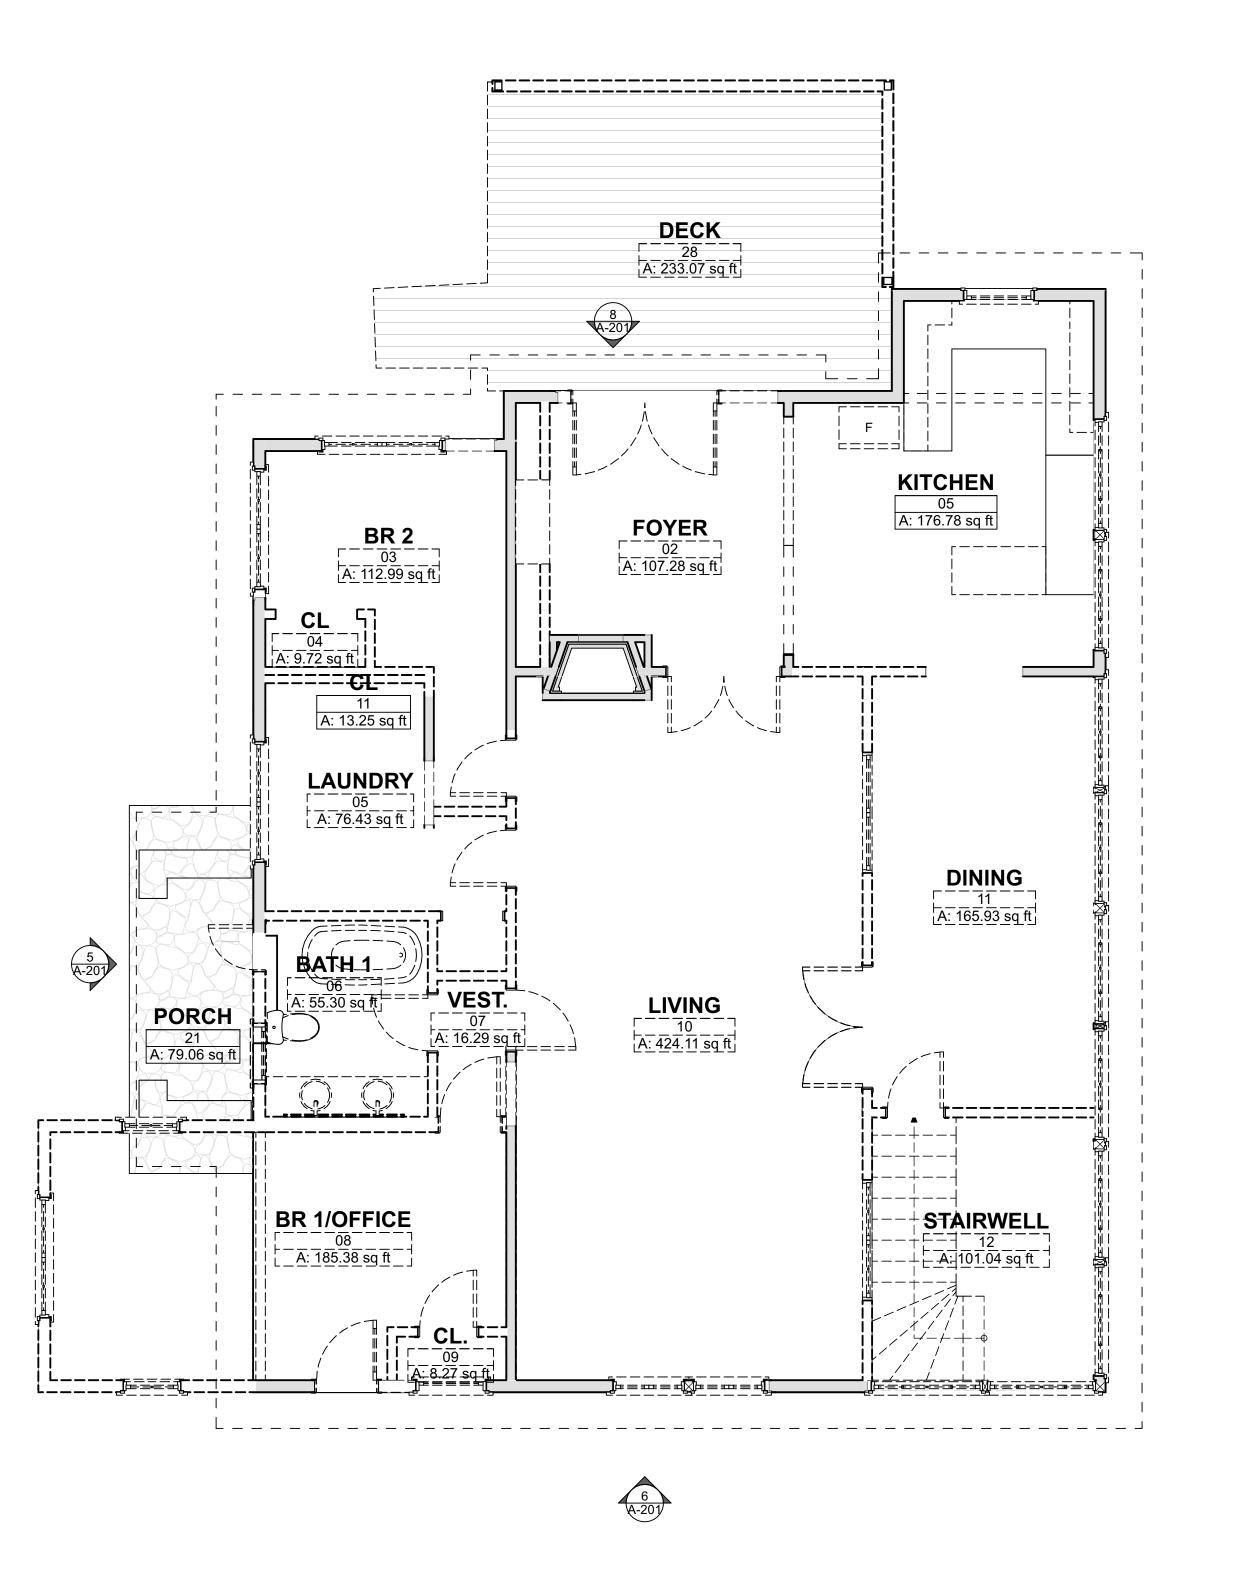DEMOLITION PLAN SYMBOLS LEGEND

(E) EXTERIOR WALL TO REMAIN

(=) =:

(E) INTERIOR WALL TO REMAIN

(E) WALL TO BE DEMOLISHED

◄ 11

ELEMENTS SHOWN DASHED TO BE REMOVED

KEY NOTE CA

KEY NOTE CALLOUT - SEE "DEMOLITION PLAN KEY NOTES" BELOW 7 Princess St. S Sausalito, CA 9 Phone: 415 944

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cific Private Money Fund I, LLC Et Al c/o Mark Hanf, Manager 1555 Grant Ave. Novato, CA 94945

> 52/54 Fremont Street San Rafael CA 94965 A.P.N.: 012-043-11 & 12

.P.N 012-043-1

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	MARK							

PROJECT #: 1805


CAD18IL5E:remont Road22 - Main - 11-20-2020.

DRAWN BY: MNA

CHECKED BY: MNA

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DEMOLITION MAIN RESIDENCE (UPPER FLOOR)

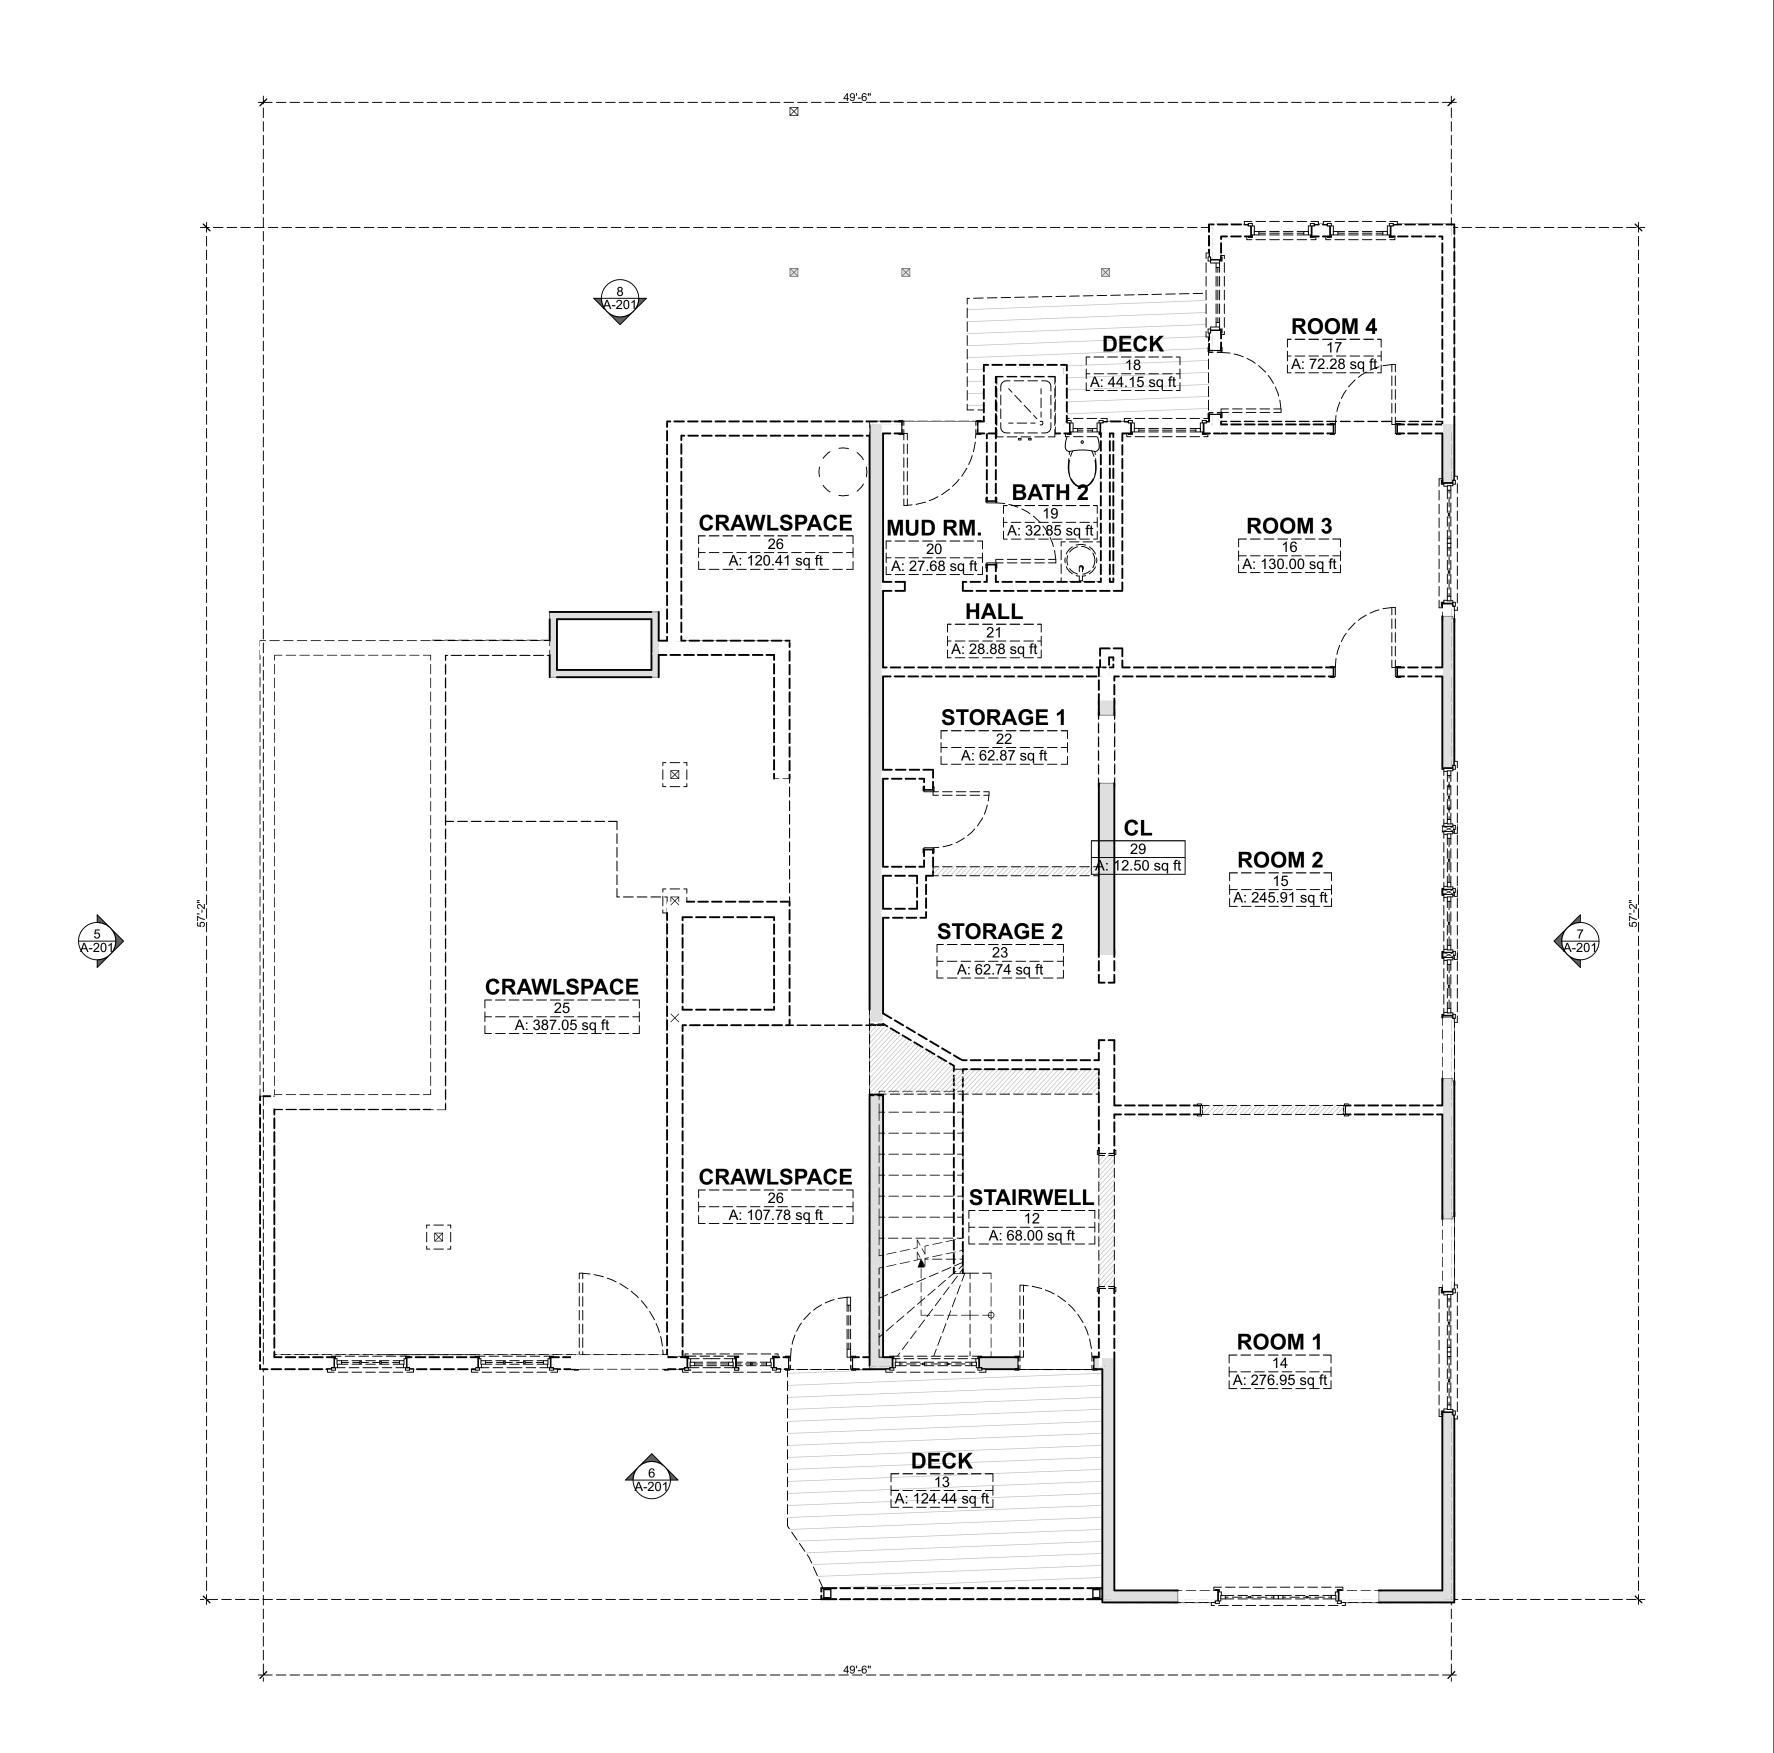

7

DEMOLITION PLAN GENERAL NOTES

 REFER TO "DEMOLITION NOTES", DIVISION 1, SHT. G-001, FOR DEMOLITION REQUIREMENTS

DEMOLITION PLAN SYMBOLS LEGEND

(E) EXTERIOR WALL TO REMAIN

· ,

(E) INTERIOR WALL TO REMAIN

(E) WALL TO BE DEMOLISHED

ELEMENTS SHOWN DASHED

TO BE REMOVED

KEY NOTE CALLOU

____11

KEY NOTE CALLOUT - SEE "DEMOLITION PLAN KEY NOTES" BELOW

7 Princess St. Sausalito, CA Phone: 415 92

fic Private Money Fund I, LLC Al c/o Mark Hanf, Manager 1555 Grant Ave. Novato, CA 94945

> 52/54 Fremont Street an Rafael CA 94965 P.N.: 012-043-11 & 12

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ISSUES	DESCRIPTION	PLANNING SUBMISSION							
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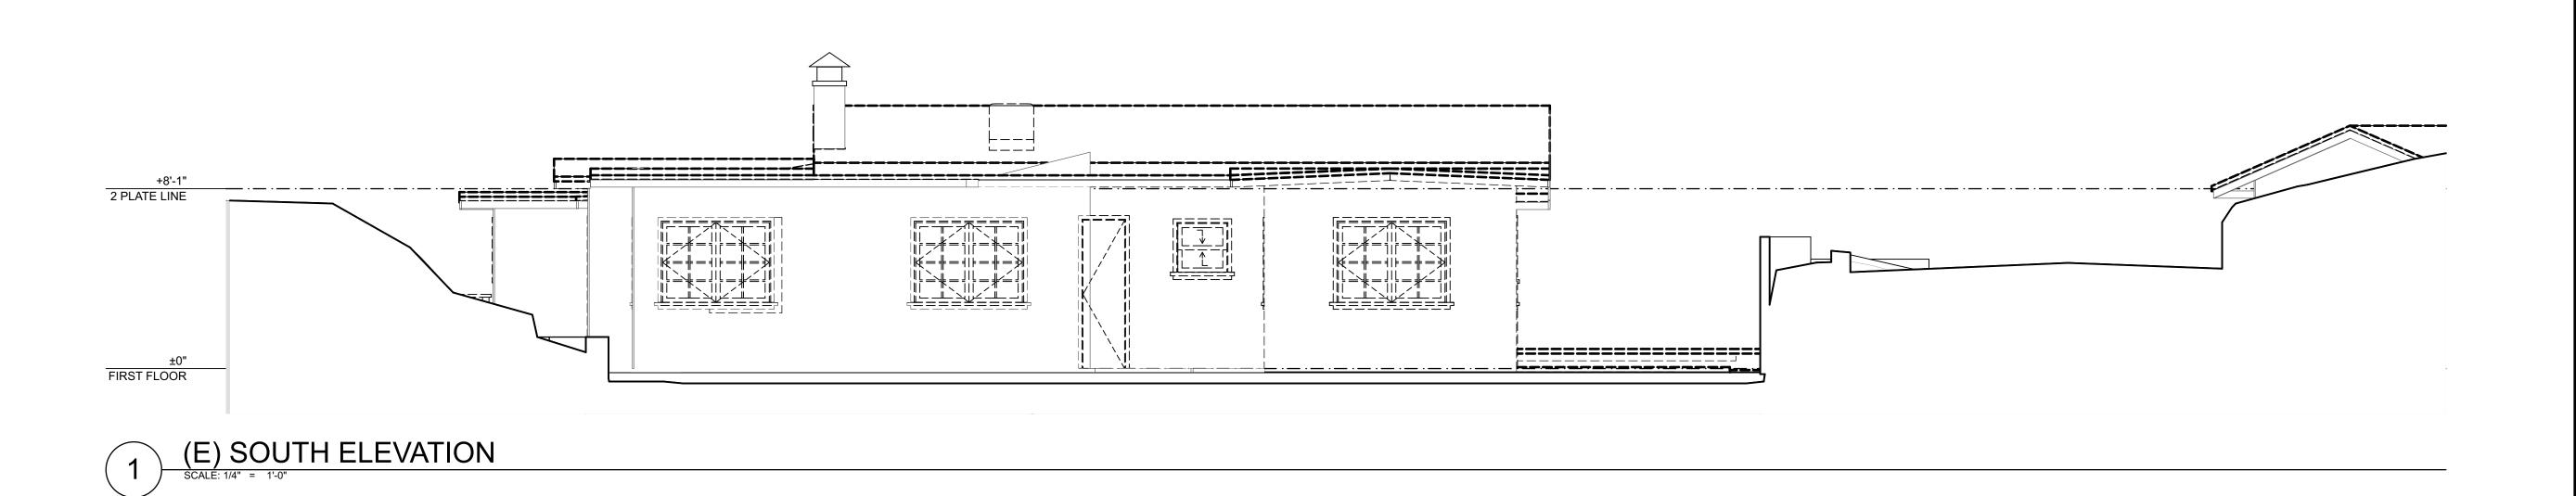
PROJECT #: 1805


CAD 1815E: remont Road22 - Main - 11-20-2020.

DRAWN BY: MNA

DEMOLITION MAIN
RESIDENCE (LOWER
FLOOR)

CHECKED BY:



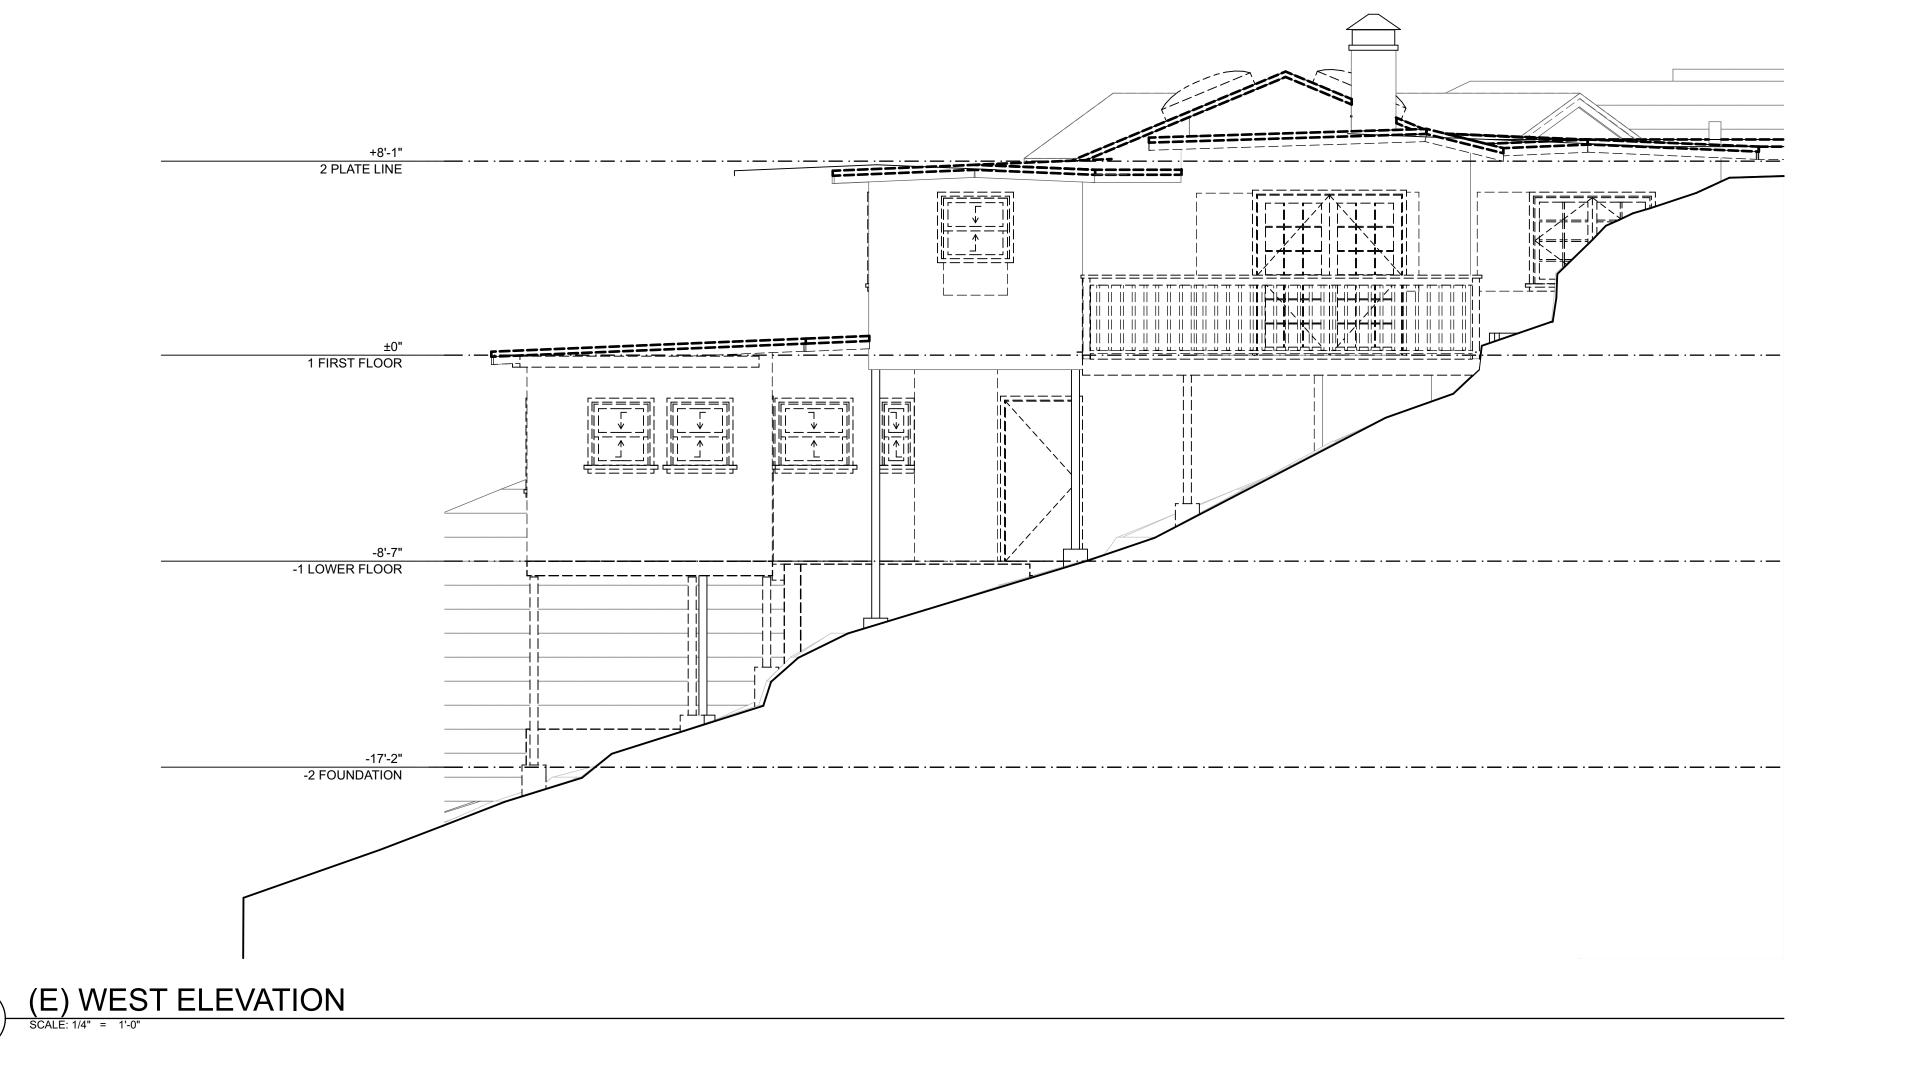

EXISTING ELEVATION GENERAL NOTES

 REFER TO "DEMOLITION NOTES", DIVISION 1, SHT. G-001, FOR DEMOLITION REQUIREMENTS.

EXISTING ELEVATION SYMBOLS LEGEND

ISTING ELEVATION STRIBUL

◄ 11

KEY NOTE CALLOUT - SEE "DEMOLITION PLAN KEY NOTES" BELOW Arterberry RESIDENTIAL DESIGN

7 Princes Sausalitt Phone: 4

ic Private Money Fund I, LLC AI c/o Mark Hanf, Manager 1555 Grant Ave. Novato, CA 94945

P.N 012-043-11 &1252/54 Fremont Street
San Rafael CA 94965
A.P.N.: 012-043-11 & 12

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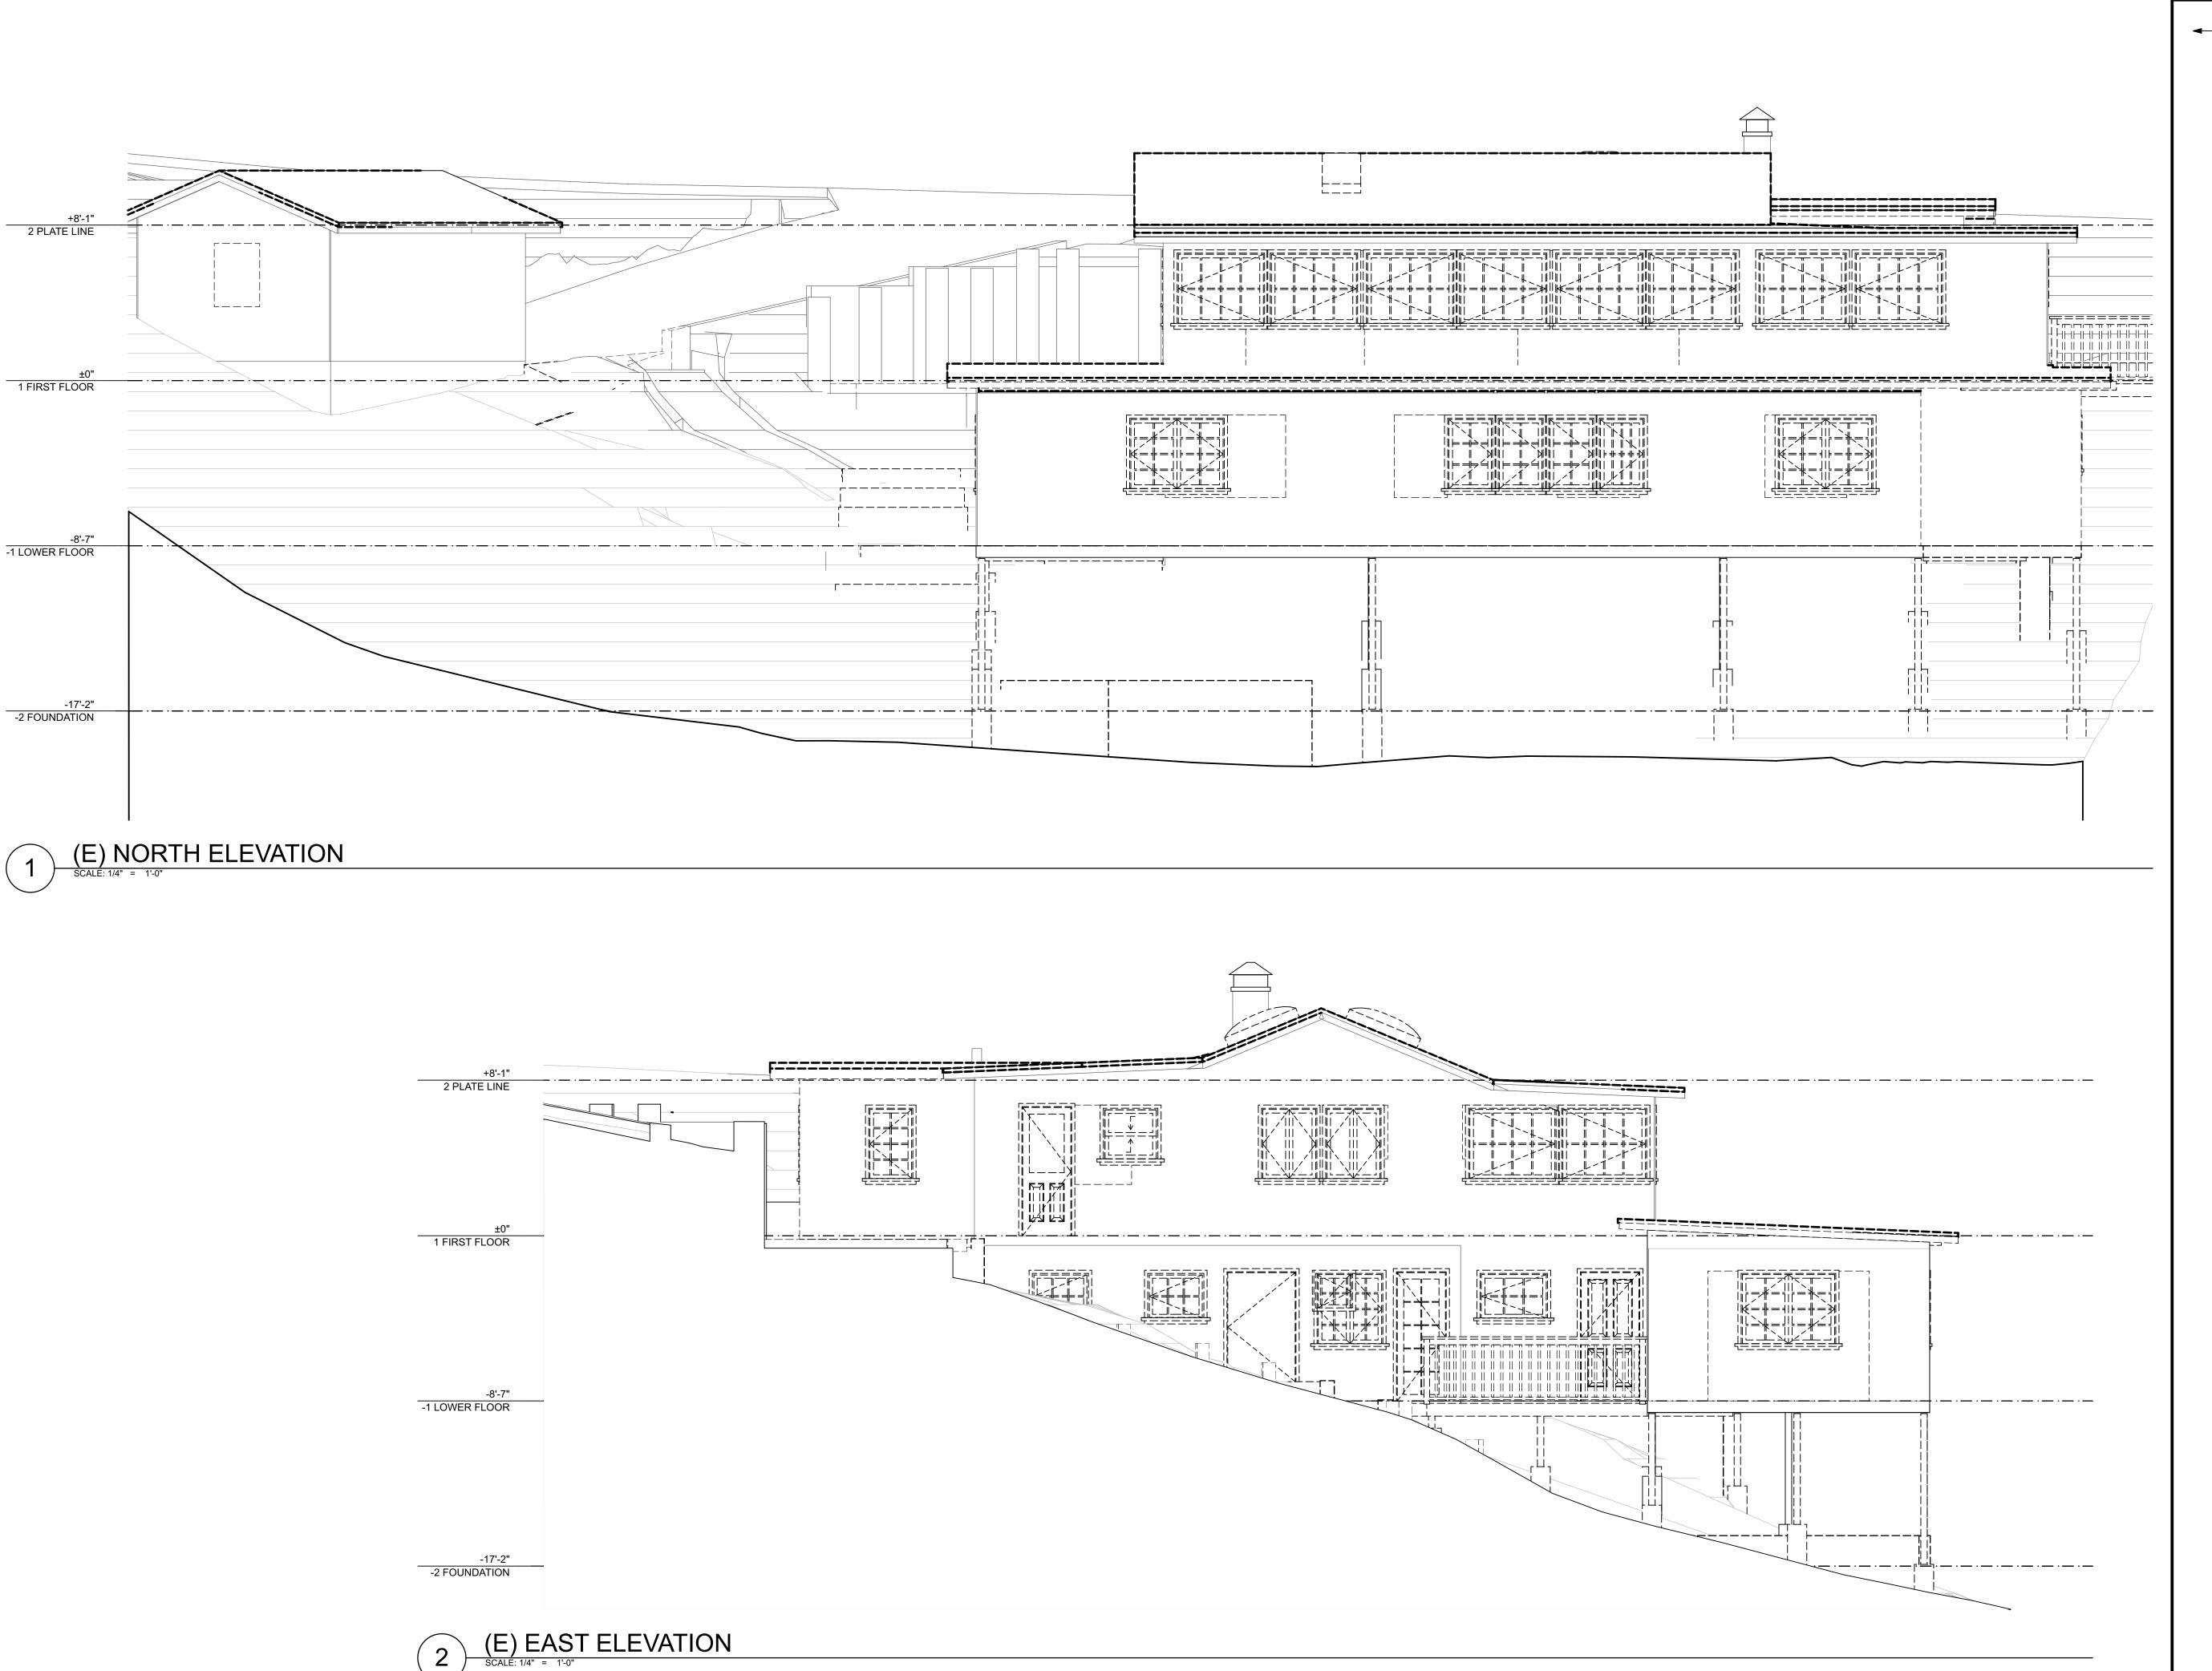
CAD 1BILSE:remont Road22 - Main - 11-20-2020.

DRAWN BY: MNA

CHECKED BY: MNA

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EXISTING EXTERIOR ELEVATIONS



EXISTING ELEVATION GENERAL NOTES

REFER TO "DEMOLITION NOTES", DIVISION 1, SHT. G-001, FOR DEMOLITION REQUIREMENTS

EXISTING ELEVATION SYMBOLS LEGEND

VEY NOTE CALL

KEY NOTE CALLOUT - SEE "DEMOLITION PLAN KEY NOTES" BELOW

Arterber

RESIDENTIAL DESIGNINCESS St. Suite A
Isalito, CA 94965

7 Princess St Sausalito, CA Phone: 415 9

e Money Fund I, LLC ark Hanf, Manager 5 Grant Ave. o, CA 94945

Et Al c/o Mark Ha 1555 Grar Novato, CA

52/54 Fremont Street San Rafael CA 94965 A.P.N.: 012-043-11 & 12

.P.N 012-043-1


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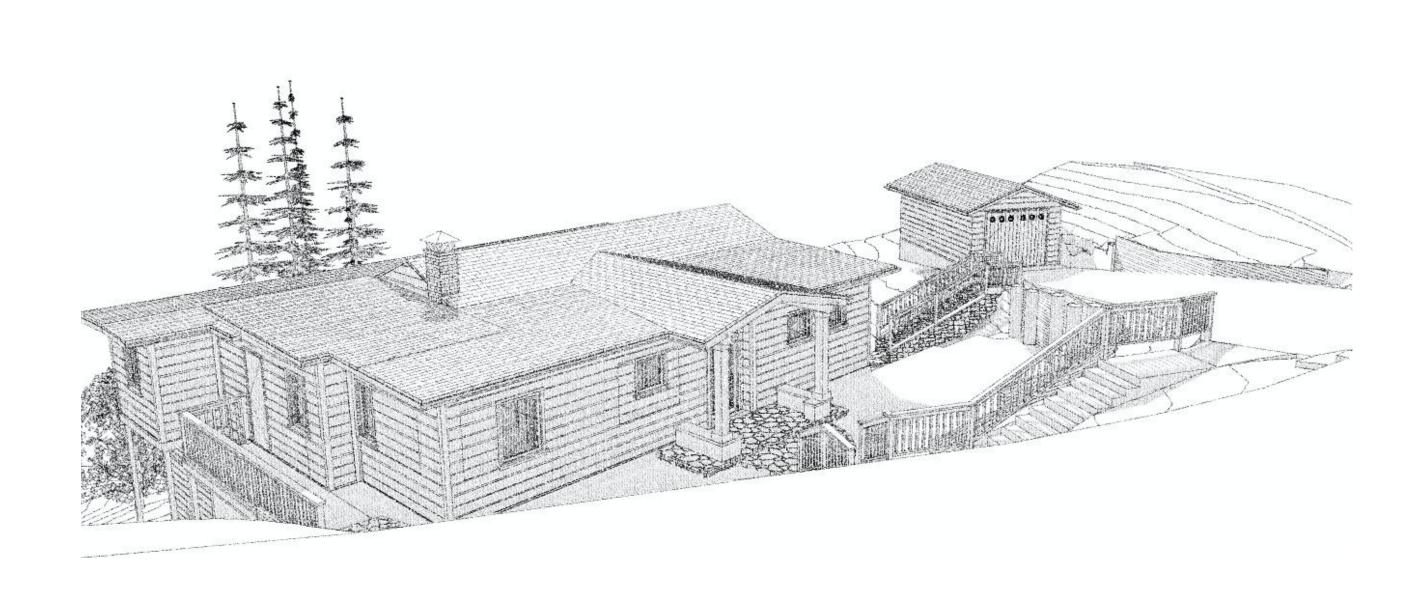
PROJECT #:	1805
CAD18115E:remont F	Road22 - Main - 11-20-
DRAWN BY:	MNA
CHECKED BY:	MNA

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EXISTING EXTERIOR

ELEVATIONS




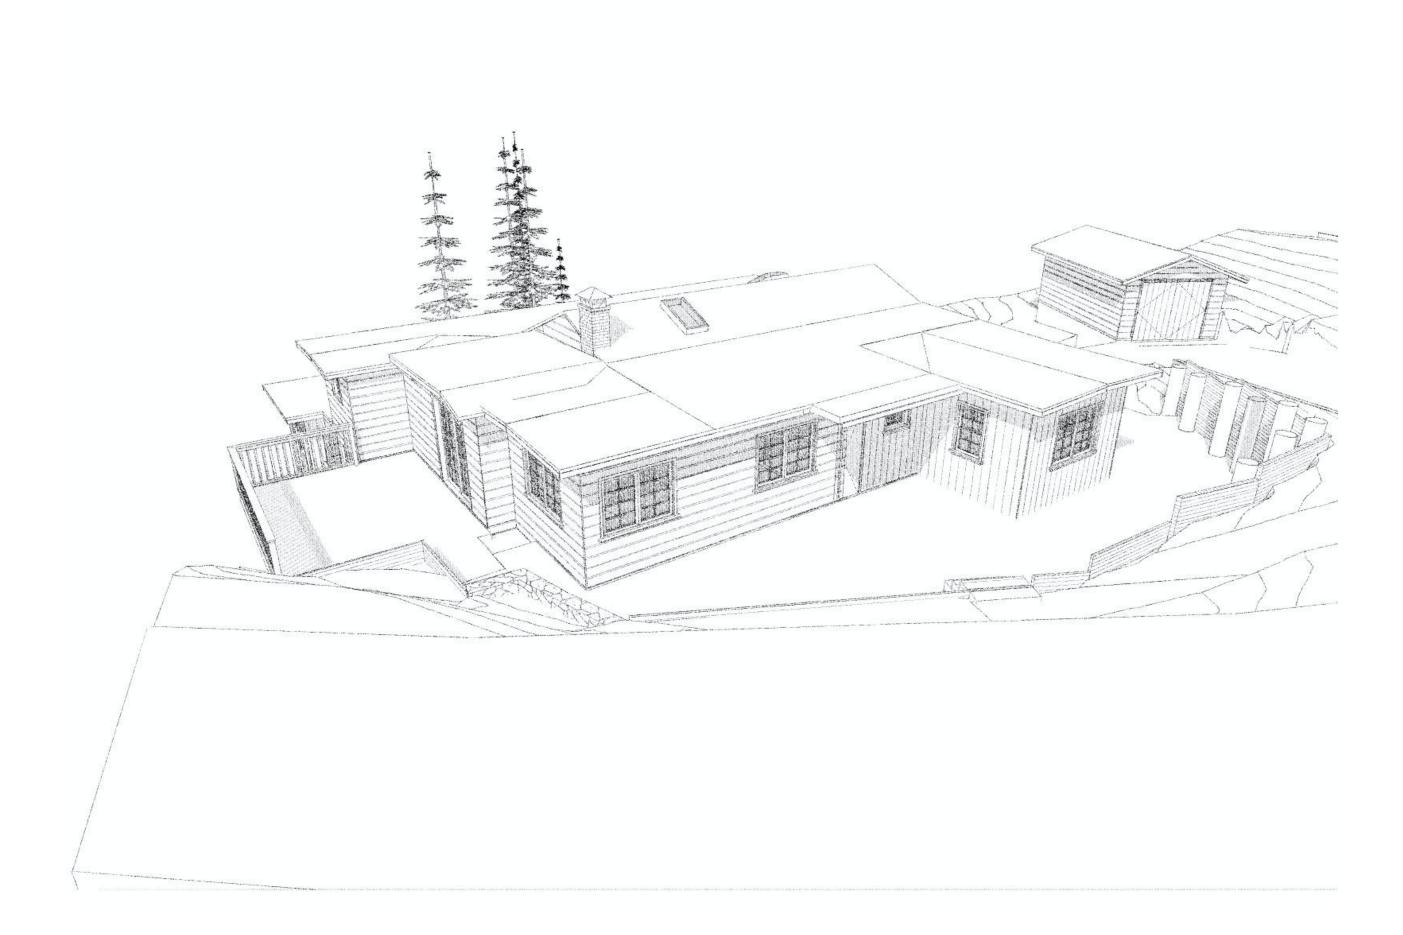

EXISTING VIEW FROM FREMONT ROAD



PROPOSED VIEW FROM FREMONT ROAD

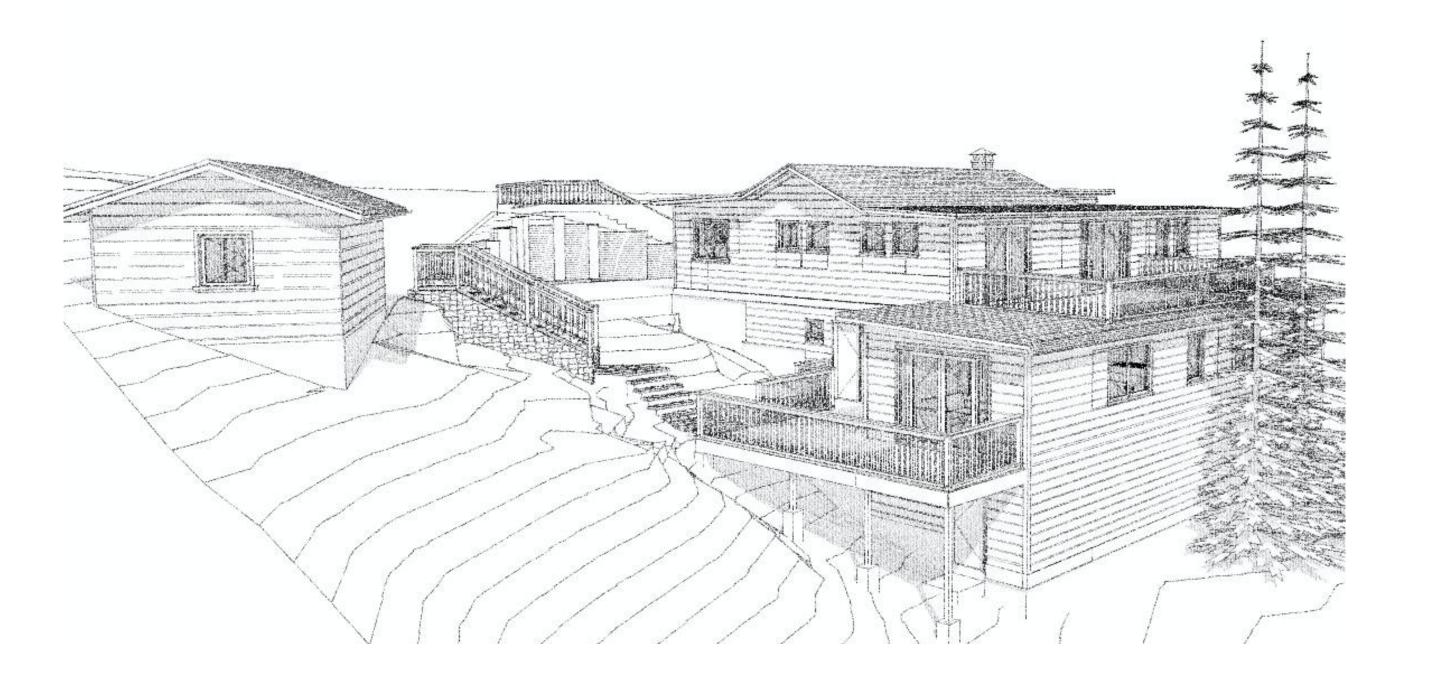

<u>1</u> F

1 PROPOSED VIEW OF 54 FREMONT ROAD

Arterberry
RESIDENTIAL DESIGN

SSS St. Suite A

7 Princess Sausalito, (Phone: 415

ate Money Fund I, LLC Mark Hanf, Manager 55 Grant Ave. ato, CA 94945

52/54 Fremont Street
San Rafael CA 94965

 DATE
 DESCRIPTION

 7/02/18
 PLANNING SUBMISSION

 2/04/19
 PLANNING SUBMISSION

 4/04/19
 PLANNING SUBMISSION

 7/26/19
 PLANNING SUBMISSION

 7/24/2020
 PLANNING SUBMISSION


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 PLANNING SUBMISSION

PROJECT #: 1805
CAD 18115E: remont Road22 - Main - 11-20
DRAWN BY: MNA

CHECKED BY: MNA

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RENDERINGS

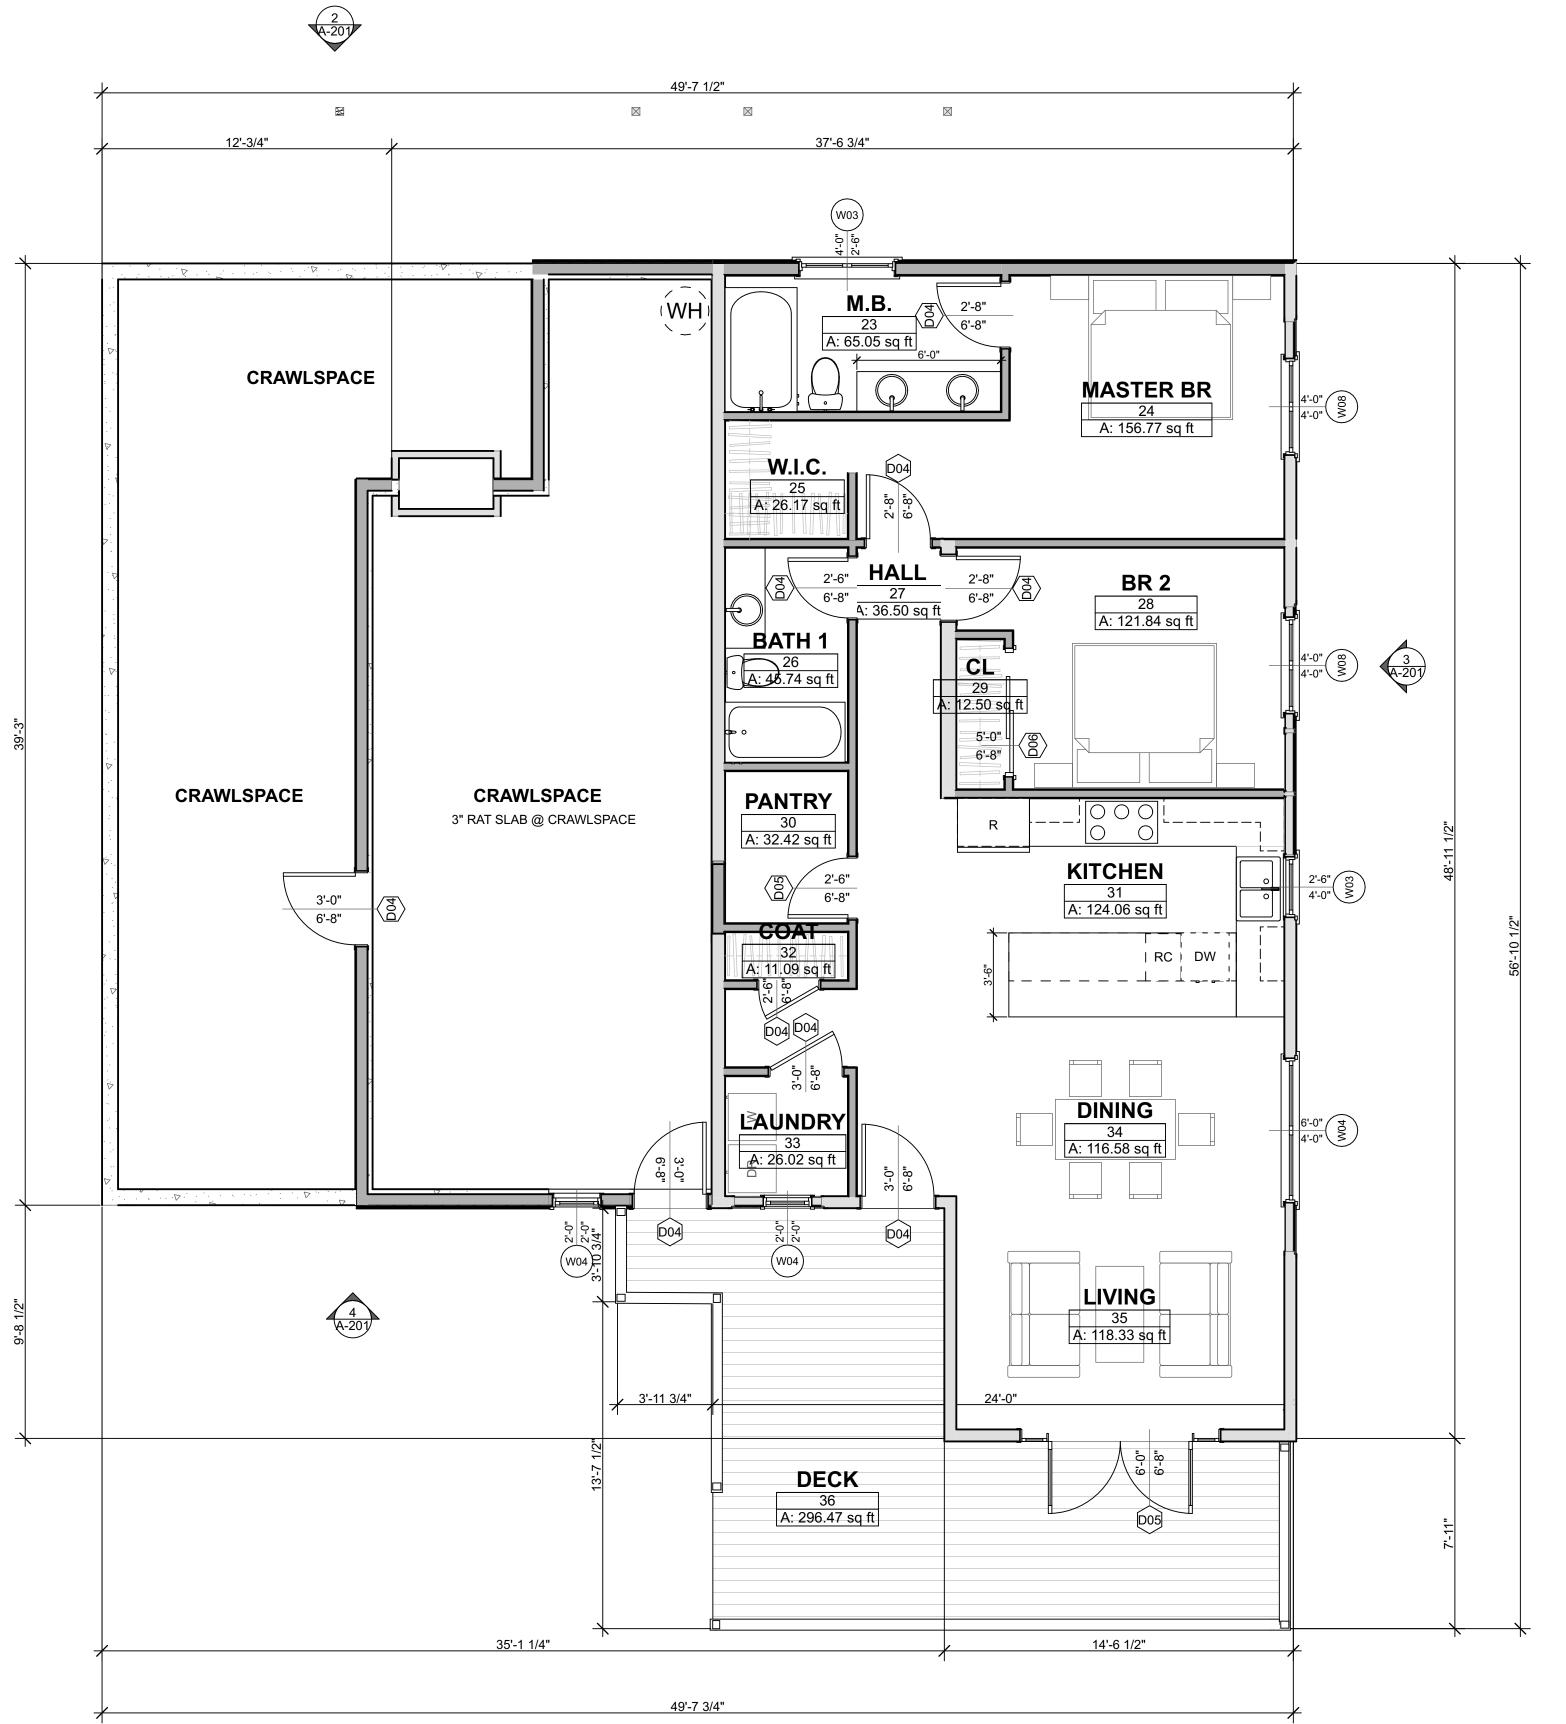

**REFER TO "GENERAL NOTES", SHT. G-001 & SHT. G-002, FOR FURTHER INFORMATION.

**FLOOR PLAN SYMBOLS LEGEND

(E) EXTERIOR CONCRETE/BRICK WALL

(E) INTERIOR WOOD FRAMED WALL - SEE STRUCTURAL PLANS

(N) 2X4 WOOD FRAMED WALL - SEE WINDOW SCHEDULE, SHT. A-600

NEW DOOR CALLOUT - SEE WINDOW SCHEDULE, SHT. A-600

NEW DOOR CALLOUT - SEE WINDOW SCHEDULE, SHT. A-600

KEY NOTE CALLOUT - SEE "FLOOR PLAN KEY NOTES" BELOW

DWG. # ELEVATION CALLOUT

Owner:

Owner:

Owner:

Altout - SEE JLE, SHT.

Owner:

Altout Section Callout

Altour J. LLC

A

P.N 012-043-11 &12 P.N 012-043-11 &12 P.N 52/54 Fremont Street San Rafael CA 94965

 DATE
 DESCRIPTION

 7/02/18
 PLANNING SUBMISSION

 2/04/19
 PLANNING SUBMISSION

 4/04/19
 PLANNING SUBMISSION


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 PLANNING SUBMISSION

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 PLANNING SUBMISSION

 1/20/2020
 PLANNING SUBMISSION

PROJECT #: 1805
CAD 1B115E: remont Road22 - Main - 11-20DRAWN BY: MNA
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BASEMENT FLOOR PLAN - 54 FREMONT RD

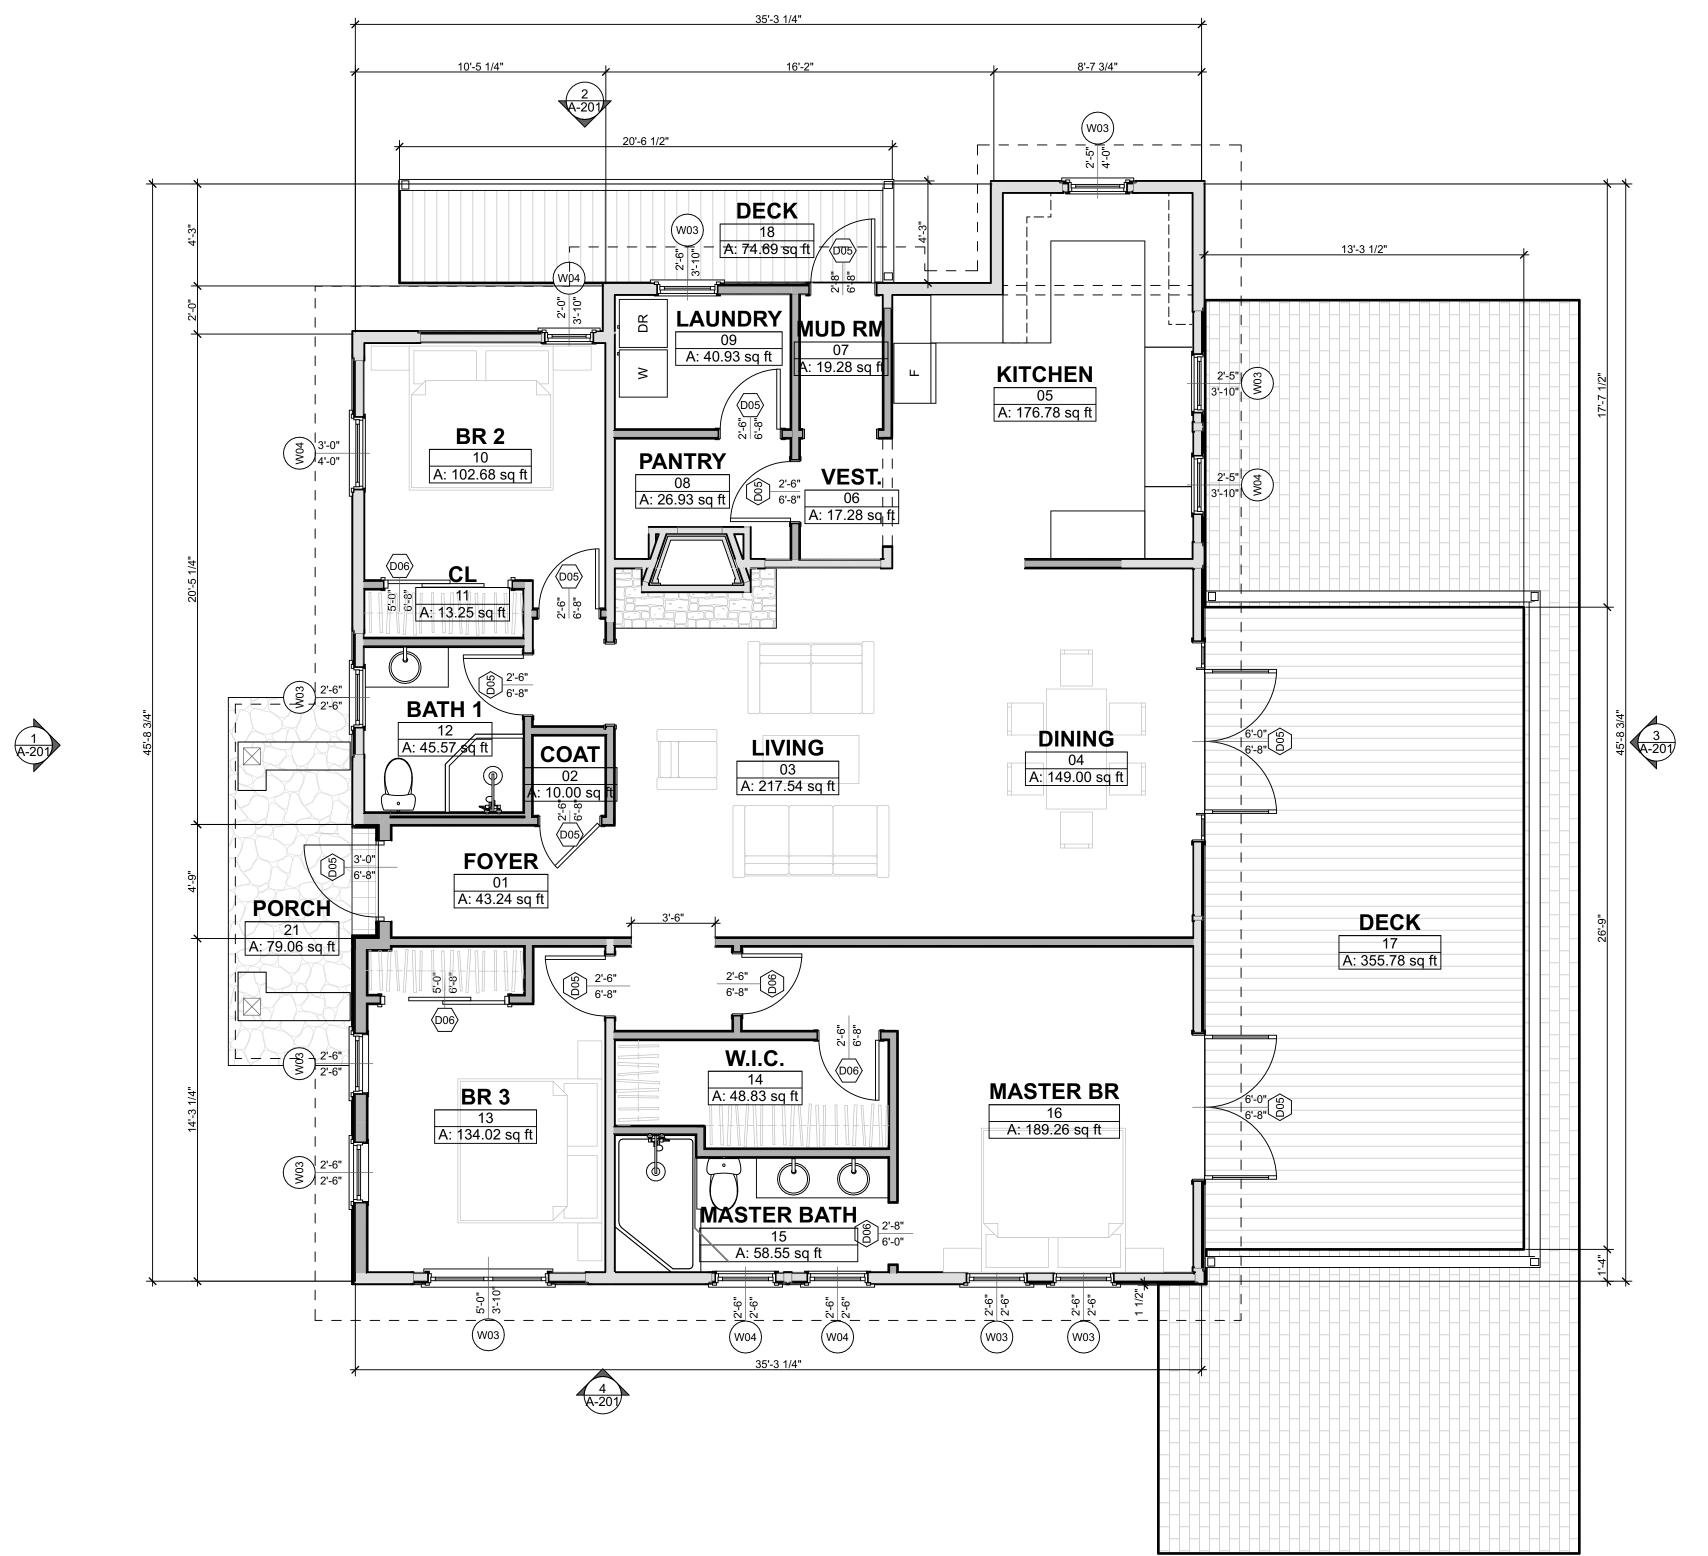


FLOOR PLAN GENERAL NOTES REFER TO "GENERAL NOTES", SHT. G-001 & SHT. G-002, FOR FURTHER INFORMATION. FLOOR PLAN SYMBOLS LEGEND (E) EXTERIOR CONCRETE/BRICK WALL (E) INTERIOR WOOD FRAMED (N) 2X4 WOOD FRAMED WALL -SEE STRUCTURAL PLANS NEW WINDOW CALLOUT -SEE WINDOW SCHEDULE, SHT. A-600 NEW DOOR CALLOUT - SEE WINDOW SCHEDULE, SHT. A-600 KEY NOTE CALLOUT - SEE "FLOOR PLAN KEY NOTES" 1 DWG. #
A-200 LAYOUT # **ELEVATION** CALLOUT SECTION CALLOUT

&12 52/54 Fremont Street San Rafael CA 94965 A.P.N.: 012-043-11 & 12

.P.N 012-043-1

PROJECT #: CAD18115E:remont Road22 - Main - 11-20-2020. CHECKED BY:

FIRST FLOOR PLAN - 54 FREMONT RD

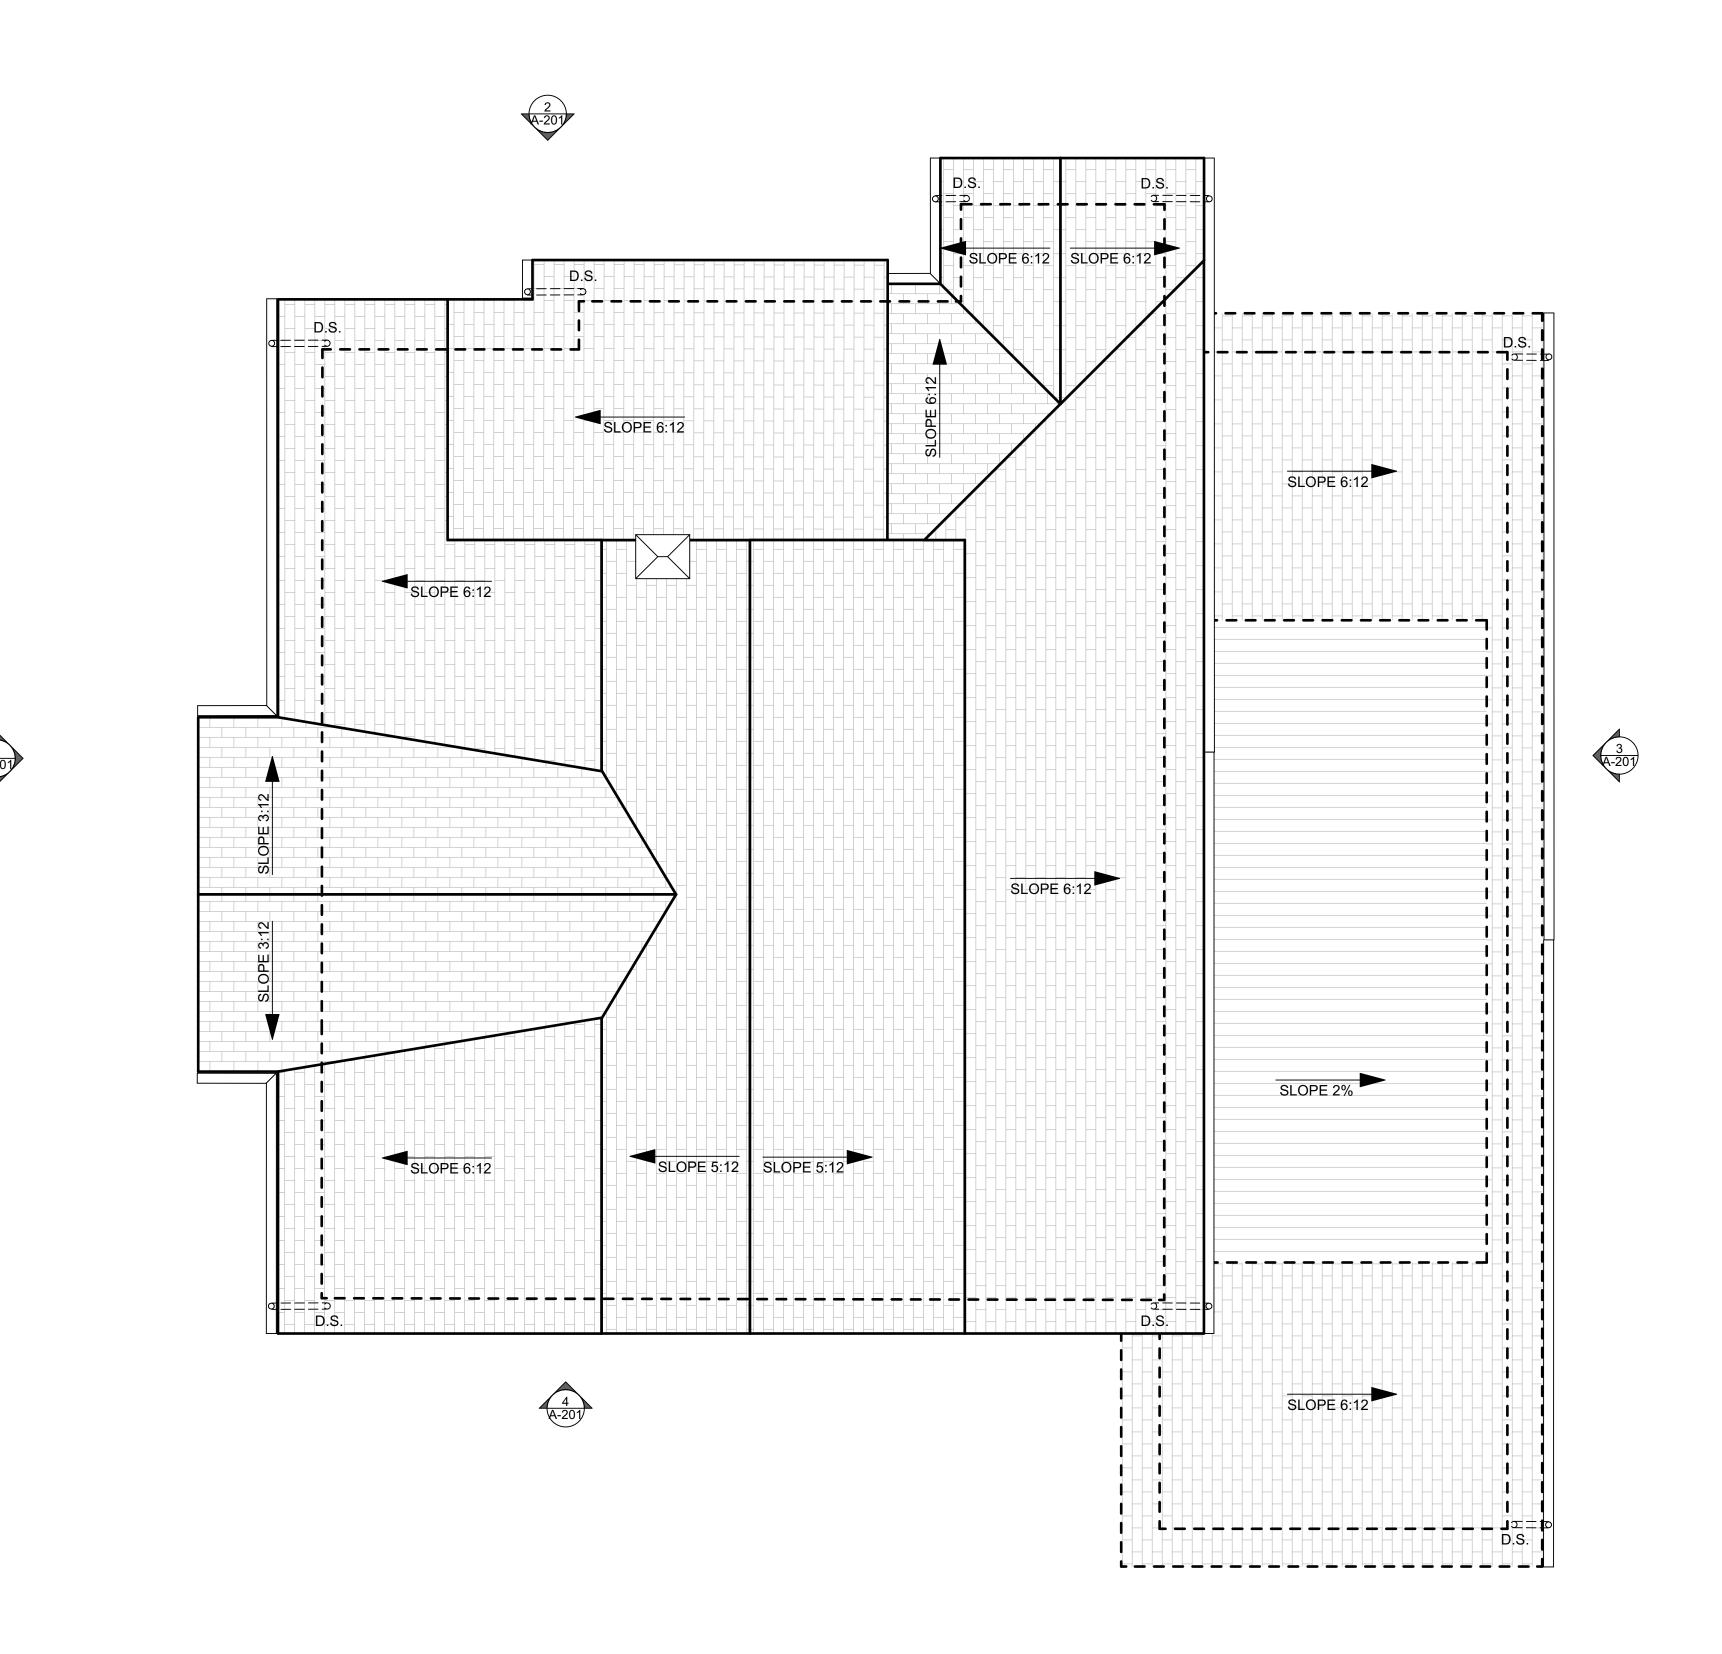

FLOOR PLAN GENERAL NOTES REFER TO "GENERAL NOTES", SHT. G-001 & SHT. G-002, FOR FURTHER INFORMATION. FLOOR PLAN SYMBOLS LEGEND (E) EXTERIOR CÓNCRETE/BRICK WALL NEW WINDOW CALLOUT -SEE WINDOW SCHEDULE, SHT. A-600 NEW DOOR CALLOUT - SEE WINDOW SCHEDULE, SHT. A-600 KEY NOTE CALLOUT - SEE "FLOOR PLAN KEY NOTES" 1 DWG. # A-200 LAYOUT #

(E) INTERIOR WOOD FRAMED (N) 2X4 WOOD FRAMED WALL -SEE STRUCTURAL PLANS **ELEVATION** CALLOUT SECTION CALLOUT

> &12 .P.N 012-043-1

PROJECT #: CAD 18115E: remont Road22 - Main - 11-20-2020. DRAWN BY: CHECKED BY:

> **ROOF PLAN - 54** FREMONT RD

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SOUTH ELEVATION

SCALE: 1/4" = 1'-0"



EXTERIOR ELEVATION GENERAL NOTES

• REFER TO "GENERAL NOTES", SHT. G-001 & SHT. G-002, FOR FURTHER INFORMATION.

EXTERIOR ELEVATION SYMBOLS LEGEND



KEY NOTE CALLOUT - SEE "FLOOR PLAN KEY NOTES" BELOW

EXTERIOR ELEVATION KEY NOTES

01- (E) GRADE LINE

02- DRIVEWAY

03- LIVING WALL (GREEN WALL)

04- ENTRY STAIRS

05- PORCH

06- PATIO SLAB

07- L

08- UNCOVERED PARKING SPACE

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cific Private Money Fund I, Et Al c/o Mark Hanf, Manag 1555 Grant Ave. Novato, CA 94945

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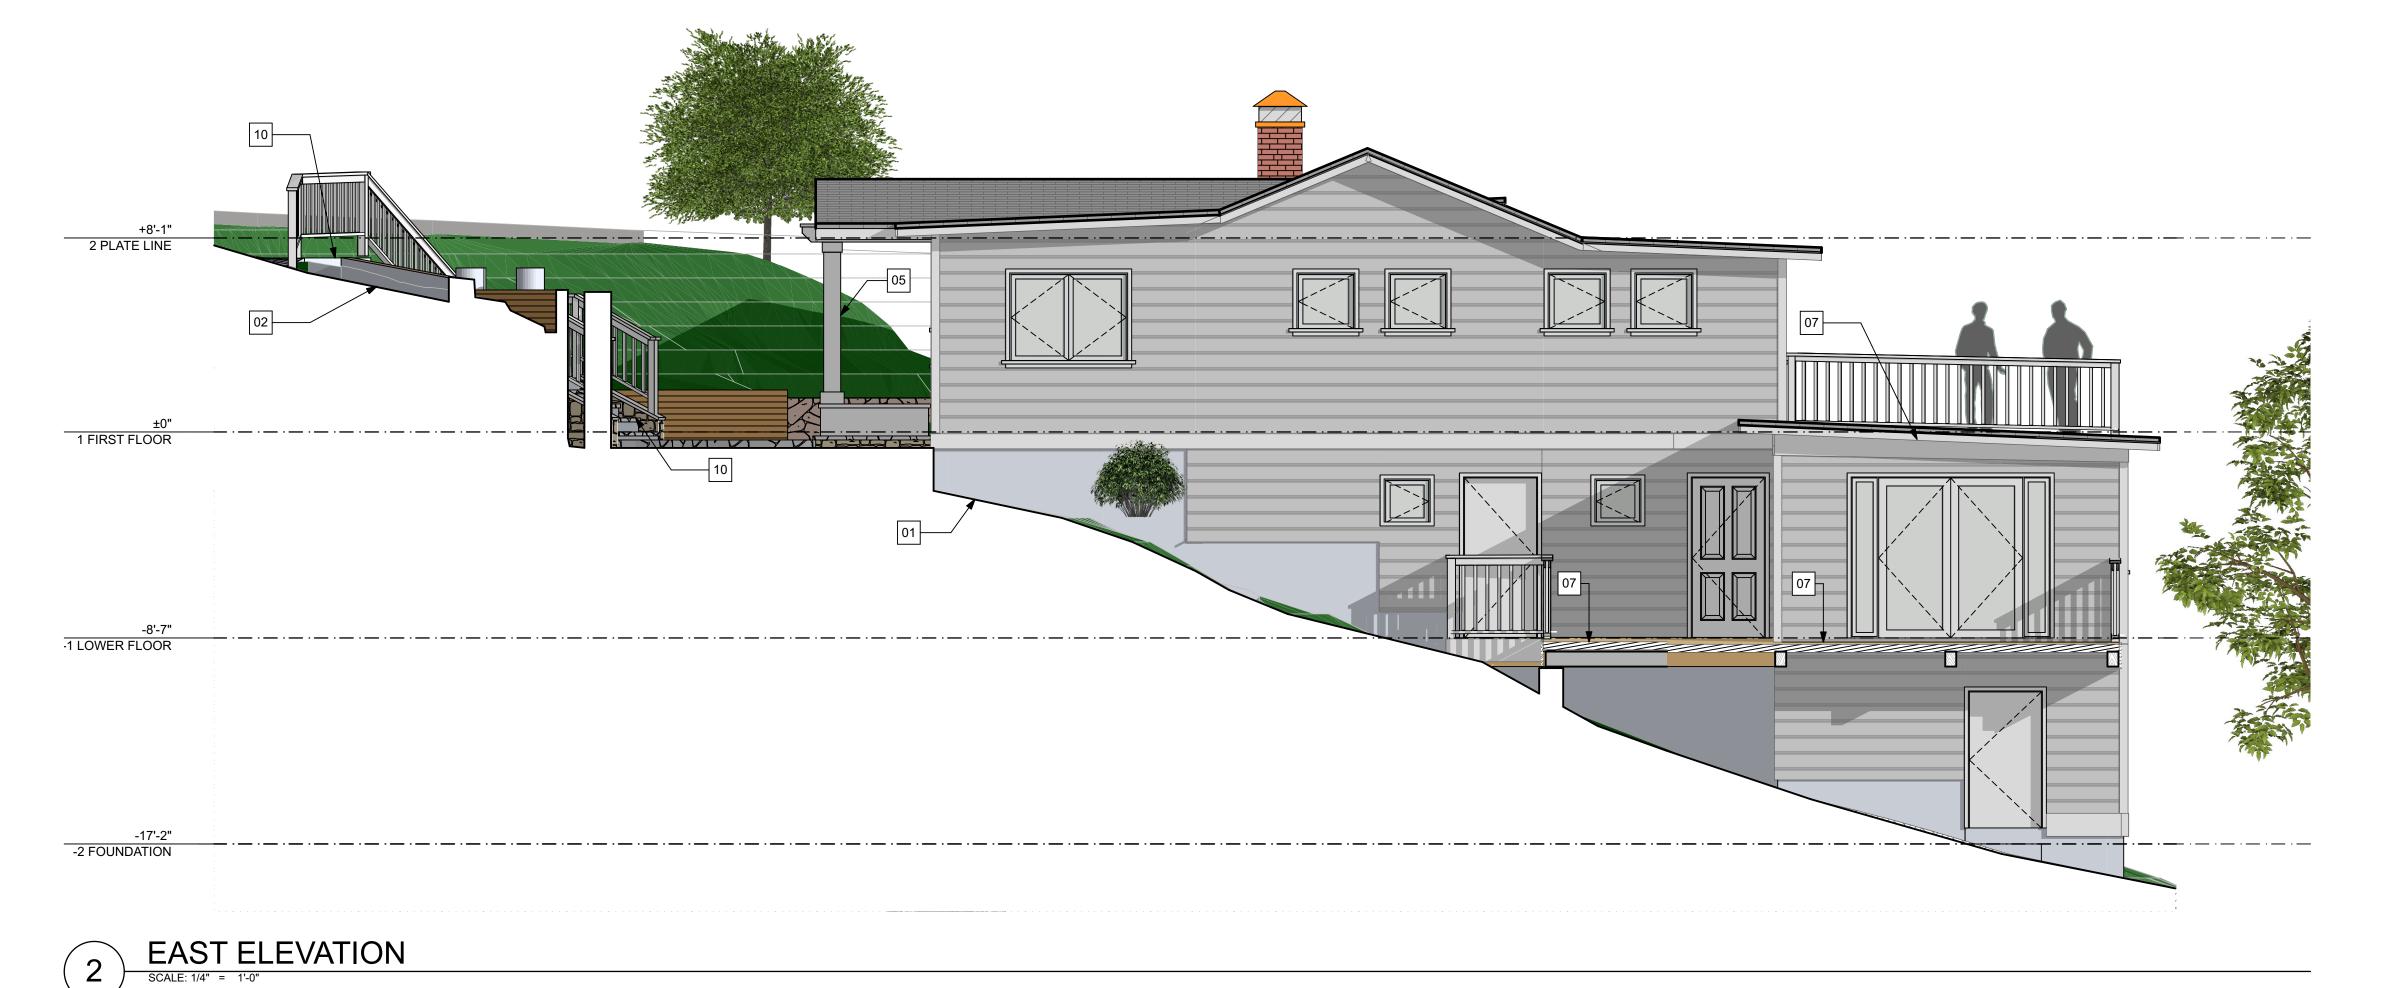
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52/54 Fremon San Rafael C/ A.P.N.: 012-04;

		ISSUES
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	7/02/18	PLANNING SUBMISSION
	2/04/19	PLANNING SUBMISSION
	4/04/19	PLANNING SUBMISSION
	7/26/19	PLANNING SUBMISSION
	2/24/2020	PLANNING SUBMISSION
	9/24/2020	PLANNING SUBMISSION
	11/20/2020	PLANNING SUBMISSION
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PROJECT #:	1805
CAD18115E:remont	Road22 - Main - 11-20-
DRAWN BY:	MNA
CHECKED BY:	MNA

PROPOSED EXTERIOR ELEVATIONS





EXTERIOR ELEVATION GENERAL NOTES

• REFER TO "GENERAL NOTES", SHT. G-001 & SHT. G-002, FOR FURTHER INFORMATION.

EXTERIOR ELEVATION SYMBOLS LEGEND

KEY NOTE CALLOUT - SEE "FLOOR PLAN KEY NOTES" BELOW

01- (E) GRADE LINE

02- DRIVEWAY

03- LIVING WALL (GREEN WALL)

04- ENTRY STAIRS

05- PORCH

06- PATIO SLAB

07- DECK

08- UNCOVERED PARKING SPACE

09- UNUSED

10- SITE WALKWAY/STAIRWAY

11- (E) GARAGE TO BE REMODELED

EXTERIOR ELEVATION KEY NOTES

&12

	DESCRIPTION
_	PLANNING SUBMISSION
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CHECKED BY:	MNA	
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PROPOSED EXTERIOR ELEVATIONS

2A-201

NORTH ELEVATION

SCALE: 1/4" = 1'-0"