





1 - View West at 47 Clayton

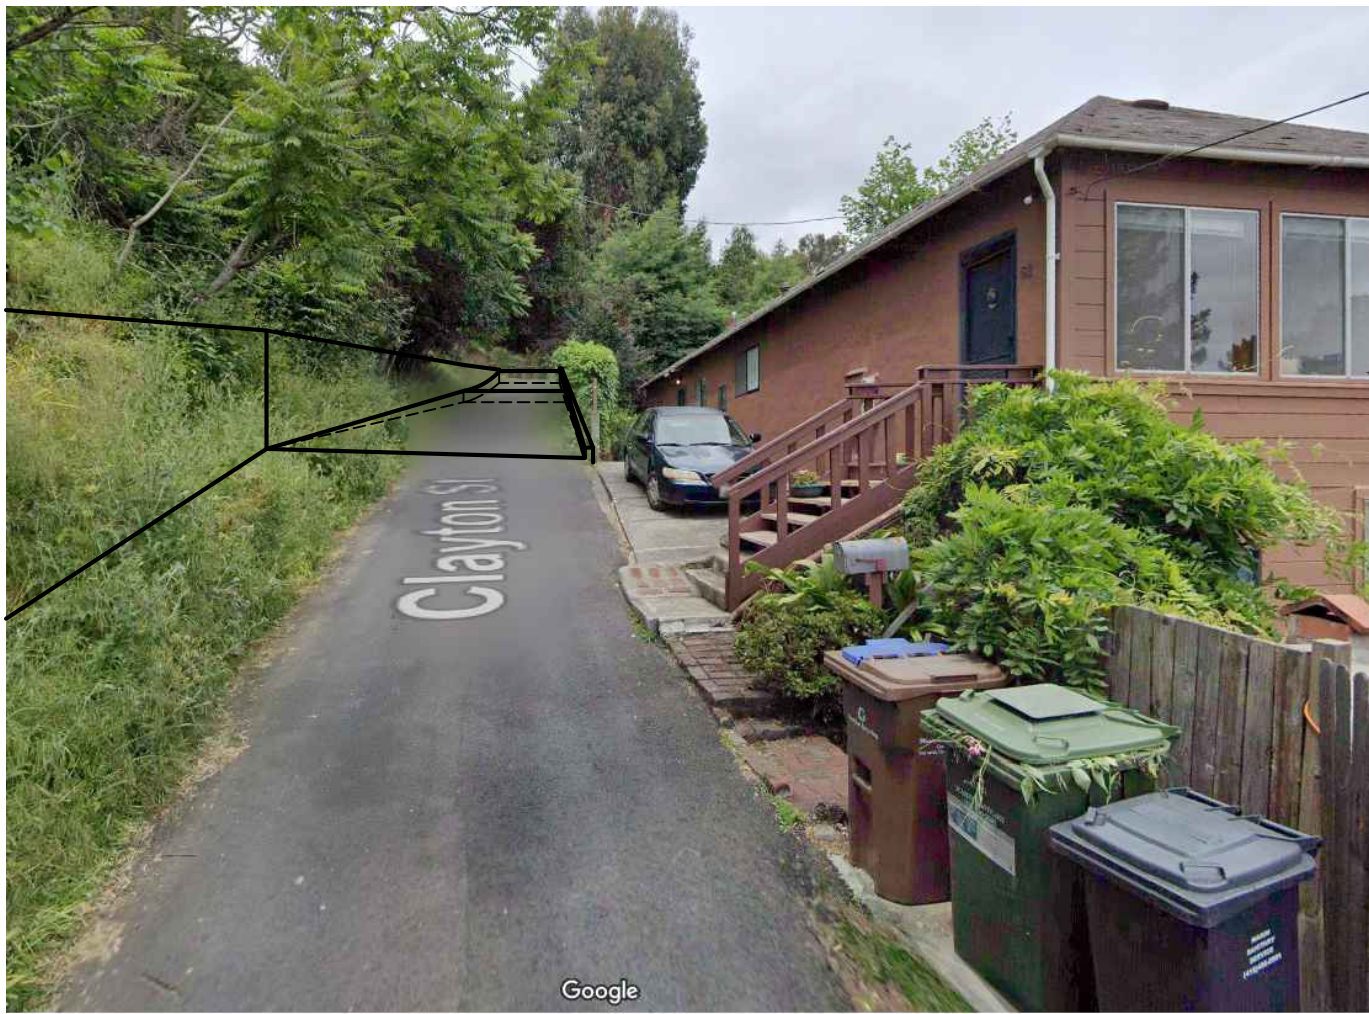

2 - View West at 51 Clayton



3 - View West at 64 Clayton

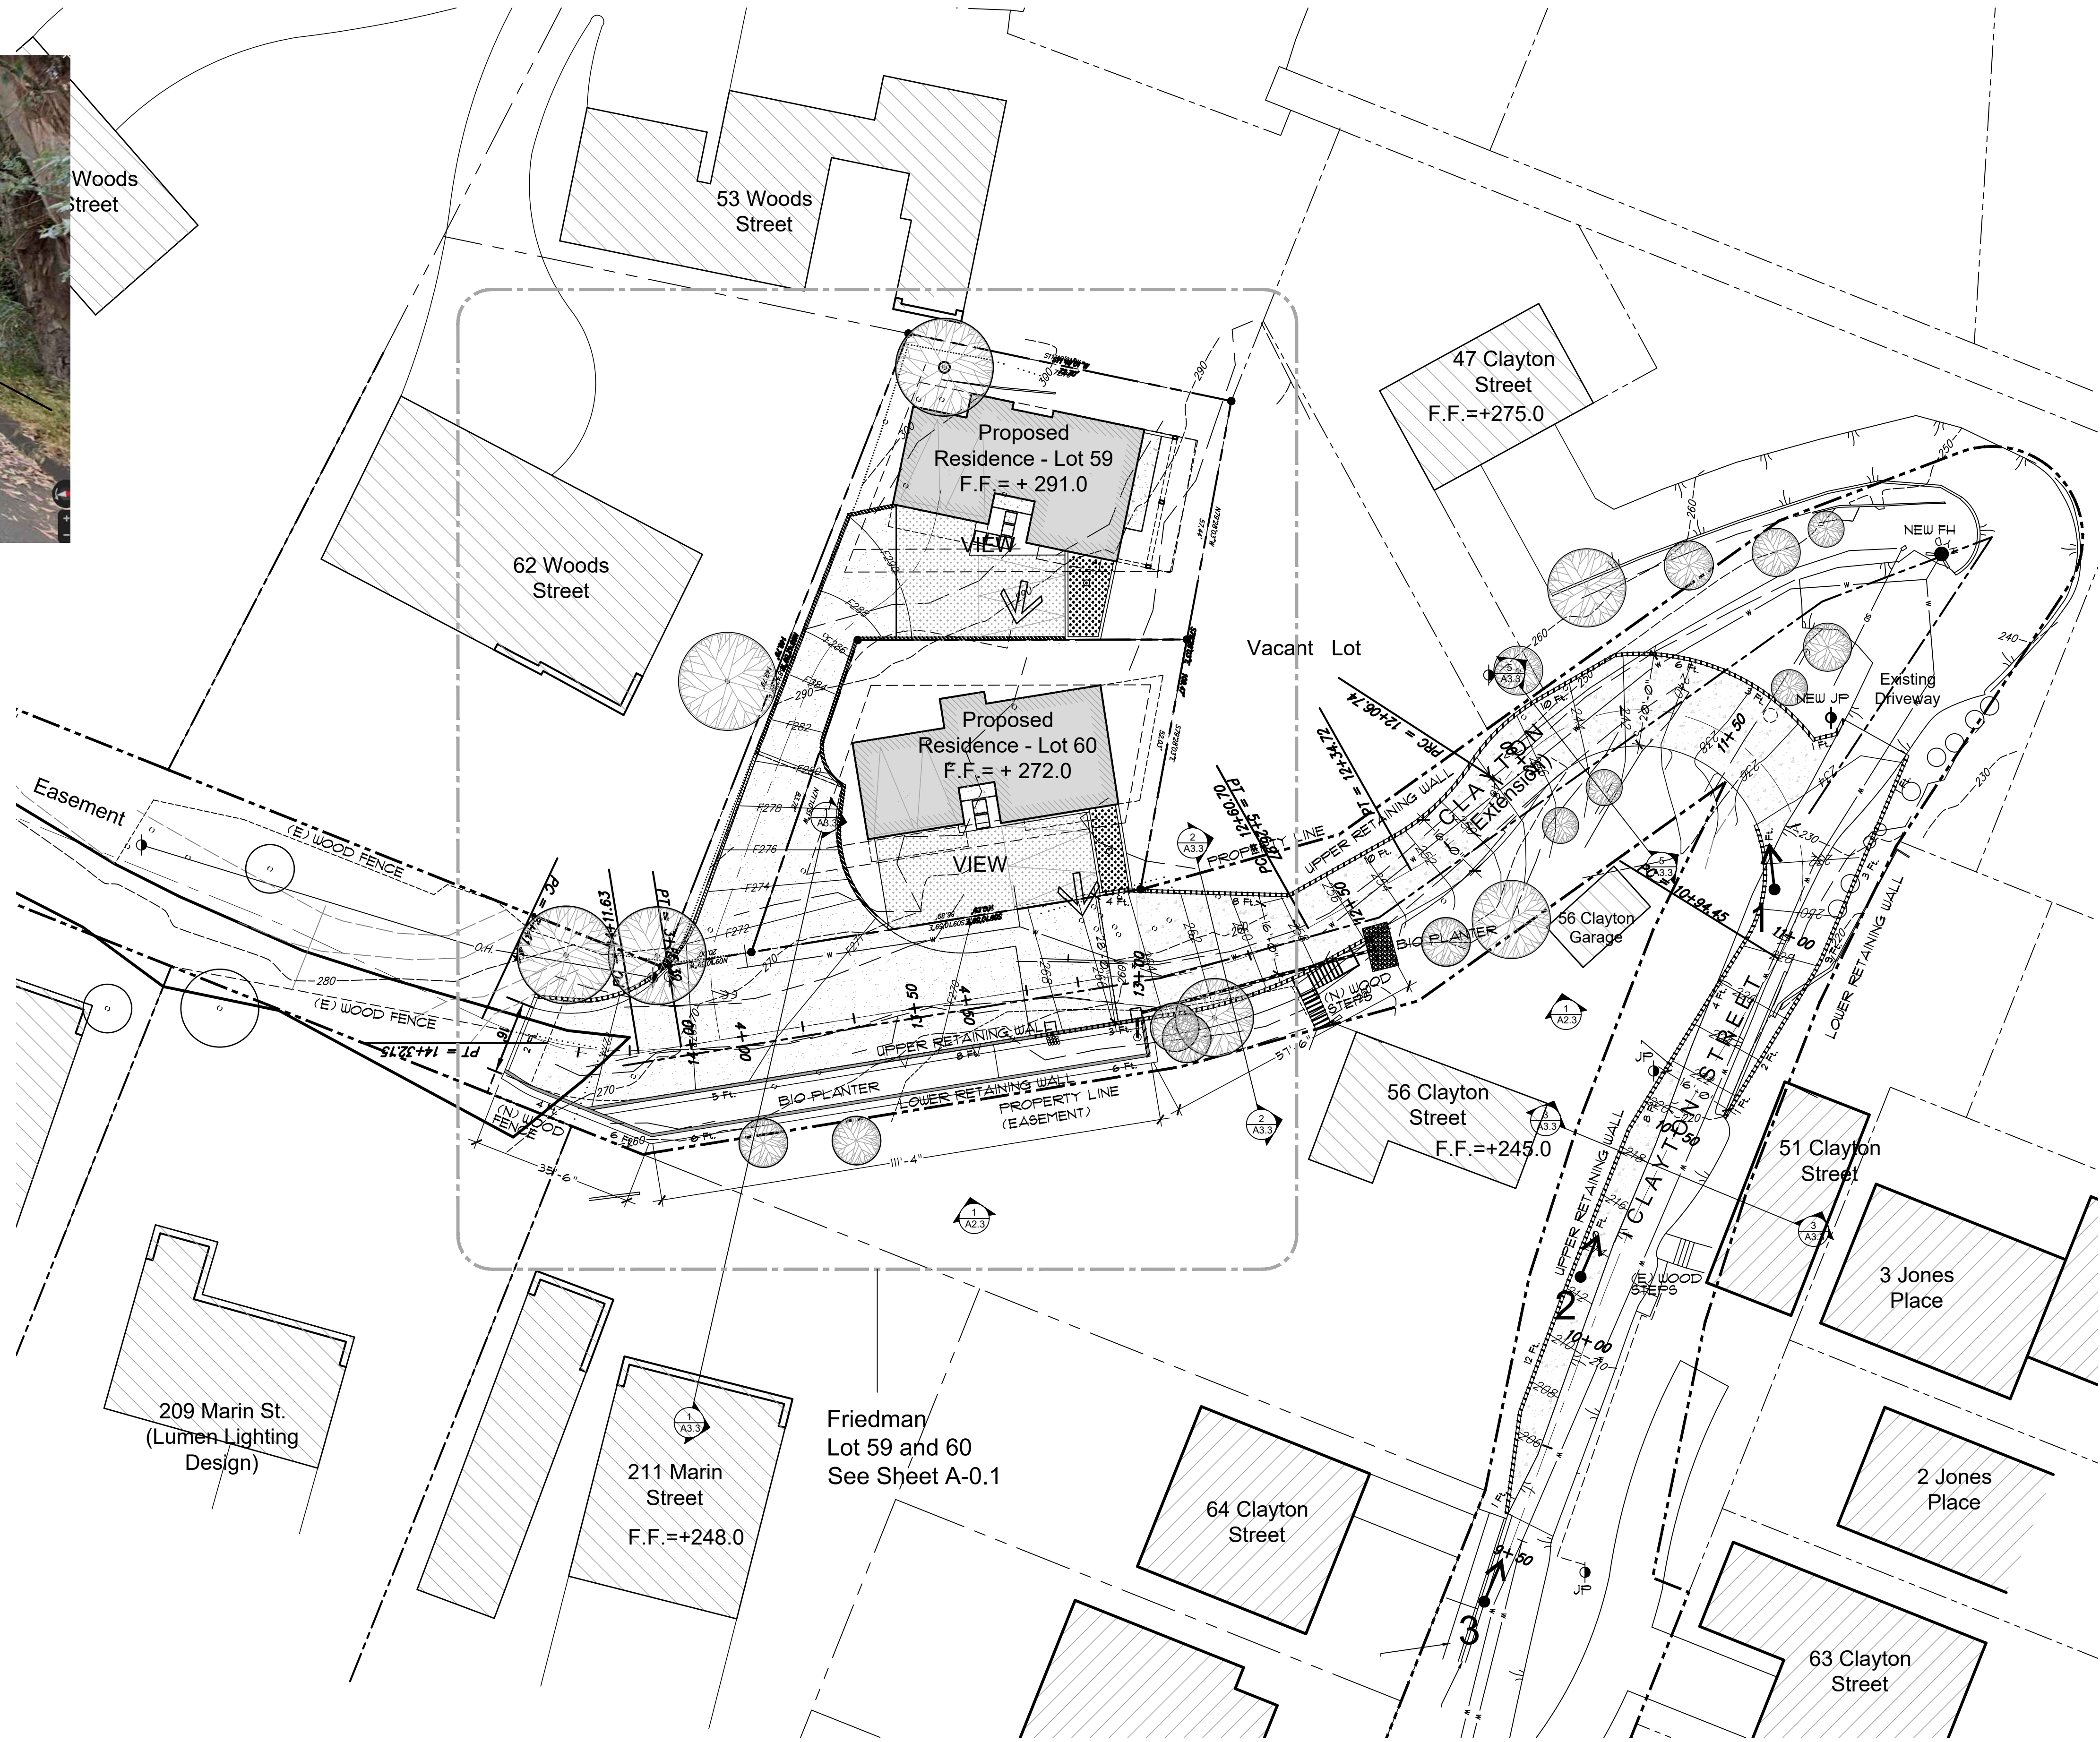


Site Vicinity Plan

© ALL DRAWINGS AND WRITTEN MATERIAL APPEARING HEREIN CONSTITUTE THE DESIGN AND ARCHITECTURAL WORK OF JOSEPH P. FARRELL ARCHITECT, AND THE SAME ARE NOT TO BE REPRODUCED, COPIED, OR DISCLOSED WITHOUT THE WRITTEN CONSENT OF JOSEPH P. FARRELL ARCHITECT.

REVISIONS	DATE	BY

Joseph Farrell
ARCHITECTURE
1 Commercial Blvd, Suite 106
Novato, CA 94949
Voice (415) 884-2860

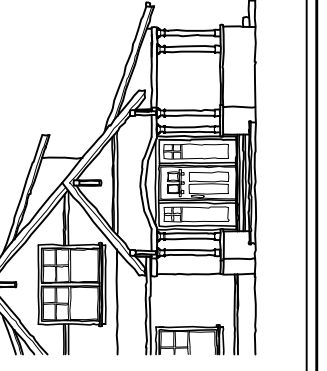


New Residence
Friedman Residence
Lots 59 and 60 - Clayton Street
San Rafael, CA APN 012-141-59 and 60

Site Vicinity
Plan

REVIEW THE DRAWINGS CAREFULLY. DO NOT SCALE THE DRAWINGS. ANY DISCREPANCIES IN DIMENSIONS AND DETAILS SHALL BE BROUGHT TO THE IMMEDIATE ATTENTION OF JOSEPH P. FARRELL ARCHITECT.
DATE: 4-15-22
SCALE: 1"=20'
DRAWN: STC
JOB NO. 1909
SHEET NO:

A-0.0
Ross Terrace
San Rafael, CA

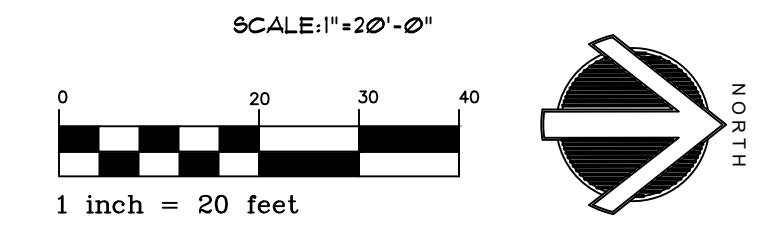


Preliminary Not for Construction

© ALL DRAWINGS AND WRITTEN MATERIAL APPEARING HEREIN CONSTITUTE THE DESIGN AND DEVELOPMENT OF JOSEPH P. FARRELL ARCHITECTURE AND SHALL BE THE PROPERTY OF JOSEPH P. FARRELL ARCHITECTURE. NO PART OF THIS DRAWING SHALL BE REPRODUCED OR TRANSMITTED IN ANY FORM OR BY ANY MEANS, ELECTRONIC OR MECHANICAL, WITHOUT THE WRITTEN CONSENT OF JOSEPH P. FARRELL ARCHITECTURE.

REVISIONS	DATE	BY

Joseph Farrell
ARCHITECTURE
1 Commercial Blvd, Suite 106
Novato, CA 94949
Voice (415) 884-2860

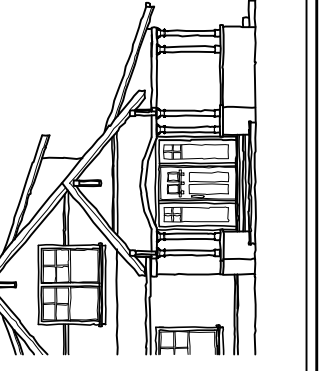

New Residence
Friedman Residence
Lots 59 and 60 - Clayton Street
San Rafael, CA APN 012-141-59 and 60

Proposed
Natural
State

REVIEW THE DRAWINGS CAREFULLY. DO NOT SCALE THE DRAWINGS. ANY DISCREPANCIES IN DIMENSIONS AND DETAILS SHALL BE BROUGHT TO THE IMMEDIATE ATTENTION OF JOSEPH P. FARRELL ARCHITECTURE.
DATE: 4-15-22
SCALE: 1/8"=1'-0"
DRAWN: STC
JOB NO. 1909
SHEET NO:

A0.1
Ross Terrace
San Rafael, CA

Natural State:

Lot 59: 36.7% Average Slope

Lot Size: 6,092 sf
Required: 3,759 sf
(Nat. State Calc: 36.7 + 25 = 61.7% x 6,092 sf = 3,759 sf)

Proposed N.S.: 1,902 sf

Residence Footprint: 1,302 sf
Deck Supports: 2 sf
Bio-Retention: 180 sf
Rtng. walls/paving: 1,879 sf
Pervious paving: 827 sf

Note: To Comply with DRB recommendation for meeting 8% of required natural state (3,045 sf) based on lot size, the building footprint could only be 151 square feet given the other requirements for access drives and guest parking.


Lot 60: 40.3% Average Slope

Lot Size: 4,787 sf
Required: 3,126 sf
(Nat. State Calc: 40.3 + 25 = 65.3% x 4,787 sf = 3,126 sf)



Proposed N.S.: 1,733 sf

Residence Footprint: 1,329 sf
Deck Supports: 11 sf
Bio-Retention: 145 sf
Rtng. walls/paving: 672 sf
Pervious paving: 897 sf

Note: To Comply with DRB recommendation for meeting 64% of required natural state (2,001 sf) based on lot size, the building footprint could only be 216 square feet given the other requirements for access drives and guest parking.

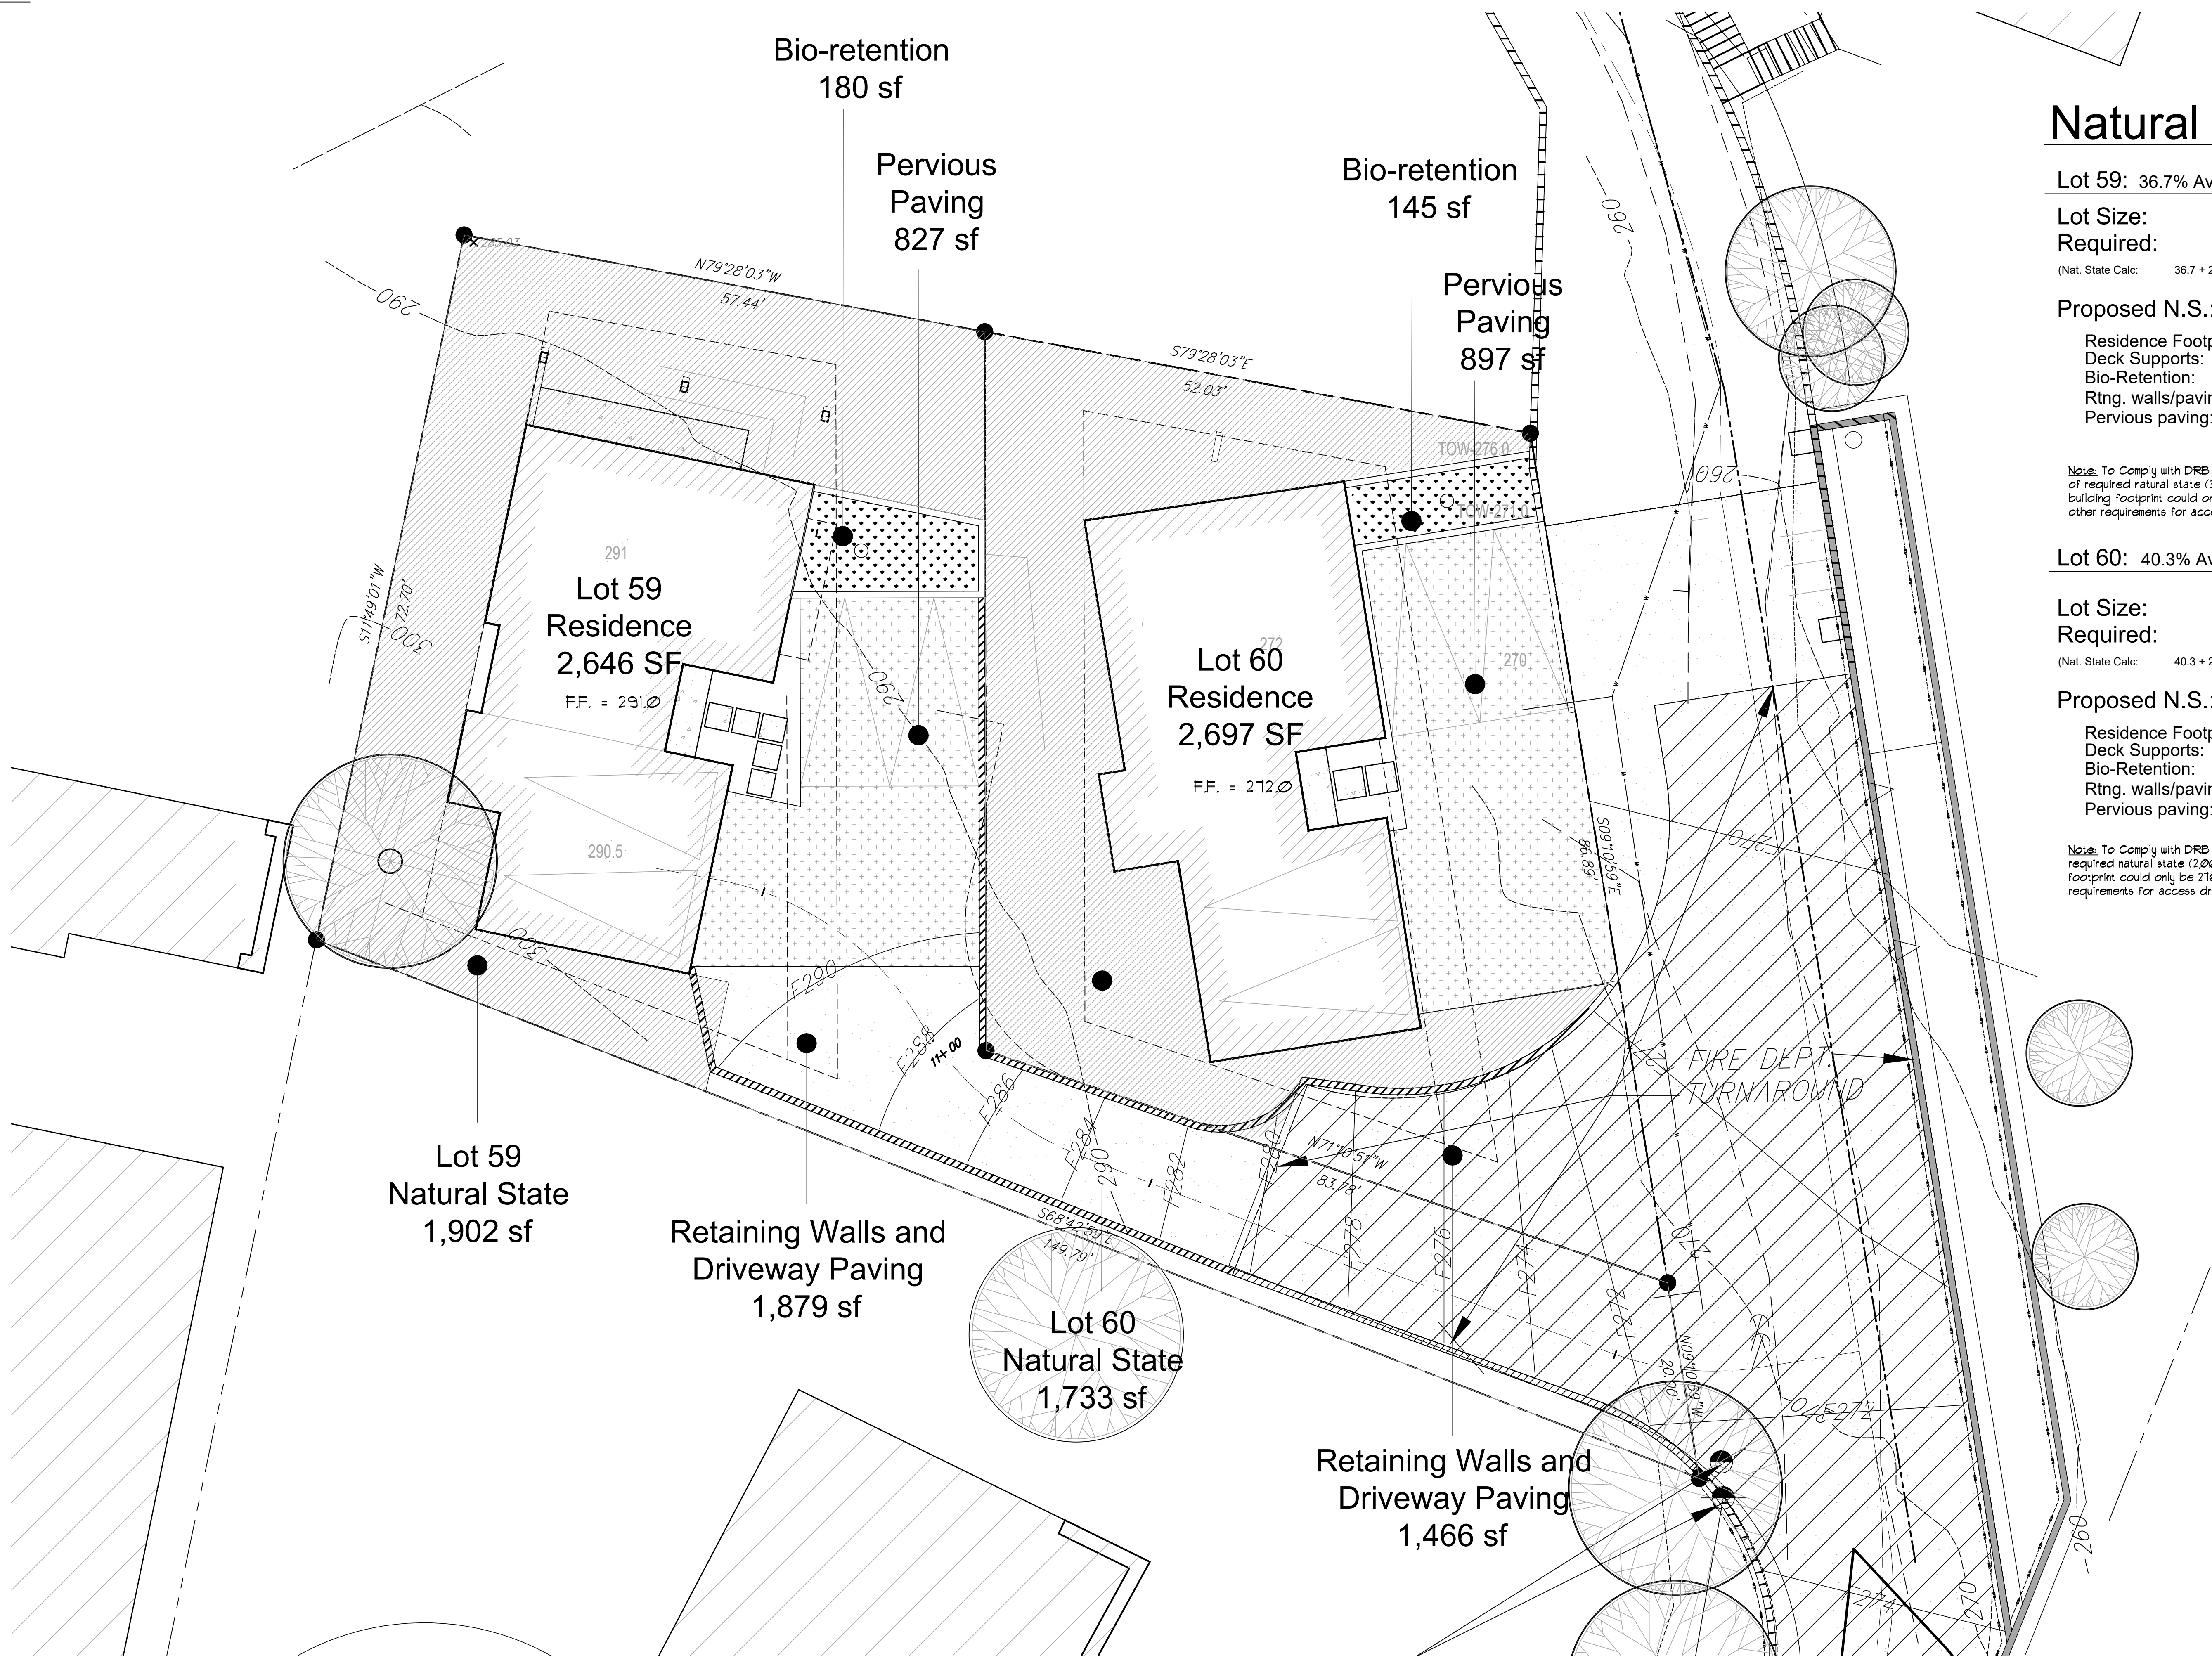

Proposed Natural State

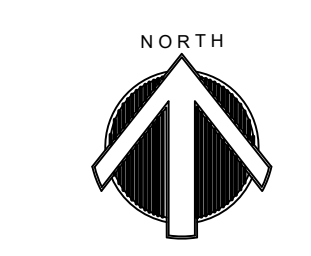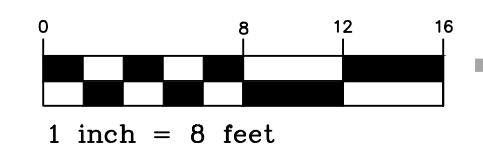

SCALE: 1/8"=1'-0"

Preliminary Not for Construction

© ALL DRAWINGS AND WRITTEN MATERIAL APPEARING HEREIN CONSTITUTE THE DESIGN AND ARCHITECTURAL WORK OF JOSEPH P. FARRELL ARCHITECT, AND THE SAME ARE NOT TO BE REPRODUCED, COPIED, OR DISCLOSED WITHOUT THE WRITTEN CONSENT OF JOSEPH P. FARRELL ARCHITECT.

REVISIONS	DATE	BY

Joseph Farrell
ARCHITECTURE

1 Commercial Blvd, Suite 106
Novato, CA 94949
Voice (415) 884-2860

New Residence
Friedman Residence
Lots 59 and 60 - Clayton Street
San Rafael, CA APN 012-141-59 and 60

Proposed
Site Plan

REVIEW THE DRAWINGS CAREFULLY. DO NOT SCALE THE DRAWINGS. ANY DISCREPANCIES IN DIMENSIONS AND DETAILS SHALL BE BROUGHT TO THE IMMEDIATE ATTENTION OF JOSEPH P. FARRELL ARCHITECT.

DATE:	4-15-22
SCALE:	1/8"=1'-0"
DRAWN:	STC
JOB NO.:	1909
SHEET NO.:	A0.2

A0.2
Ross Terrace
San Rafael, CA


Square Footage:

Lot 59: Residence A:

- Ground Floor - 782 sf
- Garage - 520 sf
- Second Floor - 1,344 sf
- Total: 2,646 sf

Lot 60: Residence B:


- Ground Floor - 874 sf
- Garage - 455 sf
- Second Floor - 1,368 sf
- Total: 2,697 sf

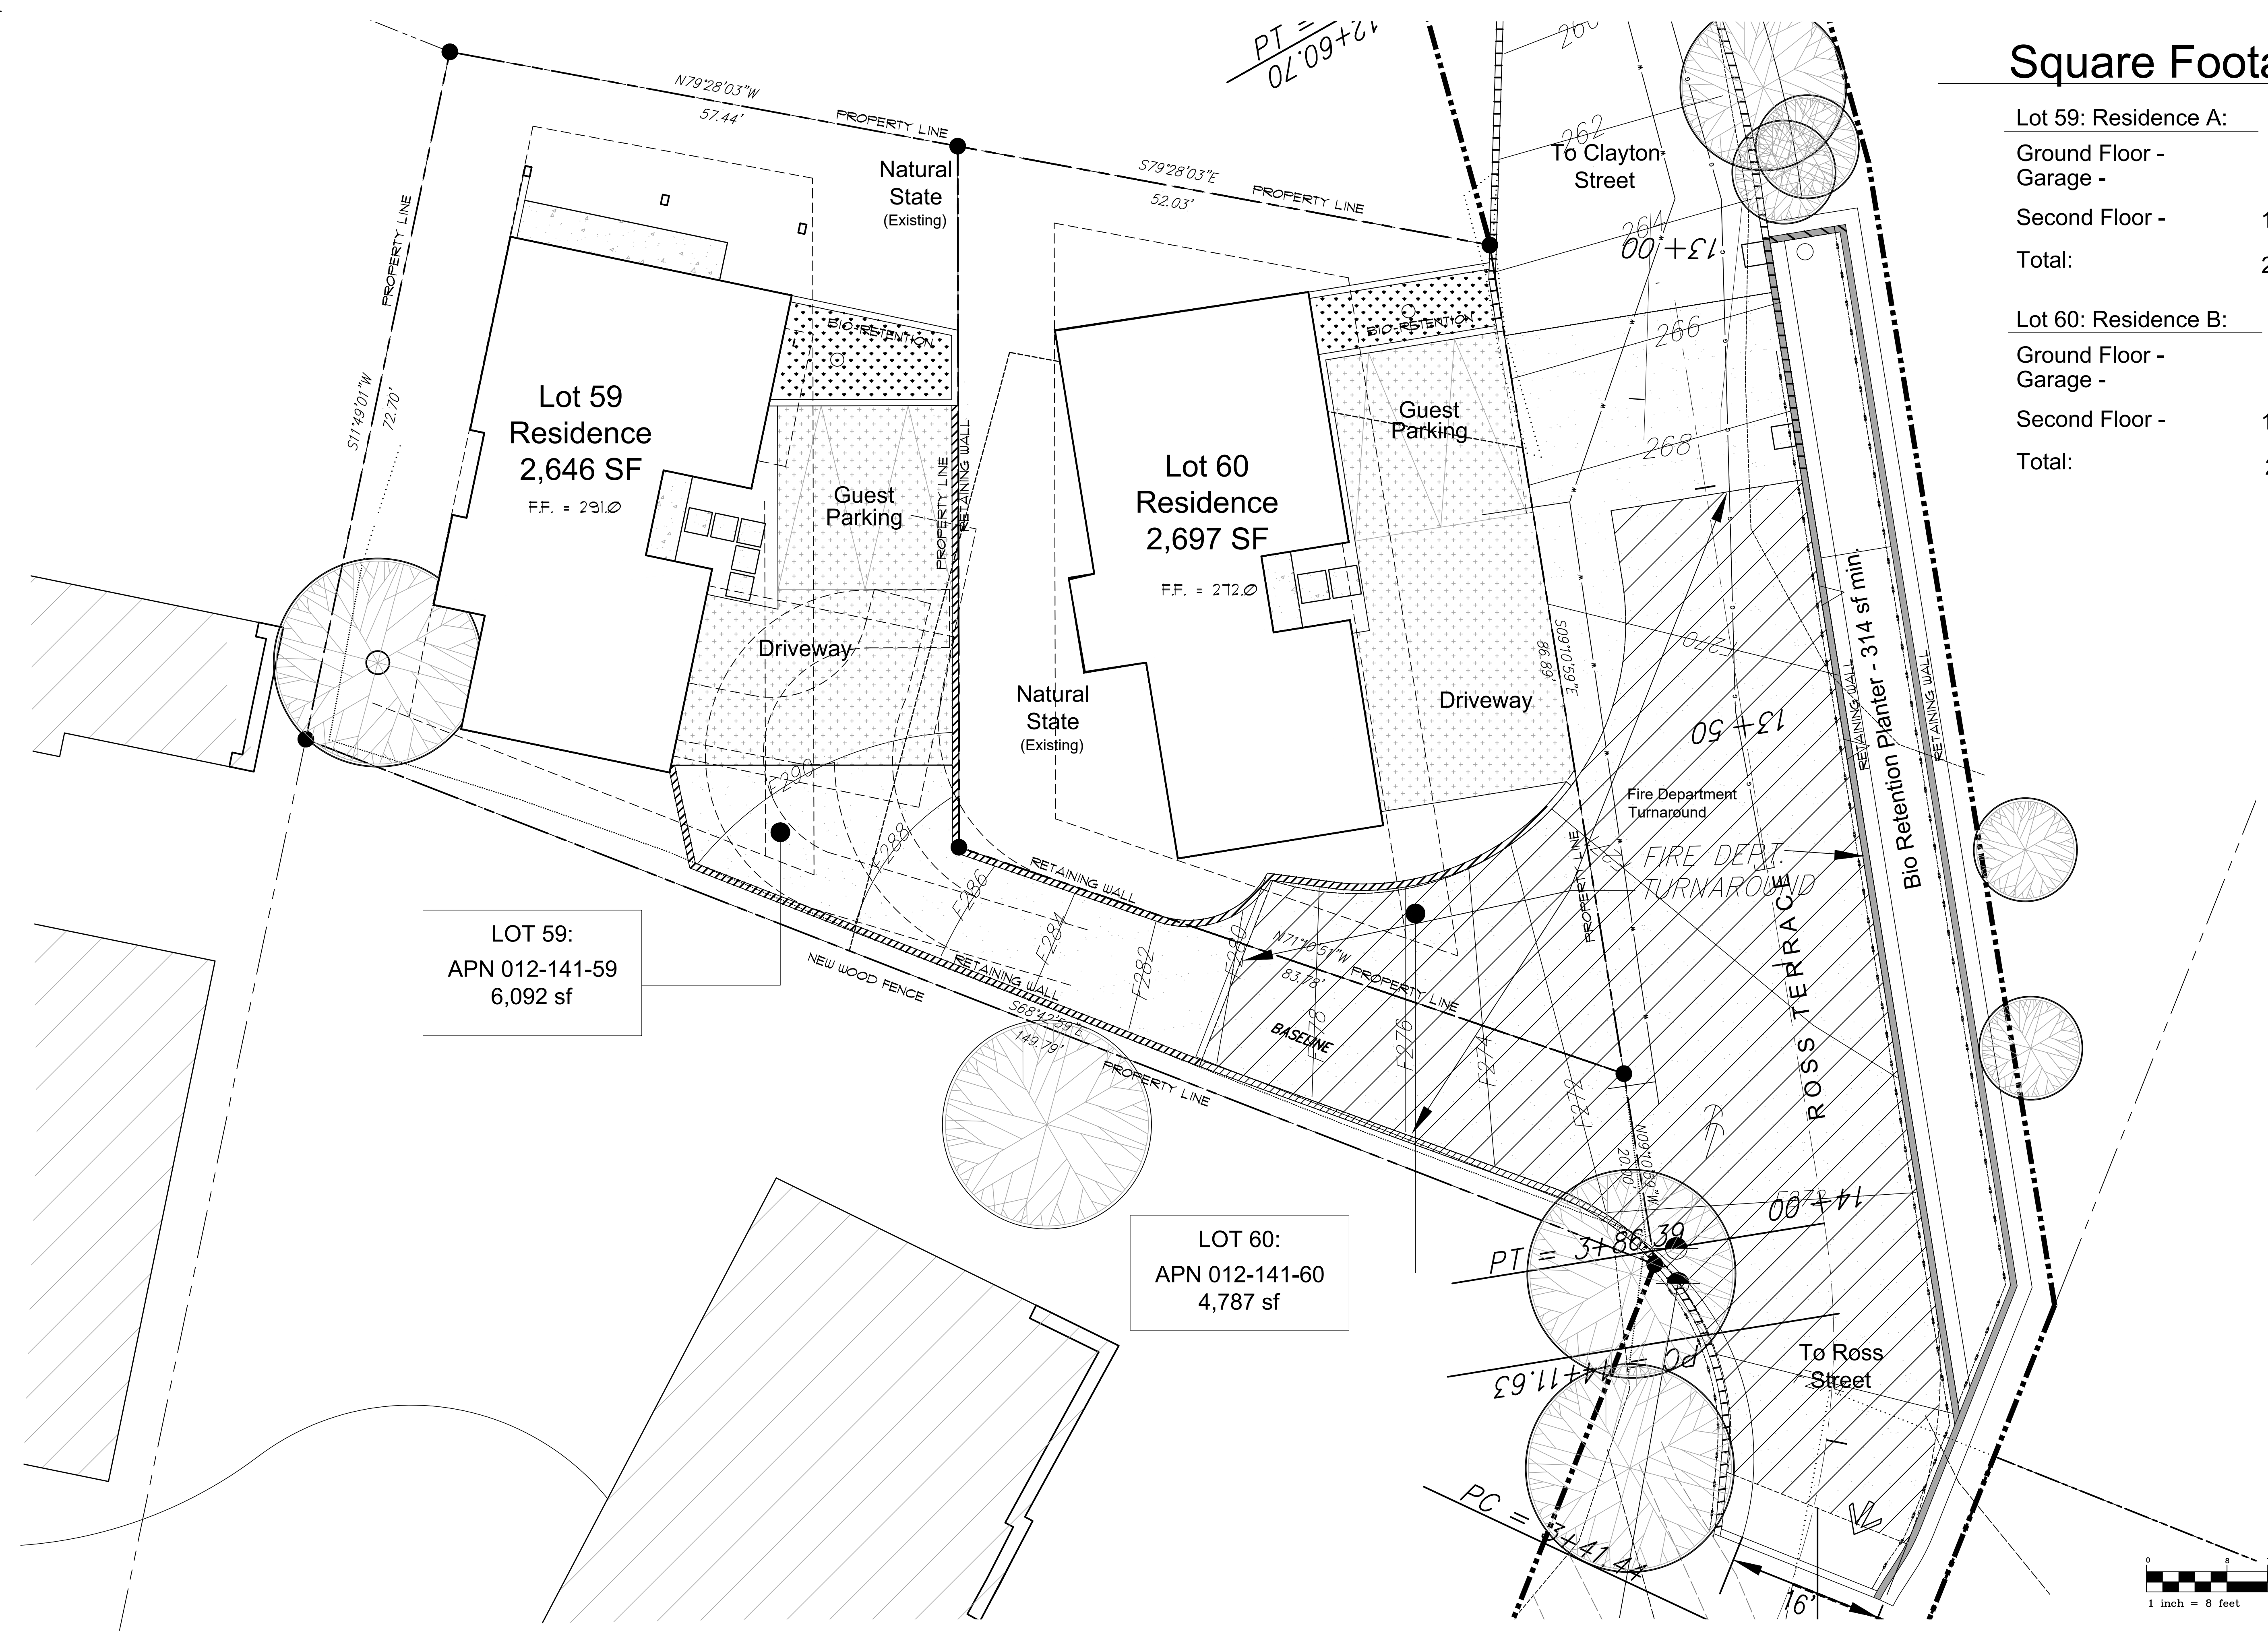

LOT 59:
APN 012-141-59
6,092 sf


LOT 60:
APN 012-141-60
4,787 sf

Proposed Site Plan

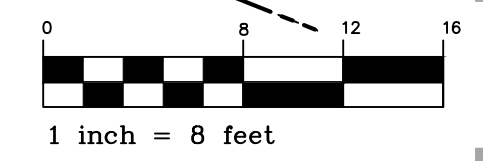


SCALE: 1/8"=1'-0"

Preliminary Not for Construction

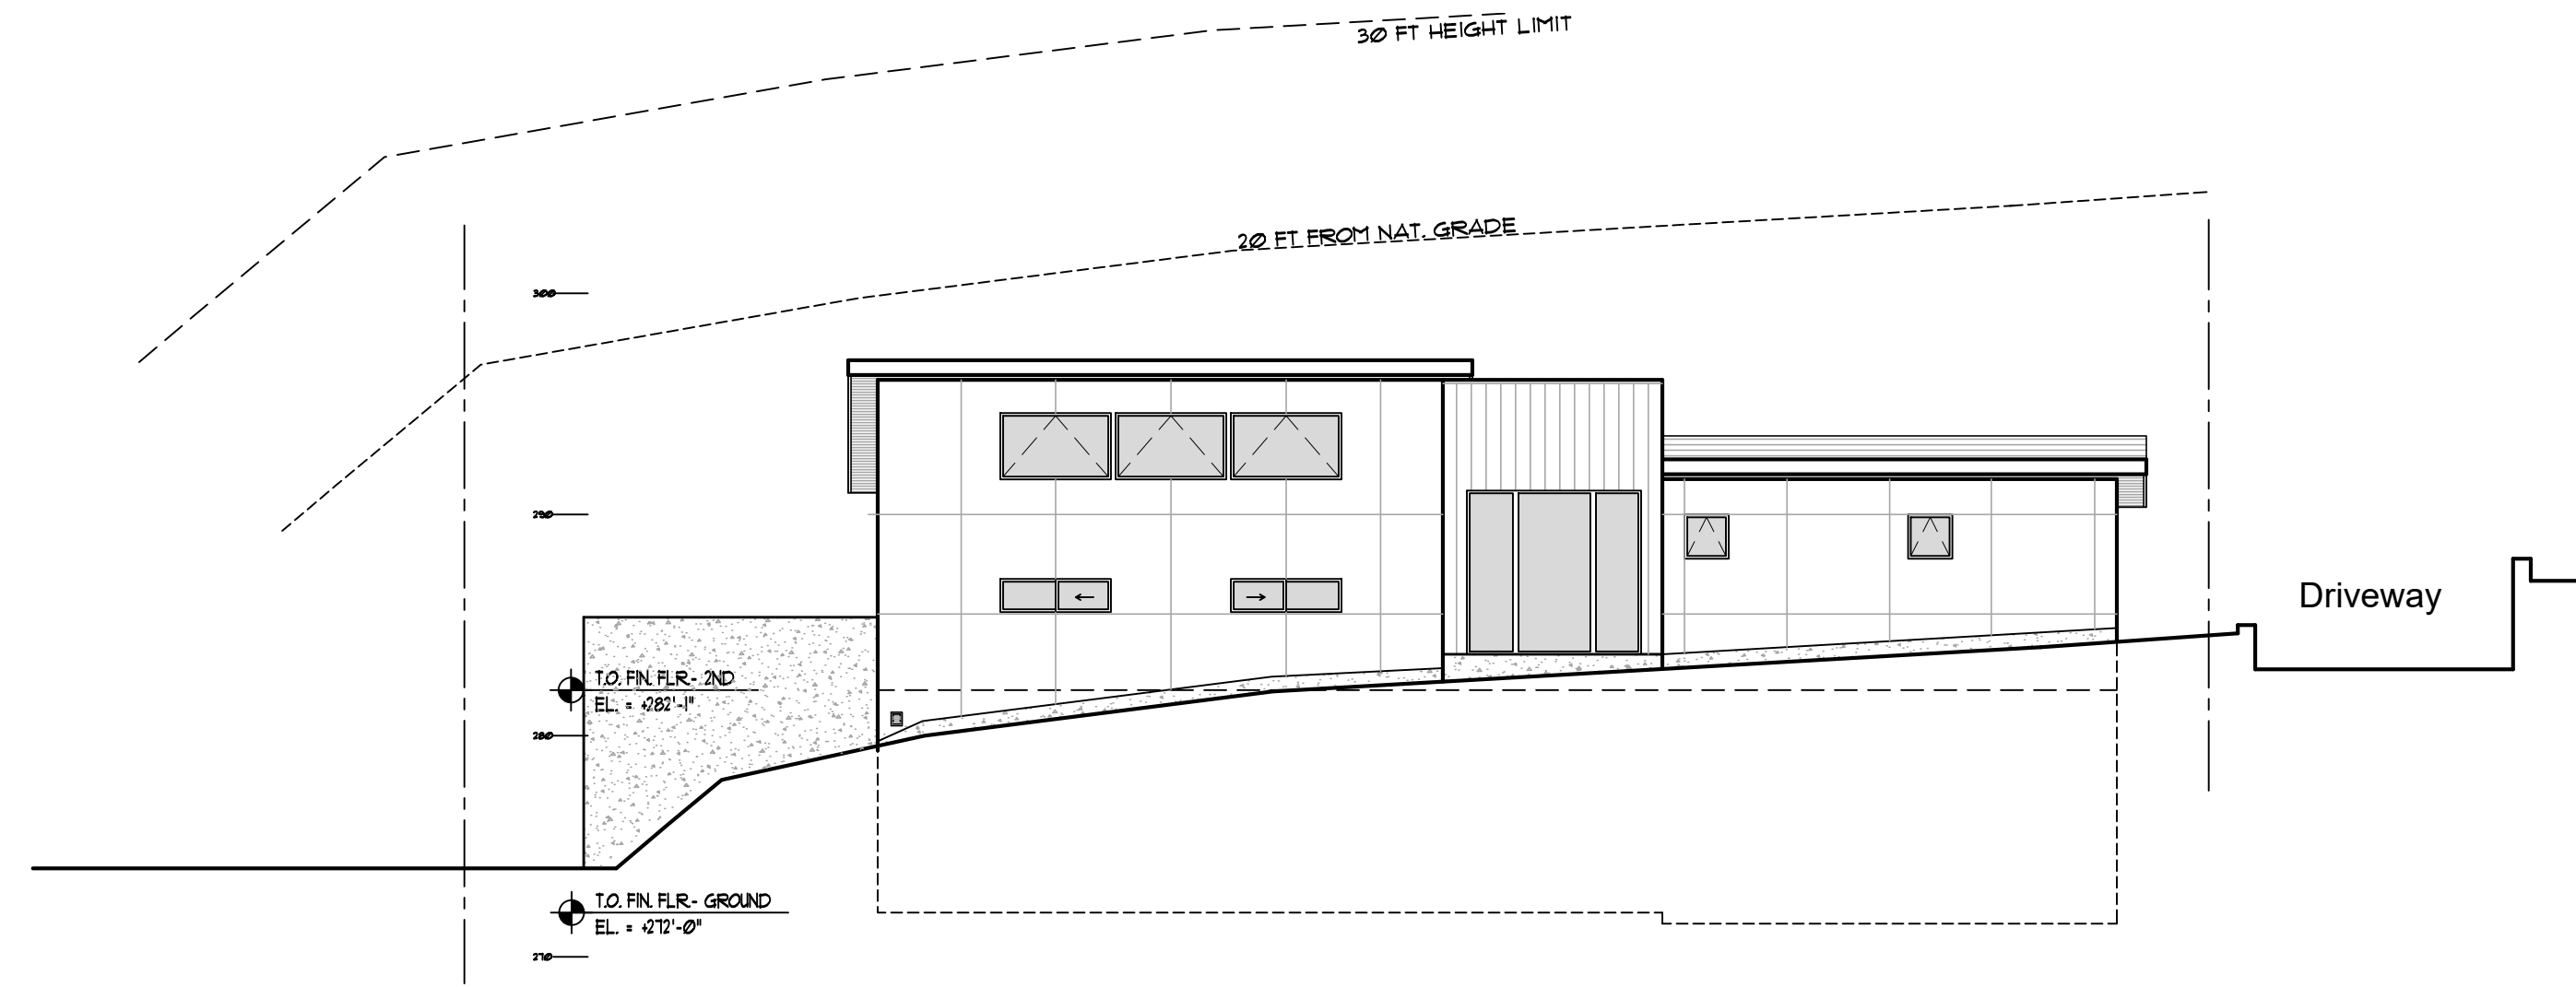


West (Rear) Elevation

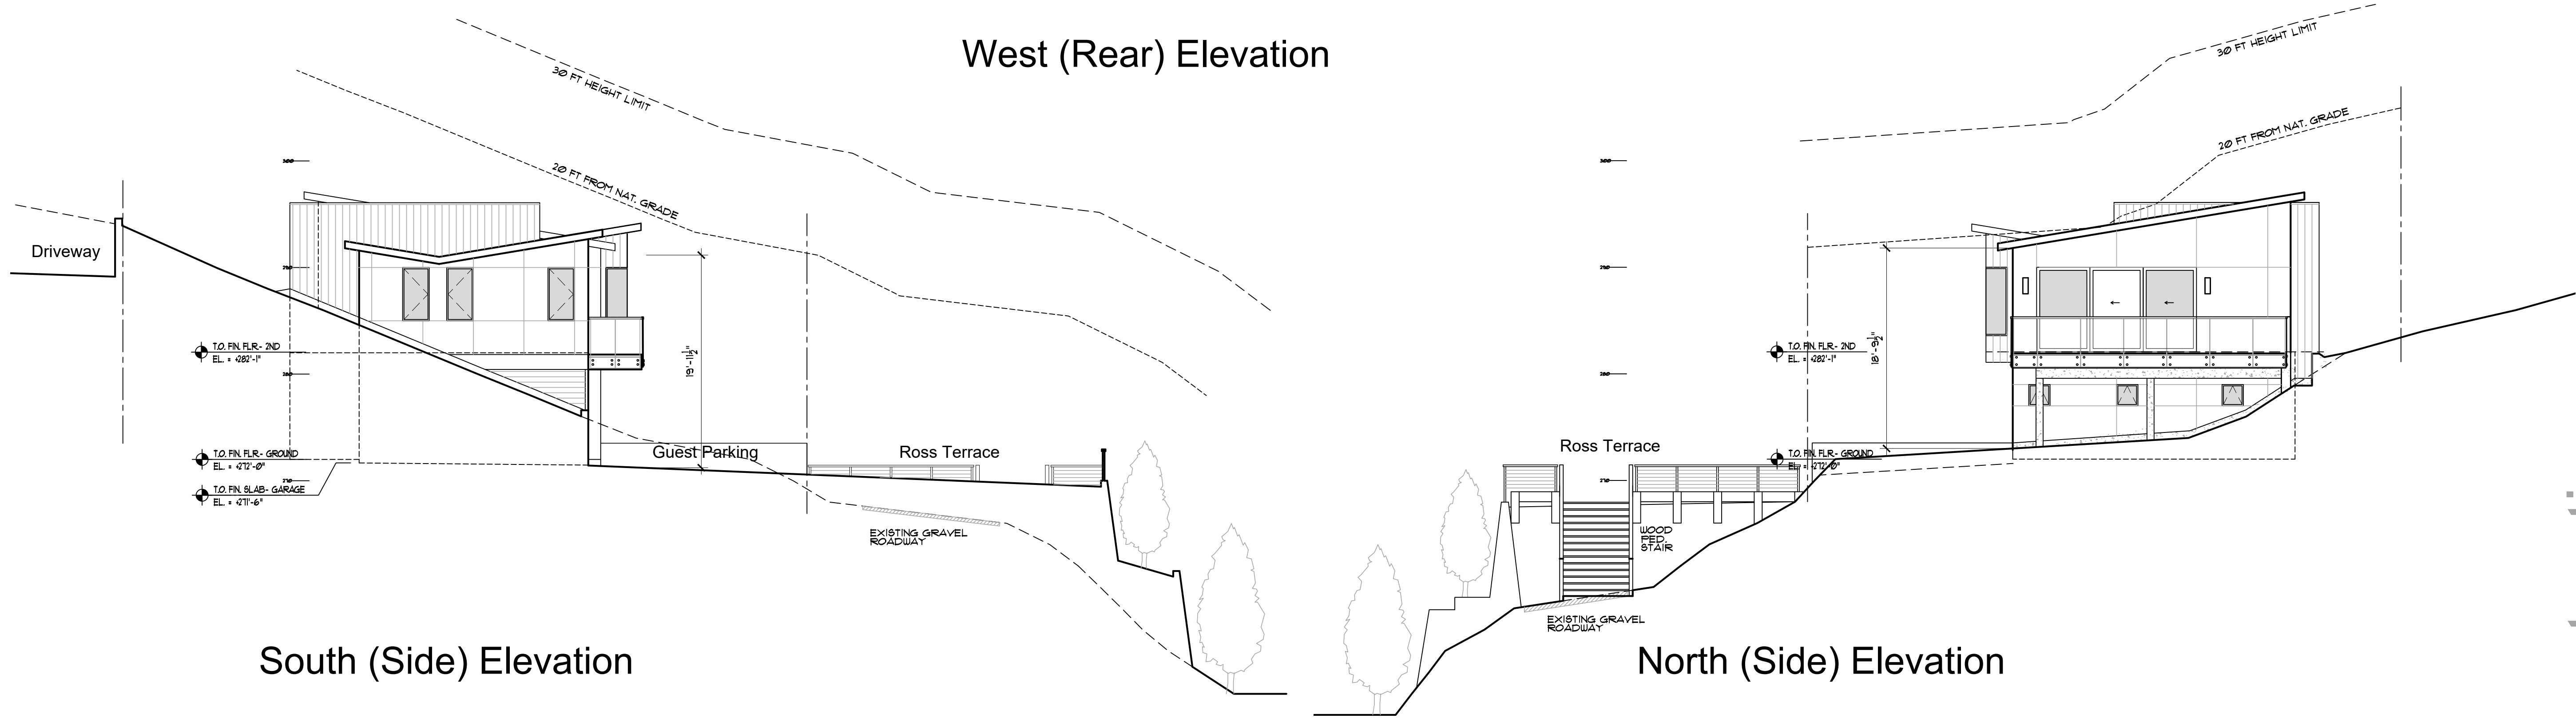


South (Side) Elevation

North (Side) Elevation

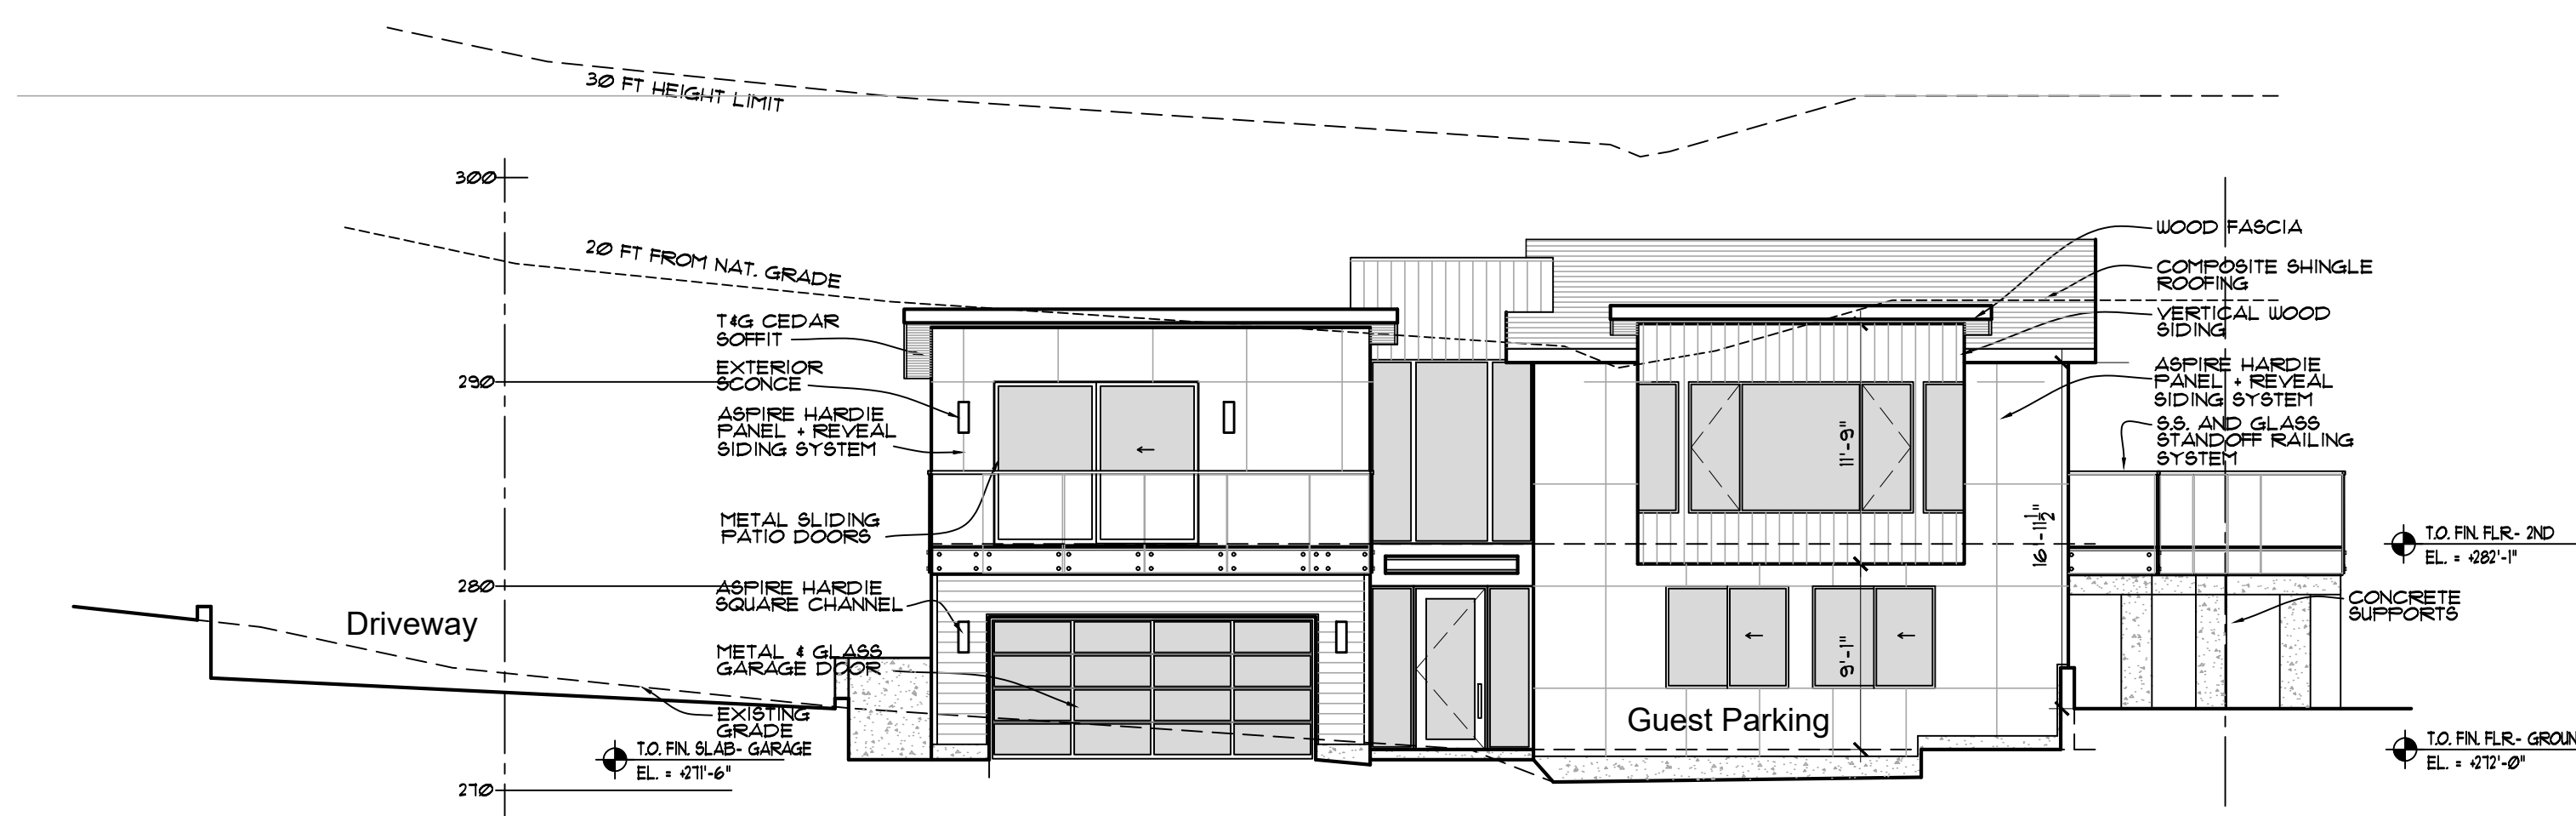

East (Front) Elevation

Proposed Exterior Elevations - Lot 60

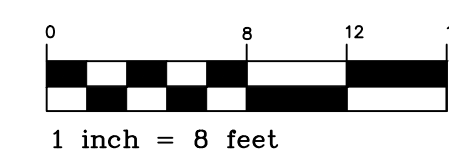


SCALE: 1/8" = 1'-0"

© ALL DIMENSIONS AND MATERIAL SPECIFICATIONS ARE TO BE CONSIDERED THE OWNERS AND ARCHITECTS WORK. NO PART OF THIS DRAWING SHALL BE REPRODUCED OR TRANSMITTED IN ANY FORM OR BY ANY MEANS WITHOUT THE WRITTEN CONSENT OF JOSEPH F. FARRELL, ARCHITECT.

REVISIONS	DATE	BY

Joseph Farrell
ARCHITECTURE
1 Commercial Blvd., Suite 106
Novato, CA 94949
Voice (415) 884-2860

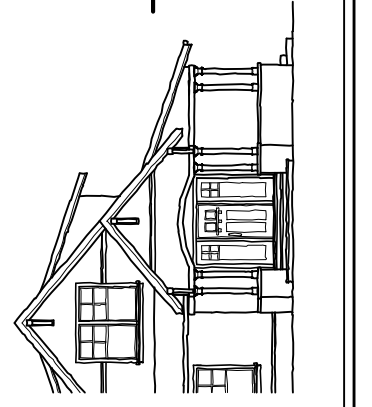

New Residence
Friedman Residence
Lots 59 and 60 - Clayton Street
San Rafael, CA APN 012-141-59 and 60

Proposed
Exterior
Elevations
Lot 60

BEFORE THE DRAWINGS ARE USED, THE OWNER SHALL BE RESPONSIBLE FOR OBTAINING ALL NECESSARY PERMITS AND SHALL BE RESPONSIBLE FOR THE MAINTENANCE AND PROTECTION OF THE DRAWINGS. THE ARCHITECT'S LIABILITY IS LIMITED TO THE ARCHITECT'S PROFESSIONAL FEES AND SHALL BE LIMITED TO THE ARCHITECT'S NEGLIGENCE.


DATE: 4-15-22
SCALE: 1/8" = 1'-0"
DRAWN: STC
JOB NO. 1909
SHEET NO:

A-2.1
Ross Terrace
San Rafael, CA

Preliminary Not for Construction

REVISIONS	DATE	BY

Joseph Farrell
ARCHITECTURE
1 Commercial Blvd, Suite 106
Novato, CA 94949
Voice (415) 884-2860

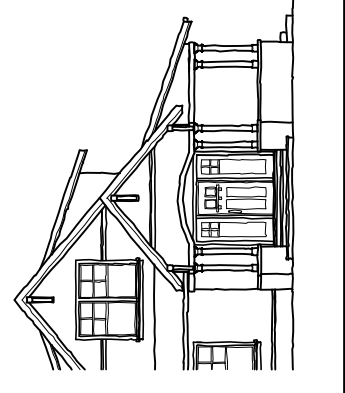

New Residence
Friedman Residence
Lots 59 and 60 - Clayton Street
San Rafael, CA APN 012-141-59 and 60


Proposed
Exterior
Elevations
Lot 59

REVIEW THE DRAWINGS CAREFULLY. DO NOT SCALE THE DRAWINGS. ANY DISCREPANCIES IN DIMENSIONS AND DETAILS SHALL BE BROUGHT TO THE IMMEDIATE ATTENTION OF JOSEPH F. FARRELL, ARCHITECT.


DATE: 4-15-22
SCALE: 1/8" = 1'-0"
DRAWN: STC
JOB NO. 1909
SHEET NO:

A-2.2
Ross Terrace
San Rafael, CA


Preliminary Not for Construction

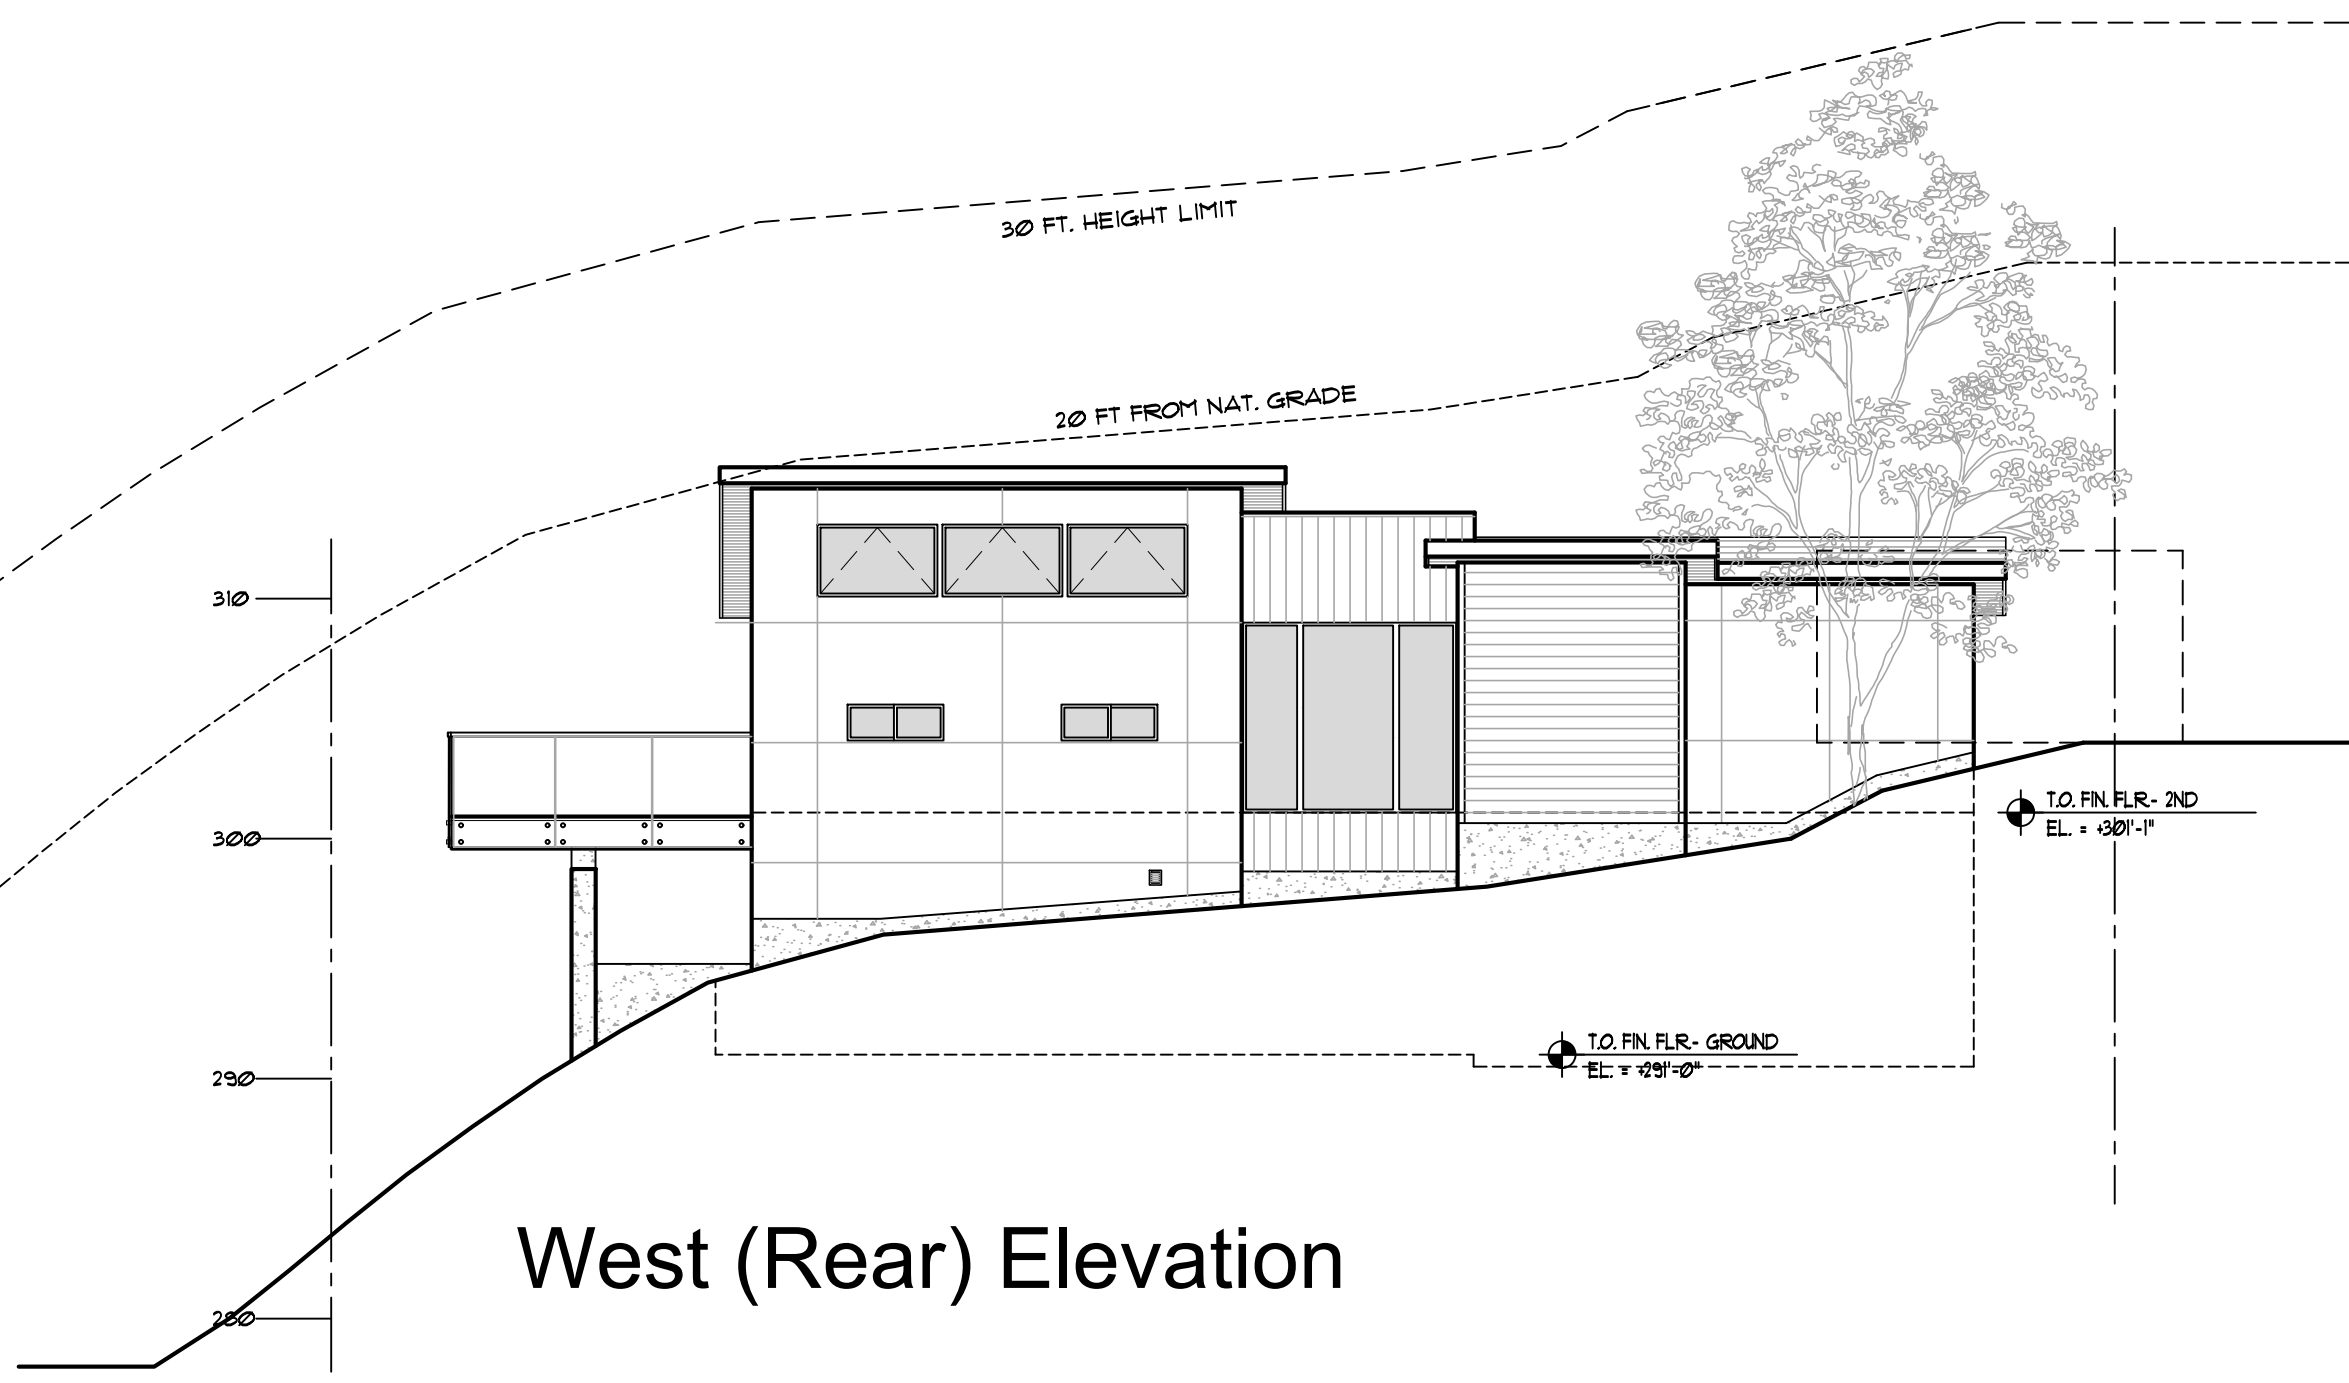


West (Rear) Elevation

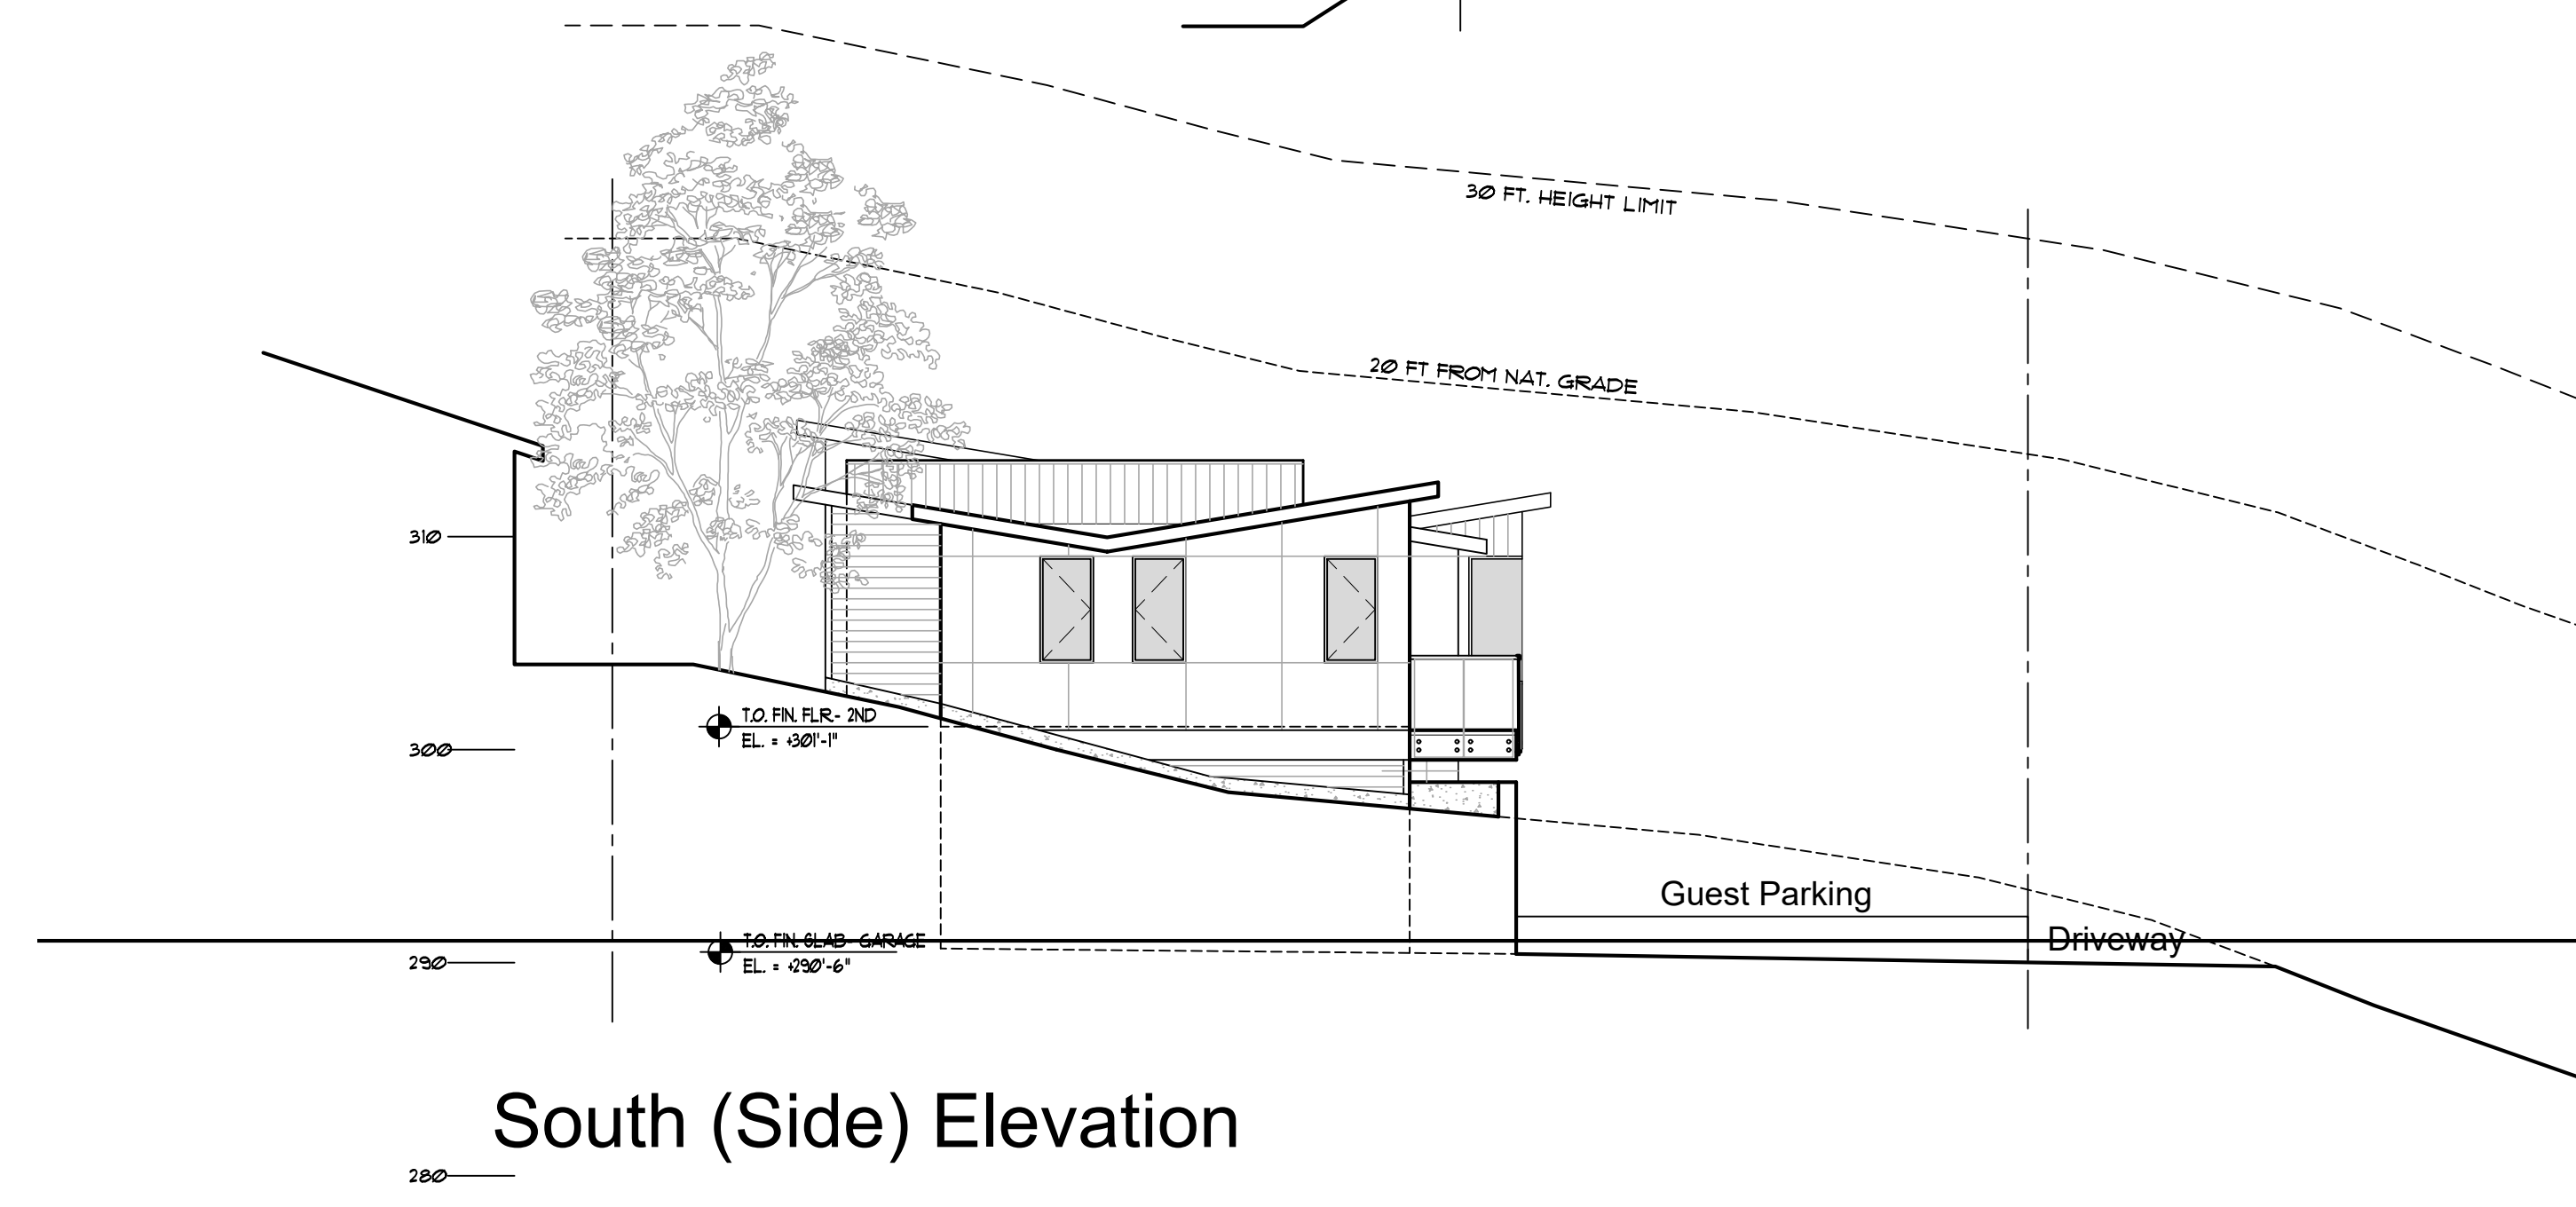


South (Side) Elevation

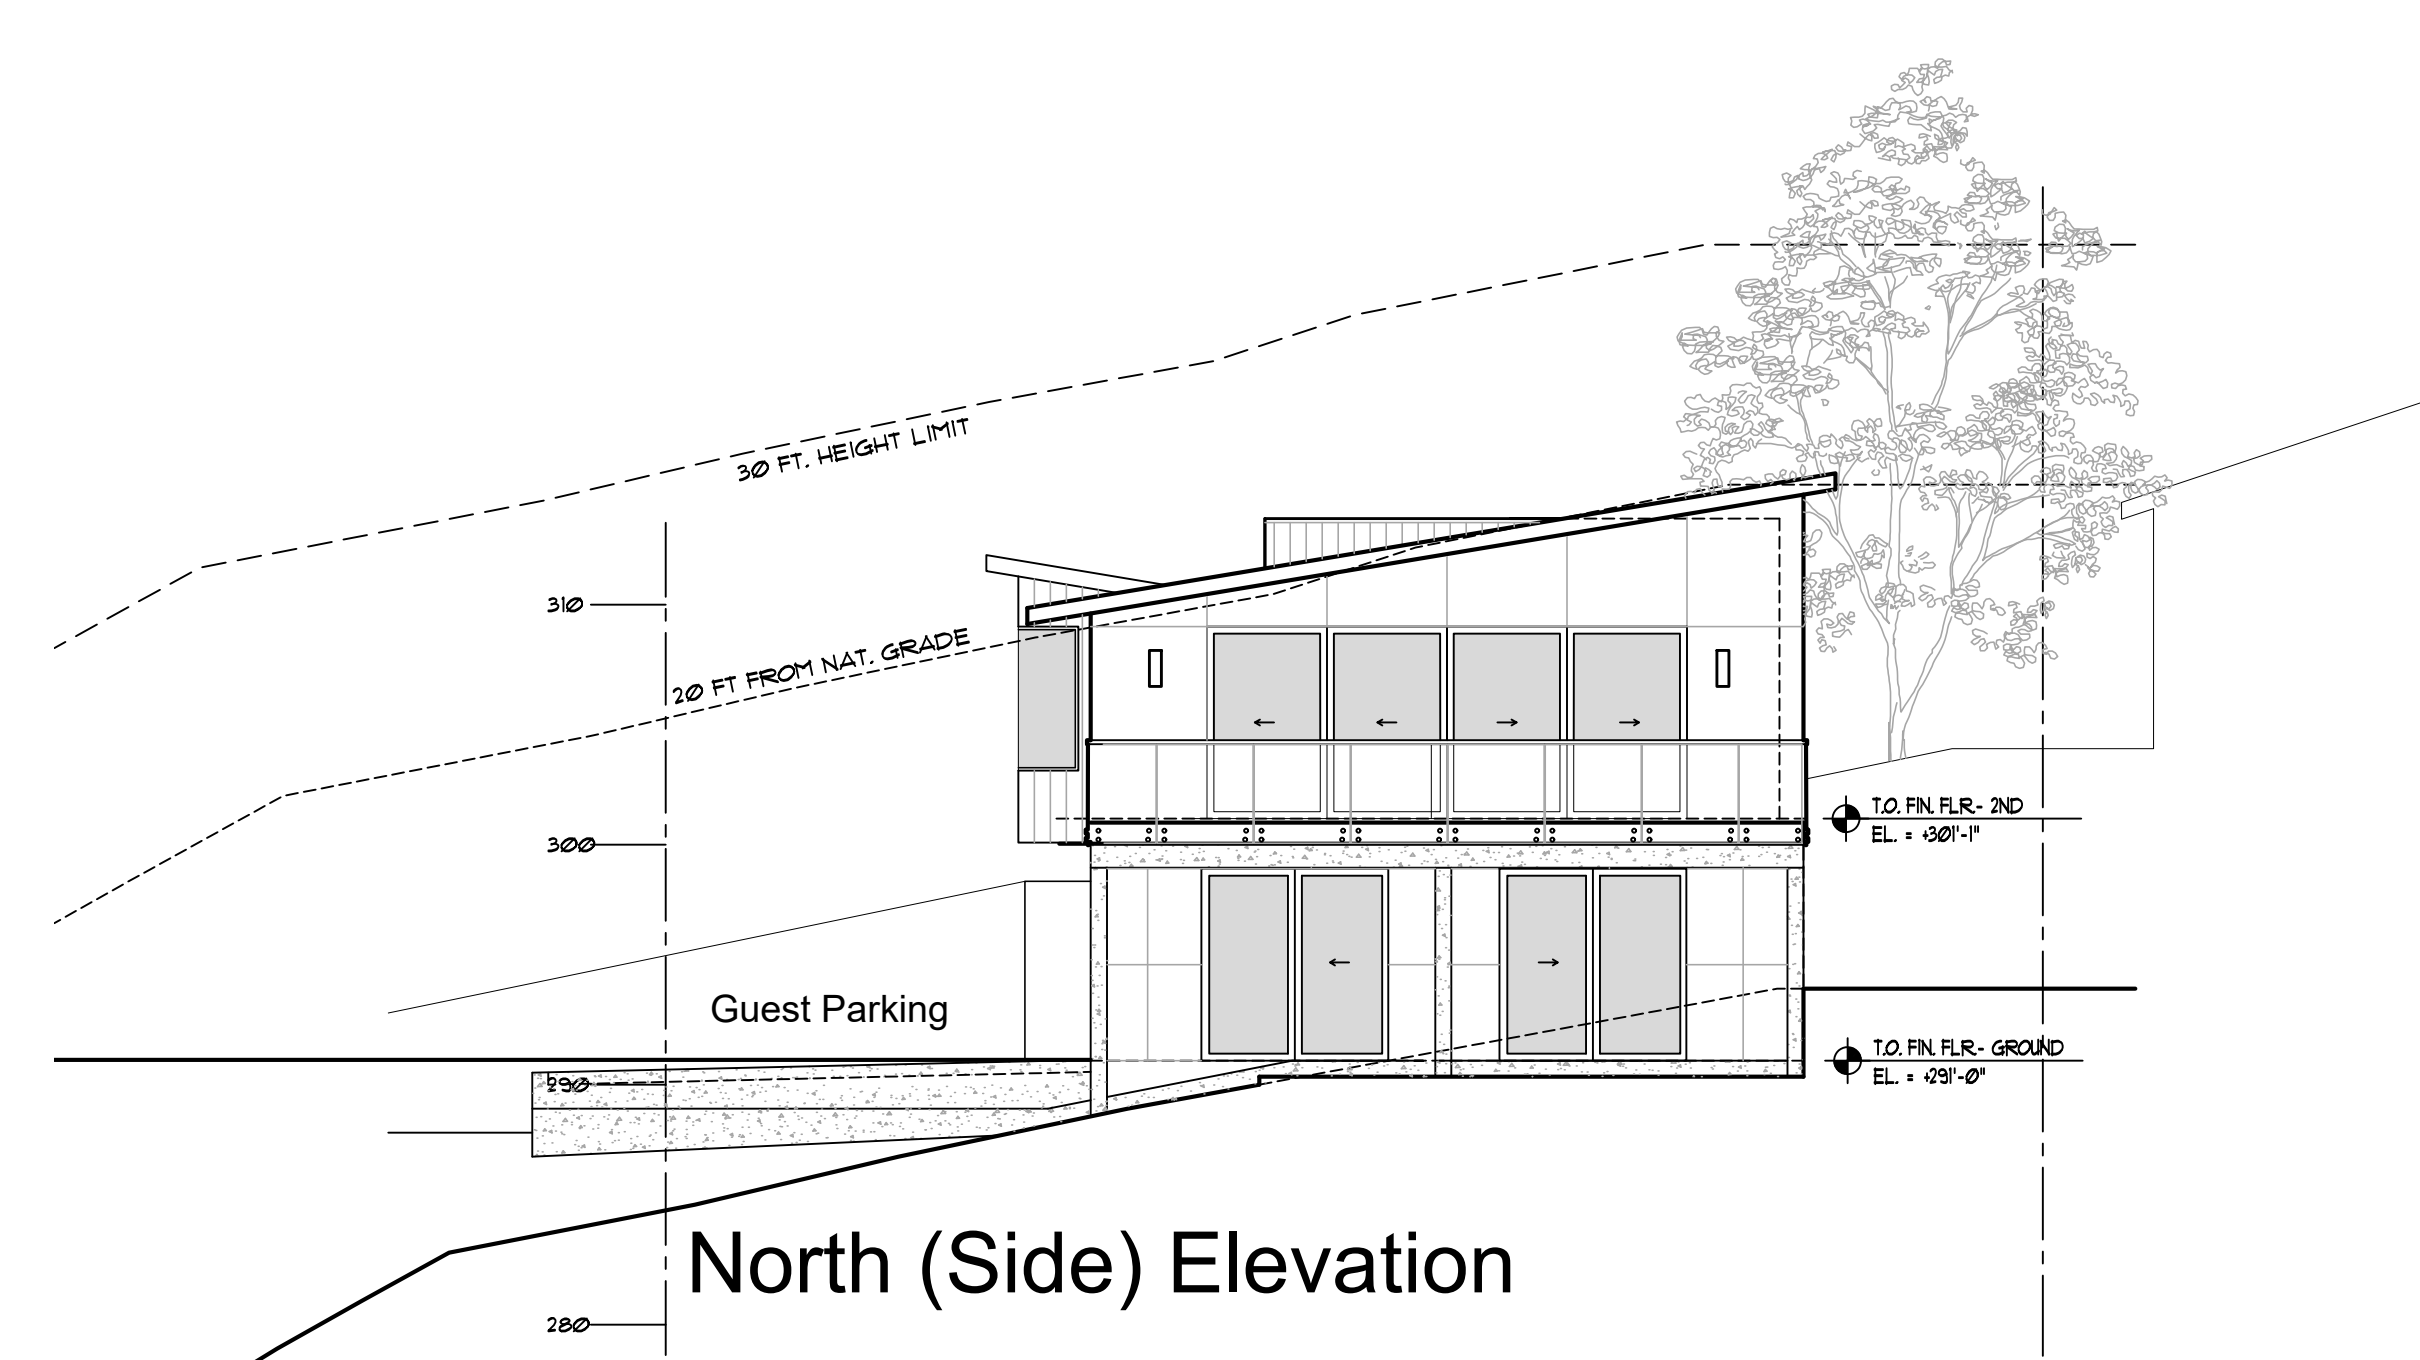

North (Side) Elevation

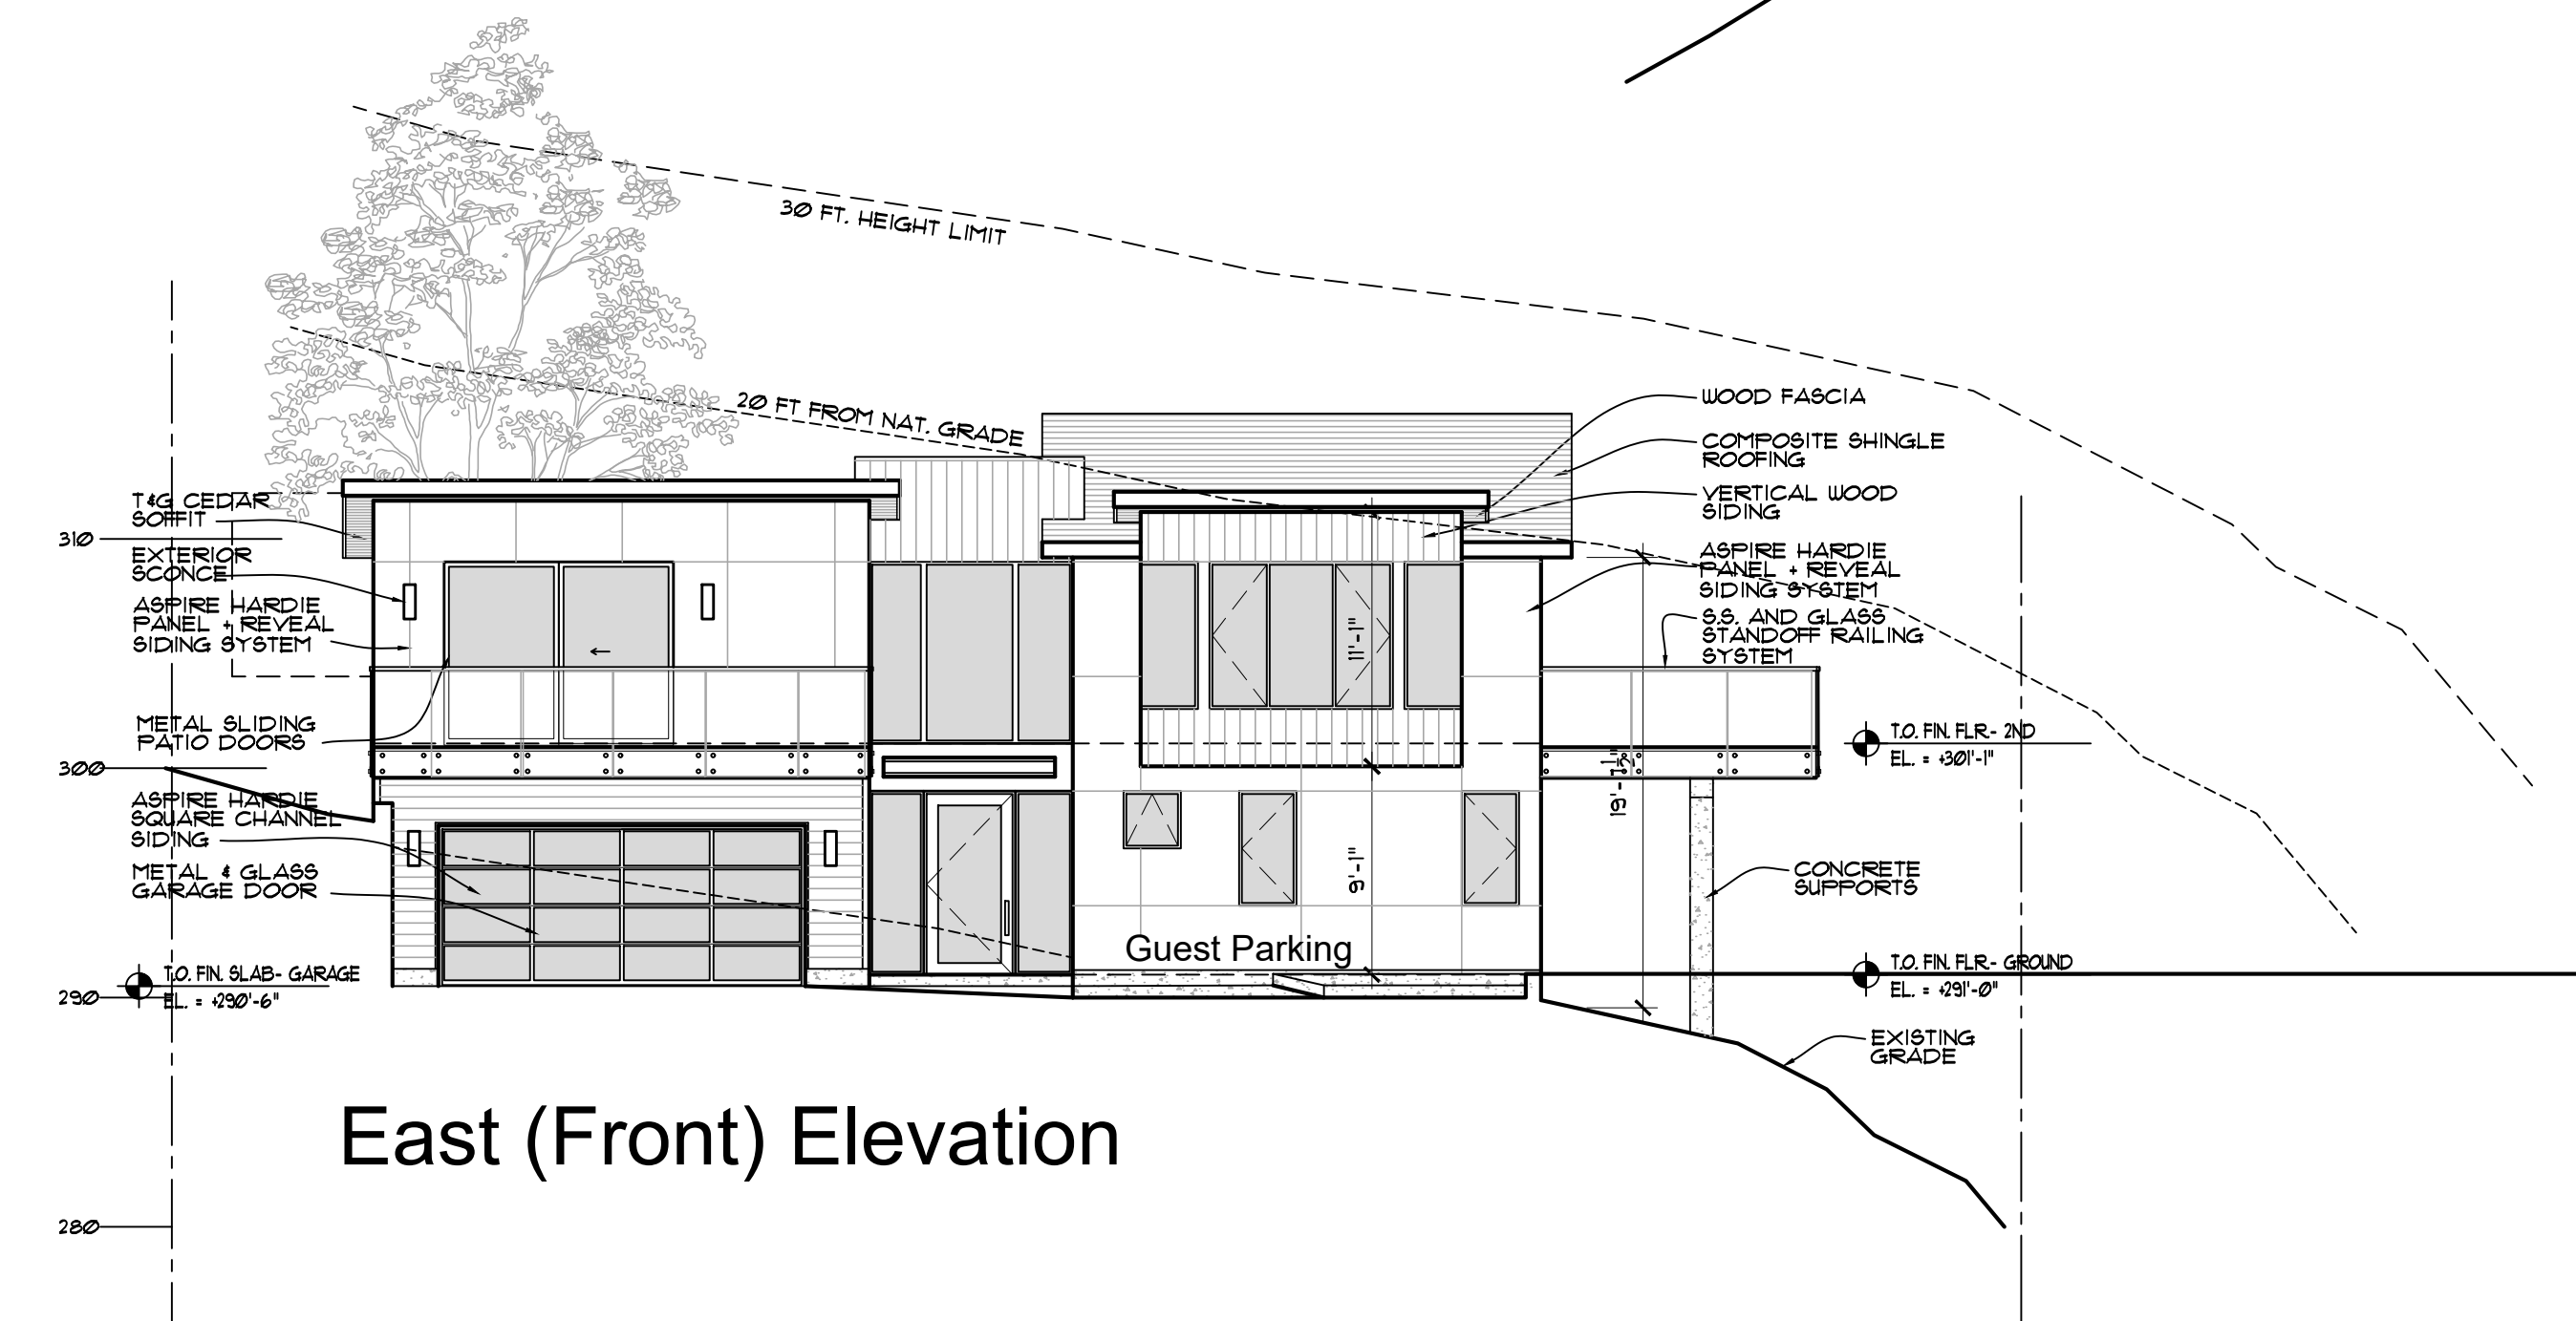


East (Front) Elevation

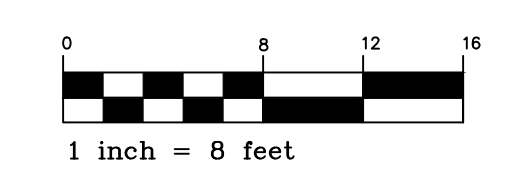


SCALE: 1/8" = 1'-0"

Proposed Exterior Elevations - Lot 59

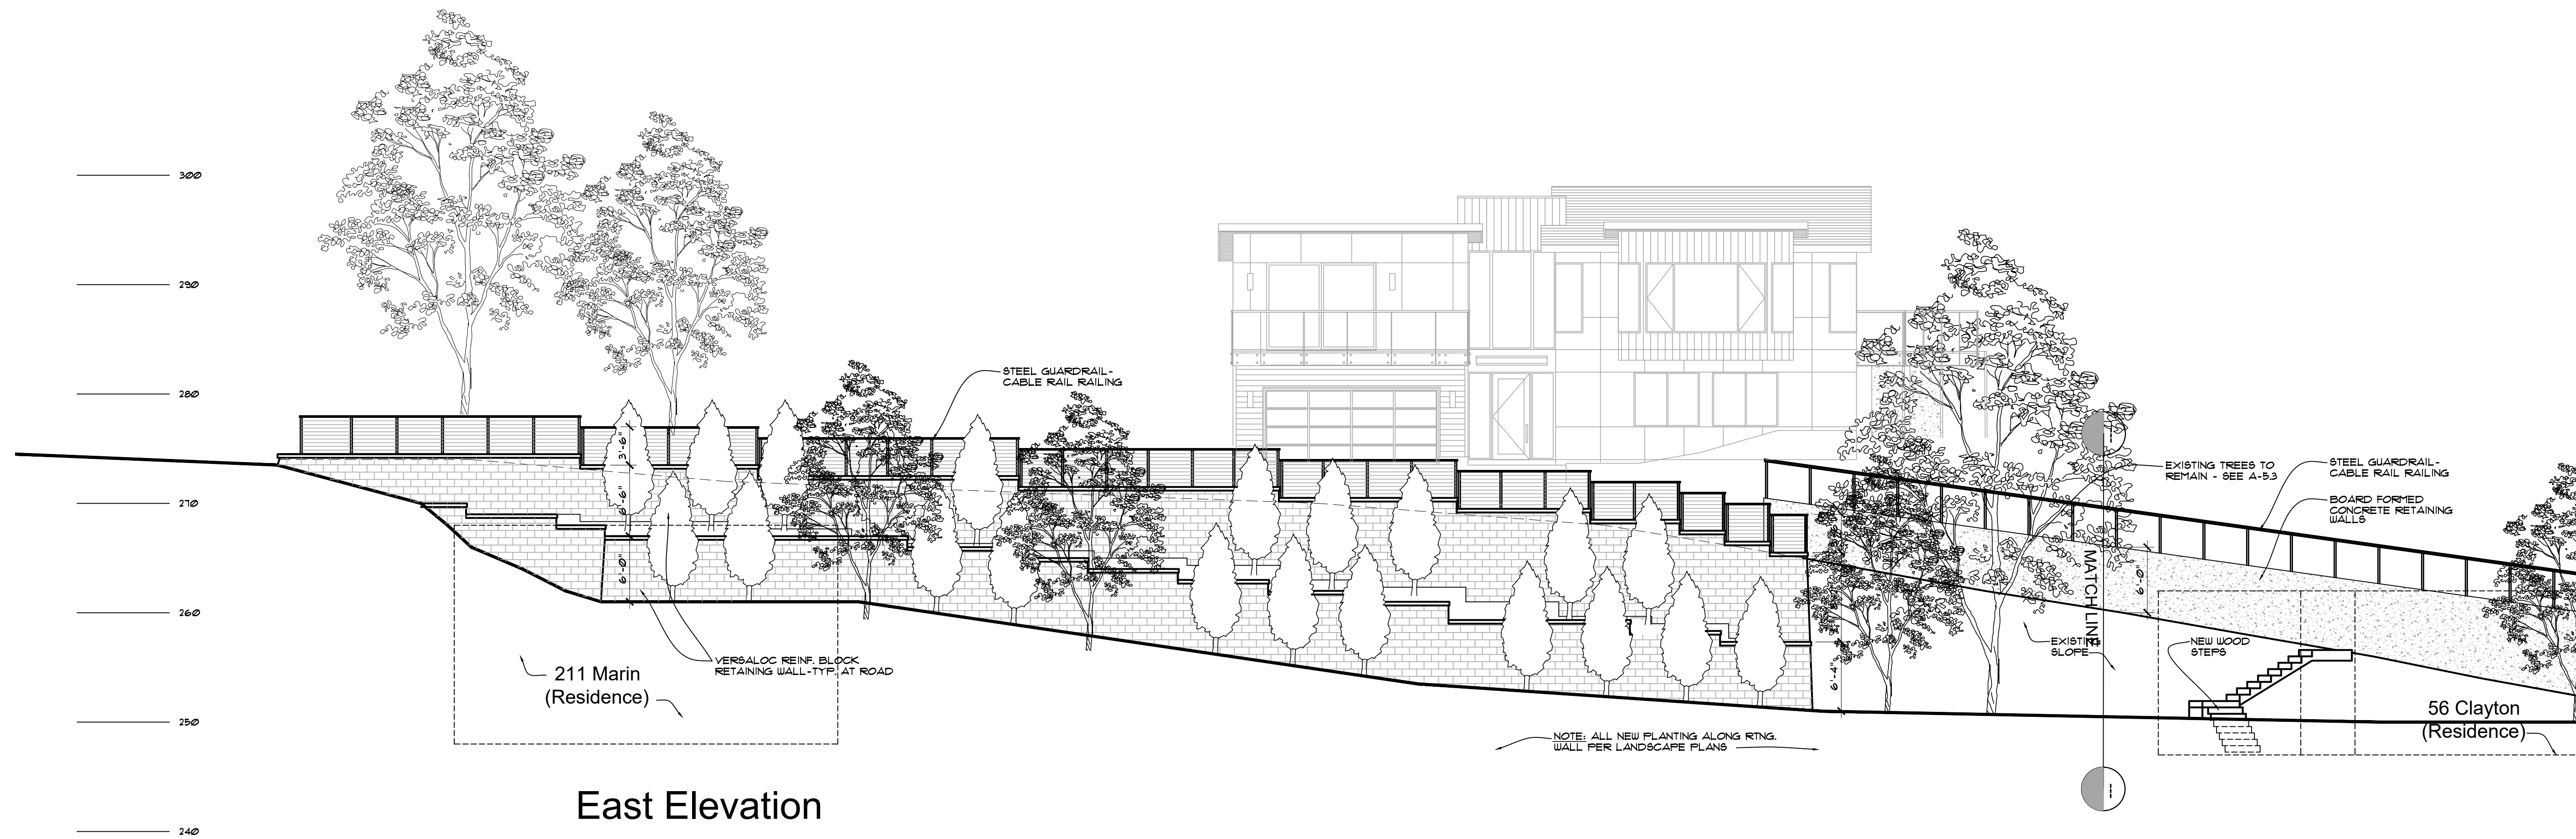


East Elevation

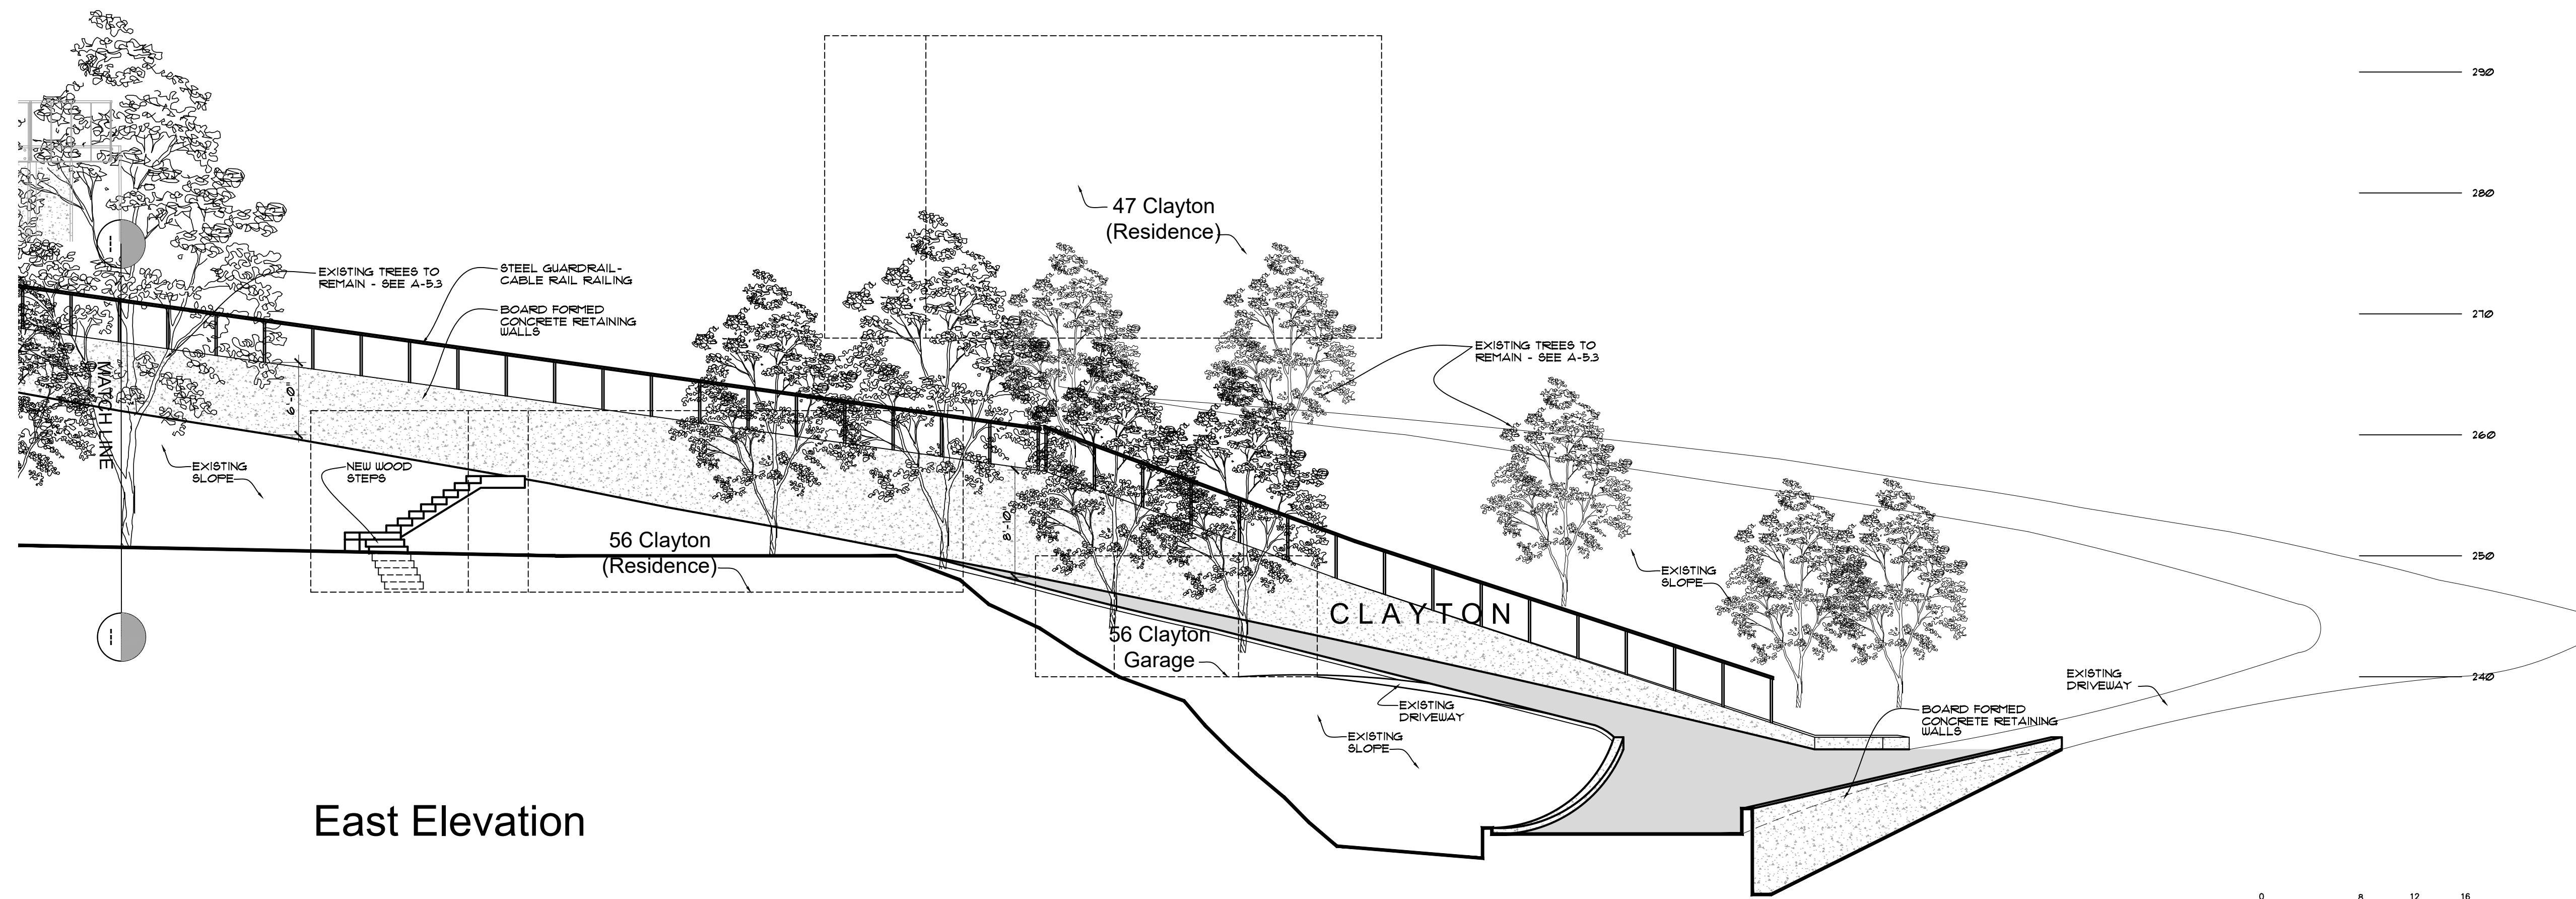

East Elevation


Proposed Clayton Elevations

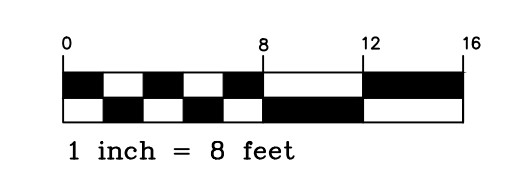

SCALE: 1/8" = 1'-0"

REVISIONS	DATE	BY

Joseph Farrell
ARCHITECTURE
1 Commercial Blvd, Suite 106
Novato, CA 94949
Voice (415) 884-2860

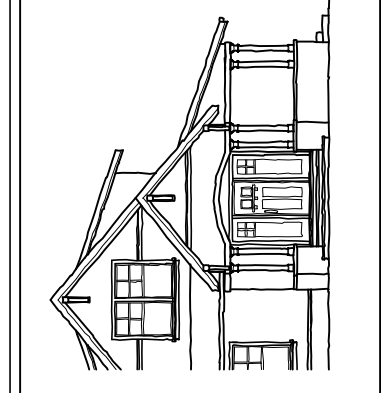

New Residence
Friedman Residence
Lots 59 and 60 - Clayton Street
San Rafael, CA APN 012-141-59 and 60


Proposed
Exterior
Elevations
Clayton

REVIEW THE DRAWINGS CAREFULLY. DO NOT SCALE THE DRAWINGS. ANY DISCREPANCIES OR OMISSIONS ARE CORRECTED BY THE ARCHITECT'S ATTENTION TO THE DRAWINGS. JOSEPH F. FARRELL, ARCHITECT


DATE: 4-15-22
SCALE: 1/8" = 1'-0"
DRAWN: STC
JOB NO. 1909

SHEET NO:
A-2.3
Ross Terrace
San Rafael, CA


Preliminary Not for Construction

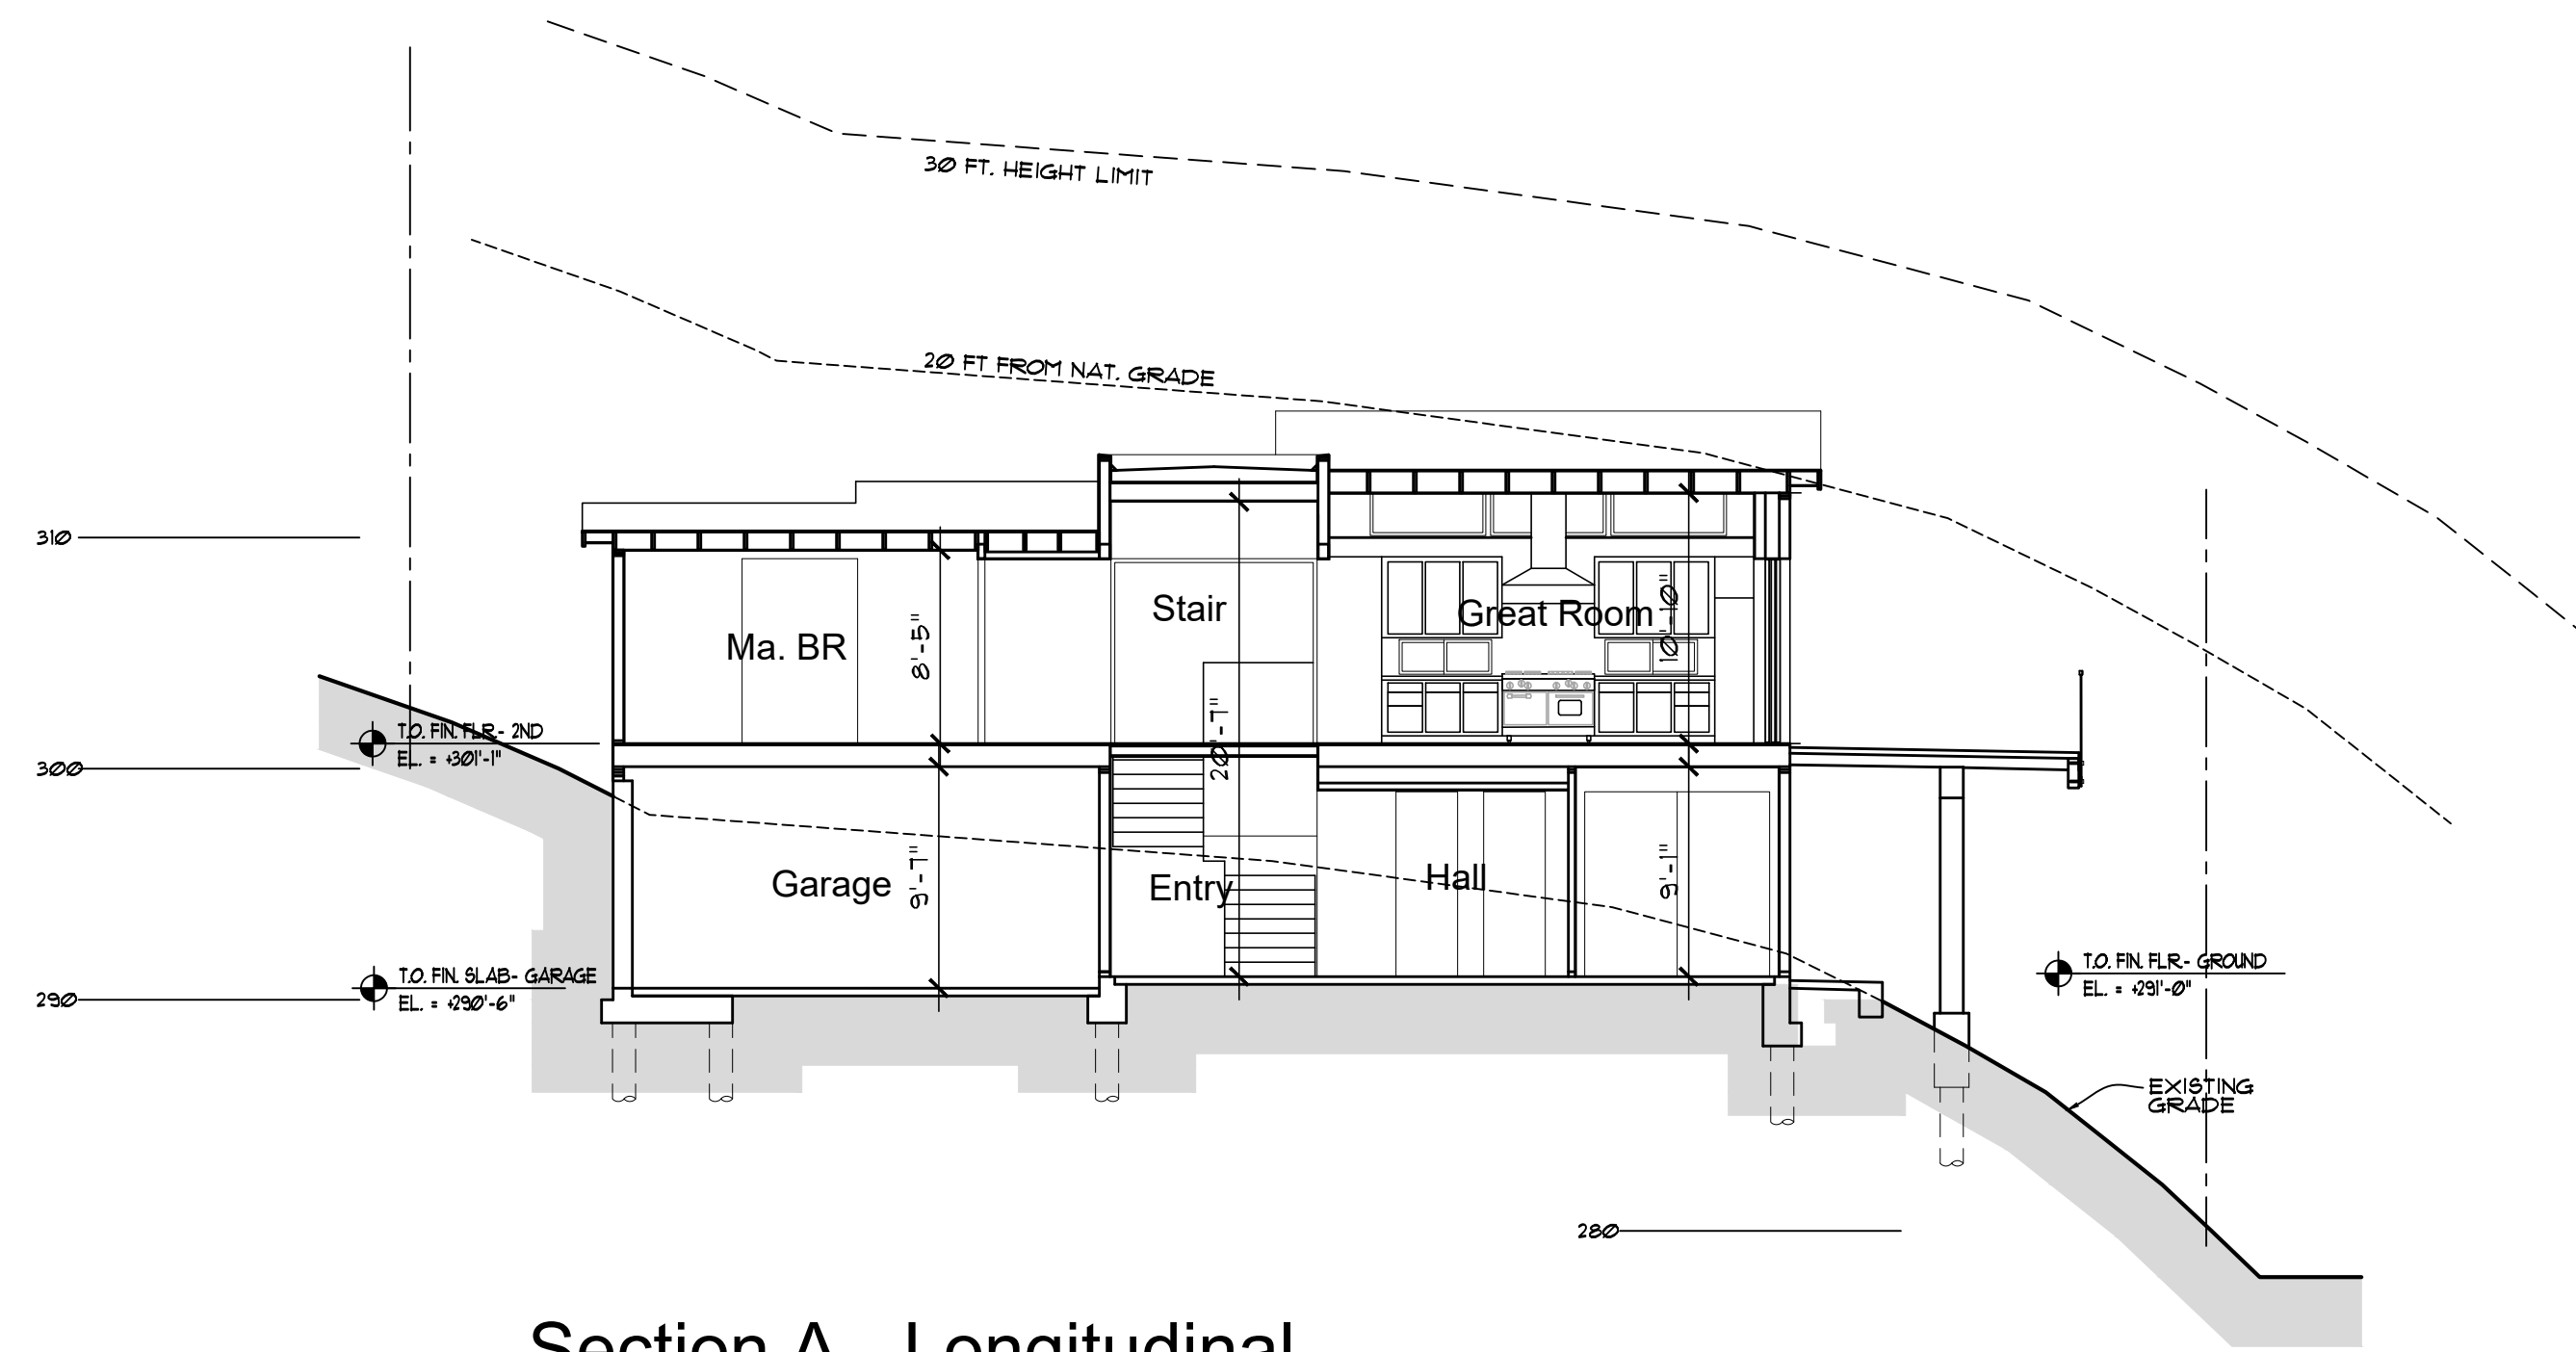

Section A - Longitudinal

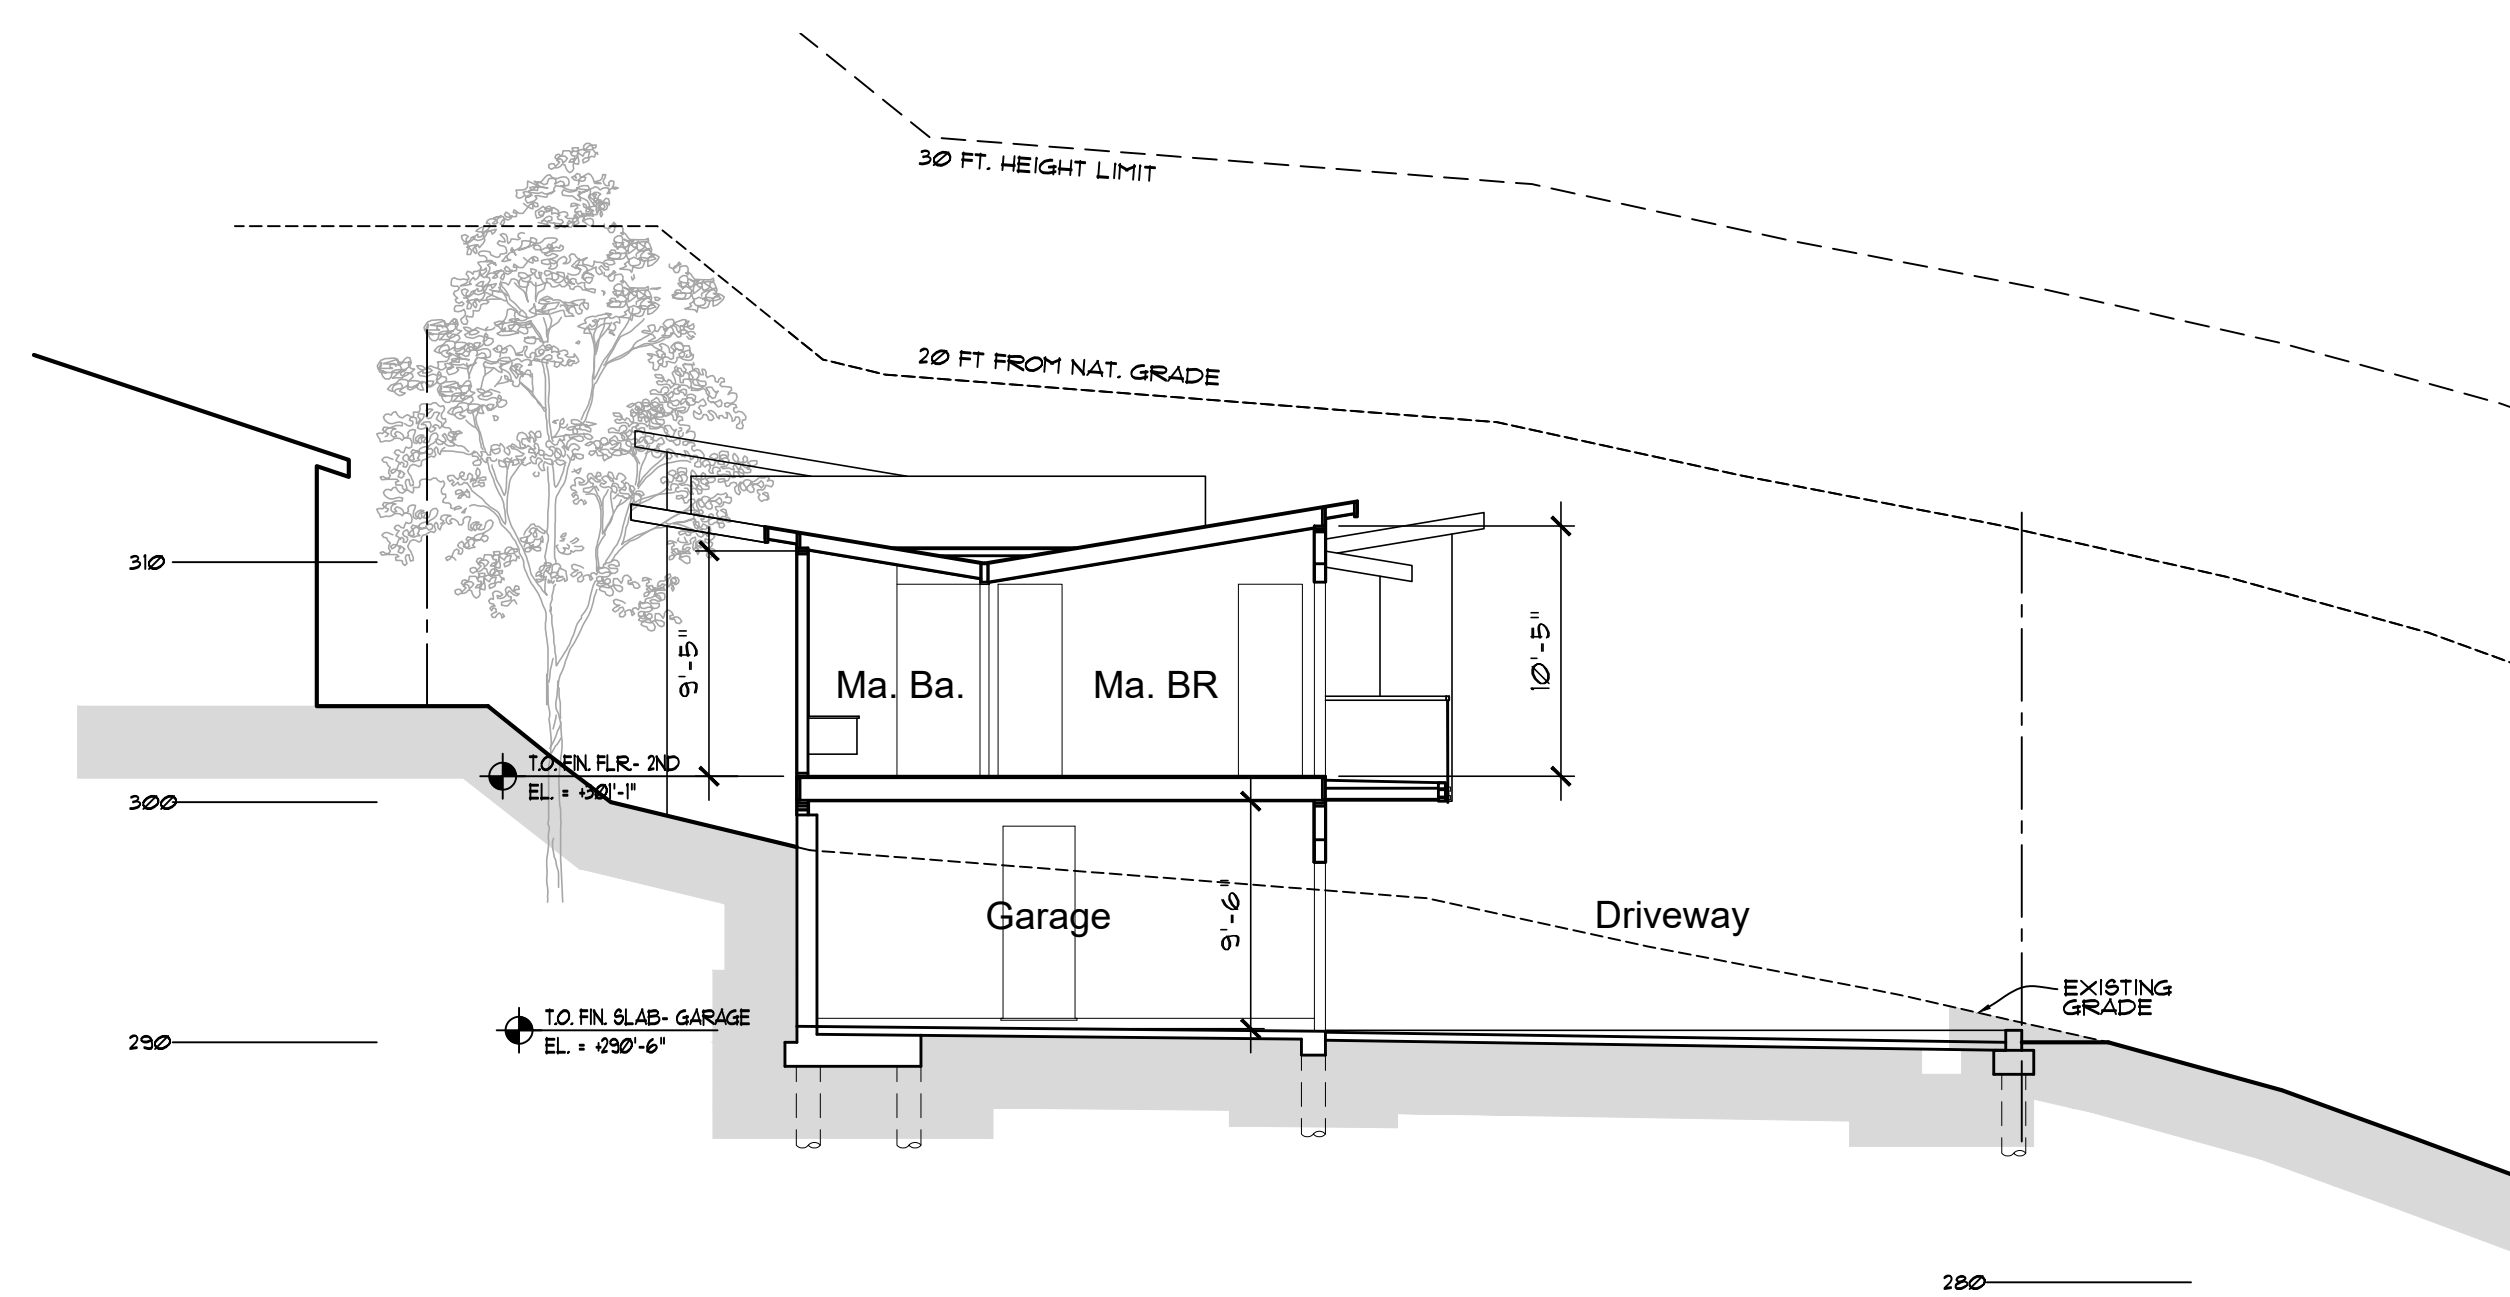


Section B - Cross Section

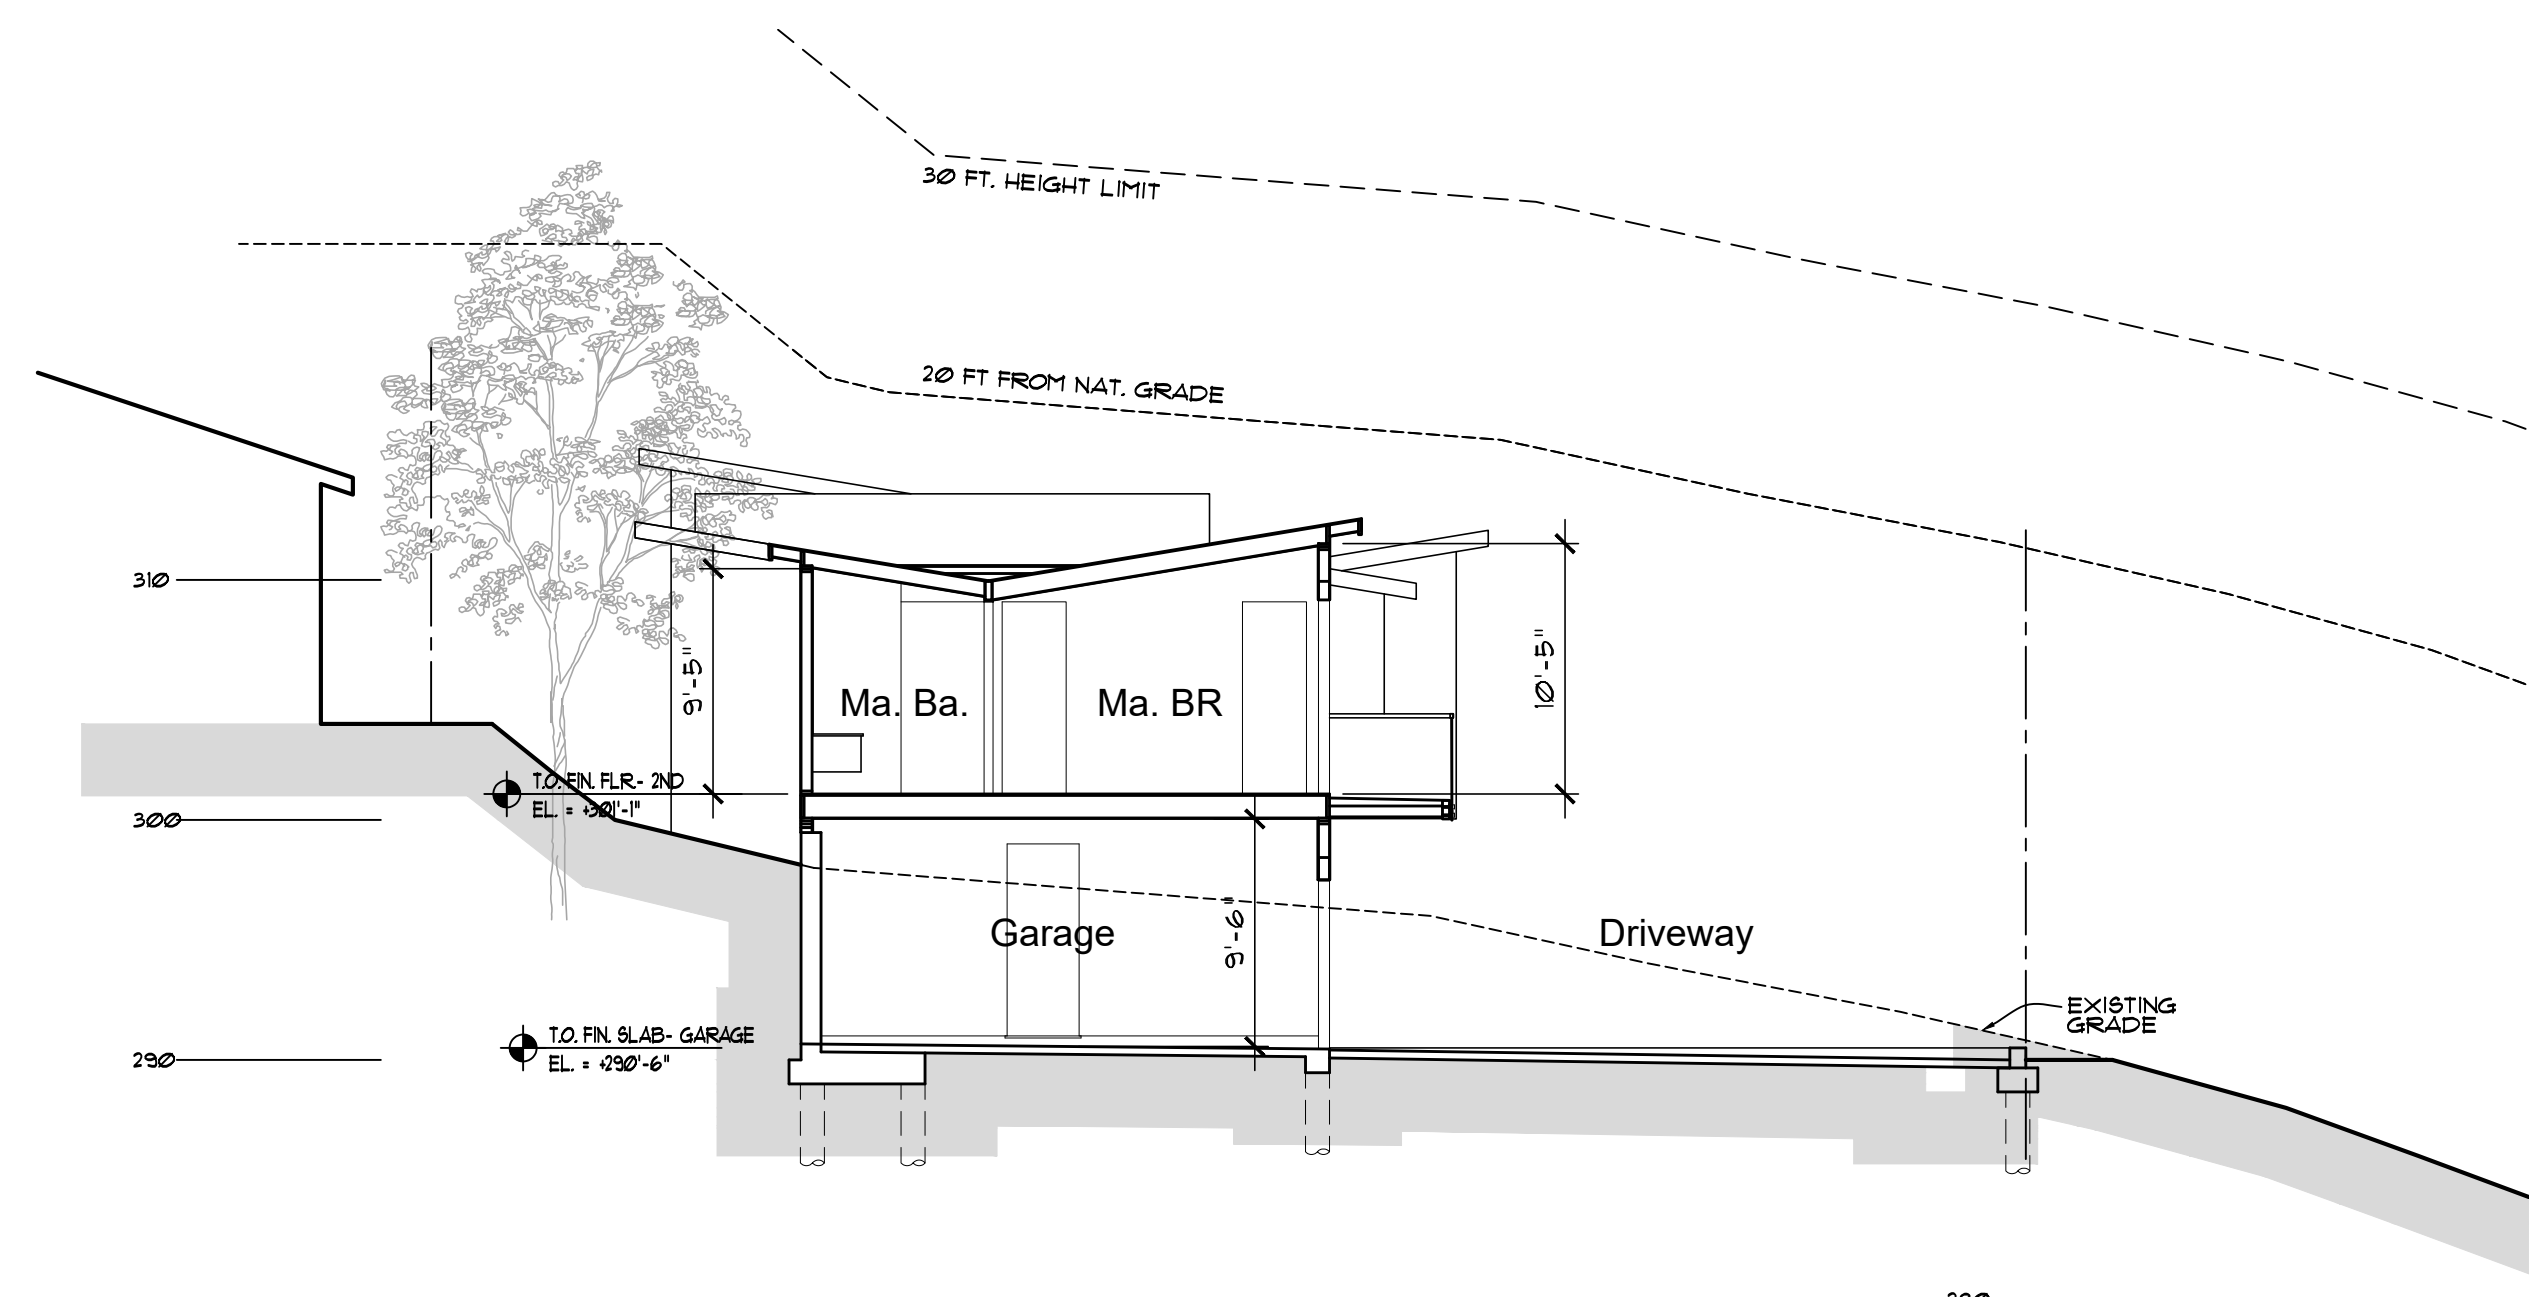

Section C - Cross Section

Proposed Sections- Lot 59

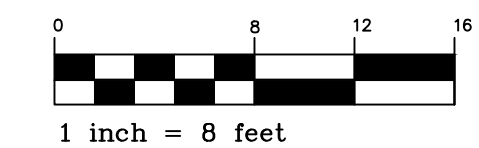


SCALE: 1/8"=1'-0"

© ALL DIMENSIONS AND WRITTEN MATERIAL, INCLUDING
WHEN CONFLICTS THE DRAWING AND DIMENSIONS
SHALL BE GOVERNED BY THE WRITTEN MATERIAL.
NO PART OF THIS DOCUMENT SHALL BE REPRODUCED
OR TRANSMITTED IN ANY FORM OR BY ANY MEANS,
ELECTRONIC OR MECHANICAL, INCLUDING PHOTOCOPYING,
RECORDING, OR BY ANY INFORMATION STORAGE AND
RETRIEVAL SYSTEM, WITHOUT THE WRITTEN CONSENT OF
JOSEPH F. FARRELL, ARCHITECT.

REVISIONS	DATE	BY

Joseph Farrell
ARCHITECTURE
1 Commercial Blvd, Suite 106
Novato, CA 94949
Voice (415) 884-2860

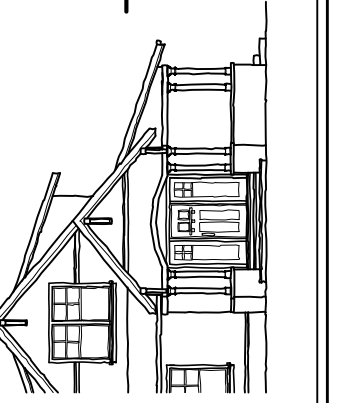

New Residence
Friedman Residence
Lots 59 and 60 - Clayton Street
San Rafael, CA APN 012-141-59 and 60


Proposed
Building
Sections
Lot 59

REVIEW THE DRAWINGS CAREFULLY.
DO NOT SCALE THE DRAWINGS. ANY DISCREP-
ANCIES OR UNRESOLVED AREAS SHALL BE
BROUGHT TO THE IMMEDIATE ATTENTION OF
JOSEPH F. FARRELL, ARCHITECT.


DATE: 04-15-22
SCALE: 1/8"=1'-0"
DRAWN: STC
JOB NO. 1909
SHEET NO:

A-3.2
Ross Terrace
San Rafael, CA

Preliminary Not for Construction

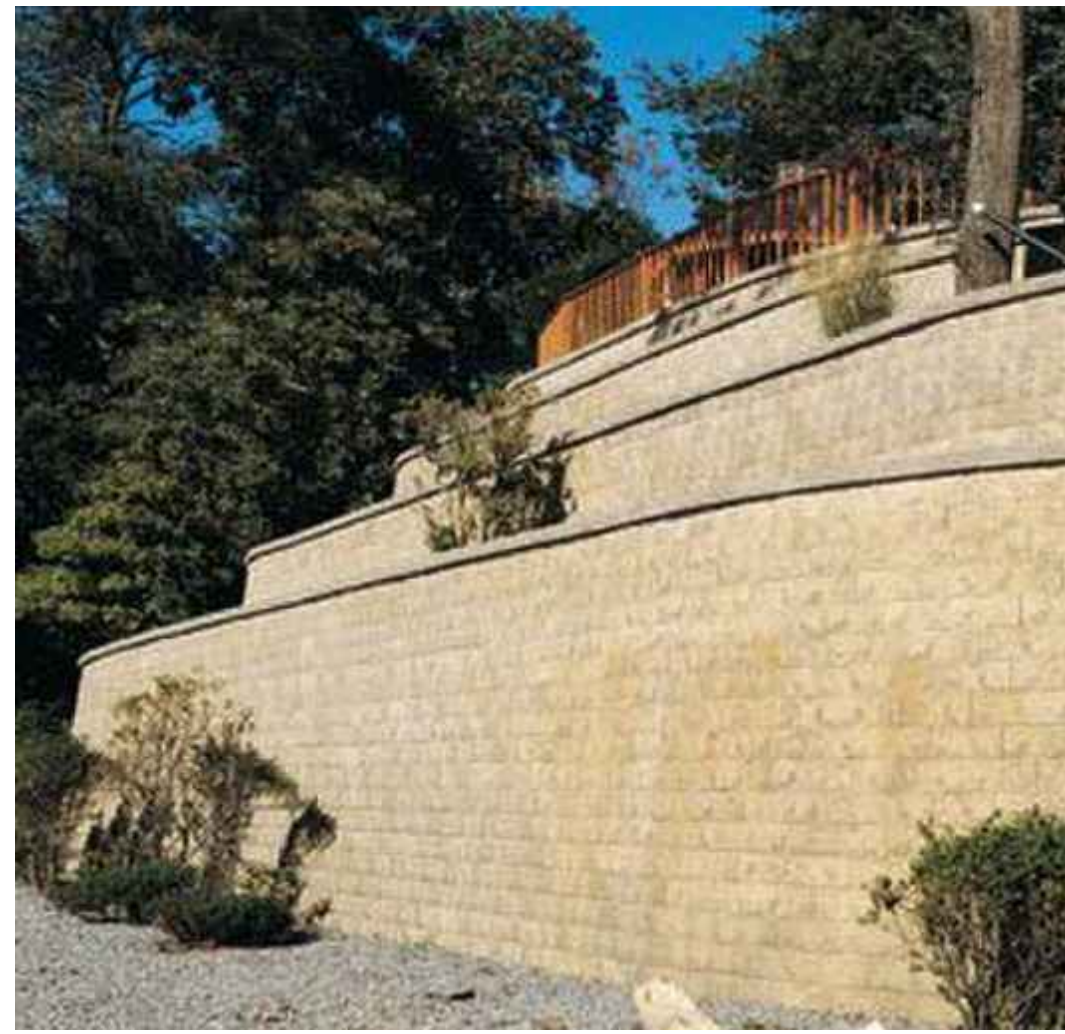


Retaining Wall Image

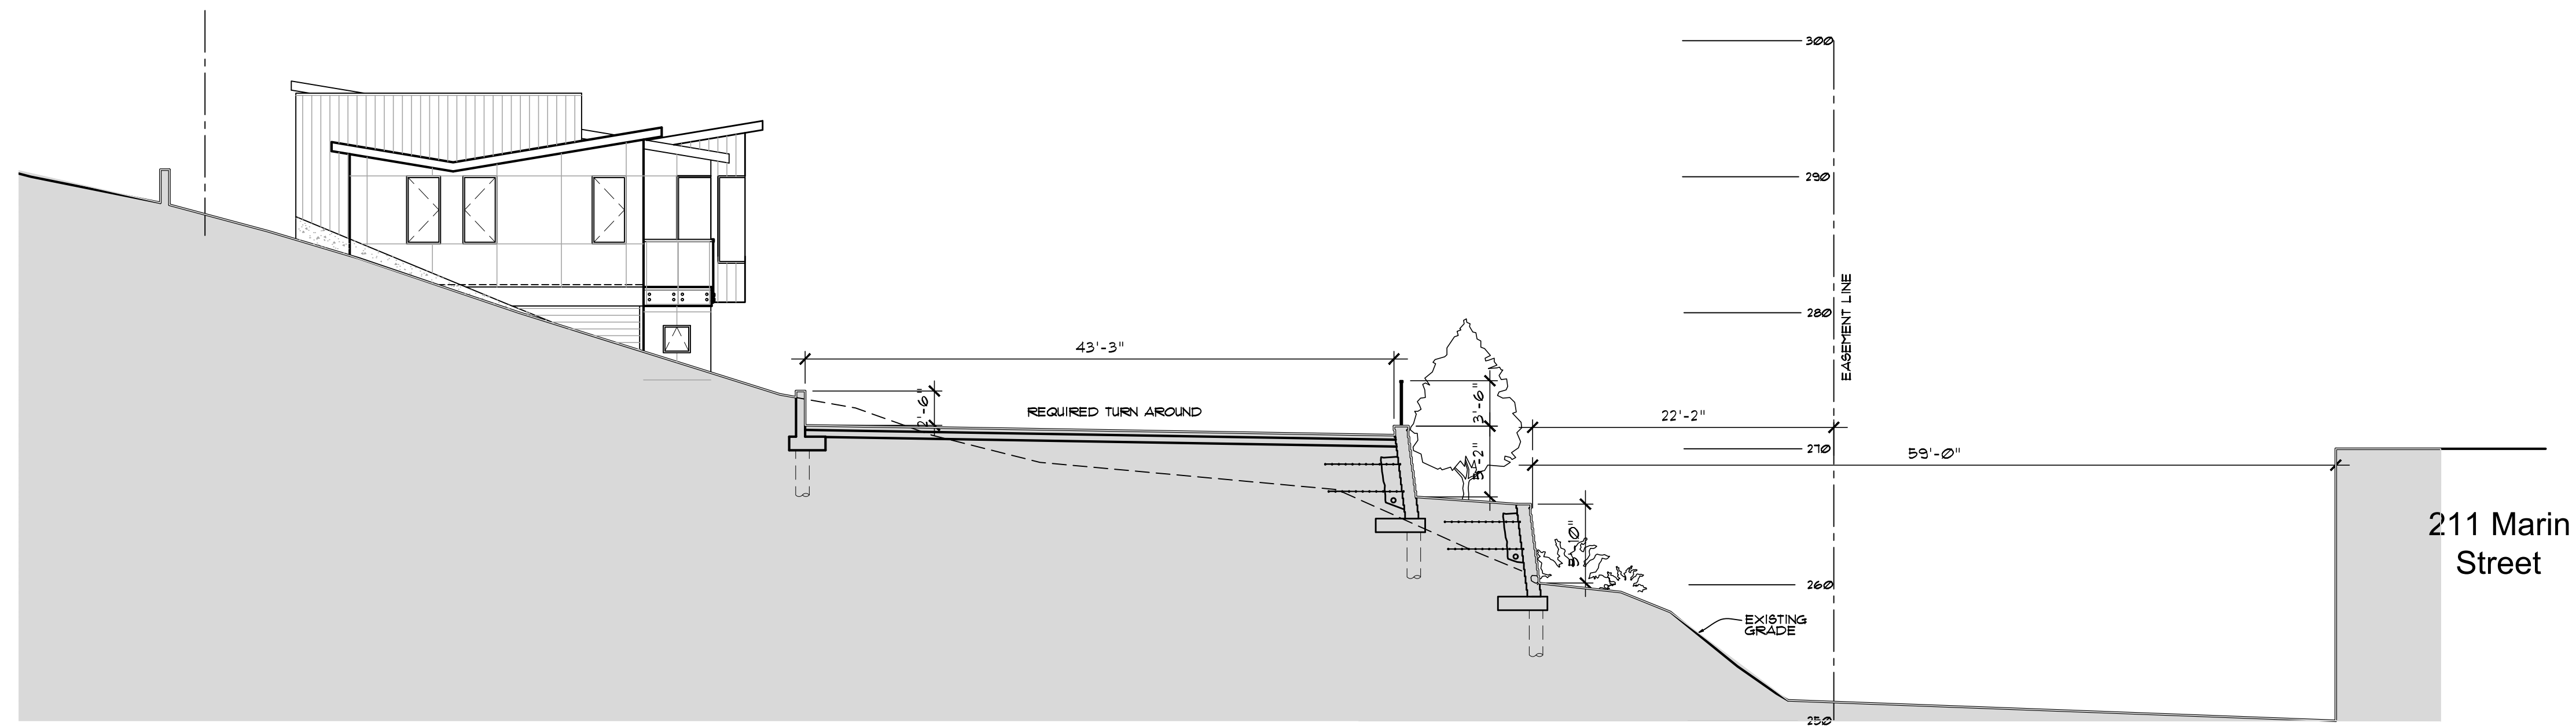


Section 1 - Section at 211 Marin Street- Residence



Versaloc Harmony

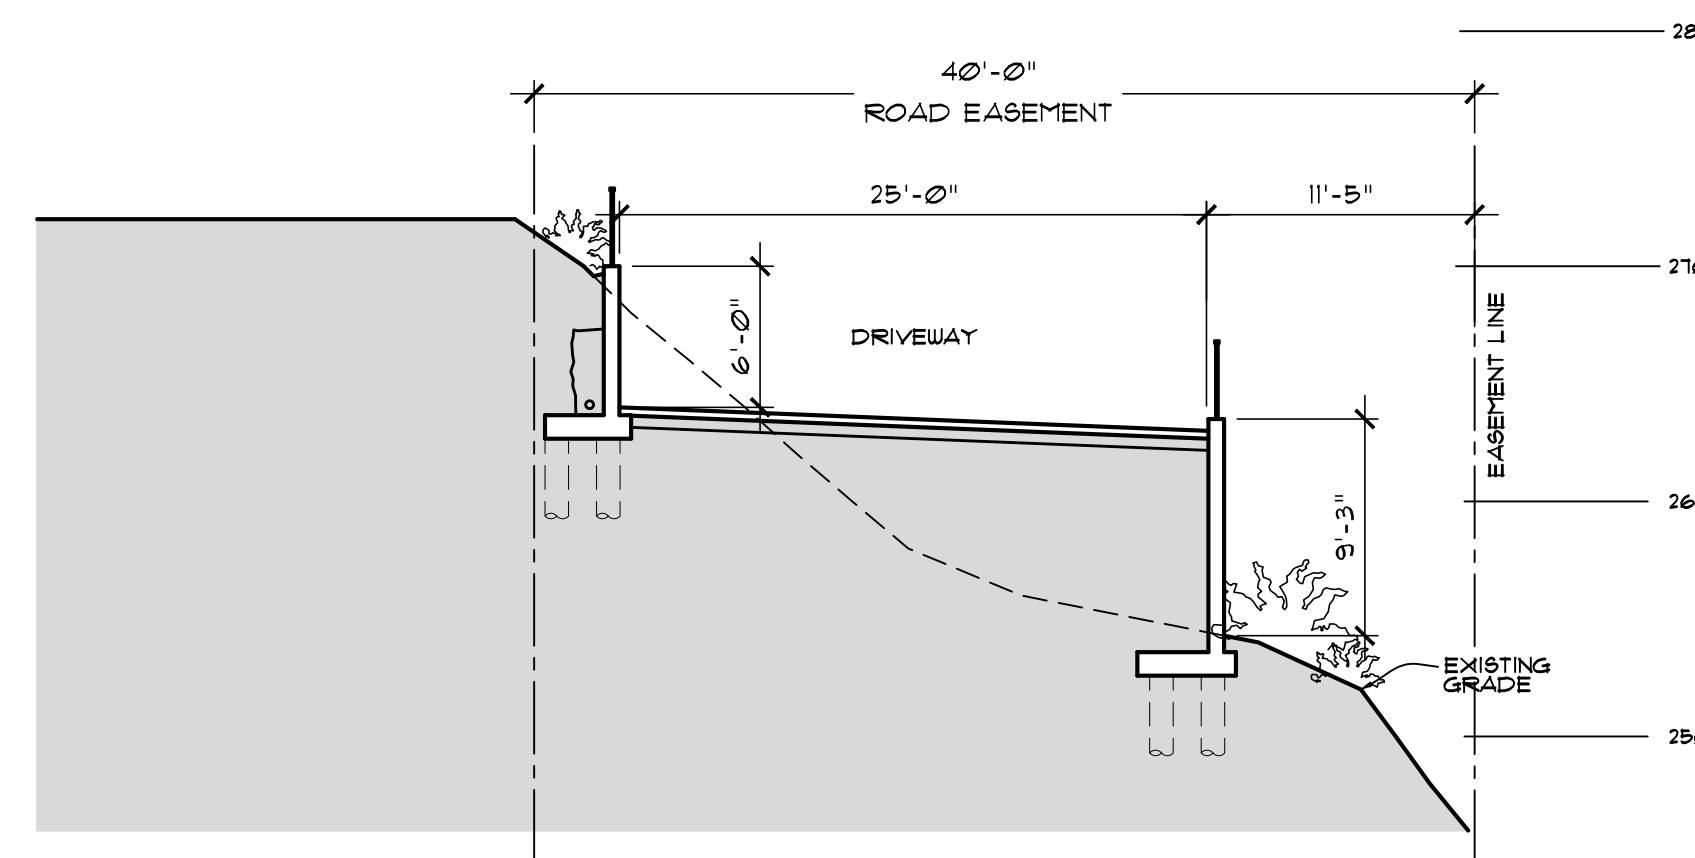


Section 2 - Section at 209 Marin Street - Business

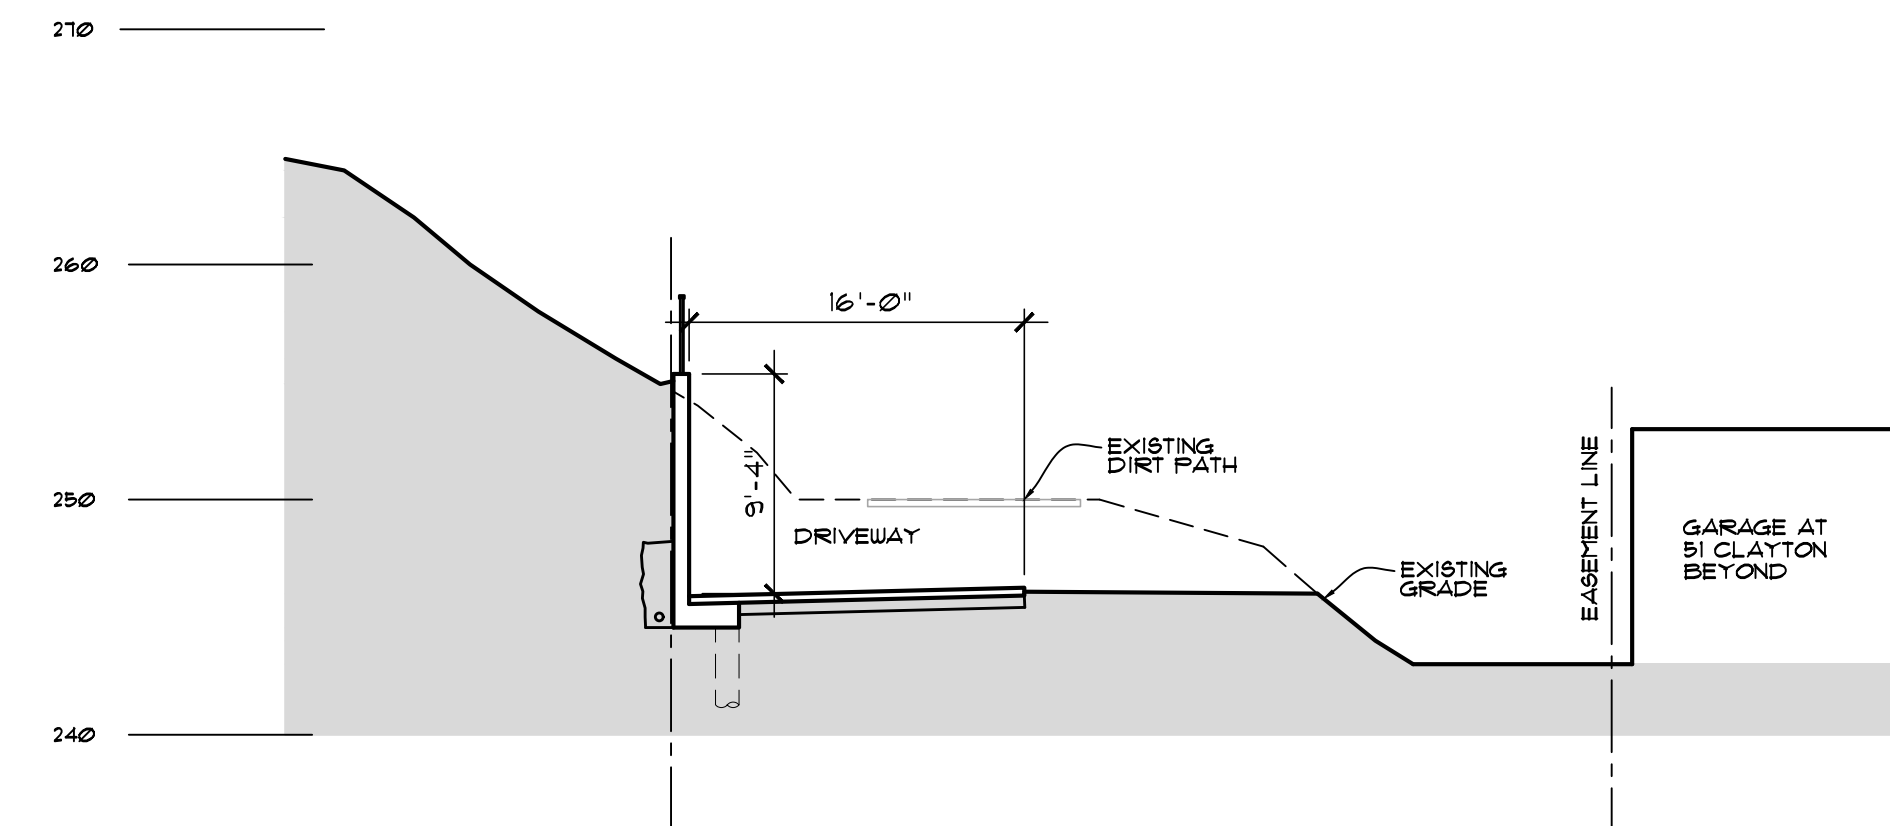

Section 3 - Section at 51 Clayton




Poured concrete walls

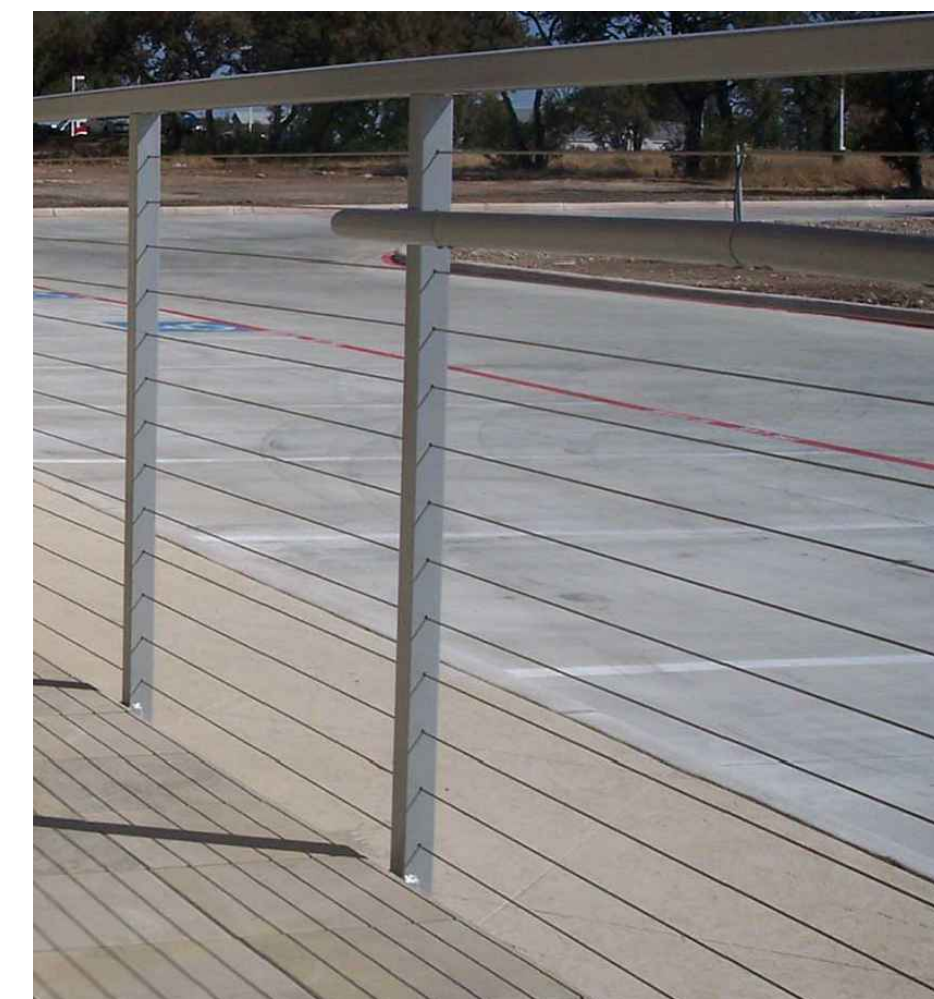


Wall Railing - Cable Rail

Proposed Sections- Clayton Street Extension

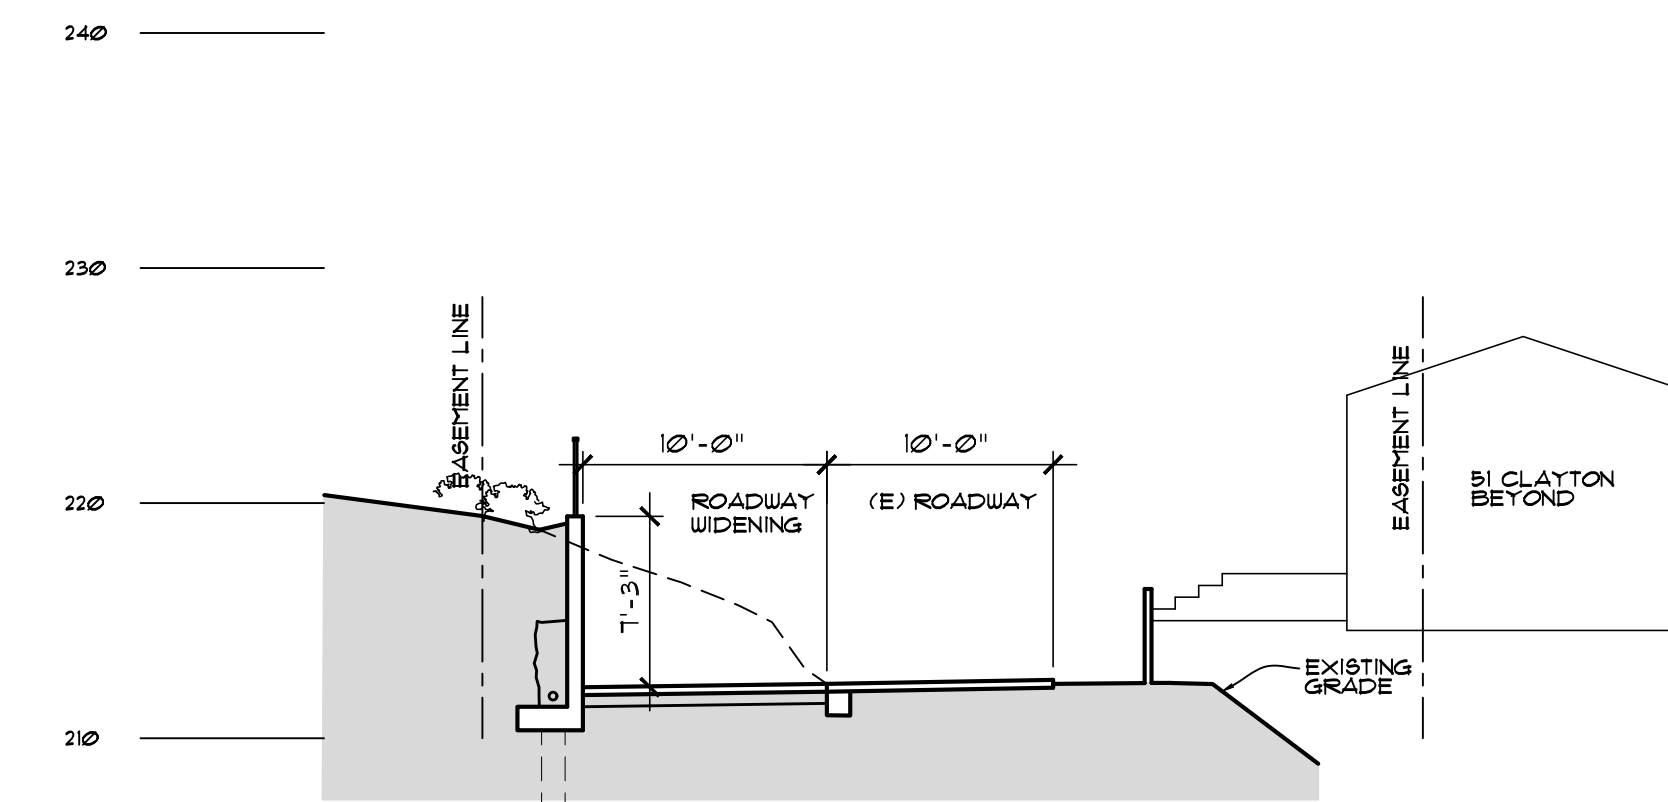

Section 4 - Clayton Street widening

SCALE: 1/8"=1'-0"

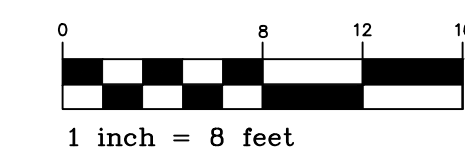


1 inch = 8 feet

Preliminary Not for Construction

© ALL DRAWINGS AND WRITTEN MATERIAL, INCLUDING THESE, ARE THE PROPERTY OF JOSEPH P. FARRELL ARCHITECTURE AND SHALL NOT BE REPRODUCED, COPIED, OR DISSEMINATED WITHOUT THE WRITTEN CONSENT OF JOSEPH P. FARRELL ARCHITECT.

REVISIONS	DATE	BY

Joseph Farrell
ARCHITECTURE
1 Commercial Blvd. Suite 106
Novato, CA 94949
Voice (415) 884-2860

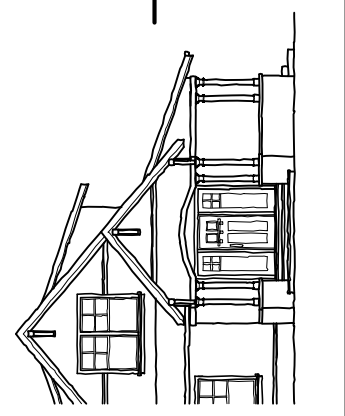

New Residence
Friedman Residence
Lots 59 and 60 - Clayton Street
San Rafael, CA APN 012-141-59 and 60

Proposed
Road Sections
Ross Street
Terrace

REVIEW THE DRAWINGS CAREFULLY. DO NOT SCALE THE DRAWINGS. ANY DISCREPANCIES IN DIMENSIONS AND DETAILS SHALL BE BROUGHT TO THE IMMEDIATE ATTENTION OF JOSEPH P. FARRELL ARCHITECT.

DATE: 4-15-22
SCALE: 1/8"=1'-0"
DRAWN: STC
JOB NO. 1909
SHEET NO:

A-3.3
Ross Terrace
San Rafael, CA

Proposed Exterior Light Fixtures:



□ Wall Sconce:



○ Porch Pendant:



● Path



IP65 : Suitable for Wet Locations
IK07 : Impact Resistant (Vandal Resistant)



LUMINAIRE SPECIFICATION

UEC-40261 Eco recessed location light

A range of rectangular and square wall recessed luminaires, with a glare free cut-off reflector system. Suitable for pathways and ramps. The spread lens provides a wide beam spread evenly illuminating up to 8 m² / 26ft² of a pathway.
Low copper content die-cast aluminum housing with a high corrosion resistance. Stainless steel screws. Durable silicone rubber gasket and toughened linear spread lens. Double cable entry. Housing is treated with a chemical chromated protection before powder coating, ensuring high corrosion resistance. Integral control gear. Anodized high purity aluminum cut-off reflector. This fixture is suitable for concrete pour applications.

Physical Data
Length: 12.76"
Height: 10.98"
Weight: 12.7 lbs

Lamp
□ CFQ 2x18w

(For More Lamp options including LED, please Consult the Catalogue, Website or Contact The Ligman Lighting Factory)



Voltage (Please Specify)

□ 120V
□ 277V
□ Other

Options
Color (Please Specify)


□ 01-Black - RAL 9011 □ 02-Dark Grey - RAL 7043
□ 03-White - RAL 9003 □ 04-Metallic Silver - RAL 9006
□ 05-Matt Silver - RAL 9006 □ 07-Custom - RAL
□ 06-Bronze - RAL 6014

□ Surface Mounting Box Enclosure

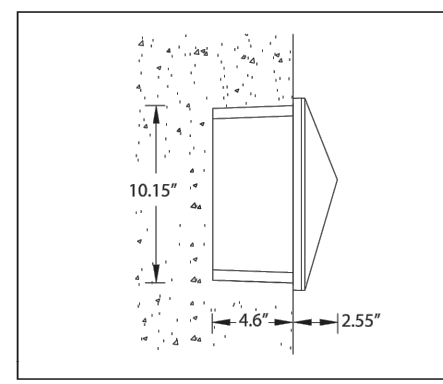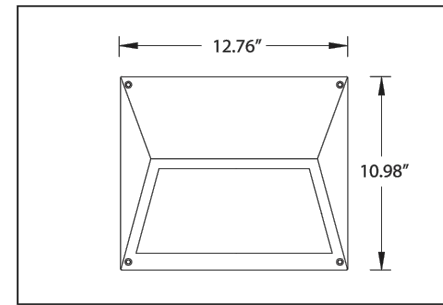

Head Office: Tel: 503-645-0500
7144 NW Progress Ct. Fax: 503-645-8100
Hillsboro, Oregon 97124
www.ligmanlightingusa.com


Photometric Diagram:

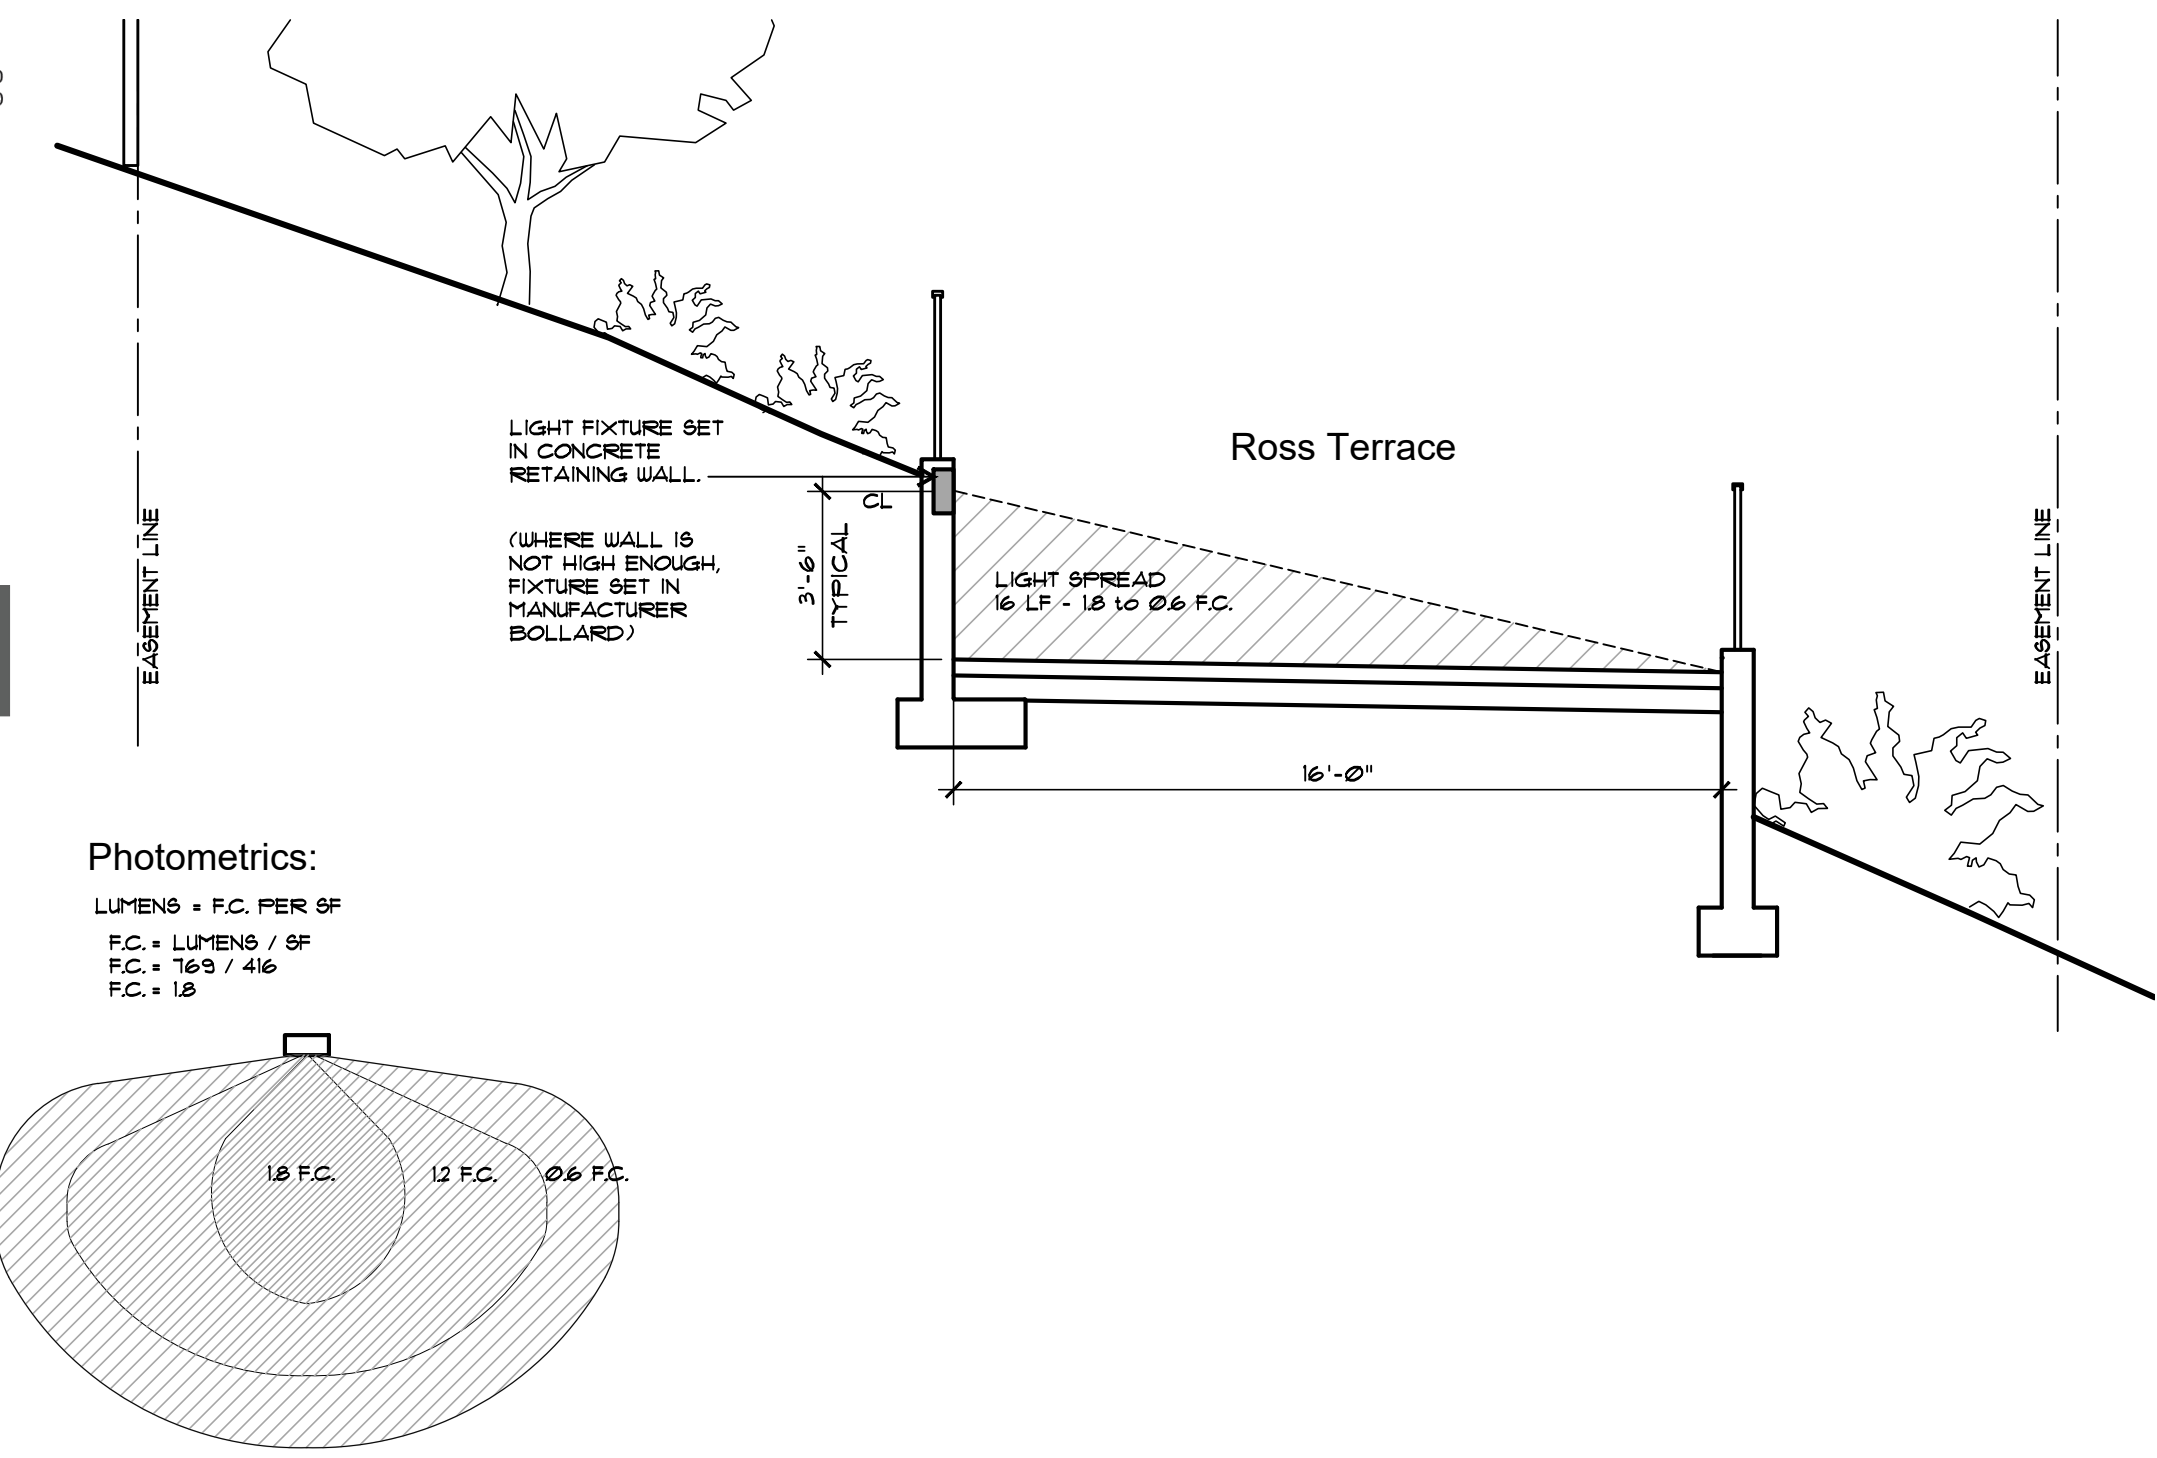

Photometrics:

LUMENS + F.C. PER SF
F.C. = LUMENS / 5F
F.C. = 169 / 416
F.C. = 18

Street Light - Wall and Bollard Mounted:

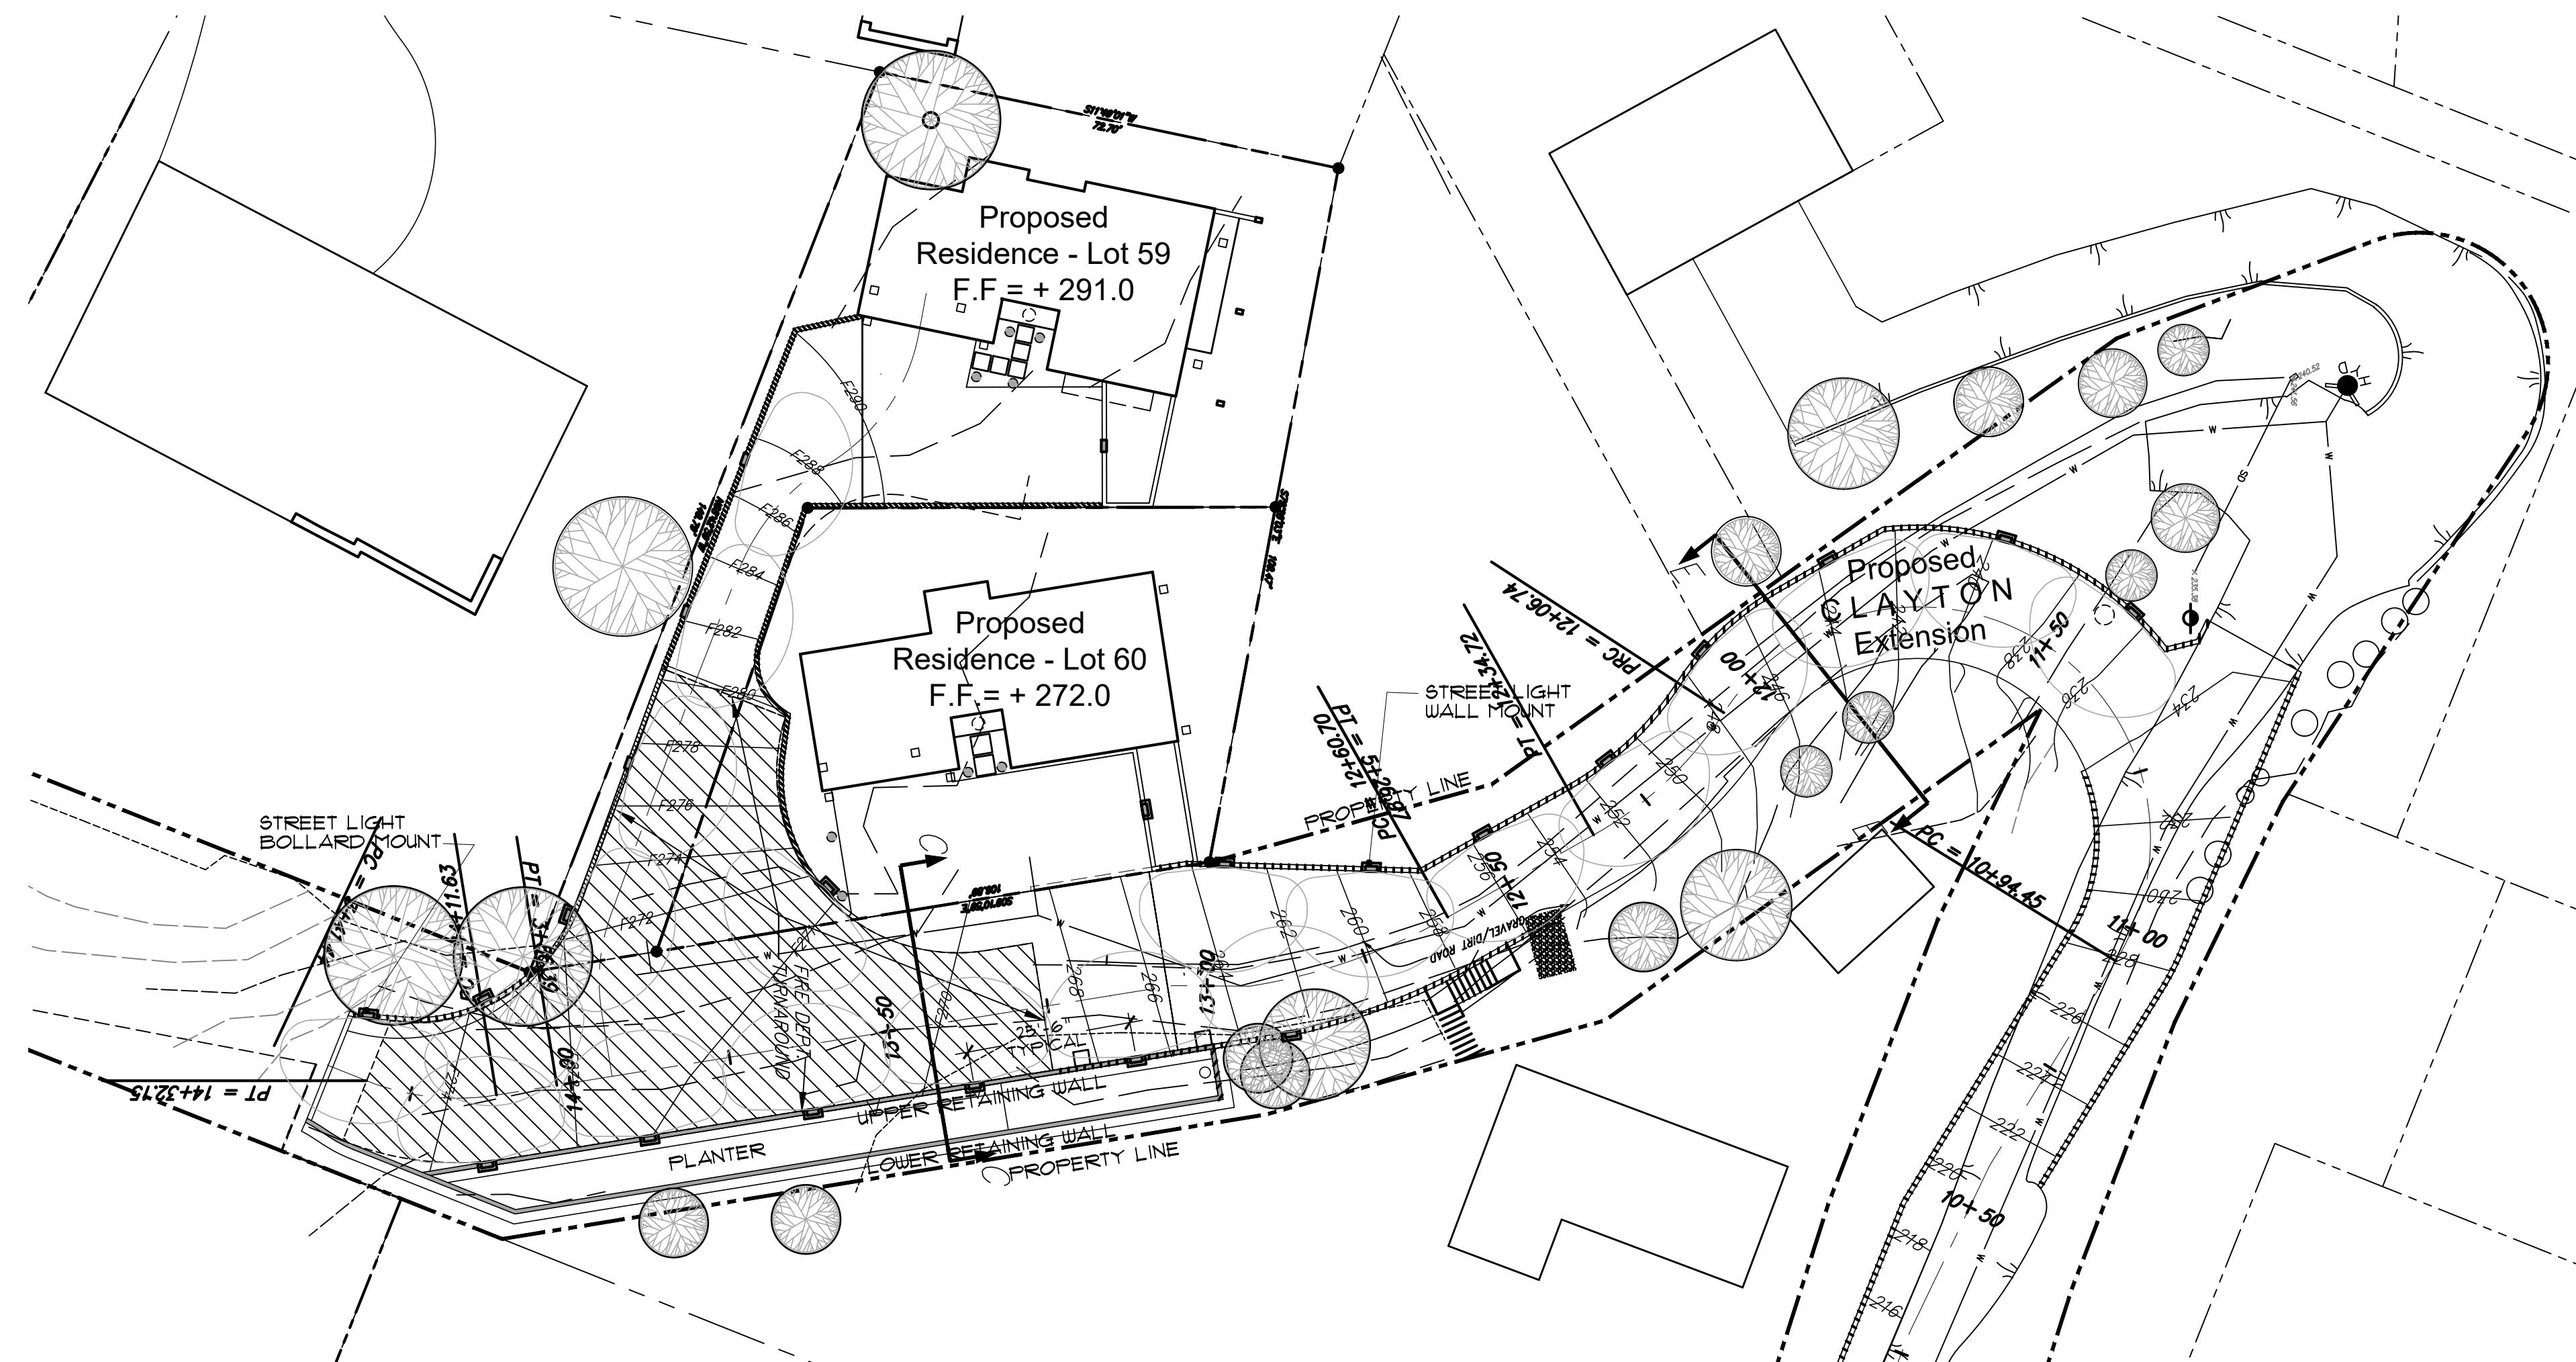

Lighting Plan

Preliminary Not for Construction

REVISIONS	DATE	BY


Joseph Farrell
ARCHITECTURE
1 Commercial Blvd, Suite 106
Novato, CA 94949
Voice (415) 884-2860

New Residence
Friedman Residence
Lots 59 and 60 - Clayton Street
San Rafael, CA APN 012-141-59 and 60

Lighting Plan

DATE: 4-15-22
SCALE: AS NOTED
DRAWN: STC
JOB NO. 1909
SHEET NO:


A-4.2
Ross Terrace
San Rafael, CA

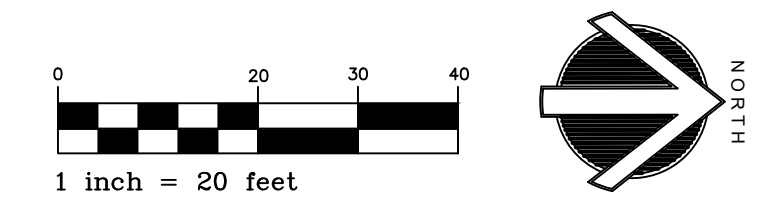

SCALE: 1" = 20'-0"

Story Pole Notes:

1. PROVIDE WOODEN STORY POLES AT EACH CORNER OF THE PROPOSED STRUCTURE. BRACE POLES AS REQUIRED TO EXISTING ADJACENT GRADES.
2. CONNECT TOPS OF POLES WITH CONSTRUCTION BARRIER TAPE OR SIMILAR IN VIBRANT COLOR TO INDICATE PROPOSED ROOF LINES, AND MASSING OF THE STRUCTURES.
3. PROVIDE WRITTEN INFORMATION ON EACH POLE TO INDICATE PROPOSED FINISH GRADES, FINISH FLOOR HEIGHTS, EAVE HEIGHTS AND MAXIMUM ROOF HEIGHTS.
4. AFTER INSTALLATION, STORY POLES SHALL BE PHOTOGRAPHED TO DOCUMENT THE LOCATION OF THE POLES FROM VARIOUS VANTAGE POINTS AROUND THE SITE PER CITY STAFF RECOMMENDATIONS.
5. STORY POLES SHALL BE INSTALLED 10 DAYS PRIOR TO THE SCHEDULED HEARING DATE AS DIRECTED BY CITY STAFF.

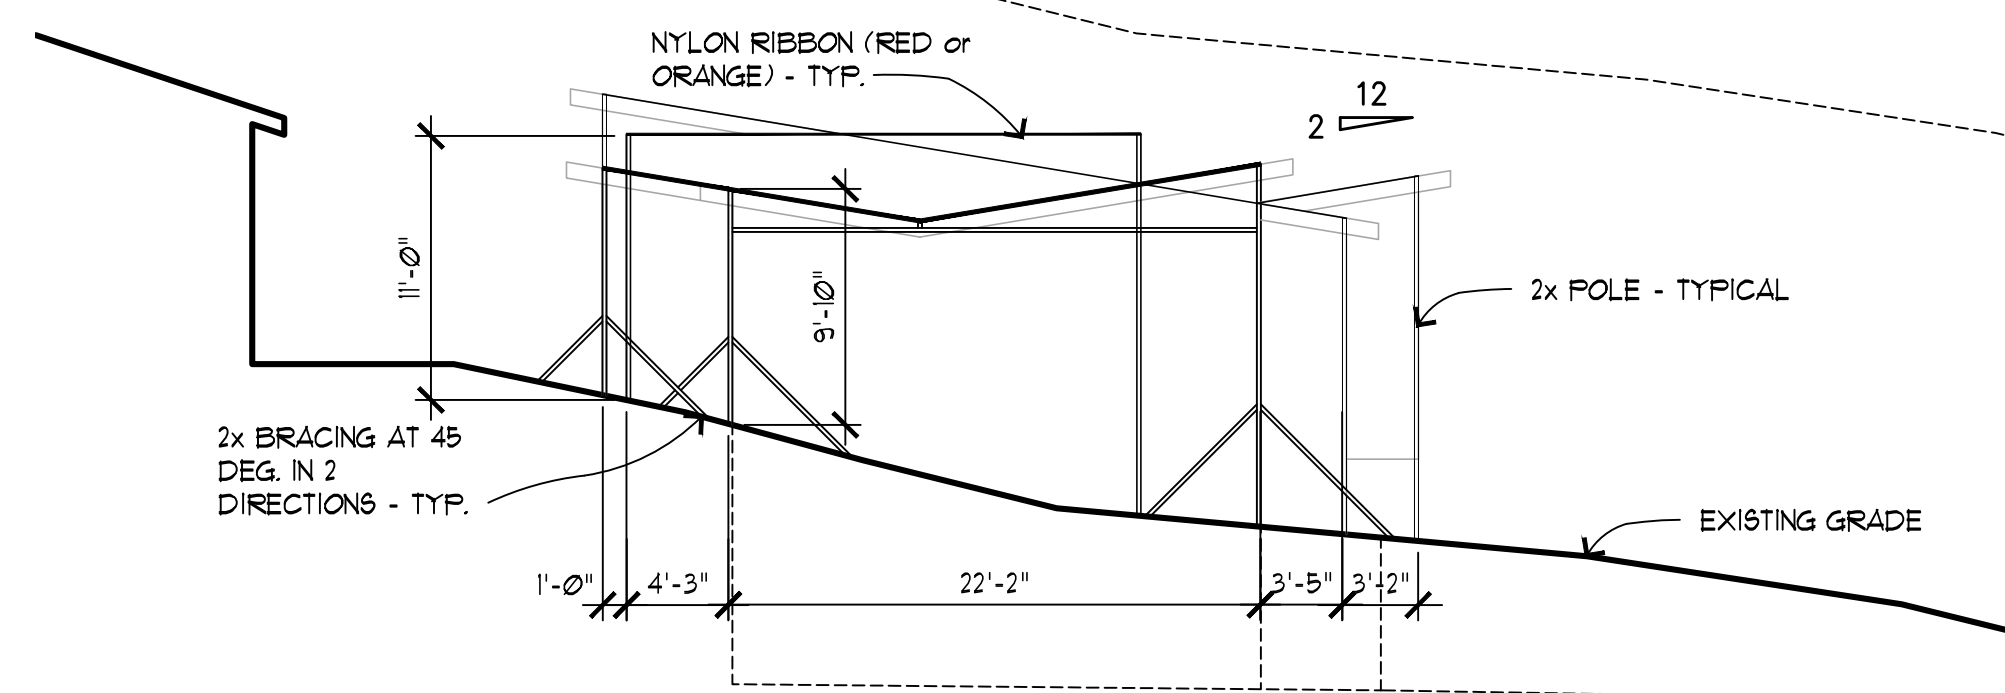


Typical Elevation

SCALE: 1/8" = 1'-0"

Story Pole Plans


* Story Pole Location

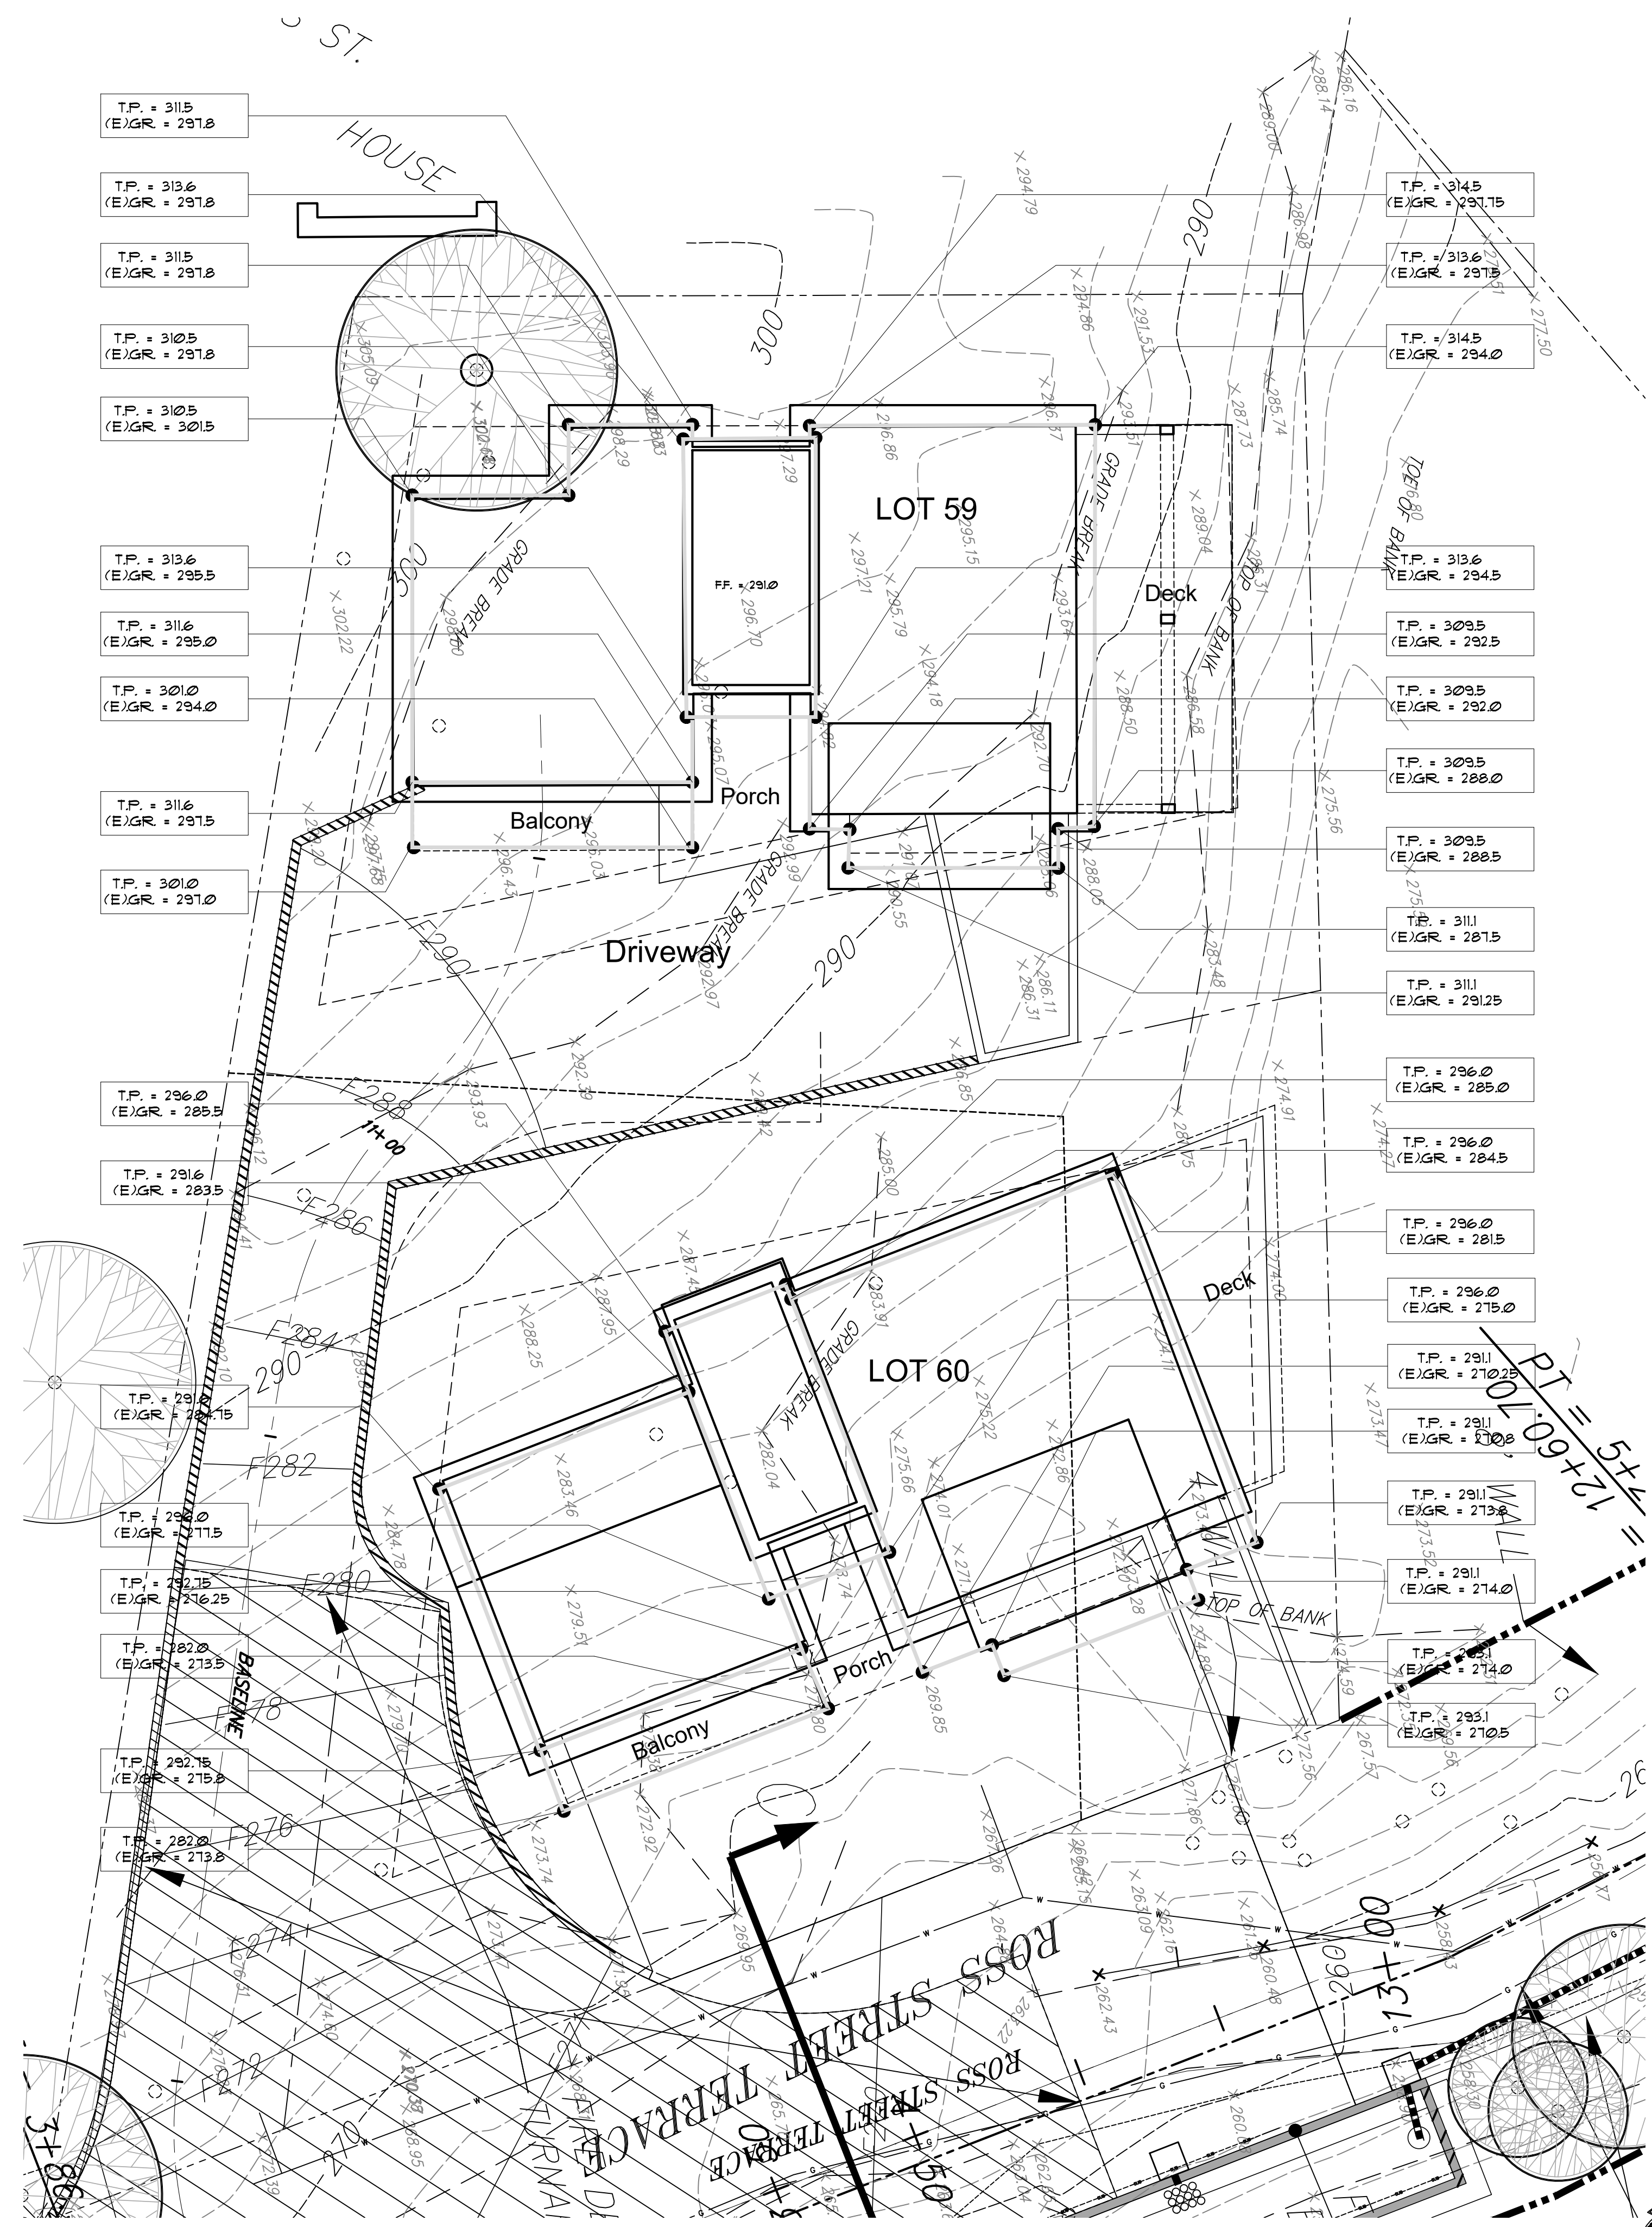

SCALE: 1/8" = 1'-0"

REVISIONS	DATE	BY

Joseph Farrell
ARCHITECTURE
1 Commercial Blvd, Suite 106
Novato, CA 94949
Voice (415) 884-2860

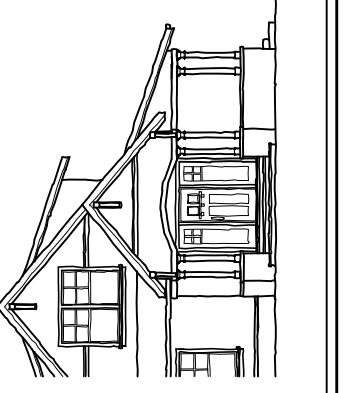

New Residence
Friedman Residence
Lots 59 and 60 - Clayton Street
San Rafael, CA APN 012-141-59 and 60

Proposed
Story Pole
Plans and
Elevation

DATE: 4-15-22
SCALE: 1/8" = 1'-0"
DRAWN: STC
JOB NO. 1909
SHEET NO:

A-5.1
Ross Terrace
San Rafael, CA

Preliminary Not for Construction

Proposed Colors and Materials

Friedman Residences

Colors

Paint - Benjamin Moore or equal



Revere Pewter

Panel Siding



Nightfall


Roof Trim- Gutters and Downspouts



Gentleman's Gray

Horizontal Siding

Railings

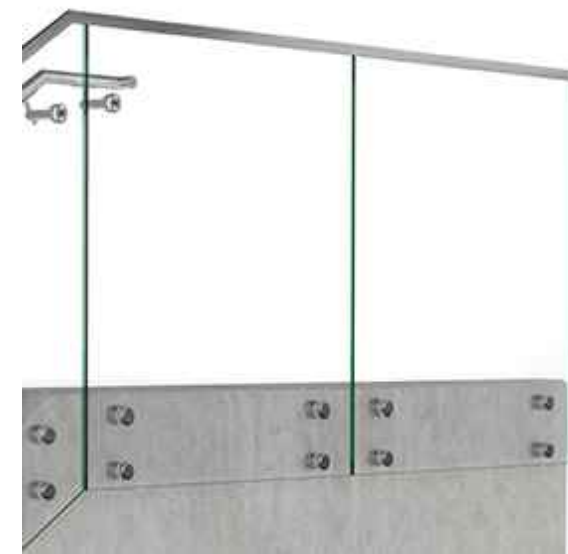

Glass railings with S.S. Caps
VIVA Railings, LLC or equal
Powder Coated Steel Channels

Retaining Walls & Supports



Board Formed Concrete

Roofing



Roof soffits:
T&G Wood - Cedar
Clear stain



Composite Shingle Roofing:
Certaineed Landmark Pro Solaris
Max Def Moire Black

Siding



Vertical Siding:
T&G Wood- Cedar
Clear stain



Panel Siding System:
Hardie Panel- Aspire with S.S. Reveal


Deck Surfaces



Ipe Wood Decking
Clear finish

Doors and Windows:


Patio/Entry Doors:
Black Metal w/ Dividers

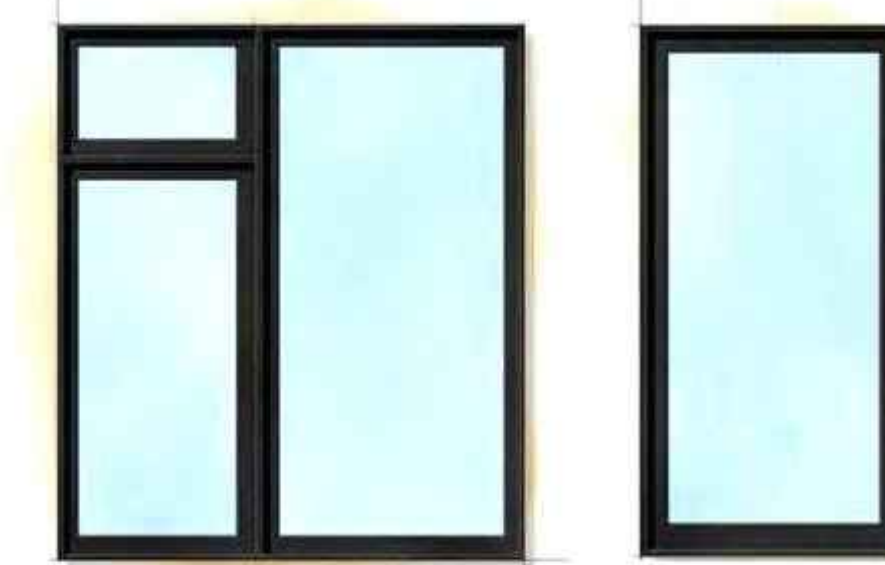


Windows:
Modern profile - Metal or Metal Clad Wood
Black Frames - no grids



Upper Front Elevation

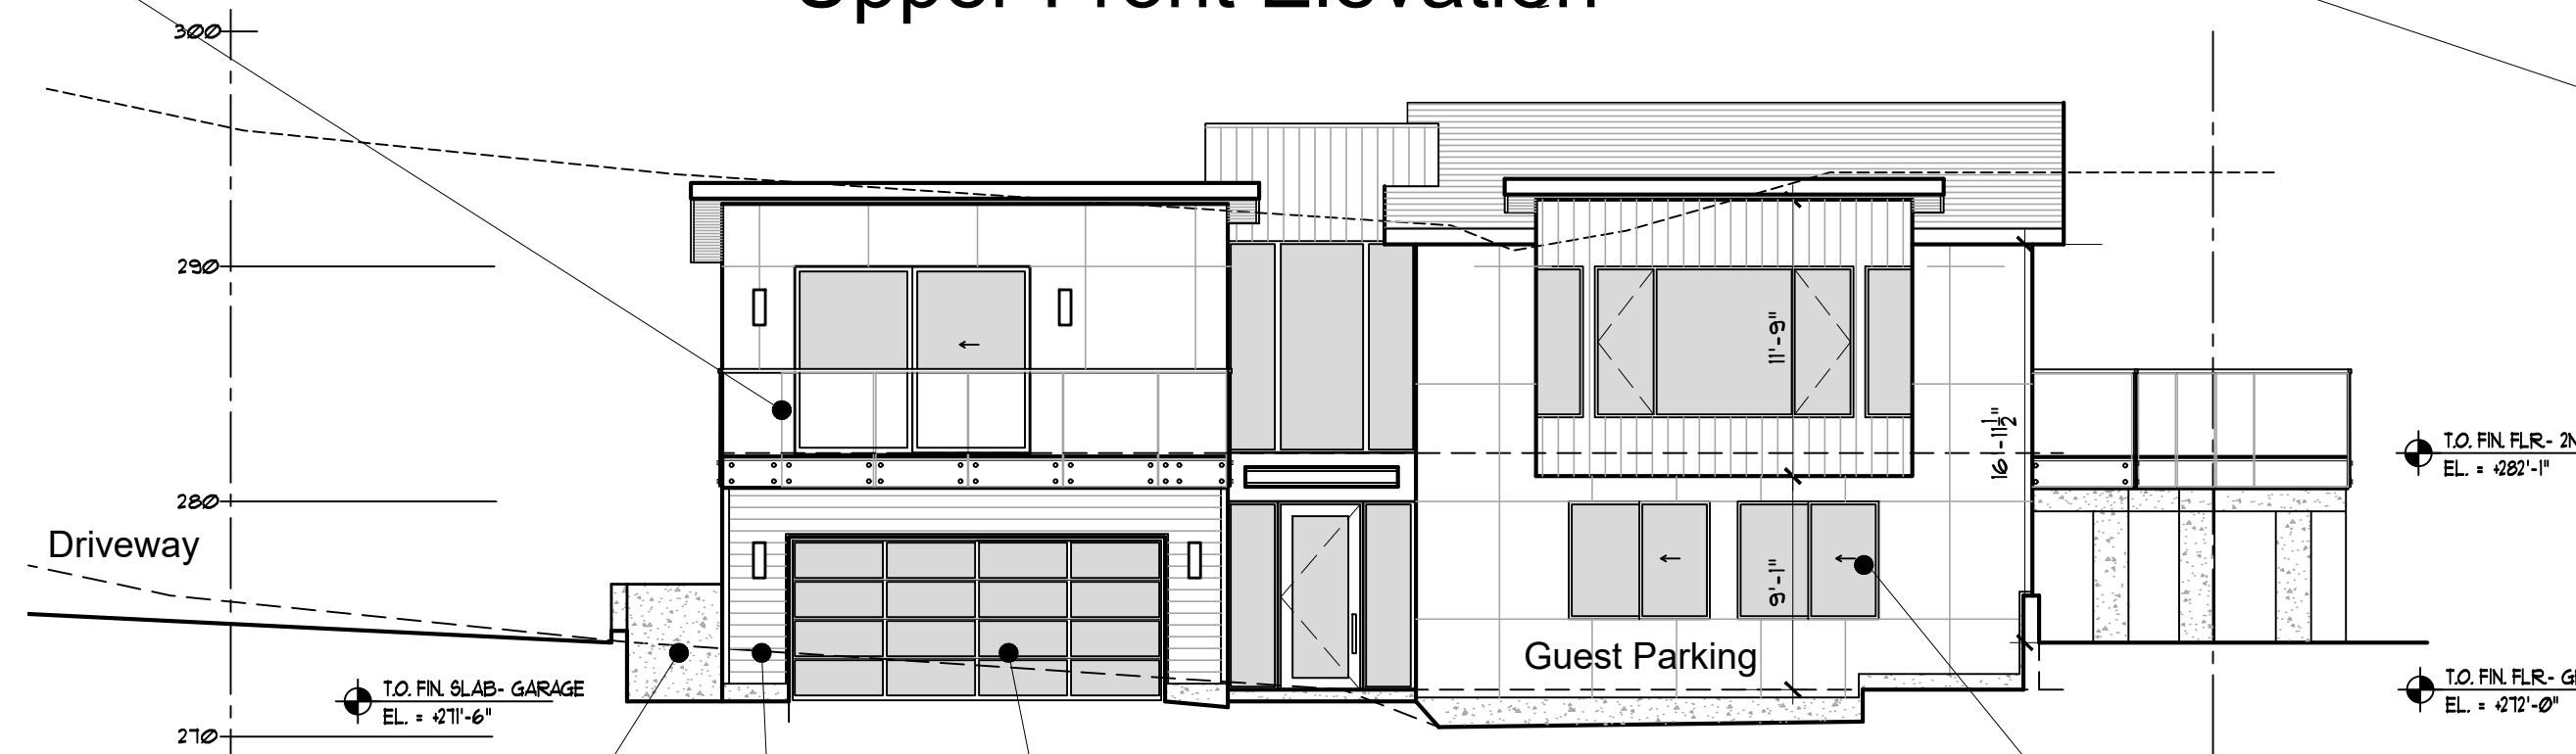

Lower Front Elevation

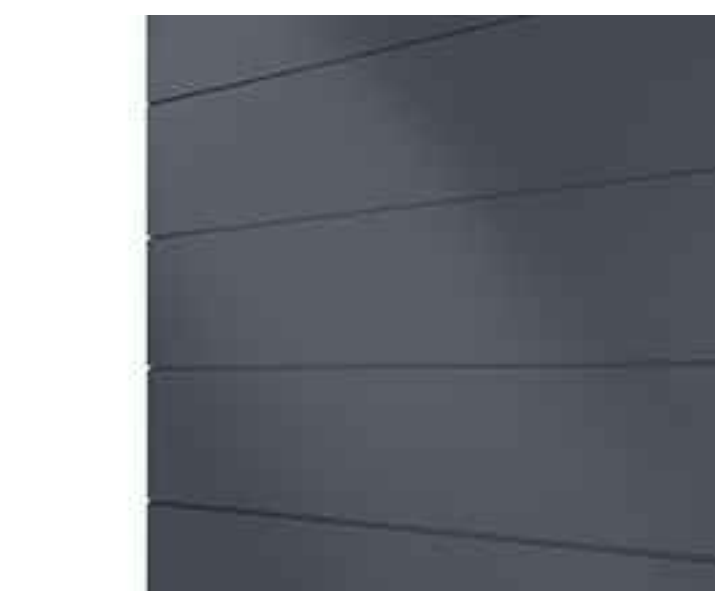

Horizontal Siding:
Hardie ShipLap




Garage Doors:
Glass and Metal

© ALL DRAWINGS AND WRITTEN MATERIAL APPEARING HEREIN CONSTITUTE THE DESIGN AND ARCHITECTURAL WORK OF JOSEPH P. FARRELL ARCHITECT, AND THE SAME ARE NOT TO BE REPRODUCED, COPIED, OR DISCLOSED WITHOUT THE WRITTEN CONSENT OF JOSEPH P. FARRELL ARCHITECT.

REVISIONS	DATE	BY

Joseph Farrell
ARCHITECTURE
1 Commercial Blvd, Suite 106
Novato, CA 94949
Voice (415) 884-2860

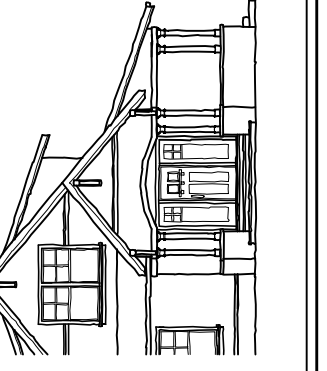

New Residence
Friedman Residence
Lots 59 and 60 - Clayton Street
San Rafael, CA APN 012-141-59 and 60

Proposed Colors and Materials

REVIEW THE DRAWINGS CAREFULLY. DO NOT SCALE THE DRAWINGS. ANY DISCREPANCIES IN DIMENSIONS AND DETAILS SHALL BE BROUGHT TO THE IMMEDIATE ATTENTION OF JOSEPH P. FARRELL ARCHITECT.
DATE: 4-15-22
SCALE: 1/8"=1'-0"
DRAWN: STC
JOB NO. 1909
SHEET NO:


A-5.2
Ross Terrace
San Rafael, CA

Preliminary Not for Construction

© ALL DRAWINGS AND WRITTEN MATERIAL APPEARING HEREIN CONSTITUTE THE ORIGINAL AND UNPUBLISHED WORK OF JOSEPH P. FARRELL ARCHITECT, AND NO PART MAY BE REPRODUCED, COPIED, OR TRANSMITTED IN ANY FORM OR BY ANY MEANS, ELECTRONIC OR MECHANICAL, INCLUDING PHOTOCOPYING, RECORDING, OR BY ANY INFORMATION STORAGE AND RETRIEVAL SYSTEM, WITHOUT THE WRITTEN CONSENT OF JOSEPH P. FARRELL ARCHITECT.

REVISIONS	DATE	BY

Joseph Farrell
ARCHITECTURE
1 Commercial Blvd, Suite 106
Novato, CA 94949
Voice (415) 884-2860

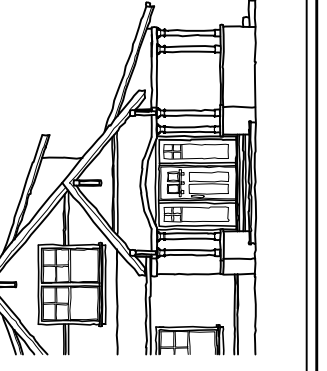


New Residence
Friedman Residence
Lots 59 and 60 - Clayton Street
San Rafael, CA APN 012-141-59 and 60

Tree Removal Plan

DATE: 4-15-22
SCALE: 1"=20'
DRAWN: STC
JOB NO. 1909
SHEET NO.

A-5.3
Ross Terrace
San Rafael, CA

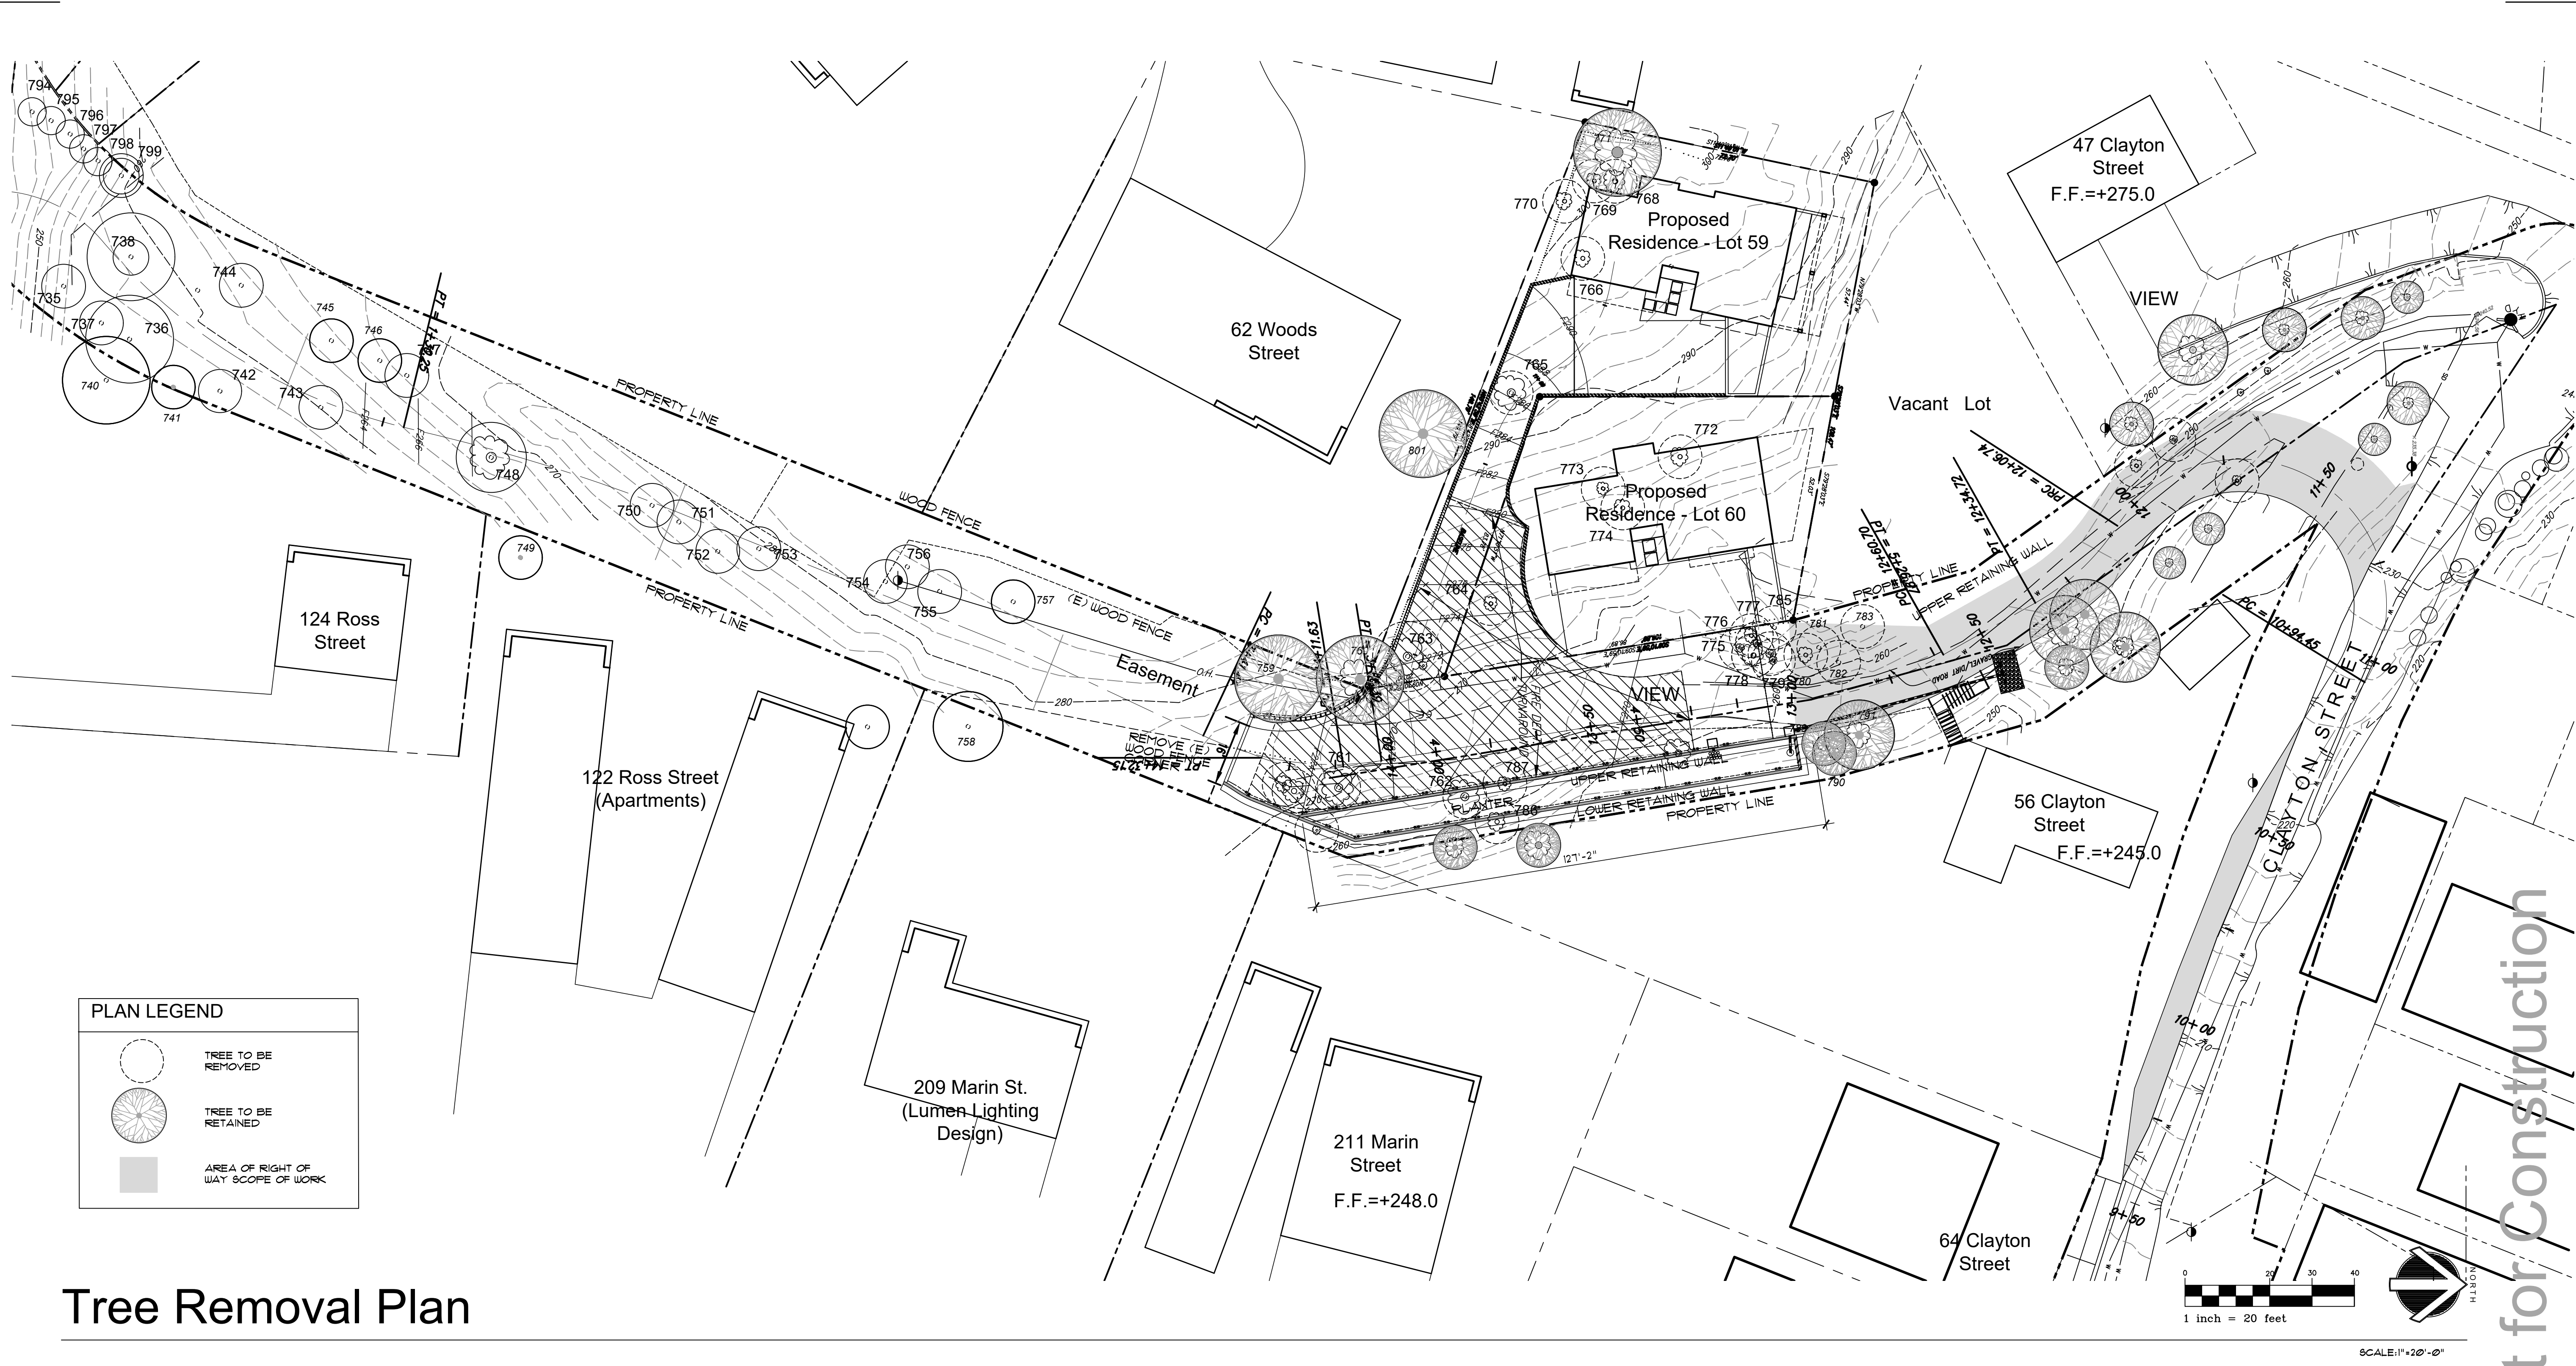

PLAN LEGEND

- TREE TO BE REMOVED
- TREE TO BE RETAINED
- AREA OF RIGHT OF WAY SCOPE OF WORK

Tree Removal Plan

TREES NUMBERED 735 TO 760 IN ARBORIST REPORT ARE TO REMAIN PER NEW PROPOSED ROAD EXTENSION OF CLAYTON STREET.

Appendix A. CF Contracting Lots 59 and 60 Ross Street Terrace San Rafael, CA, Tree Survey Table, March 2020 and June 2021.

Tag ID	Species	Common Name	Multi-trunk	Diameter	Diameter	Diameter	Diameter	Diameter	Total Diameter (inches)	Potential Impact
757	Unknown fruit tree	Unknown fruit tree	No	9.3	0.0	0.0	0.0	0.0	9.3	Remain
758	Pinus radiata	Monterey pine	No	26.1	0.0	0.0	0.0	0.0	26.1	Remain
759	Quercus agrifolia	Coast live oak	No	7.8	0.0	0.0	0.0	0.0	7.8	Remain
760	Hesperocyparis macrocarpa	Monterey cypress	No	28.0	0.0	0.0	0.0	0.0	28.0	Remain
761	Olea europaea	Olive	Yes	9.0	6.5	4.0	3.0	3.0	25.5	Remove
762	Quercus agrifolia	Coast live oak	Yes	15.3	15.3	0.0	0.0	0.0	30.6	Remove
763	Aesculus californica	California buckeye	Yes	12.1	12.1	0.0	0.0	0.0	24.2	Remove
764	Prunus cerasifera	Cherry plum	Yes	8.5	6.4	0.0	0.0	0.0	14.9	Remove
765	Acacia melanoxylon	Blackwood acacia	Yes	7.4	5.5	4.6	4.6	0.0	22.1	Remove
766	Ligustrum lucidum	Glossy privet	Yes	7.9	5.4	6.9	0.0	0.0	20.2	Remove
767	Acacia dealbata	Silver wattle	No	8.0	0.0	0.0	0.0	0.0	8.0	Remove
768	Grevillea robusta	Silk oak	No	18.2	0.0	0.0	0.0	0.0	18.2	Remove
769	Quercus agrifolia	Coast live oak	No	12.5	0.0	0.0	0.0	0.0	12.5	Remove
770	Ligustrum lucidum	Glossy privet	Yes	4.1	4.9	4.1	0.0	0.0	13.1	Remove
771	Quercus agrifolia	Coast live oak	Yes	18.9	17.6	11.4	0.0	0.0	47.9	Remain
772	Quercus agrifolia	Coast live oak	No	13.6	0.0	0.0	0.0	0.0	13.6	Remove
773	Quercus agrifolia	Coast live oak	No	10.5	0.0	0.0	0.0	0.0	10.5	Remove
774	Quercus agrifolia	Coast live oak	Yes	9.7	8.9	0.0	0.0	0.0	18.6	Remove
775	Acacia dealbata	Silver wattle	No	10.2	0.0	0.0	0.0	0.0	10.2	Remove
776	Acacia dealbata	Silver wattle	No	9.5	0.0	0.0	0.0	0.0	9.5	Remove
777	Acacia dealbata	Silver wattle	Yes	5.2	5.6	0.0	0.0	0.0	10.8	Remove

Appendix A. CF Contracting Lots 59 and 60 Ross Street Terrace San Rafael, CA, Tree Survey Table, March 2020 and June 2021.

Tag ID	Species	Common Name	Multi-trunk	Diameter	Diameter	Diameter	Diameter	Diameter	Total Diameter (inches)	Potential Impact
778	Acacia dealbata	Silver wattle	Yes	4.3	3.1	5.6	2.6	0.0	15.6	Remove
779	Acacia dealbata	Silver wattle	Yes	9.4	7.1	7.0	7.0	0.0	30.5	Remove
780	Acacia dealbata	Silver wattle	Yes	9.0	7.5	0.0	0.0	0.0	16.5	Remain
781	Acacia dealbata	Silver wattle	No	6.2	0.0	0.0	0.0	0.0	6.2	Remain
782	Acacia dealbata	Silver wattle	No	11.5	0.0	0.0	0.0	0.0	11.5	Remain
783	Acacia dealbata	Silver wattle	No	9.5	0.0	0.0	0.0	0.0	9.5	Remain
784	Acacia dealbata	Silver wattle	Yes	8.4	6.5	0.0	0.0	0.0	14.9	Remove
786	Quercus agrifolia	Coast live oak	No	12.5	0.0	0.0	0.0	0.0	12.5	Remove
787	Umbellularia californica	California bay	Yes	4.0	3.5	3.5	3.5	0.0	14.5	Remove
788	Quercus agrifolia	Coast live oak	No	18.0	0.0	0.0	0.0	0.0	18.0	Remove
789	Umbellularia californica	California bay	Yes	14.0	7.0	0.0	0.0	0.0	21.0	Remain
790	Prunus cerasifera	Cherry plum	Yes	4.0	4.0	0.0	0.0	0.0	8.0	Remain
791	Umbellularia californica	California bay	Yes	7.0	3.5	0.0	0.0	0.0	10.5	Remain
792	Prunus cerasifera	Cherry plum	Yes	5.5	3.5	5.0	4.0	0.0	18.0	Remove
793	Umbellularia californica	California bay	Yes	13.7	8.5	0.0	0.0	0.0	22.2	Remove

Preliminary Not for Construction