

1515 FOURTH STREET APARTMENTS

1515 4TH STREET SAN RAFAEL, CA 94901

SB 330 APPLICATION

7740 WEST MANCHESTER AVENUE . SUITE 205 . PLAYA DEL REY . CALIFORNIA . 90293 310.306.7804 OFFICE 310.306.9072 FAX

MARCH 10, 2022

OWNER/APPLICANT: 1515 4TH STREET ASSOCIATES, LLC 1101 FIFTH AVENUE, SUITE #300 SAN RAFAEL, CA 94901

> ARCHITECT: EGAN | SIMON ARCHITECTURE

EVIÁTIONS

GALV.

GRND. GR.

GYP. GYP. BD.

H.C. HDWD. HDWE. H.M. HORIZ. HR.

HT. H.V.A.C.

HW

INSUL. INT.

JAN.

LAM. LAV.

Maint. Mas. Matl. Mech. Mfr. Misc. Mins. Mlwk. Mtw. Mtd. Mtl.

N.

N.I.C. NO. NOM. N.T.S.

0.0

OPNG. OPP.

PL. P.LAM. PLAS. PLUMB. PLYWD. PNL. PR.

PROJ. PT. PTN.

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ARCHITE	CTURAL ABBRE
A/C A.C. TILE ACOUS. ADJ. ADJUST. A.F.F. ALUM. AMP. APPROX. ARCH.	AIR CONDITIONING ACOUSTICAL CEILING ACOUSTICAL ADJACENT ADJUSTABLE ABOVE FINISH FLOOR ALUMINUM AMPERE APPROXIMATE ARCHITECTURAL
BD. BLDG. BLK. BLKG BOT.	BOARD BUILDING BLOCK BLOCKING BOTTOM
CAB. C.B. CEM. CLG. CLOS. CLR. CLR. OPEN. C.M.U. COL. CONC. CONN. CONT. CONTR. CONTR. CORR. CORR. CPT. C.T. CTR. CW	CABINET CORNER BEAD CEMENT CEILING CLOSET CLEAR CLEAR CLEAR OPENING CONCRETE MASONRY UNIT COLUMN CONCRETE CONNECTION CONTINUOUS CONTRACTOR CORRIDOR CARPET CERAMIC TILE CENTER COLD WATER
D. DBL. DED. DEPT. D.F. DIA. DIAG. DIM. DN. DR. DR. D.S.P. DTL. DWG. DWR.	DEEP DOUBLE DEDICATED DEPARTMENT DRINKING FOUNTAIN DIAMETER DIAGONAL DIMENSION DOWN DOOR DRY STAND PIPE DETAIL DRAWING DRAWER
E. EA. E.F. ELEV. ELEC. EQ. EXIST. EXP. EXP'D. EXT.	EAST EACH EXHAUST FAN ELEVATION ELECTRIC ELEVATOR EQUAL EXISTING EXPANSION EXPOSED EXTERIOR
F.D. F.E.C. F.H.C. FIN. FIXT. FLR. FLUOR. F.O.C. F.O.F. F.O.M. F.O.S. F.S. FT. FULL FURN. FURR.	FLOOR DRAIN FIRE EXTINGUISHER CABINET FIRE HOSE CABINET FINISH FIXTURE FLOOR FLUORESCENT FACE OF COLUMN FACE OF FINISH FACE OF MASONRY FACE OF STUD FLOOR SINK FOOT OR FEET FULL SIZE FURNITURE FURRING


S		I	
0			
GALLON GAUGE GALVANIZED GENERAL CONTRACTOR GROUND FAULT INTERRUPT GLAZING GROUND GRADE GYPSUM GYPSUM WALLBOARD	R. RAD. REF. REFR. REINF. REQ'D. RESIL. R.H. R.H. R.O.	RISER RADIUS REFERENCE REFRIGERATOR REINFORCED REQUIRED RESILIENT RIGHT HAND ROOM ROUGH OPENING	
HIGH HOLLOW CORE HARDWOOD HARDWARE HOLLOW METAL HORIZONTAL HOUR HEIGHT HEATING, VENTILATION & AIR CONDITIONING HOT WATER INSIDE DIAMETER INCH INSULATION INTERIOR	S. S.C. SCHED. SECT. SEP. SHT. SIM. S.L. SPEC. S Q. S.S. STD. STG'D. STL. STOR. STRUCT. SUSP. SYM.	SOUTH SOLID CORE SCHEDULE SECTION SEPARATE SHEET SIMILAR SKYLIGHT SPECIFICATION SQUARE STAINLESS STEEL STANDARD STAGGERED STEEL STORAGE STRUCTURAL SUSPENDED SYMMETRICAL	
JANITOR JOINT KITCHEN LAMINATE LAVATORY POUNDS LEFT HAND LIGHT MAINTENANCE MASONRY MATERIAL MAXIMUM MECHANICAL MANUFACTURER MINIMUM MISCELLANEOUS MILLWORK MASONRY OPENING MOUNTED METAL MULLION NORTH NOT IN CONTRACT NUMBER NOMINAL NOT TO SCALE	T. TEL. TEMP. T&G T.O.W. TYP. U.L. UNF. U.N.O. U.O.N. V. V.C.T. VERT. VEST. V.I.F. W. W. W. W. W. W. W. W. W. W. W. W. W.	TREAD TELEPHONE TEMPERED TONGUE AND GROOVE TOP OF WALL TYPICAL UNDERWRITERS LABORATORY UNFINISHED UNLESS NOTED OTHERWISE UNLESS OTHERWISE NOTED VOLTS VINYL COMPOSITION TILE VERTICAL VESTIBULE VERIFY IN FIELD WEST WITH WATER CLOSET WOOD WATER HEATER WITHOUT WATER RESISTANT WEIGHT	
ON CENTER OUTSIDE DIAMETER OFFICE OPENING OPPOSITE PLATE PLASTIC LAMINATE PLASTER PLUMBING PLYWOOD PANEL PAIR PROJECTION POINT PARTITION			


VICINITY MAP



12' 	0 1' 	6' 	0 1'		$ \begin{array}{c ccccccccccccccccccccccccccccccccccc$
SYMBOLS			1	SHEET	INDEX
DIMENSION STRING LEADER DRAWING TITLE	1" 1" 1 1" 1 1" 1 1" 1 1 1 1 1 1 1 1 1 1 1 1 1	DIMENSION VALUE DIMENSION EXTENTS DRAWING NUMBER		<u>GENERA</u> G0.00 G0.01 G0.02 G0.05	<u>AL INFORMATION</u> COVER SHEET PROJECT INFORMATION, SHEET INDEX, LEGENDS & ABBREVIATIONS PROJECT DATA SITE PHOTOS - EXISTING CONDITIONS
DRAWING SCALE		SHEET NUMBER		ARCHITI A1.01	ECTURAL SITE PLAN
DIRECTIONAL ELEVATION INDICATOR	XX AX.X.X	DRAWING NUMBER SHEET NUMBER		A2.00A A2.00B A2.01 A2.02	P2 LEVEL FLOOR PLAN P1 LEVEL FLOOR PLAN FIRST FLOOR PLAN SECOND FLOOR PLAN
DIRECTIONAL SECTION INDICATOR	XX AX.X.X	DRAWING NUMBER SHEET NUMBER		A2.03 A2.04 A2.05 A2.06 A2.07 A2.08	THIRD FLOOR PLAN FOURTH FLOOR PLAN FIFTH FLOOR PLAN SIXTH FLOOR PLAN SEVENTH FLOOR PLAN ROOF PLAN
	×	X = ELEVATION LETTER		A3.01 A3.02	EXTERIOR ELEVATIONS EXTERIOR ELEVATIONS
INTERIOR ELEVATION INDICATOR	X XX X XX X X XX X X X	DRAWING NUMBER SHEET NUMBER X = ELEVATION LETTER		A4.01 A5.01 A5.02	BUILDING SECTIONS ENLARGED UNIT PLANS ENLARGED UNIT PLANS
NORTH INDICATOR				A6.01	COLORS AND MATERIALS BOARD
MATCH LINE		ANGLE OF OBJECT		A8.01	EXTERIOR DETAILS
GRID LINE DESIGNATOR FLOOR/LEVEL NUMBER	(X.X) XXX () EL:+/-X	X.X = GRID LINE - .X" ELEVATION - CIVIL		LANDSC L-1 L-2	APE STREET LEVEL LANDSCAPE PLAN ROOFTOP TERRACE LANDSCAPE PLAN
FLOOR DESCRIPTION FLOOR/LEVEL INDICATOR PHYSICAL ELEVATION ELEVATION MARKER	XXX EL:+/-X'	X" ELEVATION - SEA LEVEL		CIVIL C1.0 C1.1 C1.2 C1.3 C1.4 C2.0	TITLE SHEET AND DETAILS L1 GRADING AND DRAINAGE PLAN P1 GRADING AND DRAINAGE PLAN P2 GRADING AND DRAINAGE PLAN EROSION CONTROL PLAN CONCEPTUAL UTILITY PLAN
ELEVATION - SEA LEVEL ELEVATION - CIVIL		<u>-000'-00"</u> -000'-00"			
TEXT-001: 1'=1'	XXXX XXX XXX	ROOM NAME <u>ROOM NUMBER</u> SQUARE FOOTAGE			
REVISION INDICATOR	<u>x</u> x	XX = REVISION NUMBER			
WINDOW TYPE INDICATOR		XXXX = WINDOW TYPE			
MATERIAL INDICATOR		XXXX = MATERIAL FINISH			
DOOR TYPE INDICATOR	(XXXX)	XXXX = DOOR NUMBER			
TOTAL NUMBER OF OCCUANTS USING EXIT	(#)	ARROW INDICATES PATH OF TRAVEL			
EMERGENCY EXIT SIGNAGE WALL MOUNTED		ARROW INDICATES PATH OF TRAVEL (OPT.) ARROW INDICATES PATH OF TRAVEL (OPT.)			
FIRE EQUIPMENT CABINET	FEC				

1'	3' 1" = 1'-0"	2" 	0 1 1 3" = 1'-0"	
			TEAM DIRECTORY OWNER	
&			MONAHAN PACIFIC CORP. 1101 FIFTH AVENUE, SUITE #300 SAN RAFAEL, CA, 94901	77
			ARCHITECT: EGAN SIMON ARCHITECTURE, INC. 7740 WEST MANCHESTER AVENUE, SUITE 205 PLAYA DEL REY, CA 90232 TEL: 310.306.7804 CONTACT: JOHN EGAN	
				OWN
				 Revis
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				THES OF TH BY A0
				BY AG PREF JOB S ARCH
				Projec 151 APA Sheet PRC LEG
				LEG Scale: Drwn E

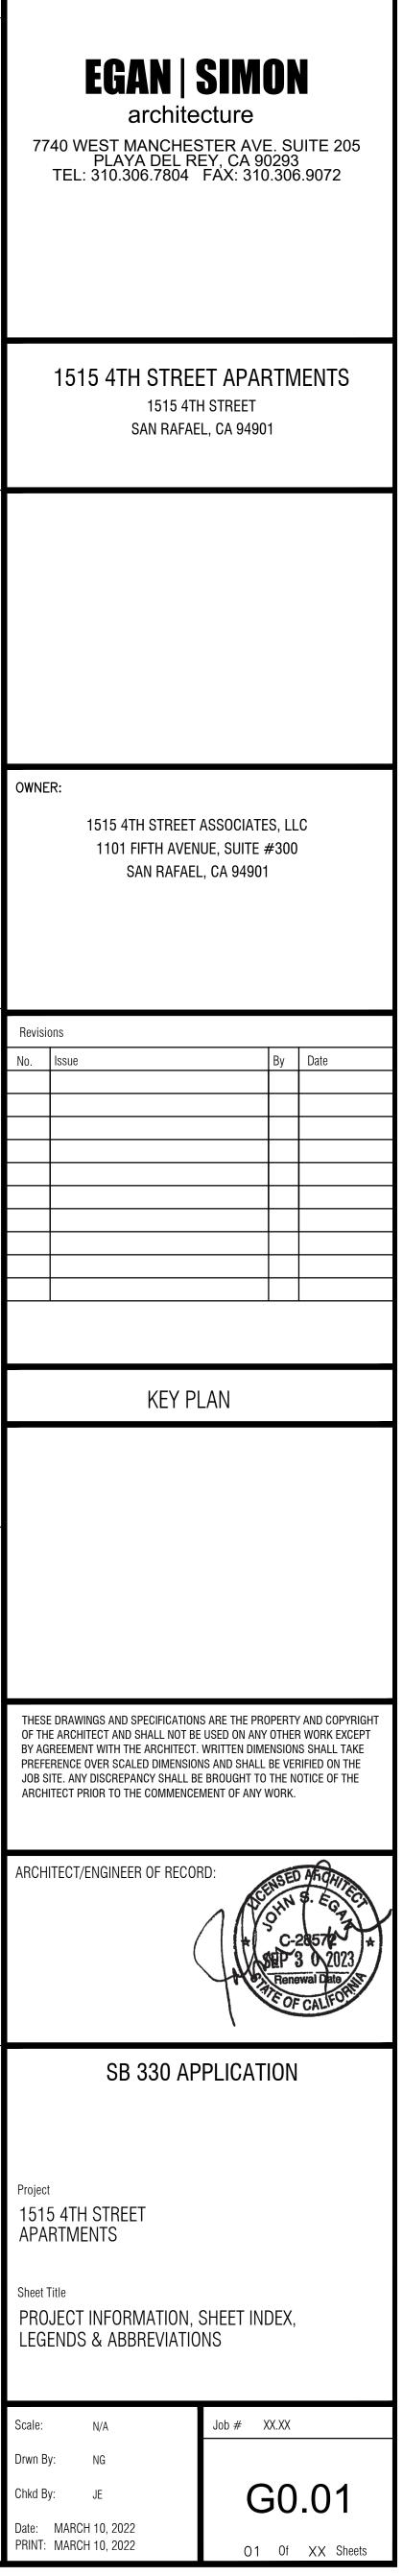

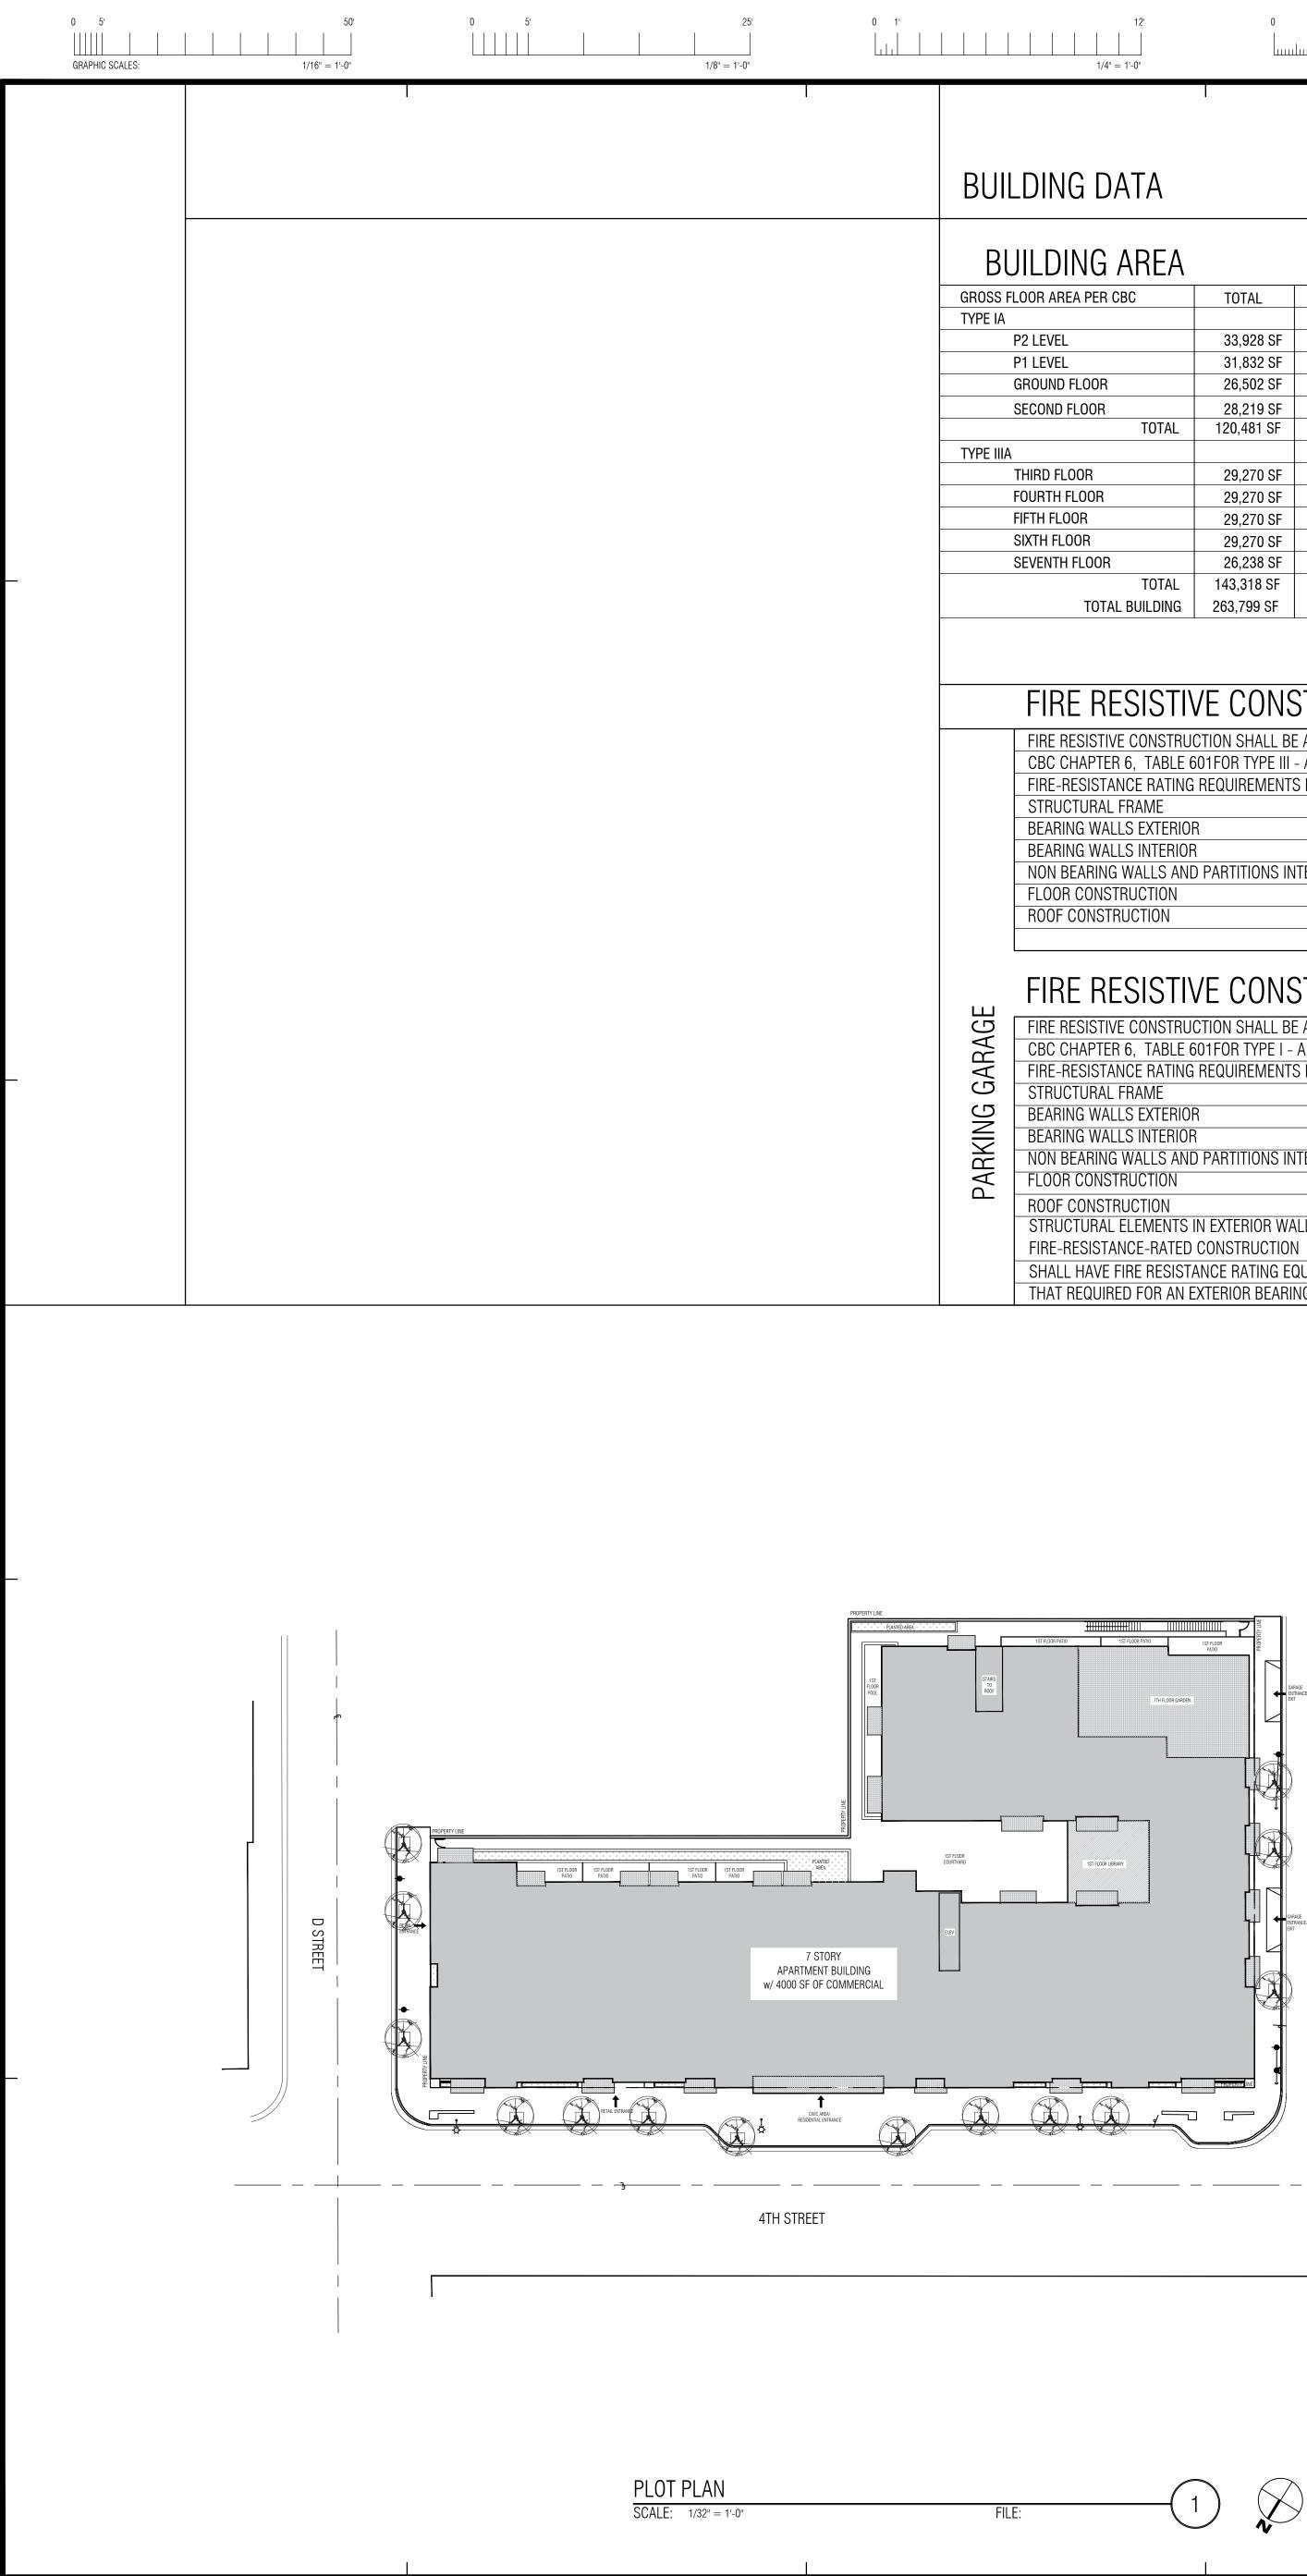

BUILDING DATA

ILDING AREA				
OOR AREA PER CBC	TOTAL	S2	R2	
22 LEVEL	33,928 SF	33,928 SF		
P1 LEVEL GROUND FLOOR	31,832 SF 26,502 SF	31,832 SF	26,502 SF	
SECOND FLOOR	28,219 SF		28,219 SF	
TOTAL	120,481 SF			
THIRD FLOOR	29,270 SF		29,270 SF	
	29,270 SF		29,270 SF	
FIFTH FLOOR	29,270 SF 29,270 SF		29,270 SF 29,270 SF	
SEVENTH FLOOR	26,238 SF		26,238 SF	
TOTAL TOTAL BUILDING	143,318 SF 263,799 SF			
FIRE RESISTIVE CONSTRUCT FIRE RESISTIVE CONSTRUCT CBC CHAPTER 6, TABLE 6 FIRE-RESISTANCE RATING STRUCTURAL FRAME BEARING WALLS EXTERIOR BEARING WALLS INTERIOR NON BEARING WALLS AND FLOOR CONSTRUCTION ROOF CONSTRUCTION	CTION SHALL BE 01FOR TYPE III REQUIREMENTS R D PARTITIONS IN	AS REQUIRED - A S FOR BUILDING TERIOR	BY ELEMENTS AS 1 HOUR 2 HOUR 1 HOUR 1 HOUR 1 HOUR 1 HOUR	FOLLOWS:
FIRE RESISTIVE CONSTRUCT				PE I-A
FIRE RESISTIVE CONSTRUCT CBC CHAPTER 6, TABLE 6			DĬ	
FIRE-RESISTANCE RATING				FOLLOWS:
STRUCTURAL FRAME	.		3 HOUR	
BEARING WALLS EXTERIOR BEARING WALLS INTERIOR			3 HOUR 3 HOUR	
NON BEARING WALLS AND		TERIOR	NON-RATED	
FLOOR CONSTRUCTION			2 HOUR	
ROOF CONSTRUCTION			1 ¹ / ₂ HOUR	
STRUCTURAL ELEMENTS FIRE-RESISTANCE-RATED			IO BE OF	
SHALL HAVE FIRE RESIST			ATER THAN	
THAT REQUIRED FOR AN E				
		14MCE/		

PLANNIN	g ane) ZONI	NG D/	ATA		
ZONING		WEV				
LOT AREA		TOTAL	GROSS ARE/	A: 38,519 SF		
DENSITY ALLOWE STATE DENSITY B BMR UNITS PROP	ONUS 32.5%		144 UNITS 144 UNITS X 1.32.5 = 190.8, ROUNE			
(10% VERY LOW I TOTAL UNITS PR	NCOME)	191 UNI	TS			
 SETBACKS (SRMC 14	4.05.032)					
	,	REQU	REQUIRED			
FRONT YARD - NO	ORTH	0	0'			
SIDE YARD - EAS	-		0' 0 0' 0			
 SIDE YARD - WES REAR YARD - SOL			0' 0'			
REAR YARD - SOL		0			4	
HEIGHT						
		PROP	OSED			
HEIGHT BONUS (1		6' (IN TH	E WEST END	VILLAGE)		
BUILDING HEIGHT		80'-0" / 7	STORIES			
PARKIN	G SUI	MMAR	Y			
	REQ	UIRED RESIDE	NTIAL	PROV	IDED	
	STAI	NDARD	COMPACT	STANDARD	CON	
 RESIDENTIAL				450		
(1 BED) (2 BED)	•) X .5 = 63.5) X 1 = 64	0	158		

COMMERCIAL 0 0 0 TOTAL 128 0 0 TOTAL: 128 (REQUIRED) TOTAL:164 (PRO


MINIMUM LANDSCAPING

WEV (SRMC 14.05.032)		
	REQUIRED LANDSCAPING	PROPOSEI
GROUND LEVEL	NR	8,213
SECOND FLOOR	NR	1,680
THIRD FLOOR	NR	1,680
FOURTH FLOOR	NR	1,680
FIFTH FLOOR	NR	1,680
SIXTH FLOOR	NR	1,680
SEVENTH FLOOR	NR	3,793
TOTAL LANDSCAPING	(NR) NOT REQUIRED	20,406

BICYCLE PARKING

			LON
	UNIT COUNT	REQUIRED SPACES PER UNIT	REQUIRED
RESIDENTIAL	191		
	127	1 PER 1 BED	127
	64	2 PER 2 BED	128
TOTAL			255
1			

0 	1' 	4' 		0	1' 		3' 		2' 1-1/2" = 1'-0"	0 	1' 3" = 1'-0"	
Ι			Ι				I		Ι			
	PLANNIN	IG AND ZONI	NG D	ATA				PROJECT DESC	RIPTION			
	ZONING WEV					THE PROPERTY IS 38,519 S.F., OF LOCATED IN THE CENTRAL BUSIN BETWEEN "E" STREET AND SHAVE GATEWAY TO THE VERY DESIRAB	ESS DISTRICT OF DOWNTOWN R STREET, OPEN ALL 3 SIDES	I SAN RAFAEL. THE PROJECT OCC TO PUBLIC RIGHT AWAY. THE PR	UPIES A FULL ¹ / ₂ Block	77		
	DENSITY ALLOW	ED 144 UN	TS					THE DEVELOPMENT WILL CONSIS UNITS)). THE PROJECT WILL INCL	-		-	
	BMR UNITS PROI (10% VERY LOW	POSED 144 UN	TS X 1.32.5 TS X .10 =	= 190.8, R0 14 BMRS)UND UP 19	91 UNITS		OF A PODIUM DECK. THE GROUND FLOOR WILL CONSI ROOM, A COURTYARD AND 14 HC				
	TOTAL UNITS PF		TS					RESIDENTIAL UNITS. THE SEVENT OUTDOOR DECK SPACES. THE SU PARKING.	H FLOOR ALSO HAS A DECK T	HAT CONSISTS OF A ROOF GARDE	en, a rec room and	
	SETBACKS (SRMC 1	4.05.032) REQU	IRED	P	ROPOSED			THE HOUSING UNIT BREAKDOWN	IS : (127) ONE BEDROOM UNI	rs and (64) two bedroom unit	S.	
	FRONT YARD - N SIDE YARD - EAS SIDE YARD - WES	ST C	μ μ μ		0' 0' 0'			THIS PROJECT REQUIRES EMERG SYSTEM IS A DEFERRED SUBMITT		/ERAGE PER CFC 507.5.1. DISTRI	BUTED ANTENNA	
	REAR YARD - SO REAR YARD - SO HEIGHT				4' 4'			LOT SUMMAF	2V			
	HEIGHT BONUS (14.16.190) 6' (IN TH	OSED E WEST END	D VILLAGE)				PROJECT ADDRESS	1515 4TH STREET			
		IG SUMMAR	Y STORIES					ASSESSOR PARCEL NUMBER	SAN RAFAEL, CA 94901 011-245-26 & 011-245-3	9		
		REQUIRED RESIDE		PROV	IDED RESID	DENTIAL	REMARKS	ABUTTING STREETS	38,519 SF 0.88 ACRES SHAVER STREET AND E S	STREET		
		STANDARD				ACCESSIBLE		ZONING DISTRICT COMMUNITY PLAN AREA	WEV (WEST END VILLAG DOWNTOWN RESIDENTIA	•		OWNE
	RESIDENTIAL (1 BED)	127 (UNITS) X .5 = 63.5	0	158	0	6						
	(2 BED)	64 (UNITS) X 1 = 64		0	0	0			EXISTING: BANK TO BE DEMOLISHED	PROPOSED: RESIDENTIAL/COMMERCIAL		
	COMMERCIAL	0	0	0	0	0		PROJECT INF	ORMATION			
		TOTAL: 128 (REQUIRED)		TOTAL:164	i (Provided			DESCRIPTION: RESIDENTIAL A	PARTMENTS + COMMERCI	AL OVER SUB. PARKING		Revisi No.
		ANT ACCESSIBLE PARKIN ANT VAN ACCESSIBLE PA			DED		= 6 SPACES= 1 SPACES	OCCUPANCY:	COMMERCIAL =			
		MERCIAL ACCESSIBLE F MERCIAL VAN ACCESSIE					= 0 SPACE= 0 SPACE	CONSTRUCTION TYPE:		PODIUM (APARTMENTS)		
		IDARD STALLS PROVIDE PACT PARKING STALLS					= 159 SPACES = 0 SPACES	SPRINKLERED: THREE HOUR	NFPA 13 SPRIN		,	
	NUMBER OF EV S NUMBER OF EVCS	TALLS					= 10 SPACES= 2 SPACES	UNIT TYPE SL				
	NOWBEN OF EVE	JUNELO					- 2 01 A020		AMOUNT TOTAL AREA 127 95,250 SF	COMMENTS		
								2 - BEDROOM 1100	64 70,400 SF			
		JM LANDSC	APIN(G				TOTAL	191 165,650 SF			_
	WEV (SRMC 14.05.0 GROUND LEVEL	J32) REQUIRED L NR			ED LANDSC 3 SF (PATIO		, COURTYARDS, CIVIC SPACE	BMR UNIT BR	EAKDOWN			=
	SECOND FLOOR THIRD FLOOR FOURTH FLOOR	NR NR NR		1,68	0 SF (BALCO 0 SF (BALCO 0 SF (BALCO	ONIES)		10 UNITS = 1 BED (UNITS 217, 219 4 UNITS = 2 BED (UNITS 215,315,		617, AND 619)		_
	FIFTH FLOOR SIXTH FLOOR SEVENTH FLOOR	NR NR NR		1,68	0 SF (BALCO 0 SF (BALCO 3 SE (BALCO	1		ADA UNIT BR	EAKDOWN			
	TOTAL LANDSCA		REQUIRED		06 SF			10% OF THE UNITS ARE FULLY ACCE 127 ONE-BEDROOM X 10% = 12.7 U	JNITS, ROUND UP TO 13 UNITS			THES OF TH BY AG
								(UNITS 104, 110, 214, 229, 309, 403 64 TWO-BEDROOM X 10% = 6.4 UN TOTAL 20 UNITS			AND 715)	PREFI JOB S ARCH
	BICYCLE	PARKING			ONG TERM	1		ALL OTHER UNITS ARE ADAPTABLE 4% OF UNITS ARE FOR AUDIBLE/VIS	UALLY IMPAIRED RESIDENTS (C	OMMUNICATION UNIT)		ARCH
	L	JNIT COUNT PER UNI 191	ED SPACES T	REQUIR	ED PRO	OPOSED		127 ONE-BEDROOM X 4% = 5.1 UN 64 ONE-BEDROOM X 4% = 2.6 UNIT TOTAL 8 UNITS \Im	ITS, ROUND UP TO 6 UNITS (UN	IITS 105, 205, 324, 417, 616 AND 70	04)	_
		127 1 PER 64 2 PER		127 128		127		DEFERRED SUB	MITTALS			
	TOTAL			255	2	255		THAT INITIATES THE OCCUF	MONITORING SYSTEM PER CB	C 907.2.3 - A MANUAL AND AUTOM IZING AN EMERGENCY VOICE/ALARI		
										JIRED BY THE CITY OF LOS ANGELES	S FIRE CODE SECTION 510	
								 PROJECT SIGNAGE STOREFRONT GLAZING SYS GLASS GUARDRAIL SYSTEM SOLAR HOT WATER SYSTEM 	1			Projec
								9. ELEVATOR (STANDBY POWE 10. DEMOLITION 11. BLOCK FENCE WALLS				151 APA
								12. DISTRIBUTED ANTENNA SYS 13. SLATE RAINSCREEN SYSTEM NOTES:				Sheet
								1. THE ARCHITECT OR ENGINE THE DEFERRED SUBMITTAL	DOCUMENTS TO THE BUILDING	THE DEFERRED SUBMITTALS ON TH OFFICIAL PRIOR TO INSTALLATION. O THE ARCHITECT OR ENGINEER OF		IT PKU
								WHO SHALL REVIEW THEM DEFERRED SUBMITTAL DOC WITH THE DESIGN OF THE E	CUMENTS HAVE BEEN REVIEWED BUILDING. THE DEFERRED SUBN	UILDING OFFICIAL WITH A NOTATION AND HAVE BEEN FOUND TO BE IN (ITTAL ITEMS SHAL NOT BE INSTALL	GENERAL CONFORMANCE ED UNTIL DESIGN AND	Scale:
								OFFICIAL TO REVIEW THE D 3. PLANS FOR THE DEFERRED	OCUMENTS.(CBC 106.3.4.2) SUBMITTAL ITEMS SHALL BE S	JILDING OFFICIAL. PROVIDE AMPLE JBMITED IN A TIMELY MANNER THA	T ALLOWS A MIN 30 WORKIN	Drwn B NG _{Chkd B}
			I				I	SATISFACTION OF THE PLAI	N CHECKER DIVISION PRIOR TO	TO THE DEFERRED SUBMITTAL MU APPROVAL OF THE SUBMITTAL ITEN N APPROVED BY THE BUILDING OFF	IS SHALL NOT BE INSTALLED) Date: PRINT:

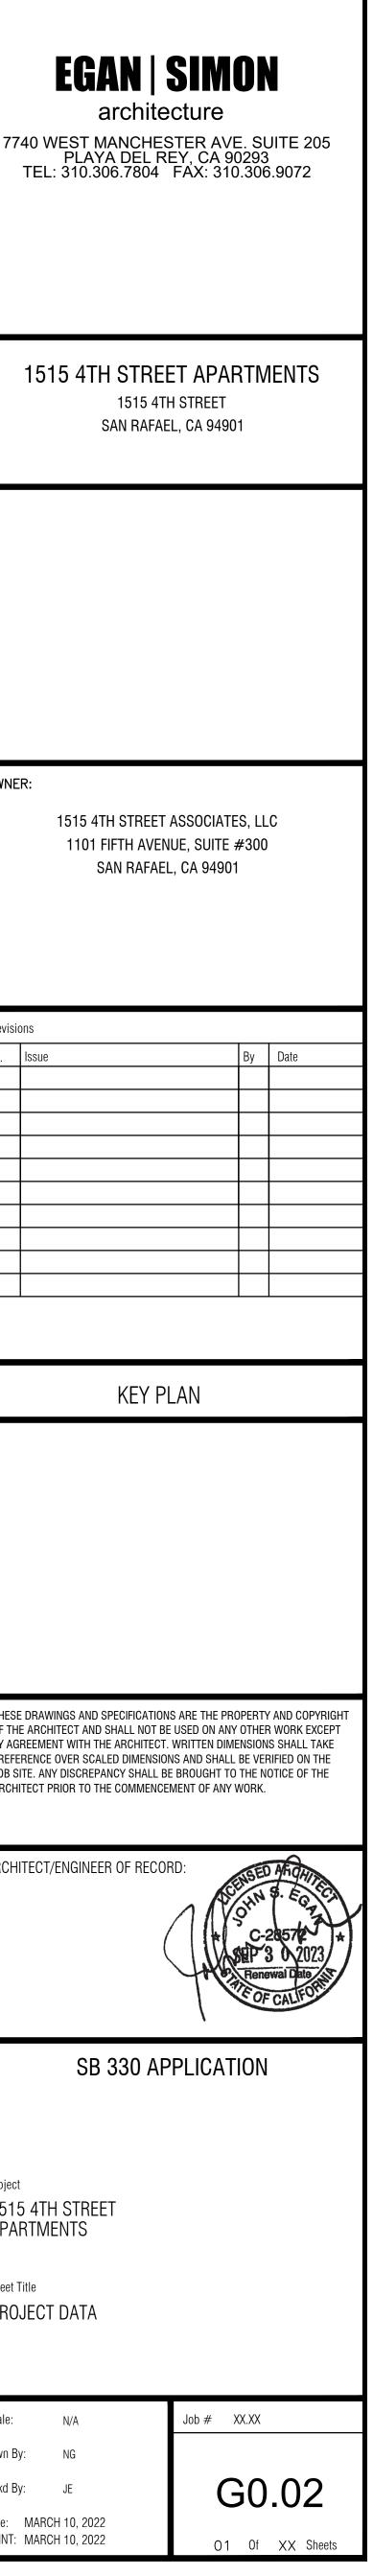

1/8" = 1'-0"



1. VIEW FROM 4TH STREET - SOUTH FACING





2. VIEW FROM SHAVER STREET - EAST FACING




3. VIEW FROM D STREET - WEST FACING




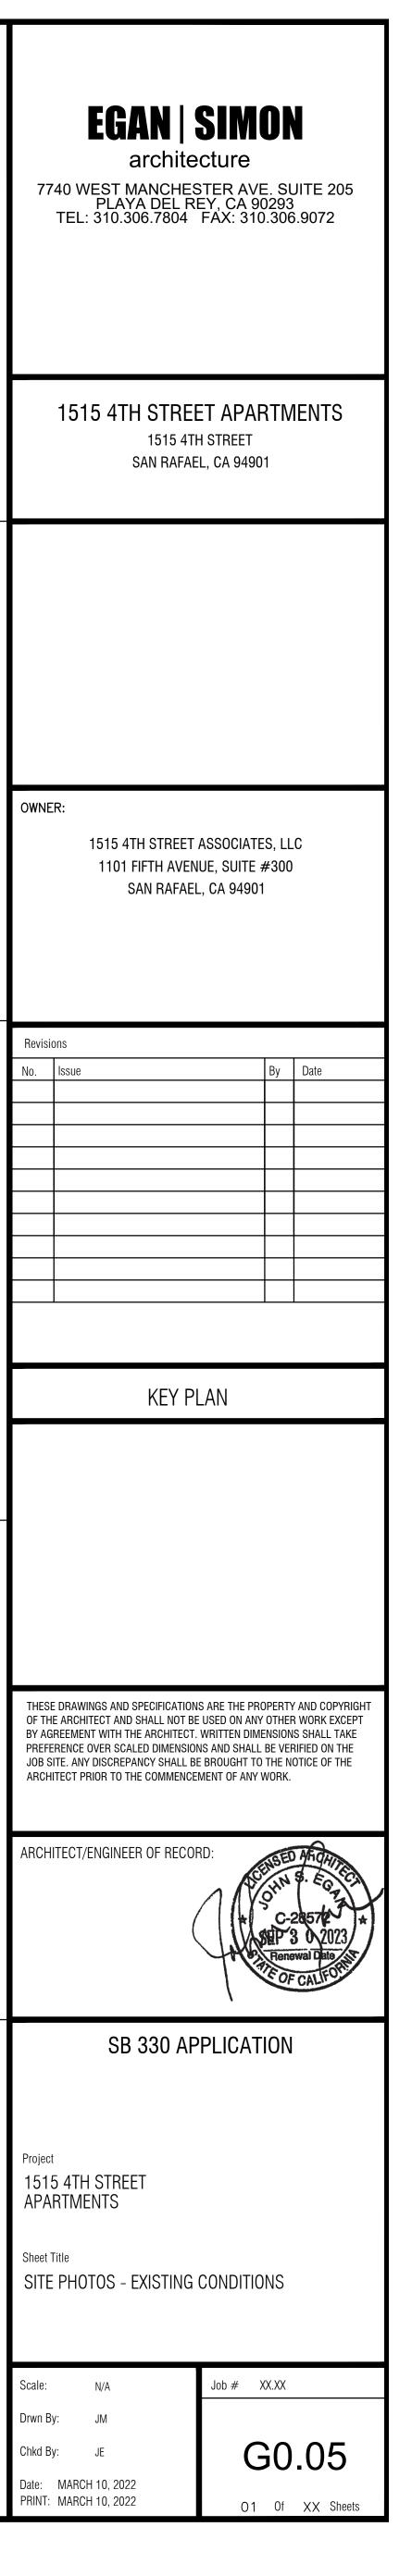


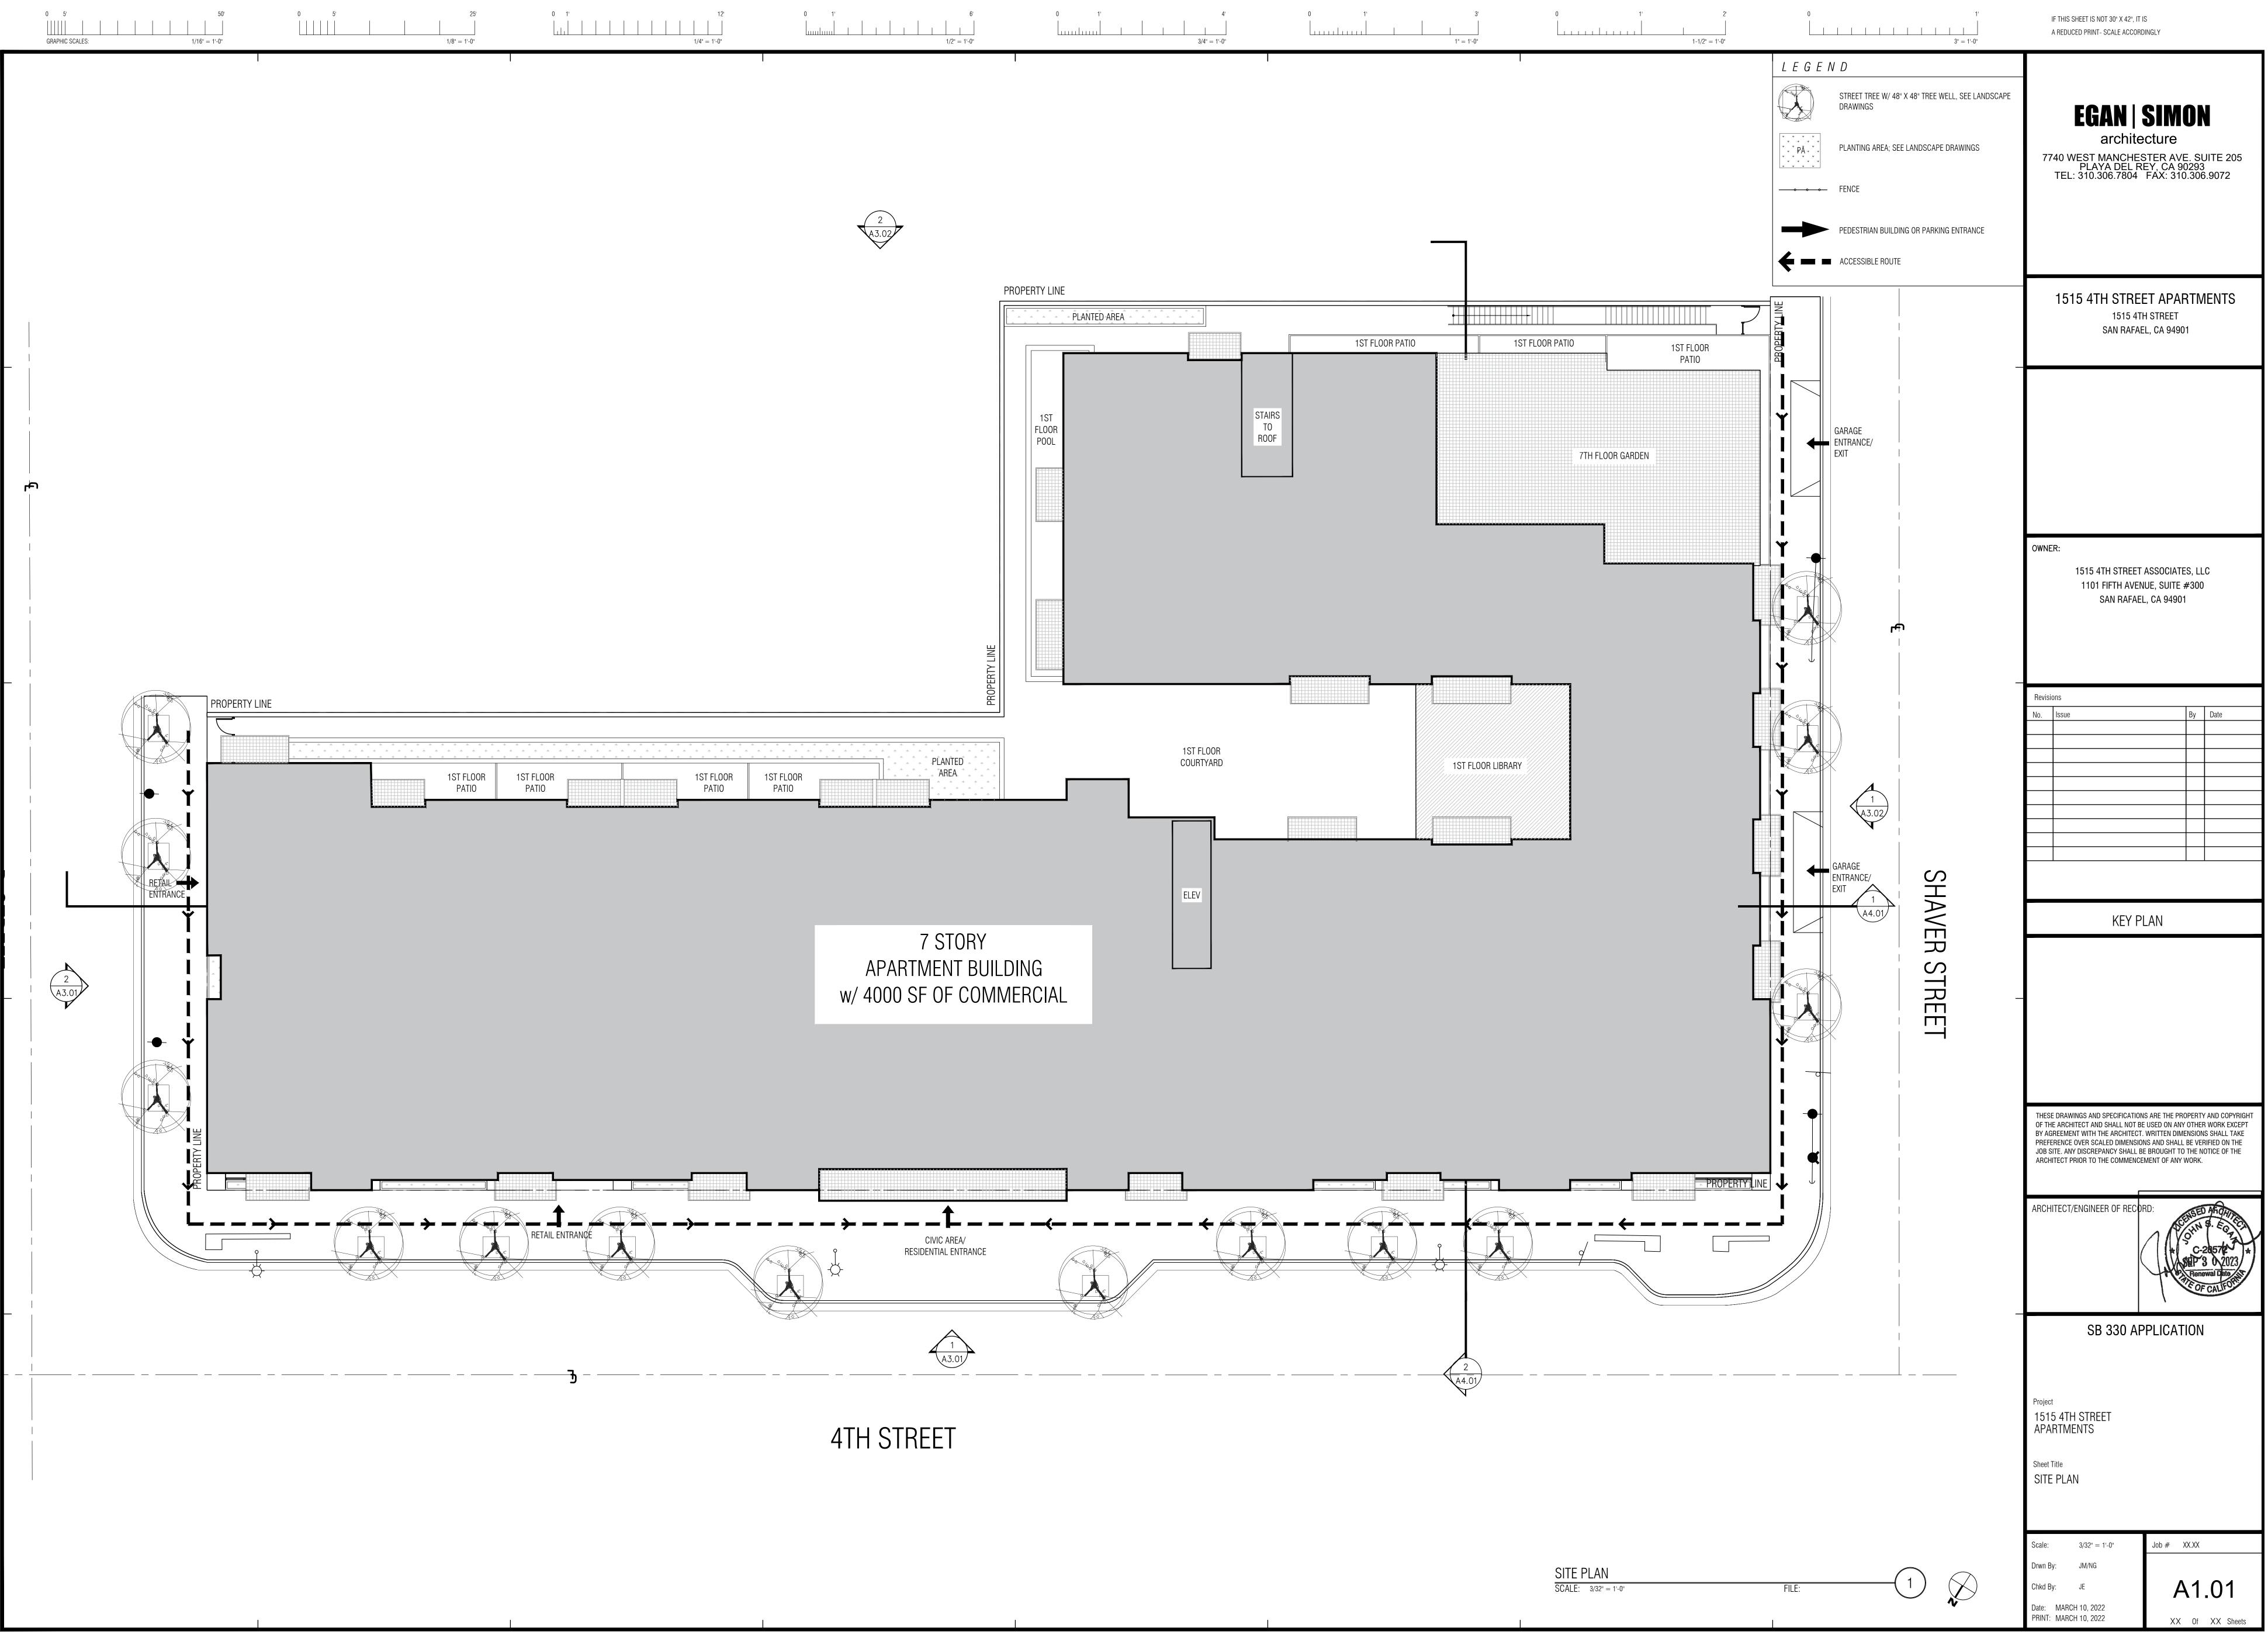

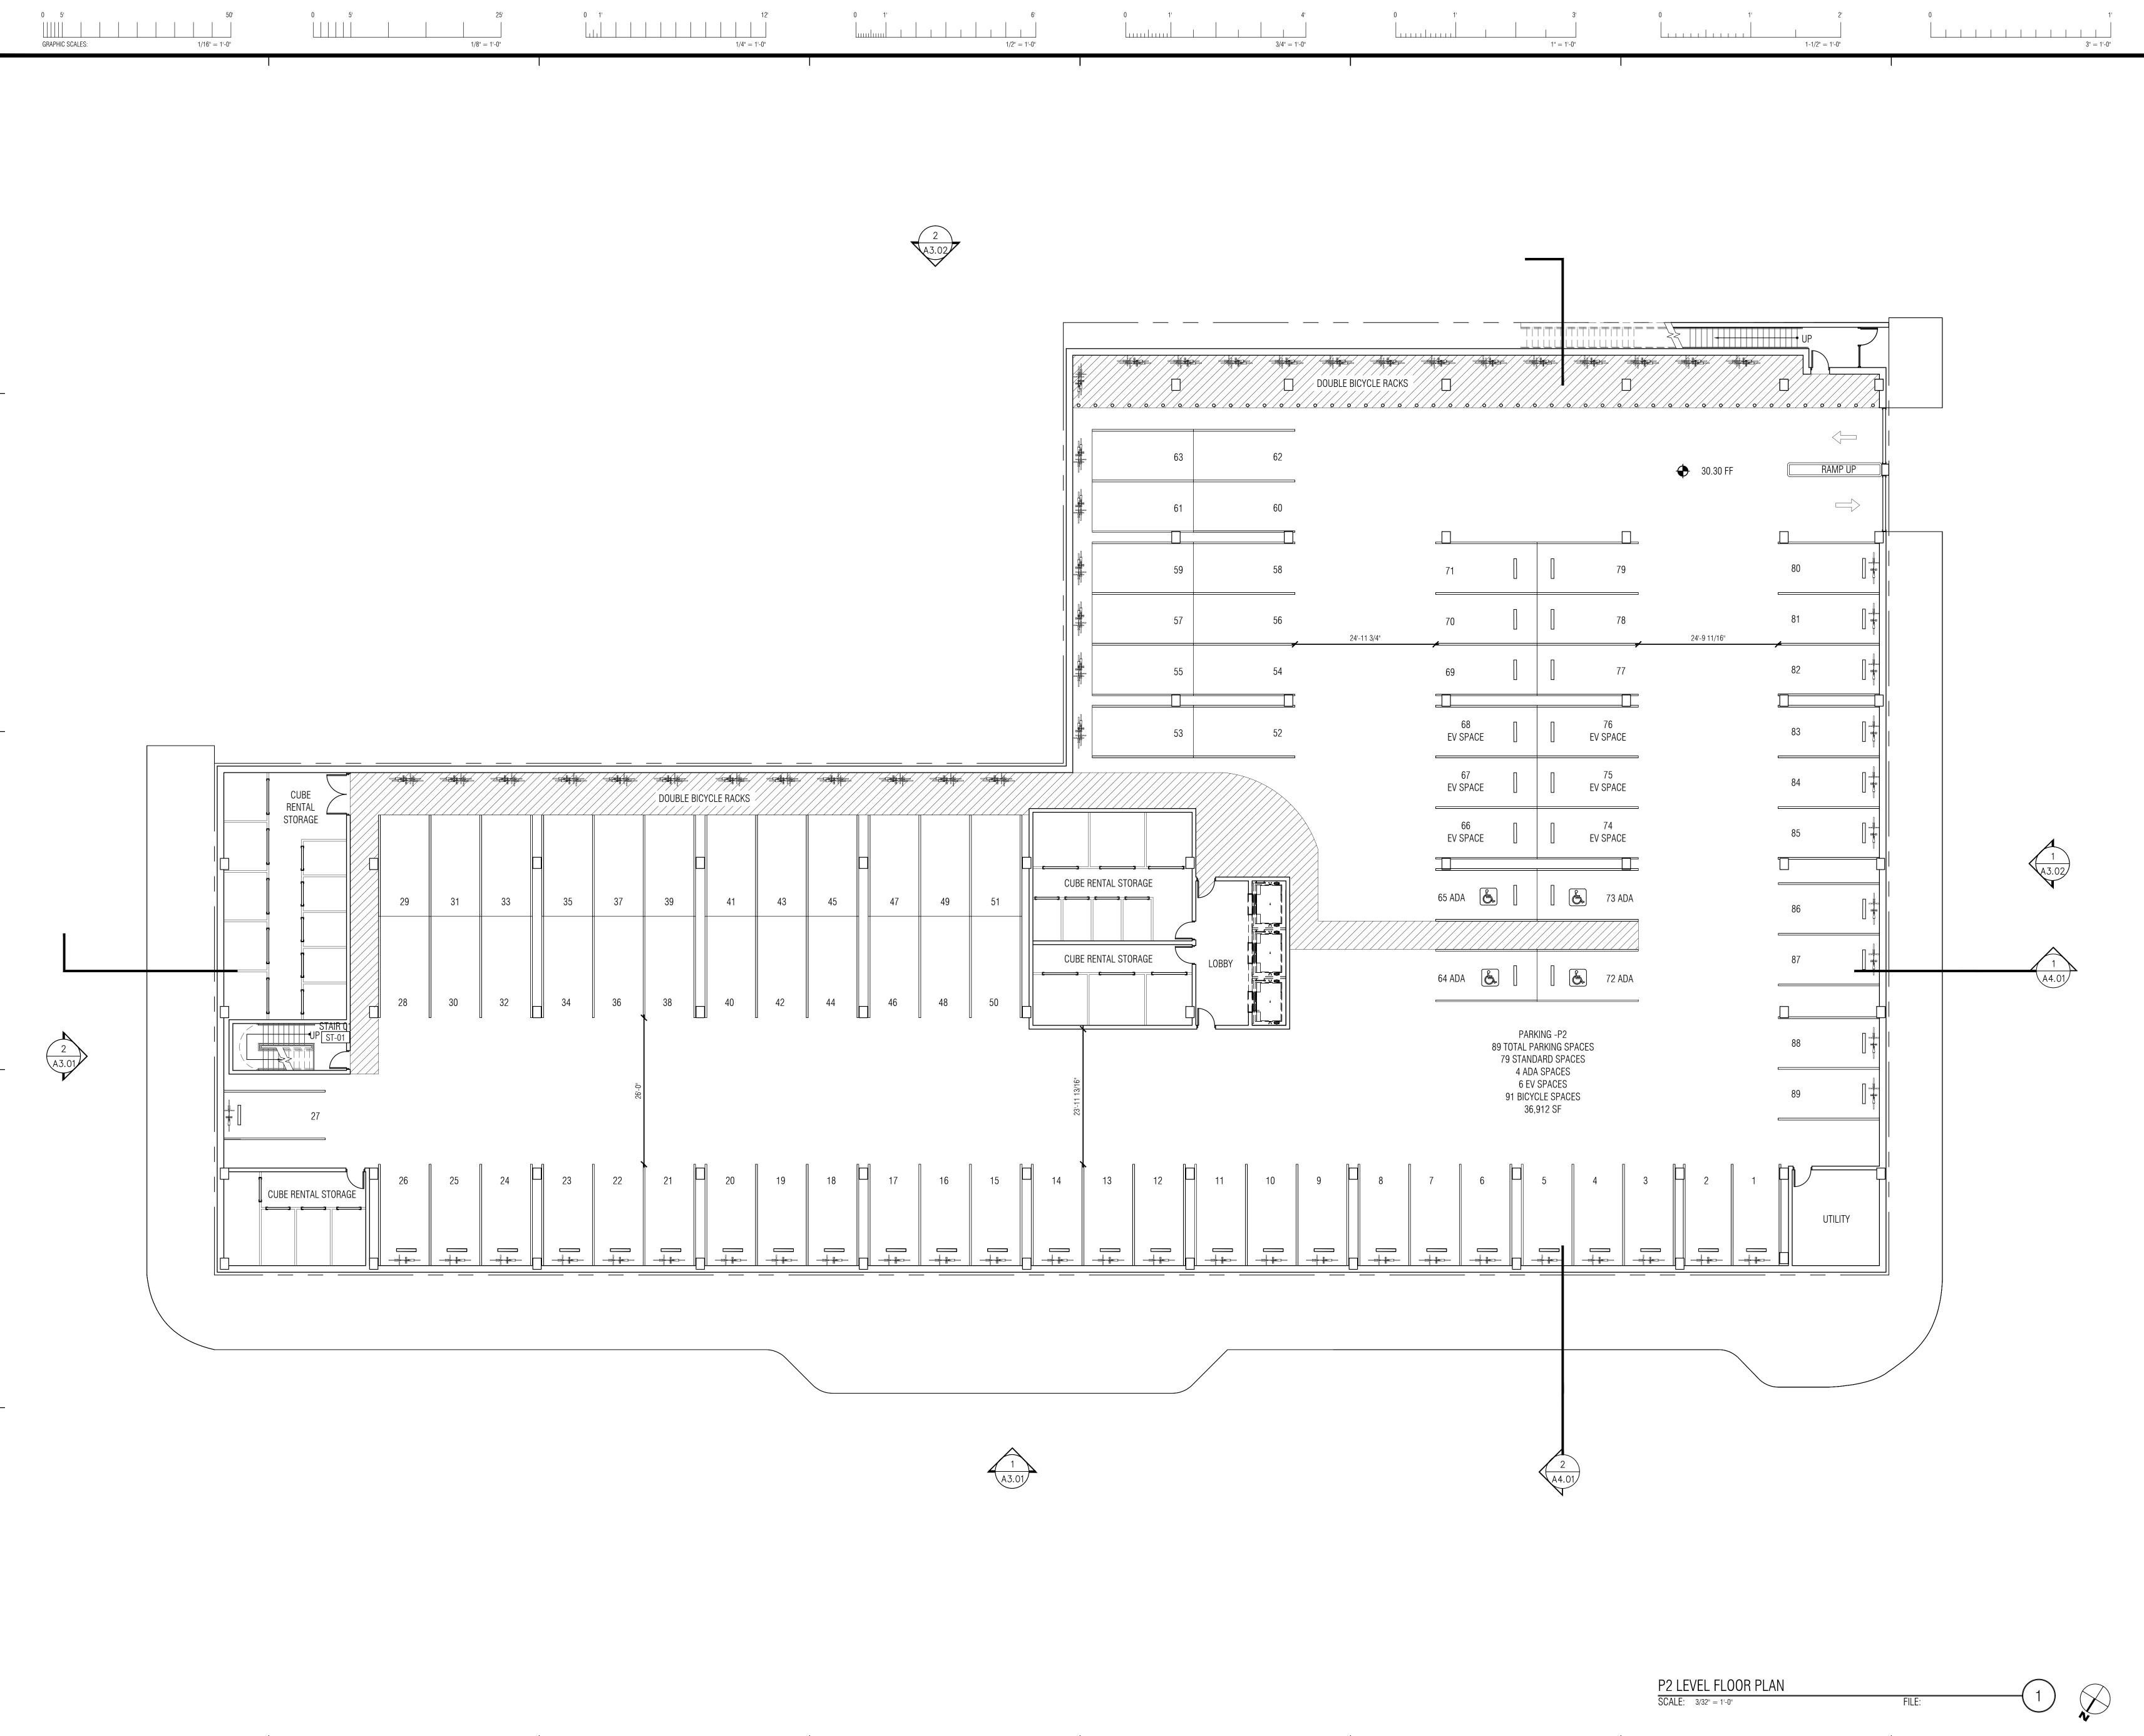



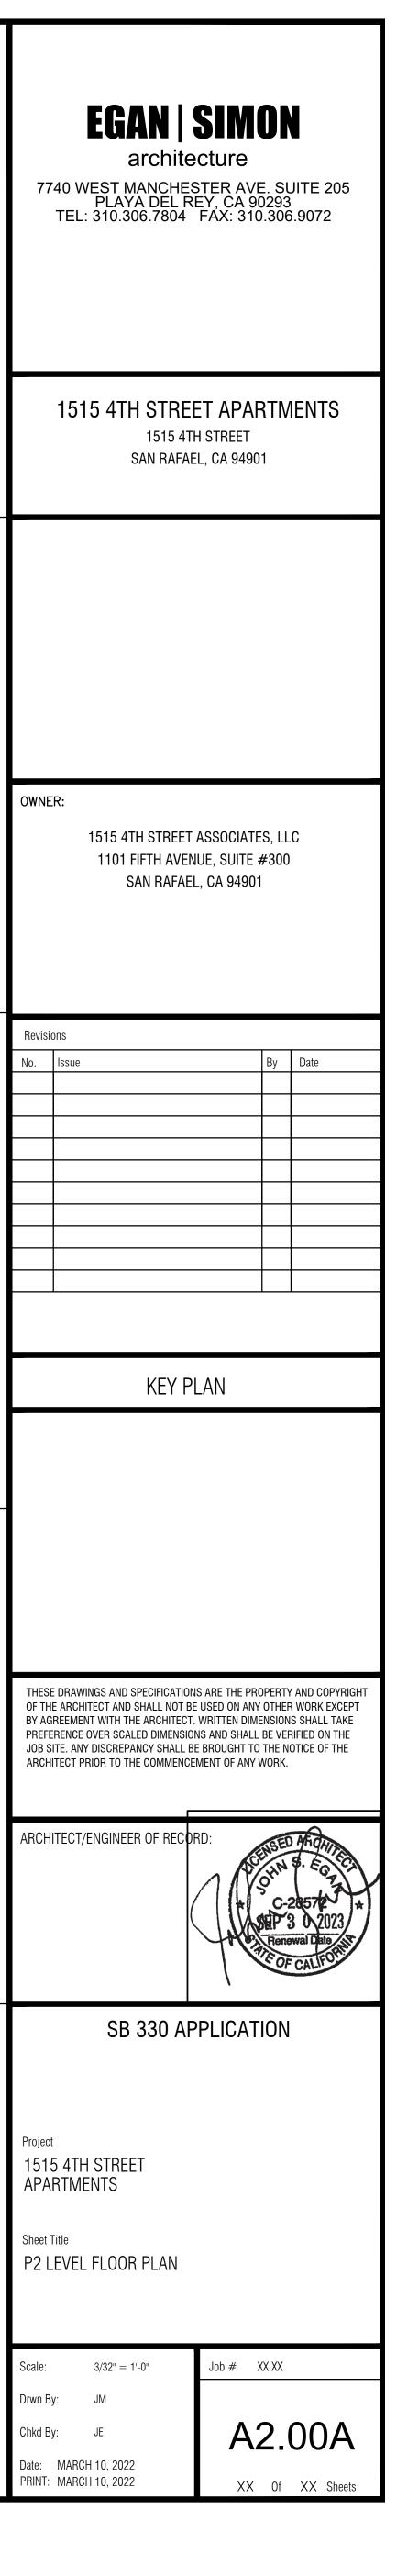

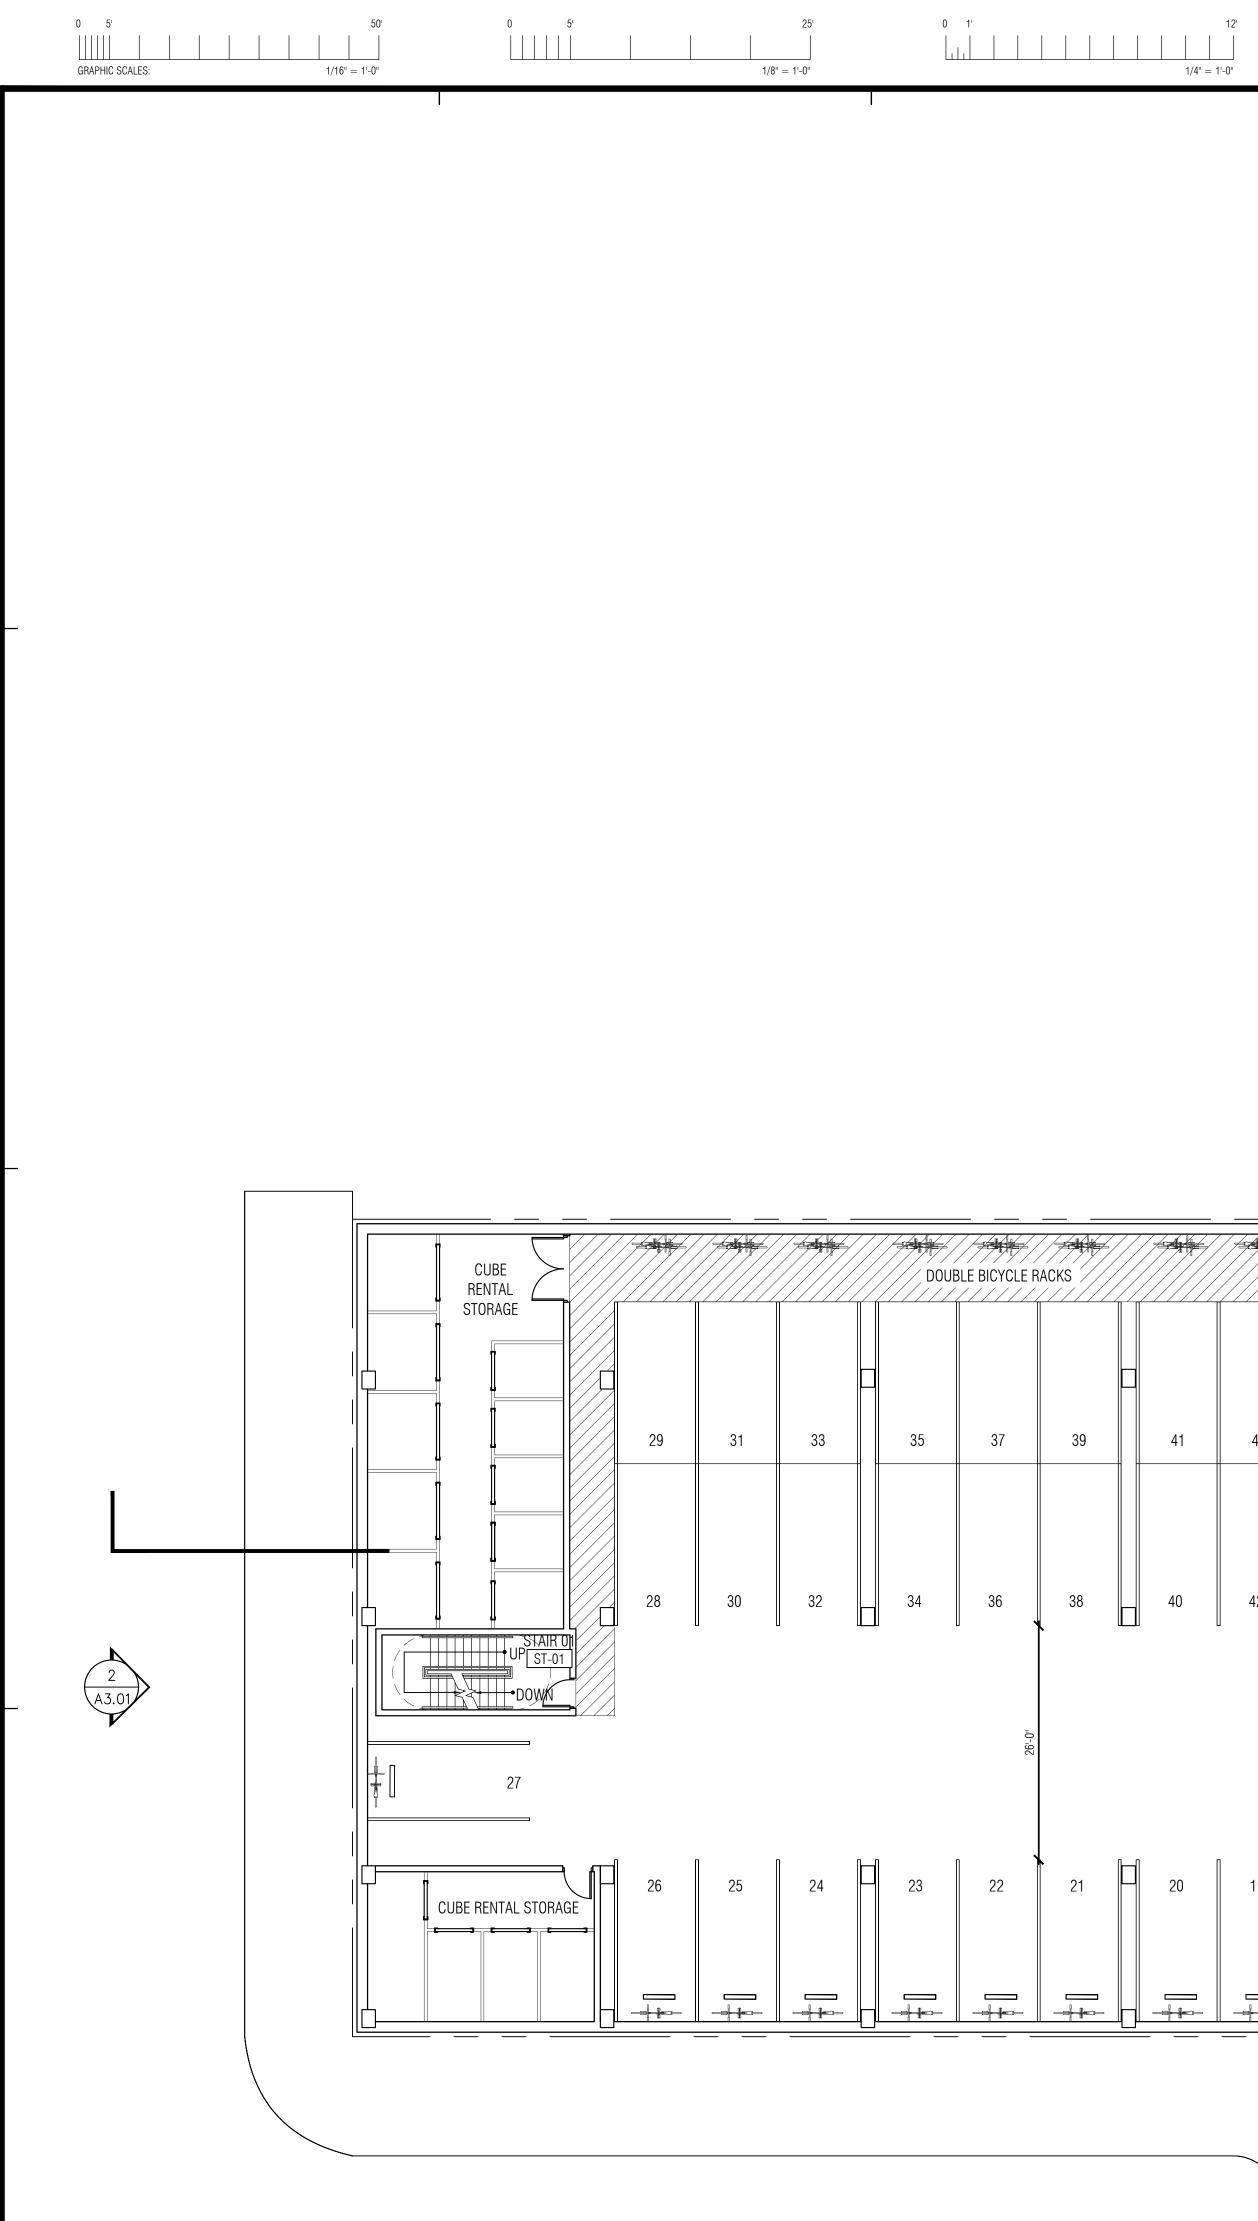


2 A3.02	7
	POOL ABOVE ABOVE BUIPMENT FV SPACE BUIPMENT FV SPACE BUIPMENT FV SPACE FV S
	CUBE RENTAL STORAGE TRASH/RECYCLE

0 1' 6' ______ 1/2" = 1'-0"

0 1' 4' |_____


3/4" = 1'-0"




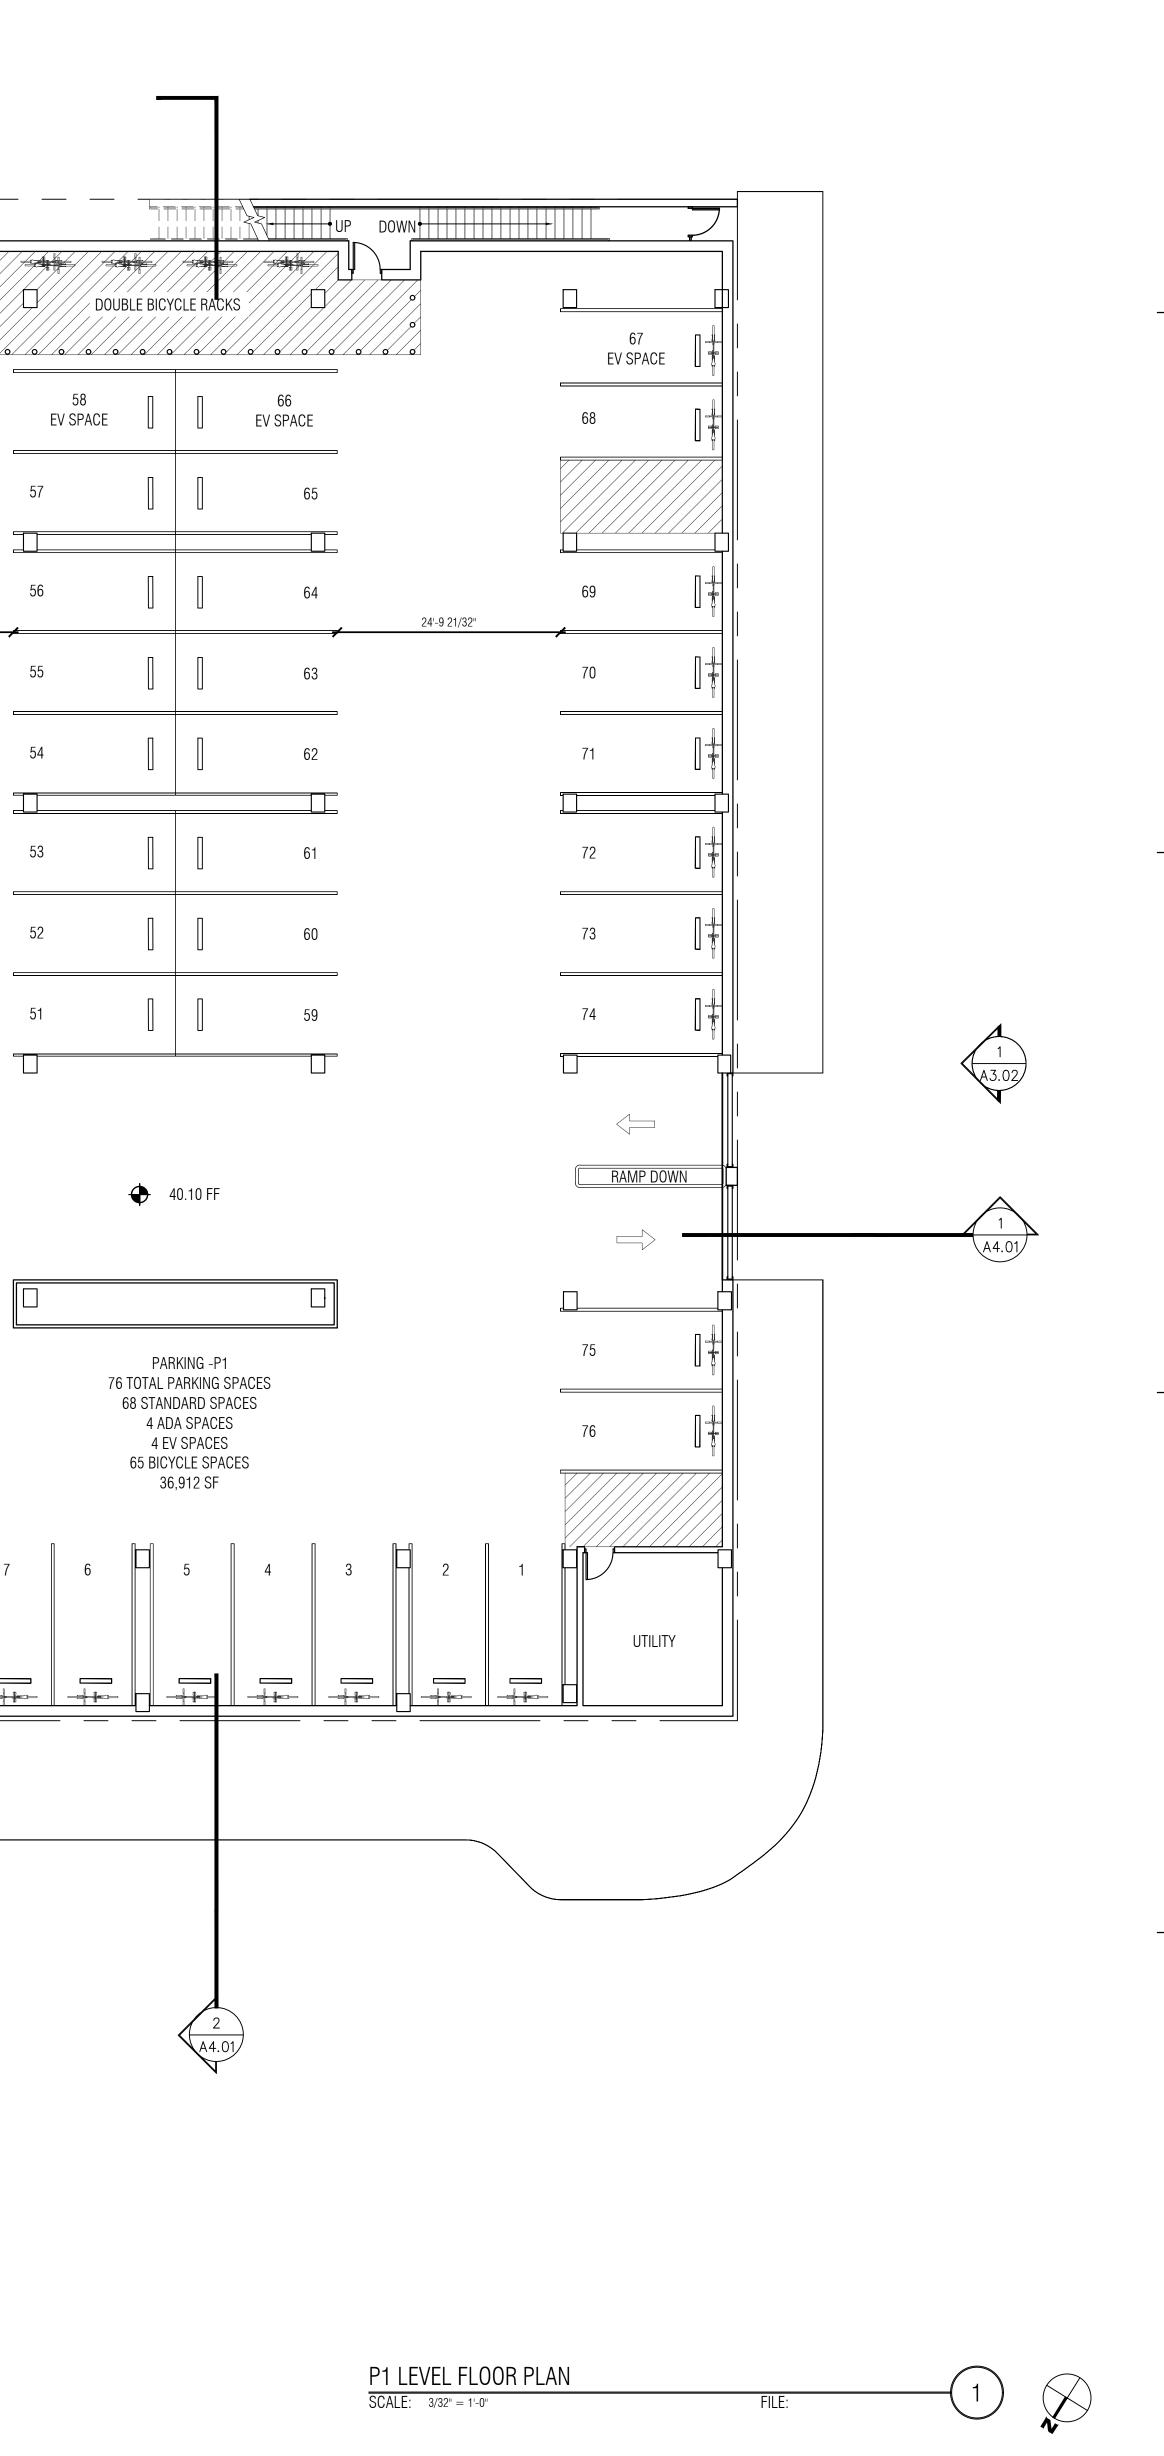



1-1/2" = 1'-0"


<u>3" = 1'-0"</u>

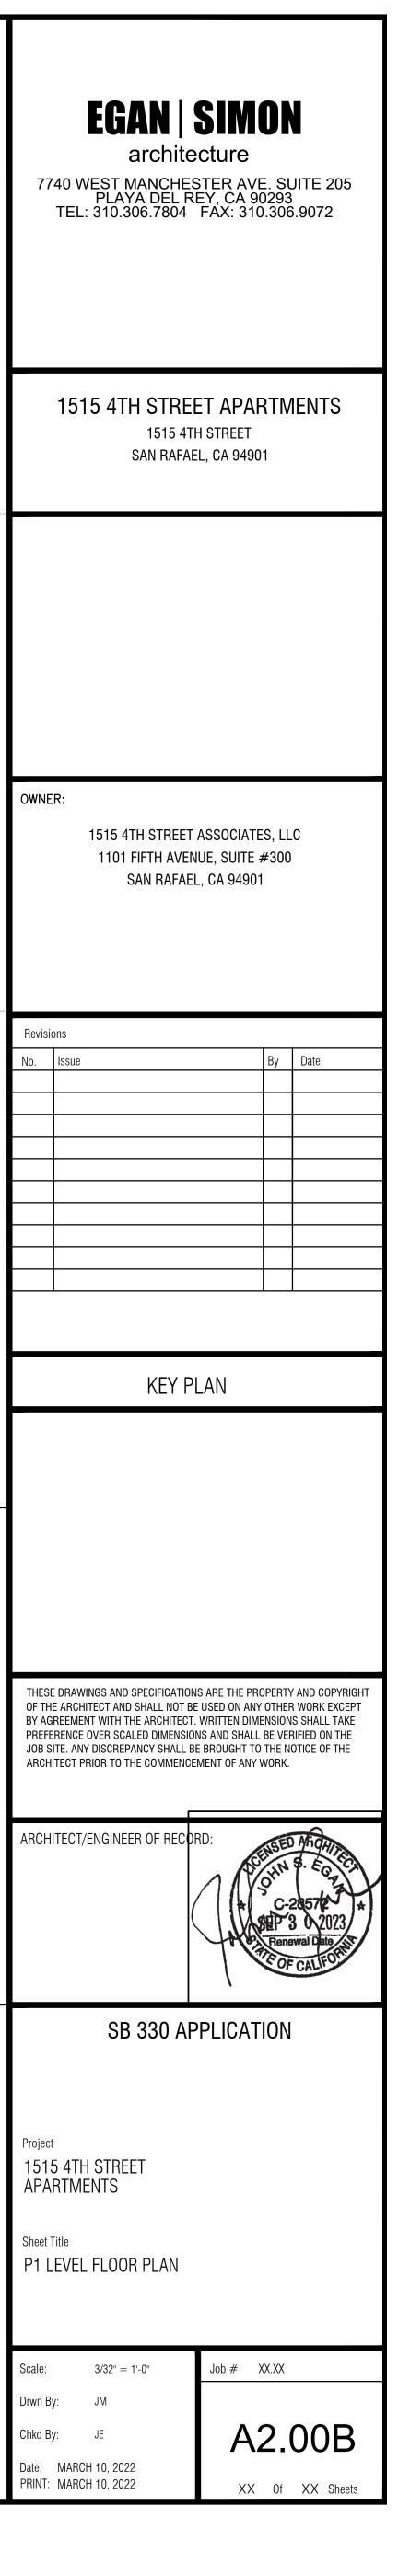


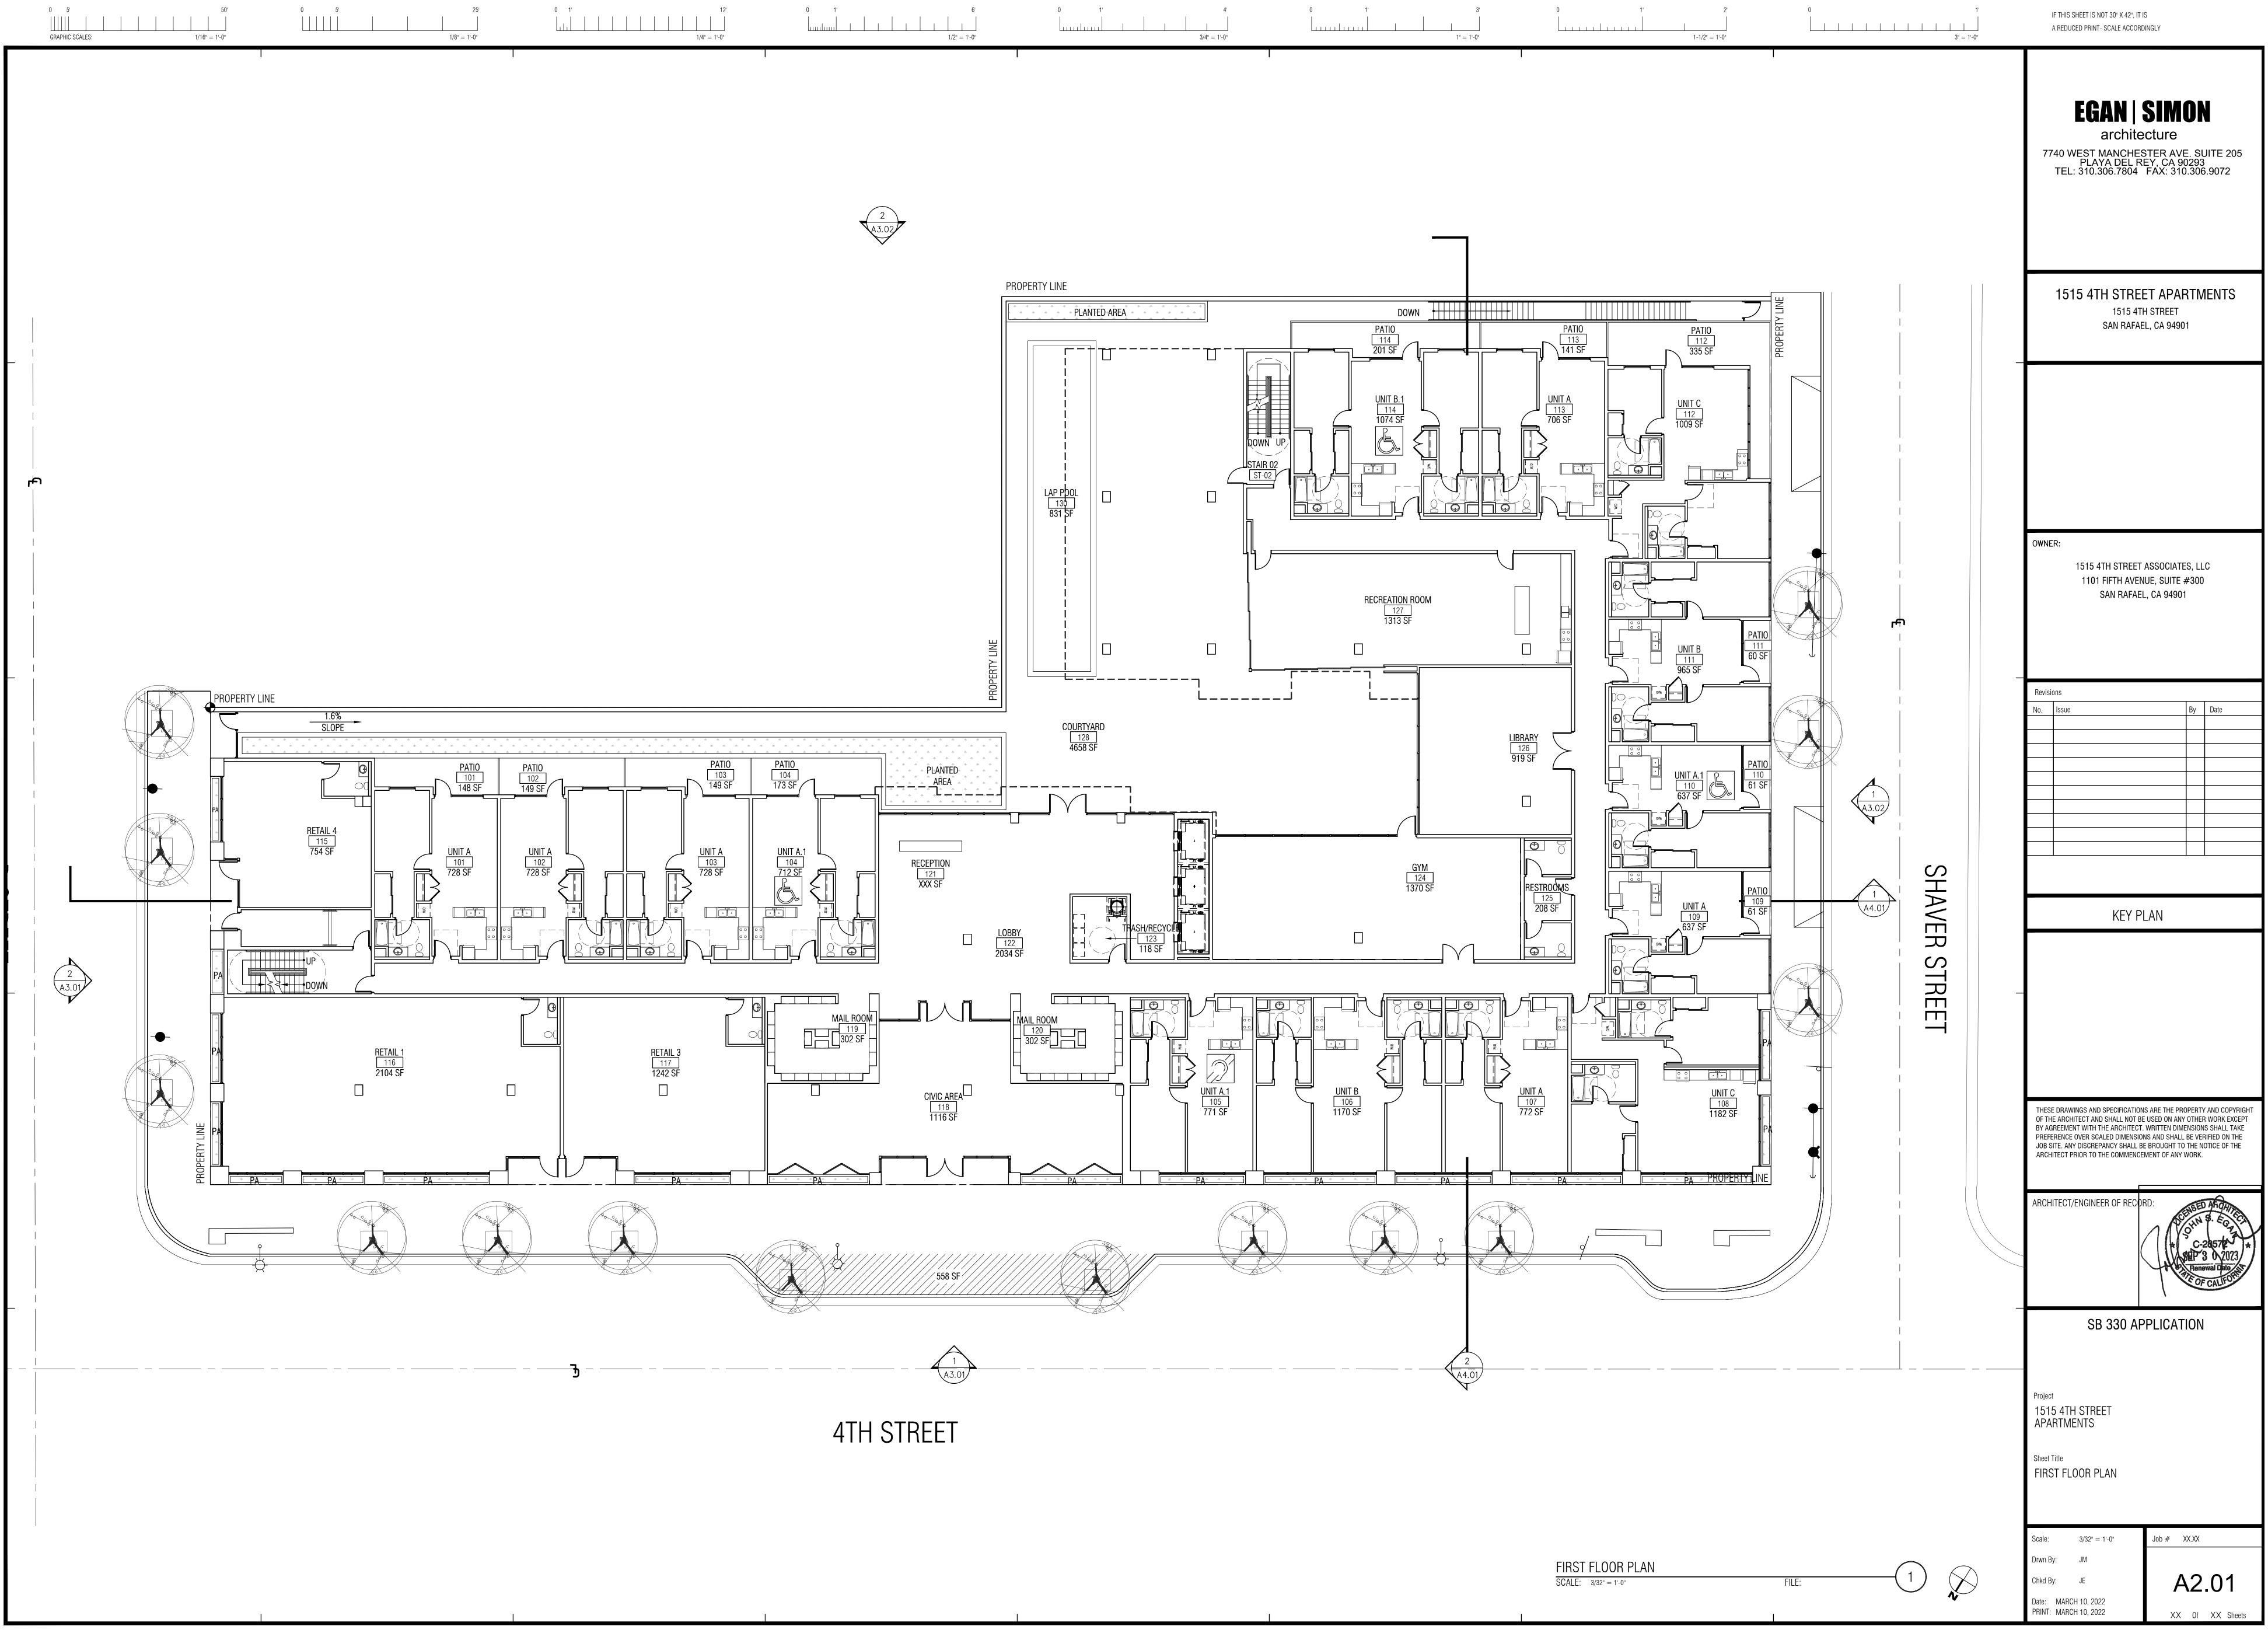


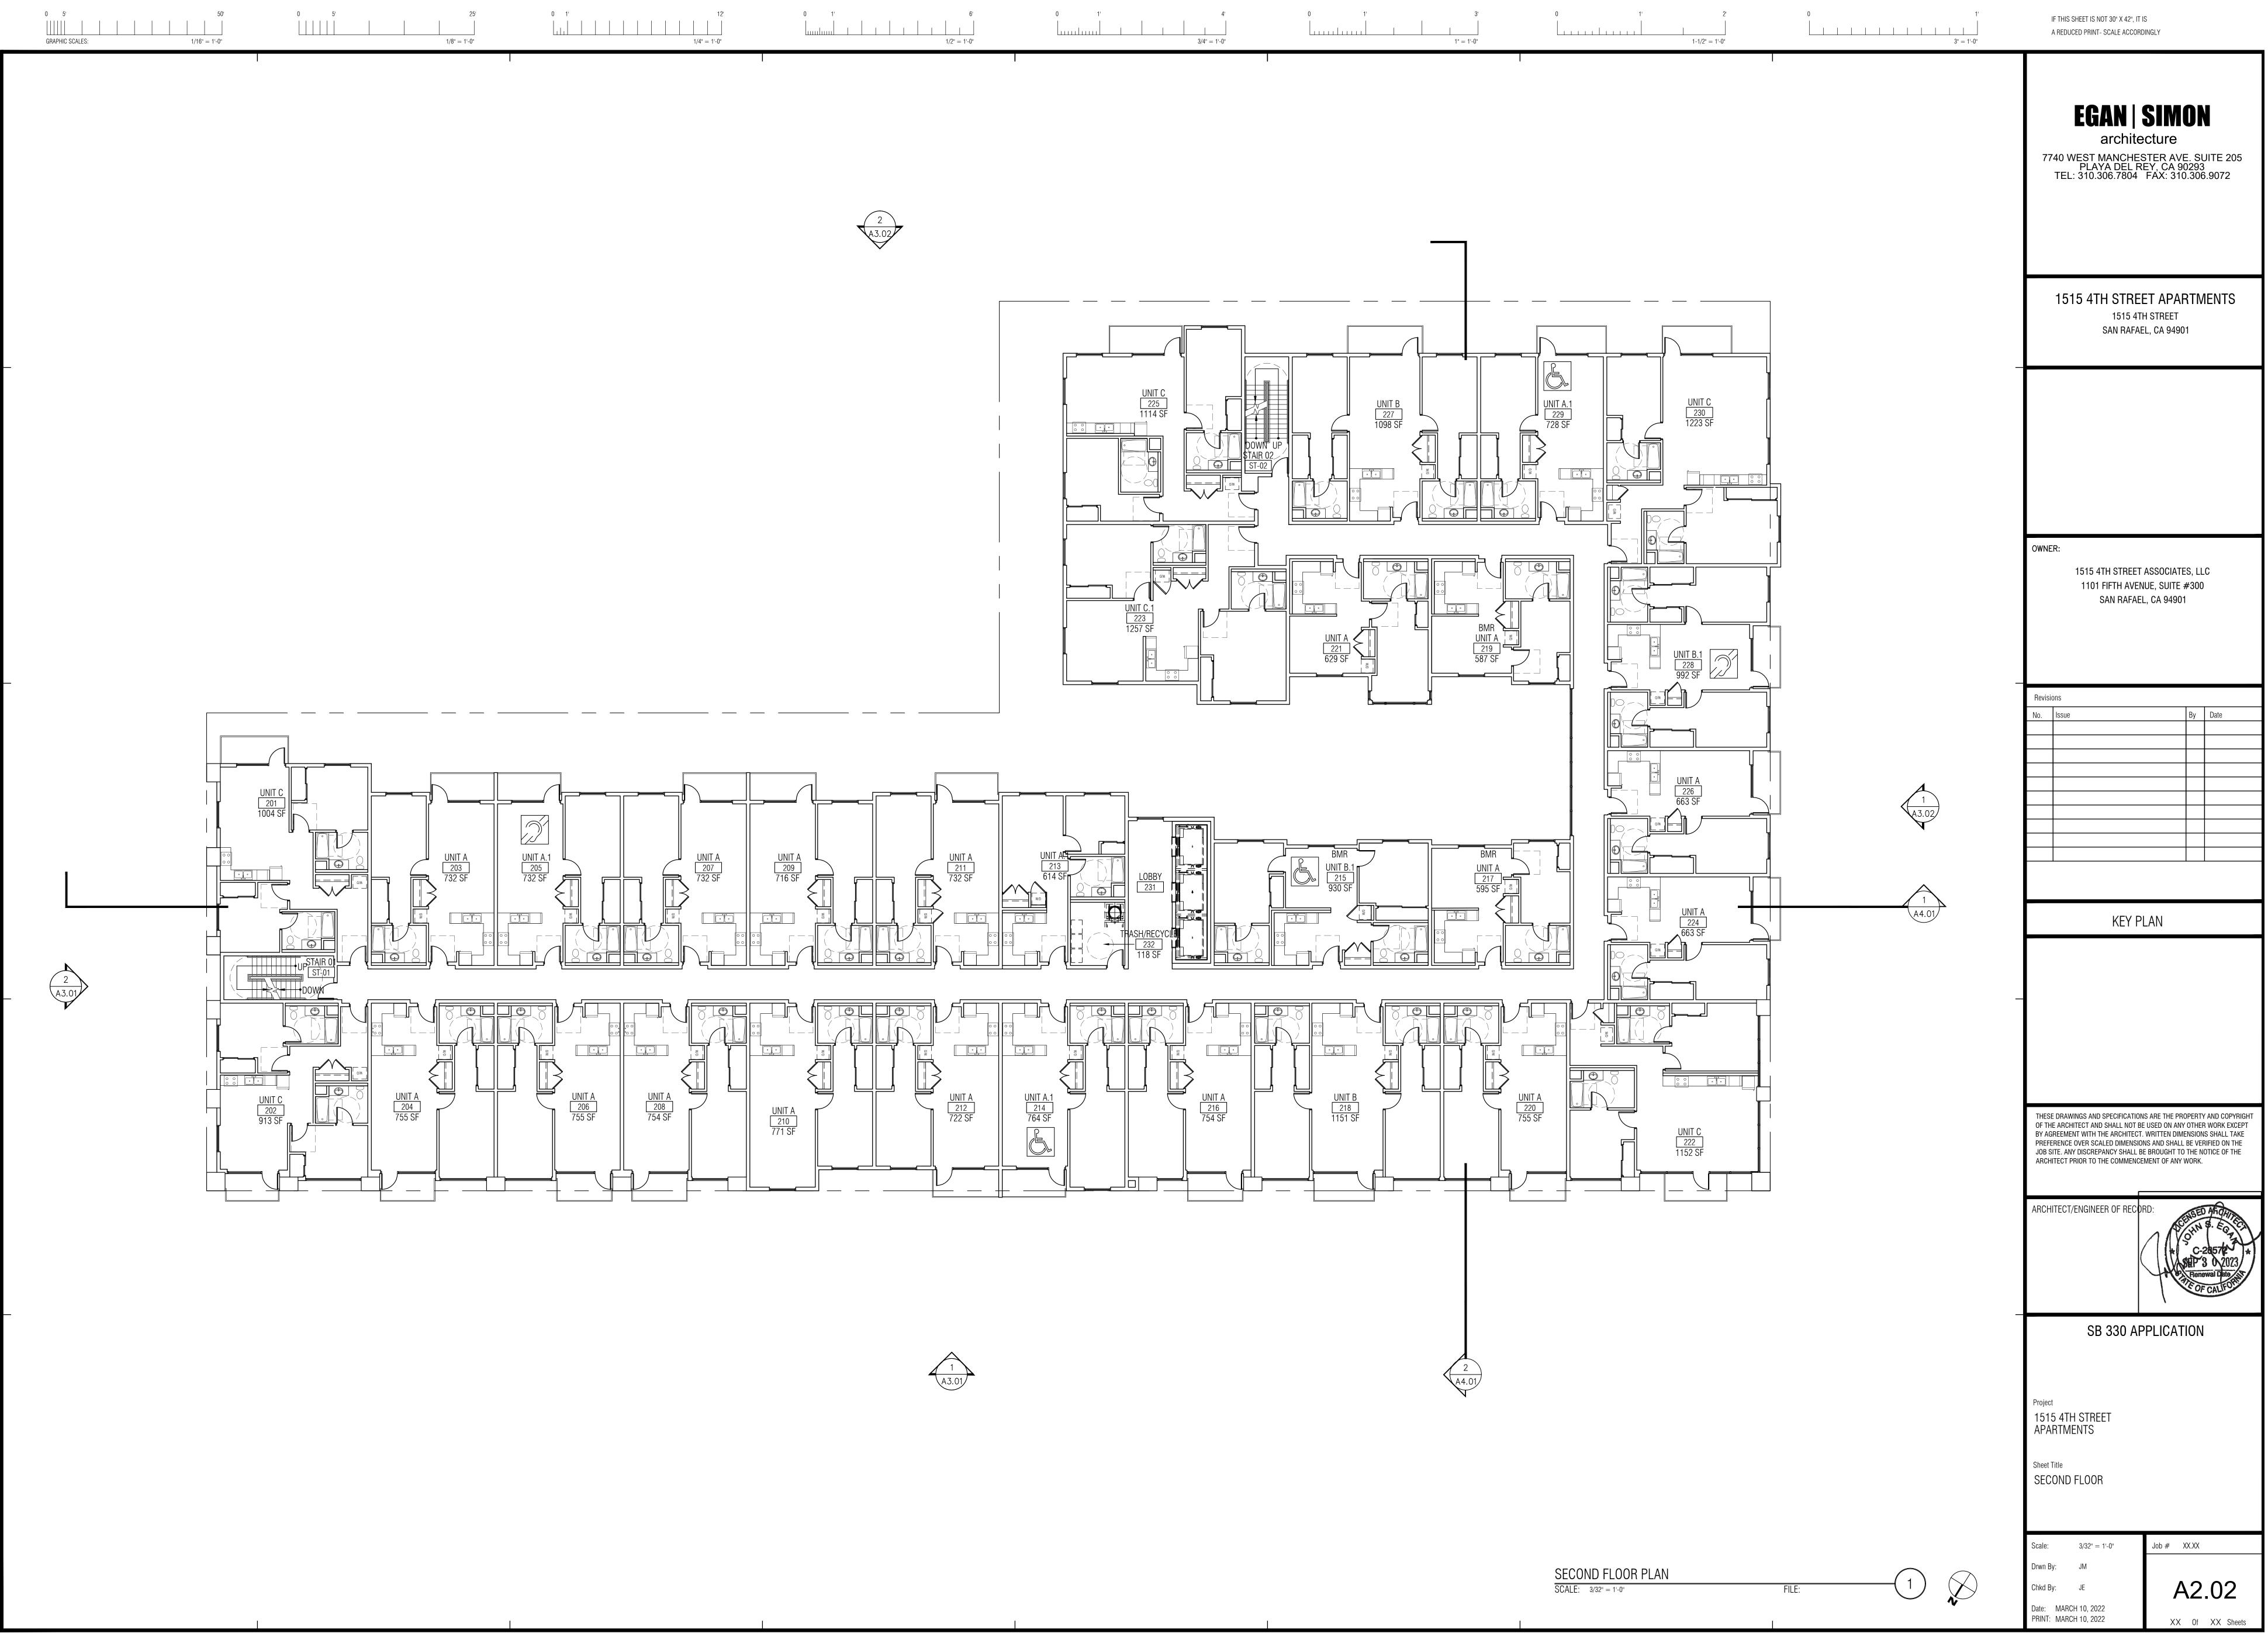


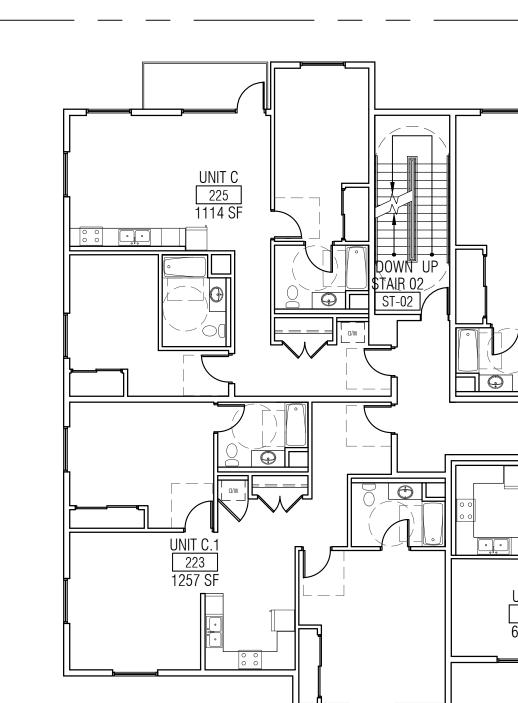


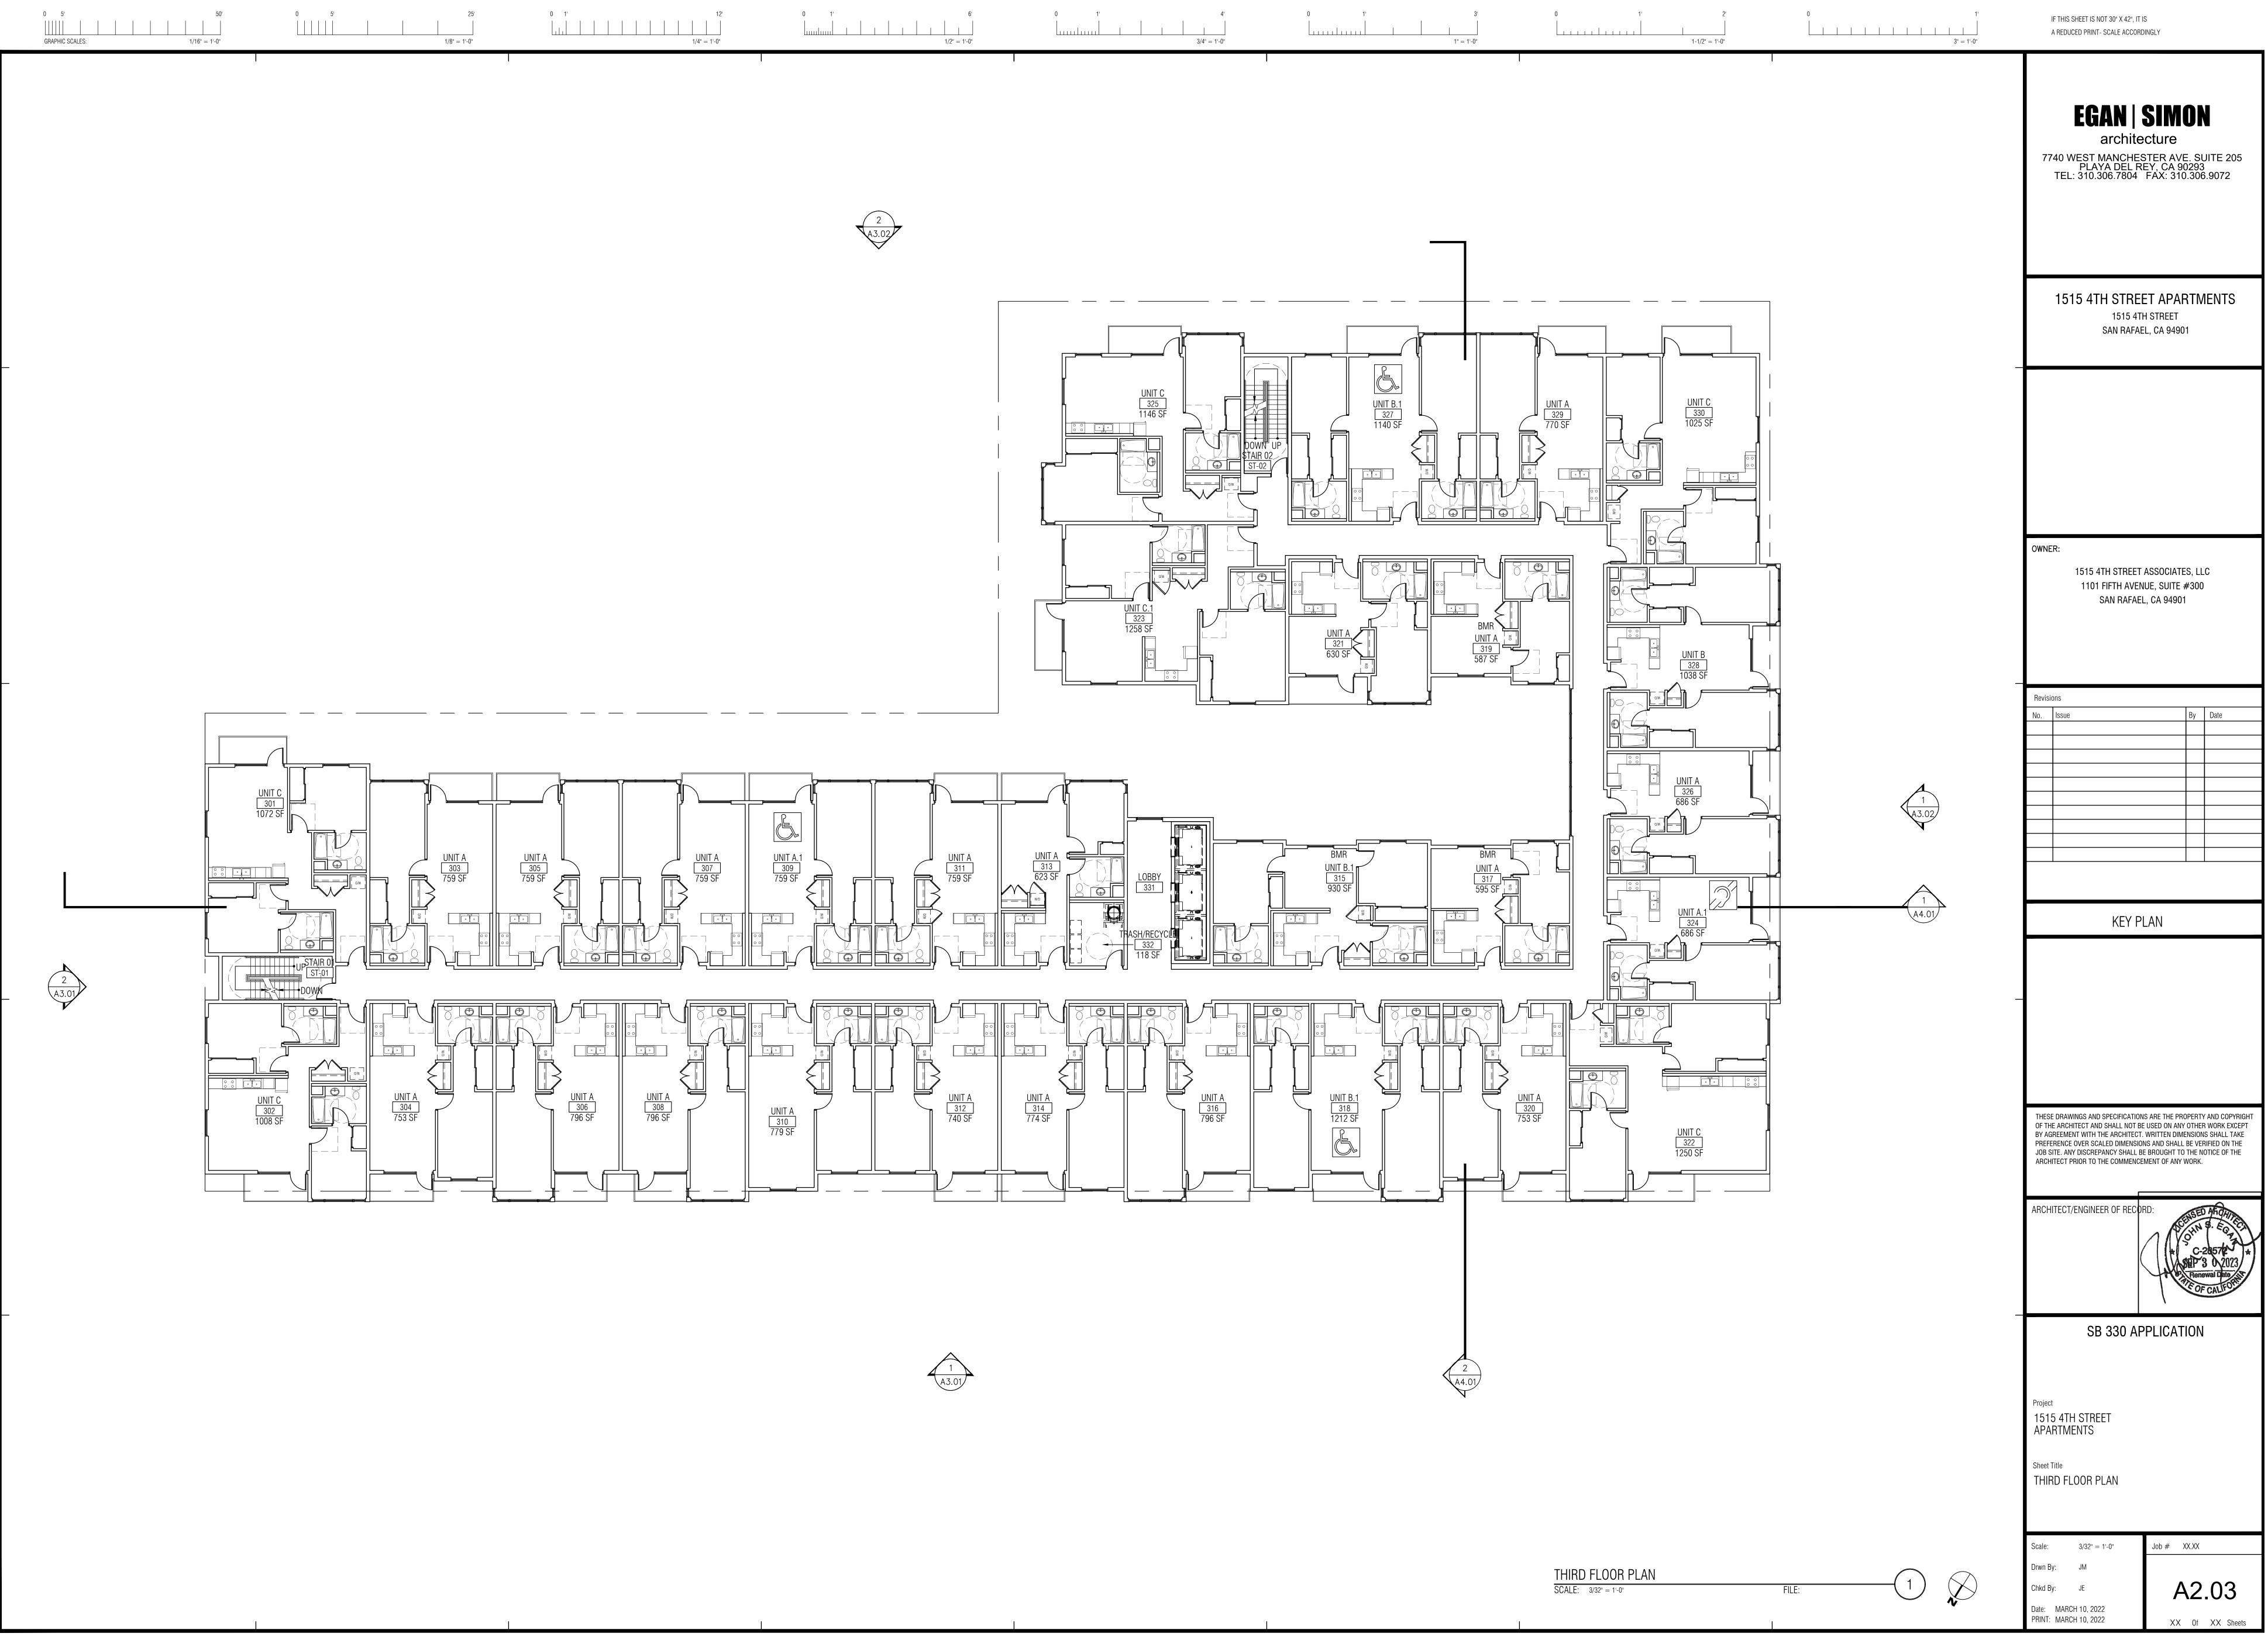


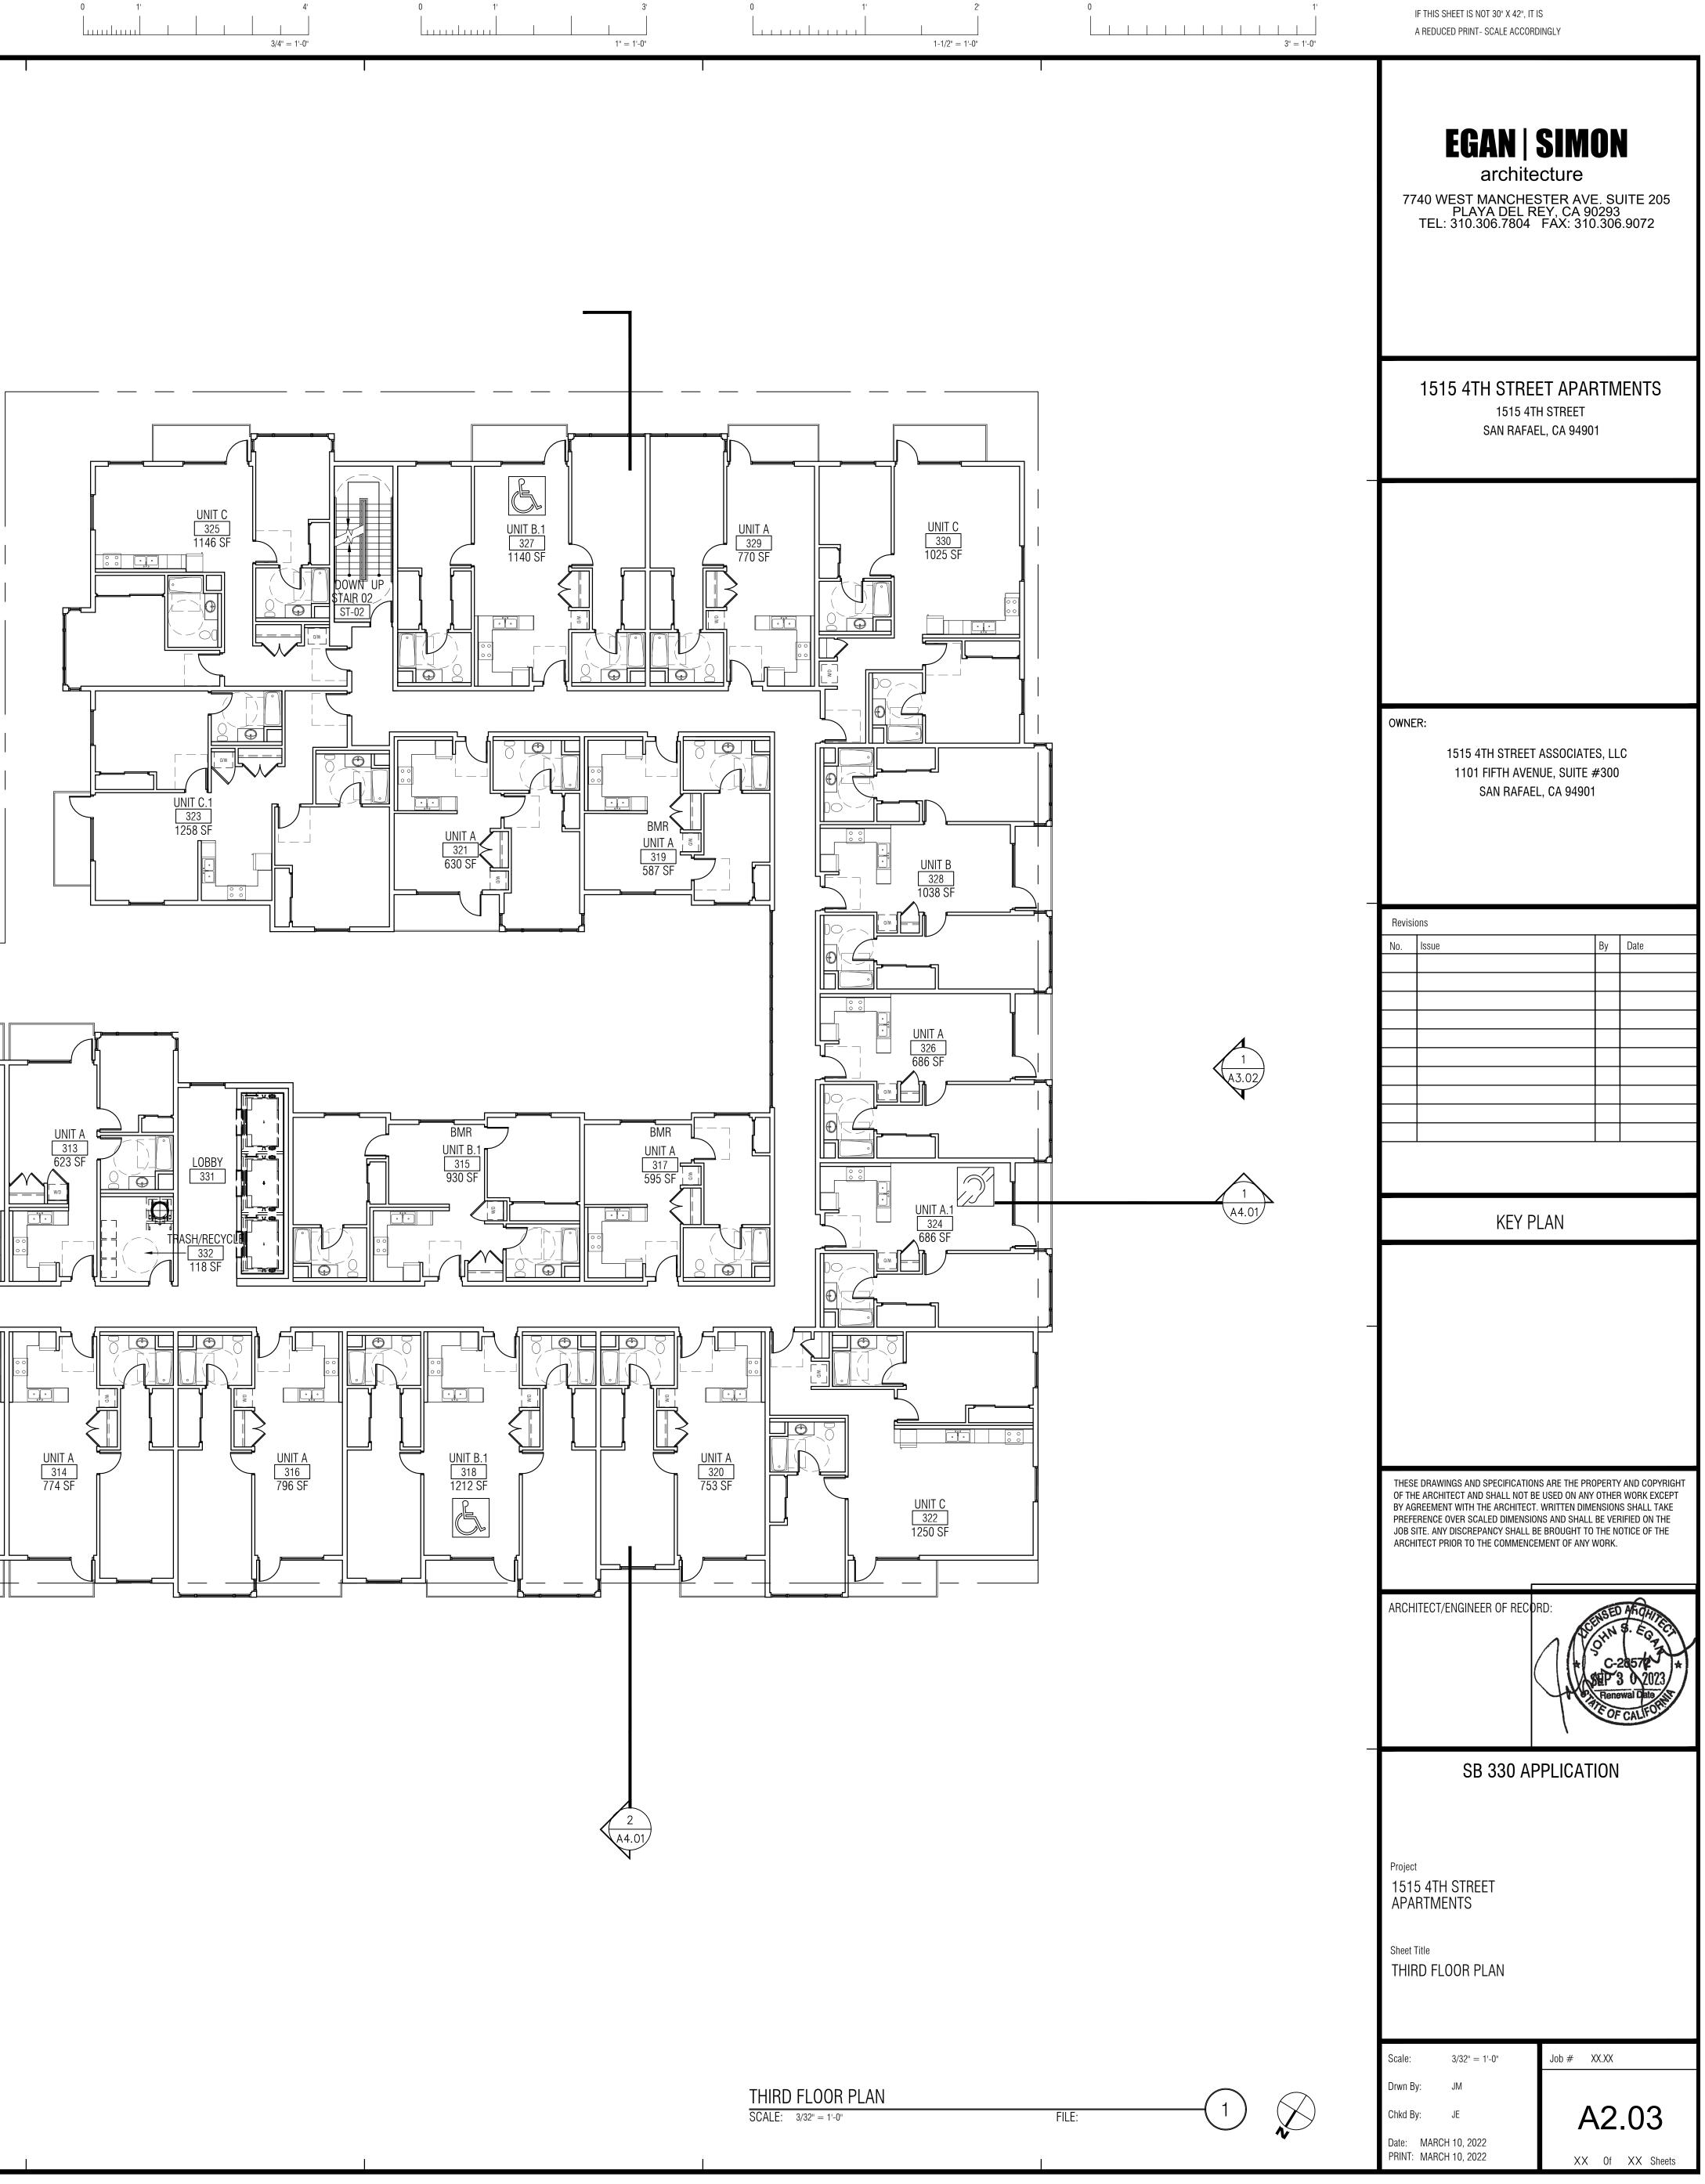


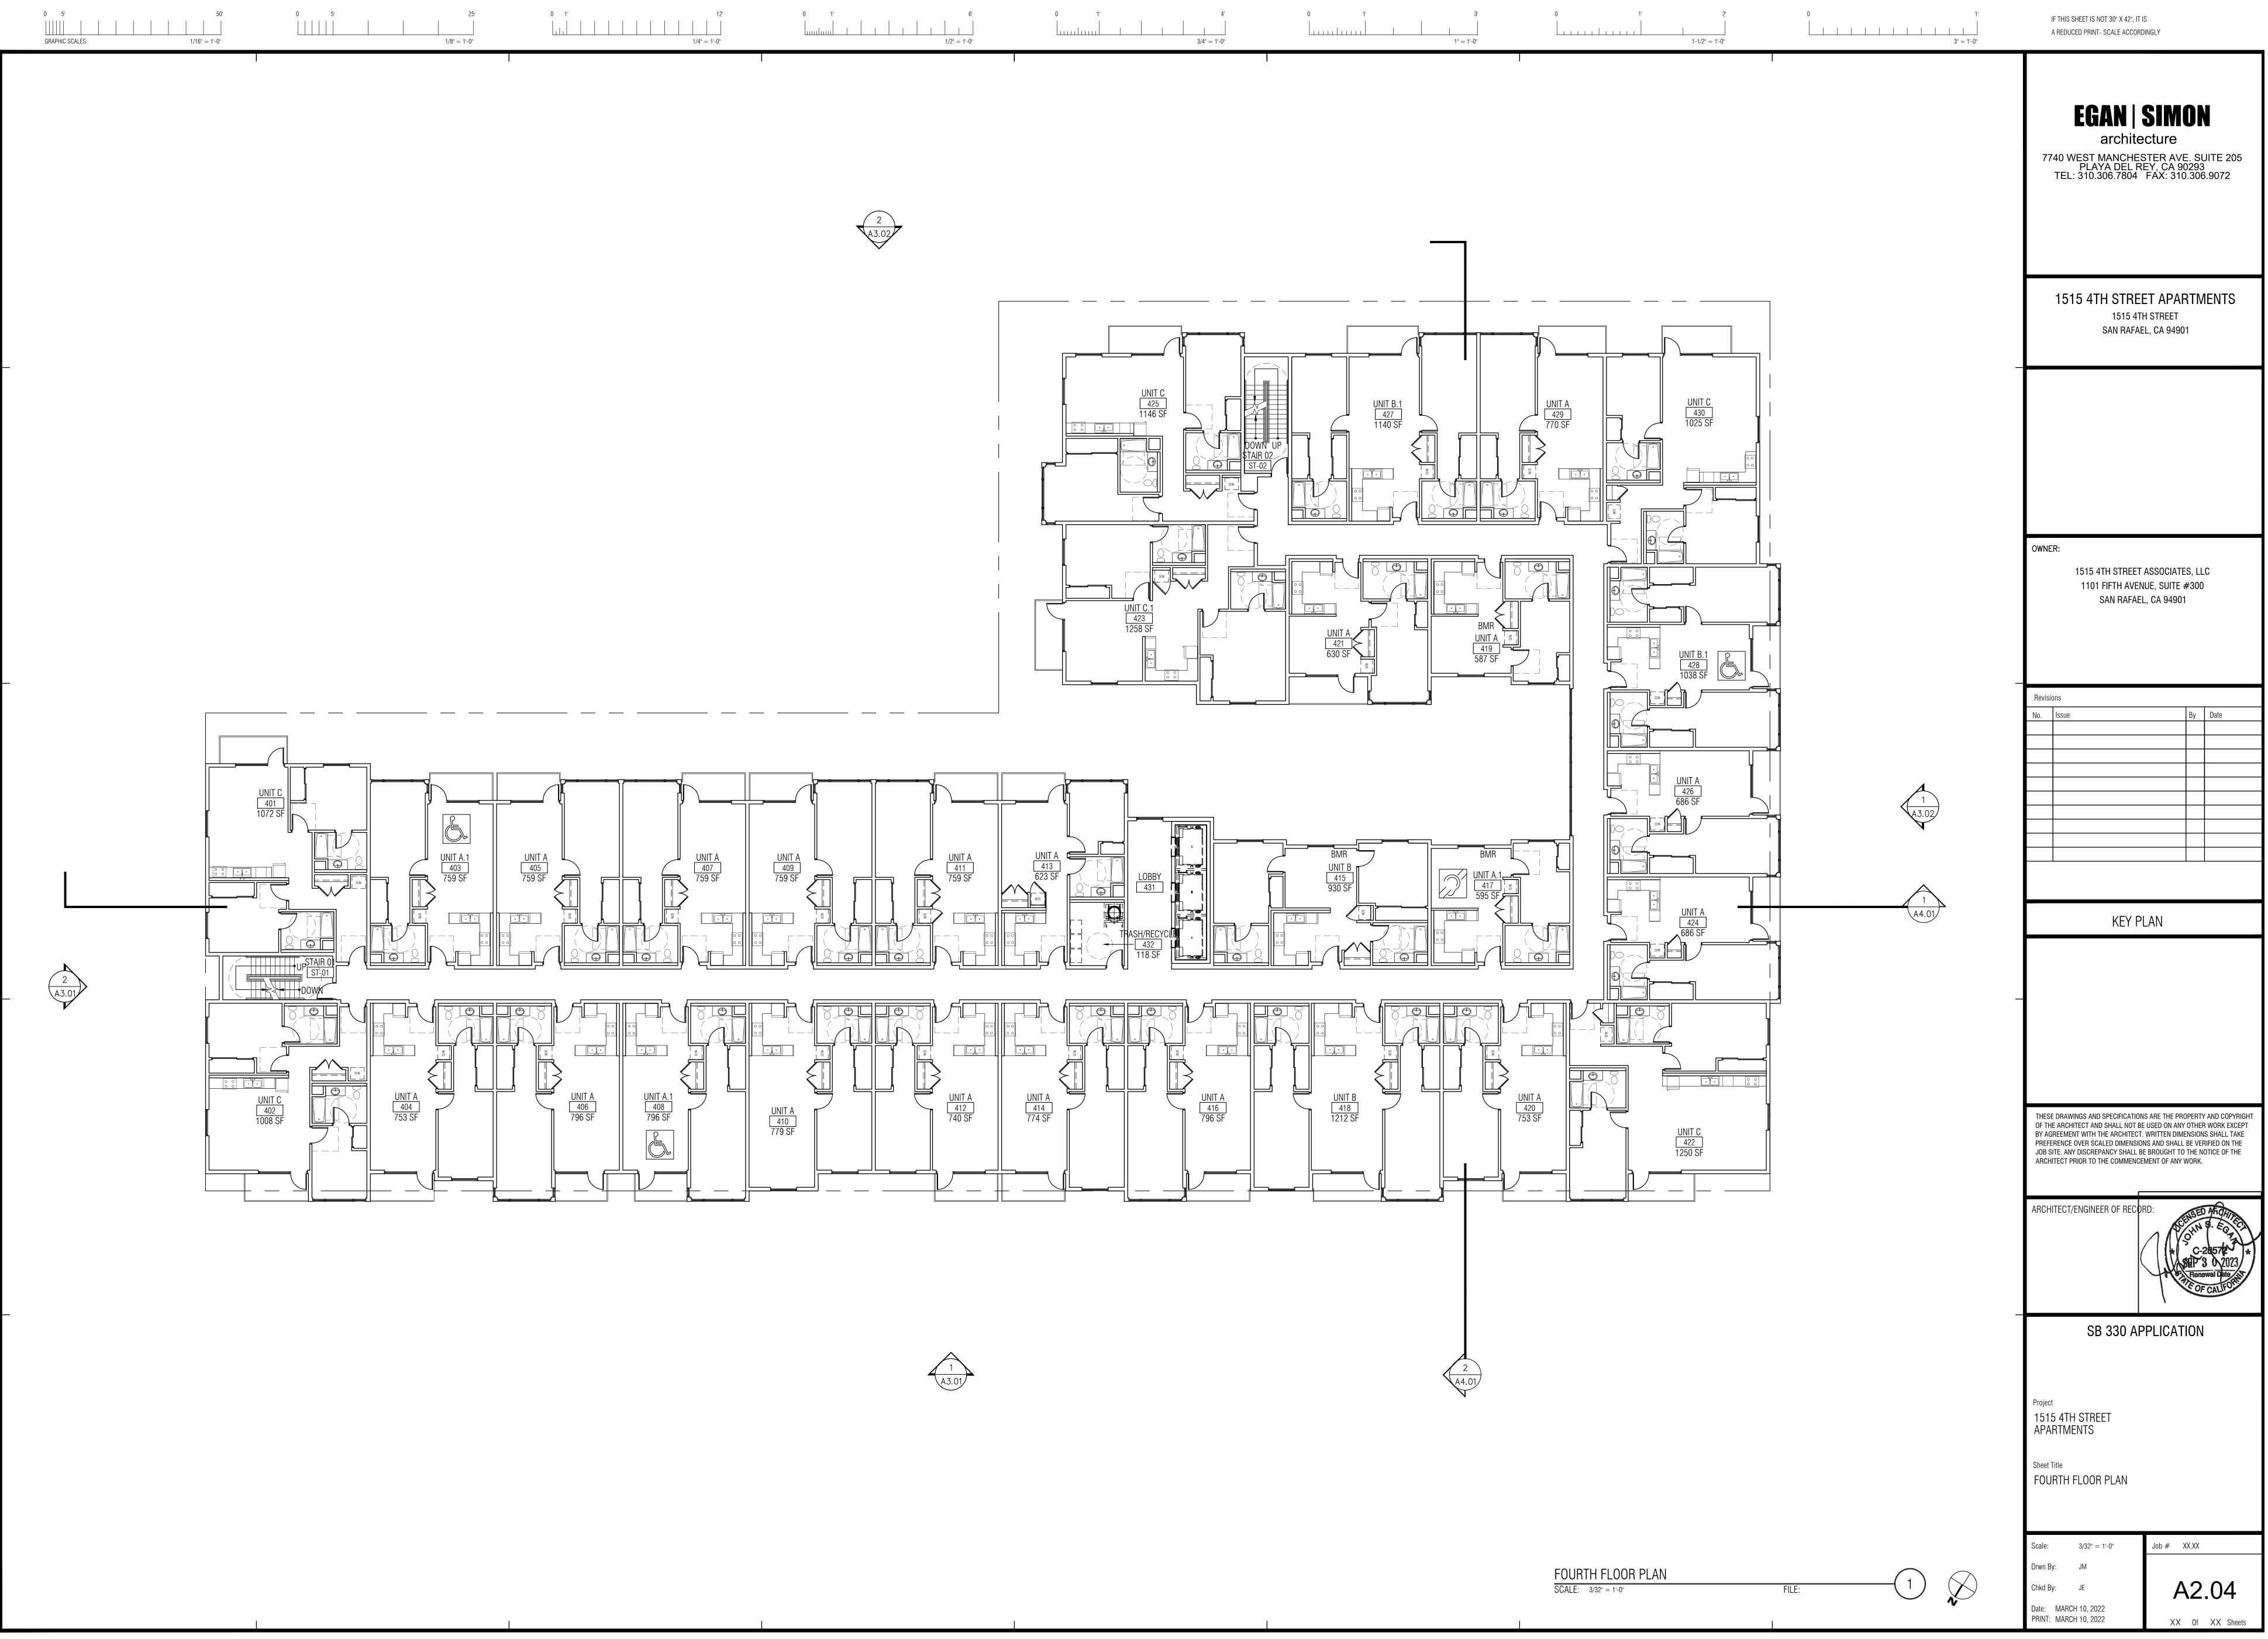


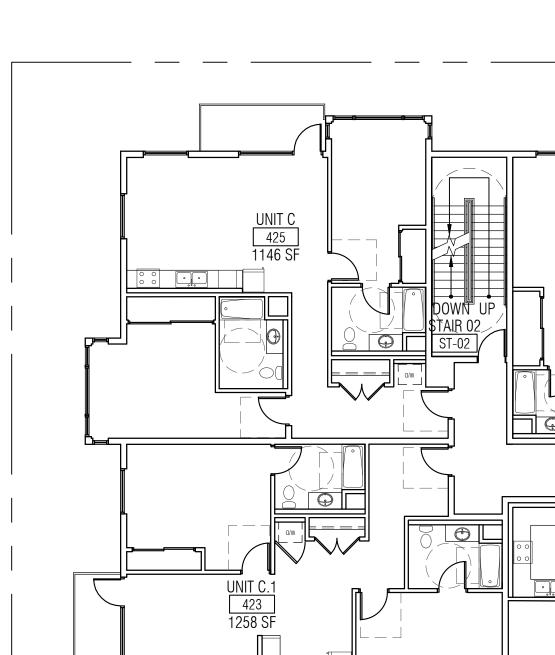


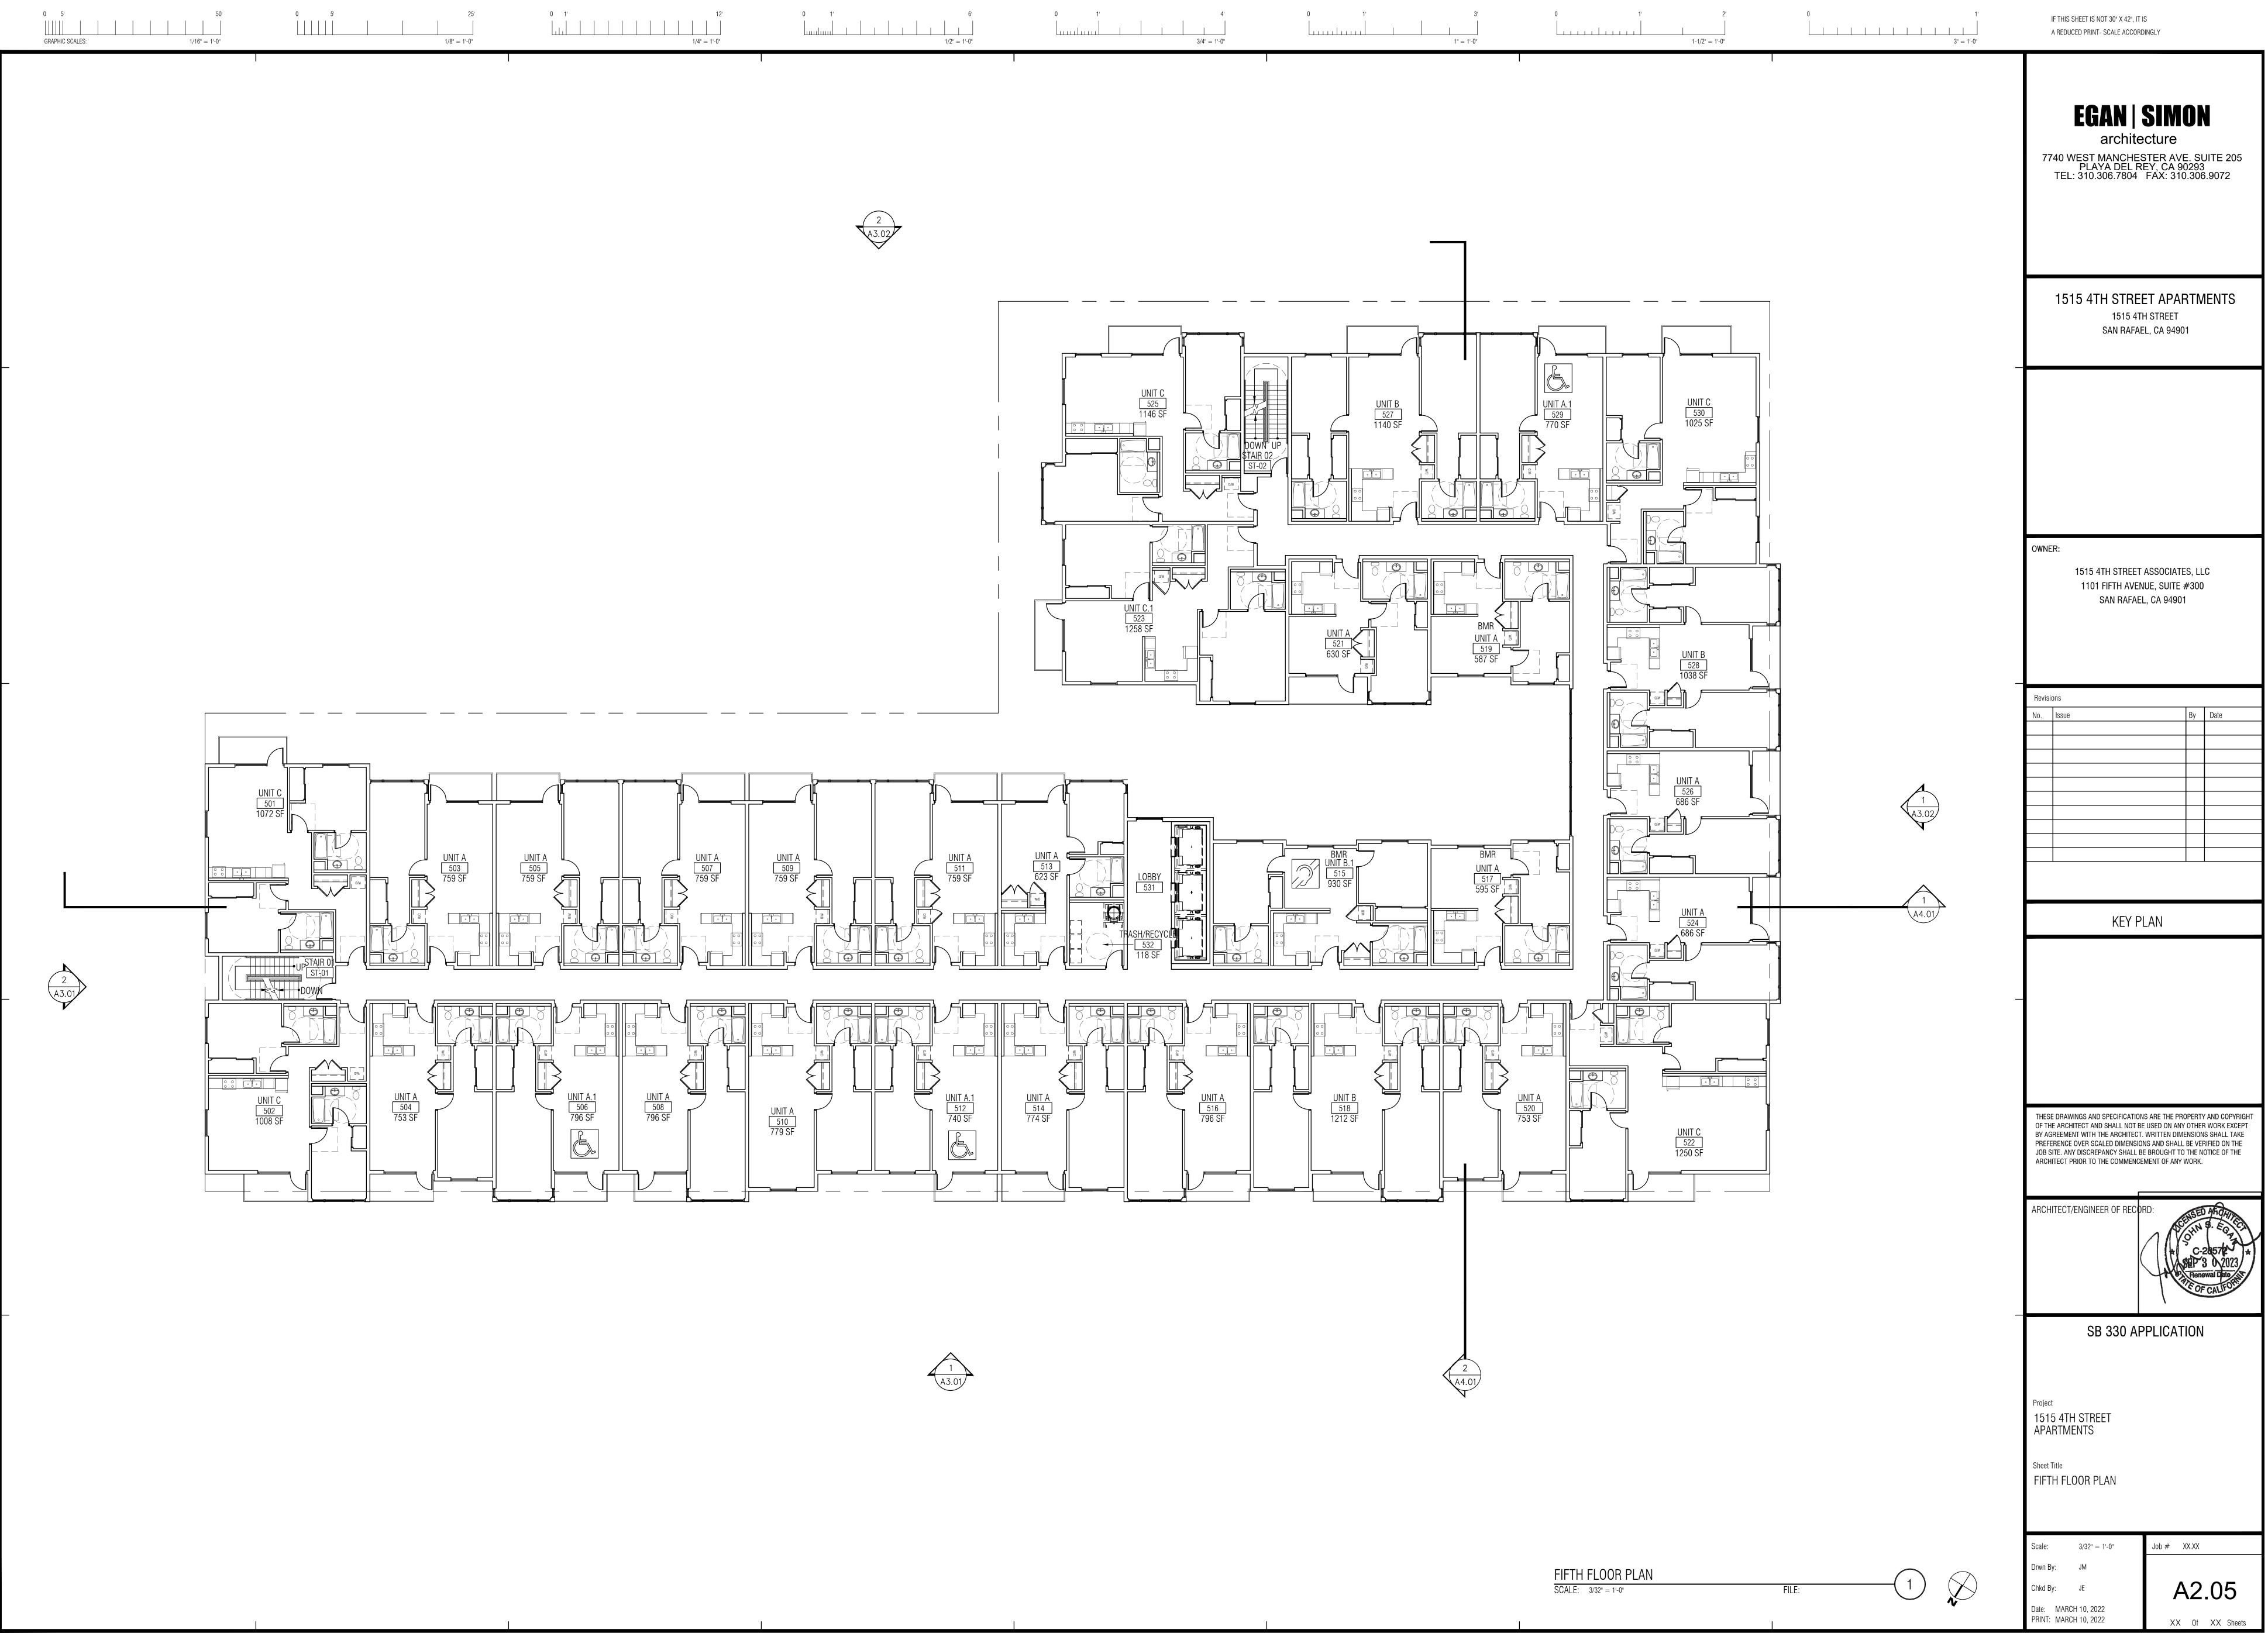


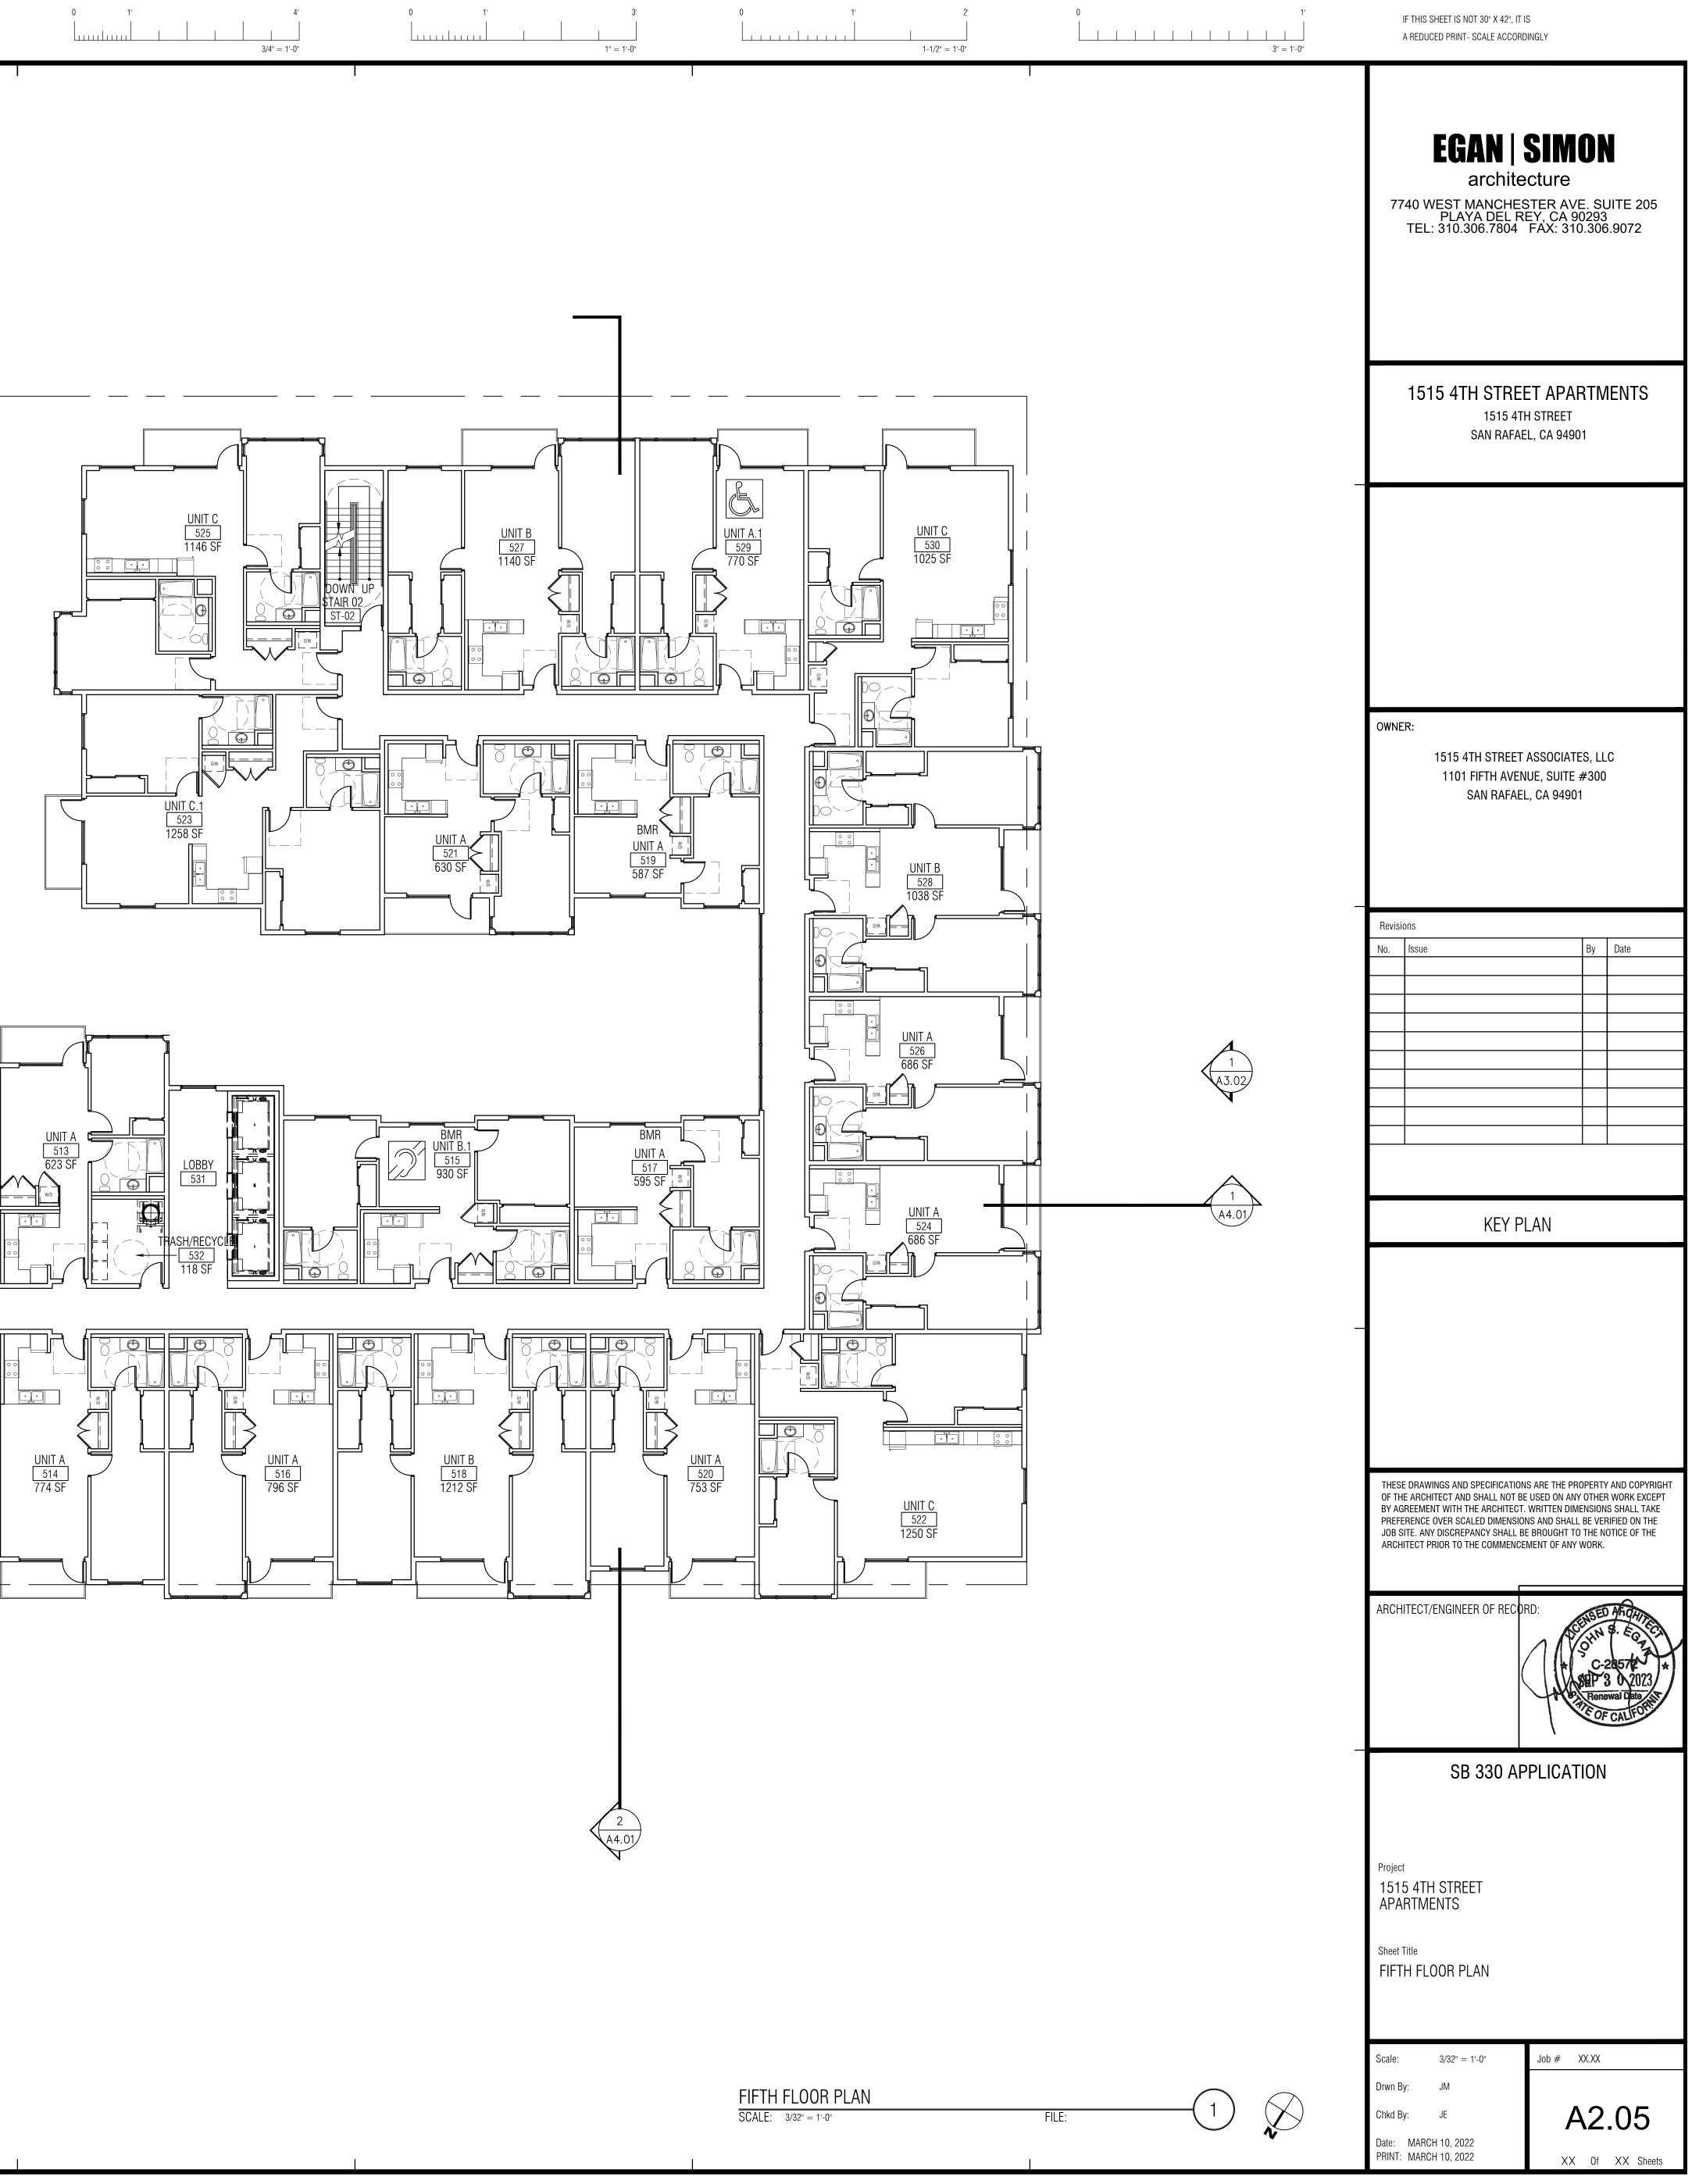


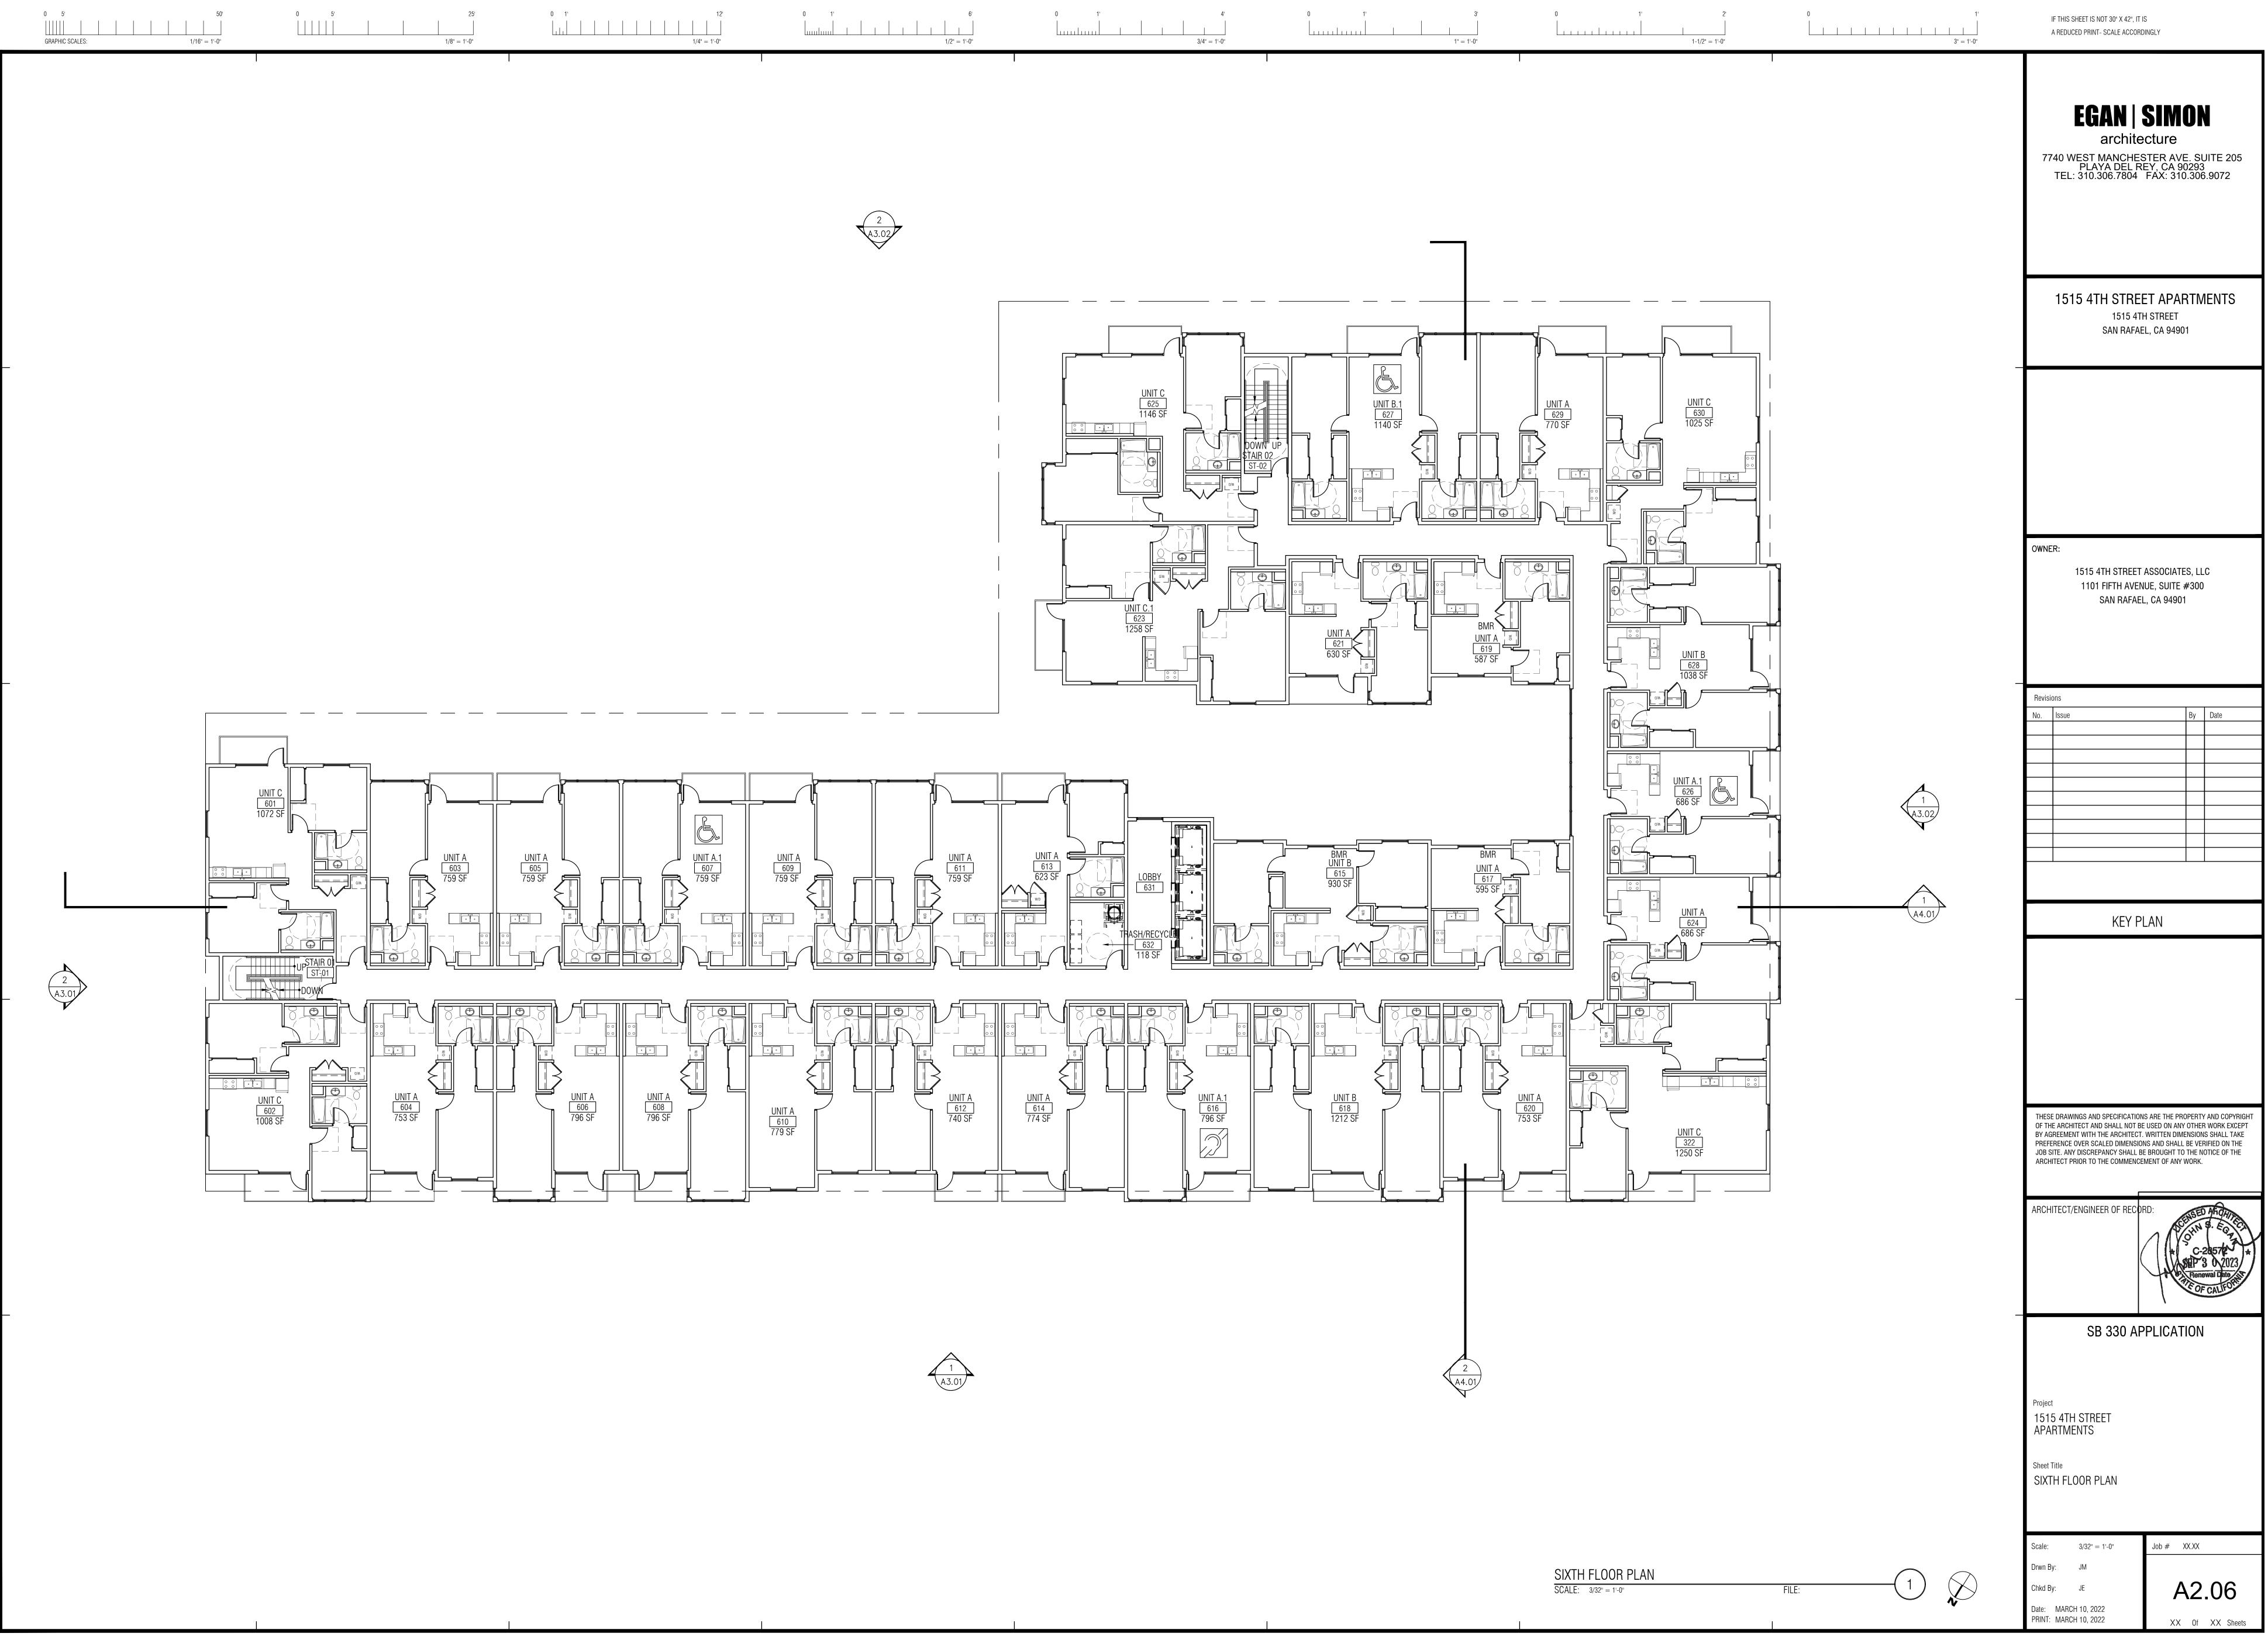

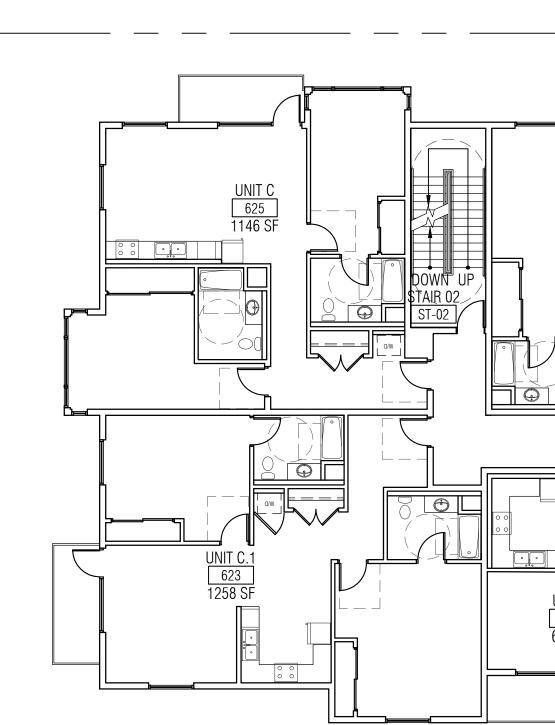


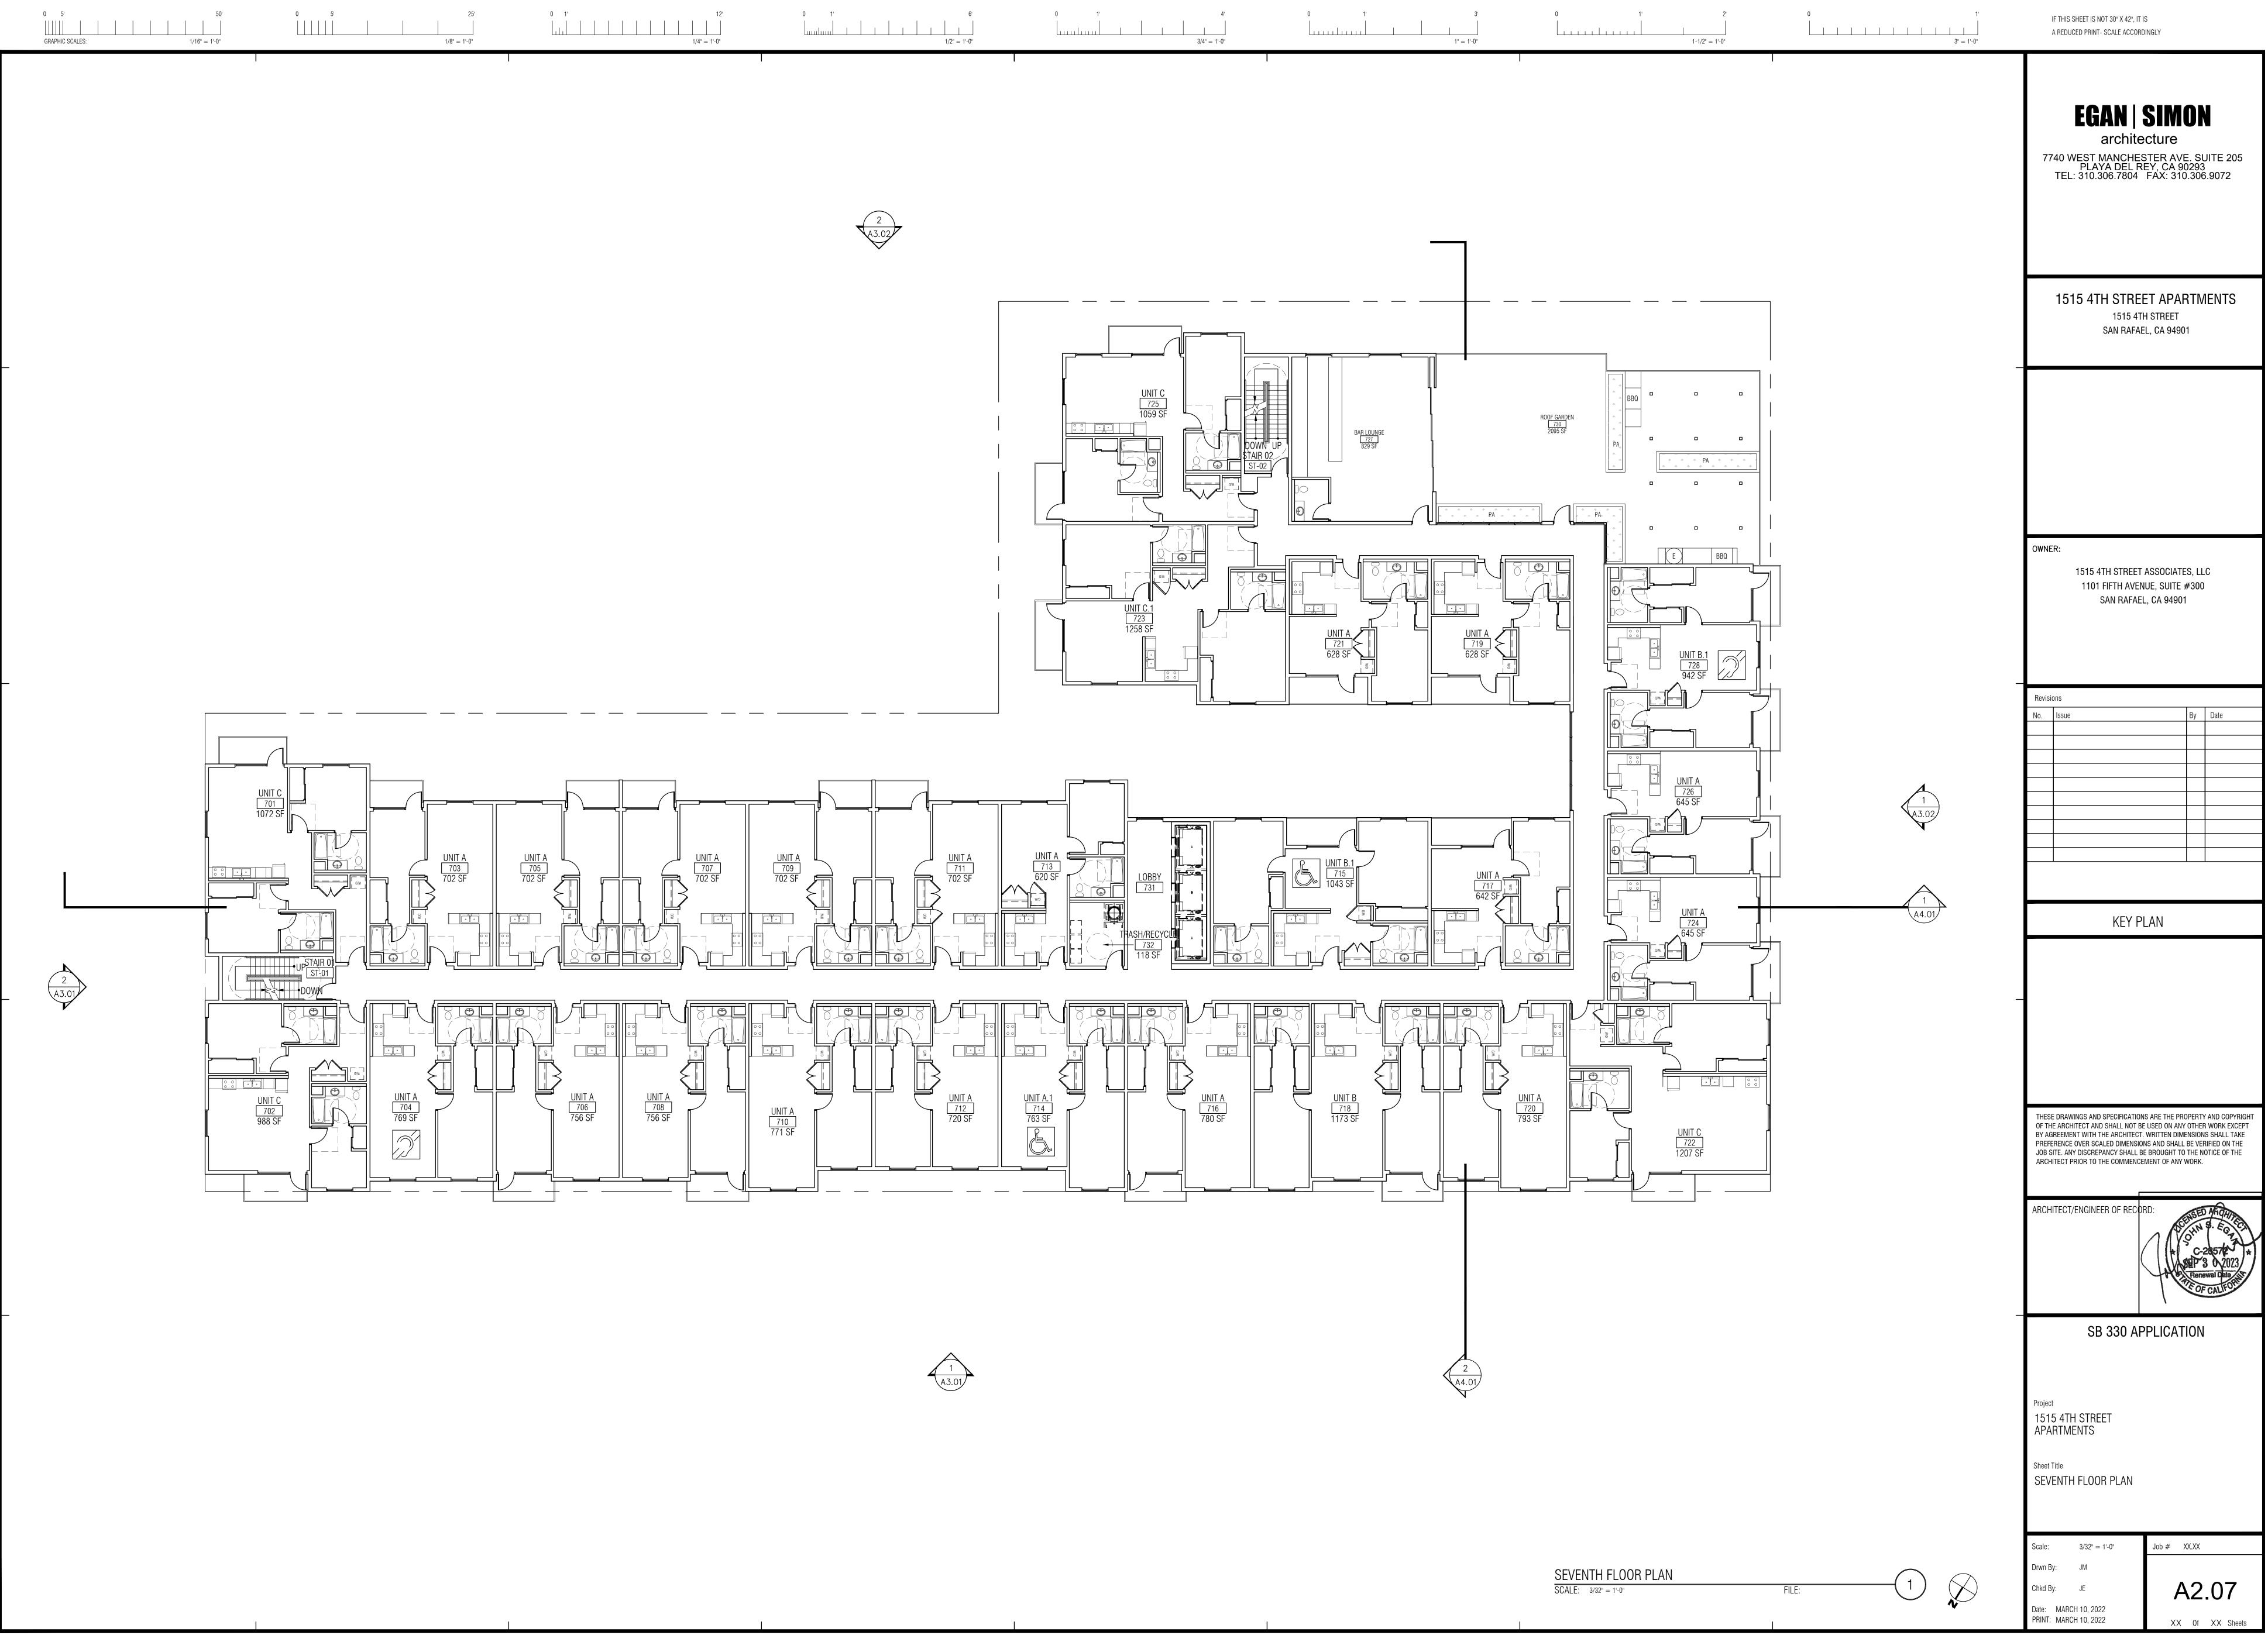

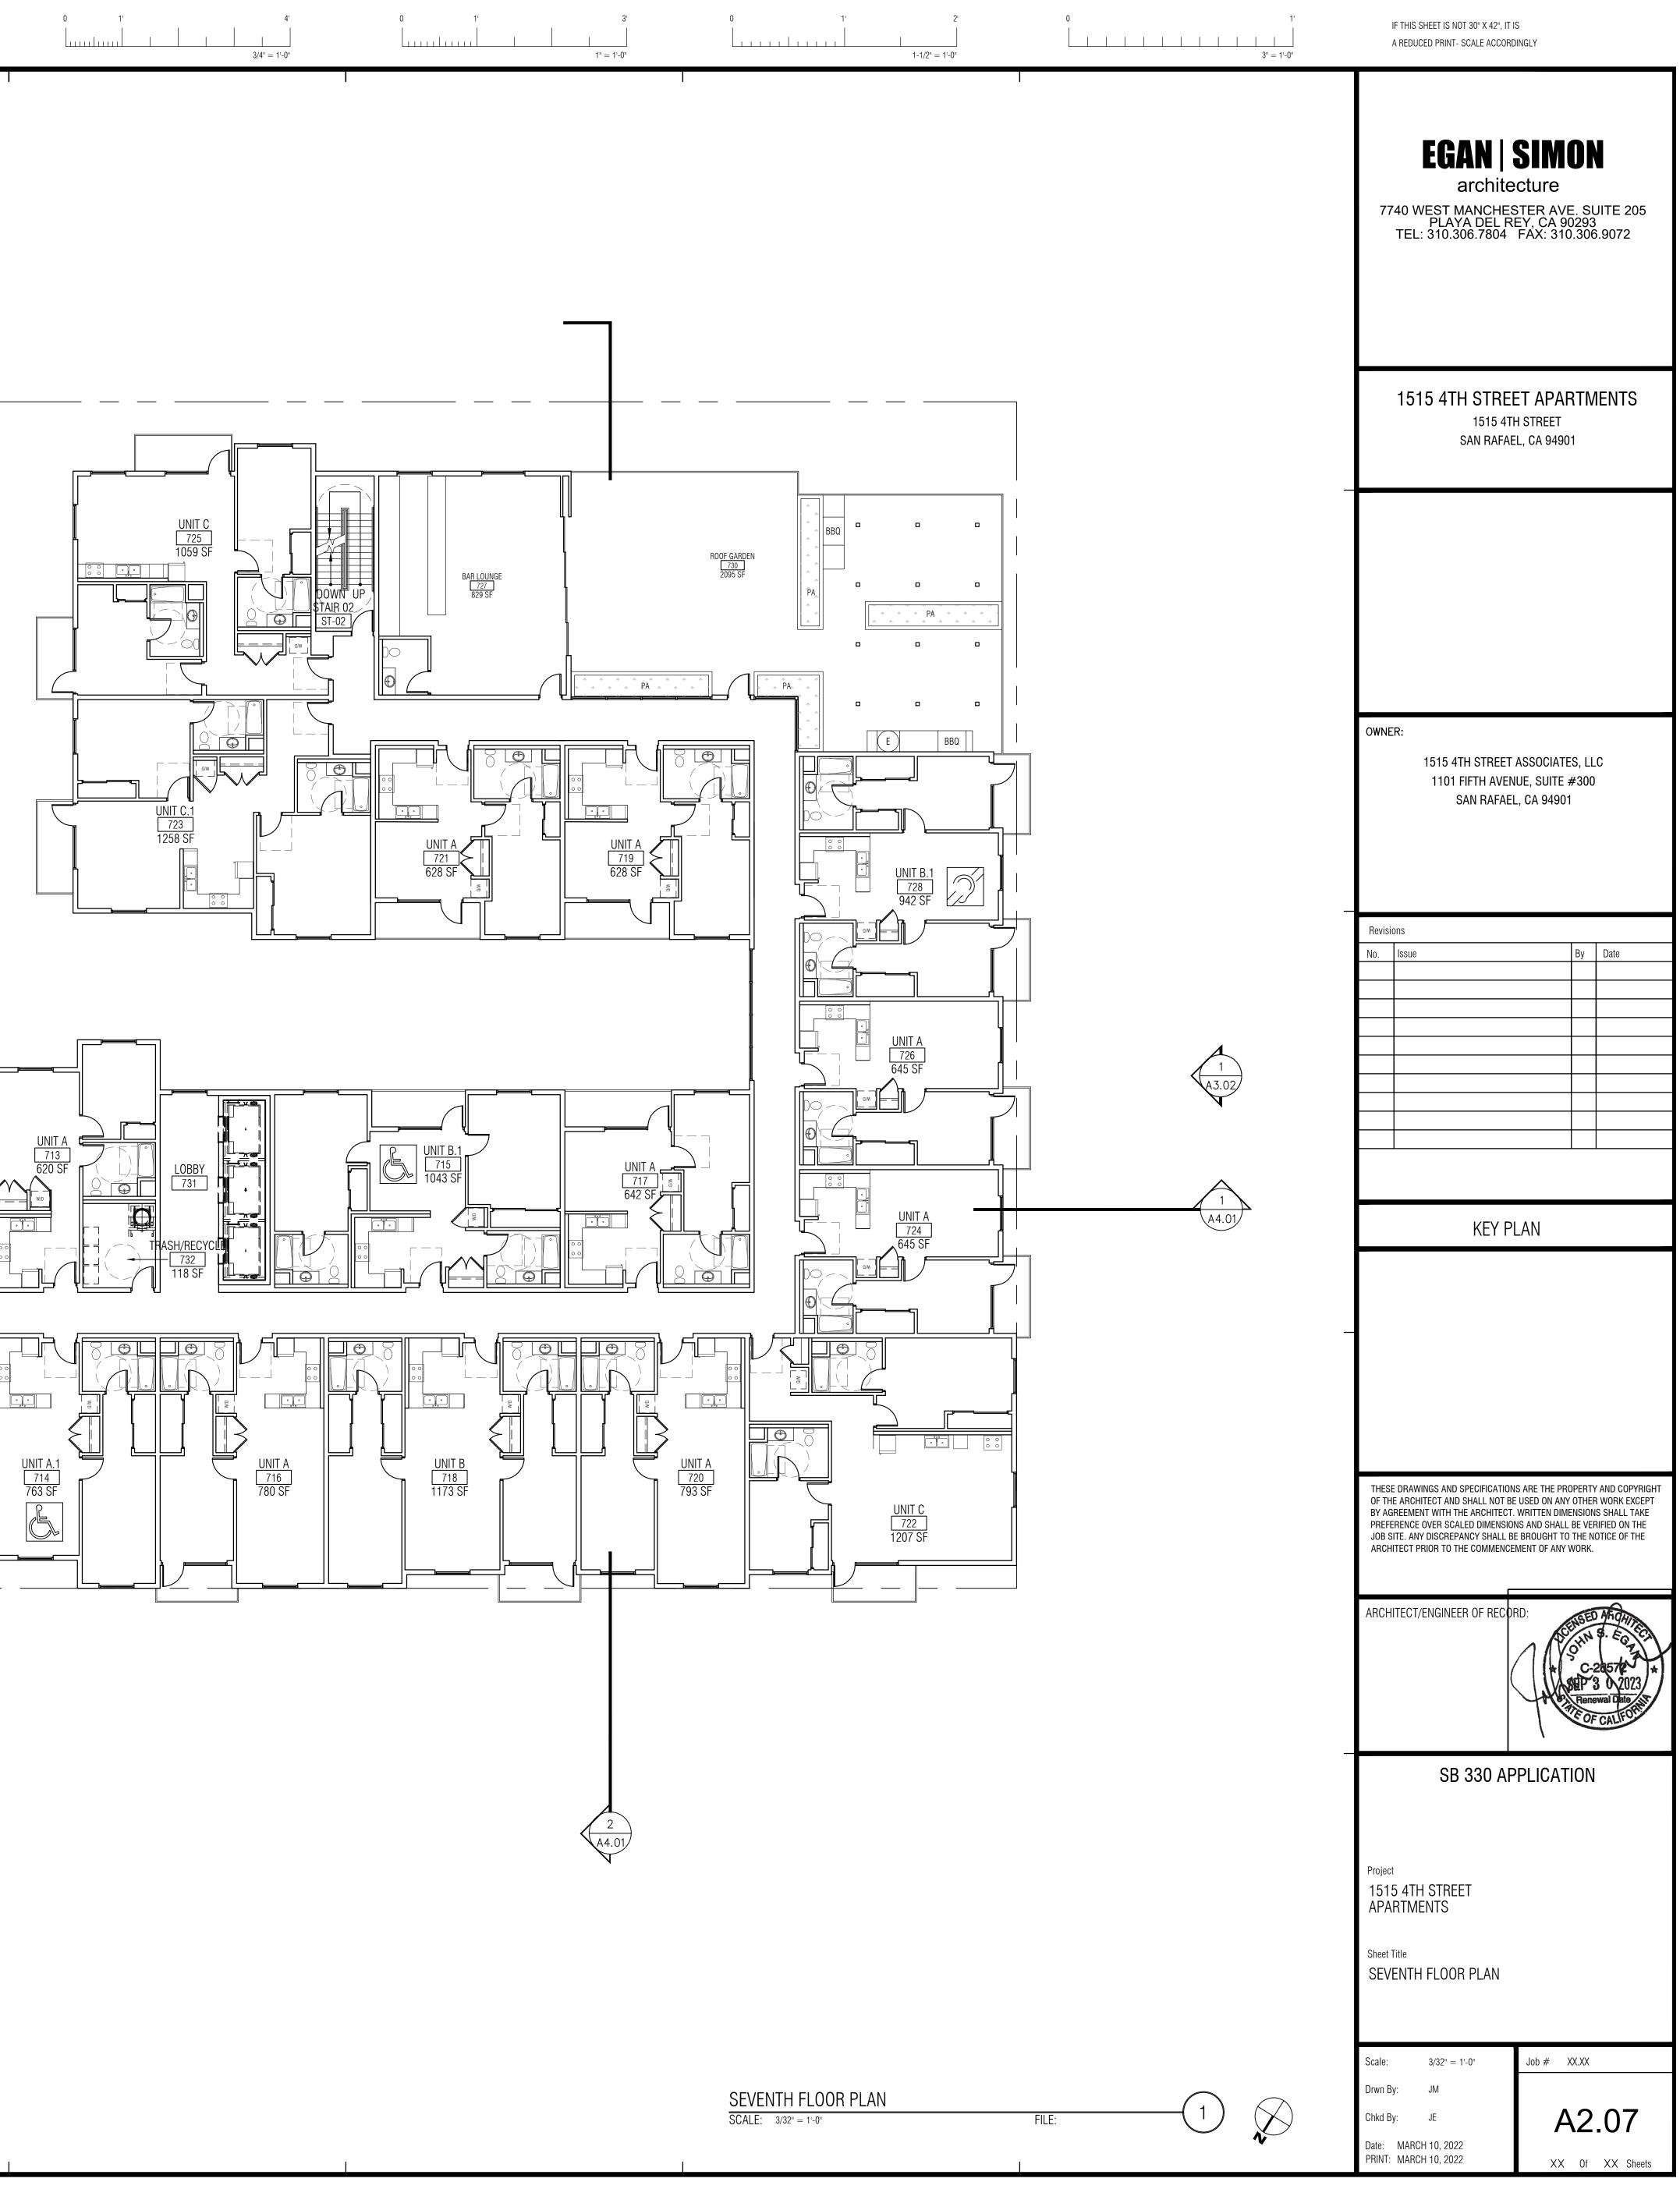

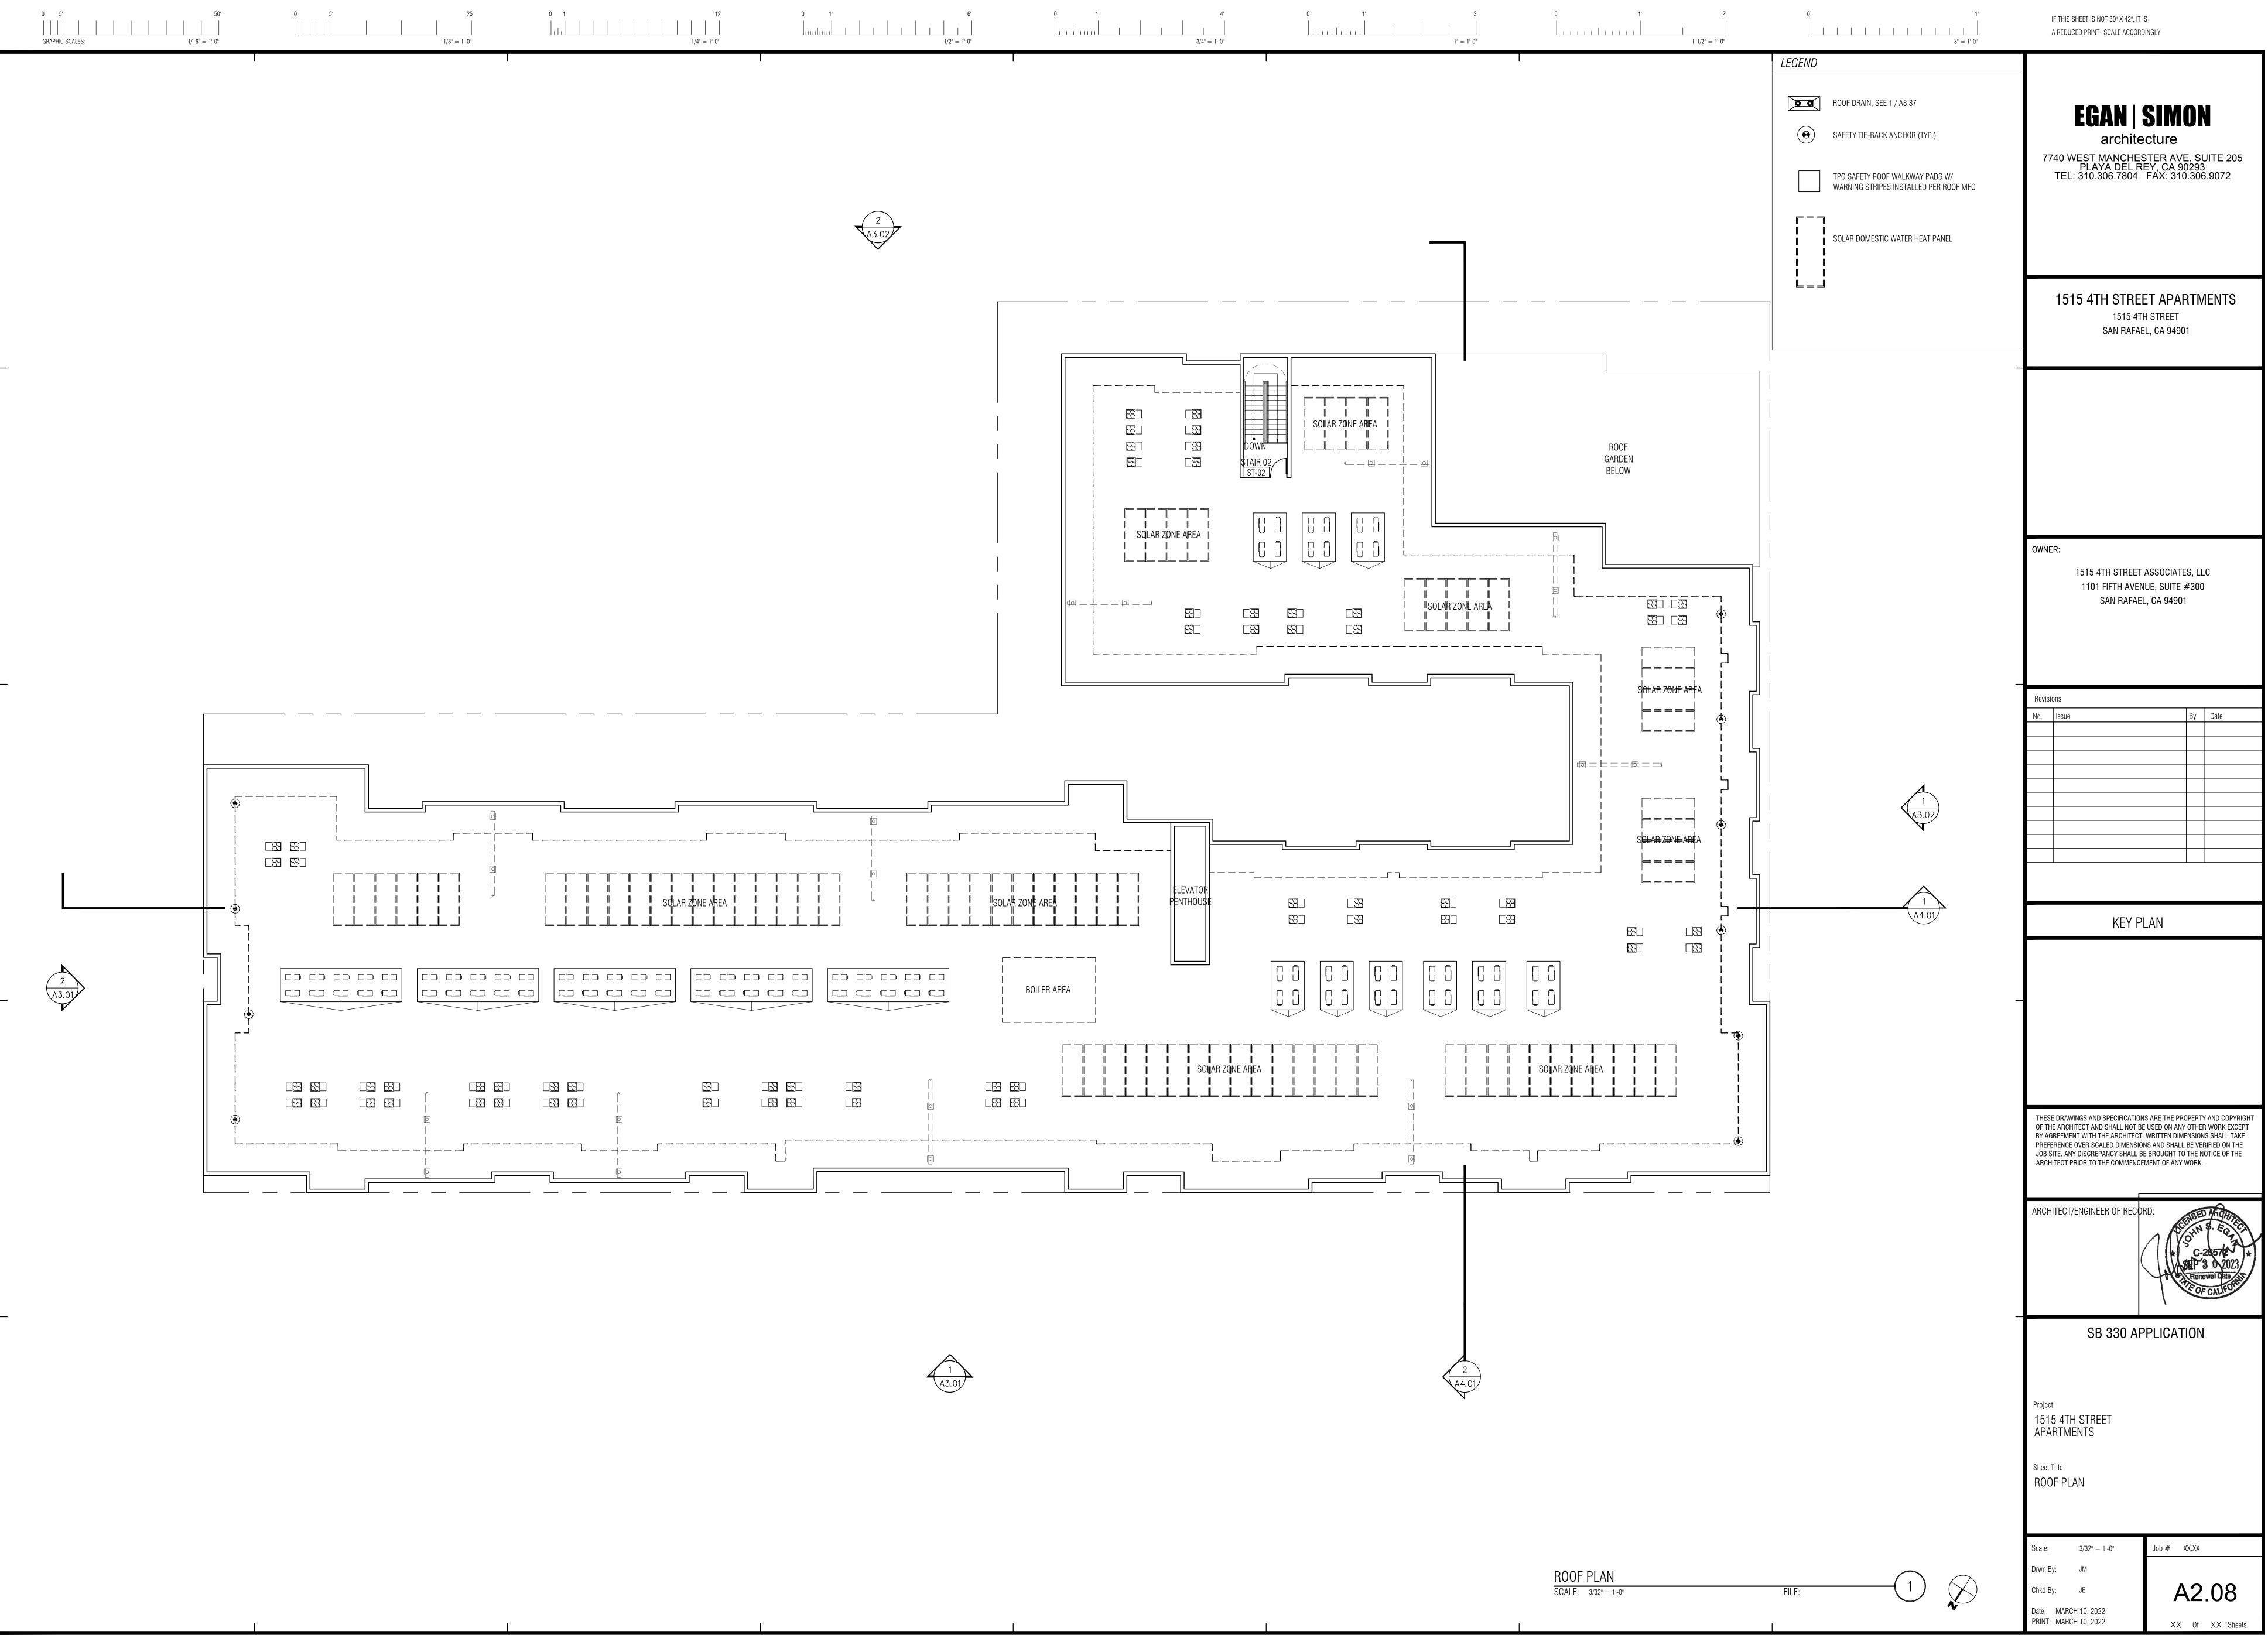



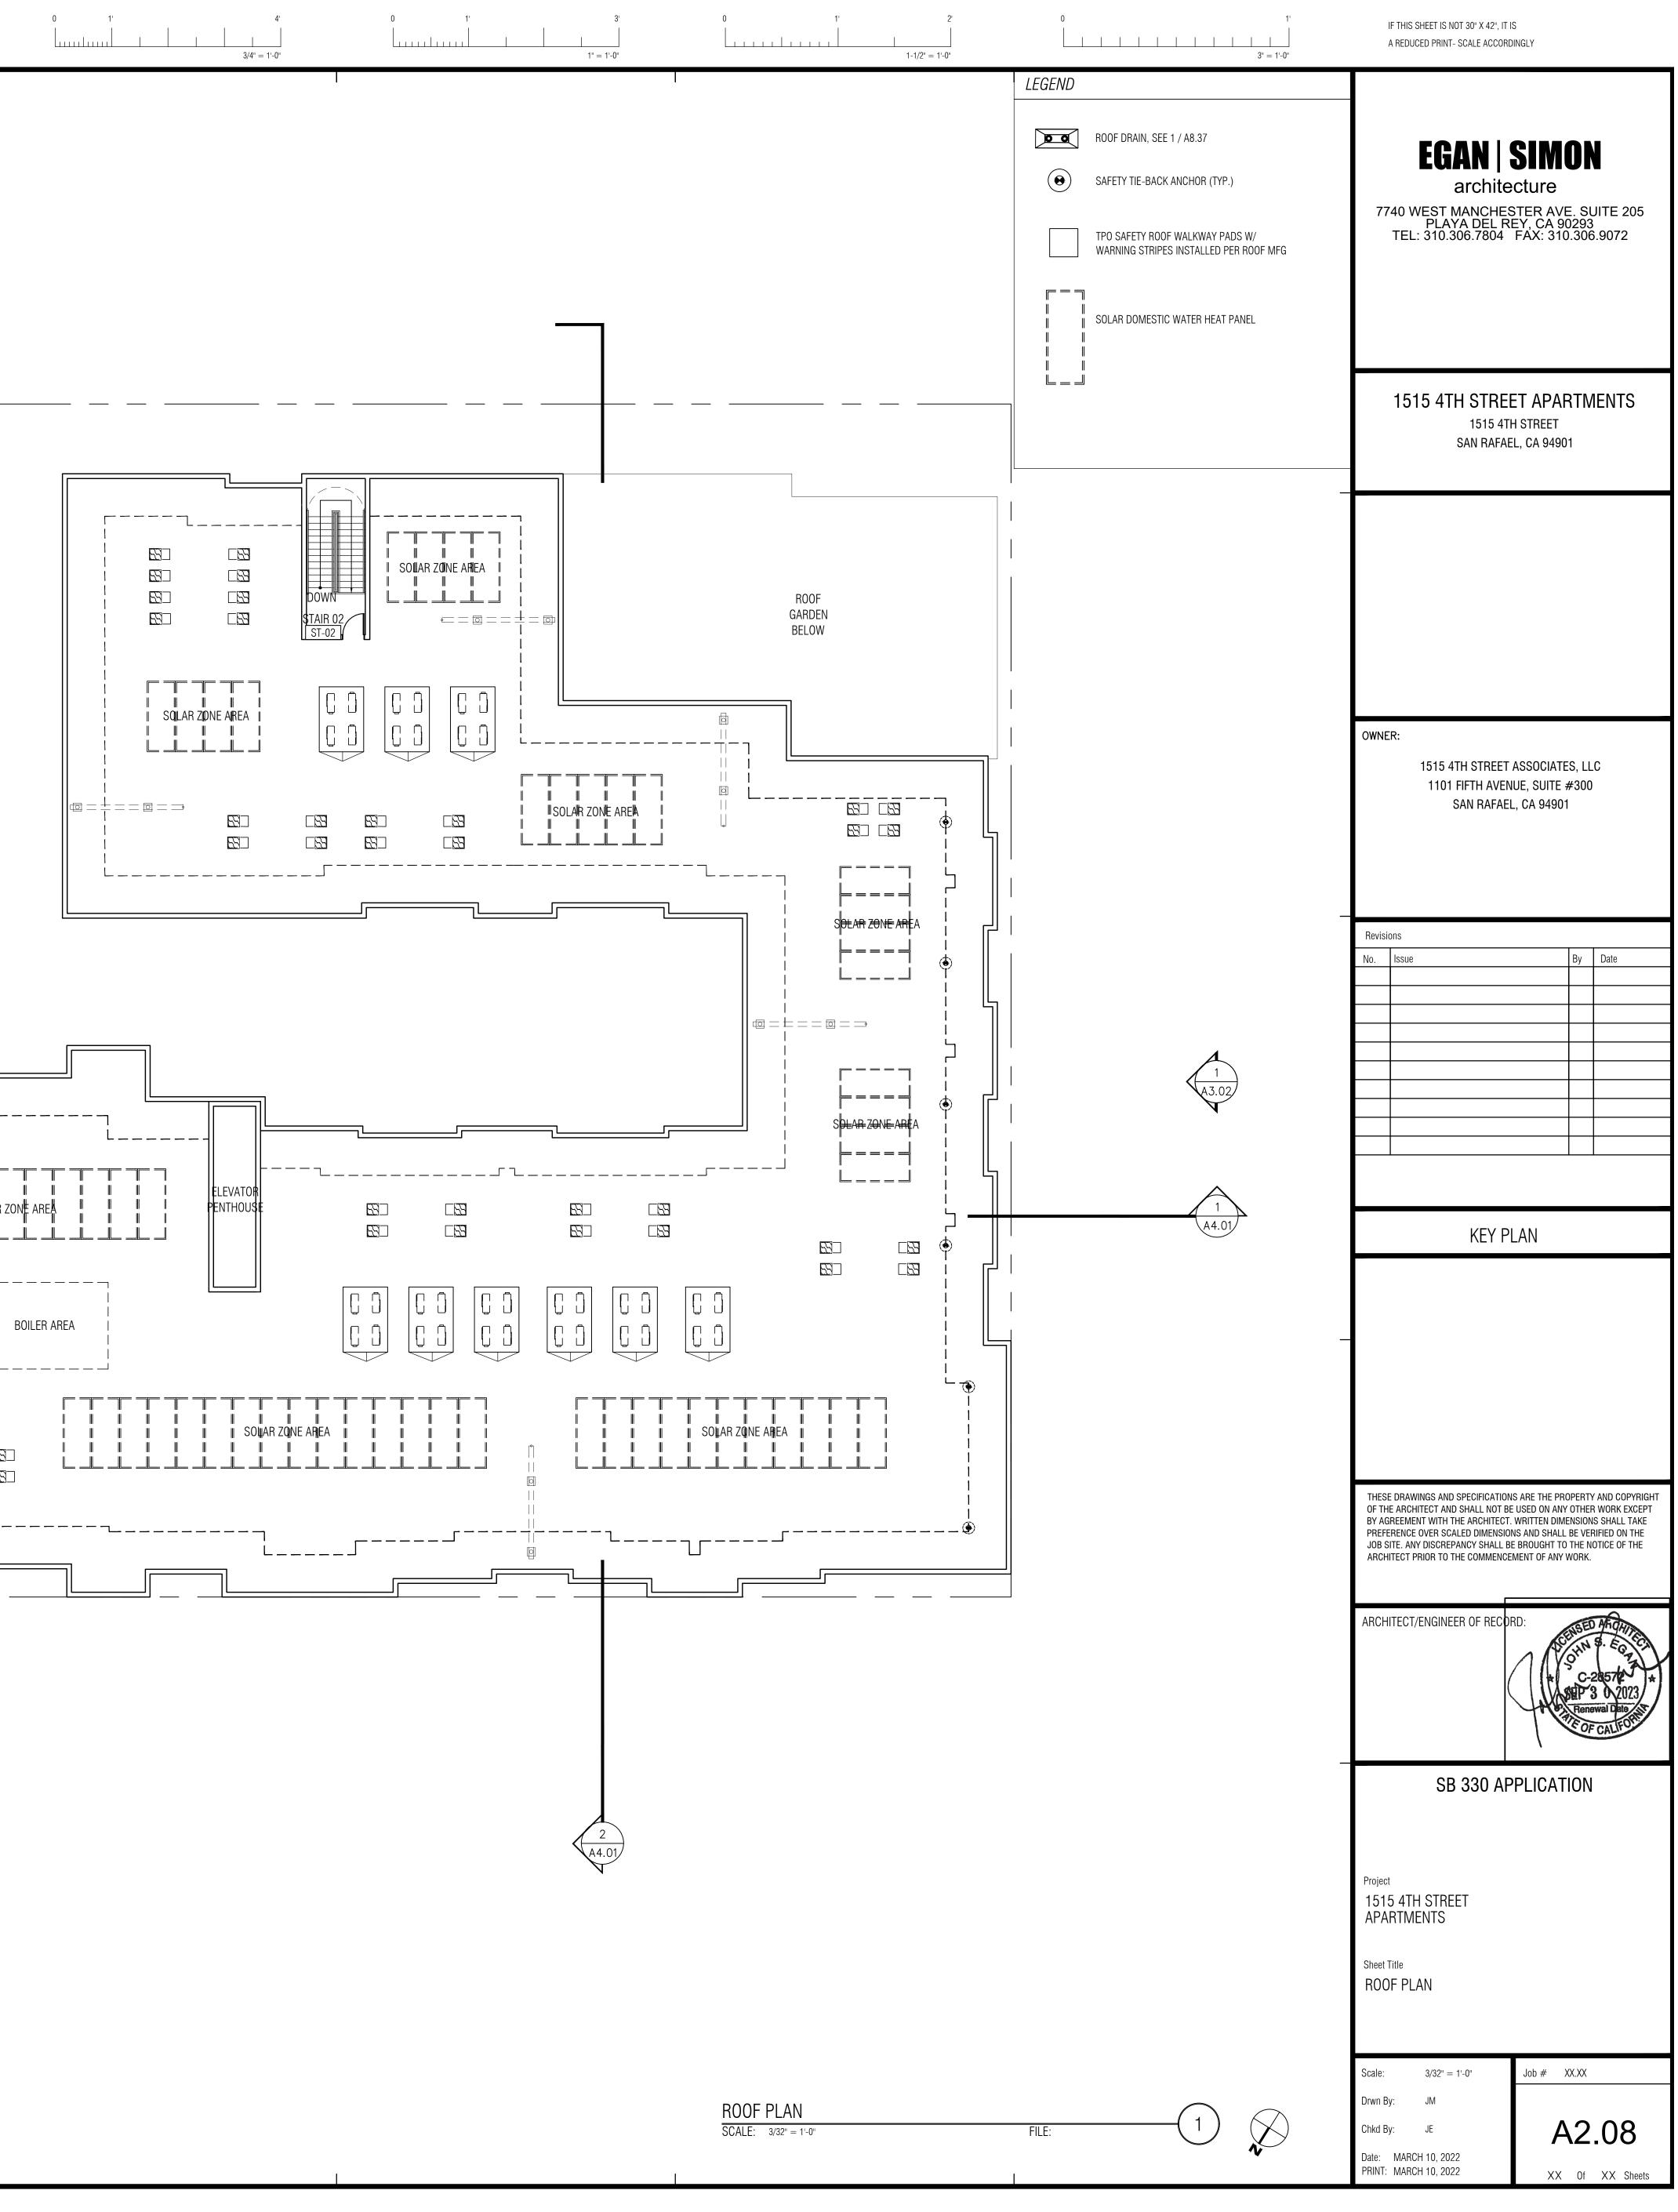



0 5' UUUUU GRAPHIC SCALES:	50' 	25' 	12' 1/4" = 1'-0"	0 1'	6' 0 1/2" = 1'-0"	1' 4' 	
							Image: selection of the se





HINNANG	$\begin{array}{c} \hline TOP \ OF \ ROOF \ CUBB \\ \hline \\$
EAST ELEVATION SCALE: 3/32" = 1'-0"	FILE:
	$\begin{array}{c} \hline \hline \ \ \ \ \ \ \ \ \ \ \ \ \ \ \ \ \ $
NORTH ELEVATION SCALE: 3/32" = 1'-0"	FILE:

1' 3' _______ _1" = 1'-0"

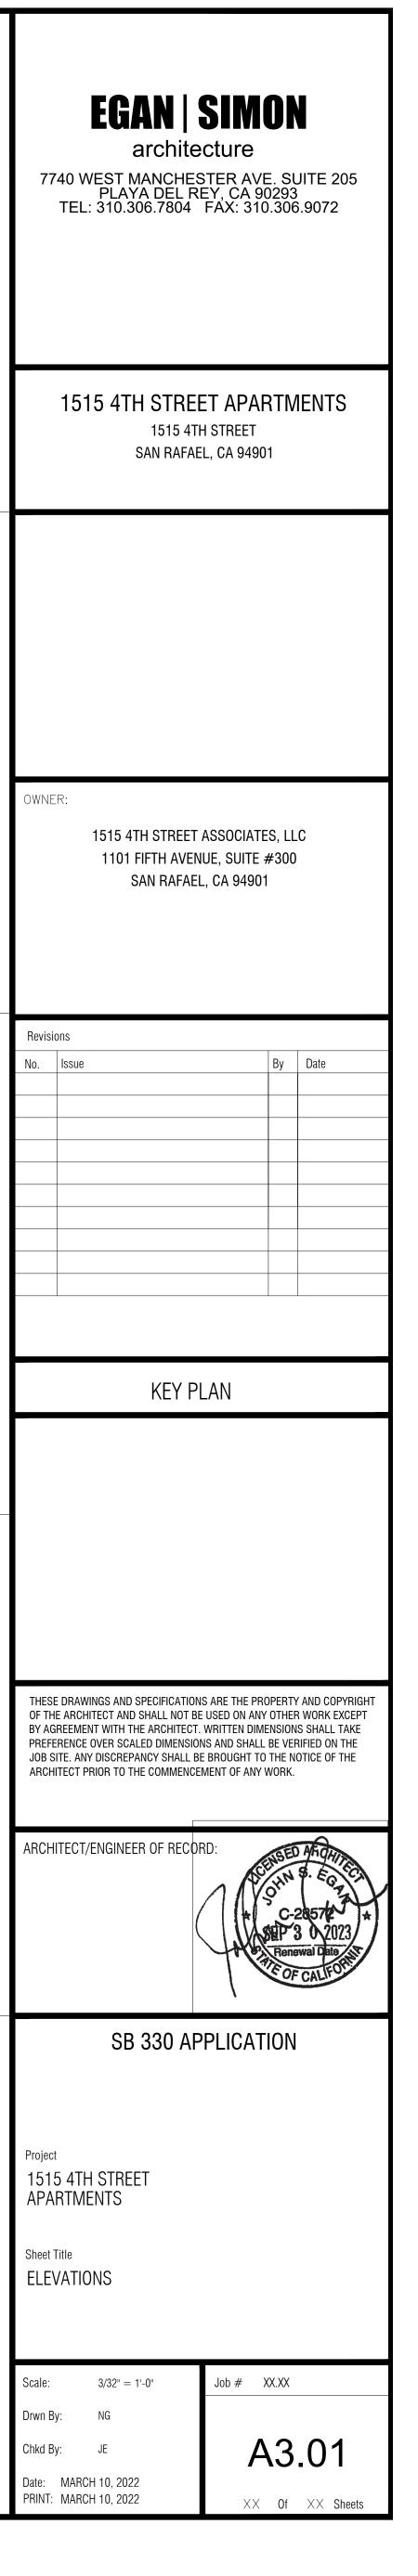


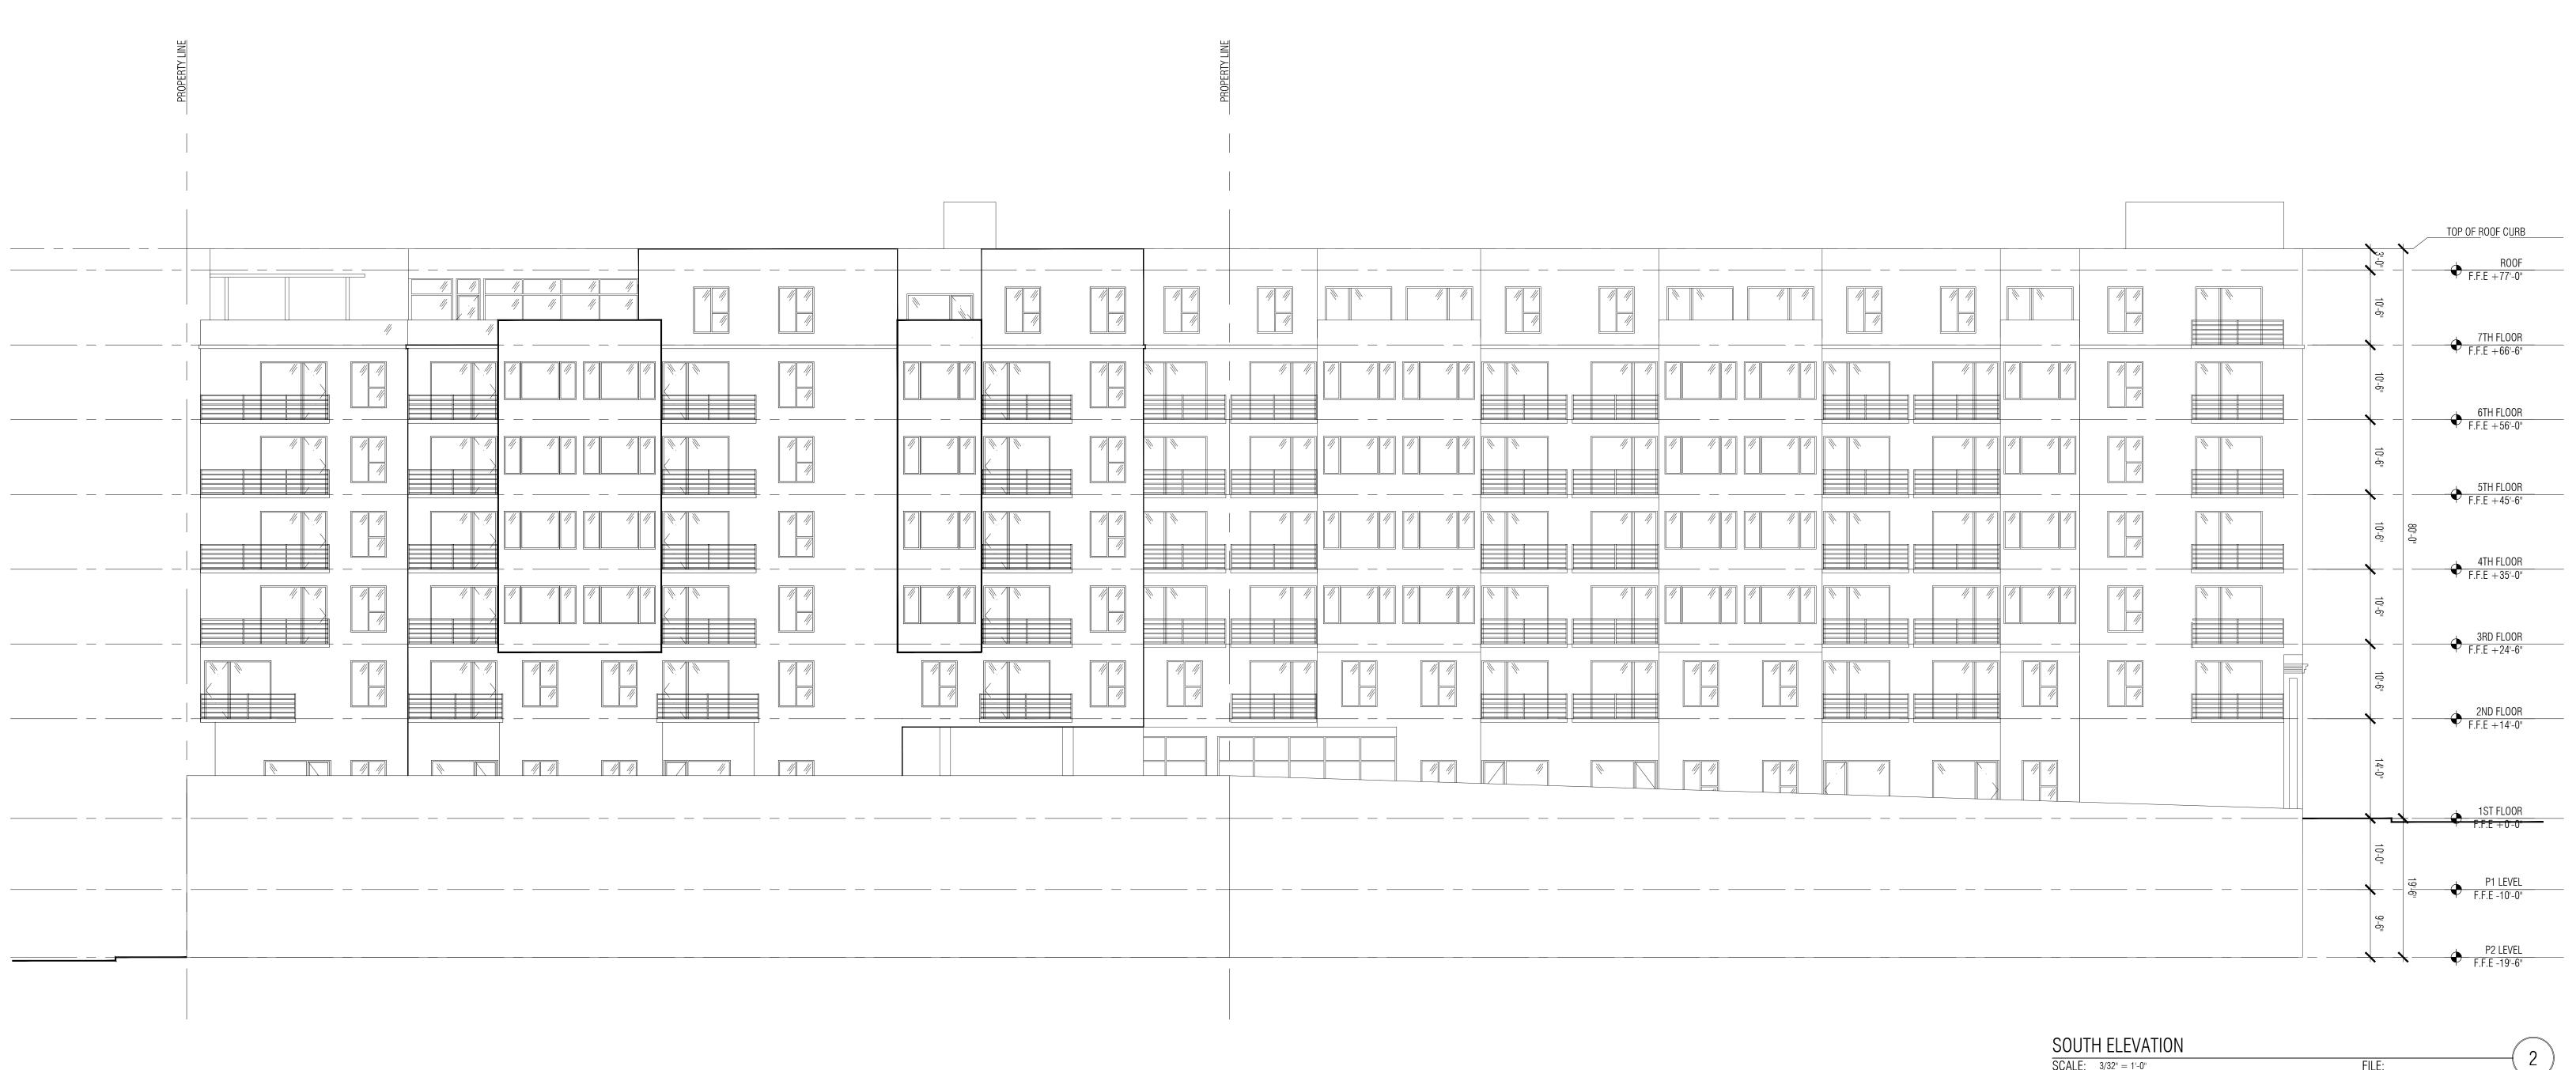

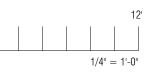

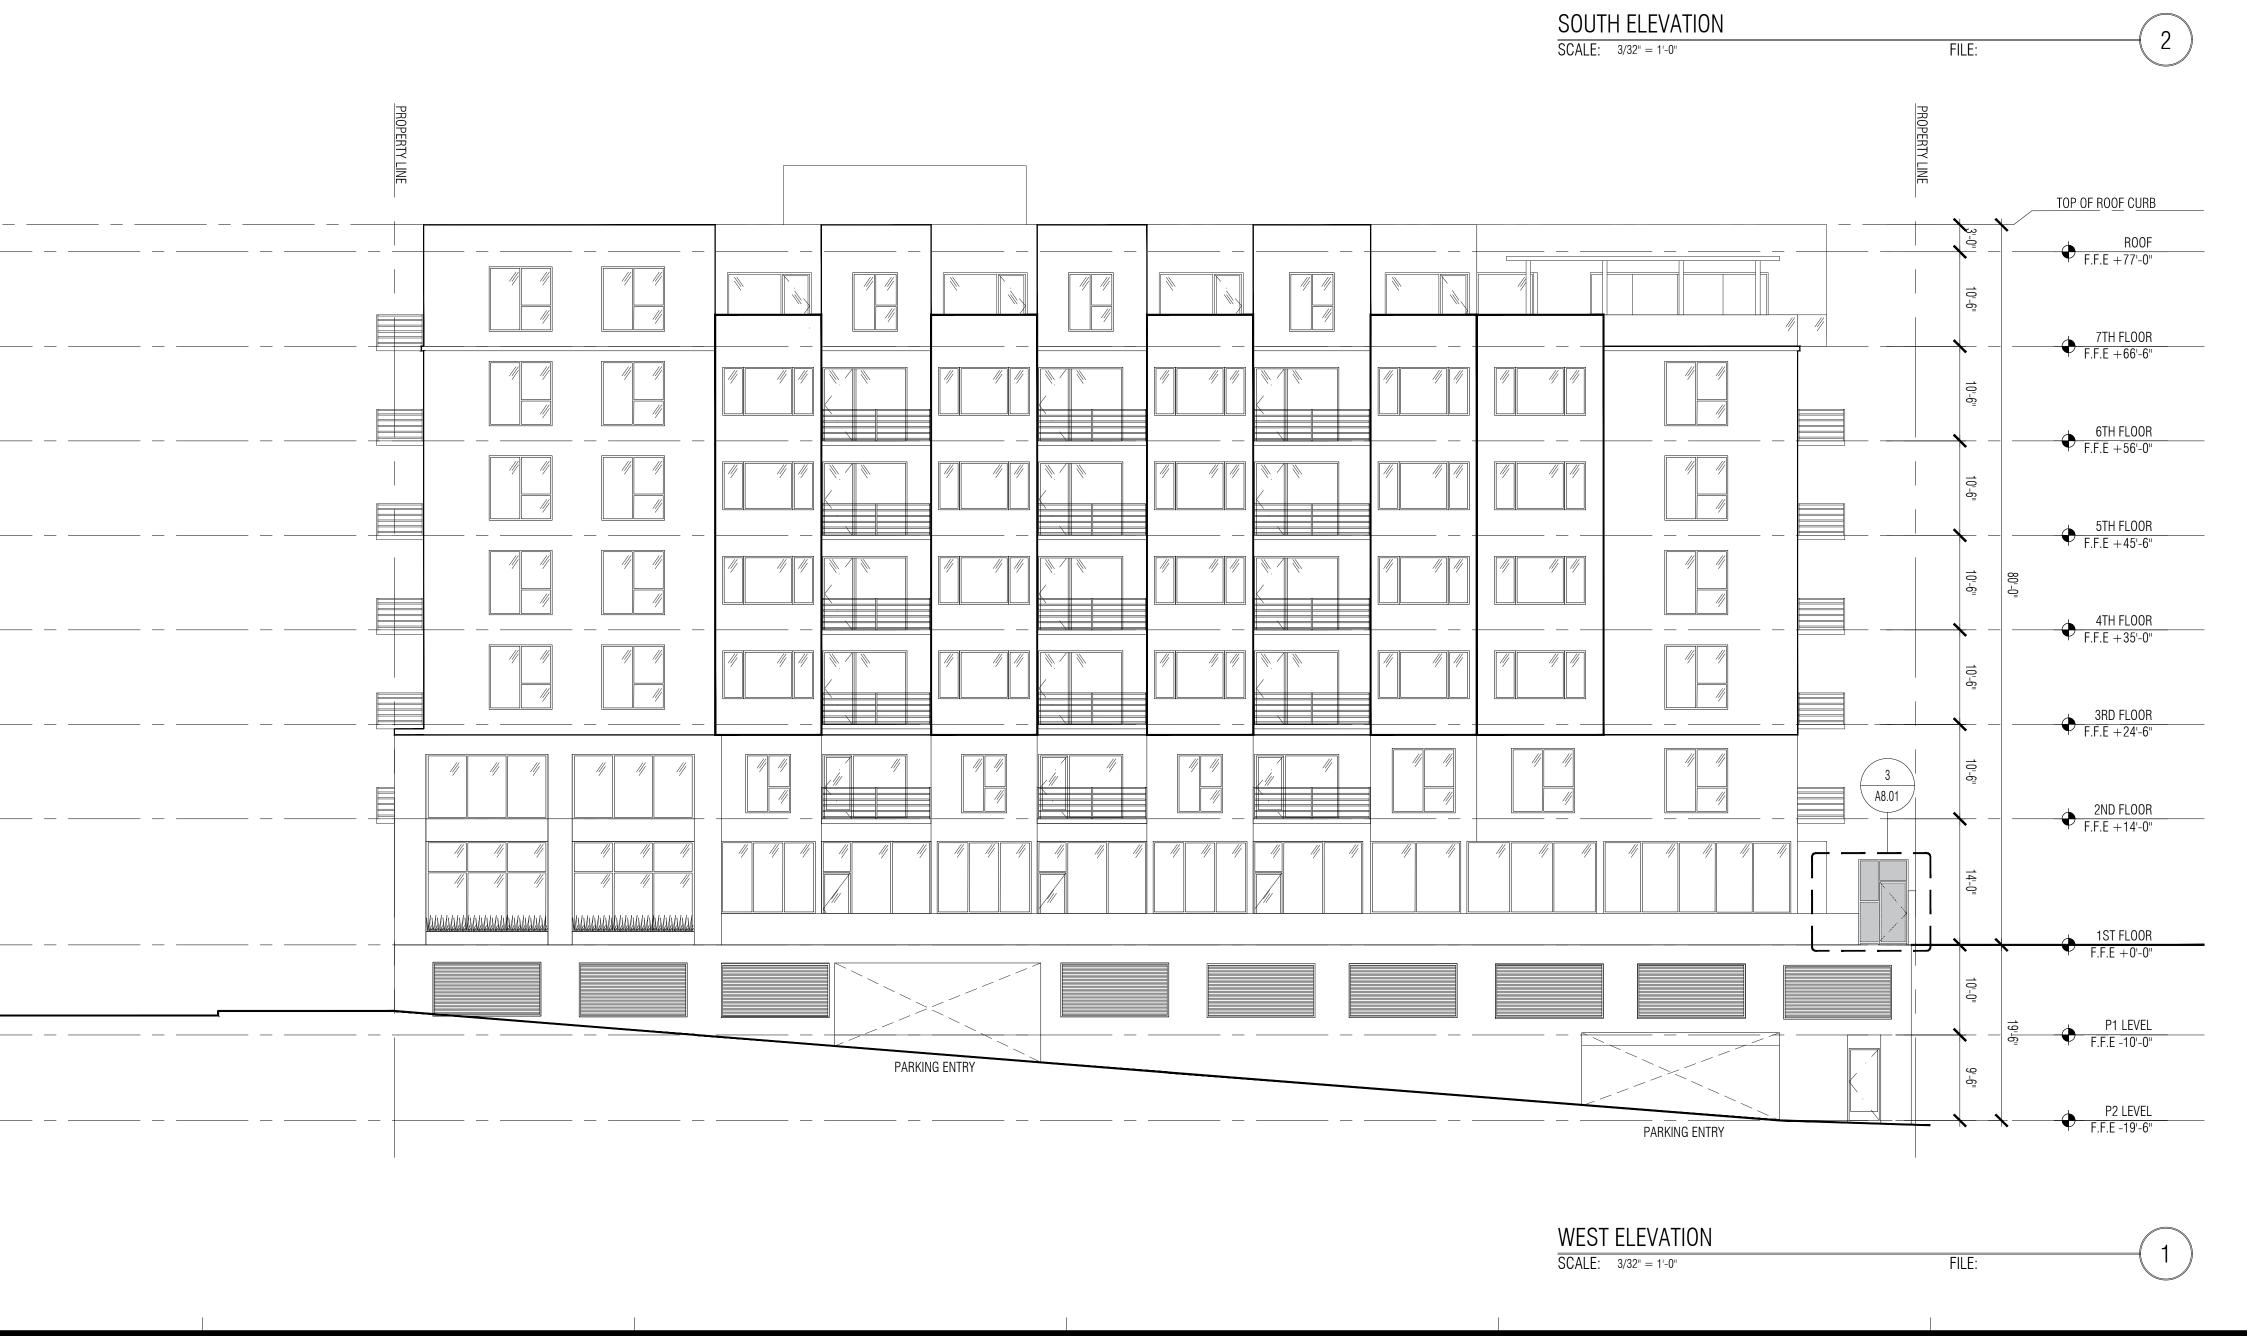



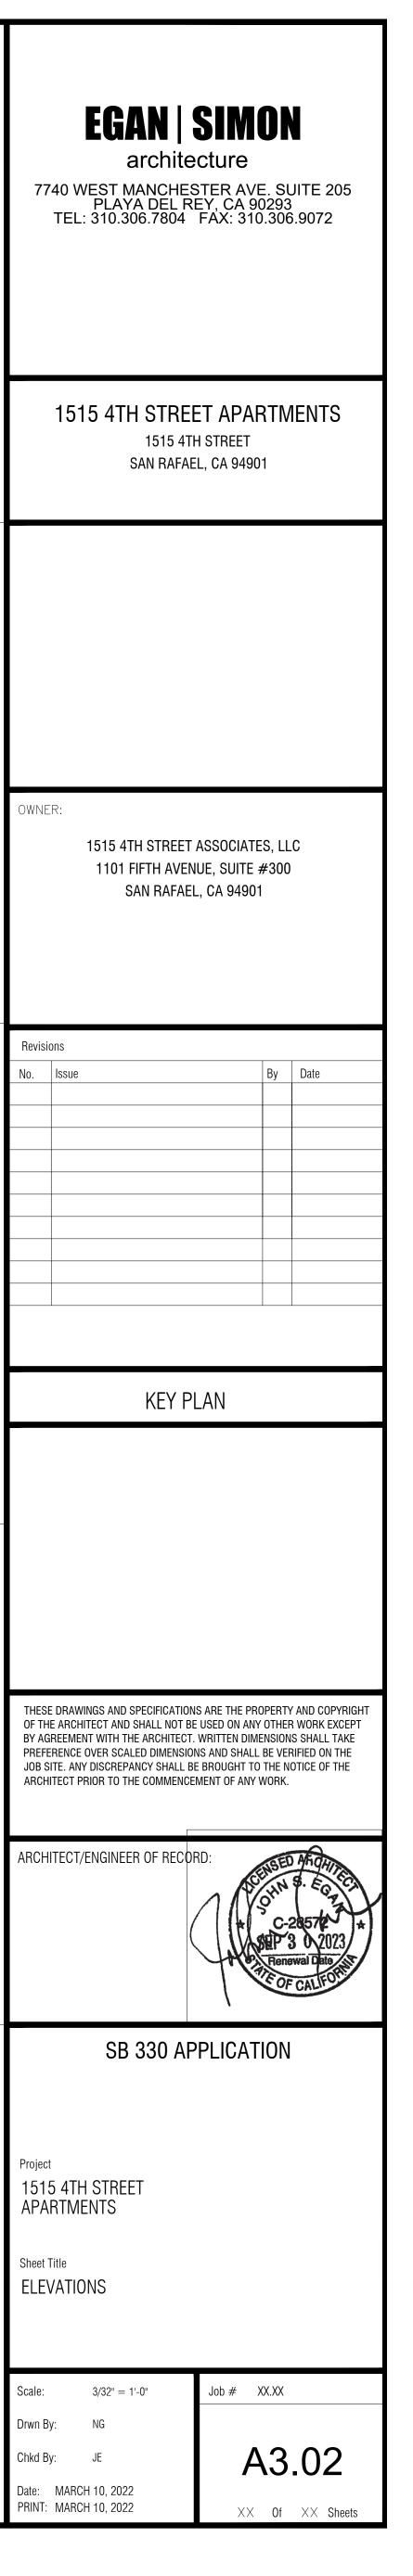


_	0 5' UIIIII GRAPHIC SCALES:		50' 1/16" = 1'-0"	0	5'	25' 			12' 1/4" = 1'-0"	0	1' 		6' 1/2" = 1'-0"	0 1		4' 3/4" = 1'-0"	o 	
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											PROPERTY LINE							
														CORR.	UNIT			
														CORR.	UNIT			
													UNIT	CORR.	UNIT			
													UNIT	CORR.	UNIT			
													UNIT	CORR.	UNIT			
													UNIT CORR.		LOUNGE			
													PARKING	COLUMN				
													PARKING	COLUMN				
		PROPER																
																		_
			UNIT		UNIT			UNIT	UNIT			UNIT	UNIT	LOBBY	ELEVATOR	UNIT		
_			UNIT		UNIT			UNIT				UNIT	UNIT	LOBBY	ELEVATOR	UNIT		
_			UNIT		UNIT			UNIT				UNIT	UNIT	LOBBY	ELEVATOR][][][
_			UNIT		UNIT			UNIT				UNIT		LOBBY	ELEVATOR	UNIT][][
╞			UNIT		UNIT			UNIT				UNIT			ELEVATOR	UNIT		
<u> </u>					UNIT			UNIT			RECEPTION/MAI	UNII	LOBBY		ELEVATOR	UNIT	LOUNGE	
		RETAIL		RESTROOM			//NC					TDACU						
	·	PARKING	STAIR			PARK PARK PARK						TRASH		LOBBY	ELEVATOR			

PROPERTY LINE			
 <u> </u>			
 UNIT	CORR.	UNIT	
 UNIT	CORR.	UNIT	
 UNIT	CORR.	UNIT	
UNIT	CORR.	UNIT	
UNIT	CORR.	UNIT	
UNIT	CORR.	UNIT	
UNIT CORR.		LOUNGE	
 PARKING	CO	LUMN	
 PARKING	COI	LUMN	


	3' 			2' 1-1/2" = 1'-0"			0		1' 3" = 1'-0"	
					PROPERTY LINE	I				
 г — —— — —					`	3 <u>-</u> 0	\checkmark	BOOF		
 UNIT	CORR.	ROOF DECK	3.6		 	10 ⁻ -6 ⁻		R00F F.F.E + 77'-0" 7TH FL00R		
 UNIT	CORR.	UNIT				10'-6"		7TH FLOOR F.F.E + 66'-6" 6TH FLOOR F.F.E + 56'-0"		
UNIT	CORR.	UNIT				10'-6"		F.F.E + 56'-0" 5TH FLOOR F.F.E + 45'-6"		
UNIT	CORR.	UNIT				10'-6"	"0- ⁻ 0	F.F.E +45'-6" 4TH FLOOR F.F.E +35'-0"		
 UNIT	CORR.	UNIT	9'-31/4"		 	10'-6"		F.F.E +35'-0" 3RD FLOOR F.F.E +24'-6"		
UNIT	CORR.	UNIT	9-4"			10'-6"				
CLUB ROOM	CORR.	UNIT	12-10"	PATIO		. 14'-0"	·•			
 PARKING			STAIRS	STAIRS		10'-0"	₩ 19 ¹ -6"	F.F.E +0'-0" P1 LEVEL F.F.E -10'-0"		
PARKING			STAIRS	STAIRS	,	9-6"	↓ =	P2 LEVEL F.F.E -19'-6"		-

CROSS SECTION SCALE: 3/32" = 1'-0" FILE


TOP OF ROOF CURB • R00F F.F.E +77'-0" UNIT UNIT 7TH FLOOR F.F.E +66'-6" UNIT UNIT 6TH FLOOR F.F.E + 56'-0" UNIT UNIT 5TH FLOOR F.F.E +45'-6" UNIT UNIT CORR. 4TH FLOOR F.F.E +35'-0" UNIT UNIT CORR. • 3RD FLOOR F.F.E +24'-6" UNIT UNIT ● 2ND FLOOR F.F.E +14'-0" CORR. UNIT ╶╅───┼ PARKING ENTRANCE/EXIT PARKING • P1 LEVEL F.F.E -10'-0" PARKING P2 LEVEL F.F.E -19'-6" LONGITUDINAL SECTION SCALE: 3/32" = 1'-0" FILE:

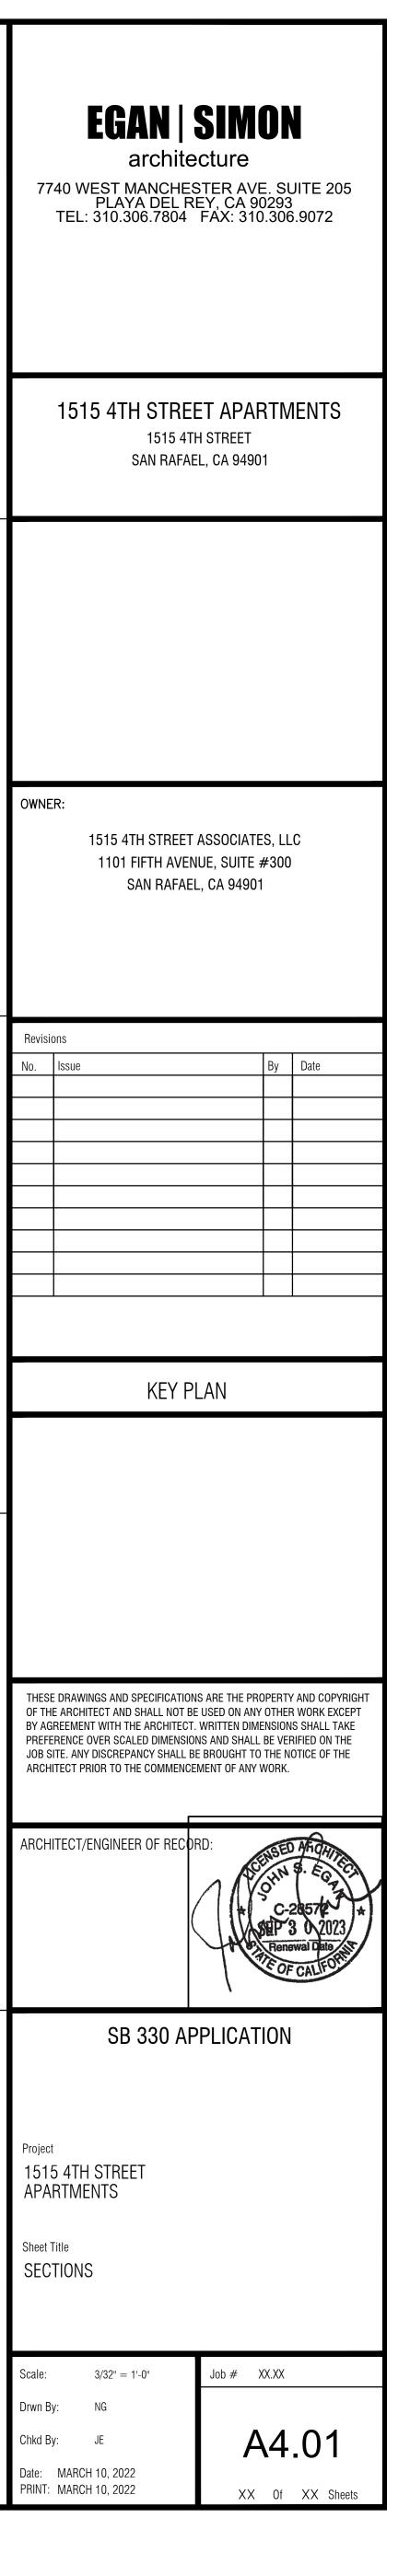


1/8" = 1'-0"

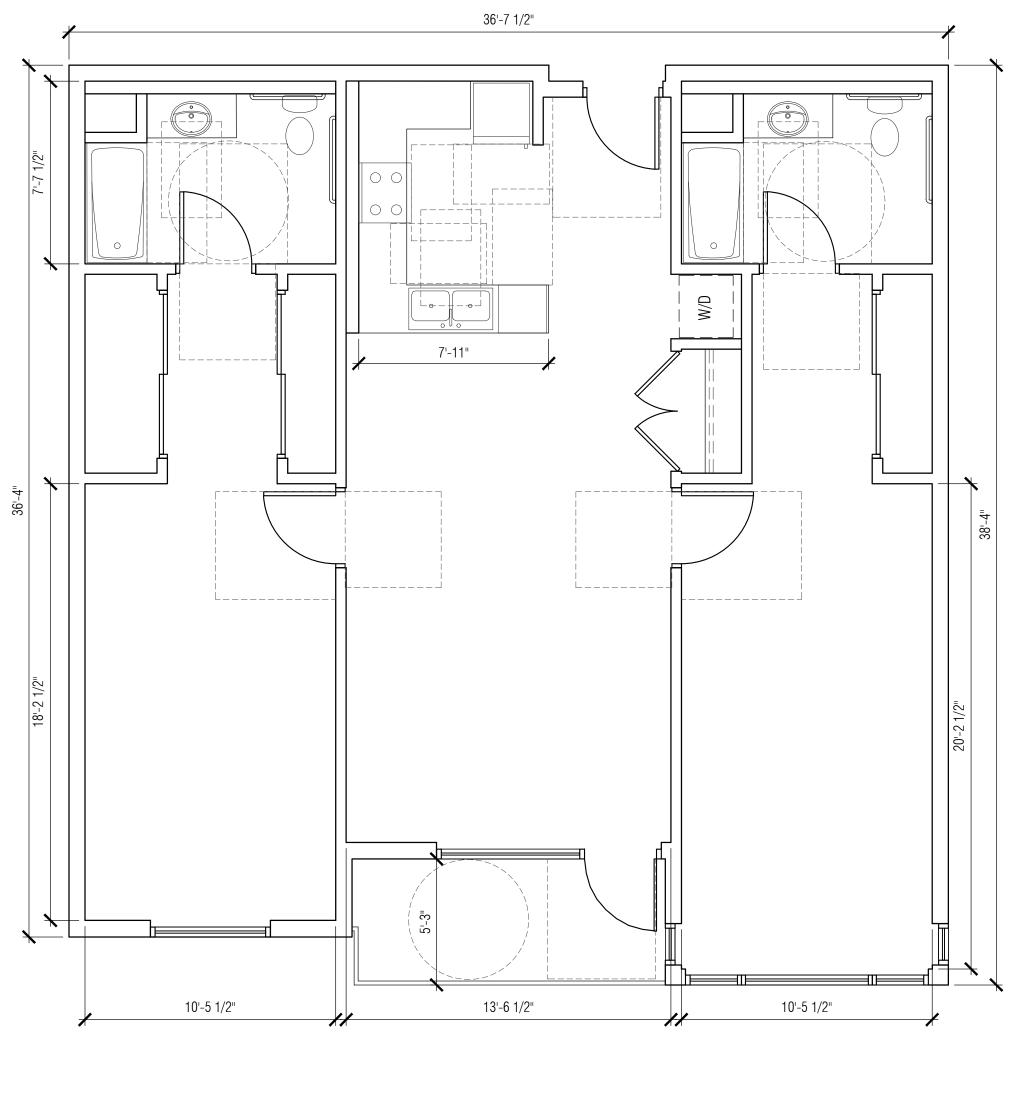

UNIT B.1 (ADA) - 1212 SF SCALE: 1/4" = 1'-0"

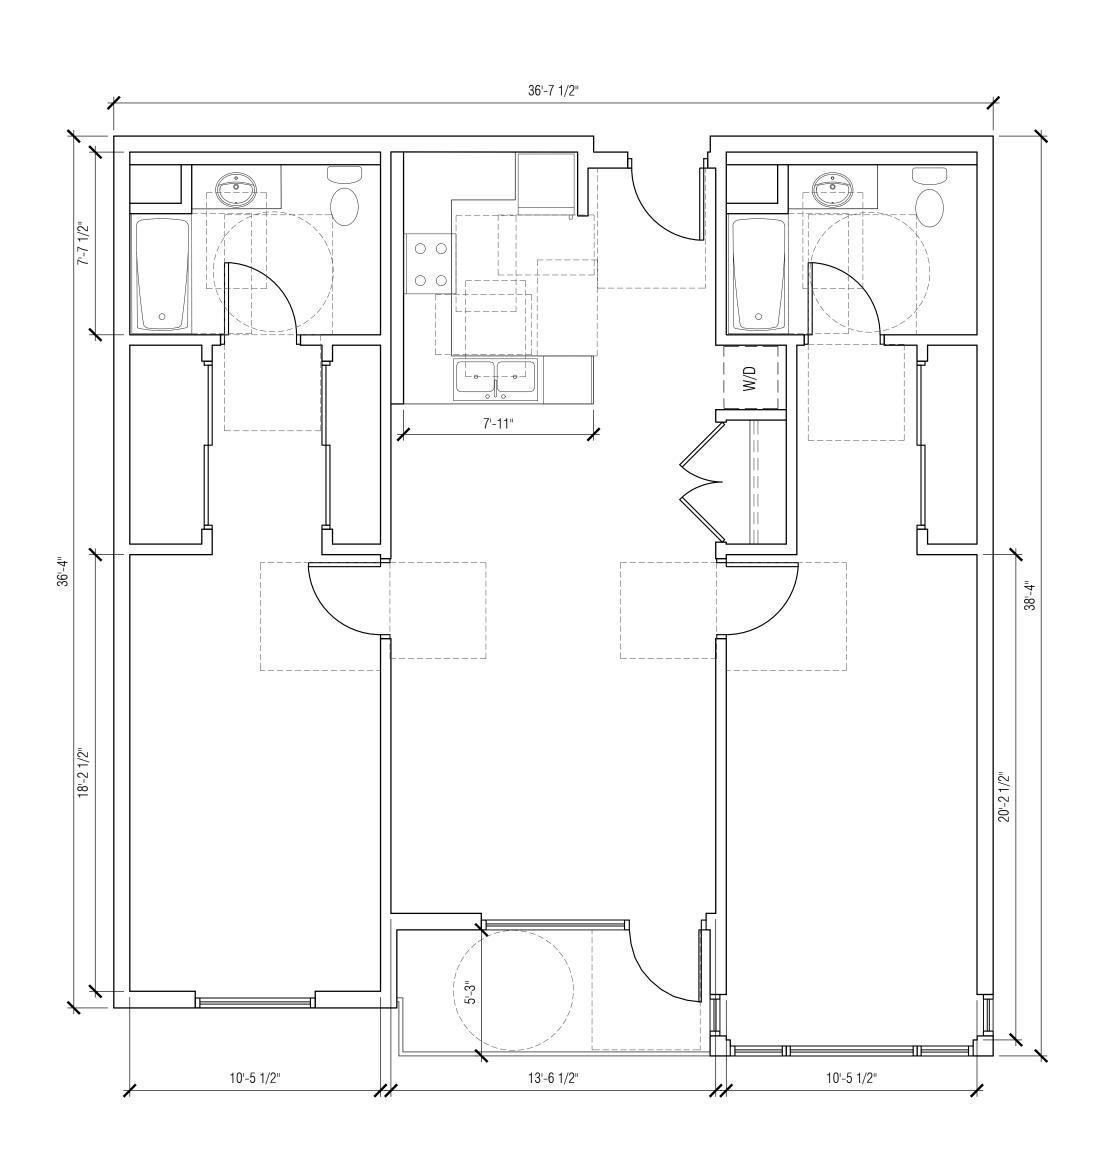

UNIT B - 1212 SF SCALE: 1/4" = 1'-0"

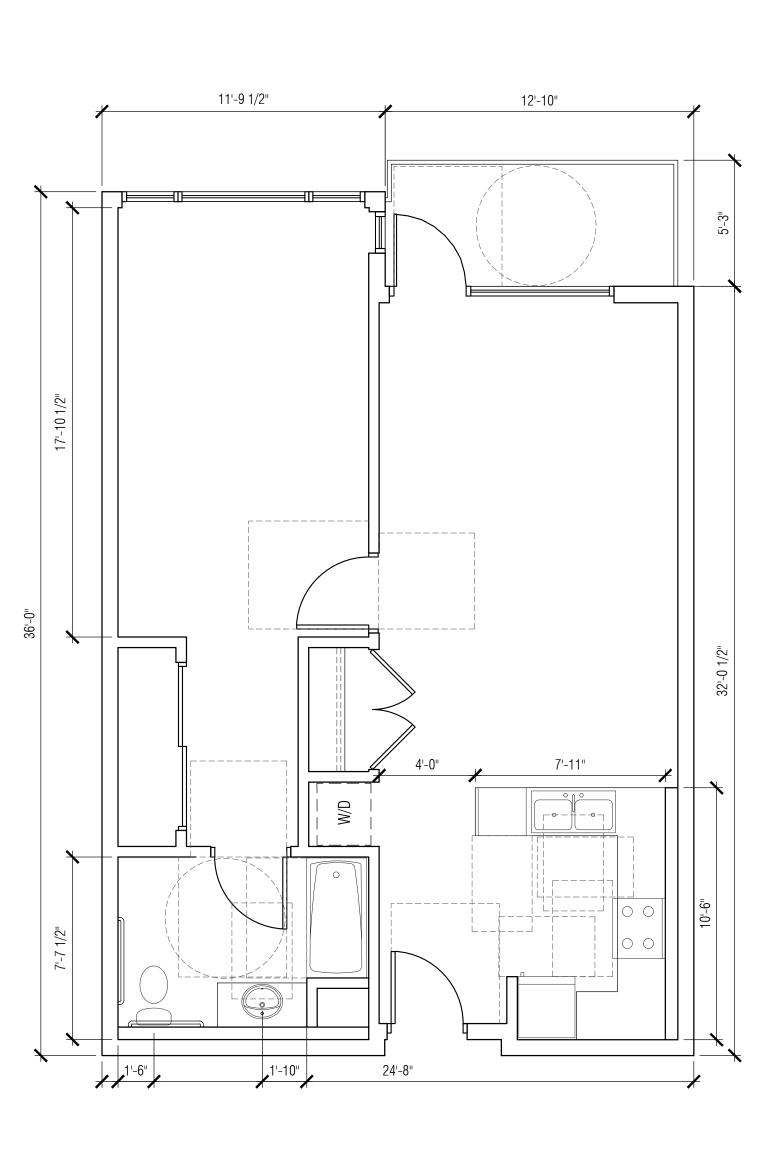



4

FILE:


FILE:

SCALE: 1/4" = 1'-0"

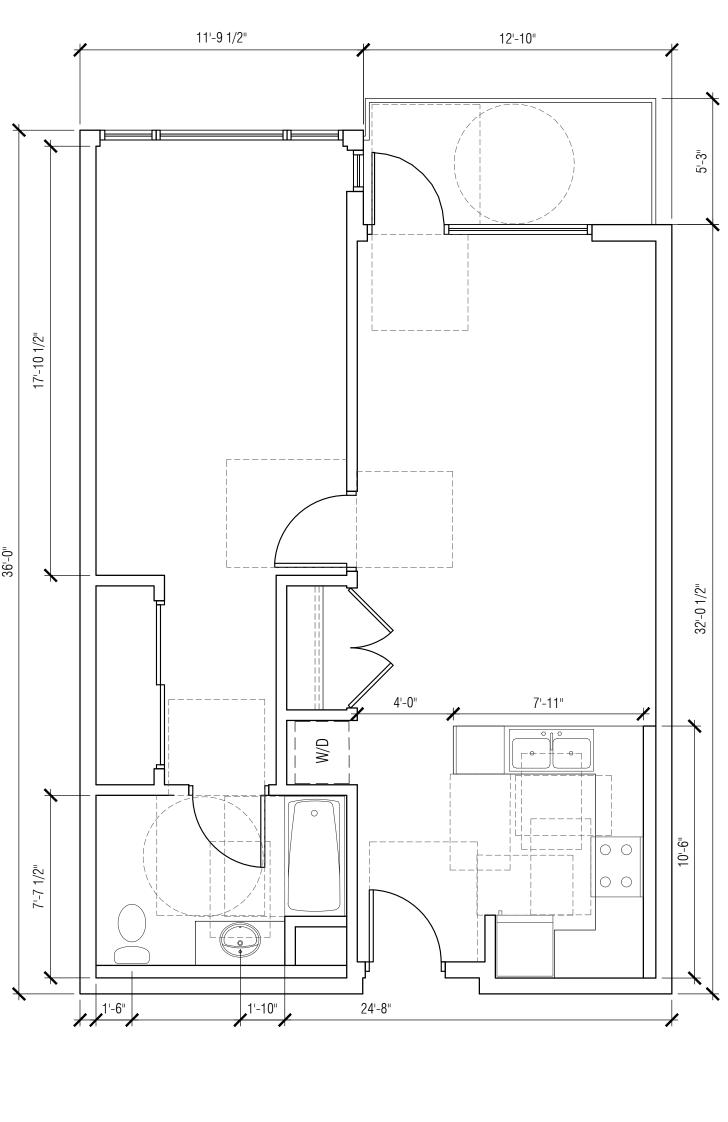


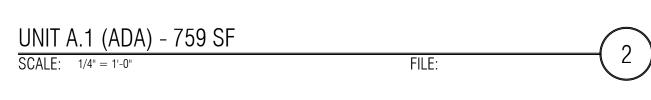


UNIT A - 759 SF SCALE: 1/4" = 1'-0"

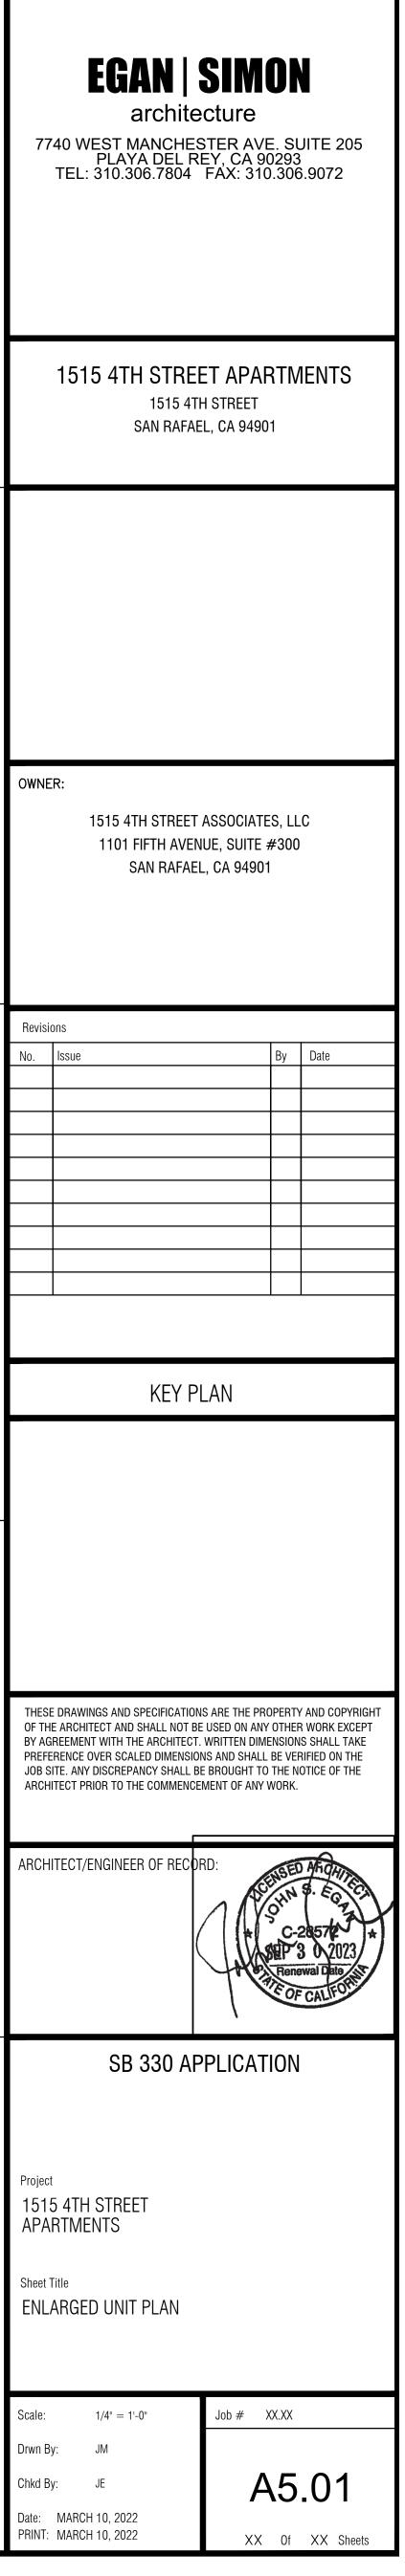

0 5'	50'	0 5'	25'	0 1'
GRAPHIC SCALES:	1/16" = 1'-0"		1/8" = 1'-0"	

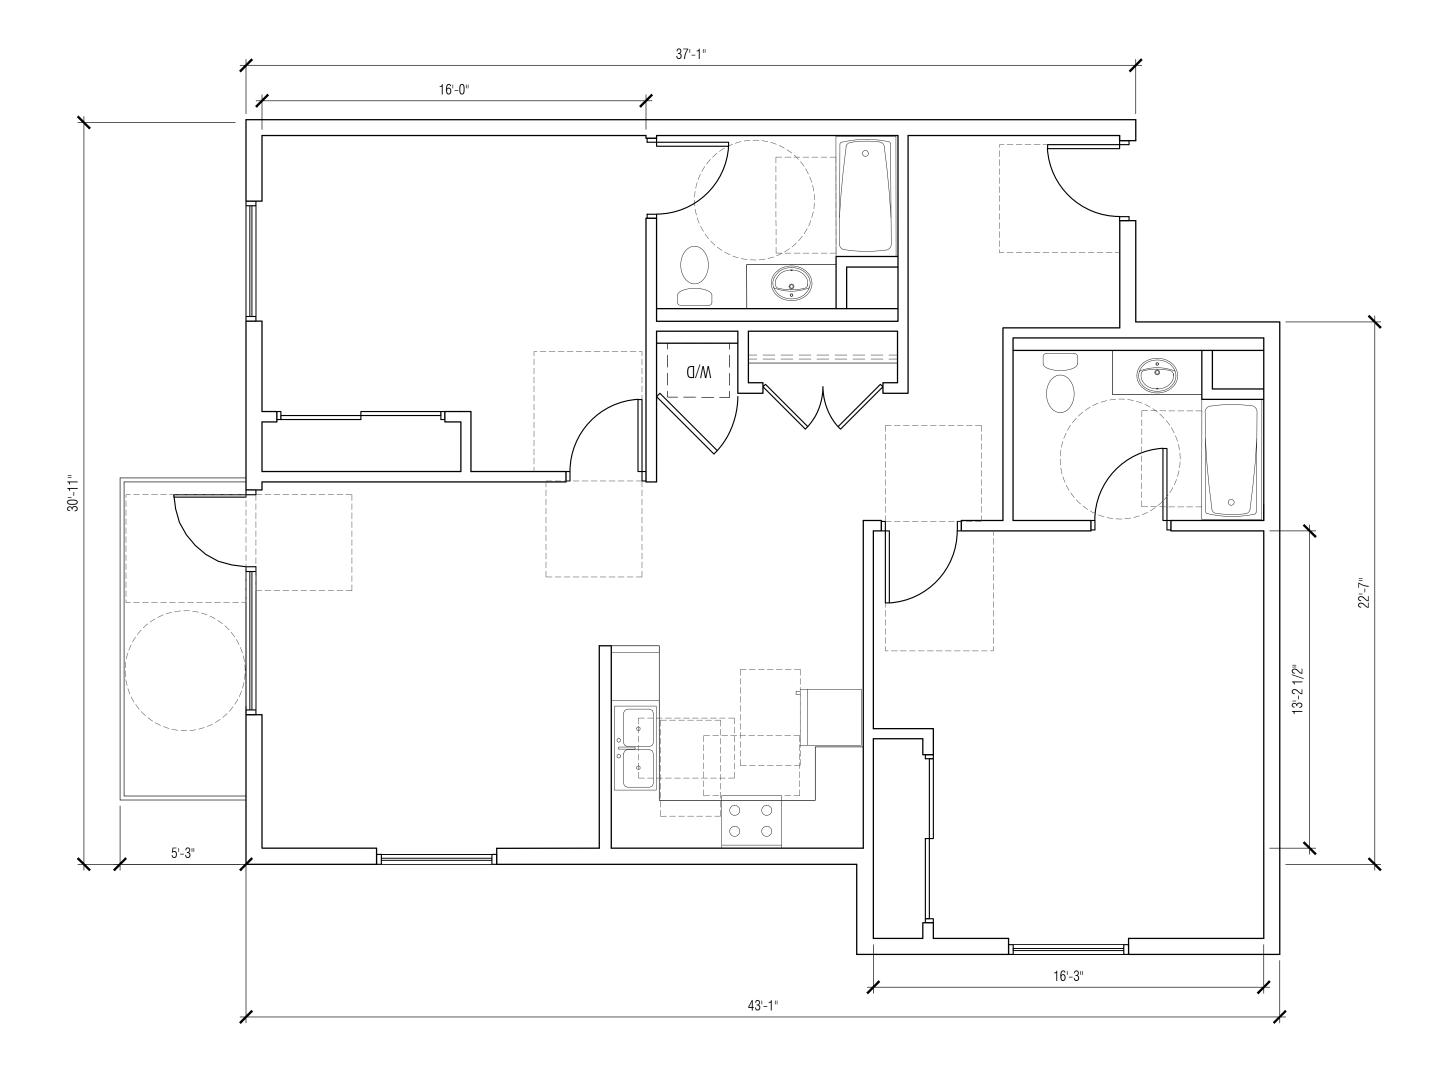


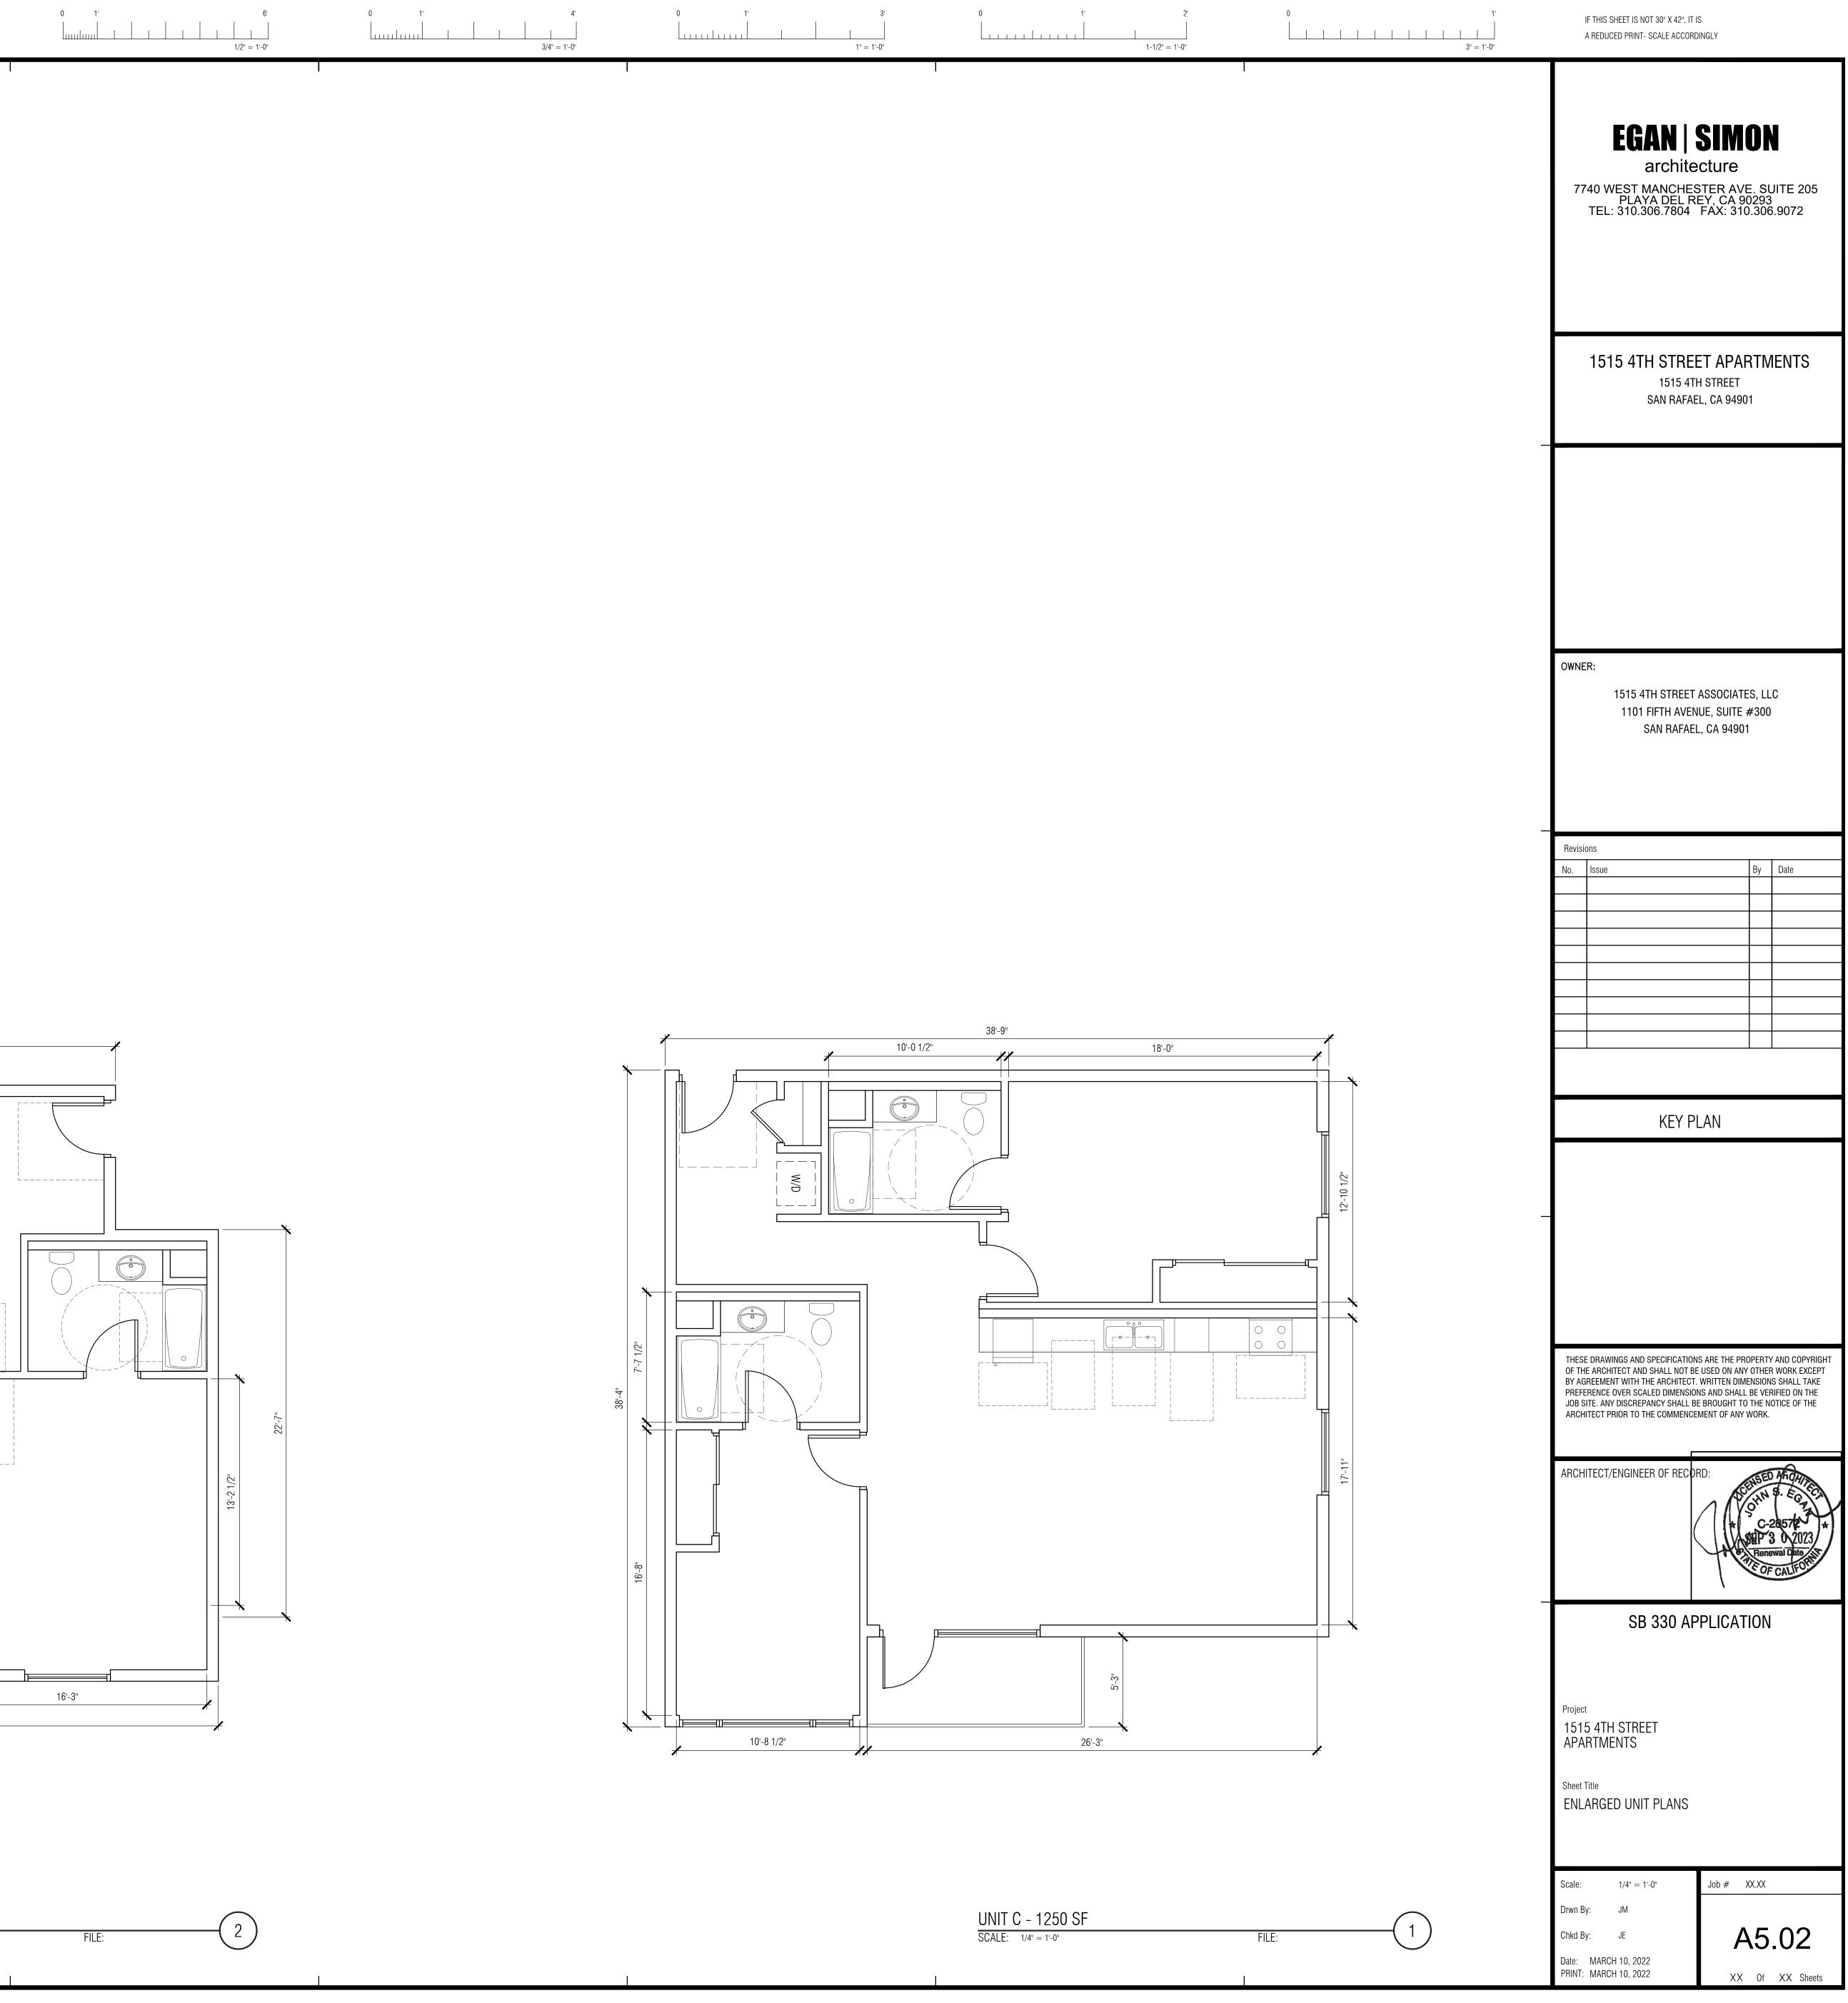



FILE:


0 5' UUUUUUUUUUUUUUUUUUUUUUUUUUUUUUUUUUUU	50' 1/16" = 1'-0"		5'	25'		0 1' 	12' 1/4" = 1'-0"
		Ι			I		



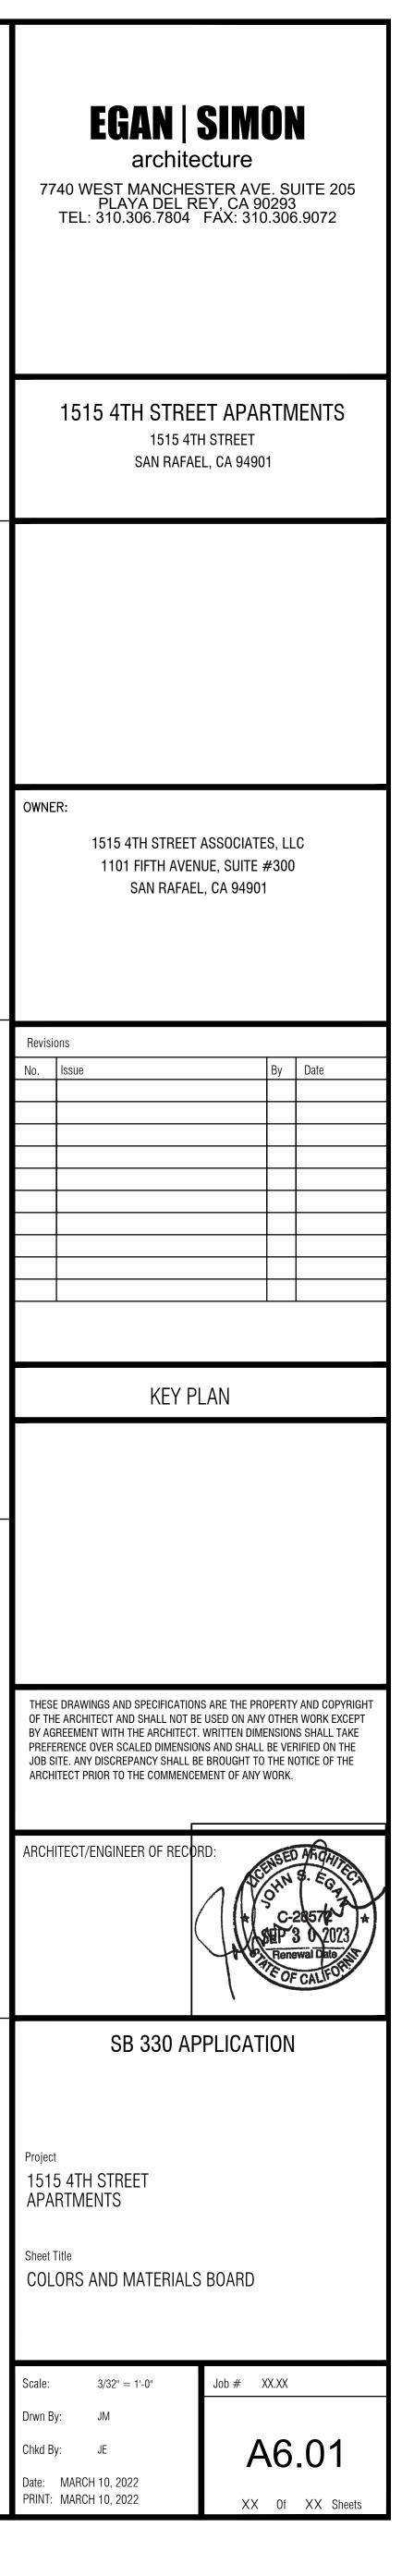

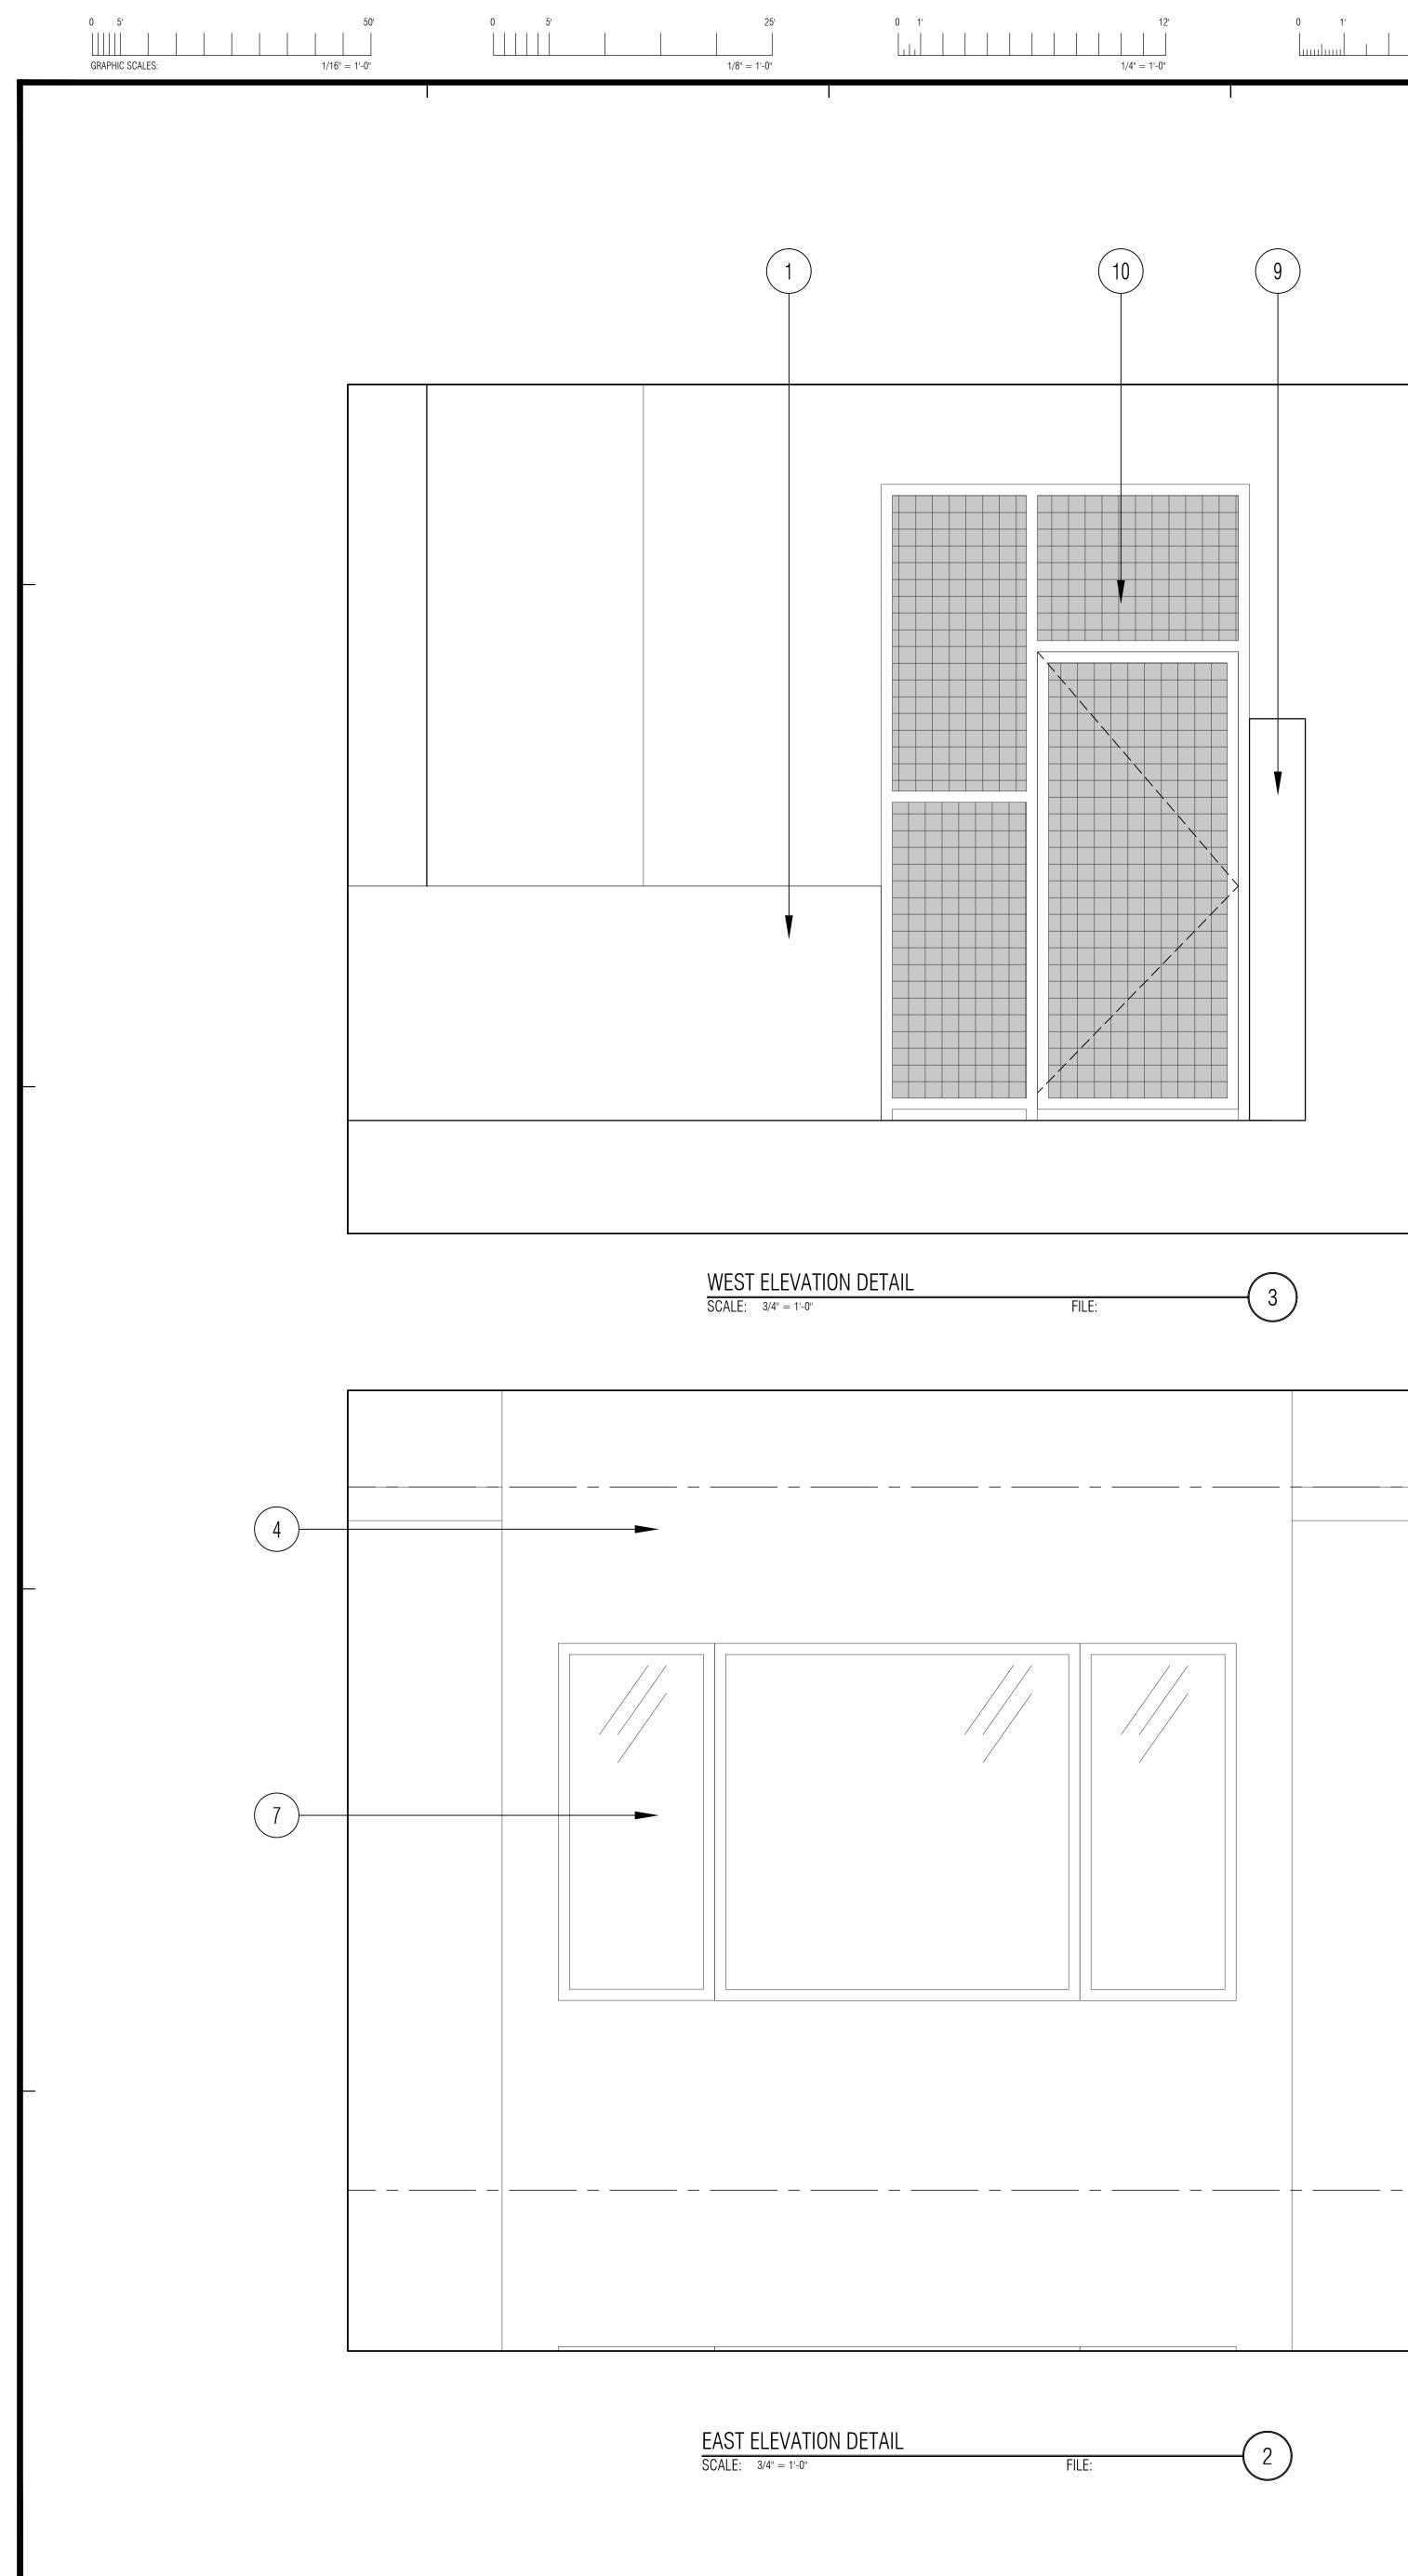

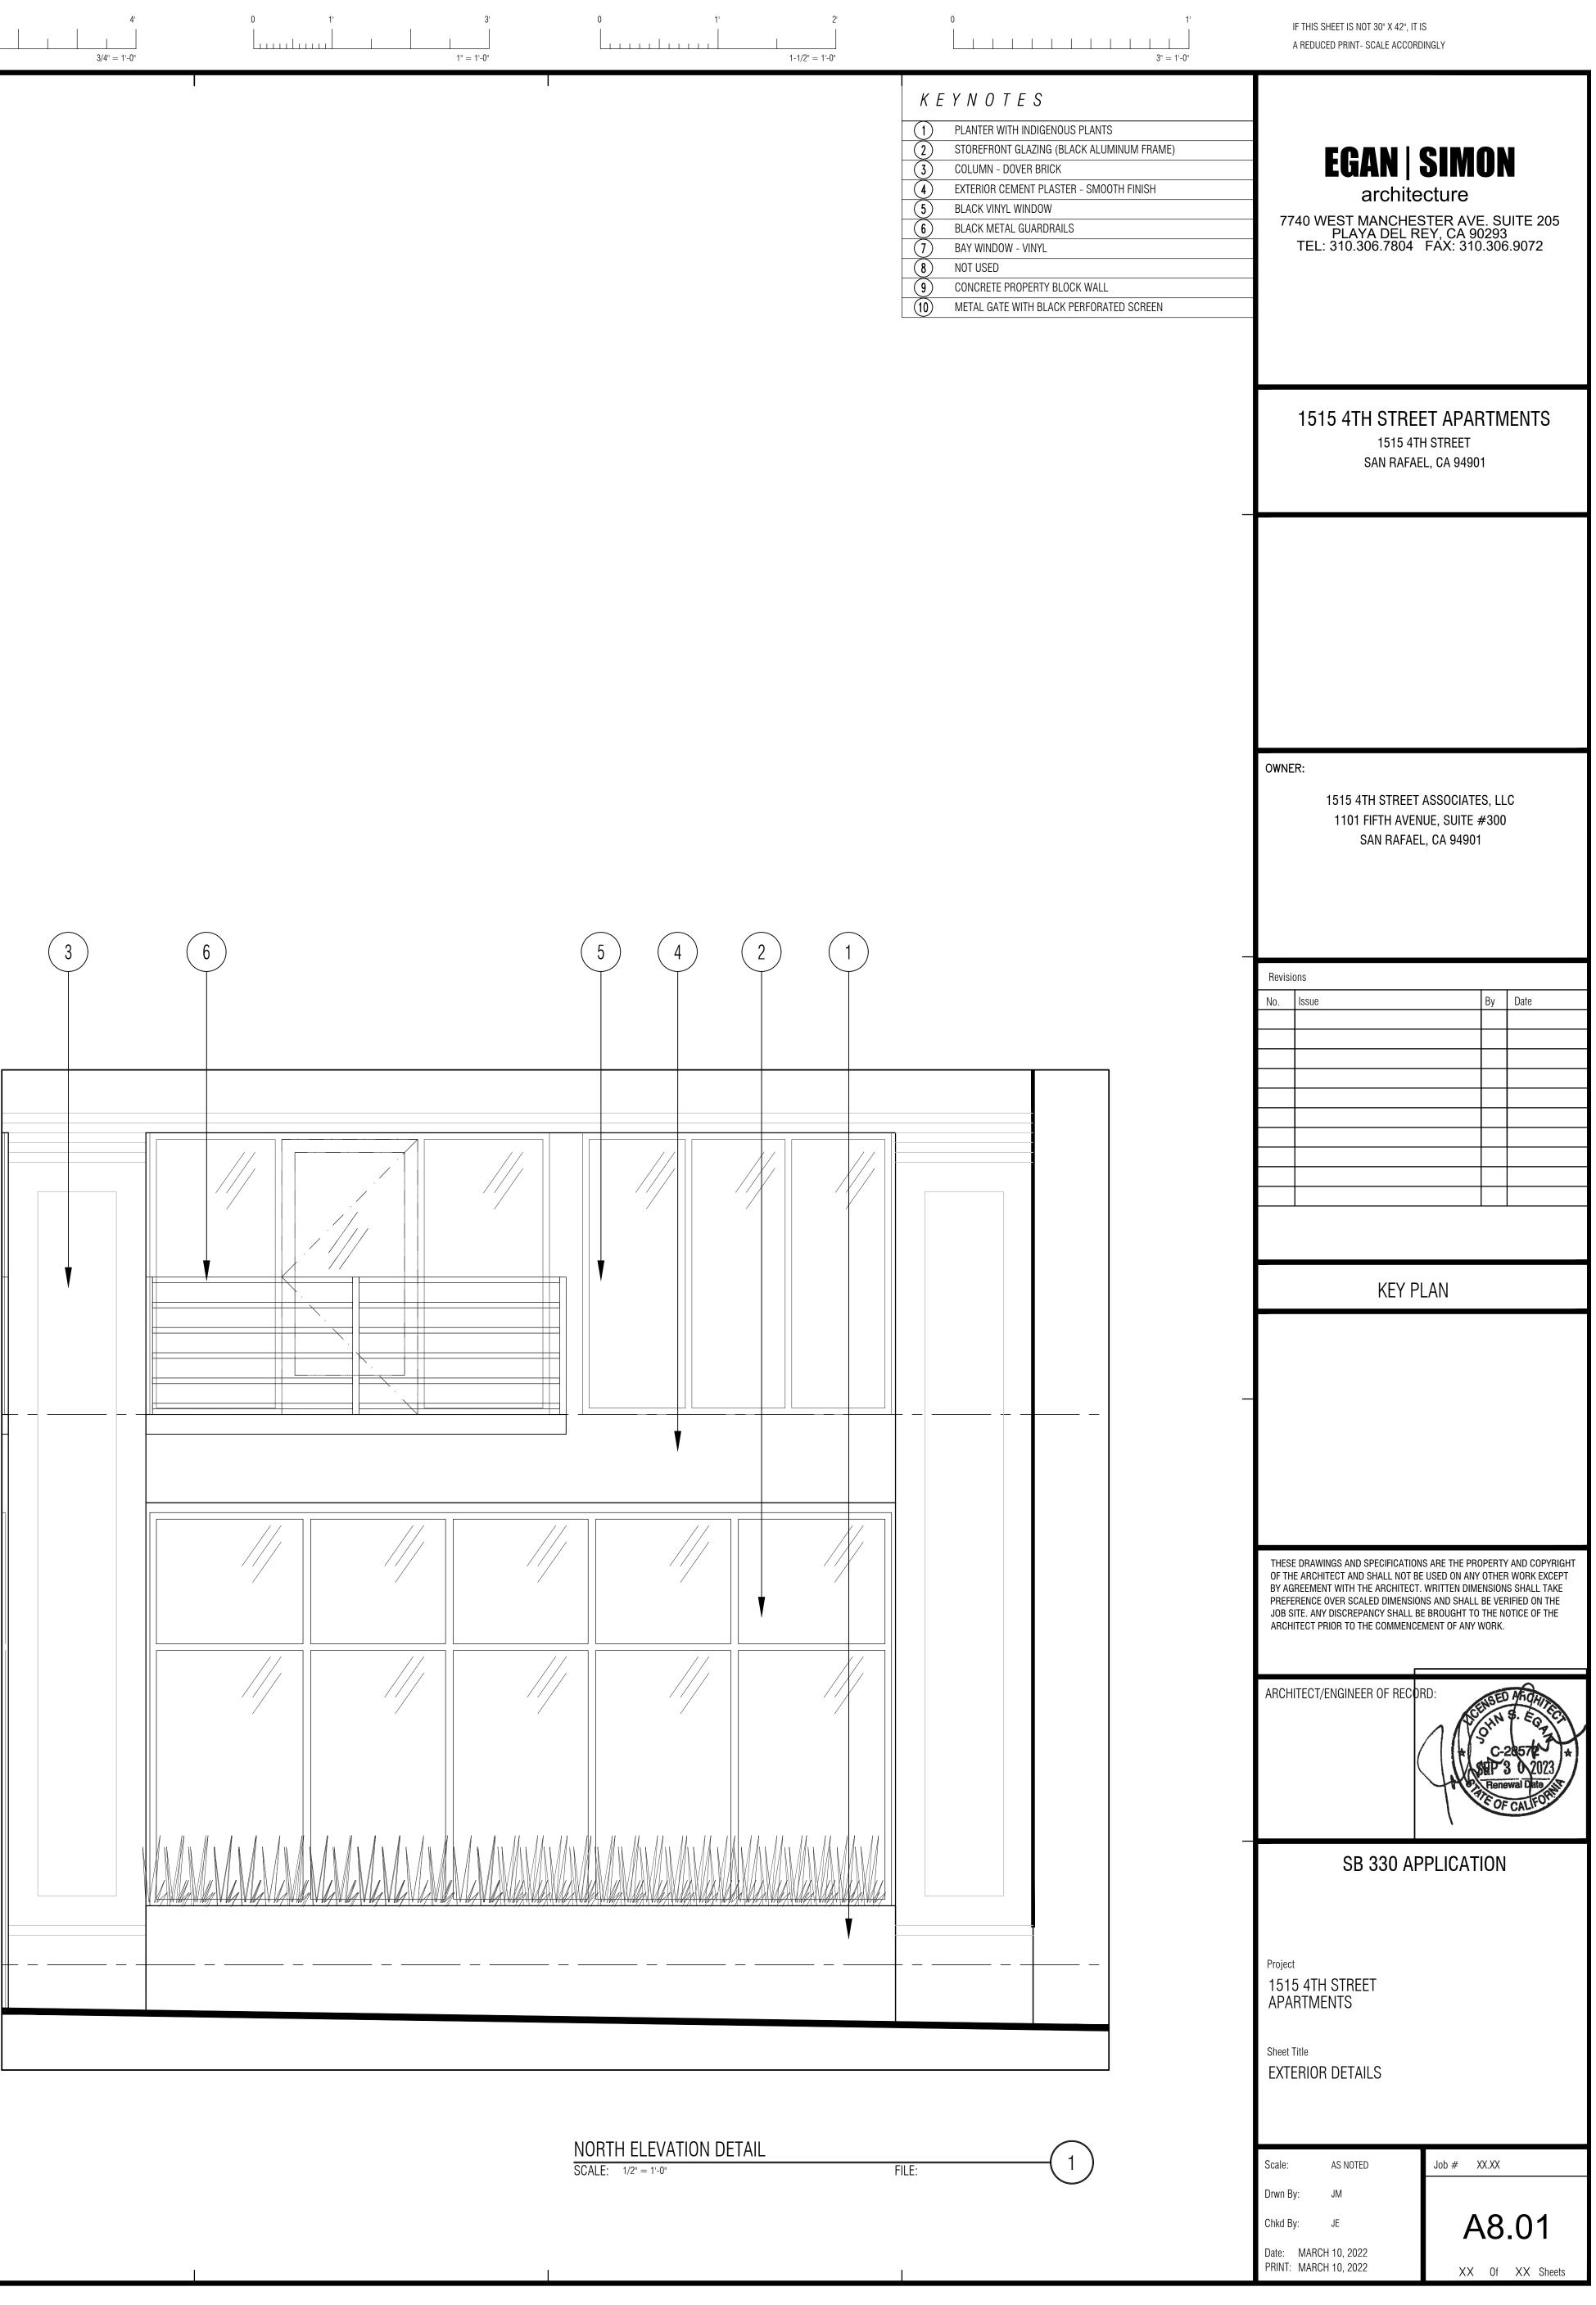

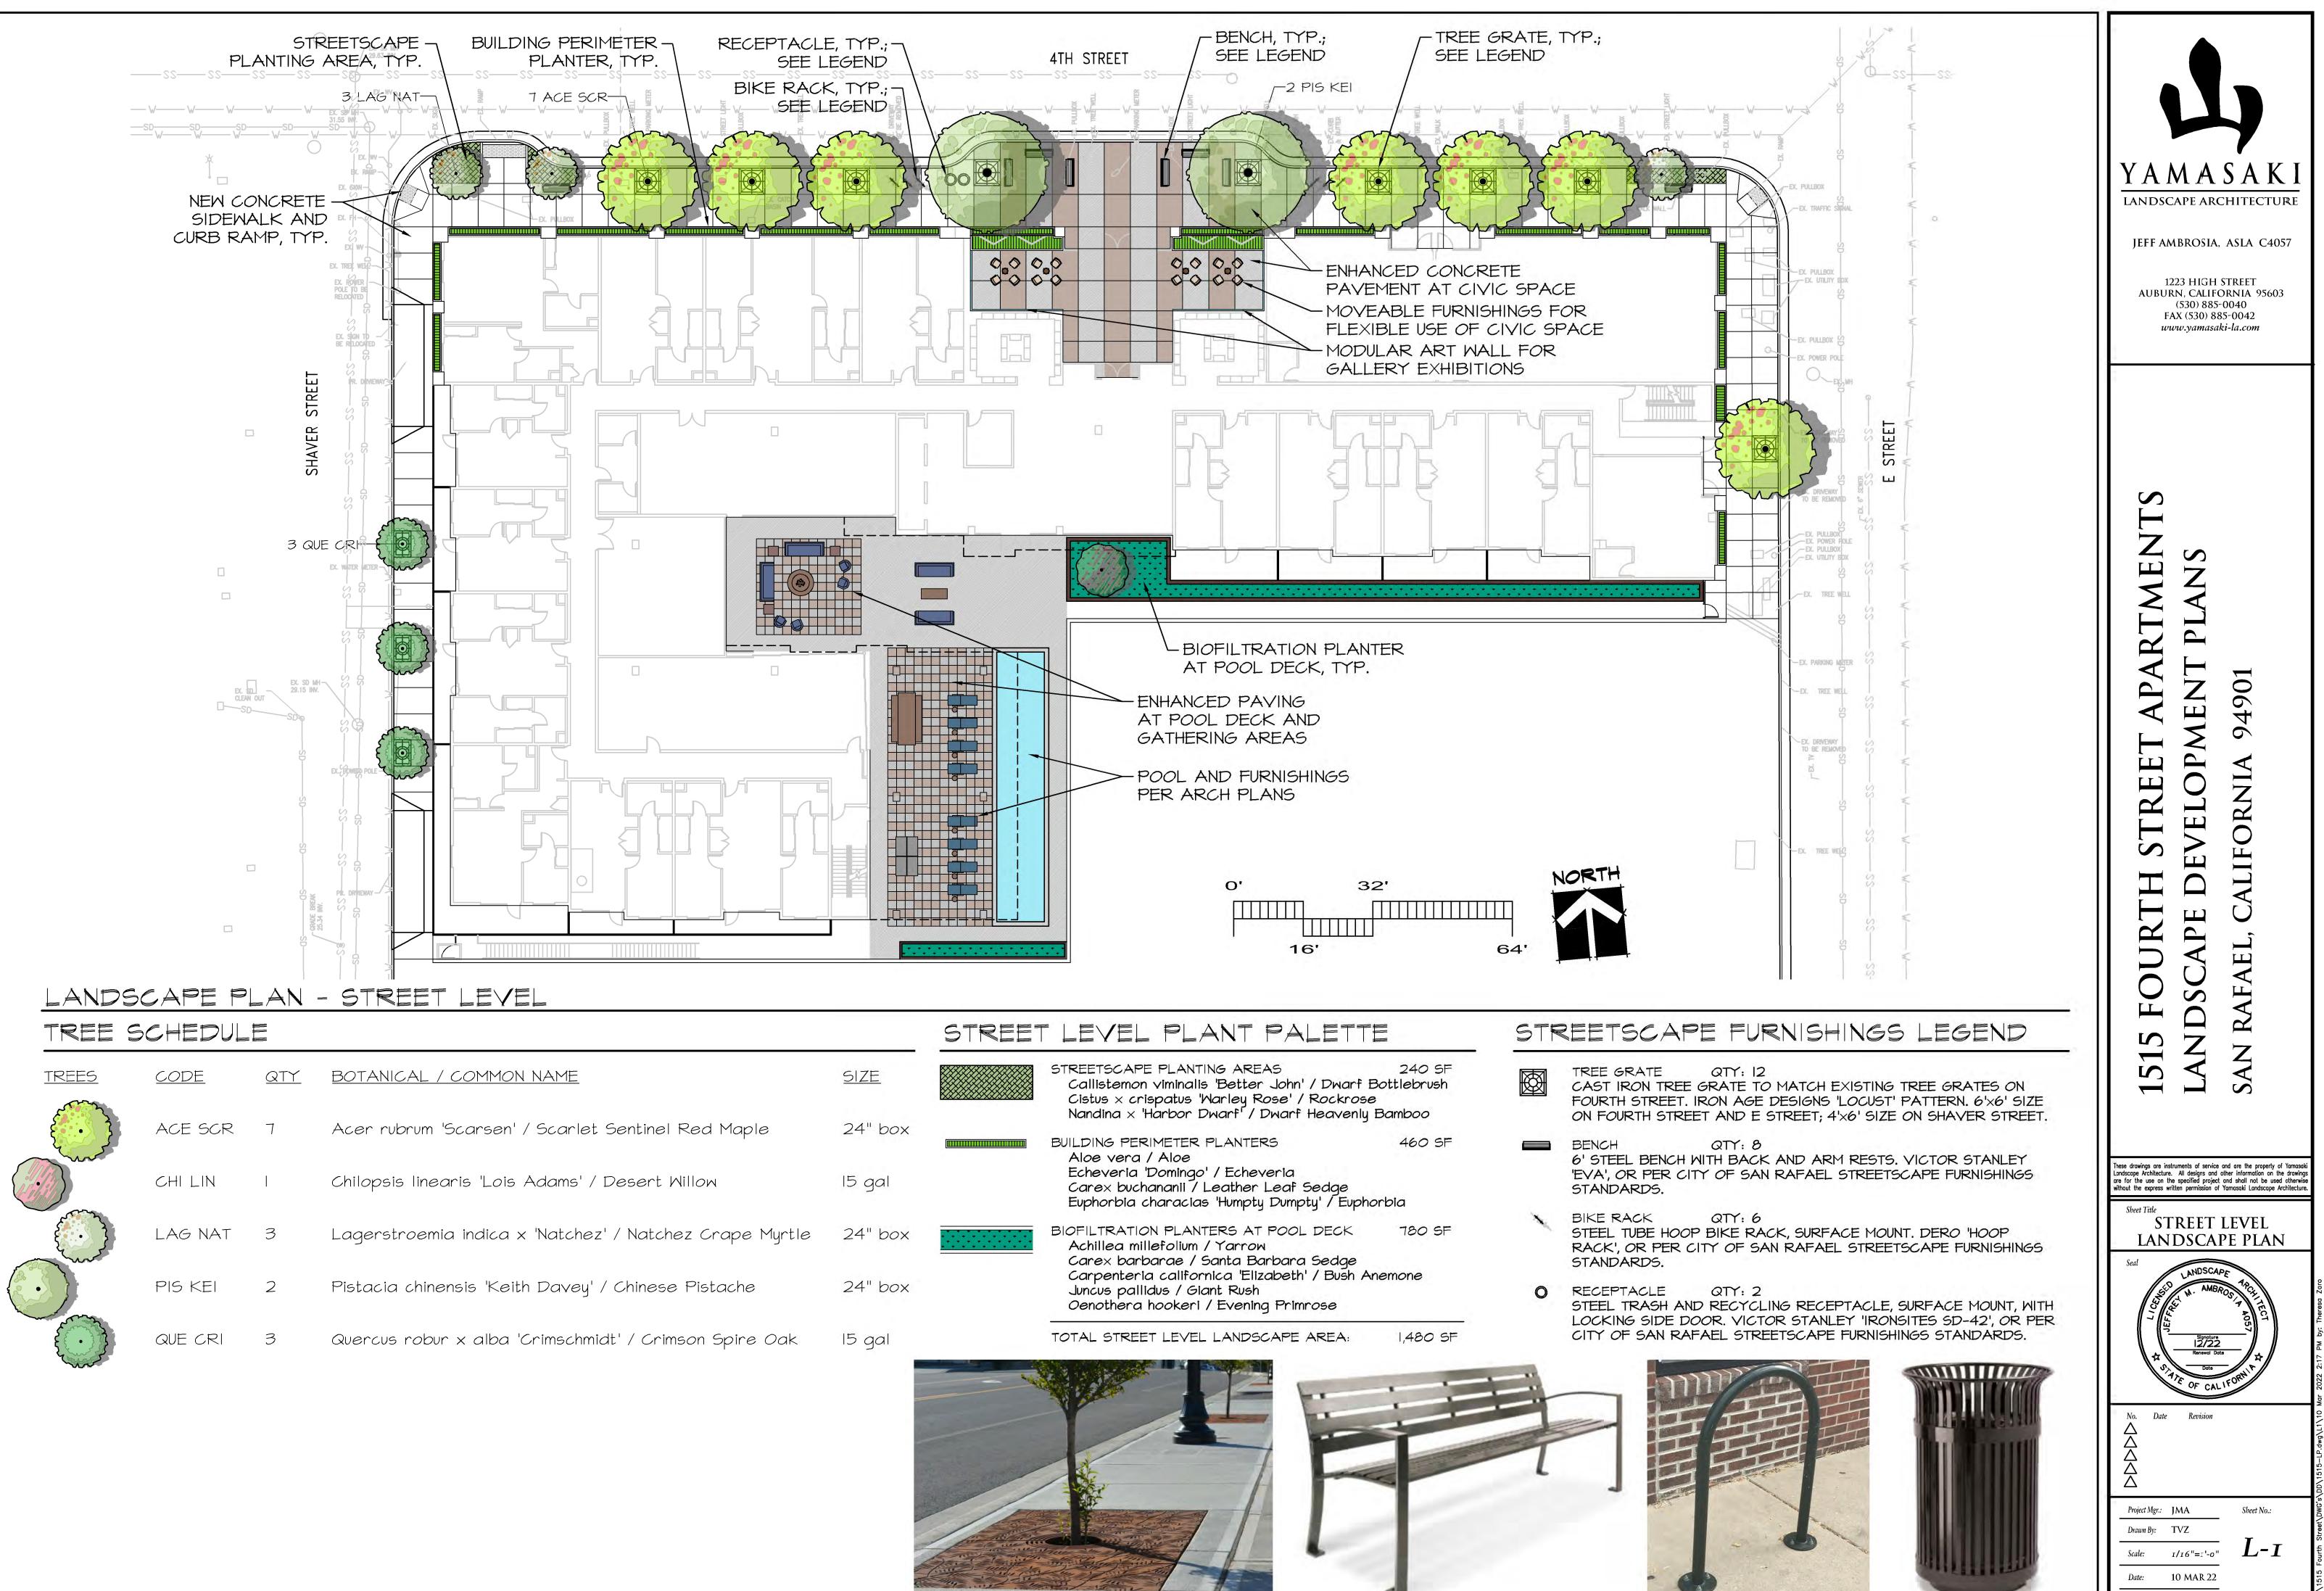


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ACE SCR	7
CHI LIN	
LAG NAT	3
PIS KEI	2
QUE CRI	З

		STREET	LEVEL PLANT PALETT		STR	REETS
	<u>SIZE</u>		STREETSCAPE PLANTING AREAS Callistemon viminalis 'Better John' / Dwarf E Cistus × crispatus 'Warley Rose' / Rockrose Nandina × 'Harbor Dwarf' / Dwarf Heavenly	3		TREE GR CAST IR FOURTH ON FOUR
ole	24" box 15 gal		BUILDING PERIMETER PLANTERS Aloe vera / Aloe Echeveria 'Domingo' / Echeveria Carex buchananii / Leather Leaf Sedge Euphorbia characias 'Humpty Dumpty' / Eupho	460 SF orbia		BENCH 6' STEEL 'EVA', <i>O</i> F STANDA
e Myrtle	24" box		BIOFILTRATION PLANTERS AT POOL DECK Achillea millefolium / Yarrow Carex barbarae / Santa Barbara Sedge Carpenteria californica 'Elizabeth' / Bush A	780 SF	×	BIKE RA STEEL TI RACK', C STANDA
e	24" box		Juncus pallidus / Giant Rush Oenothera hookeri / Evening Primrose		0	RECEPT, STEEL T LOCKING
e Oak	15 gal		<image/>	I,480 SF	Ĩ	CITY OF


File Name: 1515-LP


of _____

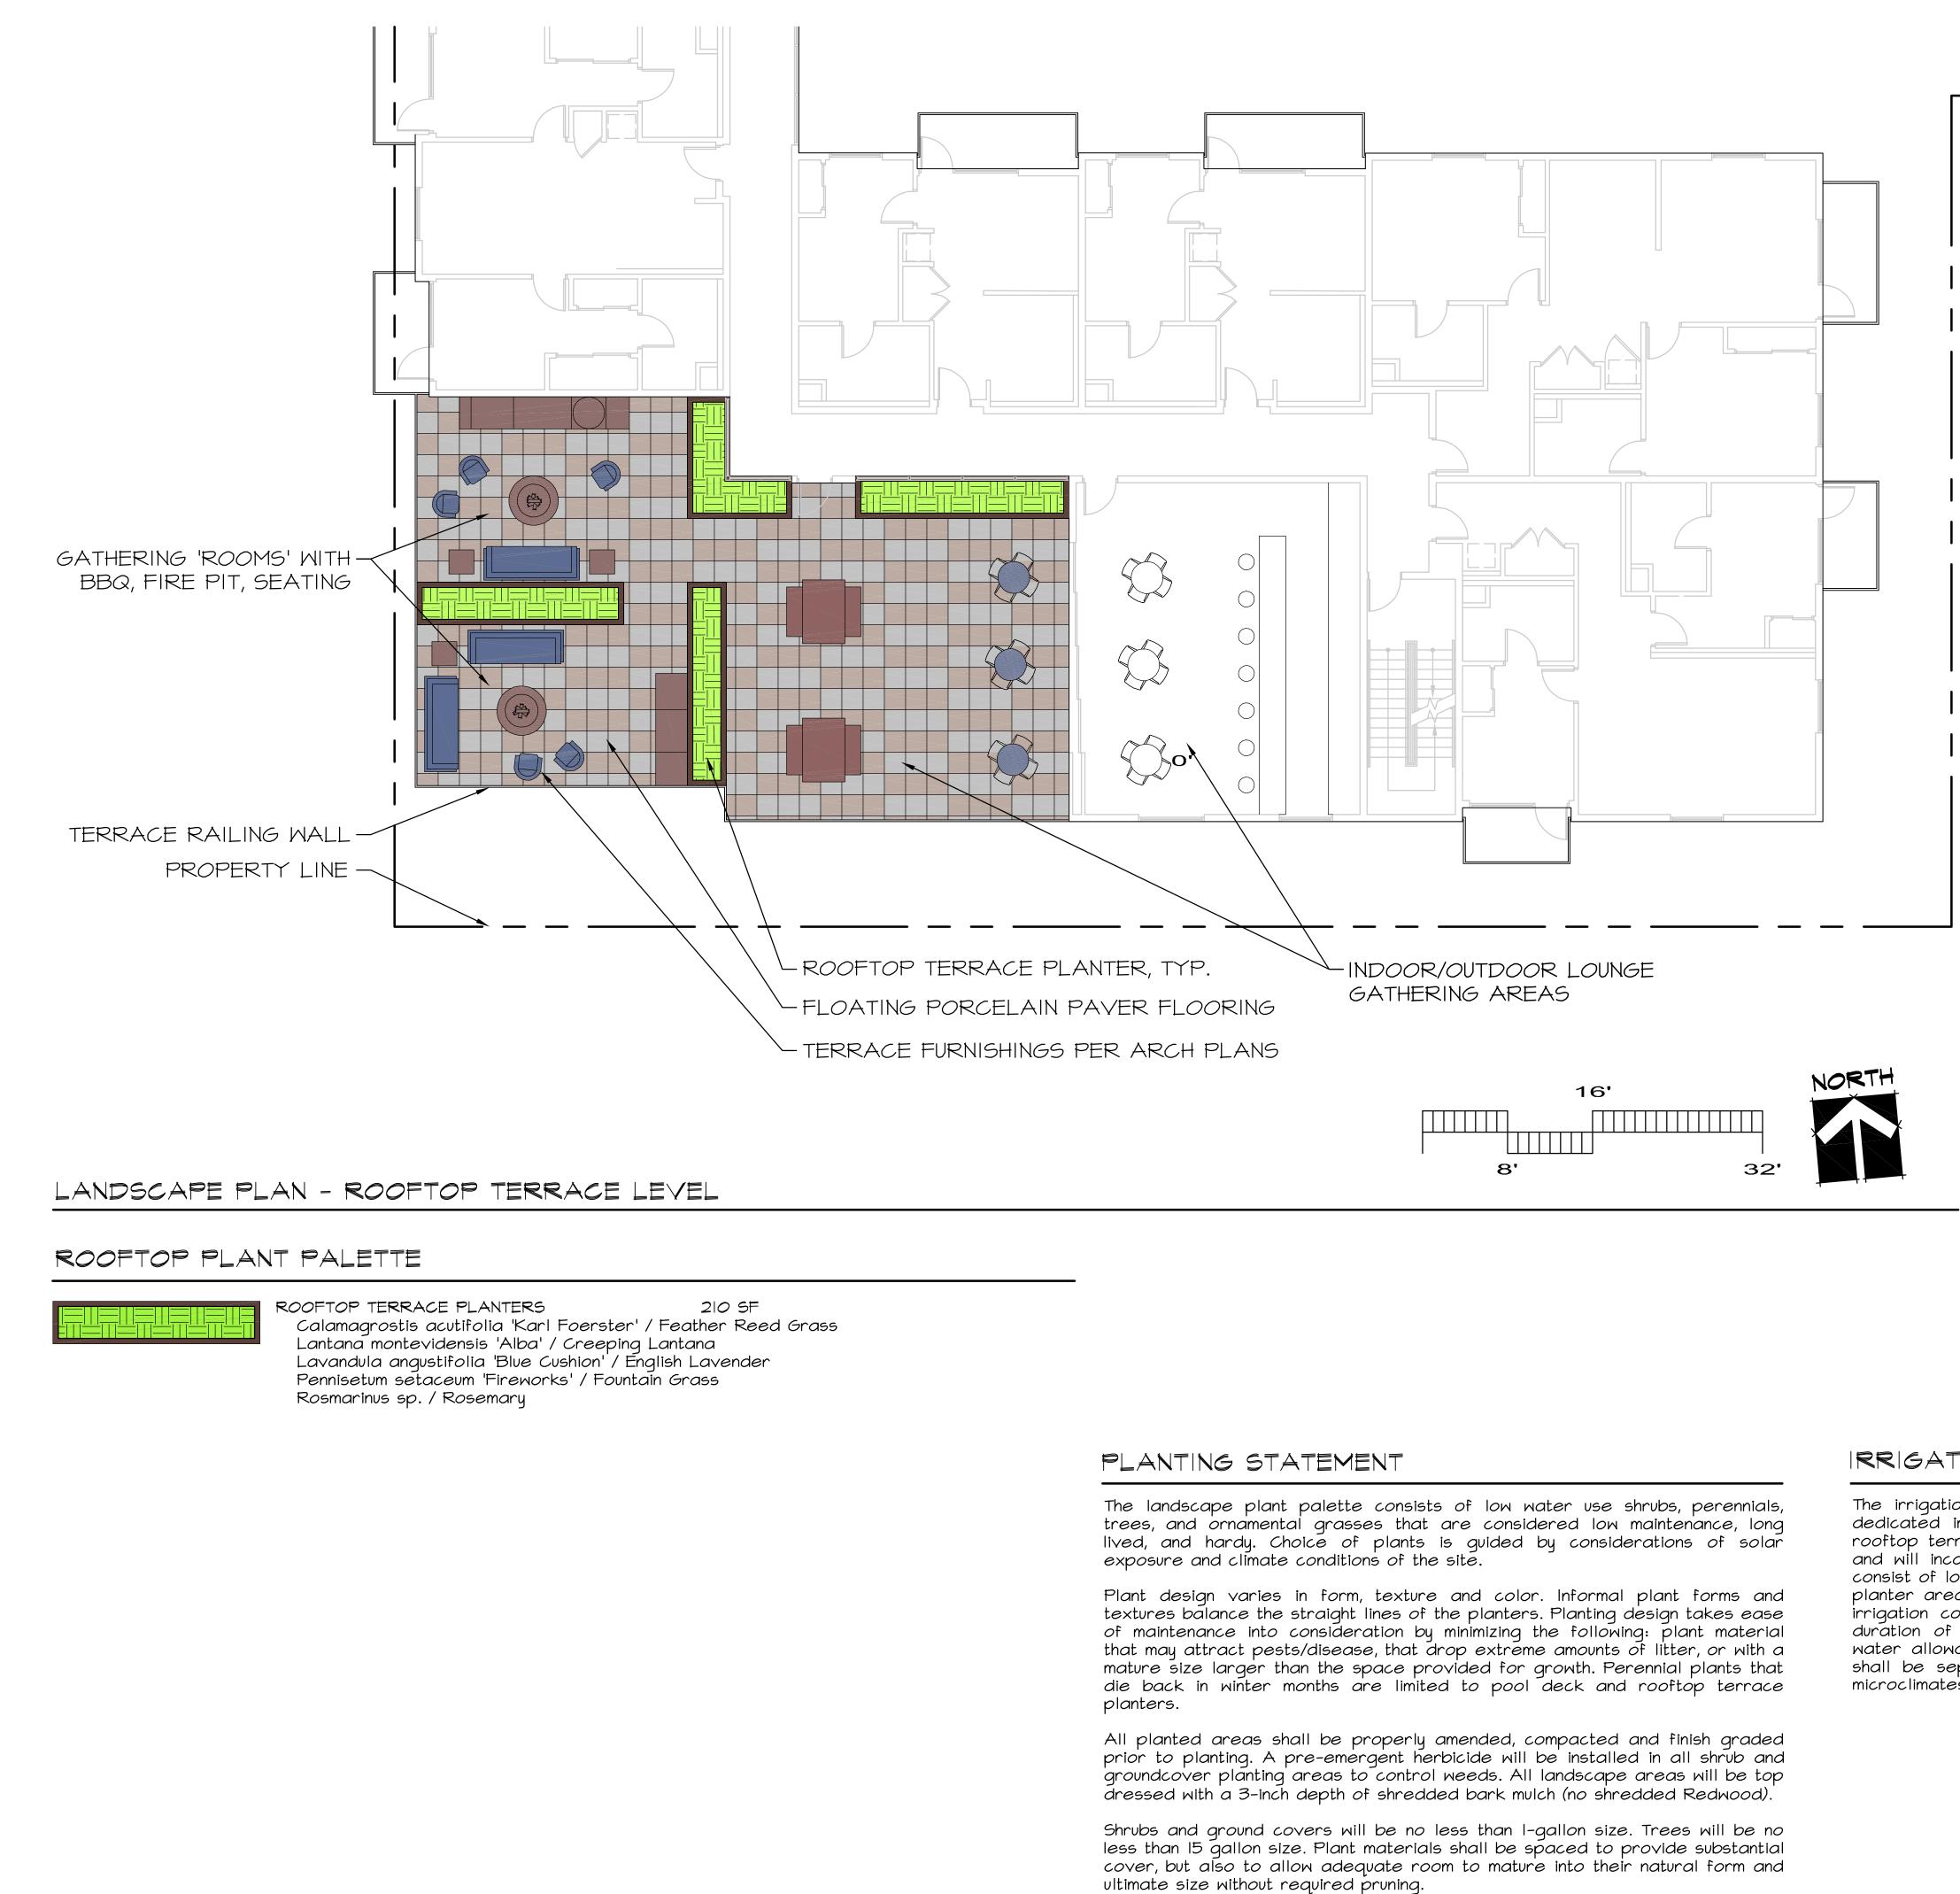


IRRIGATION STATEMENT


The irrigation system for street-level landscape will be serviced by a new dedicated irrigation water meter and point of connection. Irrigation at the rooftop terrace planters will be serviced by the domestic water service line and will incorporate backflow prevention equipment. The irrigation design will consist of low volume point source drip irrigation in planters and in streetscape planter areas; and surface bubblers at trees. The system will include a smart irrigation controller with weather sensing capabilities to automatically adjust duration of application based on current evapotranspiration data. Maximum water allowance will be determined by State MWELO code. Irrigation stations shall be separated by hydrozones - areas with similar watering needs and microclimates.

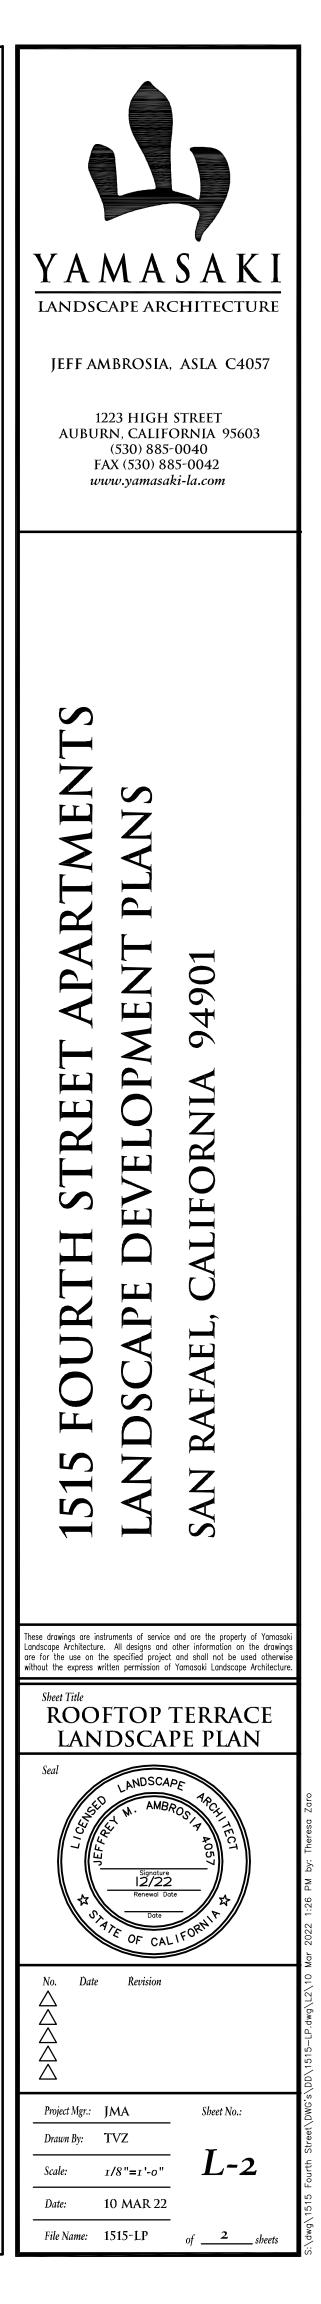


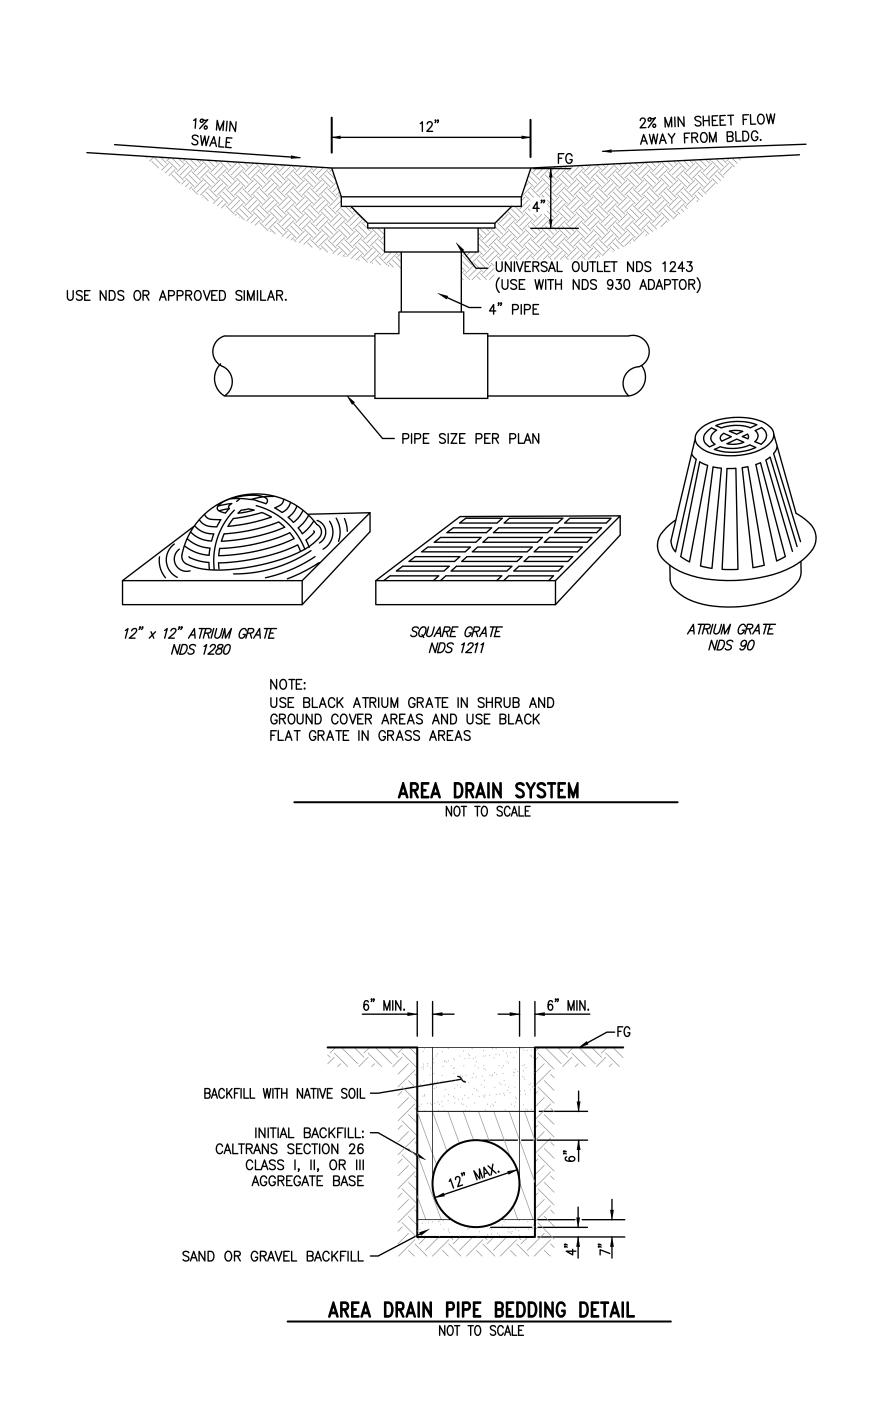


CONCEPTUAL GRADING PLAN IN THE CITY OF SAN RAFAEL, COUNTY OF MARIN, STATE OF CALIFORNIA

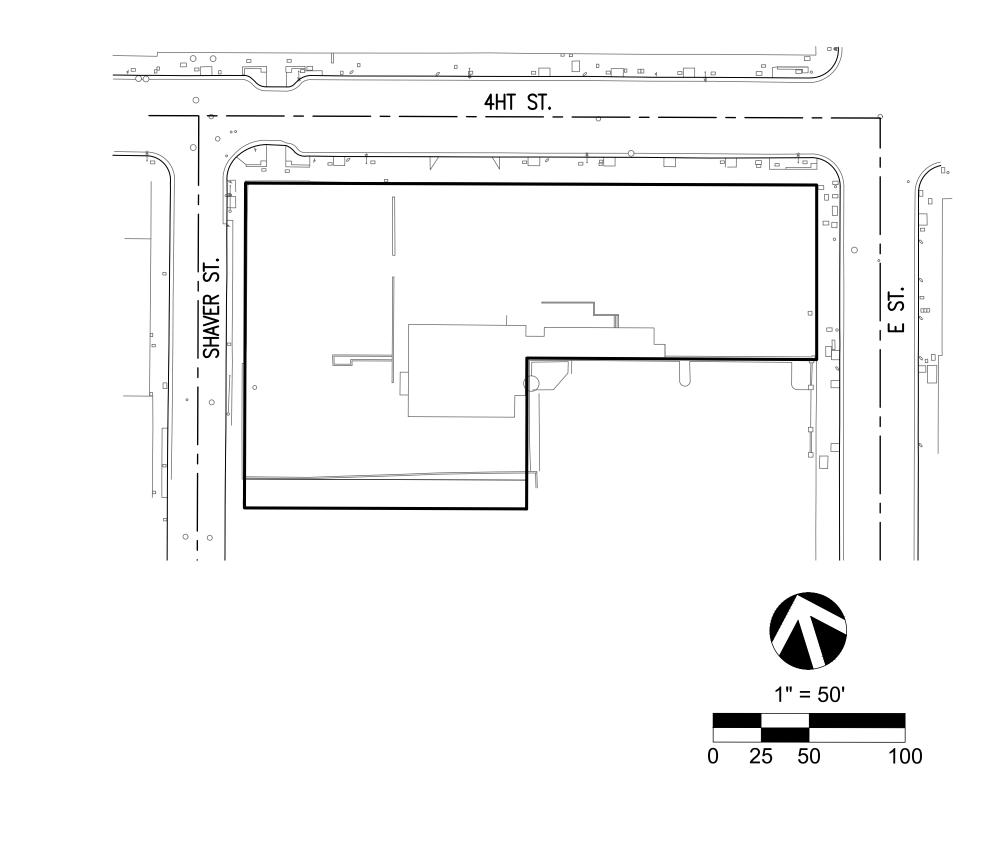

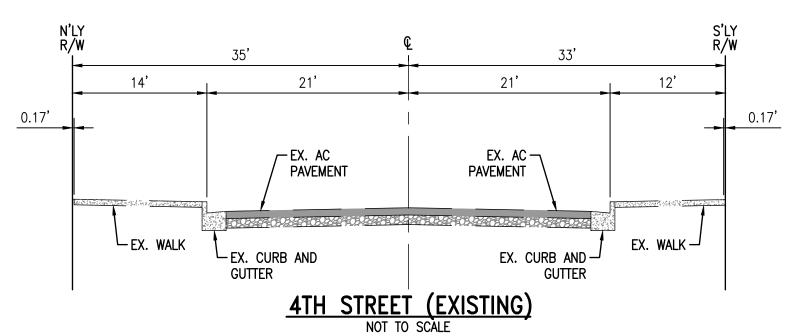

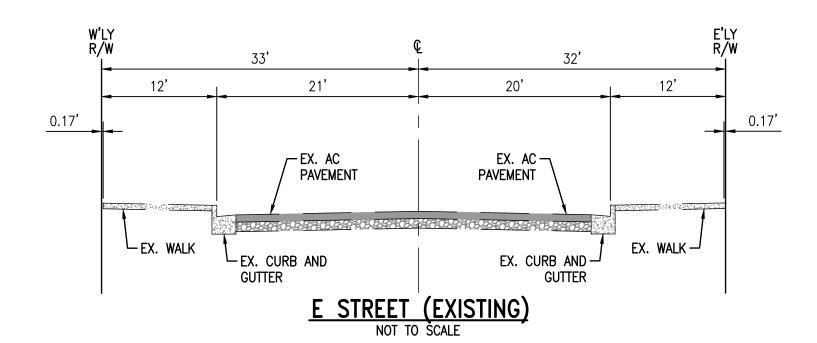

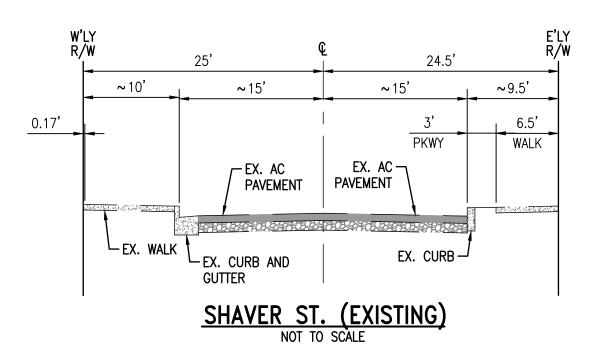



C1.0	TIT	ĽΕ	SHEET	AND	DETAILS	
C1.1	L1	GR	ADING	AND	DRAINAGE	PLA
C1.2	P1	GF	RADING	AND	DRAINAGE	PLA

- P2 GRADING AND DRAINAGE PLAN C1.3 SEDIMENT AND EROSION CONTROL PLAN C1.4
- C2.0 CONCEPTUAL UTILITY PLAN

EARTHWORK QUANTITY ESTIMATE:

ITEM (QUANTITIES FOR BON	DING PURPOSES ONLY)	UANTI
RAW CUT	1:	9648 CY
FOUNDATION SPOILS		2856 CY
OVER EXCAVATION (AVG. 1' OVER	WORK AREA)*	N/A
SHRINKAGE (CUT + OVER EX @15	5%)*	N/A
RAW FILL		50 CY
NET IMPORT/EXPORT	19648+2856-50=22454 CY	EXPORT

ABBREVIATIONS

AGGREGATE BASE
ABANDONED
ASPHALTIC CONCRETE
AREA DRAIN
BOTTOM OF WALL
CENTER LINE
CATCH BASIN
CORRUGATED STEEL PIPE
DOMESTIC WATER
EASTERLY
EXISTING GRADE
EXISTING
FINISHED GRADE
FIRE HYDRANT
FLOW LINE
TOP OF FENCE
FINISHED SURFACE
FIRE WATER
GRADE BREAK
GARAGE FINISHED FLOOR
HIGH POINT
INVERT
LANDSCAPE AREA
LOT LINE
LOW POINT
MINIMUM
MISCELLANEOUS

OWNER:

TOWNSEND CAPITAL PARTNERS, LLC 1101 5TH AVE, SUITE 300 SAN RAFAEL, CA 94901 (415)-456-0600

ARCHITECT: DESIGN DRAW BUILD INC. 2866 WEBSTER ST. OAKLAND, CA 94609 (510) 833–2643 CONTACT: TYLER KOBICK

CIVIL ENGINEER:

MFKESSLER ONE VENTURE, STE. 130 IRVINE, CA 92618 (949) 339–5330

ADDRESS: 7515 ALDER AVE. & 8145 GRAVENSTEIN HWY. COTATI, CA 94931

PROPERTY ADDRESS: APN: 144-040011 & 144-040-021

LAND AREA: 244,968 SQUARE FEET (5.62 ACRES)

ZONING: CG – COMMERCIAL GRAVENSTEIN CORRIDOR

FLOOD ZONE:

FLOOD ZONE X – AREAS DETERMINED TO BE OUTSIDE THE 0.2% ANNUAL CHANCE FLOOD PLAIN (500-YEAR FLOOD). COMMUNITY MAP NO. 06097C0878E DATED: DECEMBER 02, 2008.

UTILITY PURVEYORS:

<u>SEWER</u> CITY OF COTATI PUBLIC WORKS DEPARTMENT (707) 665–3631

<u>STORM DRAIN</u> CITY OF COTATI PUBLIC WORKS DEPARTMENT (707) 665–3638

<u>WATER</u> CITY OF COTATI PUBLIC WORKS DEPARTMENT (707)665–3631

<u>ELECTRICITY</u> PG&E

(800) 743–5000

<u>GAS</u> PG&E (800) 743–5000

<u>TELEPHONE</u> AT&T

(855) 837–9042

<u>TRASH/REFUSE</u> RECOLOGY SONOMA MARIN (800) 243–0291

<u>LEGEND</u> ------ FLOWLINE

CENTERLINE DAYLIGHT LINE ------ TRACT BOUNDARY _____ LOT LINE EX. STORM DRAIN LINE PROP. STORM DRAIN

0

JUNCTION STRUCTURE EX. WATER LINE PROP. WATER LINE FIRE HYDRANT

CATCH BASIN/LOCAL

DEPRESSION

RIGHT-OF-WAY LINE

EX. SEWER LINE PROP. SEWER LINE

WATER VALVE

BASIS OF BEARINGS:

THE BEARINGS SHOWN HEREON ARE BASED ON THE SOUTH LINE OF FOURTH STREET BEING SOUTH 83°45' EAST PER P.M. RECORDED IN BOOK 11 PAGE 60, IN THE COUNTY RECORDERS OFFICE OF MARIN COUNTY

SURVEY NOTE:

PROJECT SURVEY AND TOPOGRAPHY SOURCE IS SURVEY PREPARED BY ADOBE ASSOCIATES 2014.

BENCH MARK: CITY OF SAN RAFAEL BM #T-70 A PK AND TAG SET IN CONCRETE CURB AT THE INTERSECTION OF FOURTH STREET AND 'E' STREET ON THE NORTHEAST CURB RETURN. ELEVATION = 51.83

TITLE SHEET AND DETAILS	HU PROFESSION	ONE VENTURE, STE 100 COMMUNITY DEVELOPMEN		PLAN PREPARED FOR / OWNER: COMMUNITY DEVELOPMENT	CITY OF SAN RAFAE
				1400 FIFTH AVE.,	1515 4TH AVE.




TYP

w/

VICINITY MAP

MANHOLE
NORTHERLY
NOT A PART
NOT TO SCALE
PLANTER AREA
PORTLAND CEMENT CONCRETE
PROPOSED
PROPERTY LINE
RADIUS
REINFORCED CONCRETE PIPE
RECLAIMED WATER
RIGHT OF WAY
STORM DRAIN
STANDARD DIMENSION RATIO
SQUARE FEET
SOUTHERLY
SANITARY SEWER
STATION
STANDARD
TOP OF CURB
TOP OF FOOTING
TOP OF GRATE
TOP OF WALL
TOP OF SLOPE
TYPICAL
WEST/WITH

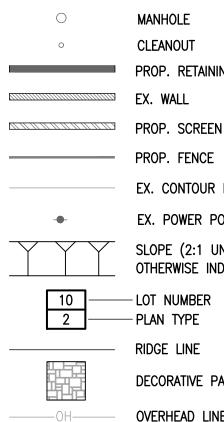


MANHOLE CLEANOUT PROP. RETAINING WALL PROP. SCREEN WALL EX. CONTOUR LINE EX. POWER POLE SLOPE (2:1 UNLESS OTHERWISE INDICATED) — PLAN TYPE RIDGE LINE DECORATIVE PAVEMENT OVERHEAD LINE


RAFAEL	
ETAILS	
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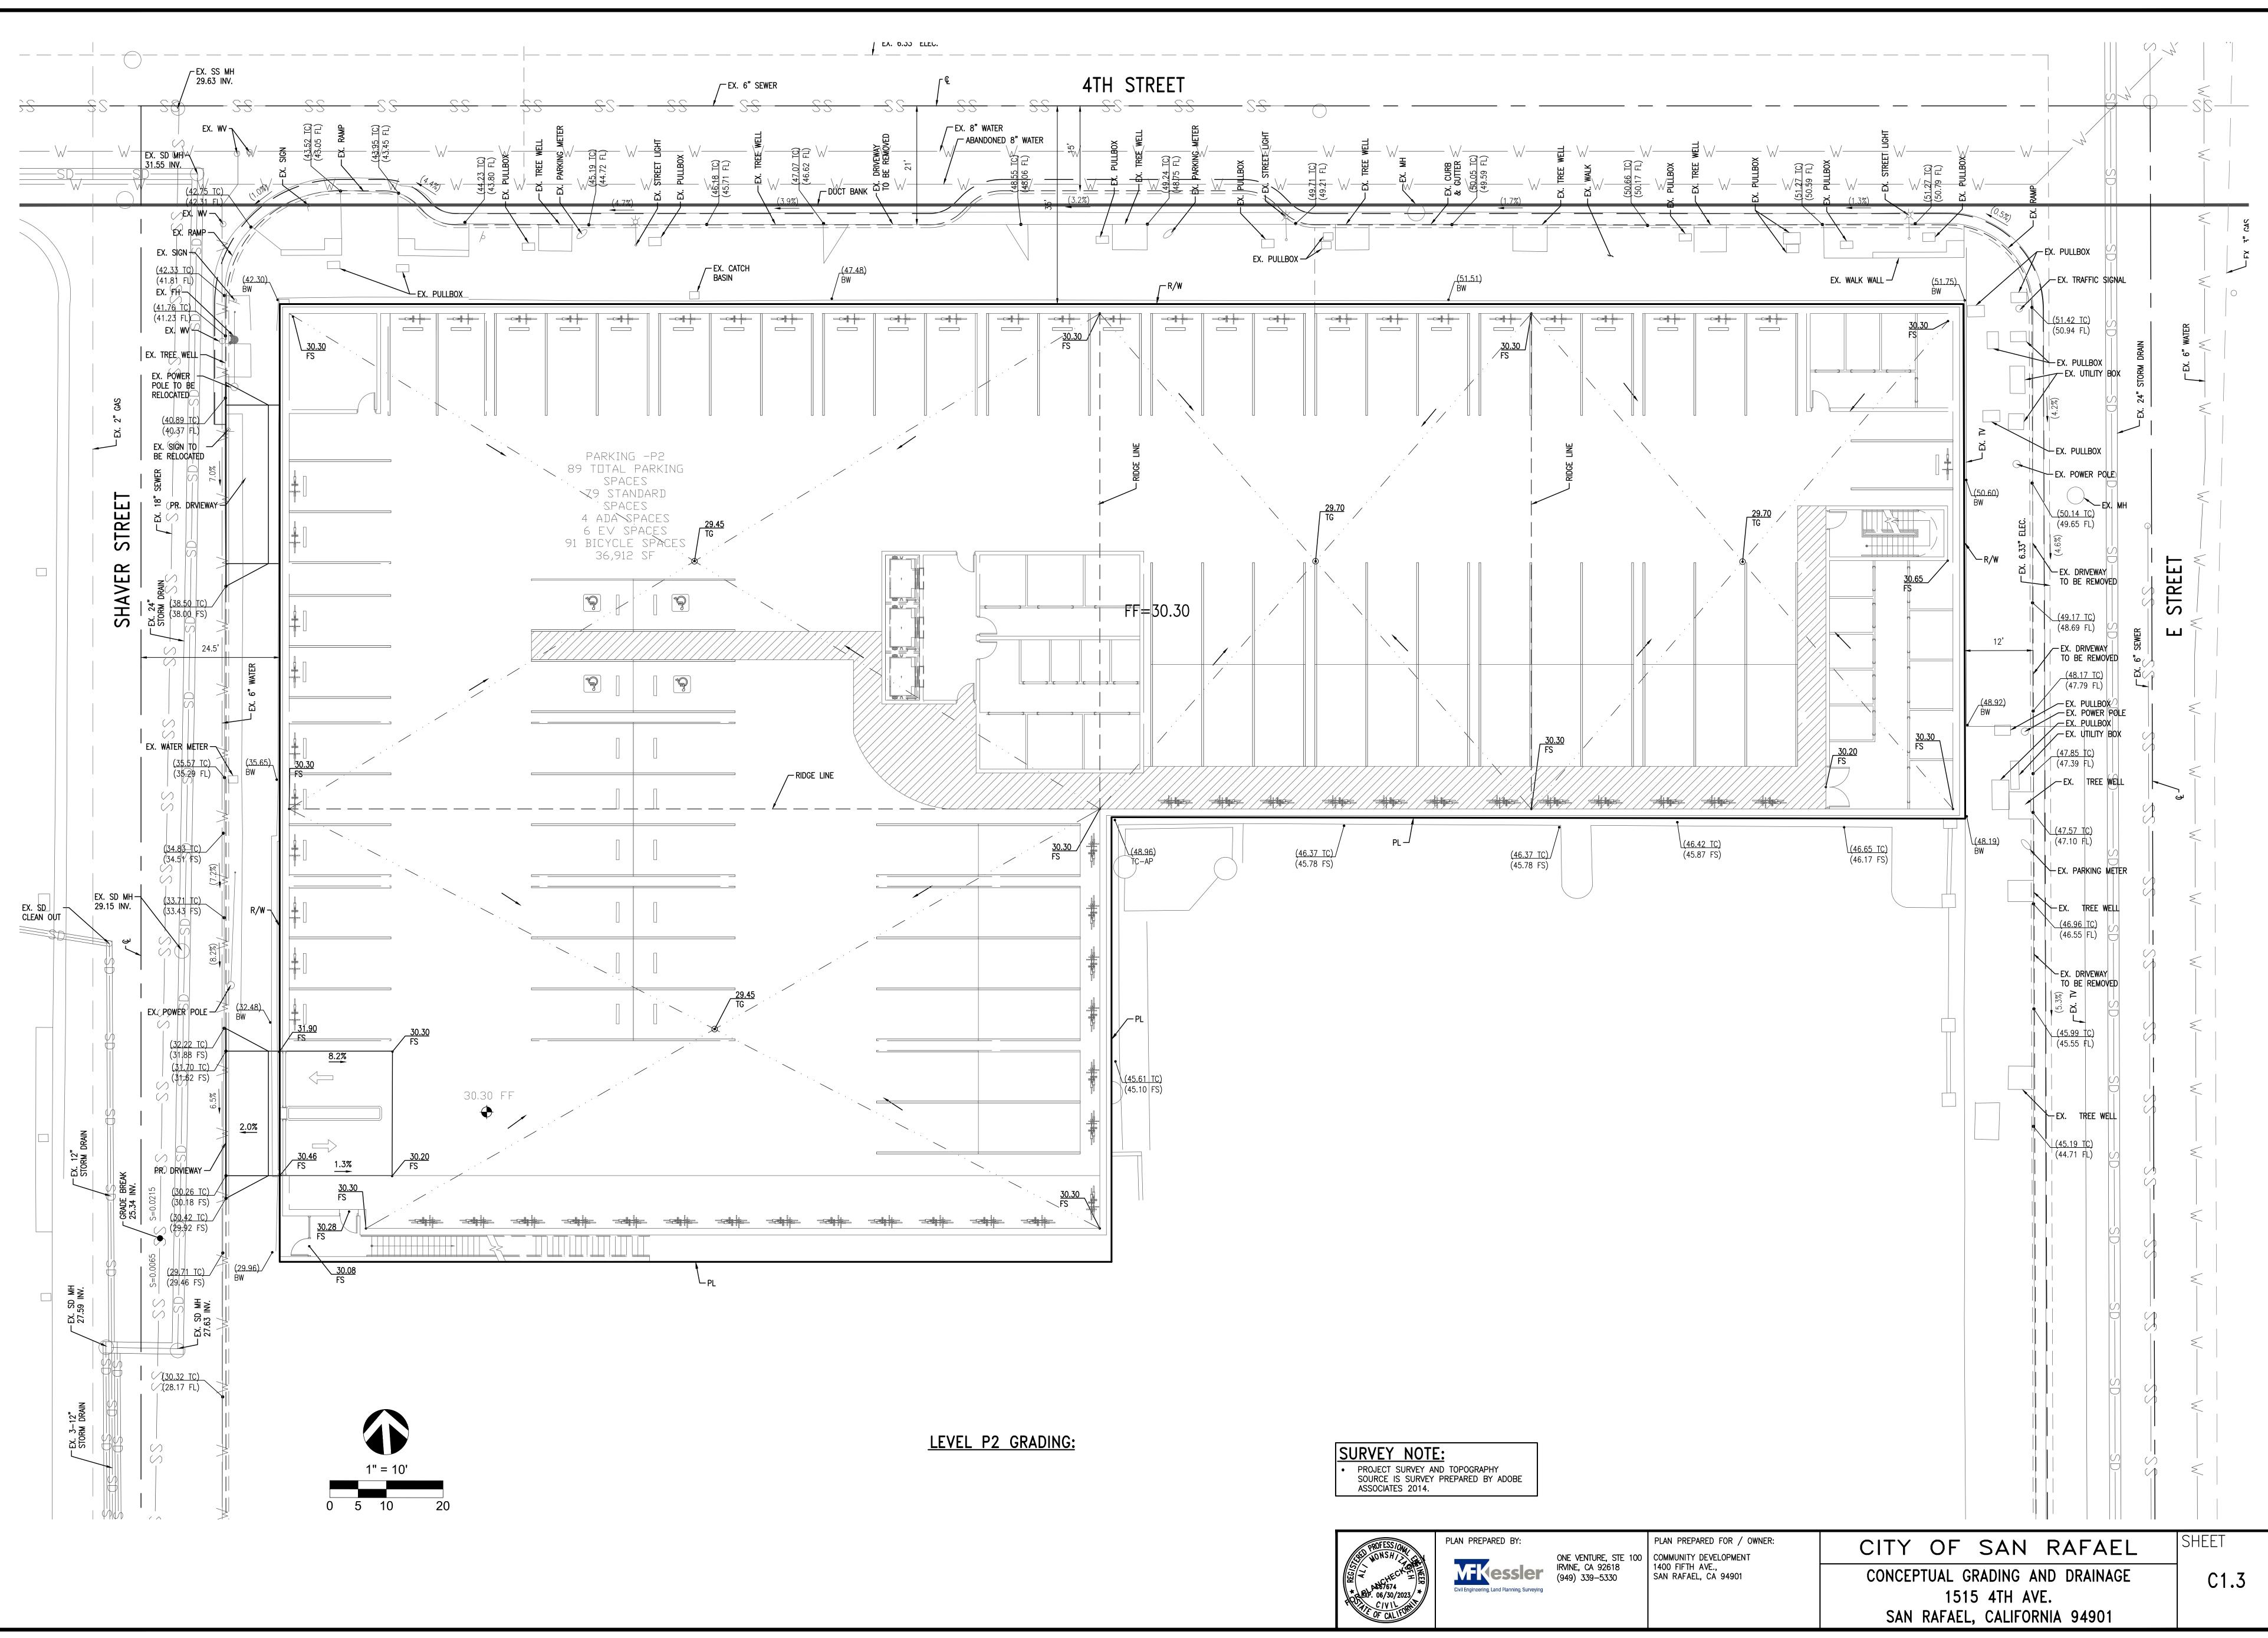
C1.0








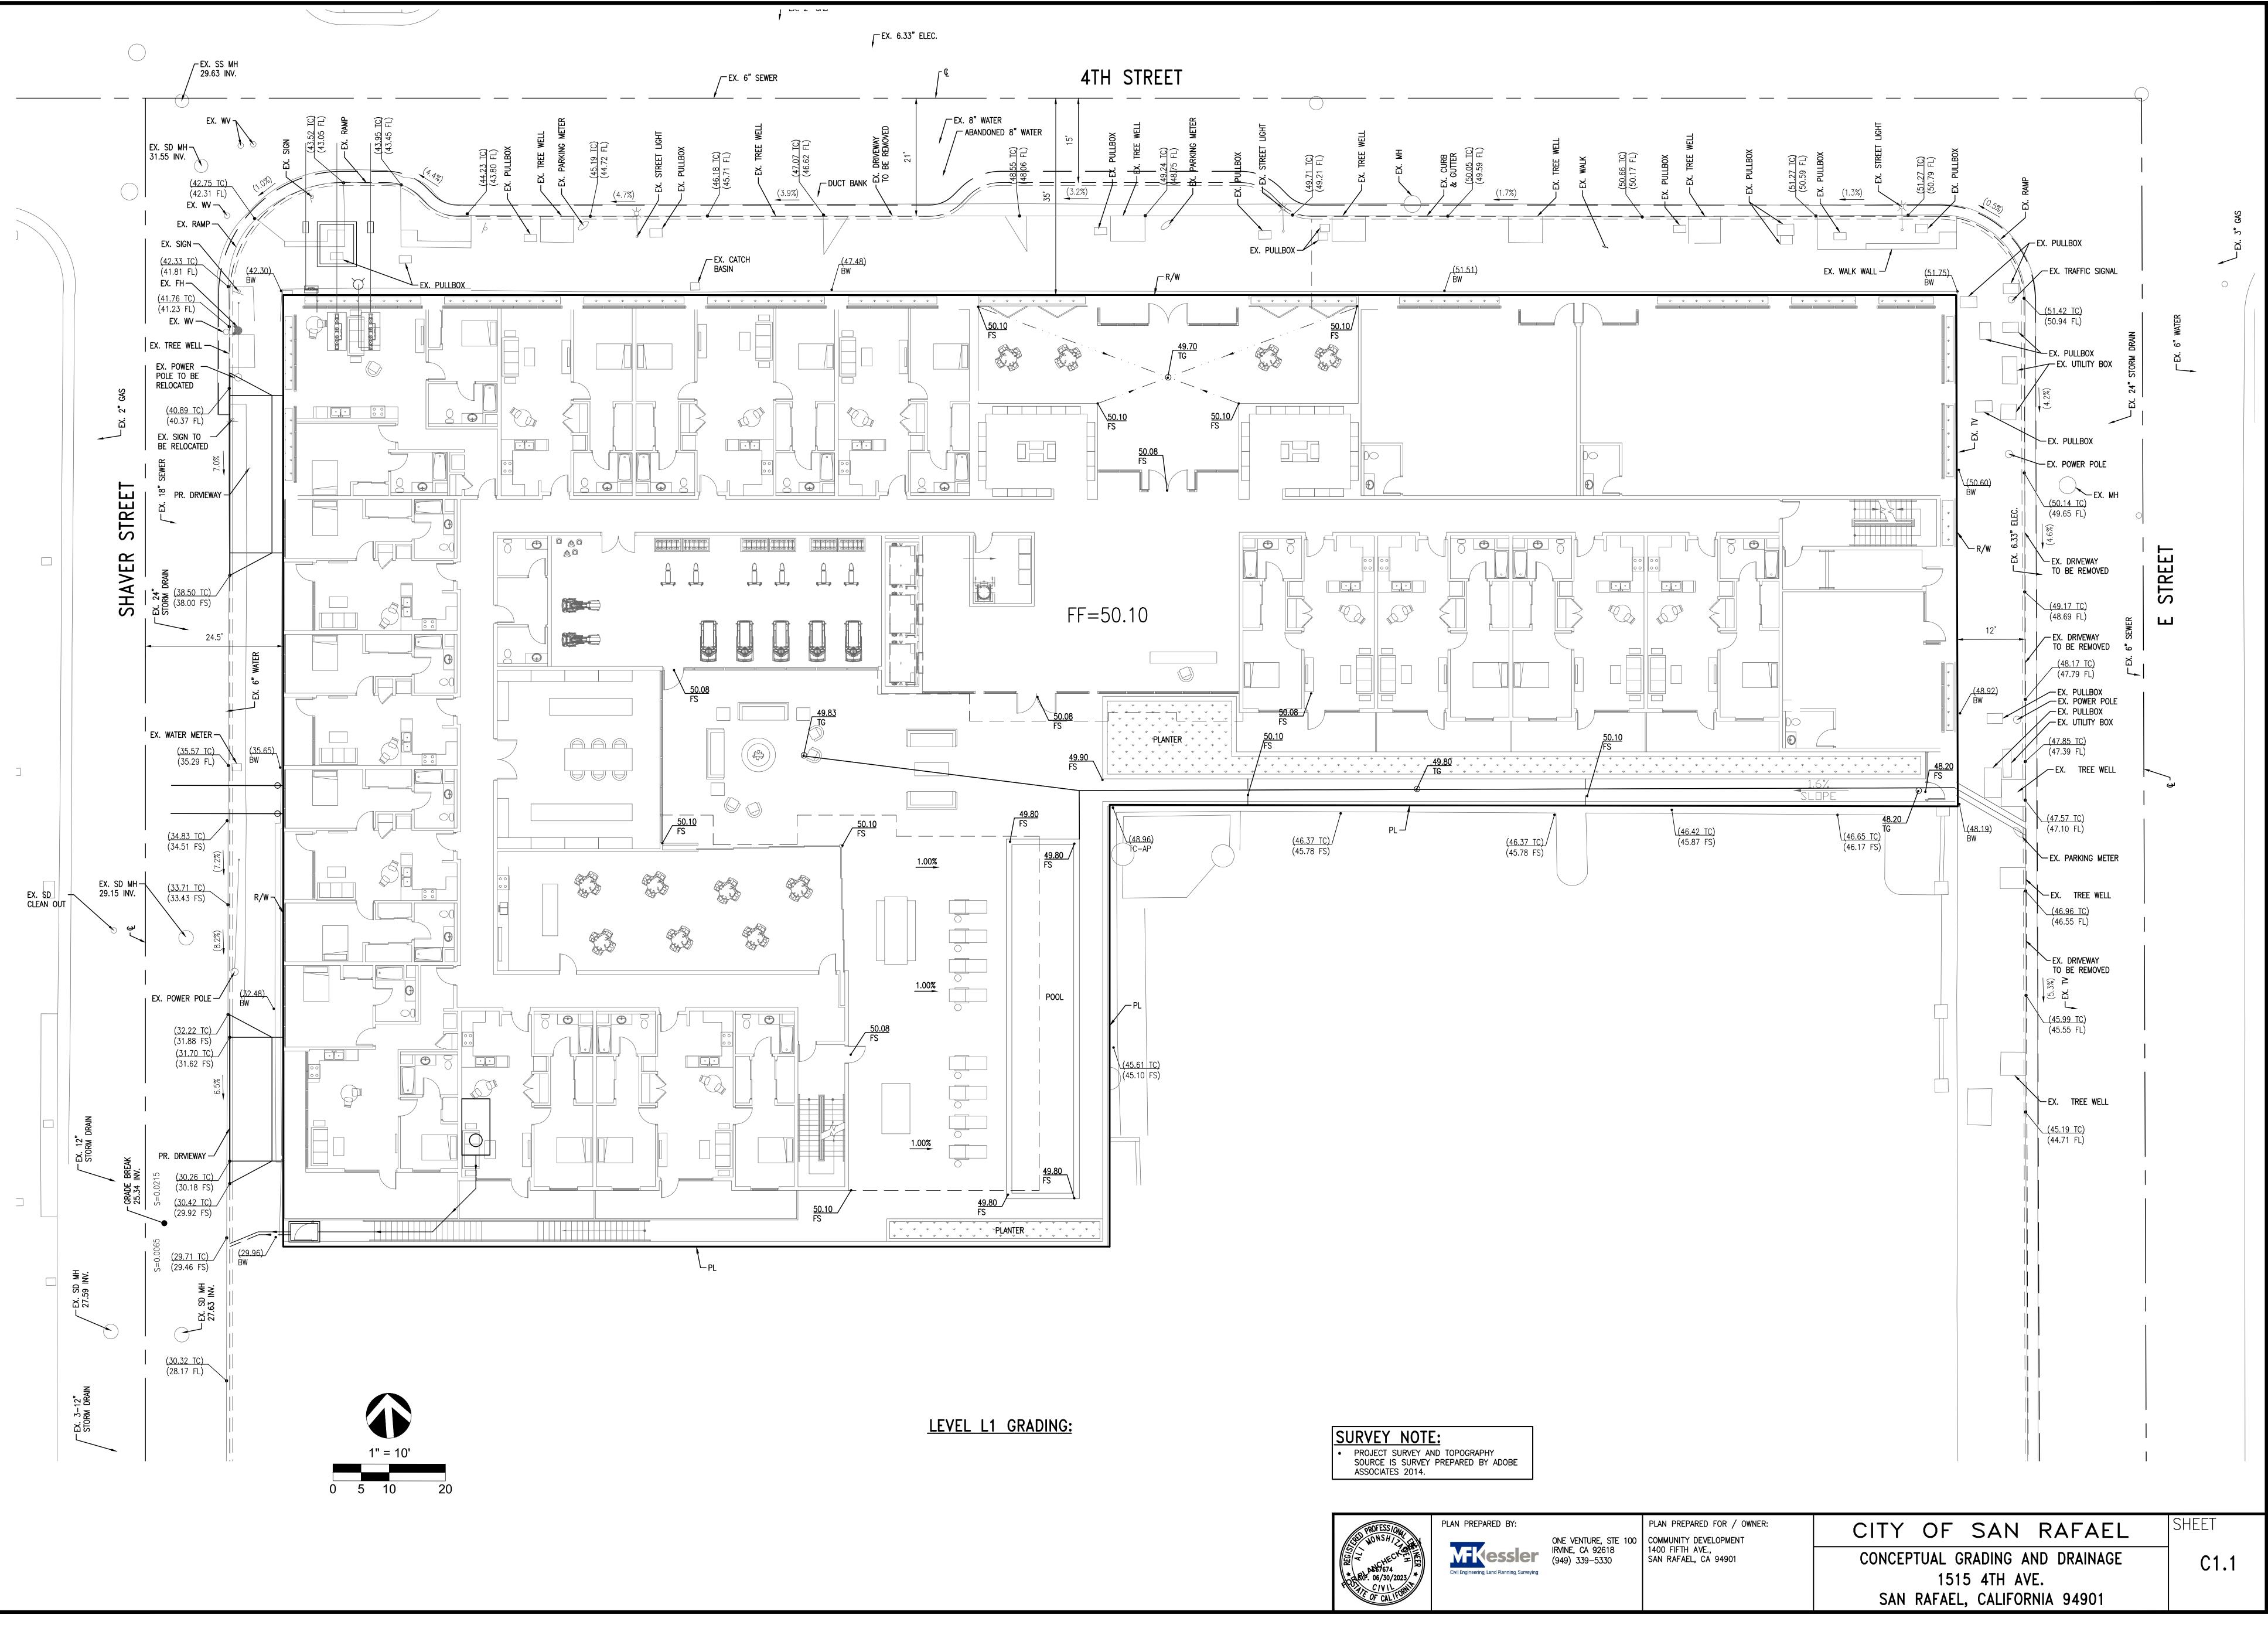

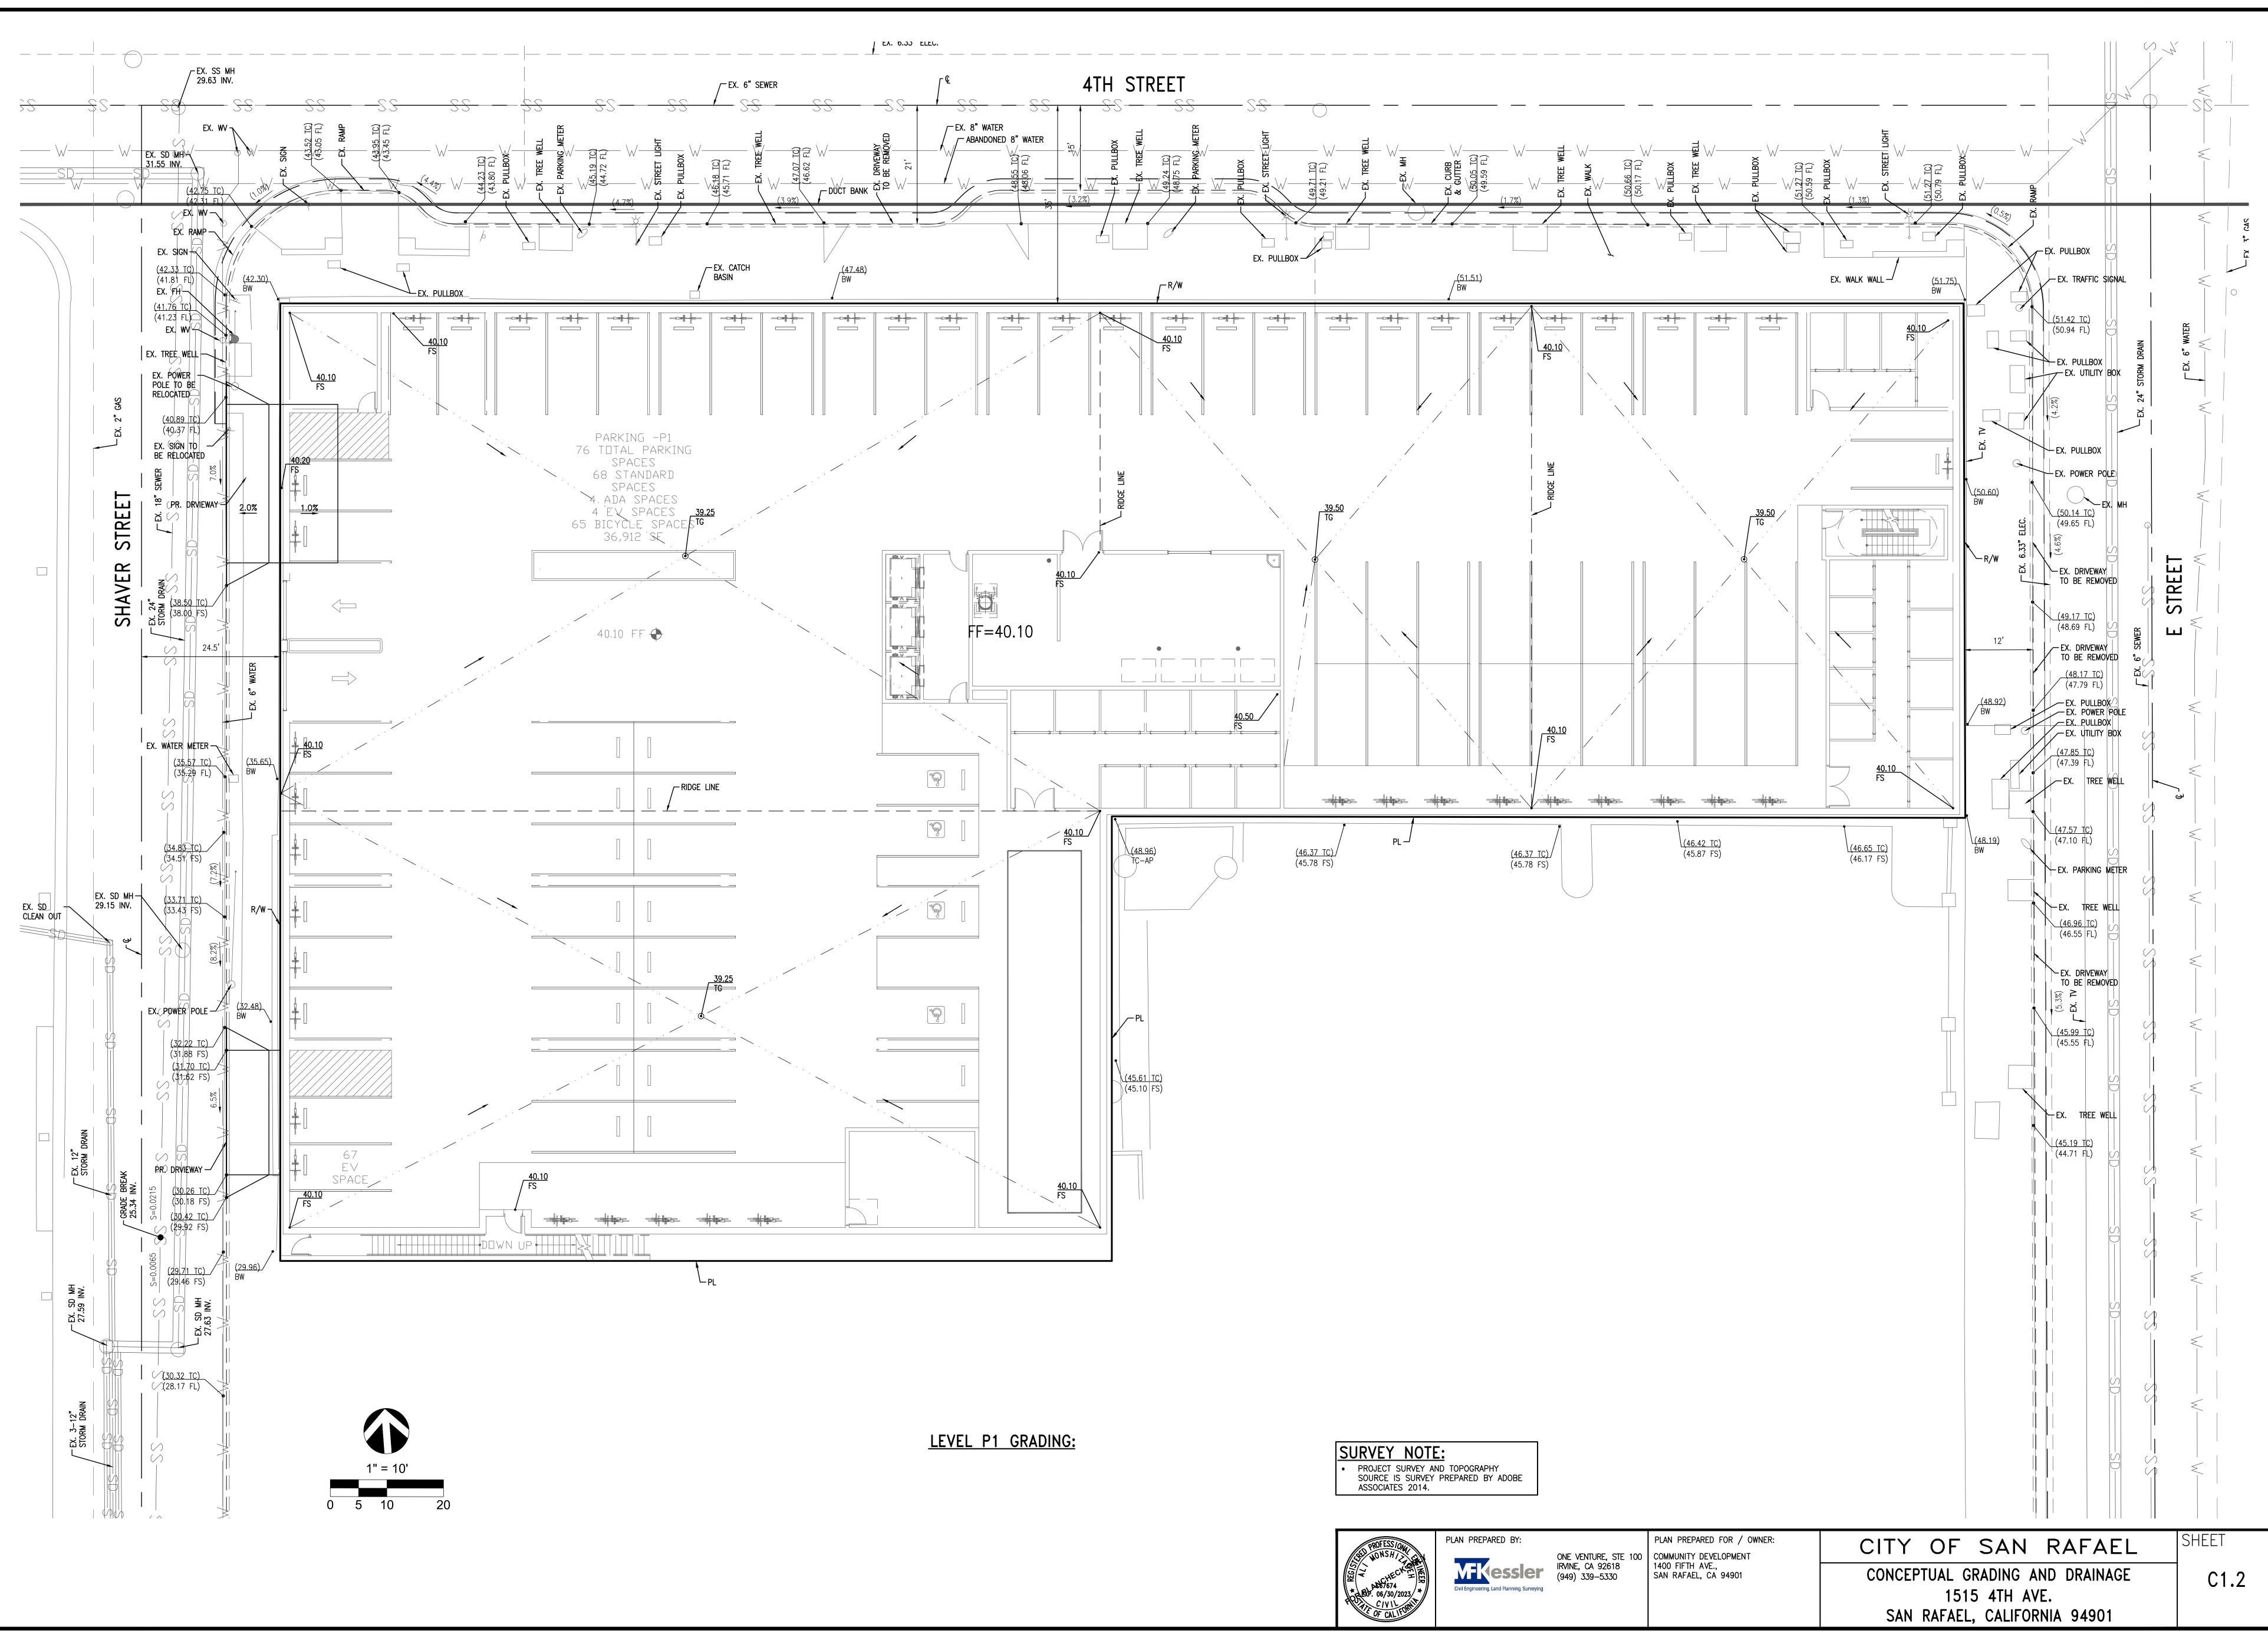



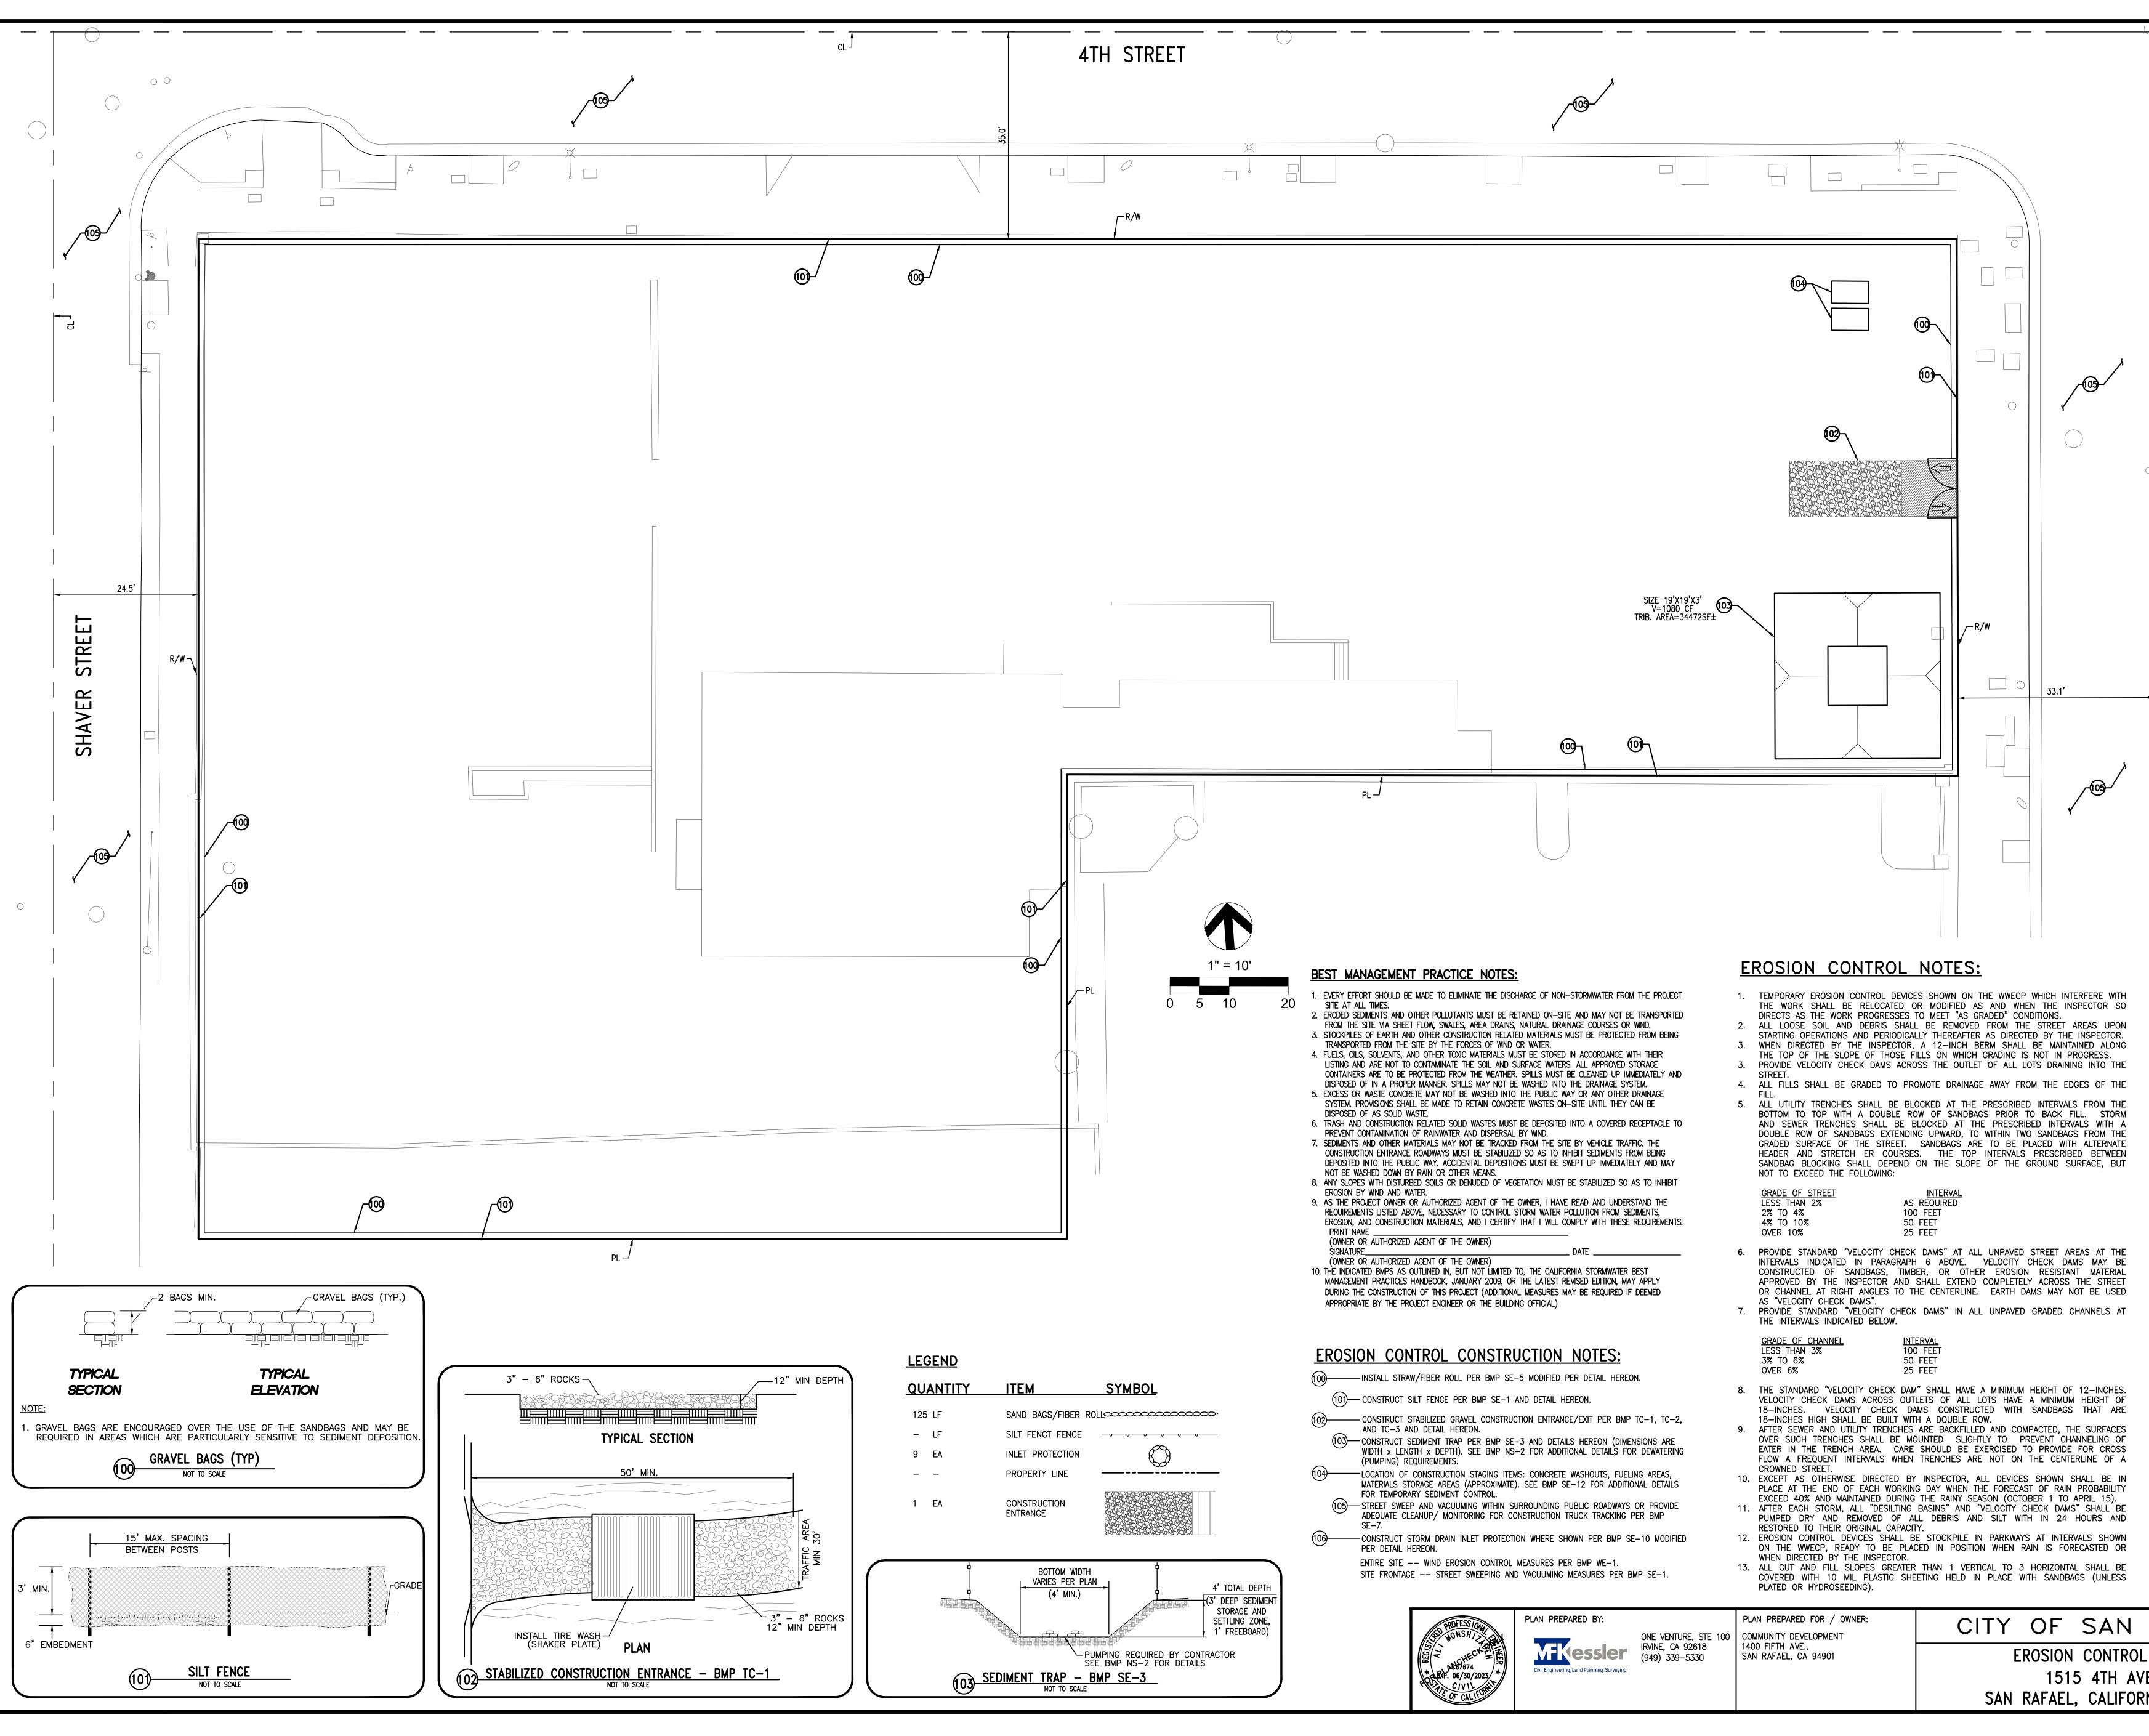

GRA	DE	OF	STF
LES	SΤ	HAN	2%
2%	TO	4%	
4%	ΤO	10%	6

<u>OF CHANNEL</u>	INTERVAL
THAN 3%	100 FEET
6%	50 FEET
6 %	25 FEET


PLAN PREPARED BY:		PLAN PREPARED FOR / OWNER:	CITY OF SAN RAFA
ONE VENTURE, STE 100 IRVINE, CA 92618 (949) 339–5330	ONE VENTURE, STE 100	COMMUNITY DEVELOPMENT 1400 FIFTH AVE., SAN RAFAEL, CA 94901	
			EROSION CONTROL PLAN
			1515 4TH AVE.
			SAN RAFAEL, CALIFORNIA 94901

DMDS (DE	R CASQA):
<u>BEST MANAGEMENT P</u> REVISED EDITION, MA THIS PROJECT (ADDI	RACTICES HANDBOOK, OR THE LATEST Y APPLY DURING THE CONSTRUCTION OF TIONAL MEASURES MAY BE REQUIRED IF E BY THE PROJECT ENGINEER OR THE
<u>Erosion Control B</u> EC-1 Sched EC-2 Prese	
<u>NON-Storm Water</u> NS-1 Water NS-3 Paving NS-7 Potabi NS-8 Vehicl NS-12 Concr NS-13 Concr	
<u>TEMPORARY SEDIMEN</u> SE-6 Gravei SE-7 Street SE-8 Sandb SE-10 Storm	L BAG BERM F SWEEPING AND VACUUMING AG BARRIER
<u>WIND EROSION CONT</u> WE-1 WIND I	<u>ROL BMPs</u> EROSION CONTROL
	IZED CONSTRUCTION NCE/OLITIET TIRE WASH
WM-1 Materi WM-2 Materi WM-3 Stocki Permit City e	& MATERIAL POLLUTION CONTROL BMPs AL DELIVERY AND STORAGE AL USE PILE MANAGEMENT (STOCKPILE NOT TED UNLESS OTHERWISE APPROVED BY NGINEER)
WM-8 CONCR	WASTE MANAGEMENT RETE WASTE MANAGEMENT RY/SEPTIC WASTE MANAGEMENT
	NOTE: SURVEY AND TOPOGRAPHY
	S SURVEY PREPARED BY ADOBE
	- SHEET

STREE

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C1.4

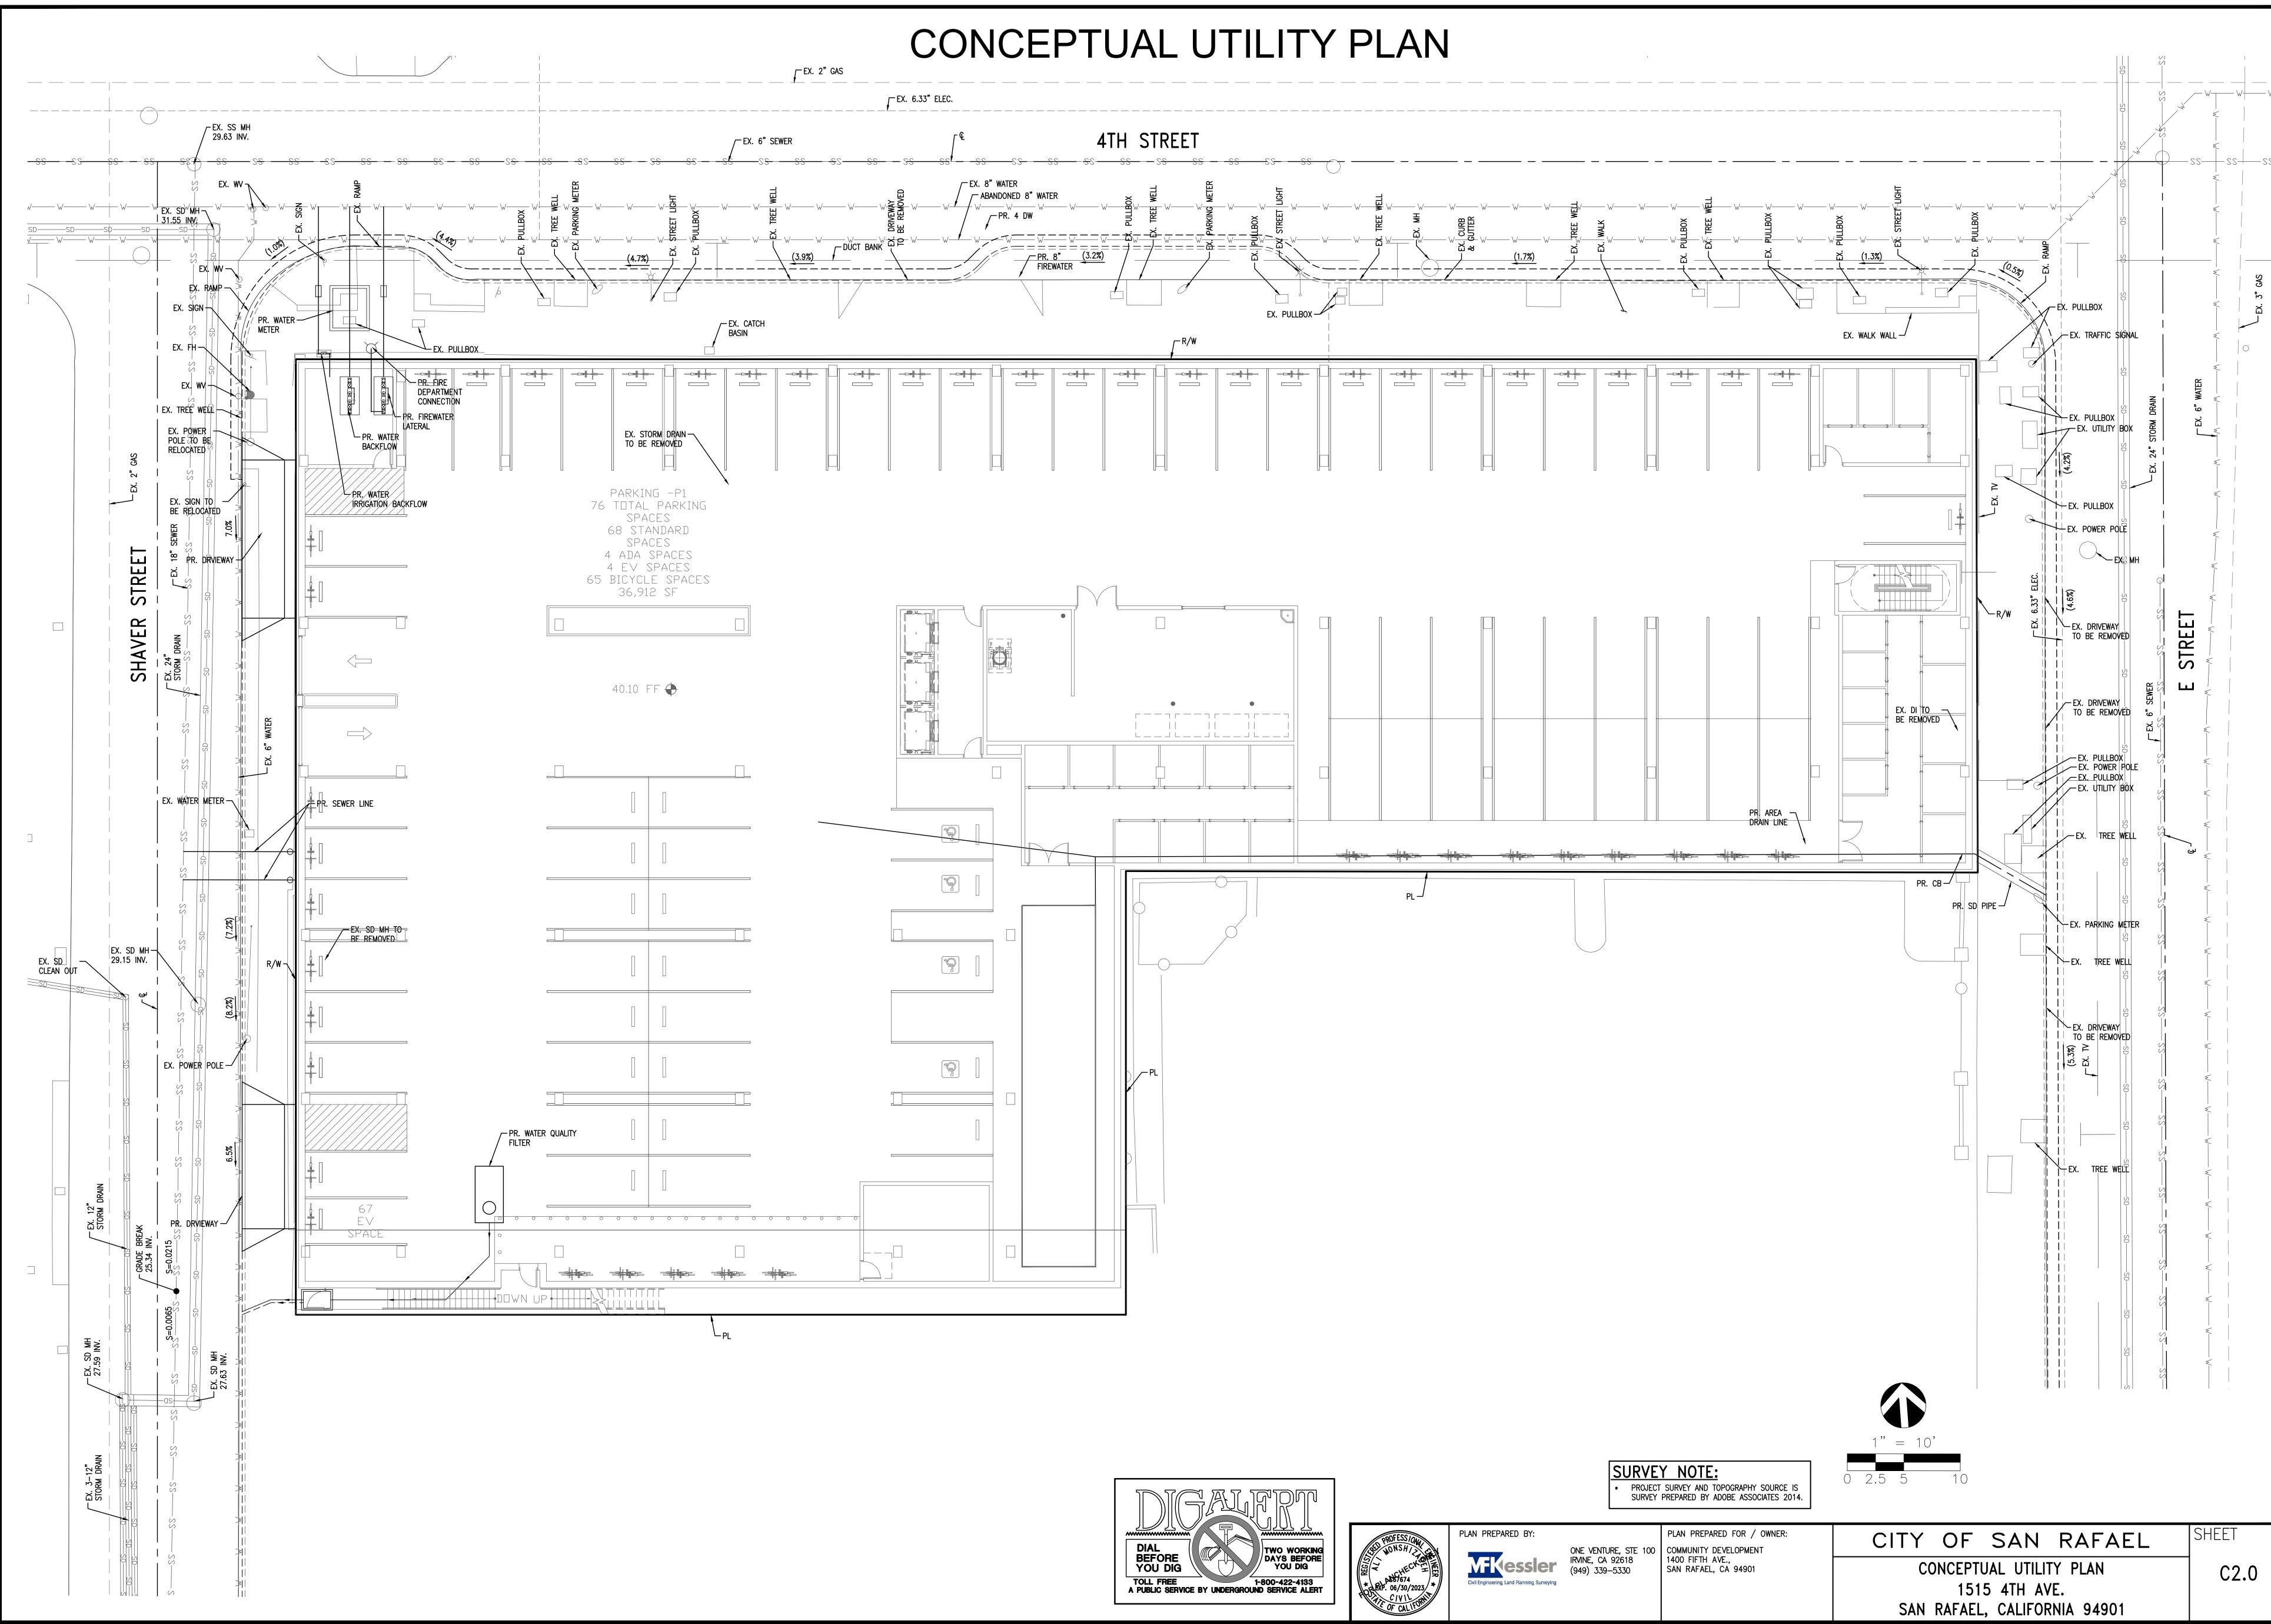

Ή	AVE.	
	ORNIA	9490