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project Santa Ana ADU

address

LEGEND

PER SCHEDULE

**BOLT TYPE HOLDOWN** 

BEARING OR EXTENT

OF RAFTERS

=── - HANGER TO BEAM/LEDGER

BEARING OR EXTENT

SHEARWALL & A.B. SPACING

revisions


description 1 Bedroom + Porch Foundation

Plan

date MAY 2023

project no. 2022\_SANTA\_ANA\_ADU

DESIGN PATH STUDIO drawn by

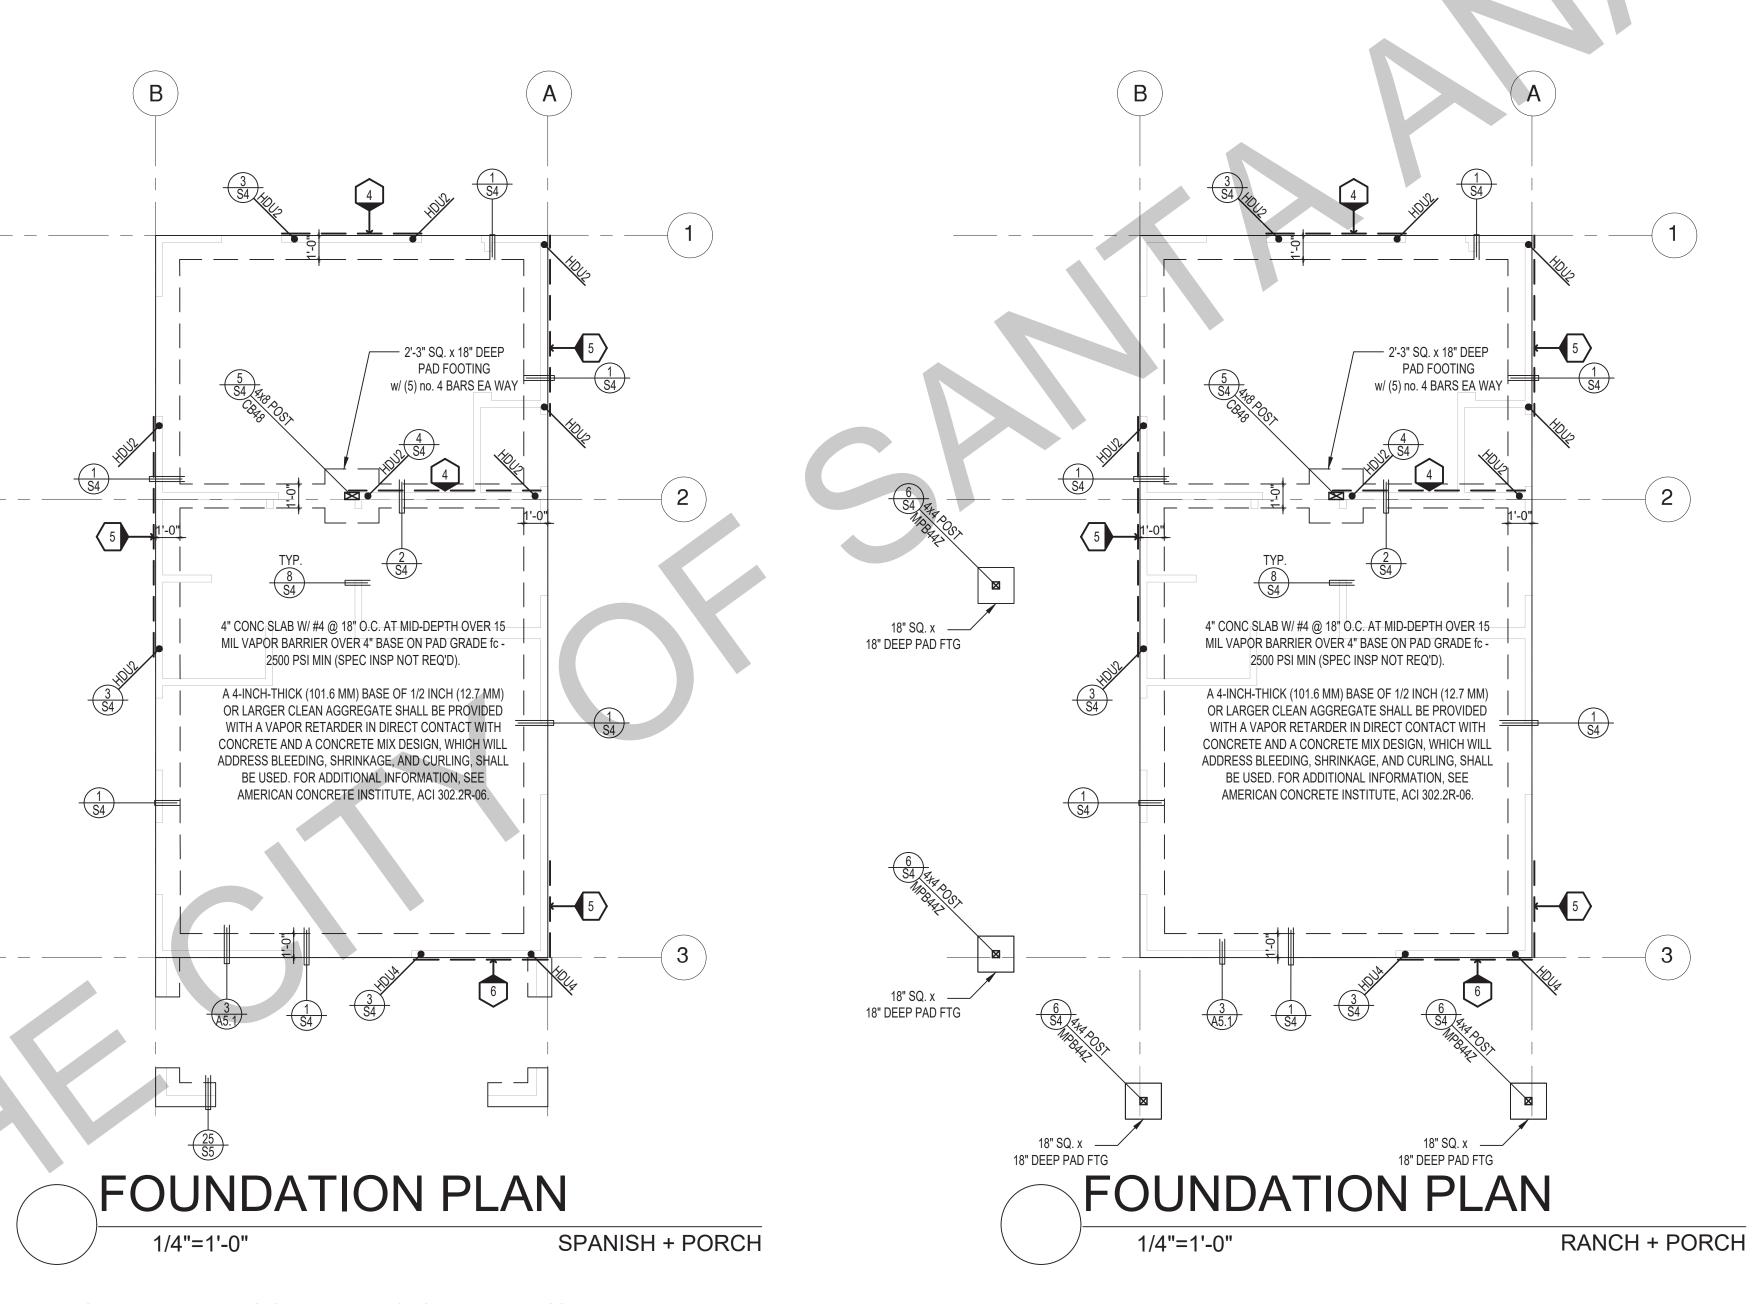

## SHEAR WALL SCHEDULE (ASD VALUES)

## FOUNDATION NOTES

1/4"=1'-0"

ALL ANCHOR BOLTS, HOLDOWN ANCHORS, & REINF. MUST BE SECURELY TIED IN PLACE PRIOR TO FDTN. INSP.

— 2'-3" SQ. x 18" DEEP

4" CONC SLAB W/ #4 @ 18" O.C. AT MID-DEPTH OVER 15

MIL VAPOR BARRIER OVER 4" BASE ON PAD GRADE fc -

2500 PSI MIN (SPEC INSP NOT REQ'D).

A 4-INCH-THICK (101.6 MM) BASE OF 1/2 INCH (12.7 MM)

OR LARGER CLEAN AGGREGATE SHALL BE PROVIDED

WITH A VAPOR RETARDER IN DIRECT CONTACT WITH

CONCRETE AND A CONCRETE MIX DESIGN, WHICH WILL

ADDRESS BLEEDING, SHRINKAGE, AND CURLING, SHALL

BE USED. FOR ADDITIONAL INFORMATION, SEE

AMERICAN CONCRETE INSTITUTE, ACI 302.2R-06.

FOUNDATION PLAN

1'-3" SQ. x 18" DEEP— PAD FOOTING

TRADITIONAL + PORCH

PAD FOOTING

w/ (5) no. 4 BARS EA WAY

ALL EXTERIOR STUDS TO BE 2x4 @ 16" O.C.

1'-3" SQ. x 18" DEEP—

PAD FOOTING

1'-3" SQ. x 18" DEEP-

PAD FOOTING

6 S4 TYP.

1'-3" SQ. x 18" DEEP\_ PAD FOOTING

- THE MINIMUM NOMINAL ANCHORBOLT DIAMETER SHALL BE 1/2 INCH NOTE: THIS WILL REQUIRE A MINIMUM DISTANCE FROM THE ENDS OF SILL PLATES TO BE 4" (AND A MAXIMUM OF 12")
- PLATE WASHERS (MINIMUM SIZE OF 3" x 3" x 1/4") SHALL BE USED ON EACH
- PROVIDE CONC SLAB JOINTS AT NO MORE THAN 15 FT EA. WAY
- 6. SEE SHT S4 FOR TYP. CONCRETE & SLAB DETAILS 1-8
- . POSTS W/O SPECIFIED BASE SHALL BE NAILED TO BOLTED SILL PLATES W/ (2)
- . FOOTINGS ADJACENT TO SLOPES GREATER THAN OR EQUAL TO 33.3% SHALL COMPLY WITH SETBACK REQUIREMENTS DEFINED IN CBC 1808.7.

	4	5	6	7	8	9
SHEARWALL DESCRIPTION (See footnotes 1& 4)	3" ply. C-D or C-C sheathing, (1) side w/ 8d @ 6" o/c edge, 12" o/c field, blocked (See footnote 3)	3/8" ply. C-D or C-C sheathing, (1) side w/ 8d @ 41/2" o/c edge, 12" o/c field, blocked (See footnote 3)	3/8" ply. C-D or C-C sheathing, (1) side w/ 8d @ 3" o/c edge, 12" o/c field 3x abutting panel studs blocked (See footnote 3 & 4)	3/8" rated STRUCT 1 panel, (1) side w/ 8d @ 3" o/c edge, 12" o/c field 3x abutting panel studs blocked (See footnote 3 & 4)	15/ <sub>32</sub> " rated STRUCT 1 panel, (1) side w/ 10d @ 3" o/c edge, 12" o/c field 3x abutting panel studs blocked (See footnote 3, 4, & 5)	15/ <sub>32</sub> " rated STRUCT 1 panel, (1) side w/ 10d @ 2" o/c edge, 12" o/c field 3x abutting panel studs blocked (See footnote 3, 4, & 5)
SHEAR VALUE (PLF)	260*	350*	490*	550*	665*	870*
ANCHOR BOLT SPACING	½" @ 48" or ½" @ 32"	½" @ 32" or ½" @ 24"	½" @ 24" or ½" @ 16"	½" @ 24" or ½" @ 16"	½" @ 16" or ½" @ 24"	½" @ 12" or ½" @ 8"
16d (0.148") SILL NAILING	6"	4½"	3½"	3"	1/4"x41/2" SDS screws @ 8"	1/4"x41/2" SDS screws @ 8"
SPACING OF A35/LTP4 FRAMING TO TOP PLATE	32" O.C.	18" O.C.	12" O.C.	12" O.C.	8" O.C.	8" O.C.

## SHEAR WALL FOOTNOTES

- (1) AT PLYWOOD OR OSB PS-1 OR PS-2 RATED PANELS USE COMMON NAILS OR GALVANIZED BOX NAILS (2) LAYERS OF PAPER EXTERIOR PLYWOOD REQUIRED. SHEARSHALL BE APPLIED OVER STUDS @ 16" O/C. GALVANIZED NAILS SHALL NOT BE HOT-DIPPED OR TUMBLED.
- (2) SILL PLATES & WASHERS SHALL COMPLY WITH THE CONCRETE FOUNDATION CONSTRUCTION AND WOOD FRAMING CONSTRUCTION NOTES. (SEE NOTES #206, 208, 209. 307, 308, 309, ETC.)
- (3) IN PLYWOOD SHEARWALLS, THE EDGE OF THE 3" SQUARE WASHERS (SEE NOTE #206) SHALL BE 1/8" OR LESS FROM THE EDGE OF THE SILL PLATE ON THE SIDE OF THE SHEATHING. ALL NAILING SHALL BE 3/8" MIN. FROM THE EDGE OF SHEATHING.
- (4) WHERE ALLOWABLE SHEAR VALUES EXCEED 350 PLF (SHEARWALL TYPES 6, 7, 8, & 9) ALL FRAMING RECEIVING NAILING FROM ABUTTING PANEL EDGES SHALL NOT BE LESS THAN A SINGLE 3" NOMINAL MEMBER OR (2) 2X MEMBERS NAILED WITH 10D, SPACING EQUAL TO THE E.N. SPACING. PLYWOOD JOINT AND SILL NAILING SHALL BE STAGGERED.
- (5) IN SHEARWALL TYPES 8 & 9, SILL PLATE NAILING SHALL BE STAGGERED. AT SECOND FLOOR CONDITIONS, PROVIDE ADEQUATE RIM OR BLOCKING TO PREVENT SPLITTING.
- (\*) ALLOWABLE SHEAR VALUES FOR PLYWOOD SHEARWALLS MAY BE INCREASED BY 40% UNDER WIND LOADING.