

Brazil Street Lot 228

tahoe city ca 96145

p 530.583.3690

f 5 3 0 . 5 8 3 . 4 6 9 0

99 Brazil Street Lot 228 City of Sonoma California APN 018-051-007

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Job Number

Issue Date 10 February 2017

Conditional Use Permit

Drawing Title

Cover

Drawing Number
a 0.1

L o t 2 2 8

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VIEW FROM DRIVEWAY

VIEW FROM UPHILL SIDE





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City of Sonoma

APN 018-051-007

Lot 228

California

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VIEW FROM UPHILL SIDE

VIEW FROM DRIVEWAY

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Model Images

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VIEW TOWARDS POOL TERRACE

VIEW FROM DOWNHILL SIDE

a 0.3



VIEW FROM EAST 4TH STREET LOOKING NORTH TOWARDS LOT 228





LOCATION MAP - 4TH STREET

LOCATION MAP - LOVALL VALLEY ROAD

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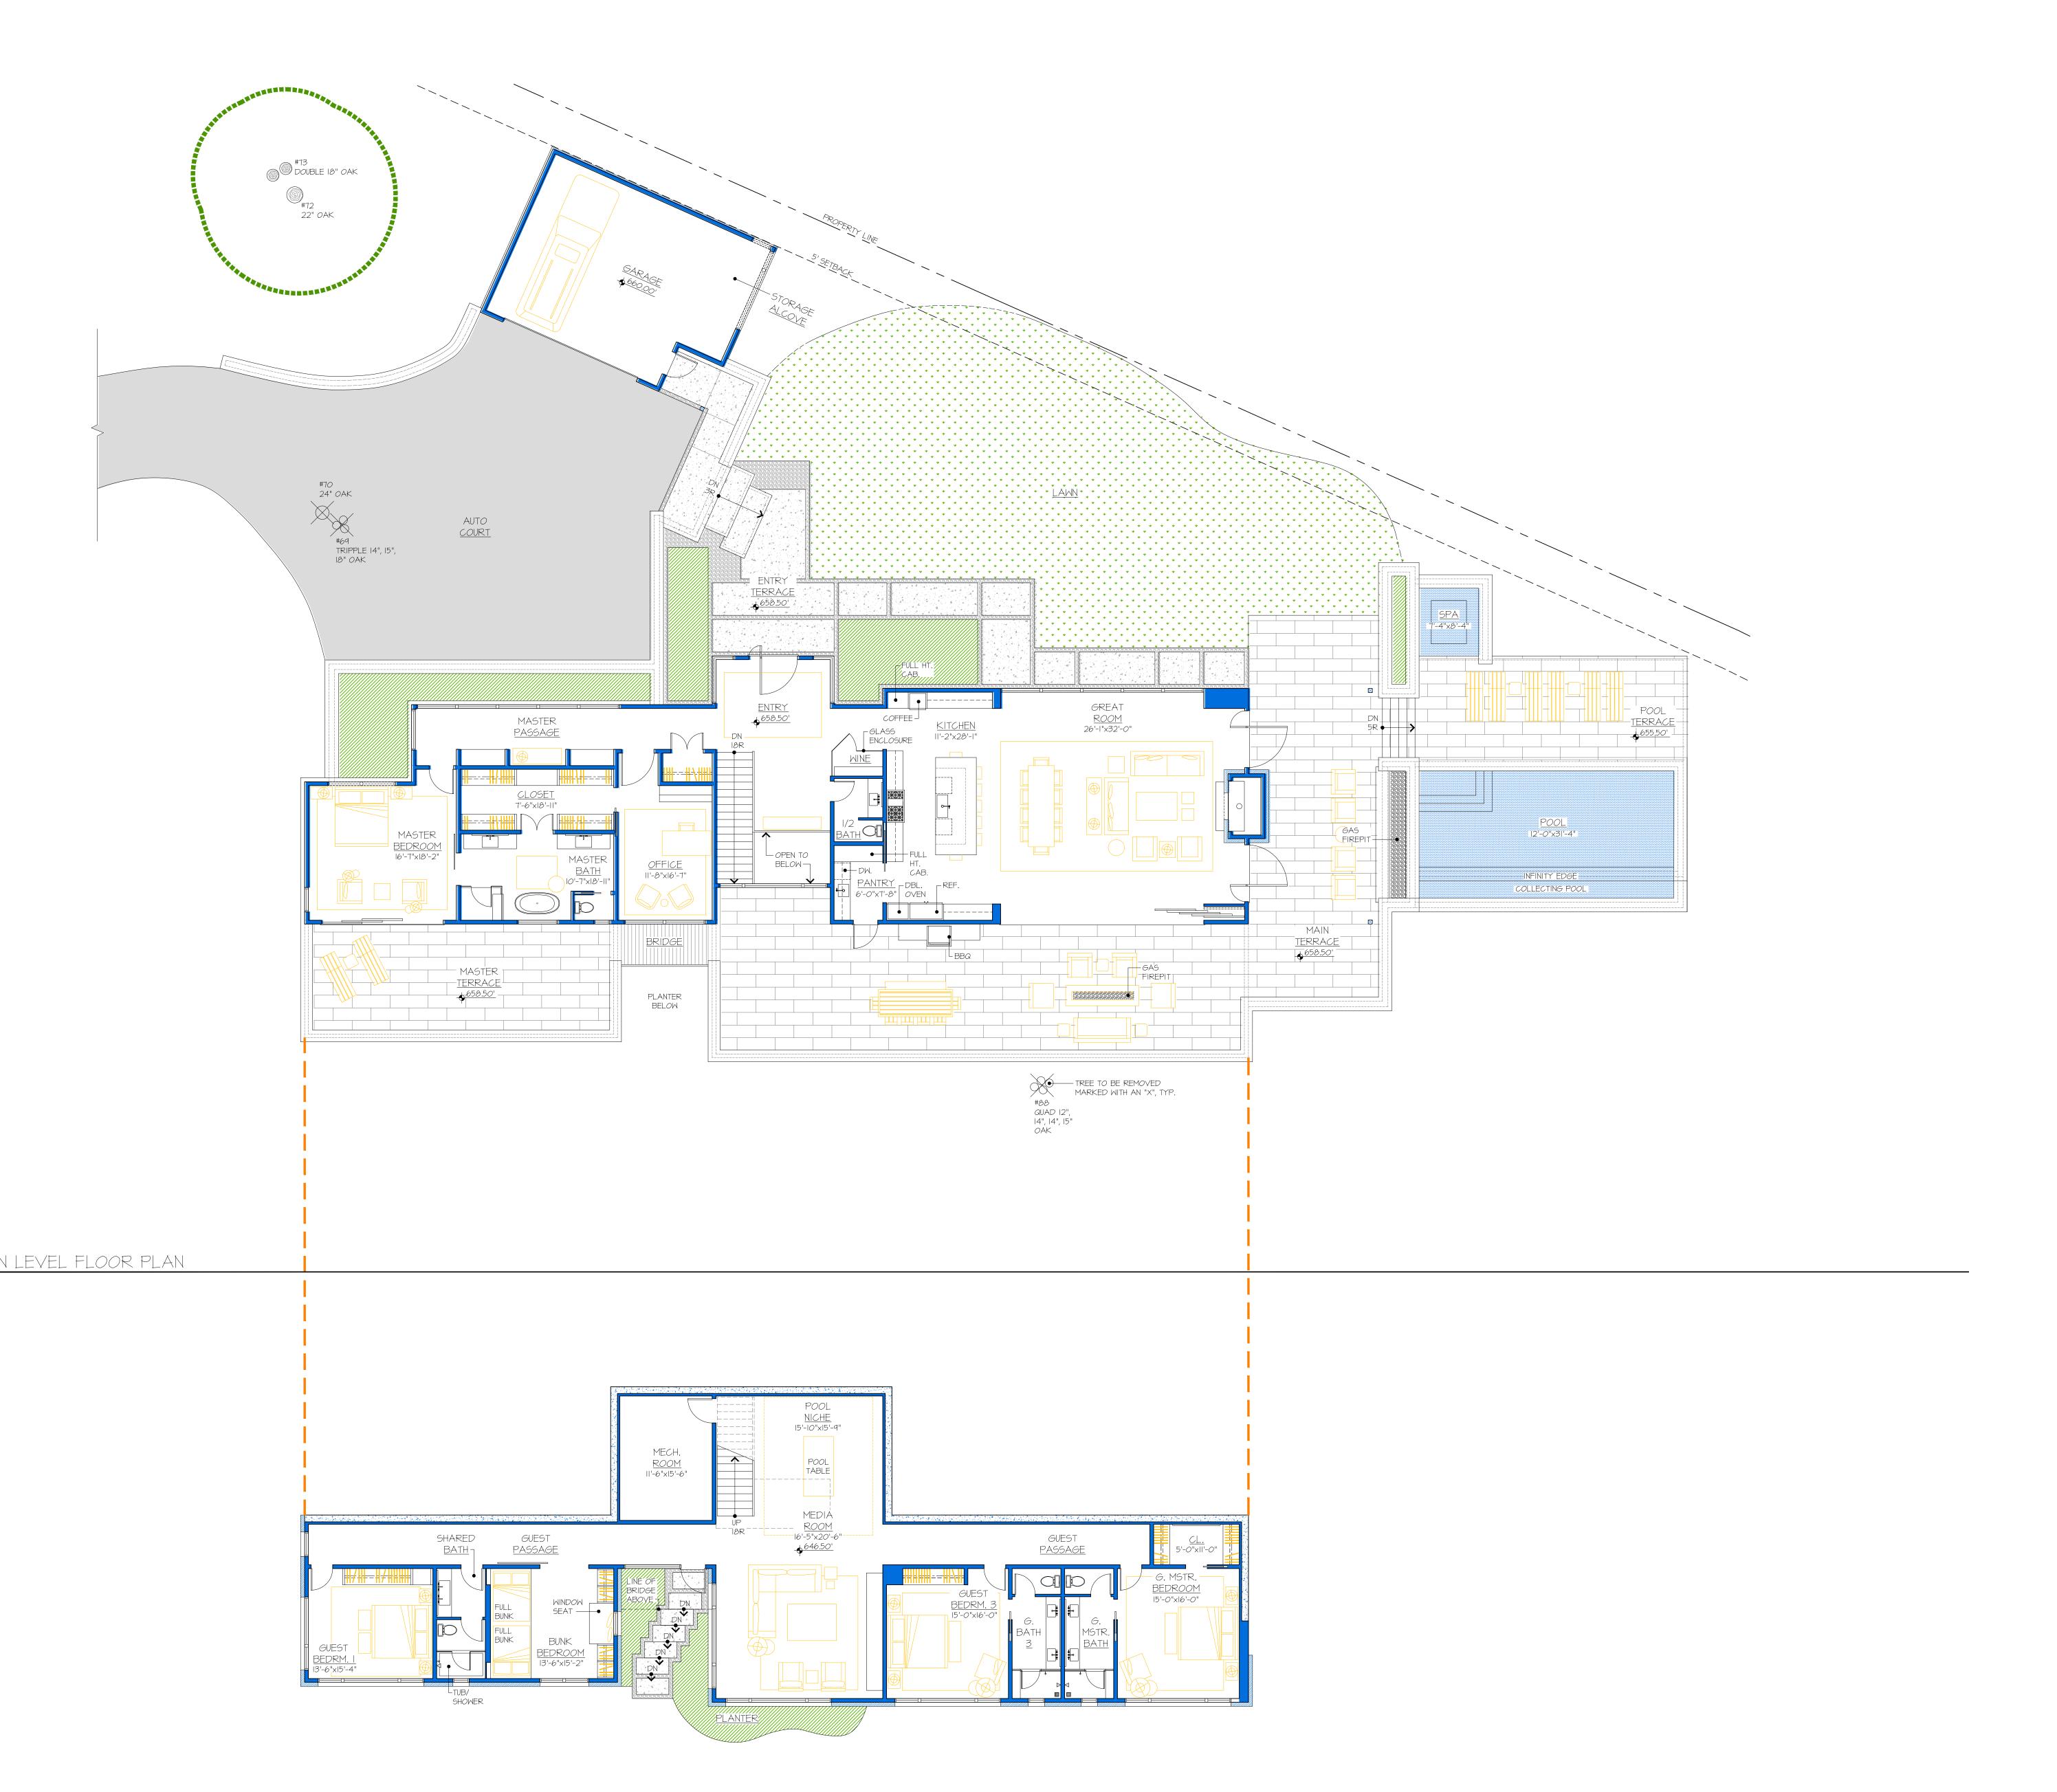
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SQUARE FOOTAGE ANALYSIS

CONDITIONED SQUARE FOOTAGE MAIN LEVEL



= 5,504 SF = 593 SF = 144 SF = 737 SF engineering|inc.

GENERAL NOTES

STORAGE

TOTAL

I.] STAIRWAYS SERVING AN OCCUPANT LOAD LESS THAN 50 SHALL SHALL HAVE A WIDTH OF NOT LESS THAN 36 INCHES. CRC SECTION R311.7.11 STAIRWAYS SHALL HAVE A MINIMUM HEADROOM CLEARANCE OF 80 INCHES MEASURED VERTICALLY FROM A LINE CONNECTING THE EDGE OF THE NOSINGS. SUCH HEADROOM SHALL BE CONTINUOUS ABOVE THE STAIRWAY TO THE POINT WHERE THE LINE INTERSECTS THE LANDING BELOW, ONE TREAD DEPTH BEYOND THE BOTTOM RISER. THE MINIMUM CLEARANCE SHALL BE MAINTAINED THE FULL WIDTH OF THE STAIRWAY. CRC SECTION R311.7.2. WITHIN DWELLING UNITS, THE MAXIMUM RISER HEIGHT SHALL BE 7-3/4"; THE MINIMUM TREAD DEPTH SHALL BE IO INCHES. CRC SECTIONS R311.7.4.1 AND R311.7.4.2.

2.] GUARDRAILS AND HANDRAILS SHALL BE STRUCTURED TO WITHSTAND A 200# LATERAL LOAD.

a] HANDRAILS: HANDRAIL HEIGHT, MEASURED ABOVE STAIR TREAD NOSINGS, SHALL BE UNIFORM, NOT LESS THAN 34 INCHES AND NOT MORE THAN 38 INCHES. CRC SECTION R311.7.7.1. HANDRAILS WITH A CIRCULAR CROSS-SECTION SHALL HAVE AN OUTSIDE DIAMETER OF AT LEAST 1.25 INCHES AND NOT GREATER THAN 2 INCHES. IF THE HANDRAIL IS NOT CIRCULAR, IT SHALL HAVE A PERIMETER DIMENSION OF AT LEAST 4 INCHES AND NOT GREATER THAN 6.25 INCHES. EDGES SHALL HAVE A MINIMUM RADIUS OF O.OI INCH. CRC SECTION R311.7.7.3. HANDRAILS WITHIN DWELLING UNITS ARE PERMITTED TO BE INTERRUPTED BY A NEWEL POST AT A STAIR LANDING. CRC SECTION R311.7.7.2. CLEAR SPACE BETWEEN A HANDRAIL AND A WALL OR OTHER SURFACE SHALL BE A MINIMUM OF 1.5 INCHES. CBC SECTION 1012.6. PROJECTIONS INTO THE REQUIRED WIDTH OF STAIRWAYS AT EACH HANDRAIL SHALL NOT EXCEED 4.5 INCHES AT OR BELOW THE HANDRAIL HEIGHT. CBC SECTION 1012.8. PROVIDE CONTINUOUS HANDRAIL FOR STAIRWAY WITH 4 OR MORE RISERS AS PER R311.

b] GUARDRAILS: GUARDS SHALL FORM A PROTECTIVE BARRIER NOT LESS THAN 42 INCHES HIGH, MEASURED VERTICALLY ABOVE THE LEADING EDGE OF THE TREAD OR ADJACENT WALKING SURFACE. WITHIN DWELLING UNITS, GUARDS WHOSE TOP RAIL ALSO SERVES AS A HANDRAIL SHALL HAVE A HEIGHT NOT LESS THAN 34 INCHES AND NOT MORE THAN 38 INCHES MEASURED VERTICALLY FROM THE LEADING EDGE OF THE STAIR TREAD NOSING. CRC SECTION R312.2. OPEN GUARDS SHALL HAVE INTERMEDIATE RAILS SUCH THAT A 4 INCH DIAMETER SPHERE CANNOT PASS THROUGH ANY OPENING. THE TRIANGULAR OPENINGS FORMED BY THE RISER, TREAD, AND BOTTOM RAIL AT THE OPEN SIDE OF A STAIRWAY SHALL BE OF A MAXIMUM SIZE SUCH THAT A SPHERE OF 6 INCHES IN DIAMETER CANNOT PASS THROUGH THE OPENING. CRC SECTION R312.3.

3.] THE WALLS AND SOFFITS OF THE ENCLOSED SPACE UNDER STAIRS SHALL BE PROTECTED ON THE ENCLOSED SIDE WITH 1/2" GYPSUM WALLBOARD. CRC SECTION R302.7

4.] MINIMUM OCCUPANCY SEPARATION BETWEEN GARAGE AND RESIDENCE SHALL BE AS FOLLOWS: 1/2" GYPSUM WALLBOARD SHALL BE INSTALLED ON THE GARAGE SIDE OF THE WALL SEPARATING THE GARAGE FROM THE RESIDENCE AND 5/8" TYPE-X GYPSUM WALLBOARD AT THE UNDERSIDE OF THE HABITABLE ROOM ABOVE THE GARAGE. CRC SECTION AND TABLE R302.6.

5.] MINIMUM OPENING PROTECTION FOR DOOR BETWEEN GARAGE AND RESIDENCE SHALL BE THE INSTALLATION OF A SELF-CLOSING TIGHT-FITTING SOLID WOOD DOOR I-3/8" IN THICKNESS OR A SELF-CLOSING TIGHT-FITTING DOOR HAVING A FIRE PROTECTION RATING OF NOT LESS THAN 20 MINUTES. CRC SECTION R302.5.I.

6.] WATER HEATERS, FURNACES OR OTHER APPLIANCES INSTALLED IN A GARAGE WHICH HAVE A GLOW, SPARK OR IGNITION SOURCE NEED TO BE MOUNTED 18" ABOVE THE FLOOR AND PROTECTED FROM AUTO IMPACT. CPC 507.13 AND CMC 308.1. ALL WATER HEATERS SHALL BE STRAPPED TO THE BUILDING WITH AT LEAST TWO STRAPS TO PREVENT SEISMIC MOVEMENT. ONE STRAP WITHIN THE TOP THIRD AND THE OTHER WITHIN THE BOTTOM THIRD OF THE WATER HEATER. THE LOWER STRAP SHALL NOT BE WITHIN 4" OF THE CONTROL. CPC 507.2

SHALL BE INSTALLED PER MANUFACTURER'S SPECIFICATIONS. SEE FLUE MANUFACTURER'S SPECIFICATIONS FOR FLUE CLEARANCES. VERIFICATION OR APPROVAL OF VENT HEIGHT AND LOCATION WITH AN INSPECTOR PRIOR TO INSTALLATION IS SUGGESTED. ALL GAS FIREPLACES SHALL BE DIRECT-VENT SEALED-COMBUSTION TYPE PER CALGREEN 2013 GREEN BUILDING CODE SECTION 4.503.

7.] PROVIDE ROOF TERMINATION FOR GAS APPLIANCE. APPLIANCE

a] PROVIDE 60" DIRECT-VENT GAS FIREPLACE @ LIVING b] FIREPIT SHALL BE PLUMBED FOR GAS. PROVIDE (4) EQ. SPACED ADJUSTABLE GAS JETS SET IN BLACK VOLCANIC STONES.

8.] THE FOLLOWING SHALL BE CONSIDERED HAZARDOUS LOCATIONS REQUIRING SAFETY GLAZING: GLAZING IN DOORS AND ENCLOSURES FOR HOT TUBS, WHIRLPOOLS, SAUNAS, STEAM ROOMS, BATHTUBS, AND SHOWERS; GLAZING IN ANY PORTION OF A BUILDING WALL ENCLOSING THESE COMPARTMENTS WHERE THE BOTTOM EXPOSED EDGE OF THE GLAZING IS LESS THAN 60" ABOVE A STANDING SURFACE AND DRAIN INLET: GLAZING WITHIN A 24" ARC OF EITHER VERTICAL EDGE OF A DOOR IN CLOSED POSITION; GLAZING ADJACENT TO STAIRWAYS AND LANDINGS WITHIN 36 INCHES HORIZONTALLY OF A WALKING SURFACE WHEN THE EXPOSED SURFACE OF THE GLASS IS LESS THAN 60 INCHES ABOVE THE PLANE OF THE ADJACENT WALKING SURFACE; GLAZING ADJACENT TO STAIRWAYS WITHIN 60 INCHES HORIZONTALLY OF THE BOTTOM TREAD OF A STAIRWAY IN ANY DIRECTION WHEN THE EXPOSED SURFACE OF THE GLASS IS LESS THAN 60 INCHES ABOVE THE NOSE OF THE TREAD. CRC SECTION R308.4.

a] CONTRACTOR SHALL VERIFY SAFETY GLAZING AT ALL LOCATIONS PER 2013 CBC.

b] EXTERIOR WINDOWS, WINDOW WALLS, GLAZED DOORS, AND GLAZED consent of the architect + engineer OPENINGS WITHIN EXTERIOR DOORS SHALL BE INSULATING-GLASS UNITS WITH A MINIMUM OF ONE TEMPERED PANE. CRC SECTION

9.] SLEEPING ROOMS BELOW THE FOURTH STORY ABOVE GRADE PLANE SHALL HAVE AT LEAST ONE EXTERIOR EMERGENCY ESCAPE AND RESCUE OPENING. CRC SECTION R310.1. EMERGENCY ESCAPE AND RESCUE OPENINGS SHALL HAVE A MINIMUM NET CLEAR OPENING OF 5.7 SQUARE FEET. THE MINIMUM NET CLEAR OPENING HEIGHT DIMENSION SHALL BE 24 INCHES. THE MINIMUM NET CLEAR OPENING WIDTH DIMENSION SHALL BE 20 INCHES. CRC SECTIONS R310.1.1 THROUGH R310.1.3. EMERGENCY ESCAPE AND RESCUE OPENINGS SHALL HAVE THE BOTTOM OF THE CLEAR OPENING NOT GREATER THAN 44 INCHES MEASURED FROM THE FLOOR. CRC SECTION R310.1.

IO.] DECKING, SURFACES, STAIR TREADS, RISERS, AND LANDINGS OF DECKS, PORCHES, AND BALCONIES WHERE ANY PORTION OF SUCH SURFACE IS WITHIN 10 FEET OF THE PRIMARY STRUCTURE SHALL BE CONSTRUCTED WITH HEAVY TIMBER, EXTERIOR FIRE-RETARDANT-TREATED WOOD OR APPROVED NONCOMBUSTIBLE MATERIALS. CRC SECTION R327.9.3.

II.] NOTE NOT USED

12.] NOTE NOT USED

13.] OPENINGS IN THE BUILDING ENVELOPE SEPARATING CONDITIONED SPACE FROM UNCONDITIONED SPACE NEEDED TO ACCOMMODATE GAS, PLUMBING, ELECTRICAL LINES AND OTHER NECESSARY PENETRATIONS MUST BE SEALED IN COMPLIANCE WITH THE CALIFORNIA ENERGY CODE AND ALSO THE CALIFORNIA RESIDENTIAL CODE CRC R316 WHERE FOAM PLASTIC INSULATION IS PROPOSED FOR COMPLIANCE. EXCEPTION: ANNULAR SPACES AROUND PIPES, ELECTRIC CABLES, CONDUITS, OR OTHER OPENINGS IN PLATES AT EXTERIOR WALLS SHALL BE PROTECTED AGAINST THE PASSAGE OF RODENTS BY CLOSING SUCH OPENINGS WITH CEMENT MORTAR, CONCRETE MASONRY OR SIMILAR METHOD ACCEPTABLE TO THE ENFORCING AGENCY, CALGREEN 4.406.1

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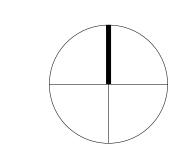
Job Number 681

Issue Date 10 February 2017

Subject

Conditional Use Permit


Plan North




**K**ey Plan

Drawing Number

LOWER LEVEL FLOOR PLAN

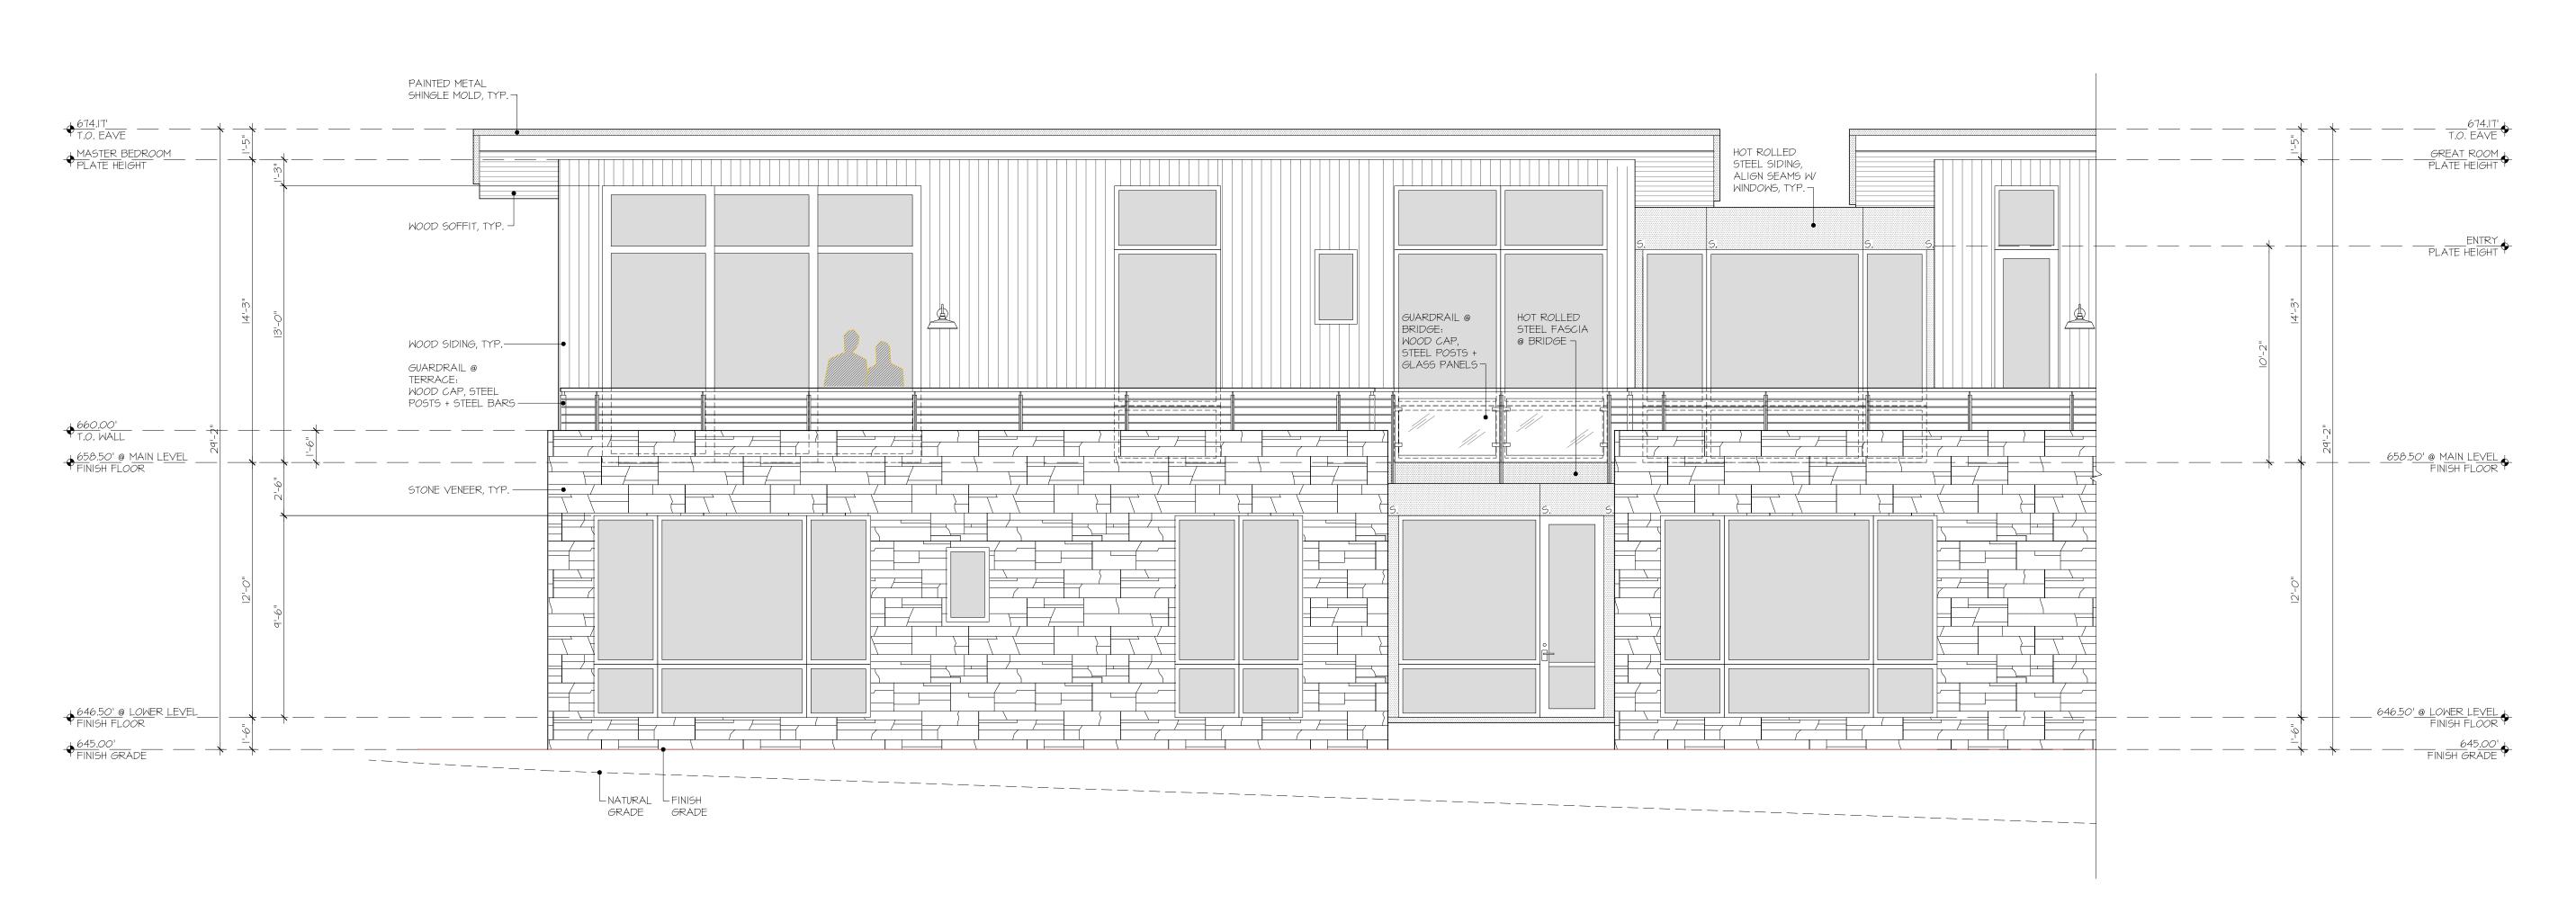

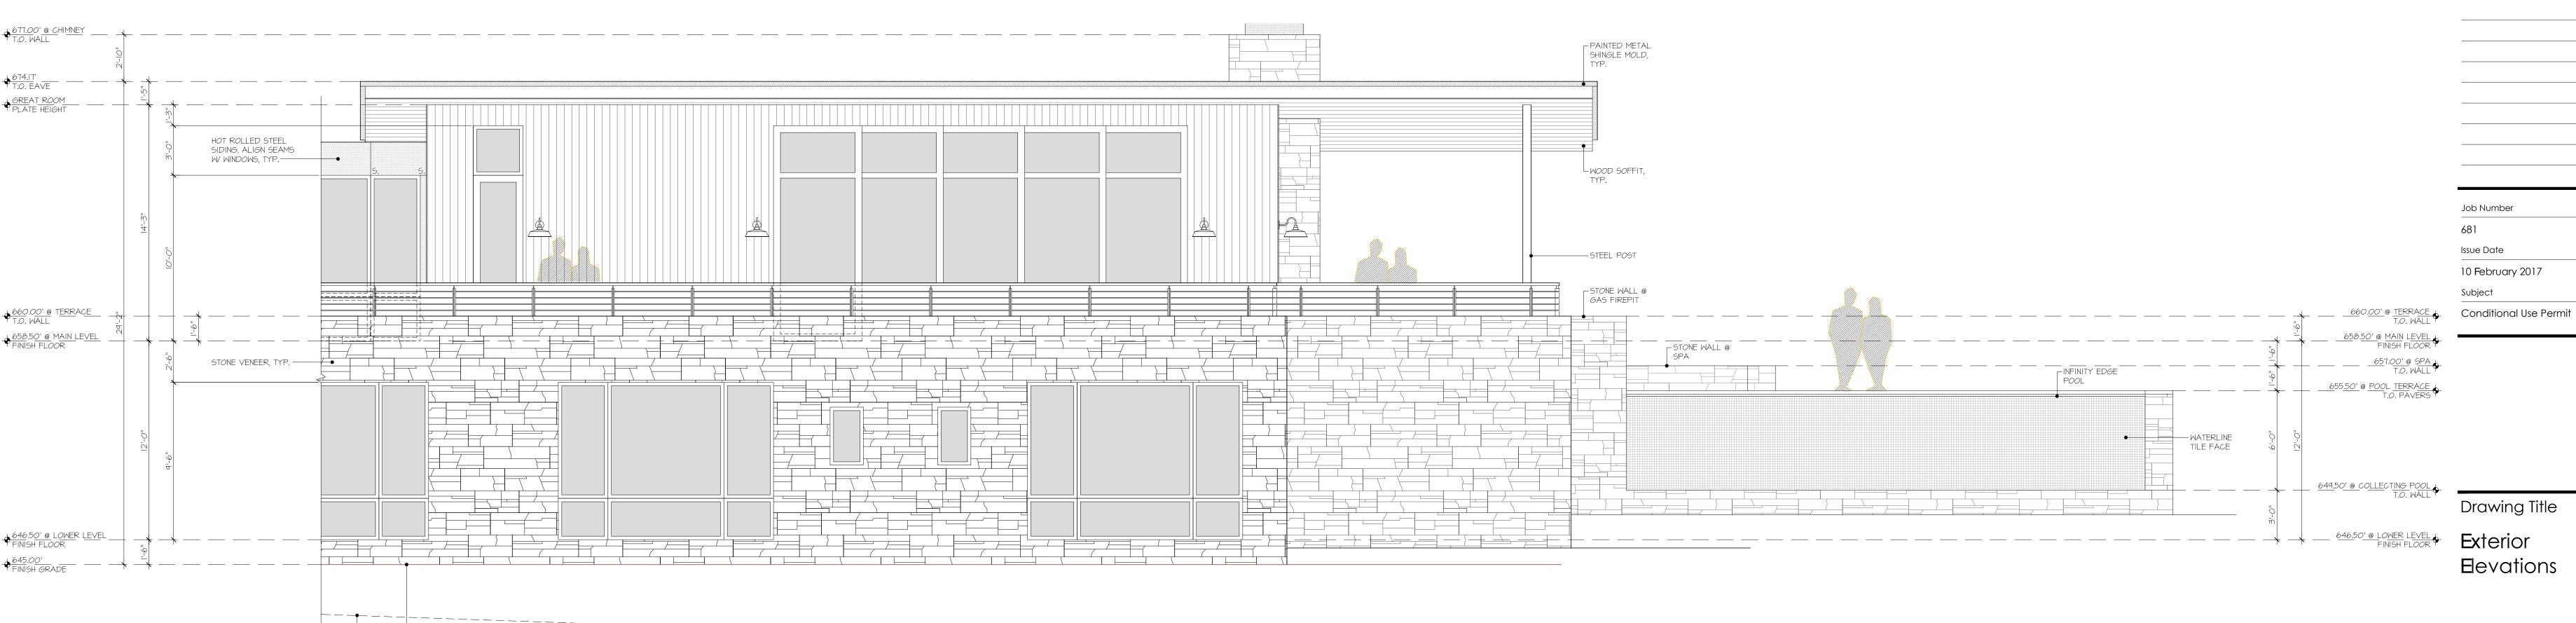

HEIGHT CALCULATION

LOWEST FINISH GRADE AT BUILDING FOUNDATION = 645.00' T.O. HIGHEST EAVE = 674.17'MAXIMUM PROPOSED BUILDING HEIGHT = 29'-2"

## EXTERIOR FINISH LEGEND

FASCIA: PAINTED METAL COLOR: BLACK

ROOFS [I:12 SLOPE]: DOUBLE-LOCK STANDING SEAM PAINTED METAL COLOR: BLACK ROOFS [1/4:12 SLOPE]: TORCH-DOWN WITH DECORATIVE PEBBLE BALLAST COLOR: BLACK

WOOD SIDING: BARNWOOD, IX6 SHIPLAP COLOR: WEATHERED GRAY

METAL SIDING: HOT ROLLED STEEL FINISH: CLEAR

WINDOWS: ALUMINUM CLAD EXTERIOR, WOOD INTERIOR COLOR: BLACK

STRUCTURAL MEMBERS: STEEL COLOR: CLEAR

SOFFITS: DOUGLAS FIR GRADE-D, RESAWN, IX4 T+G STAIN: GINGER

STONE VENEER: SQUARE RUBBLE LEDGESTONE

#### GENERAL NOTES

I] ALL EXTERIOR MATERIALS TO COMPLY WITH R327 OF THE CALIFORNIA RESIDENTIAL CODE.

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**Elevations** 



LNATURAL LFINISH GRADE GRADE

HEIGHT CALCULATION SEE SHEET A-3.I

EXTERIOR FINISH LEGEND

SEE SHEET A-3,I

GENERAL NOTES

SEE SHEET A-3,I

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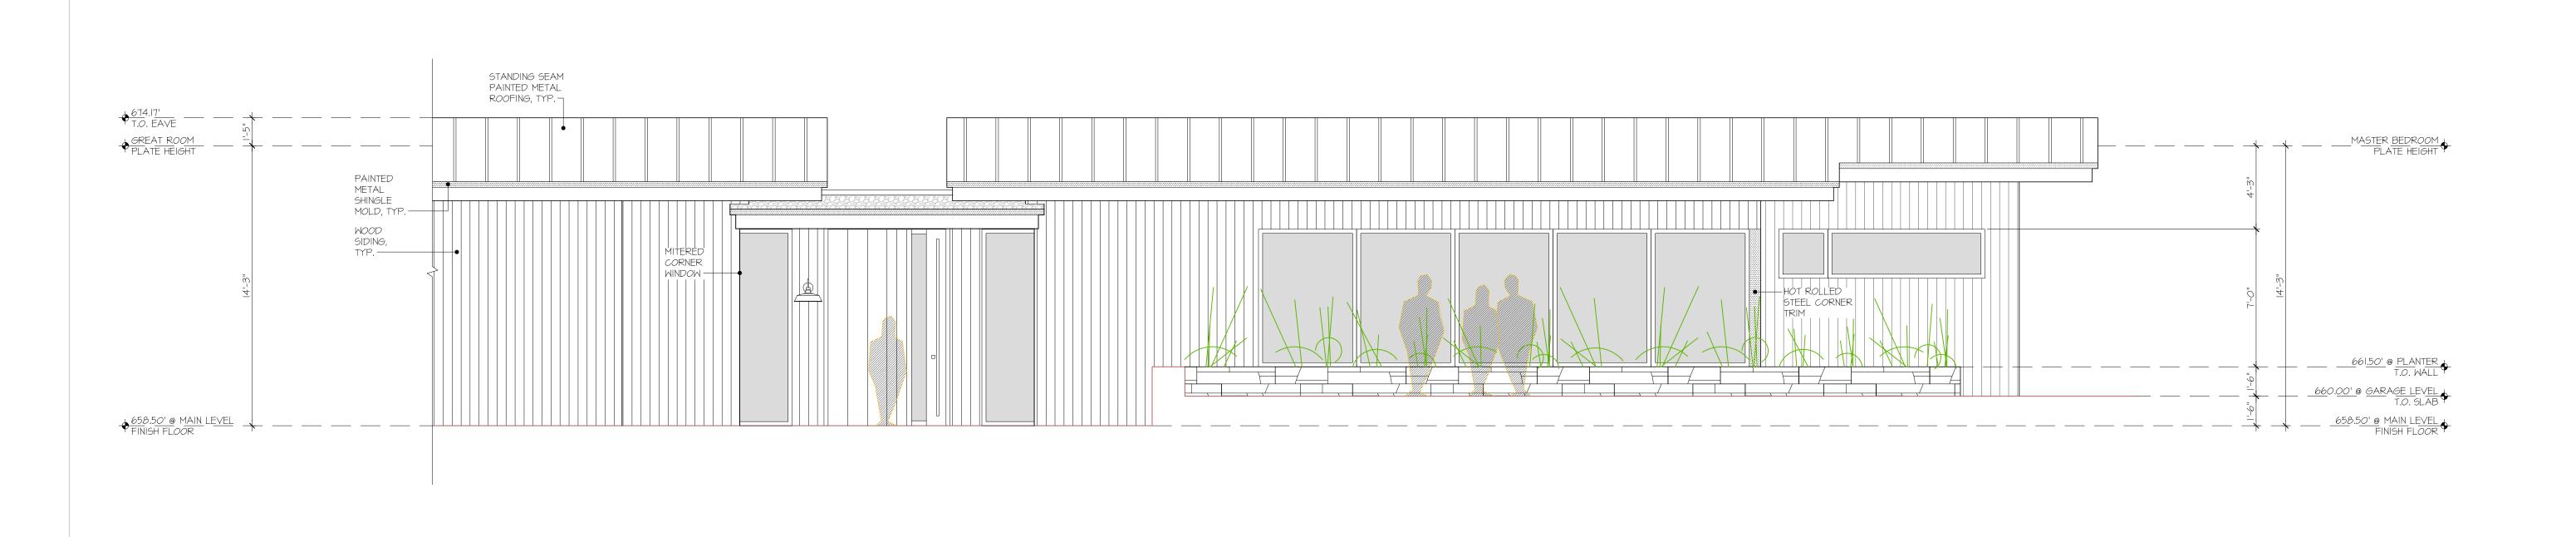
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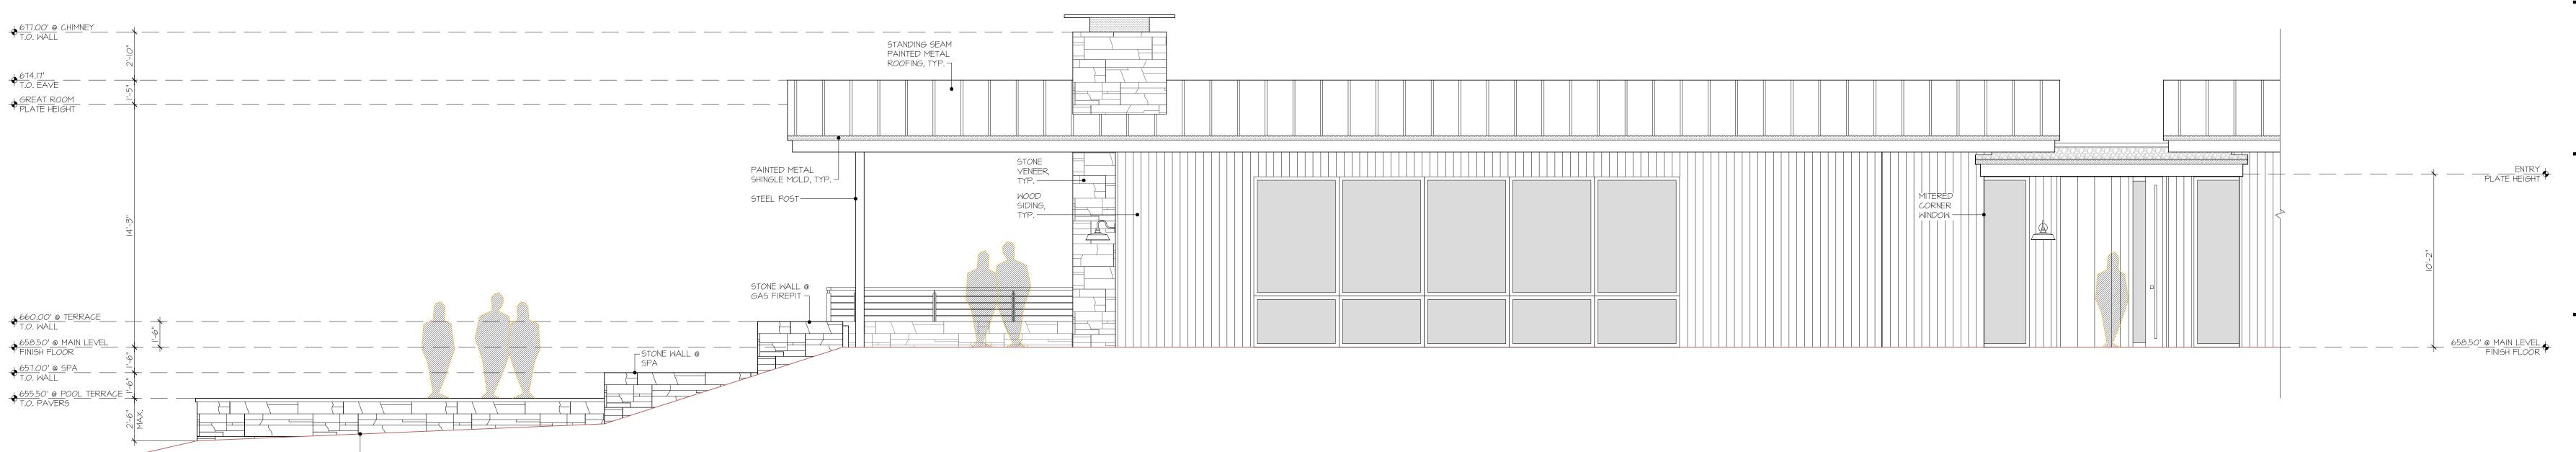
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Exterior Elevations

Drawing Number




NORTH ELEVATION



NATURAL FINISH GRADE GRADE

# \_\_\_\_674.17′ **♦** MITERED CORNER WINDOW ——— ♦ 661.50' @ PLANTER\_\_\_\_\_ T.O. WALL 660.00' @ TERRACE + T.O. WALL L FINISH GRADE

POOL TERRACE VIEW

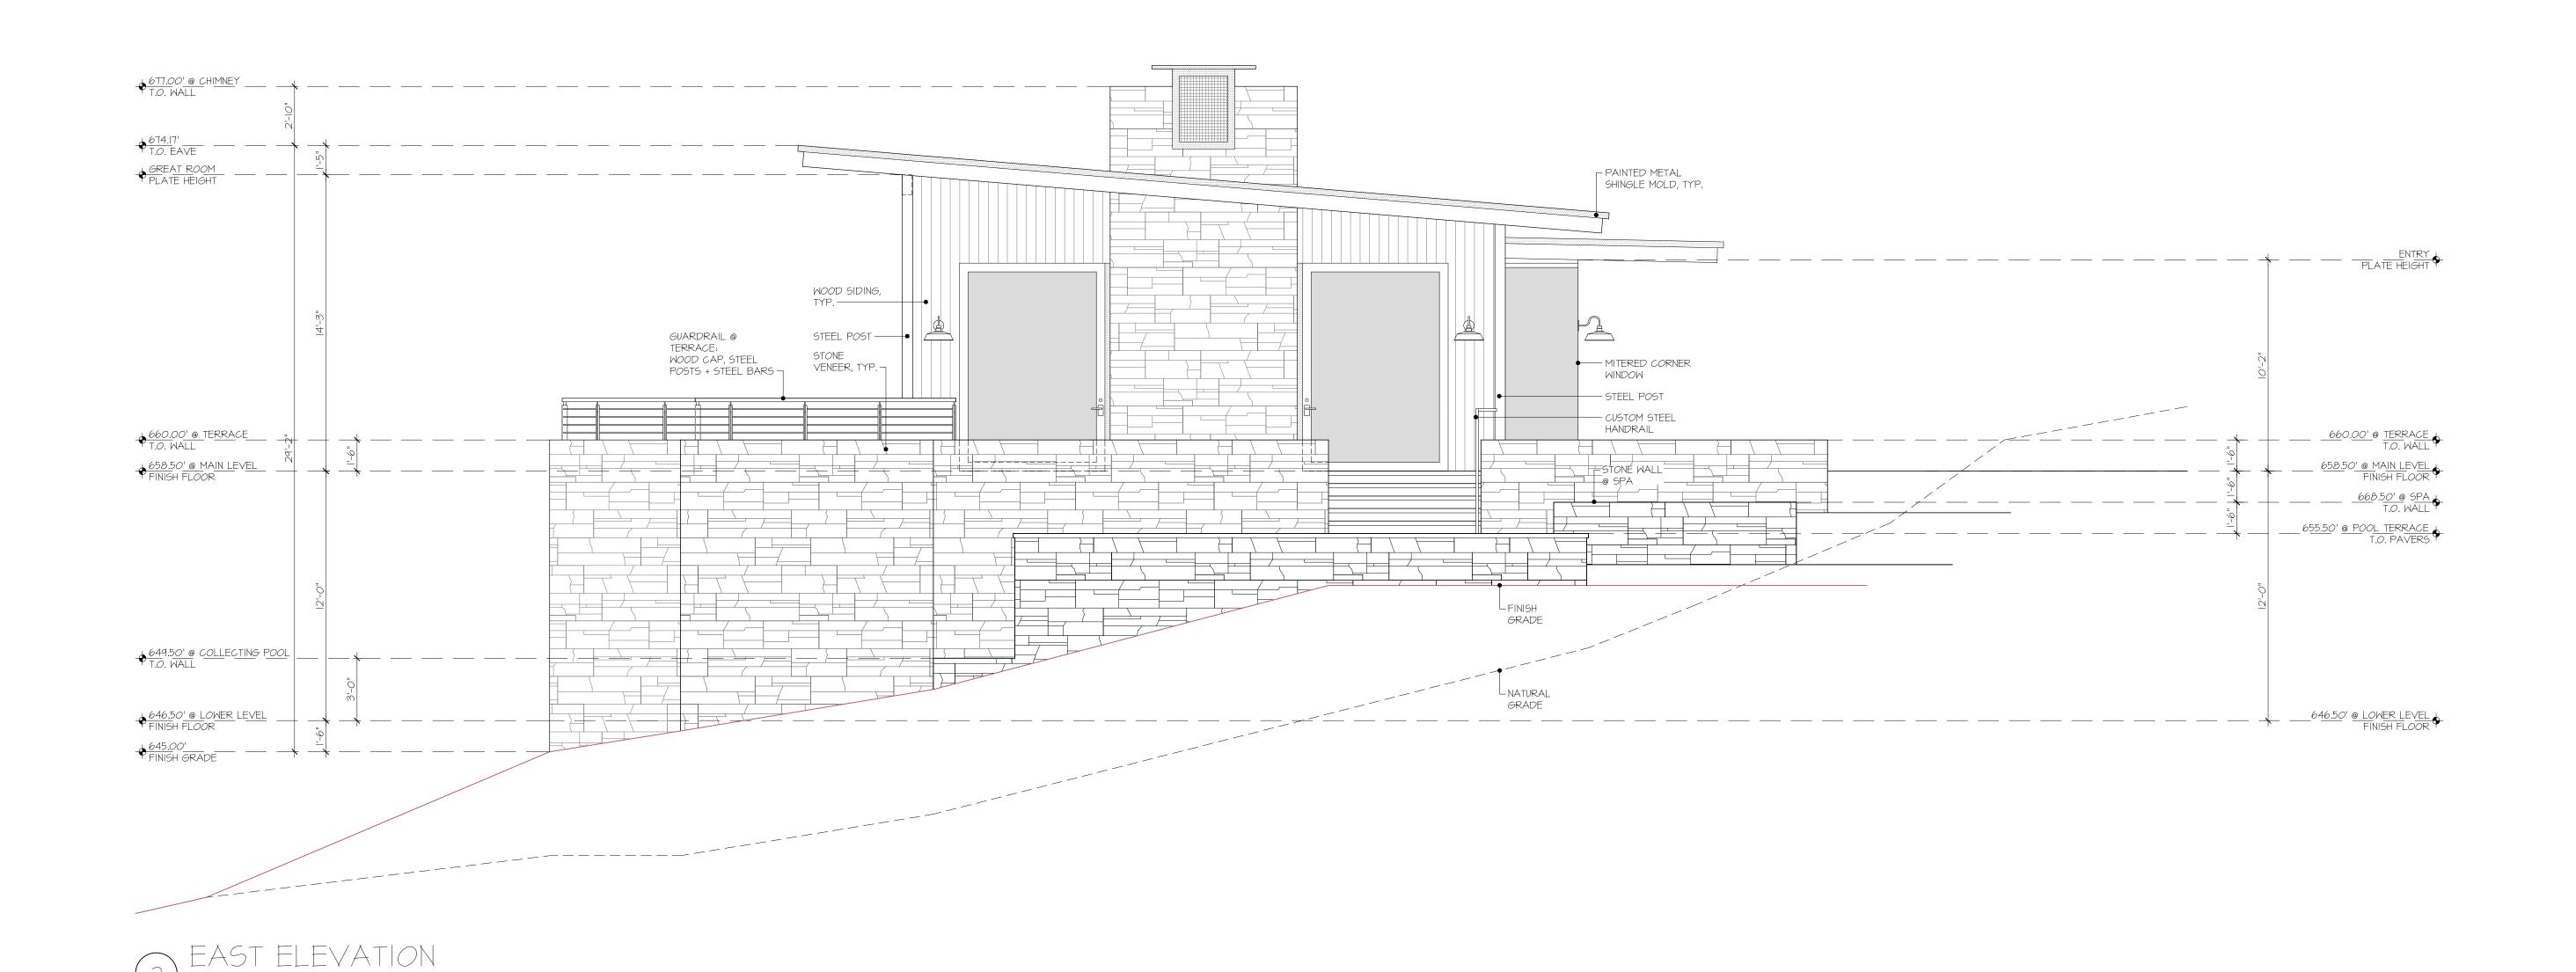

HEIGHT CALCULATION

SEE SHEET A-3.I

EXTERIOR FINISH LEGEND

SEE SHEET A-3.I

GENERAL NOTES

SEE SHEET A-3.I

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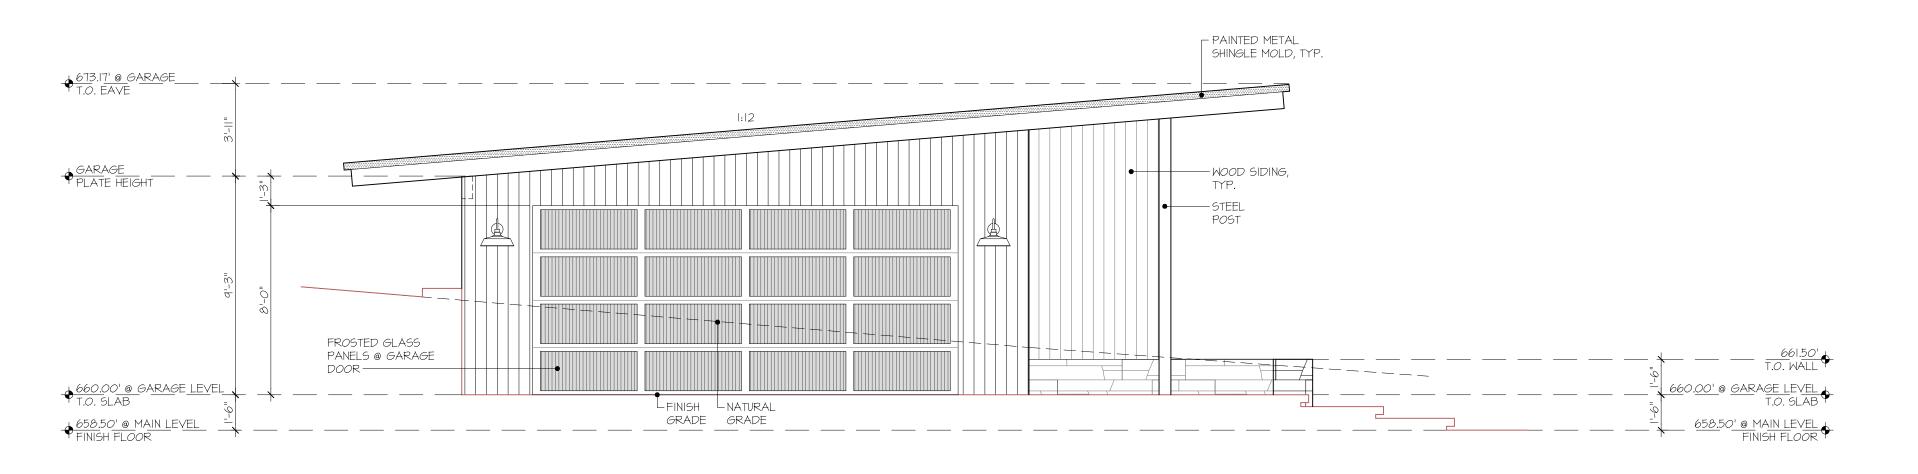
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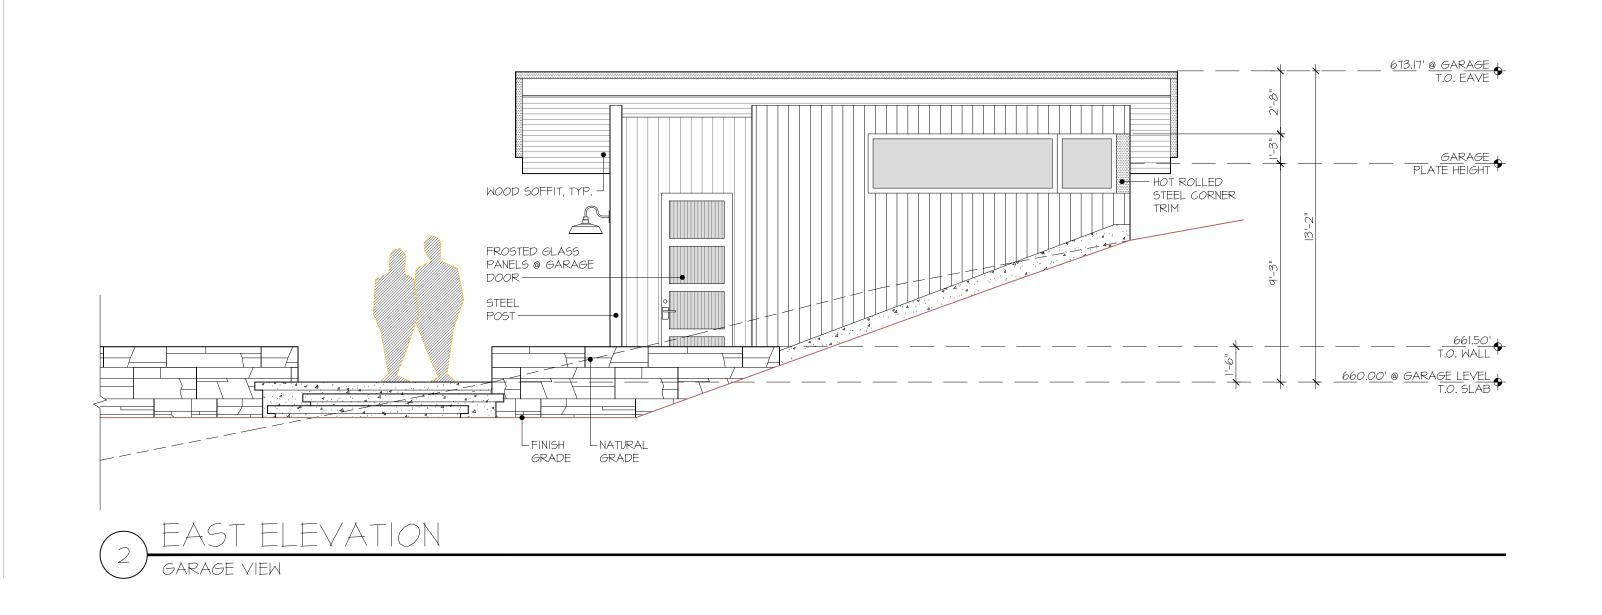
Drawing Title

Exterior Elevations

Drawing Number

a 3.3





HEIGHT CALCULATION

SEE SHEET A-3.I

EXTERIOR FINISH LEGEND

SEE SHEET A-3.I

GENERAL NOTES


SEE SHEET A-3.I

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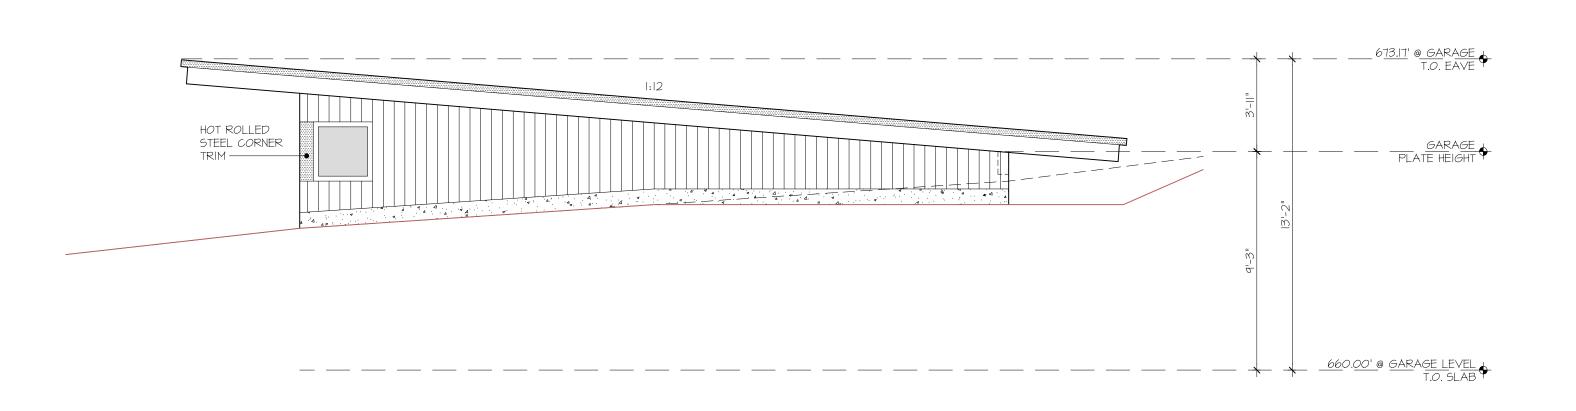
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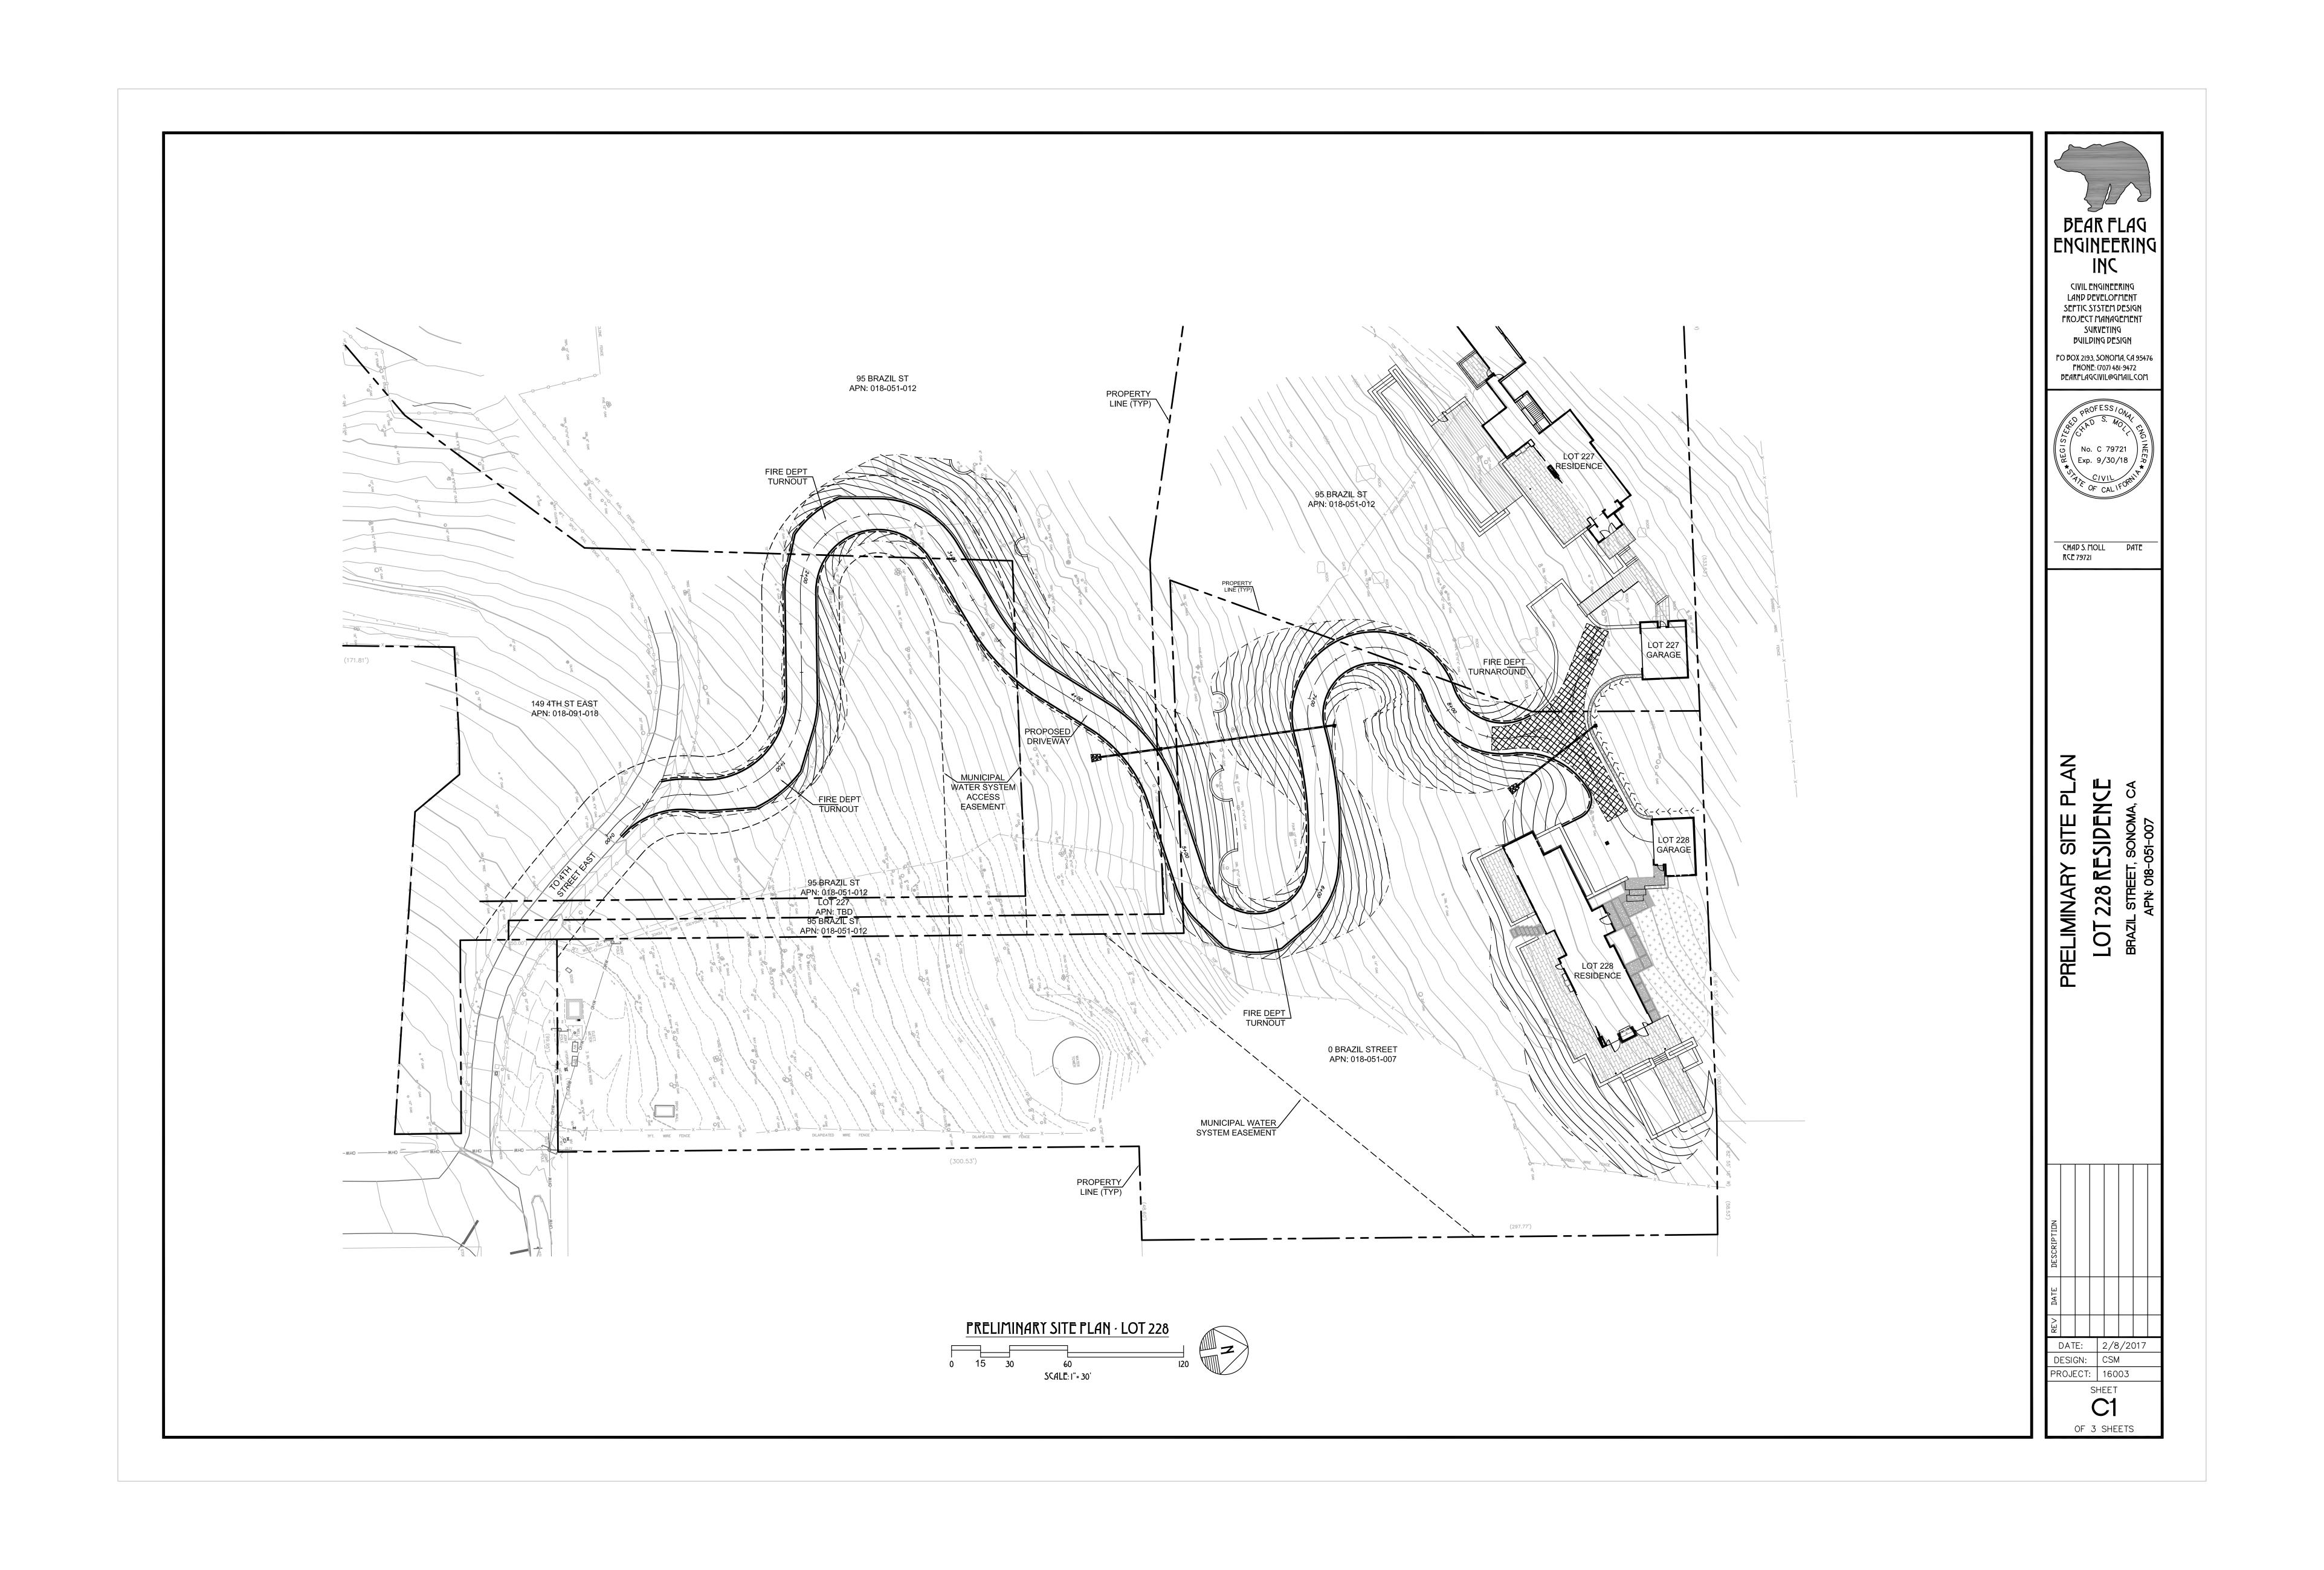



NORTH ELEVATION GARAGE VIEW


Drawing Title Exterior **Elevations** 

Drawing Number

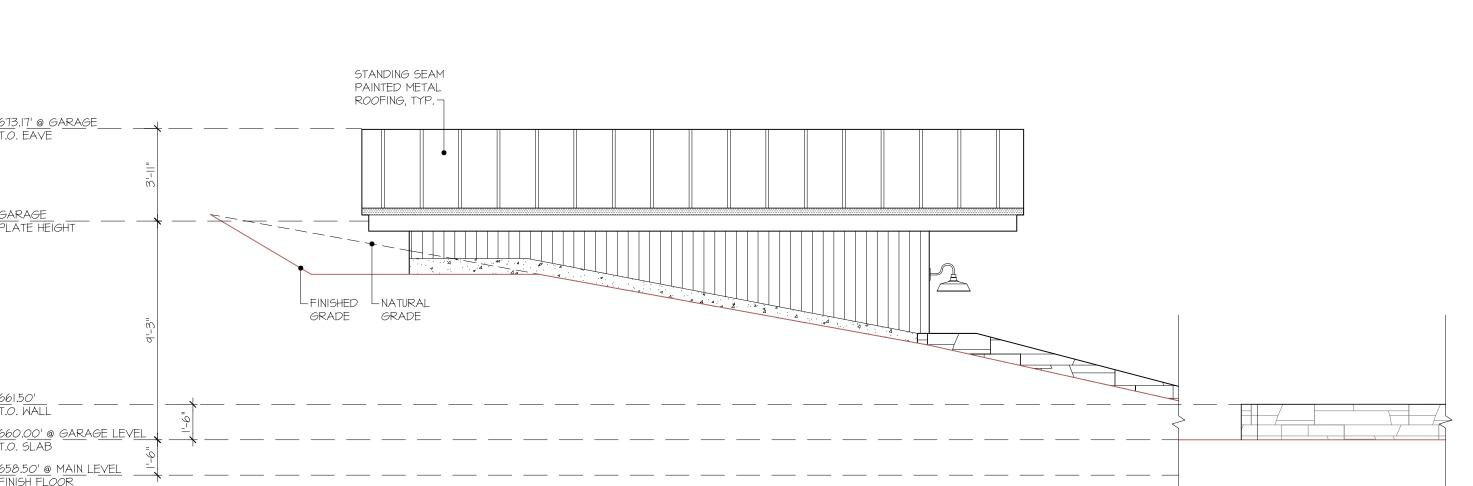a 3.4



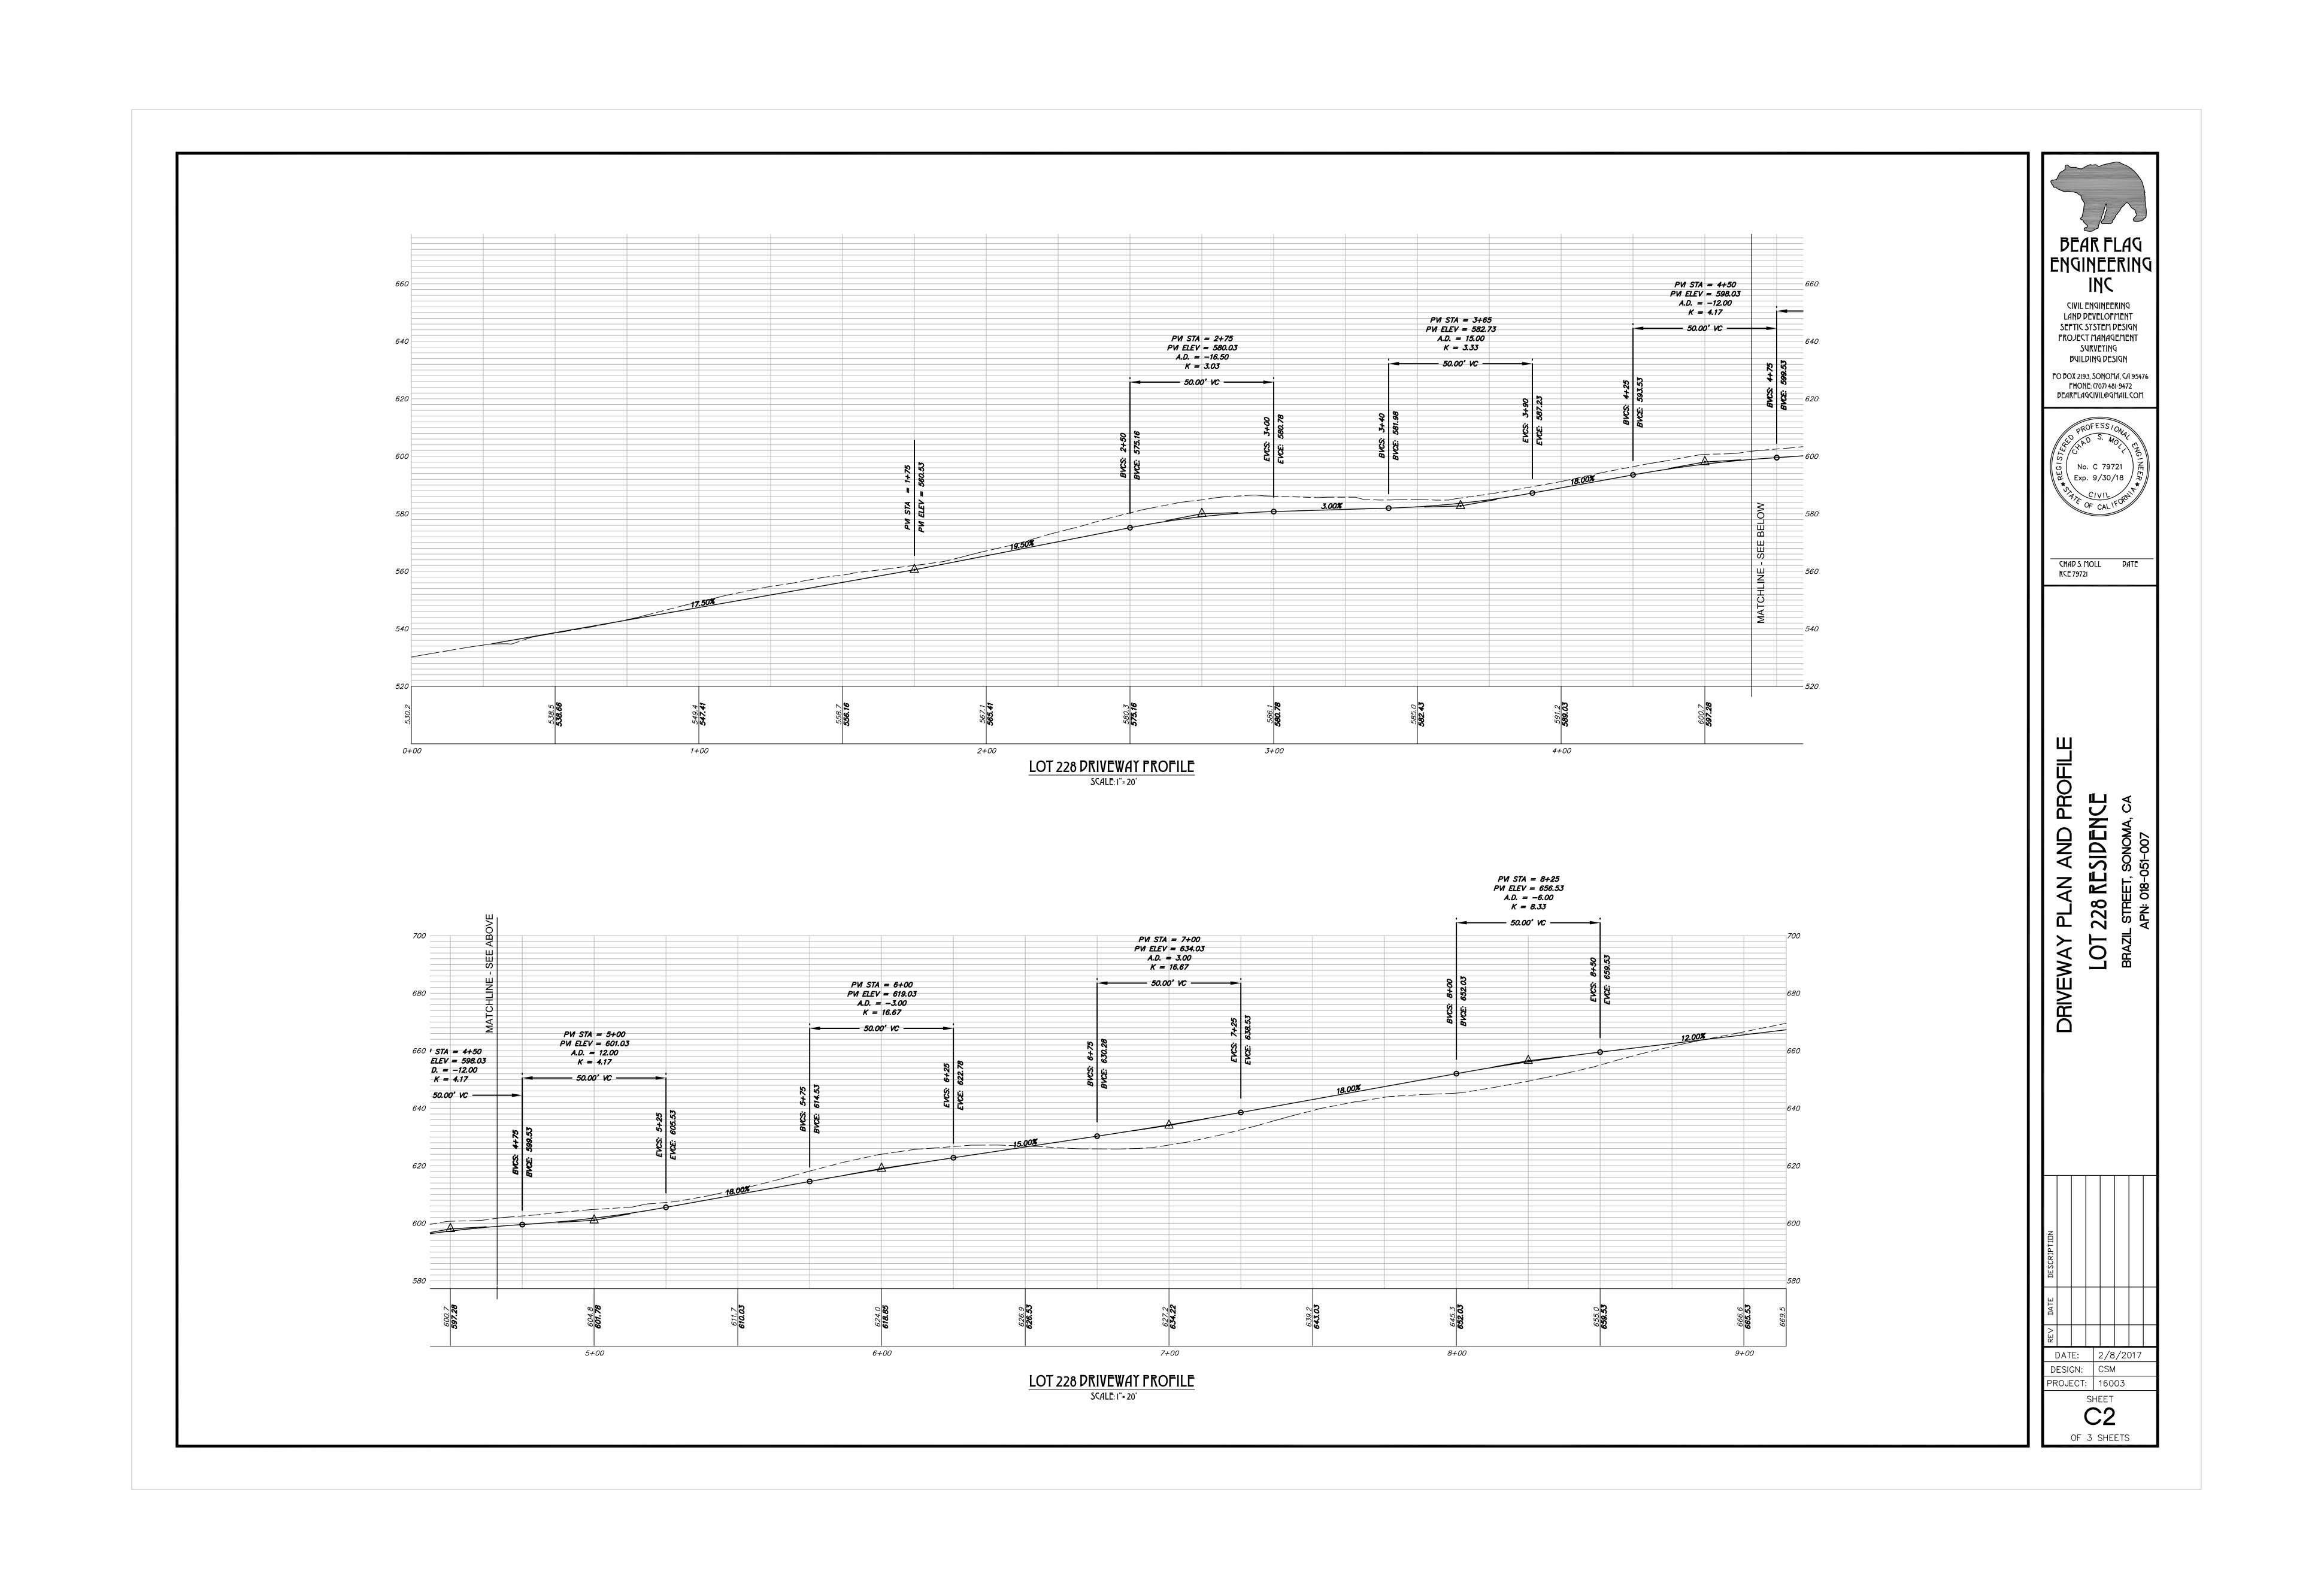

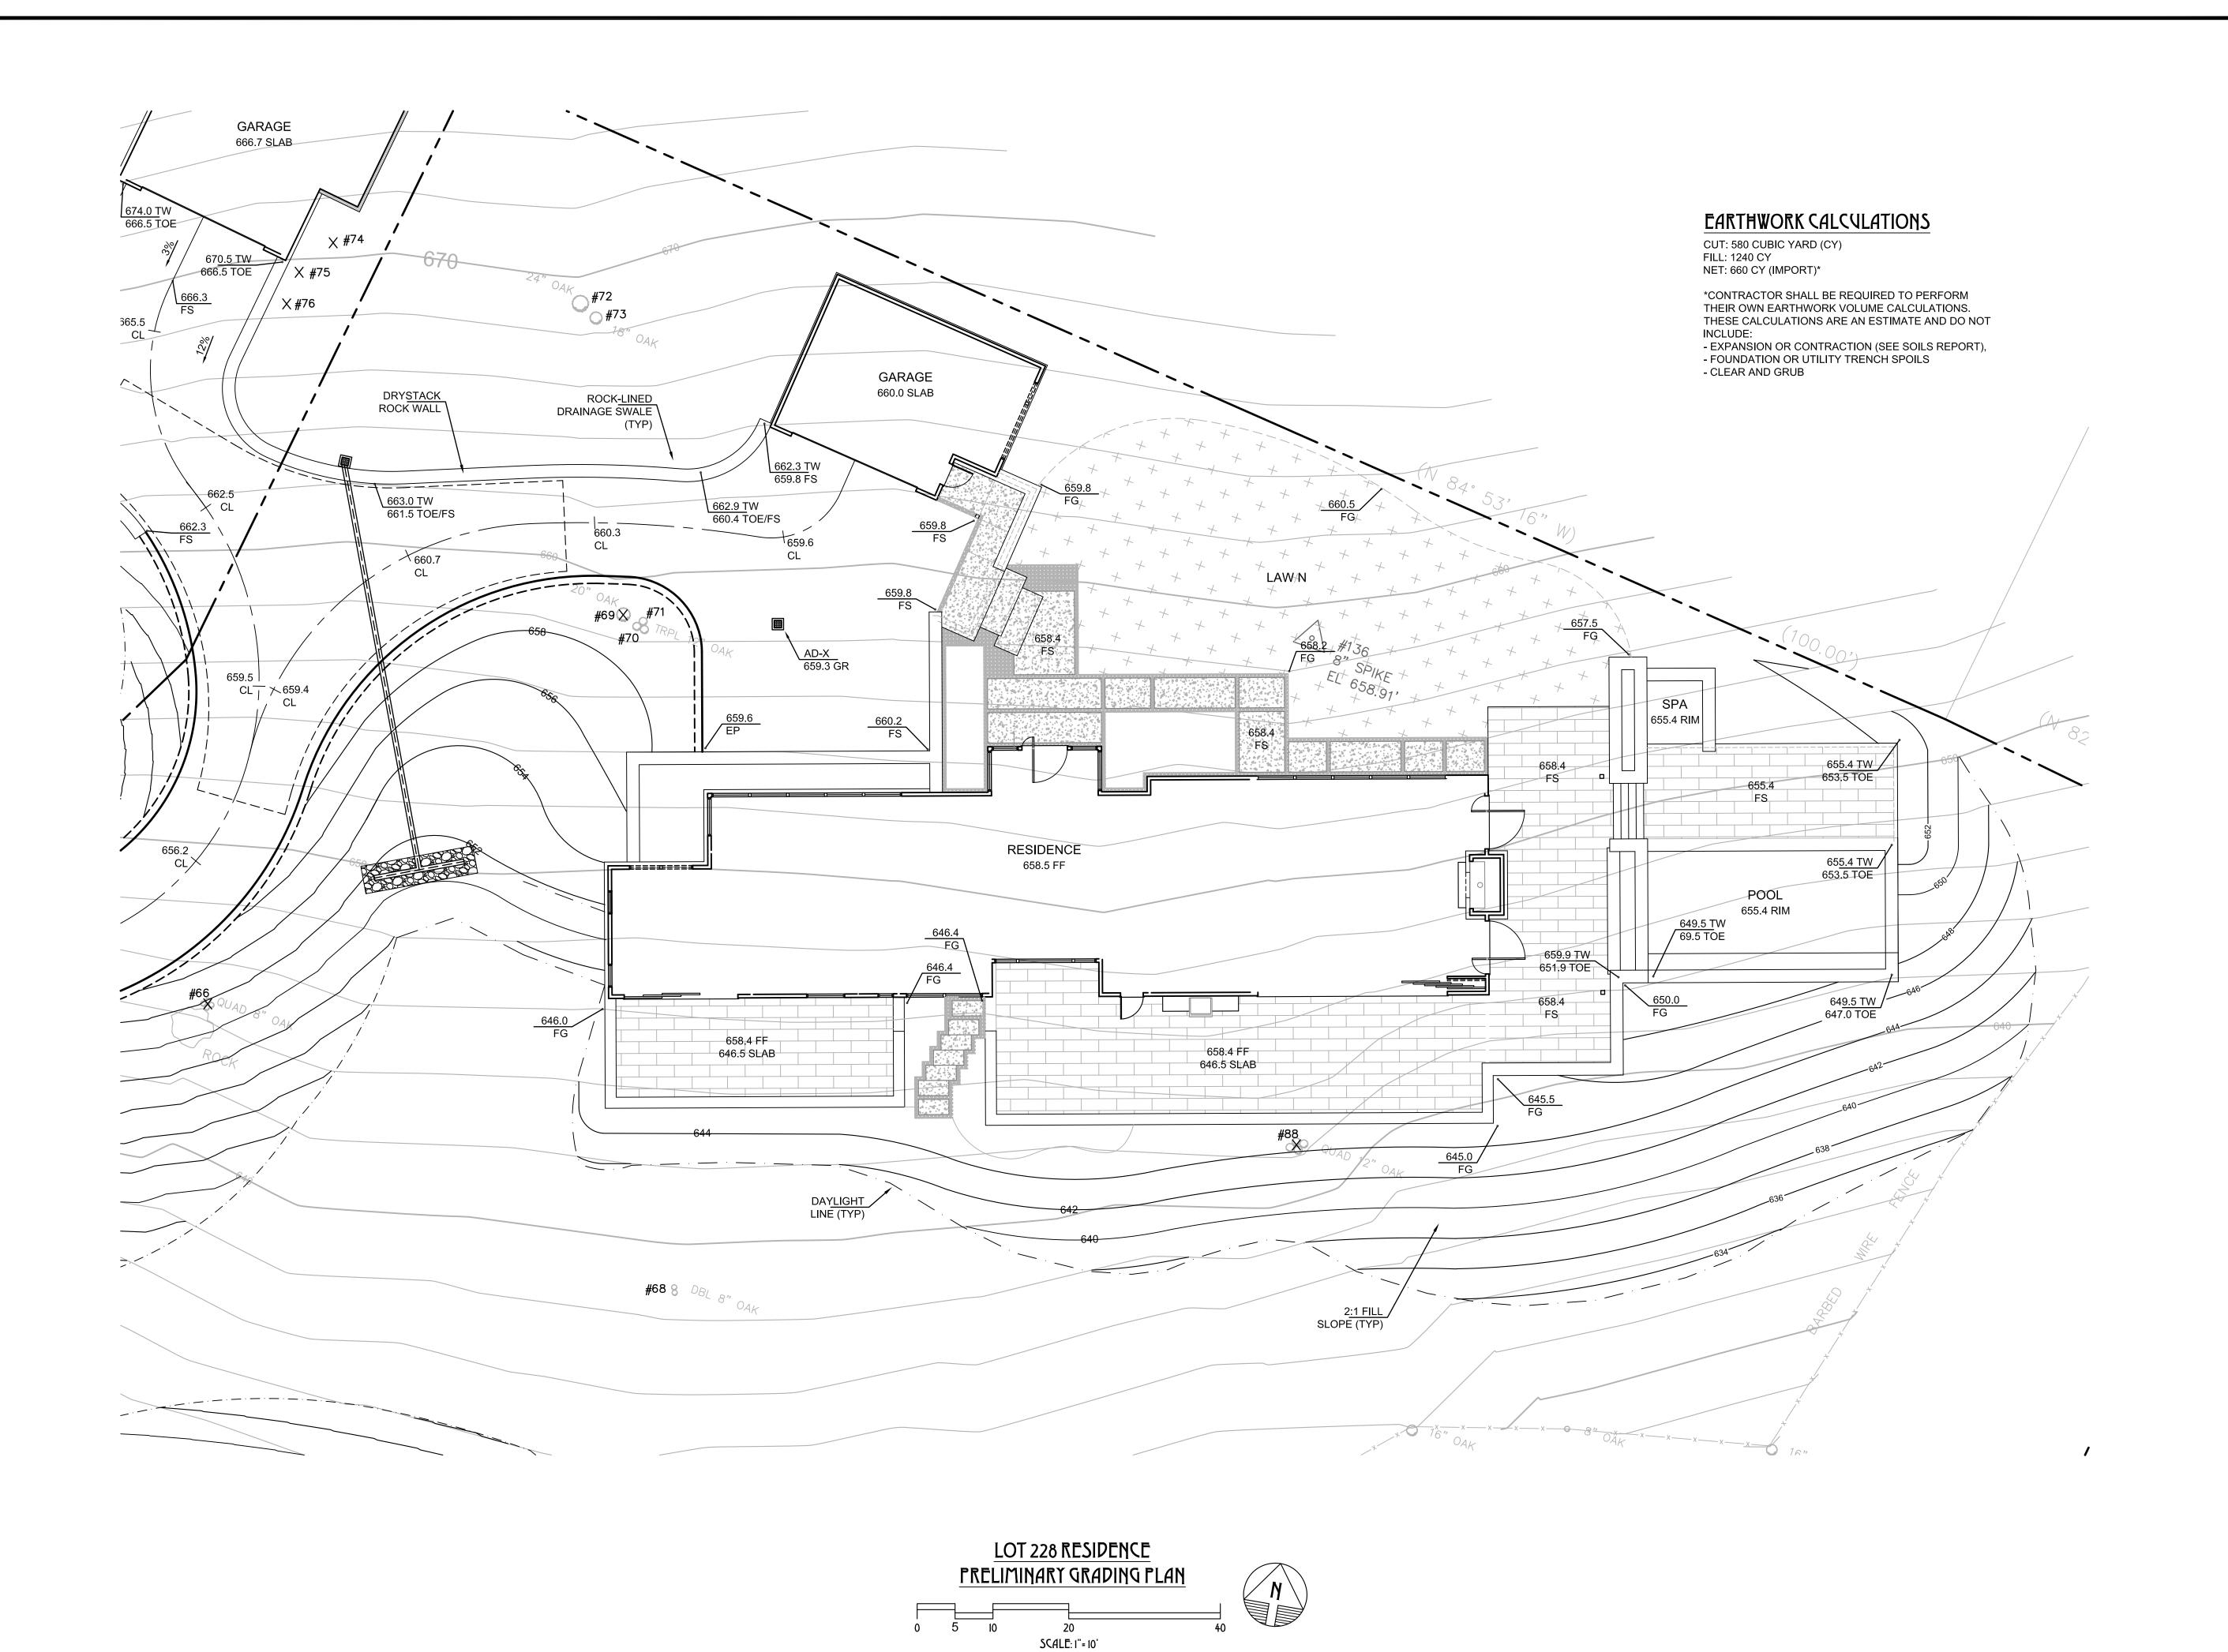




CIVIL ENGINEERING SURVEYING LAND DEVELOPMENT SEPTIC SYSTEM DESIGN PROJECT MANAGEMENT FORENSIC ENGINEERING

527 BROADWAY #202 SONOMA, CA 95476 PHONE: (707) 481-9472


OFFICE@BEARFLAGCIVIL.COM


PLAN RESIDENCE 28 **PRELIMINARY** LOT 23

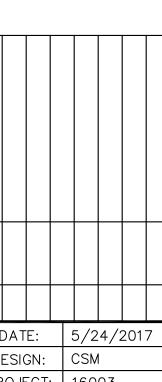

DESIGN: PROJECT: 16003

> SHEET **C**3

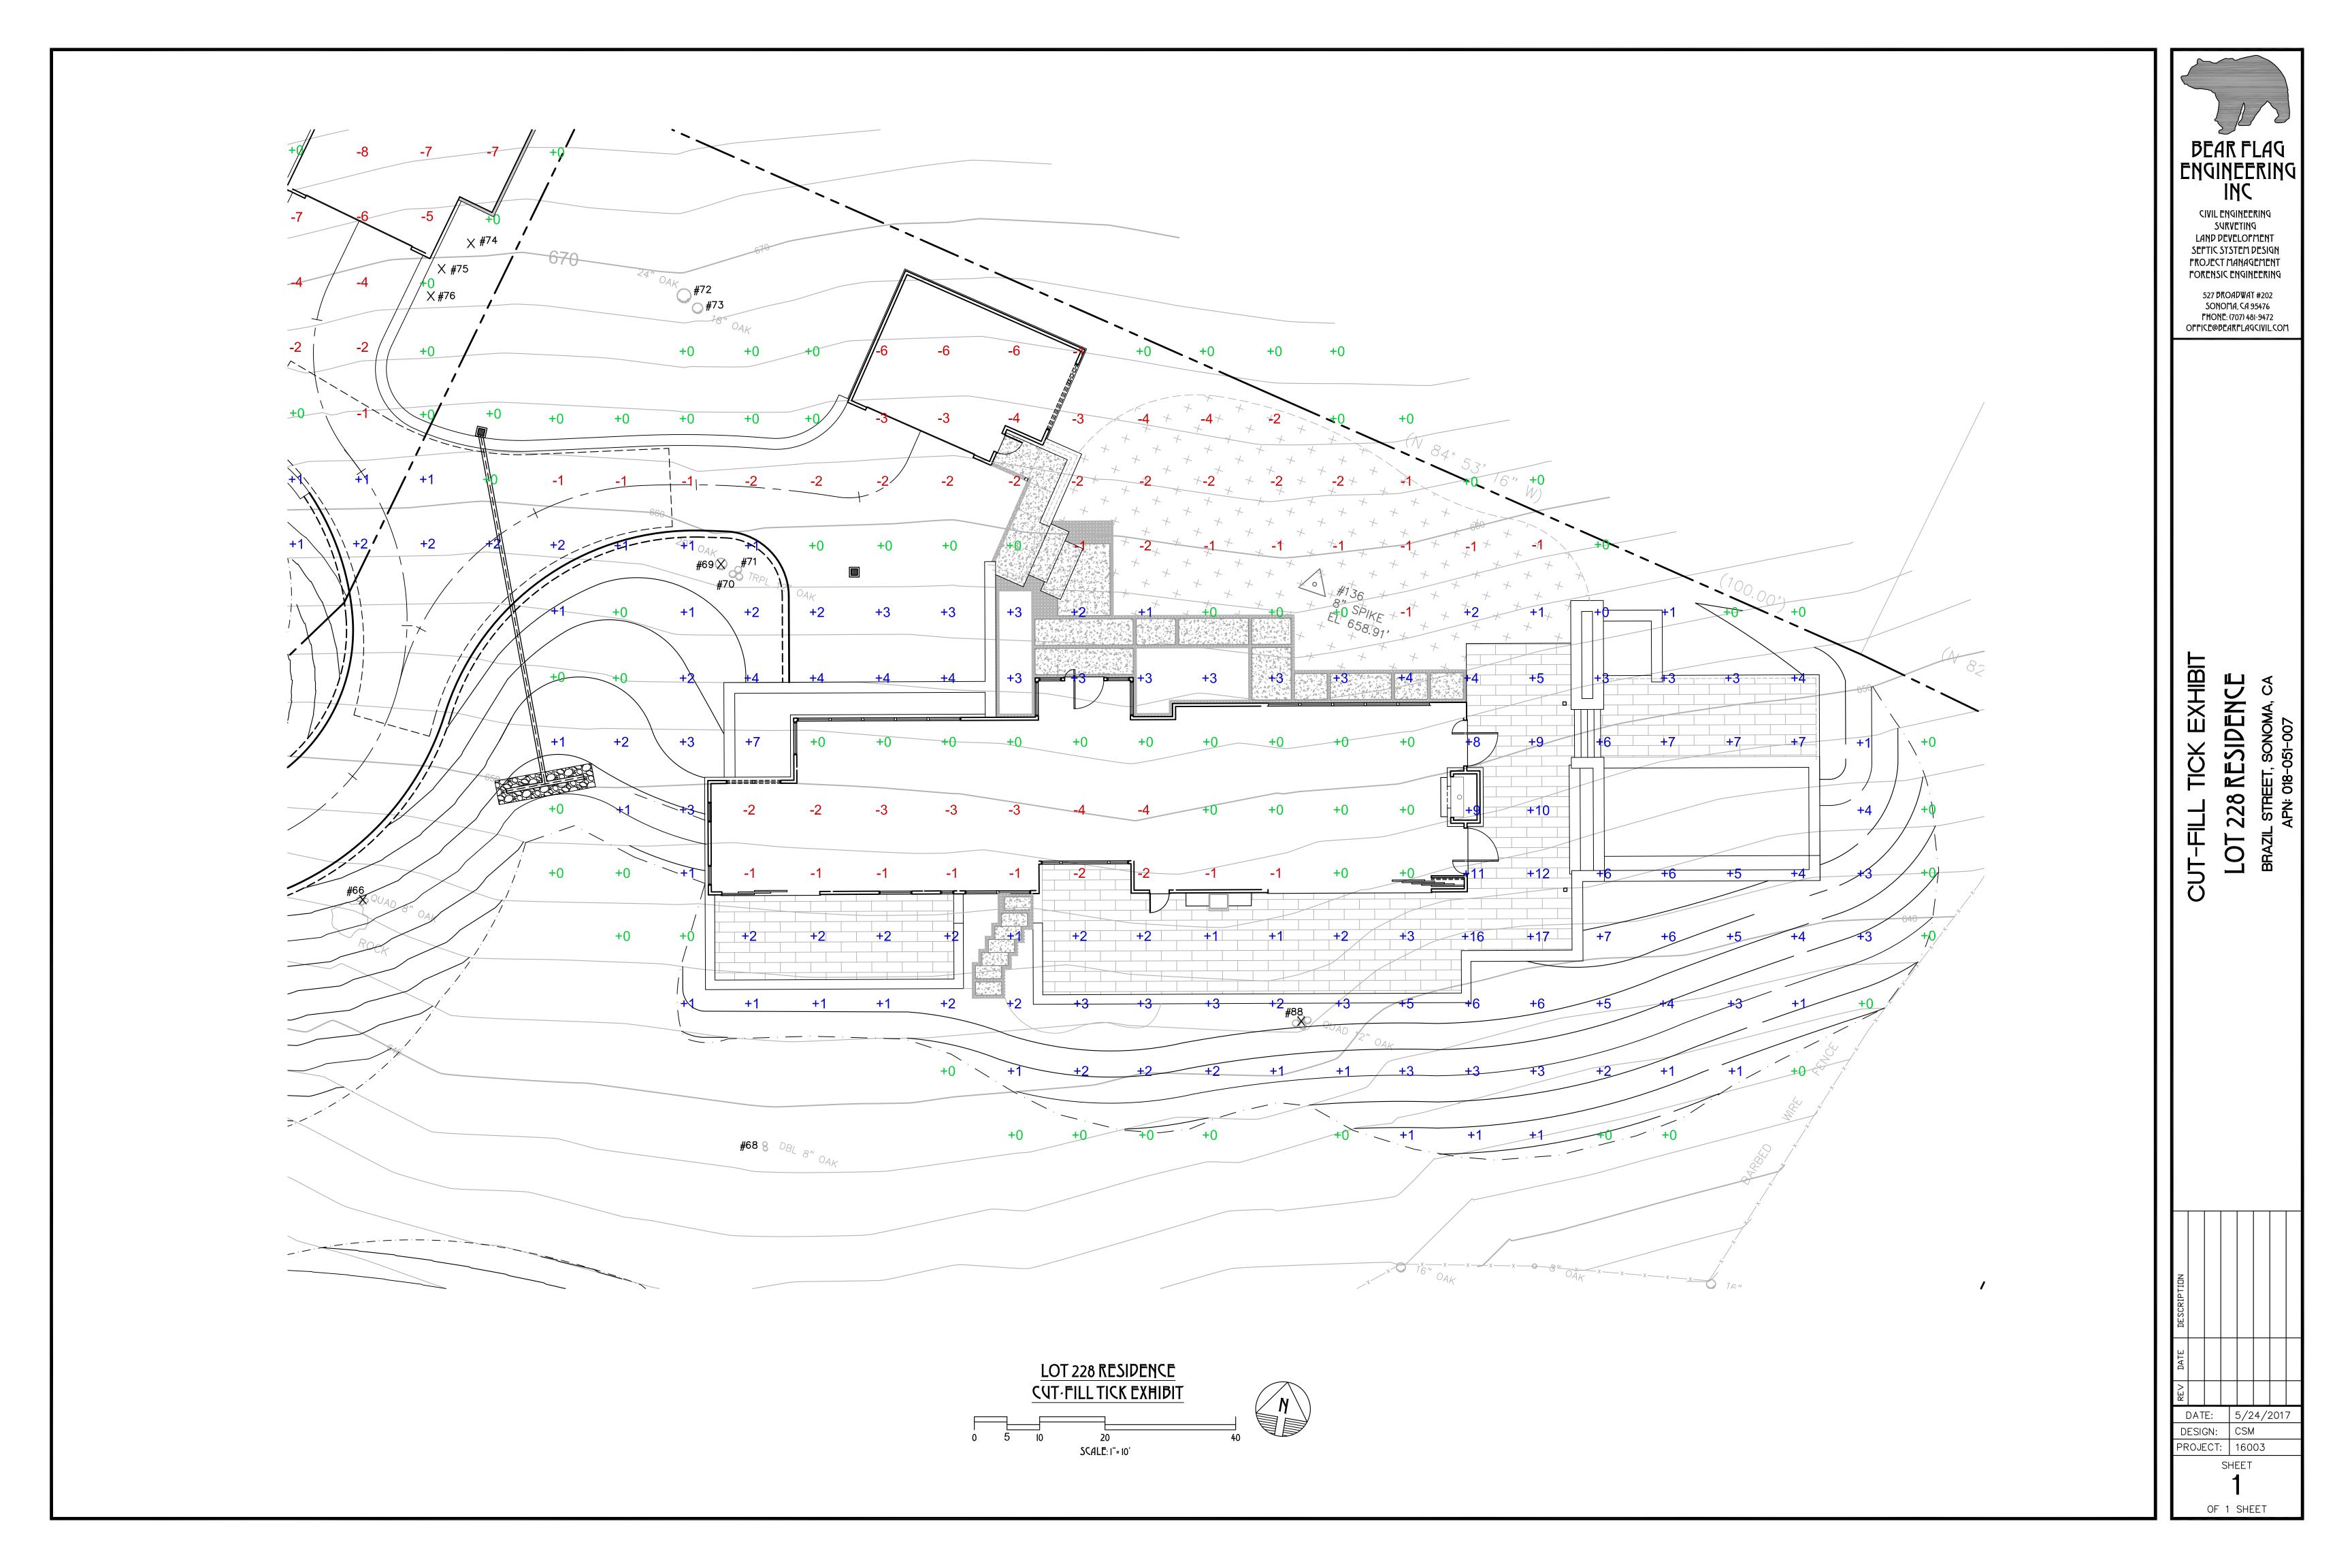

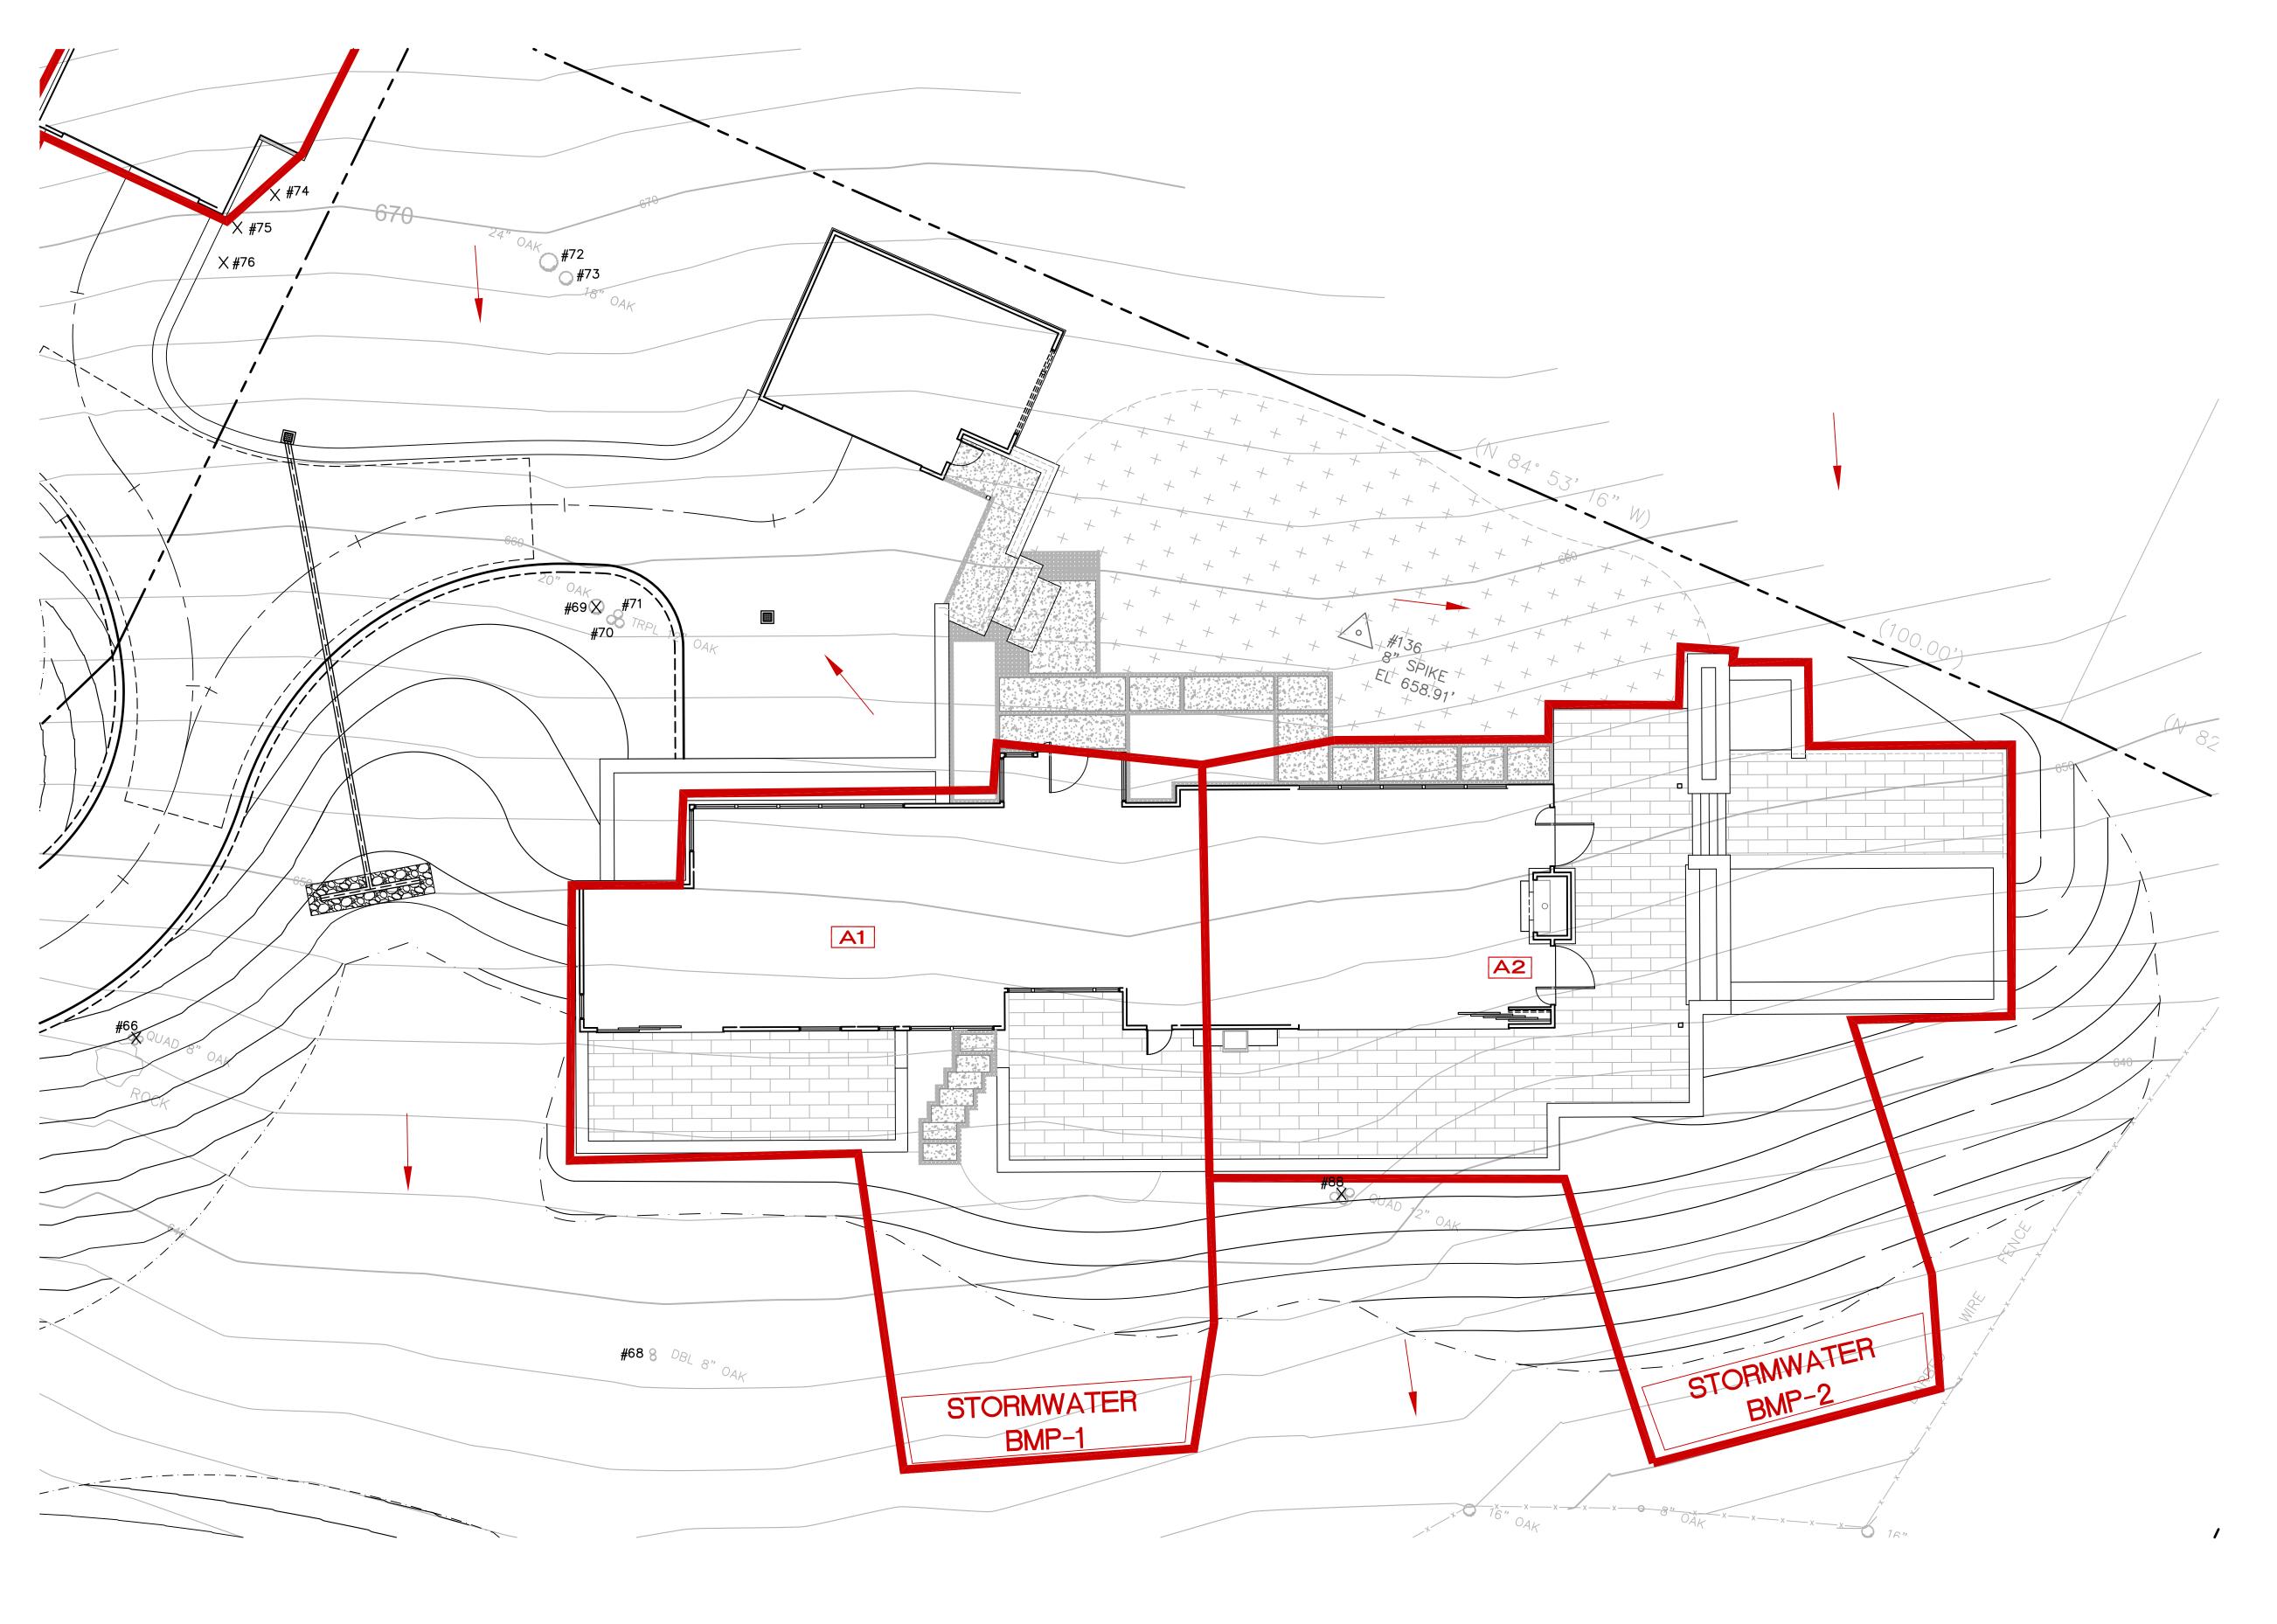




WATERSHED Boundary

POINT OF Concentration

SWL-1 SWALE #1

SD-1 STORM DRAIN #1

OVERLAND FLOW DIRECTION

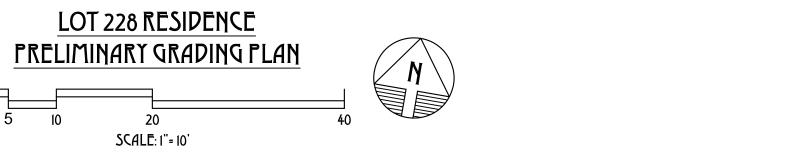





CIVIL ENGINEERING
LAND DEVELOPMENT
SEPTIC SYSTEM DESIGN
PROJECT MANAGEMENT SURVEYING **BUILDING DESIGN** 

HYDROLOGY MAP LOT 228 RESIDENCE

BRAZIL STREET, SONOMA, CA APN: 018-051-007

POST-CONTRUCTION

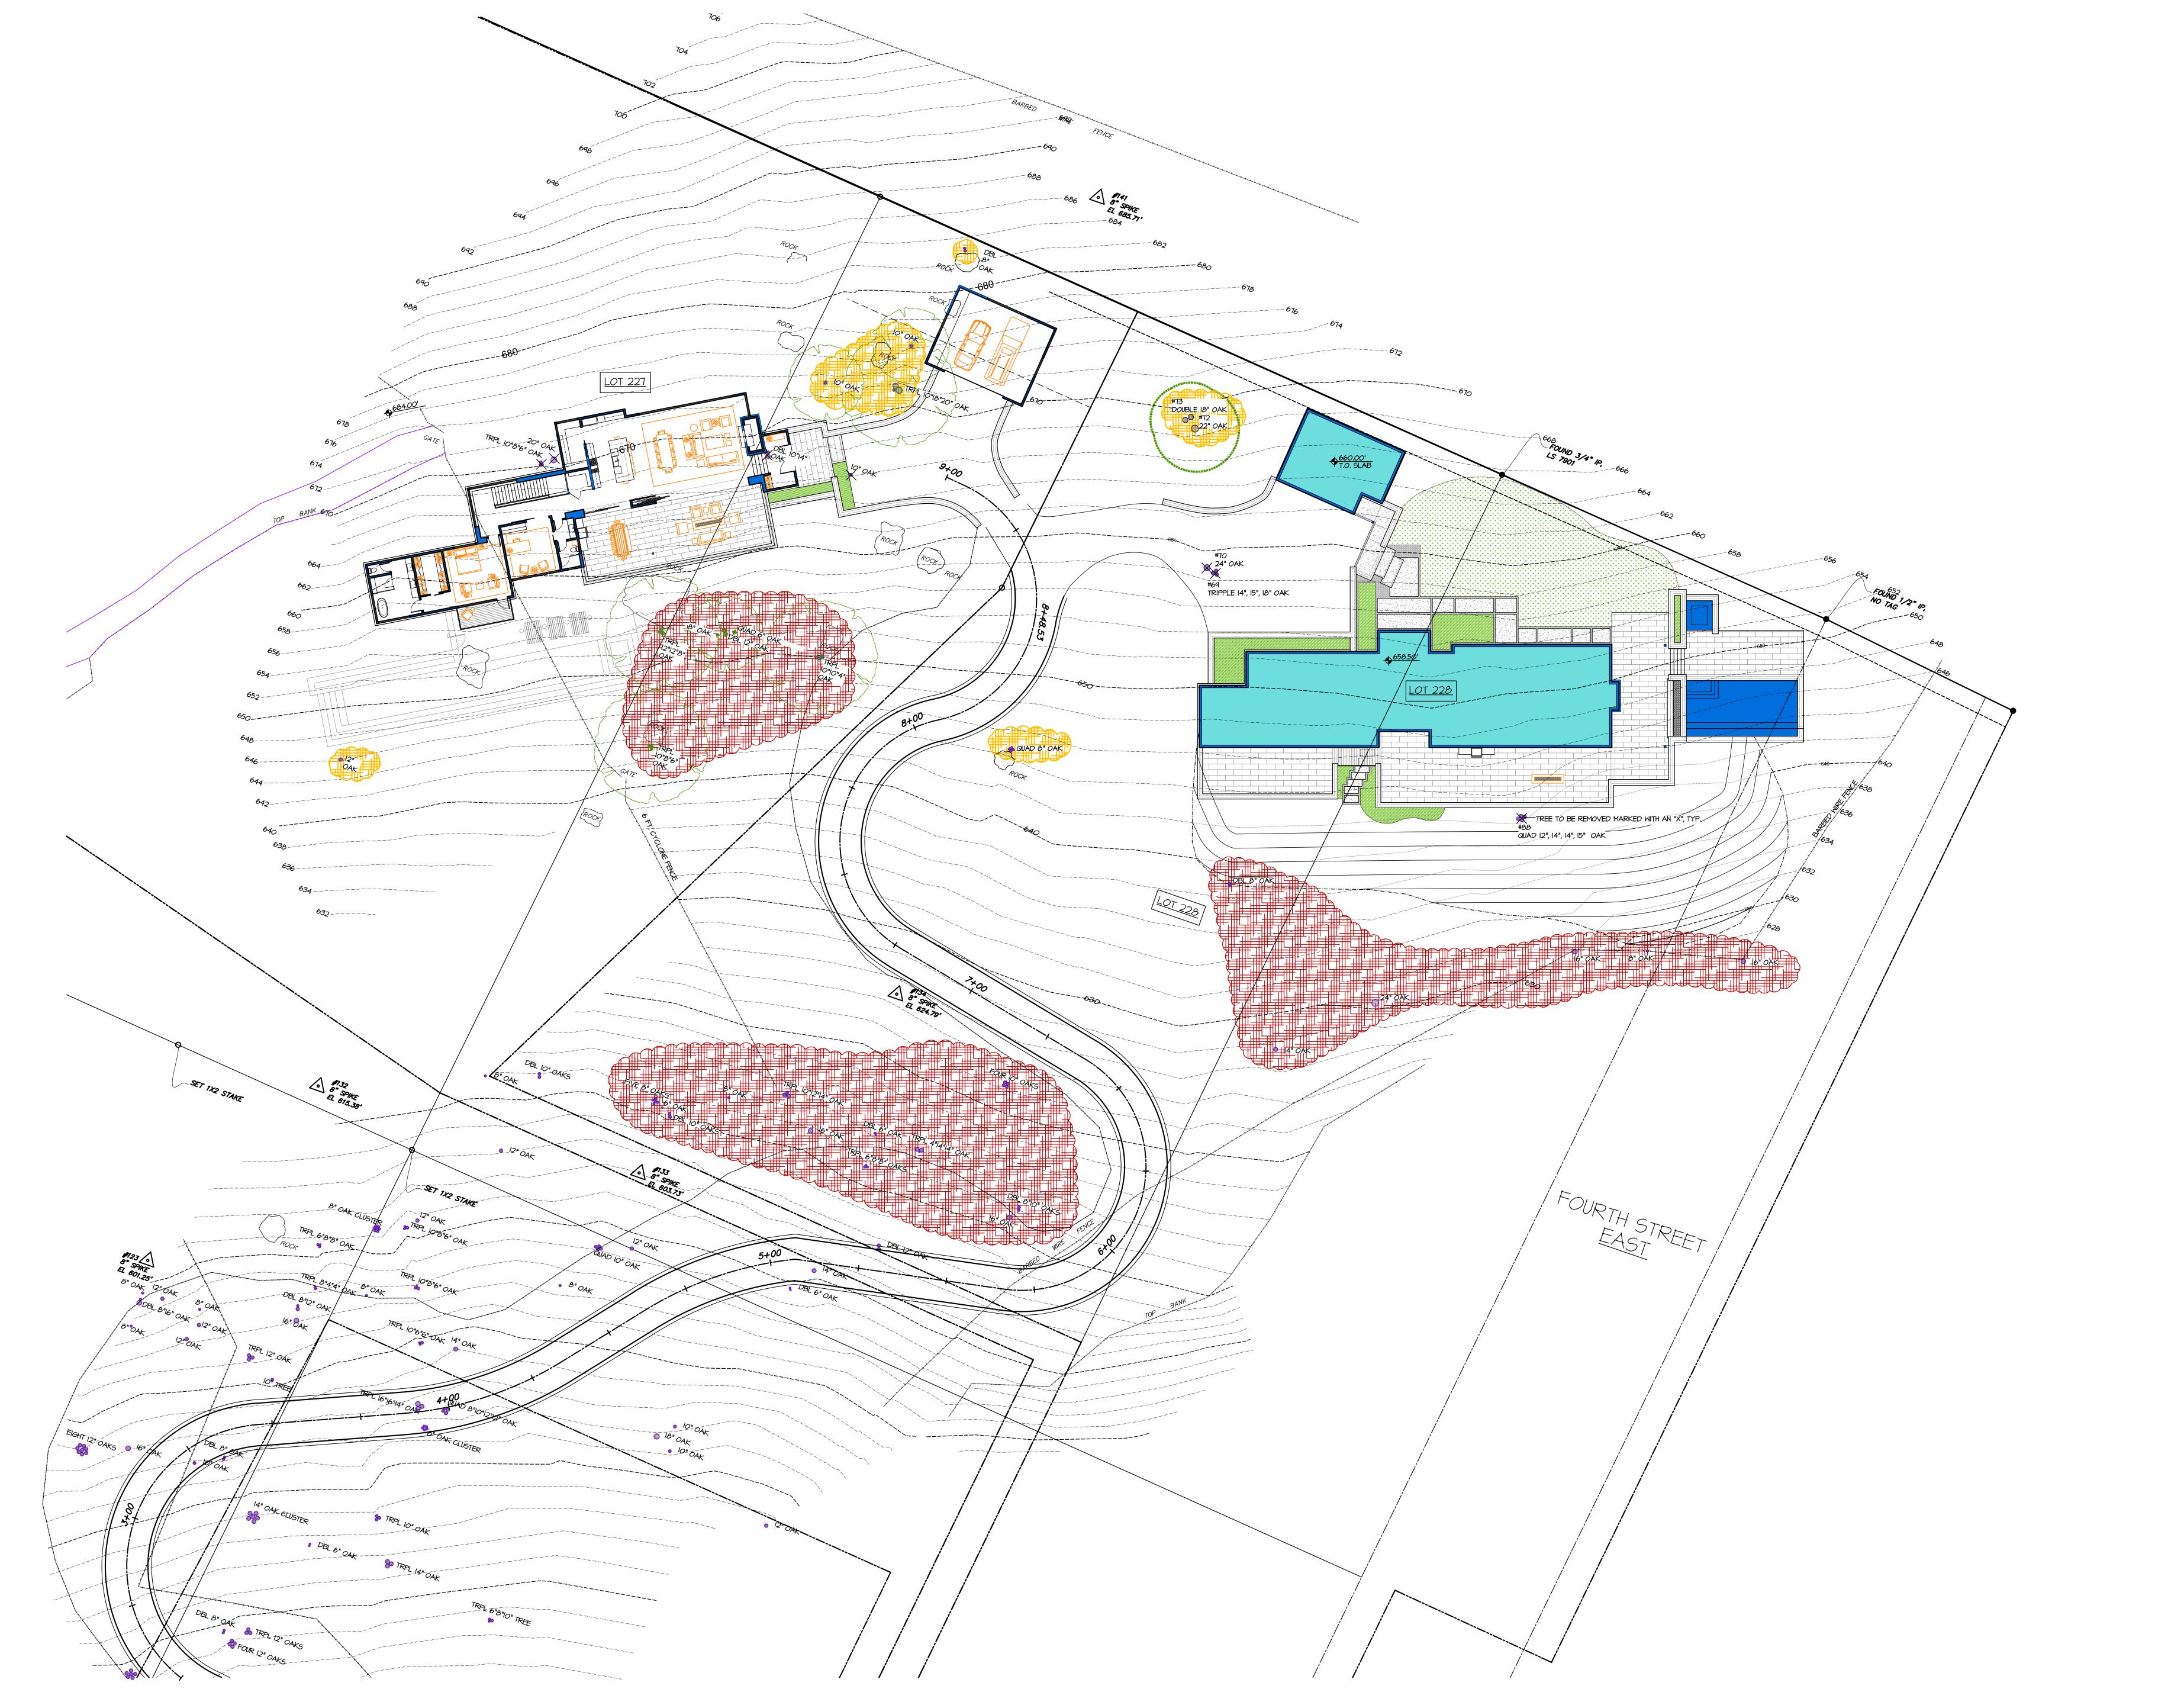

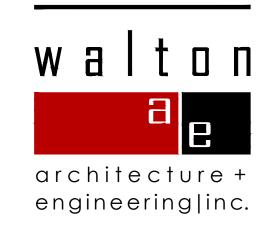

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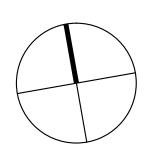
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Job Number 684

Issue Date
22 March 2017

Subject
Tree Identification

True North



Drawing Title

Site Plan

Scale: 1/16" = 1'-0"

Drawing Number

a 1 1

