



4TH STREET EAST | SONOMA

view towards outdoor dining + firepit



4TH STREET EAST | SONOMA

view towards main terrace




4TH STREET EAST | SONOMA

view towards main terrace




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view towards main terrace + firepit terrace



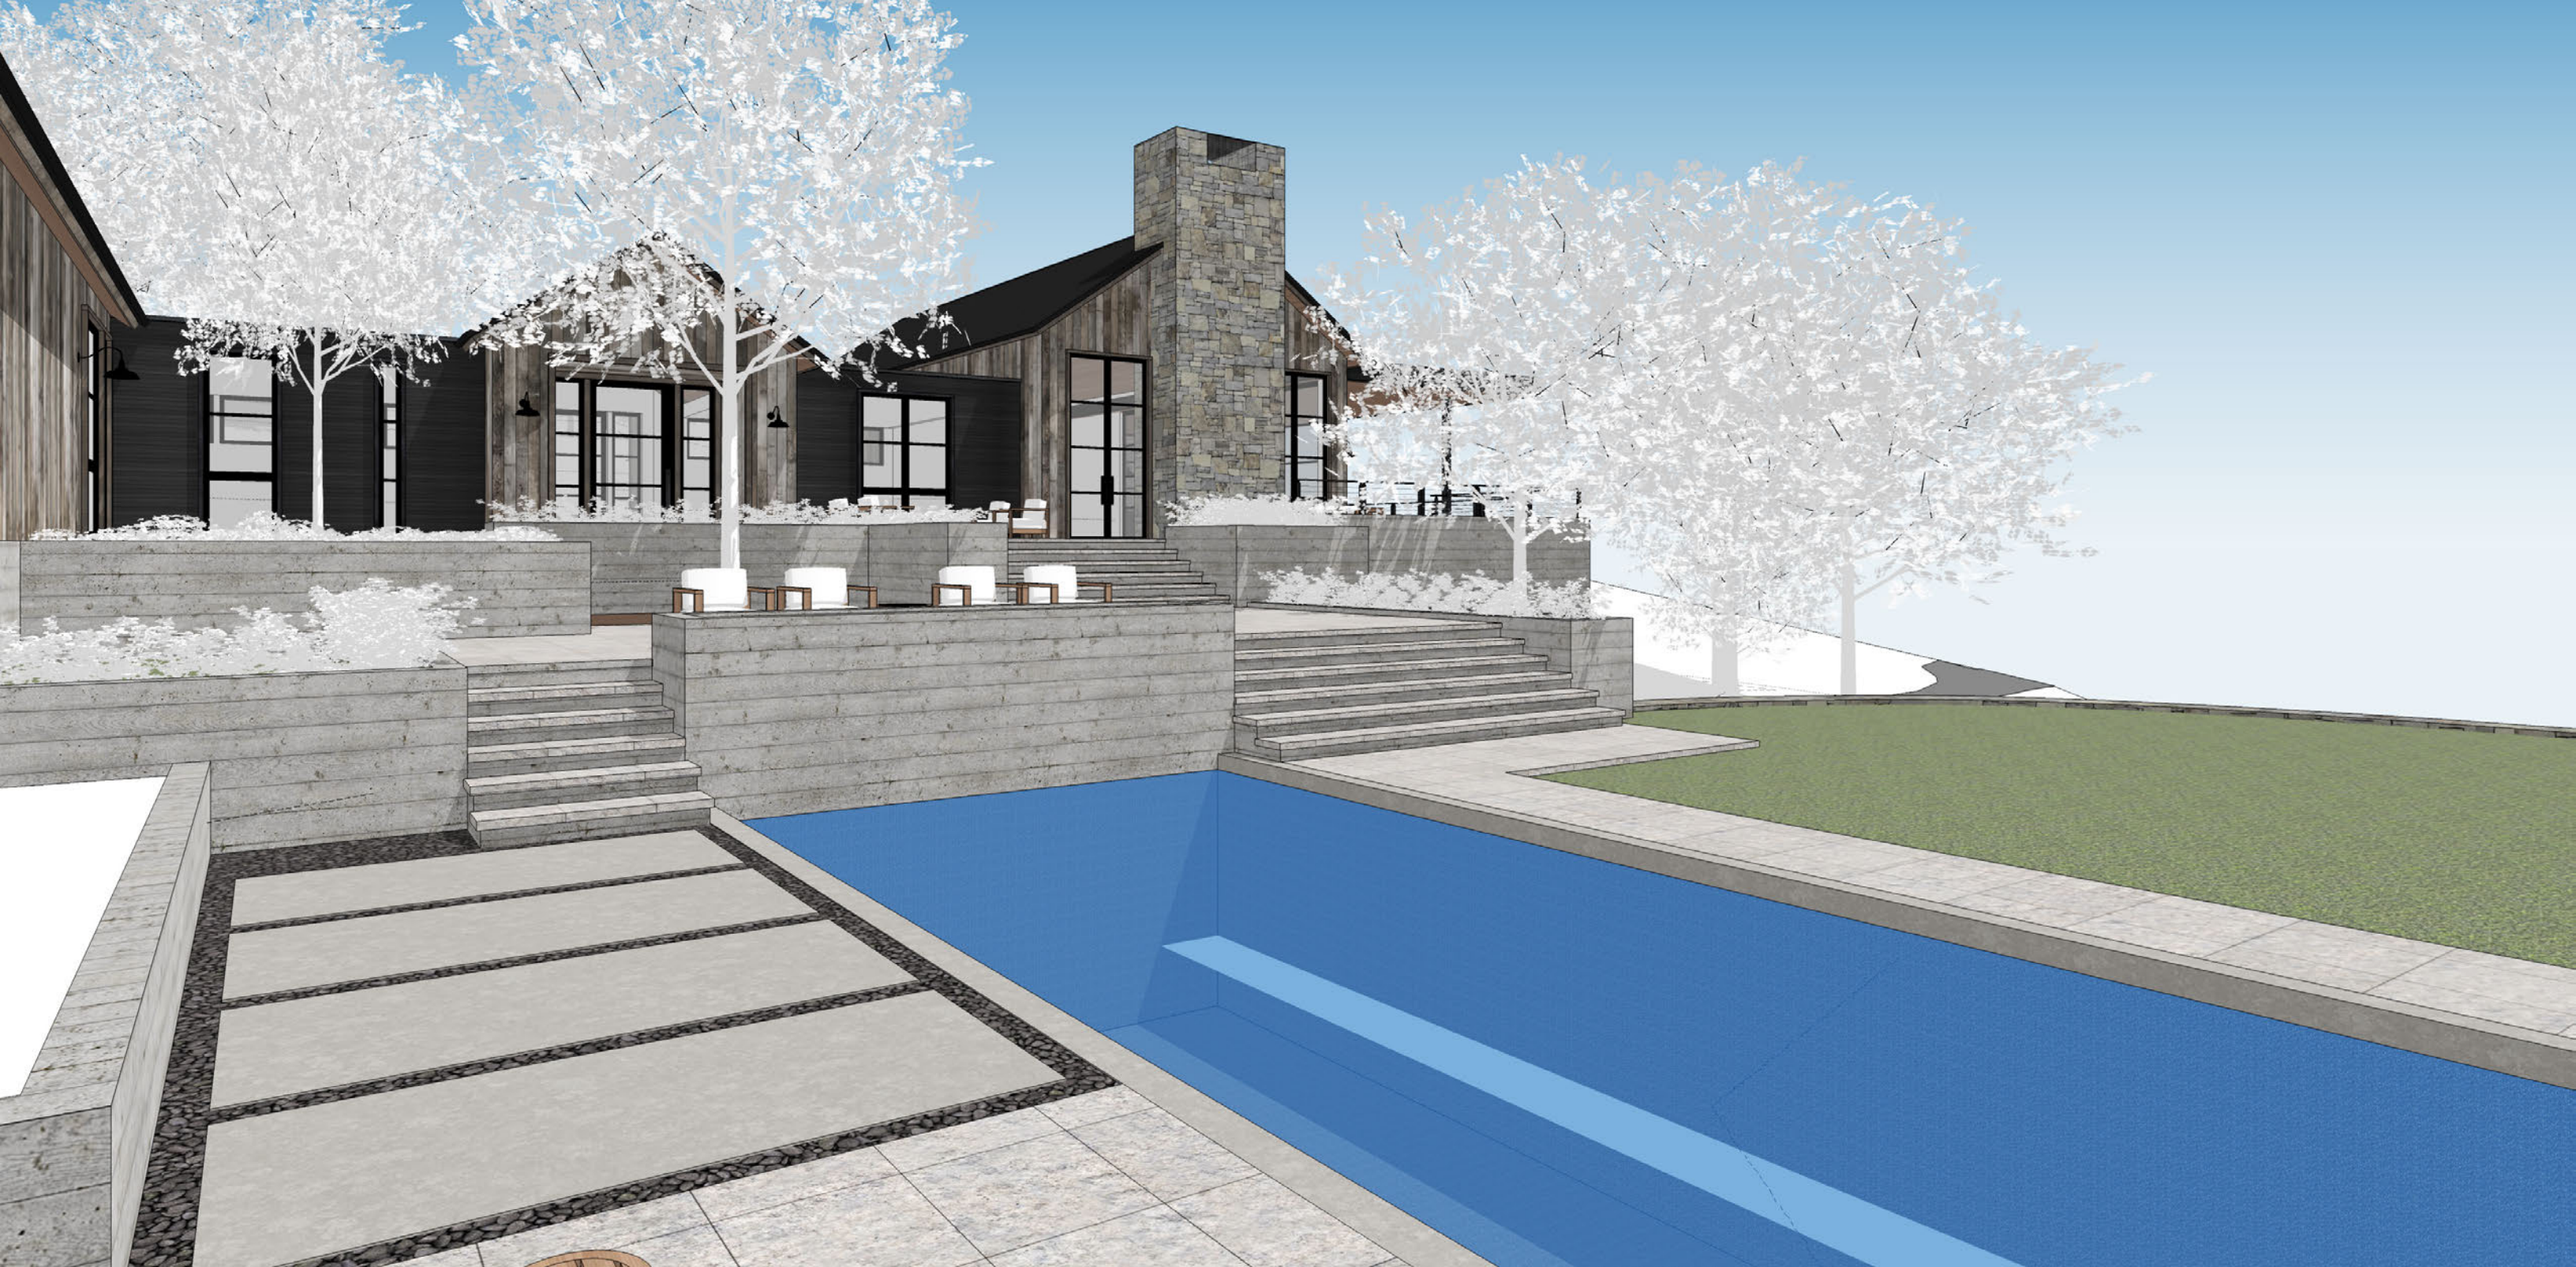




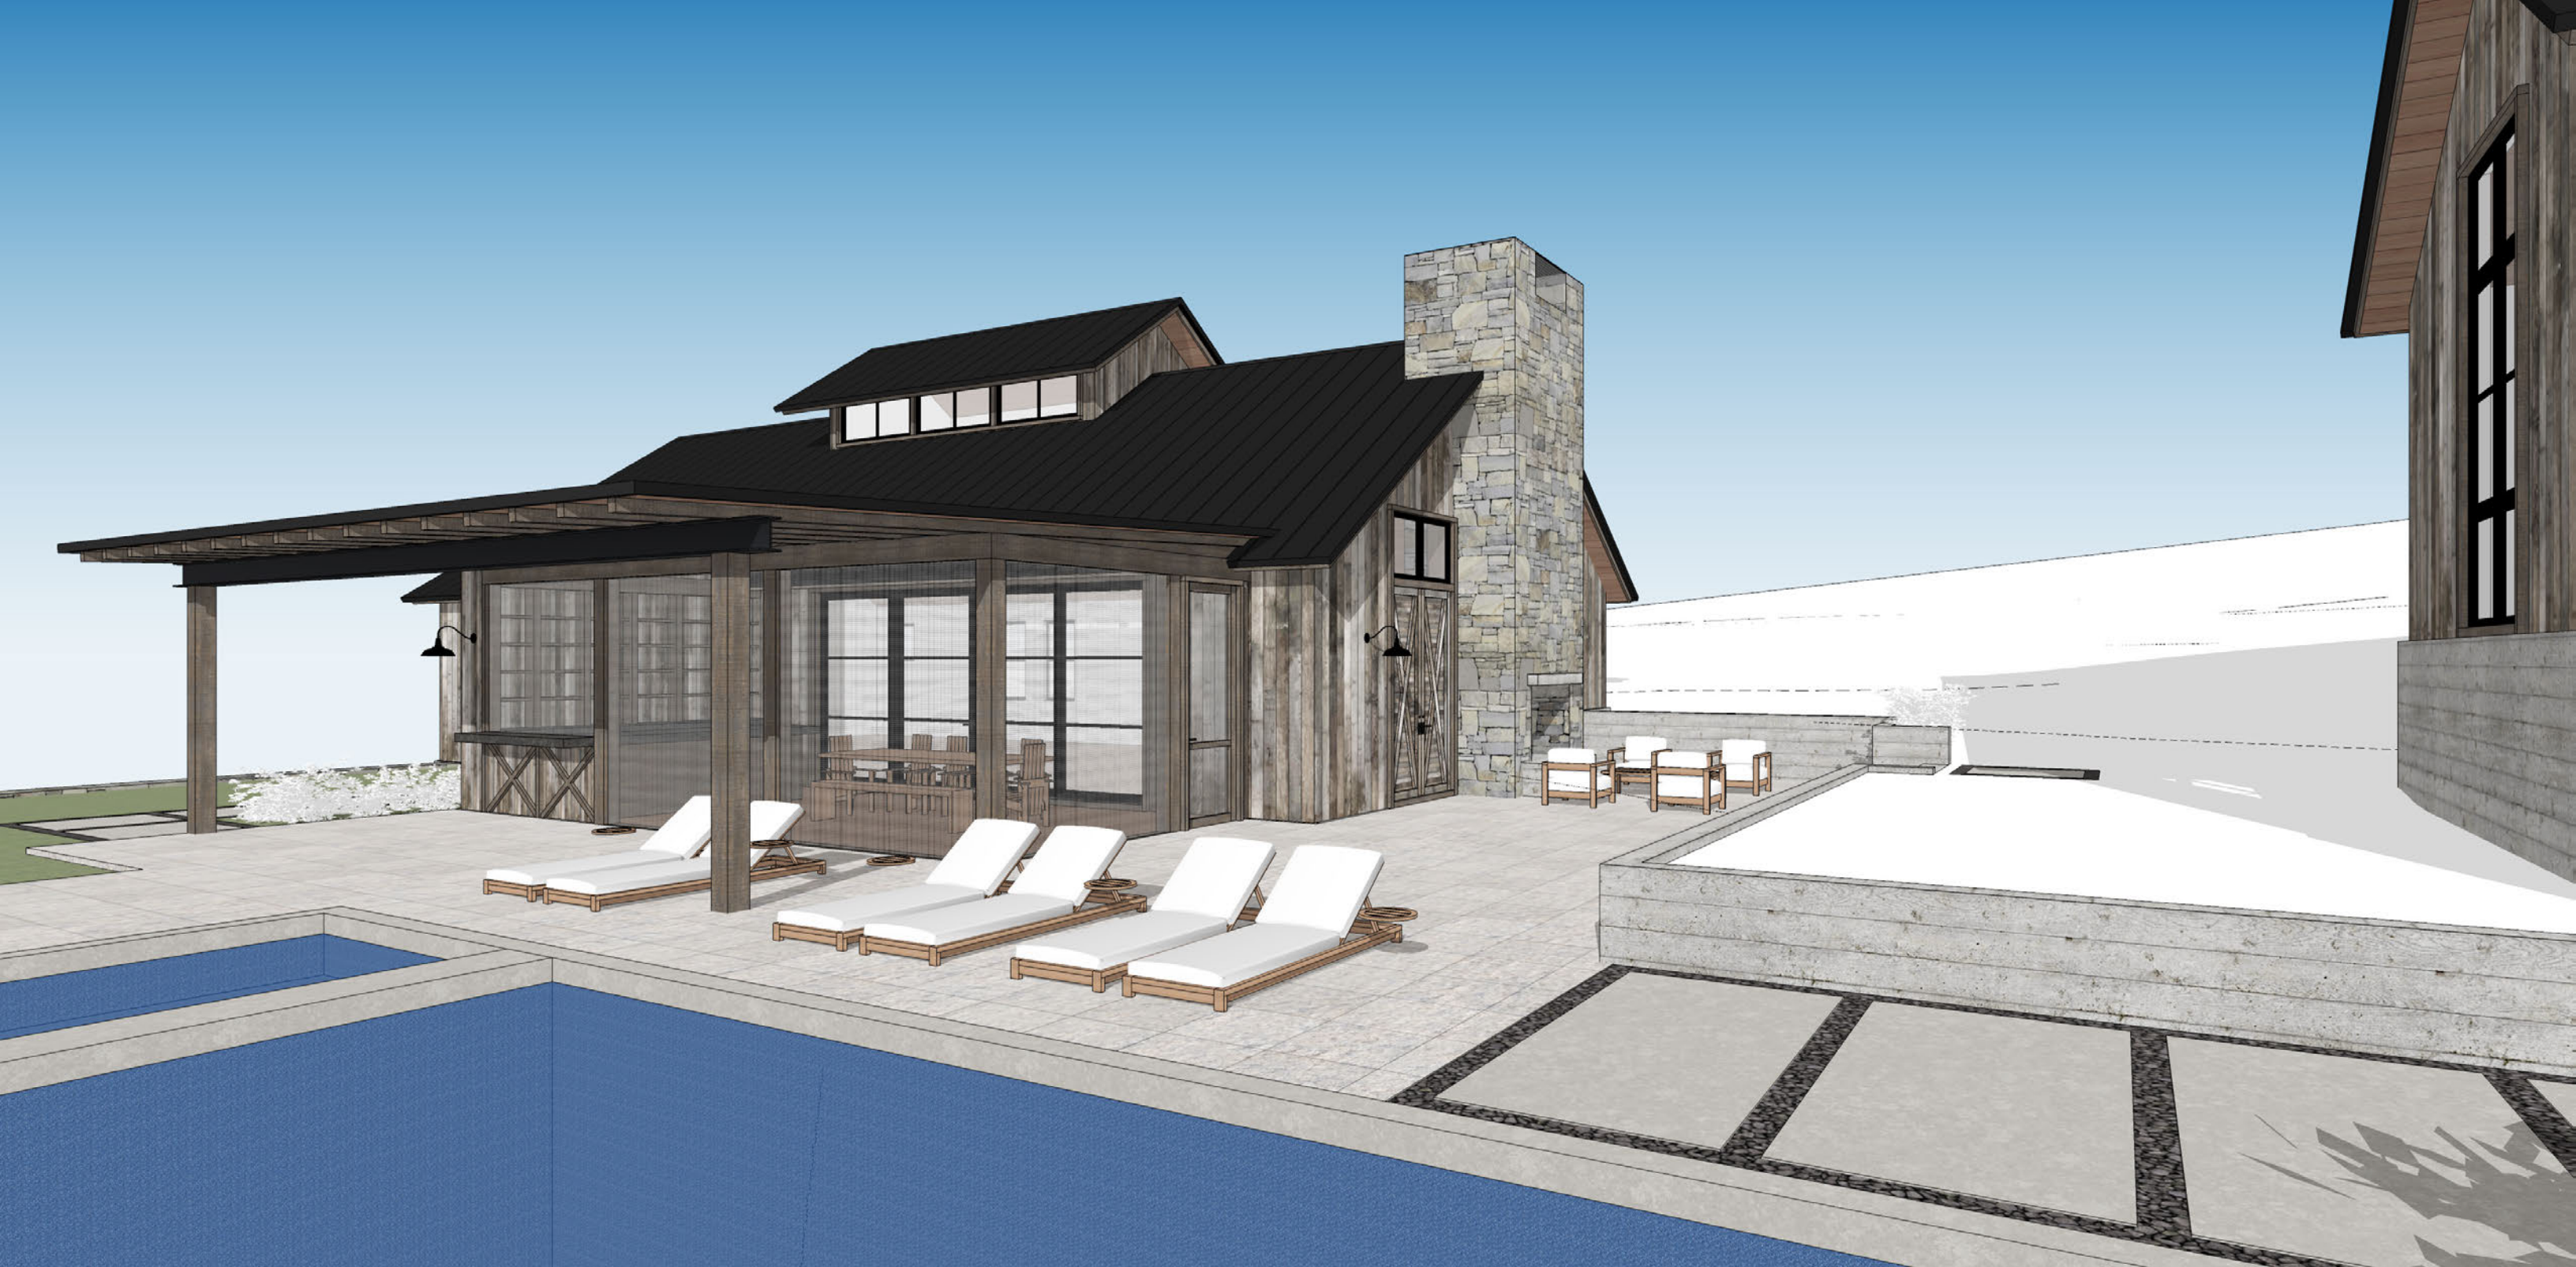

4TH STREET EAST | SONOMA

view towards barn + screened porch

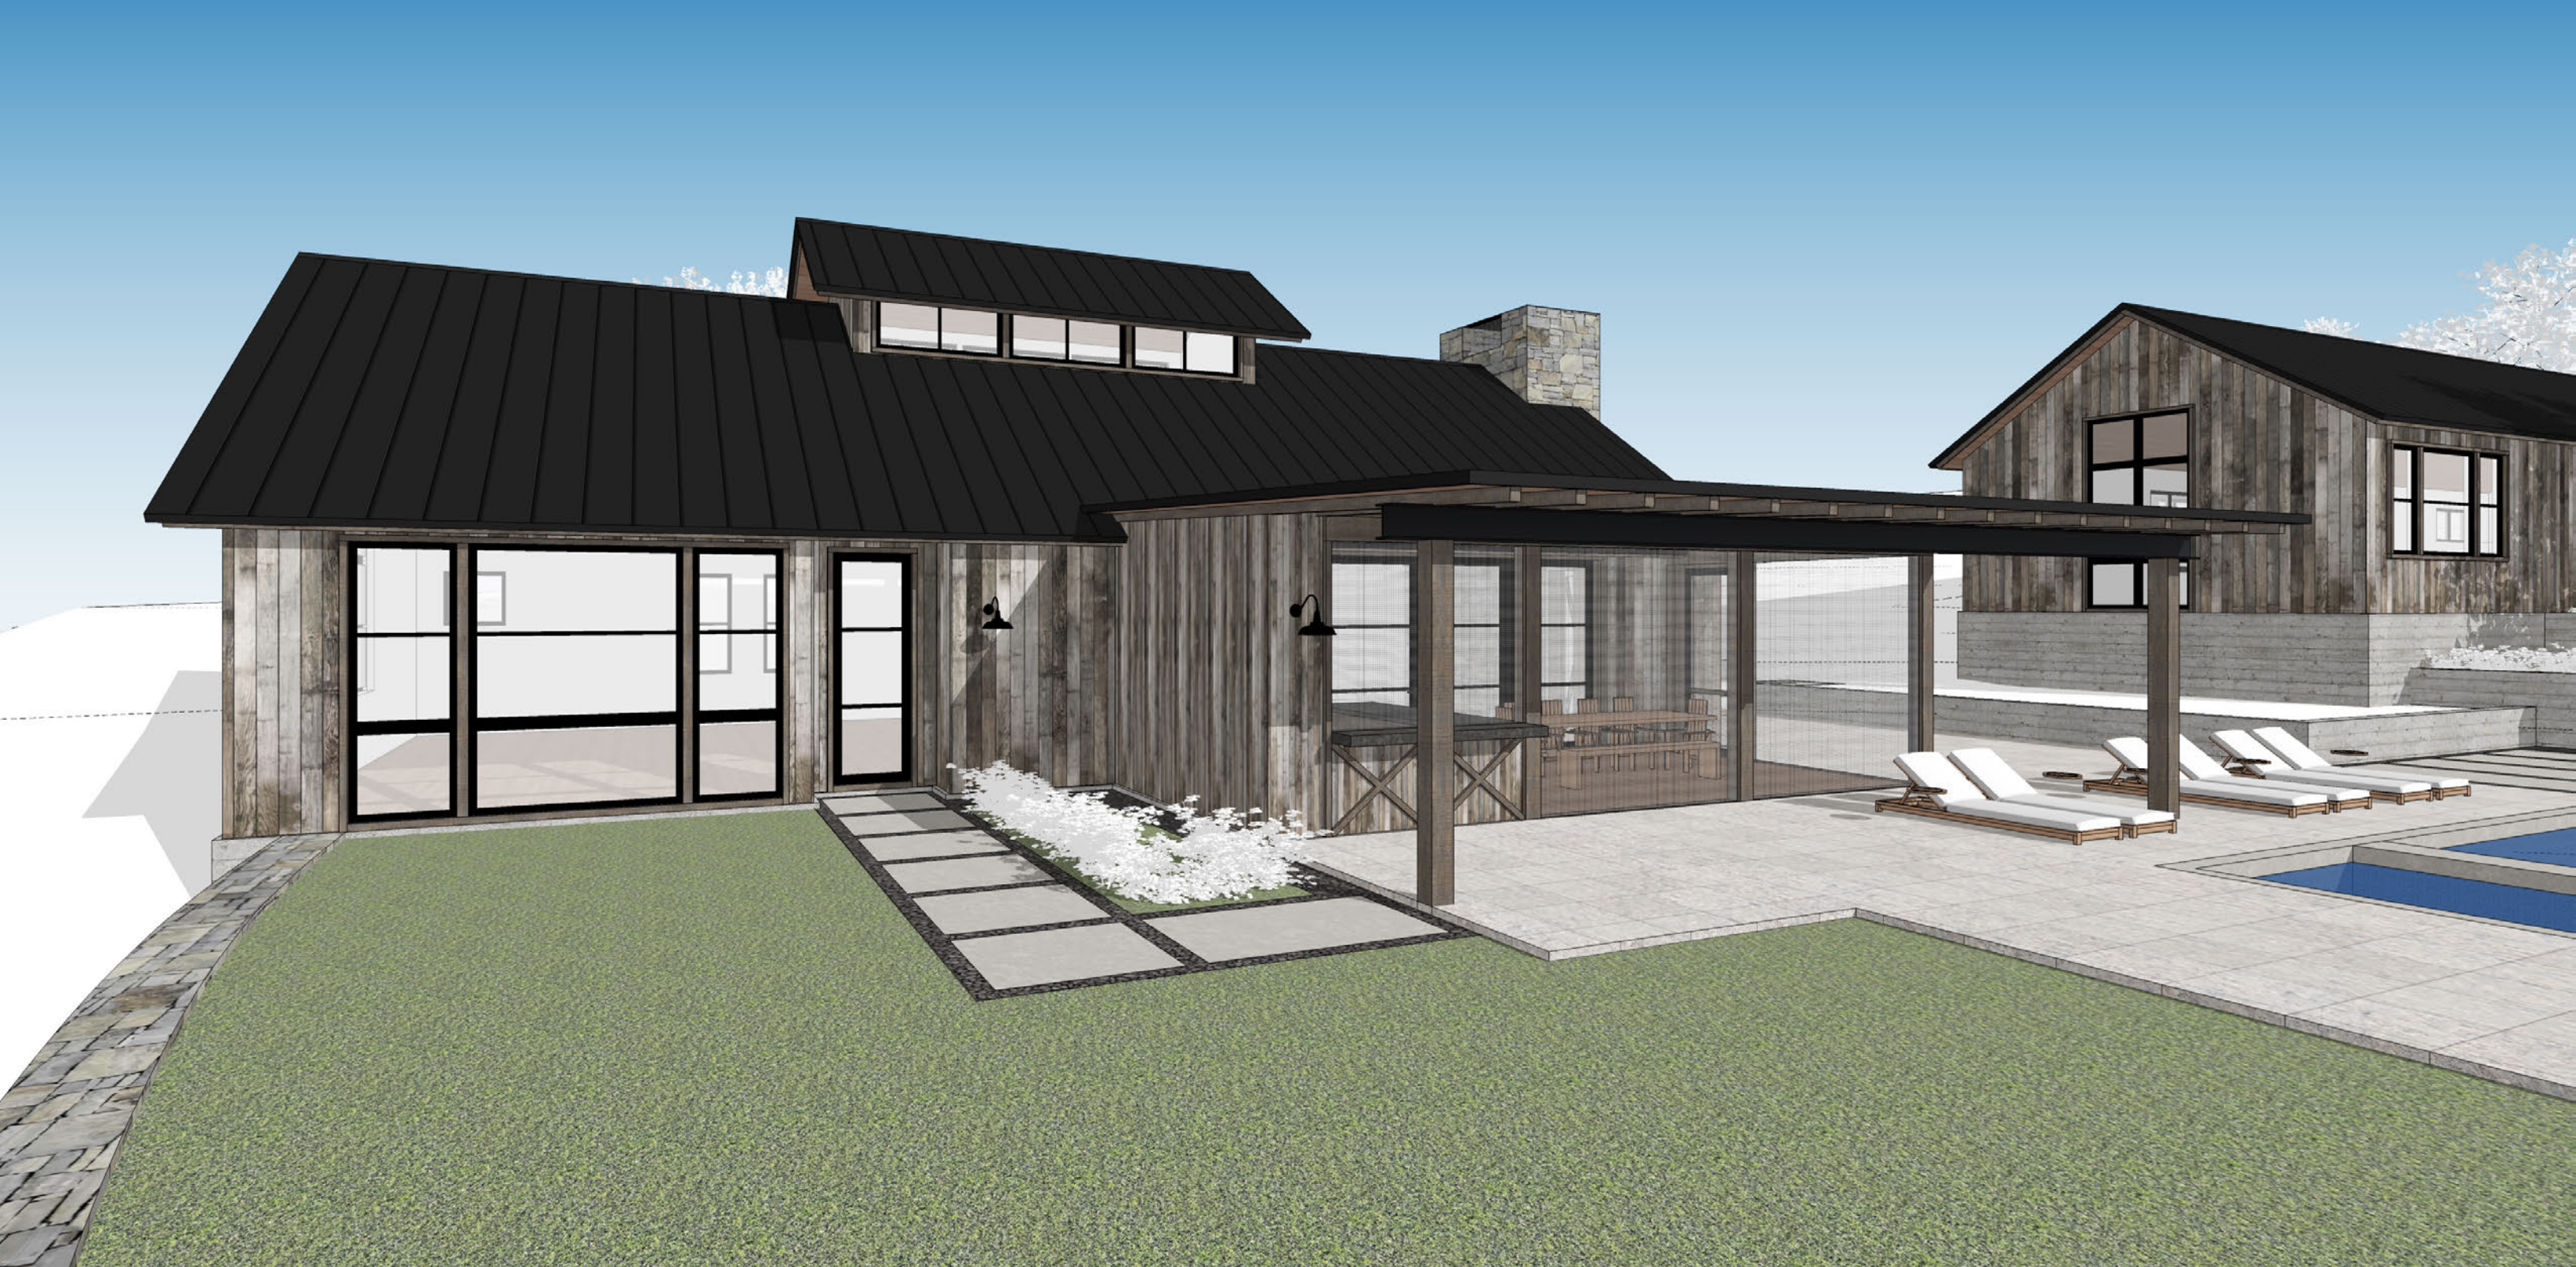

4TH STREET EAST | SONOMA

view towards barn + screened porch

SQUARE FOOTAGE ANALYSIS

HOUSE	
CONDITIONED SQUARE FOOTAGE	+ 5,233 SF
MAIN LEVEL	
UNCONDITIONED SQUARE FOOTAGE:	
DETACHED GARAGE	+ 404 SF
ACCESSORY STRUCTURE	
CONDITIONED SQUARE FOOTAGE	
MAIN LEVEL	+ 5,233 SF

GENERAL NOTES

- STAIRWAYS SERVING AN OCCUPANT LOAD LESS THAN 50 SHALL HAVE A WIDTH OF NOT LESS THAN 36 INCHES. CRC SECTION R301.1. STAIRWAYS SHALL HAVE A MINIMUM HEADROOM CLEARANCE OF 80 INCHES MEASURED VERTICALLY FROM A LINE CONNECTING THE EDGE OF THE NOSINGS. SUCH HEADROOM SHALL BE CONTINUOUS ABOVE THE STAIRWAY TO THE POINT WHERE THE LINE INTERSECTS THE LANDING BELOW ONE TREAD DEPTH BEYOND THE BOTTOM RISER. THE MINIMUM CLEARANCE SHALL BE MAINTAINED THE FULL WIDTH OF THE STAIRWAY. CRC SECTION R301.2. WITHIN DWELLING UNITS, THE MAXIMUM RISER HEIGHT SHALL BE 7.31/4" THE MINIMUM TREAD DEPTH SHALL BE 10 INCHES. CRC SECTIONS R301.1.41 AND R301.1.4.2.
- GUARDRAILS AND HANDRAILS SHALL BE STRUCTURED TO WITHSTAND A 200# LATERAL LOAD.
 - HANDRAILS: HANDRAIL HEIGHT, MEASURED ABOVE STAIR TREAD NOSINGS, SHALL BE UNIFORM NOT LESS THAN 34 INCHES AND NOT MORE THAN 38 INCHES. CRC SECTION R301.1.1. HANDRAILS WITH A CIRCULAR CROSS-SECTION SHALL HAVE AN OUTSIDE DIAMETER OF AT LEAST 1.25 INCHES AND NOT GREATER THAN 2 INCHES. IF THE HANDRAIL IS NOT CIRCULAR, IT SHALL HAVE A PERIMETER DIMENSION OF AT LEAST 4 INCHES AND NOT GREATER THAN 6.25 INCHES. EDGES SHALL HAVE A MINIMUM RADIUS OF 0.01 INCH. CRC SECTION R301.1.1.3. HANDRAILS WITHIN DWELLING UNITS ARE PERMITTED TO BE INTERRUPTED BY A NEVEL POST AT A STAIR LANDING. CRC SECTION R301.1.2. CLEAR SPACE BETWEEN A HANDRAIL AND A WALL OR OTHER SURFACE SHALL BE A MINIMUM OF 15 INCHES. CRC SECTION 1022. PROJECTIONS INTO THE REQUIRED WIDTH OF STAIRWAYS AT EACH HANDRAIL SHALL NOT EXCEED 4.5 INCHES AT OR BELOW THE HANDRAIL HEIGHT. CRC SECTION 1022. PROVIDE CONTINUOUS HANDRAIL FOR STAIRWAY WITH 4 OR MORE RISERS AS PER R301.
- GUARDRAILS: GUARDS SHALL FORM A PROTECTIVE BARRIER NOT LESS THAN 42 INCHES HIGH MEASURED VERTICALLY ABOVE THE LEADING EDGE OF THE TREAD OR ADJACENT WALKING SURFACE. WITHIN DWELLING UNITS, GUARDS TOP RAIL, ALSO KNOWN AS A HANDRAIL SHALL HAVE A HEIGHT NOT LESS THAN 34 INCHES AND NOT MORE THAN 38 INCHES MEASURED VERTICALLY FROM THE LEADING EDGE OF THE STAIR TREAD NOSING. CRC SECTION R302.2. OPEN GUARDS SHALL HAVE INTERMEDIATE RAILS SUCH THAT A 4 INCH DIAMETER SPHERE CANNOT PASS THROUGH ANY OPENING. THE TRIANGULAR OPENINGS FORMED BY THE RISER, TREAD, AND BOTTOM RAIL AT THE OPEN SIDE OF A STAIRWAY SHALL BE OF A MAXIMUM SIZE SUCH THAT A SPHERE OF 6 INCHES IN DIAMETER CANNOT PASS THROUGH THE OPENING. CRC SECTION R302.3.
- THE WALLS AND SOFFITS OF THE ENCLOSED SPACE UNDER STAIRS SHALL BE PROTECTED ON THE ENCLOSED SIDE WITH 1/2" GYPSUM HALLOWARD. CRC SECTION R302.1.
- MINIMUM OCCUPANCY SEPARATION BETWEEN GARAGE AND RESIDENCE SHALL BE AS FOLLOWS: 1/2" GYPSUM HALLOWARD SHALL BE INSTALLED ON THE GARAGE SIDE OF THE WALL SEPARATING THE GARAGE FROM THE RESIDENCE AND 5/8" TYPE-X GYPSUM HALLOWARD AT THE UNDERSIDE OF THE HABITABLE ROOM ABOVE THE GARAGE. CRC SECTION AND TABLE R302.6.
- MINIMUM OPENING PROTECTION FOR DOOR BETWEEN GARAGE AND RESIDENCE SHALL BE THE INSTALLATION OF A SELF-CLOSING TIGHT-FITTING SOLID WOOD DOOR 1 3/4" IN THICKNESS OR A SELF-CLOSING TIGHT-FITTING DOOR HAVING A FIRE PROTECTION RATING OF NOT LESS THAN 20 MINUTES. CRC SECTION R302.5.1.
- WATER HEATERS, FURNACES OR OTHER APPLIANCES INSTALLED IN A GARAGE WHICH HAVE A GLOBE SPARK OR IGNITION SOURCE NEED TO BE MOUNTED 18" ABOVE THE FLOOR AND PROTECTED FROM AUTO IMPACT. CRC 507.8 AND 508.300. ALL WATER HEATERS SHALL BE STRAPPED TO THE BUILDING WITH AT LEAST TWO STRAPS TO PREVENT SEISMIC MOVEMENT. ONE STRAP WITHIN THE TOP THIRD AND THE OTHER WITHIN THE BOTTOM THIRD OF THE WATER HEATER. THE LOWER STRAP SHALL NOT BE WITHIN 4" OF THE CONTROL. CRC 507.2
- PROVIDE ROOF TERMINATION FOR GAS APPLIANCE. APPLIANCE SHALL BE INSTALLED PER MANUFACTURER'S SPECIFICATIONS. SEE FILE MANUFACTURER'S SPECIFICATIONS FOR FLEE CLEARANCES. VERIFICATION OR APPROVAL OF VENT HEIGHT AND LOCATION WITH AN INSPECTOR PRIOR TO INSTALLATION IS SUGGESTED. ALL GAS FIREPLACES SHALL BE DIRECT-VENT SEALED-COMBUSTION TYPE PER CALGREEN 2013 GREEN BUILDING CODE SECTION 4.505.
 - PROVIDE 60" DV GAS FIREPLACE @ LIVING ROOM + BARN
 - FIREPIT SHALL BE LIMBED FOR GAS, PROVIDE (4) EQ. SPACED ADJUSTABLE GAS JETS SET IN BLACK VOLCANIC STONES.
- THE FOLLOWING SHALL BE CONSIDERED HAZARDOUS LOCATIONS REQUIRING SAFETY GLAZING: GLAZING IN DOORS AND ENCLOSURES FOR HOT TUBS, whirlpools, SAUNAS, STEAM ROOMS, BATHTUBS, AND SHOWERS, GLAZING IN ANY PORTION OF A BUILDING WALL ENCLOSED THESE COMPARTMENTS WHERE THE BOTTOM EXPOSED EDGE OF THE GLAZING IS LESS THAN 60" ABOVE A STANDING SURFACE AND DRAIN INLET GLAZING WITH A 24" ARC OF EITHER VERTICAL EDGE OF A DOOR IN CLOSED POSITION, GLAZING ADJACENT TO STAIRWAYS AND LANDINGS WITHIN 36 INCHES HORIZONTALLY OF A WALKING SURFACE WHEN THE EXPOSED SURFACE OF THE GLASS IS LESS THAN 60 INCHES ABOVE THE PLANE OF THE ADJACENT WALKING SURFACE, GLAZING ADJACENT TO STAIRWAYS WITHIN 60 INCHES HORIZONTALLY OF THE BOTTOM TREAD OF A STAIRWAY IN ANY DIRECTION WHEN THE EXPOSED SURFACE OF THE GLASS IS LESS THAN 60 INCHES ABOVE THE NOSE OF THE TREAD. CRC SECTION R308.4.
 - CONTRACTOR SHALL VERIFY SAFETY GLAZING AT ALL LOCATIONS PER 2013 CBC.
- EXTERIOR WINDOWS, WINDOW WALLS, GLAZED DOORS, AND GLAZED OPENINGS WITHIN EXTERIOR DOORS SHALL BE INSULATING-GLASS UNITS WITH A MINIMUM OF ONE TEMPERED PANE. CRC SECTION R321.9.2.
- SLEEPING ROOMS BELOW THE FOURTH STORY ABOVE GRADE PLANE SHALL HAVE AT LEAST ONE EXTERIOR EMERGENCY ESCAPE AND RESCUE OPENING. CRC SECTION R301.1. EMERGENCY ESCAPE AND RESCUE OPENINGS SHALL HAVE A MINIMUM NET CLEAR OPENING OF 5.7 SQUARE FEET. THE MINIMUM NET CLEAR OPENING HEIGHT DIMENSION SHALL BE 24 INCHES. THE MINIMUM NET CLEAR OPENING WIDTH DIMENSION SHALL BE 20 INCHES. CRC SECTIONS R301.1 THROUGH R301.1.3. EMERGENCY ESCAPE AND RESCUE OPENINGS SHALL HAVE THE BOTTOM OF THE CLEAR OPENING NOT GREATER THAN 44 INCHES MEASURED FROM THE FLOOR. CRC SECTION R301.1.
- DECKING, SURFACES, STAIR TREADS, RISERS, AND LANDINGS OF DECKS, PORCHES, AND BALCONIES WHERE ANY PORTION OF SUCH SURFACE IS WITHIN 10 FEET OF THE PRIMARY STRUCTURE SHALL BE CONSTRUCTED WITH HEAVY TIMBER, EXTERIOR, FIRE-RETARDANT-TREATED WOOD OR APPROVED NON-COMBUSTIBLE MATERIALS. CRC SECTION R321.1.3.
- NOTE NOT USED
- NOTE NOT USED
- OPENINGS IN THE BUILDING ENVELOPE SEPARATING CONDITIONED SPACE FROM UNCONDITIONED SPACE NEEDED TO ACCOMMODATE GAS, PLUMBING, ELECTRICAL LINES, AND OTHER NECESSARY PENETRATIONS MUST BE SEALED IN COMPLIANCE WITH THE CALIFORNIA ENERGY CODE AND ALSO THE CALIFORNIA RESIDENTIAL CODE CRC R316 WHERE FOAM PLASTIC INSULATION IS PROPOSED FOR COMPLIANCE. EXCEPTION: ANNULAR SPACES AROUND PIPES, ELECTRIC CABLES, CONDUITS, OR OTHER OPENINGS IN FLATES AT EXTERIOR WALLS SHALL BE PROTECTED AGAINST THE PASSAGE OF RODENTS BY CLOSING SUCH OPENINGS WITH CEMENT MORTAR, CONCRETE MASONRY OR SIMILAR METHOD ACCEPTABLE TO THE ENFORCING AGENCY. CALGREEN 4.406.1.



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149 4th Street East


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149 4th Street East
Sonoma, CA
APN 018-091-018

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Job Number
725
Issue Date
28 July 2017
Subject
PC Submittal


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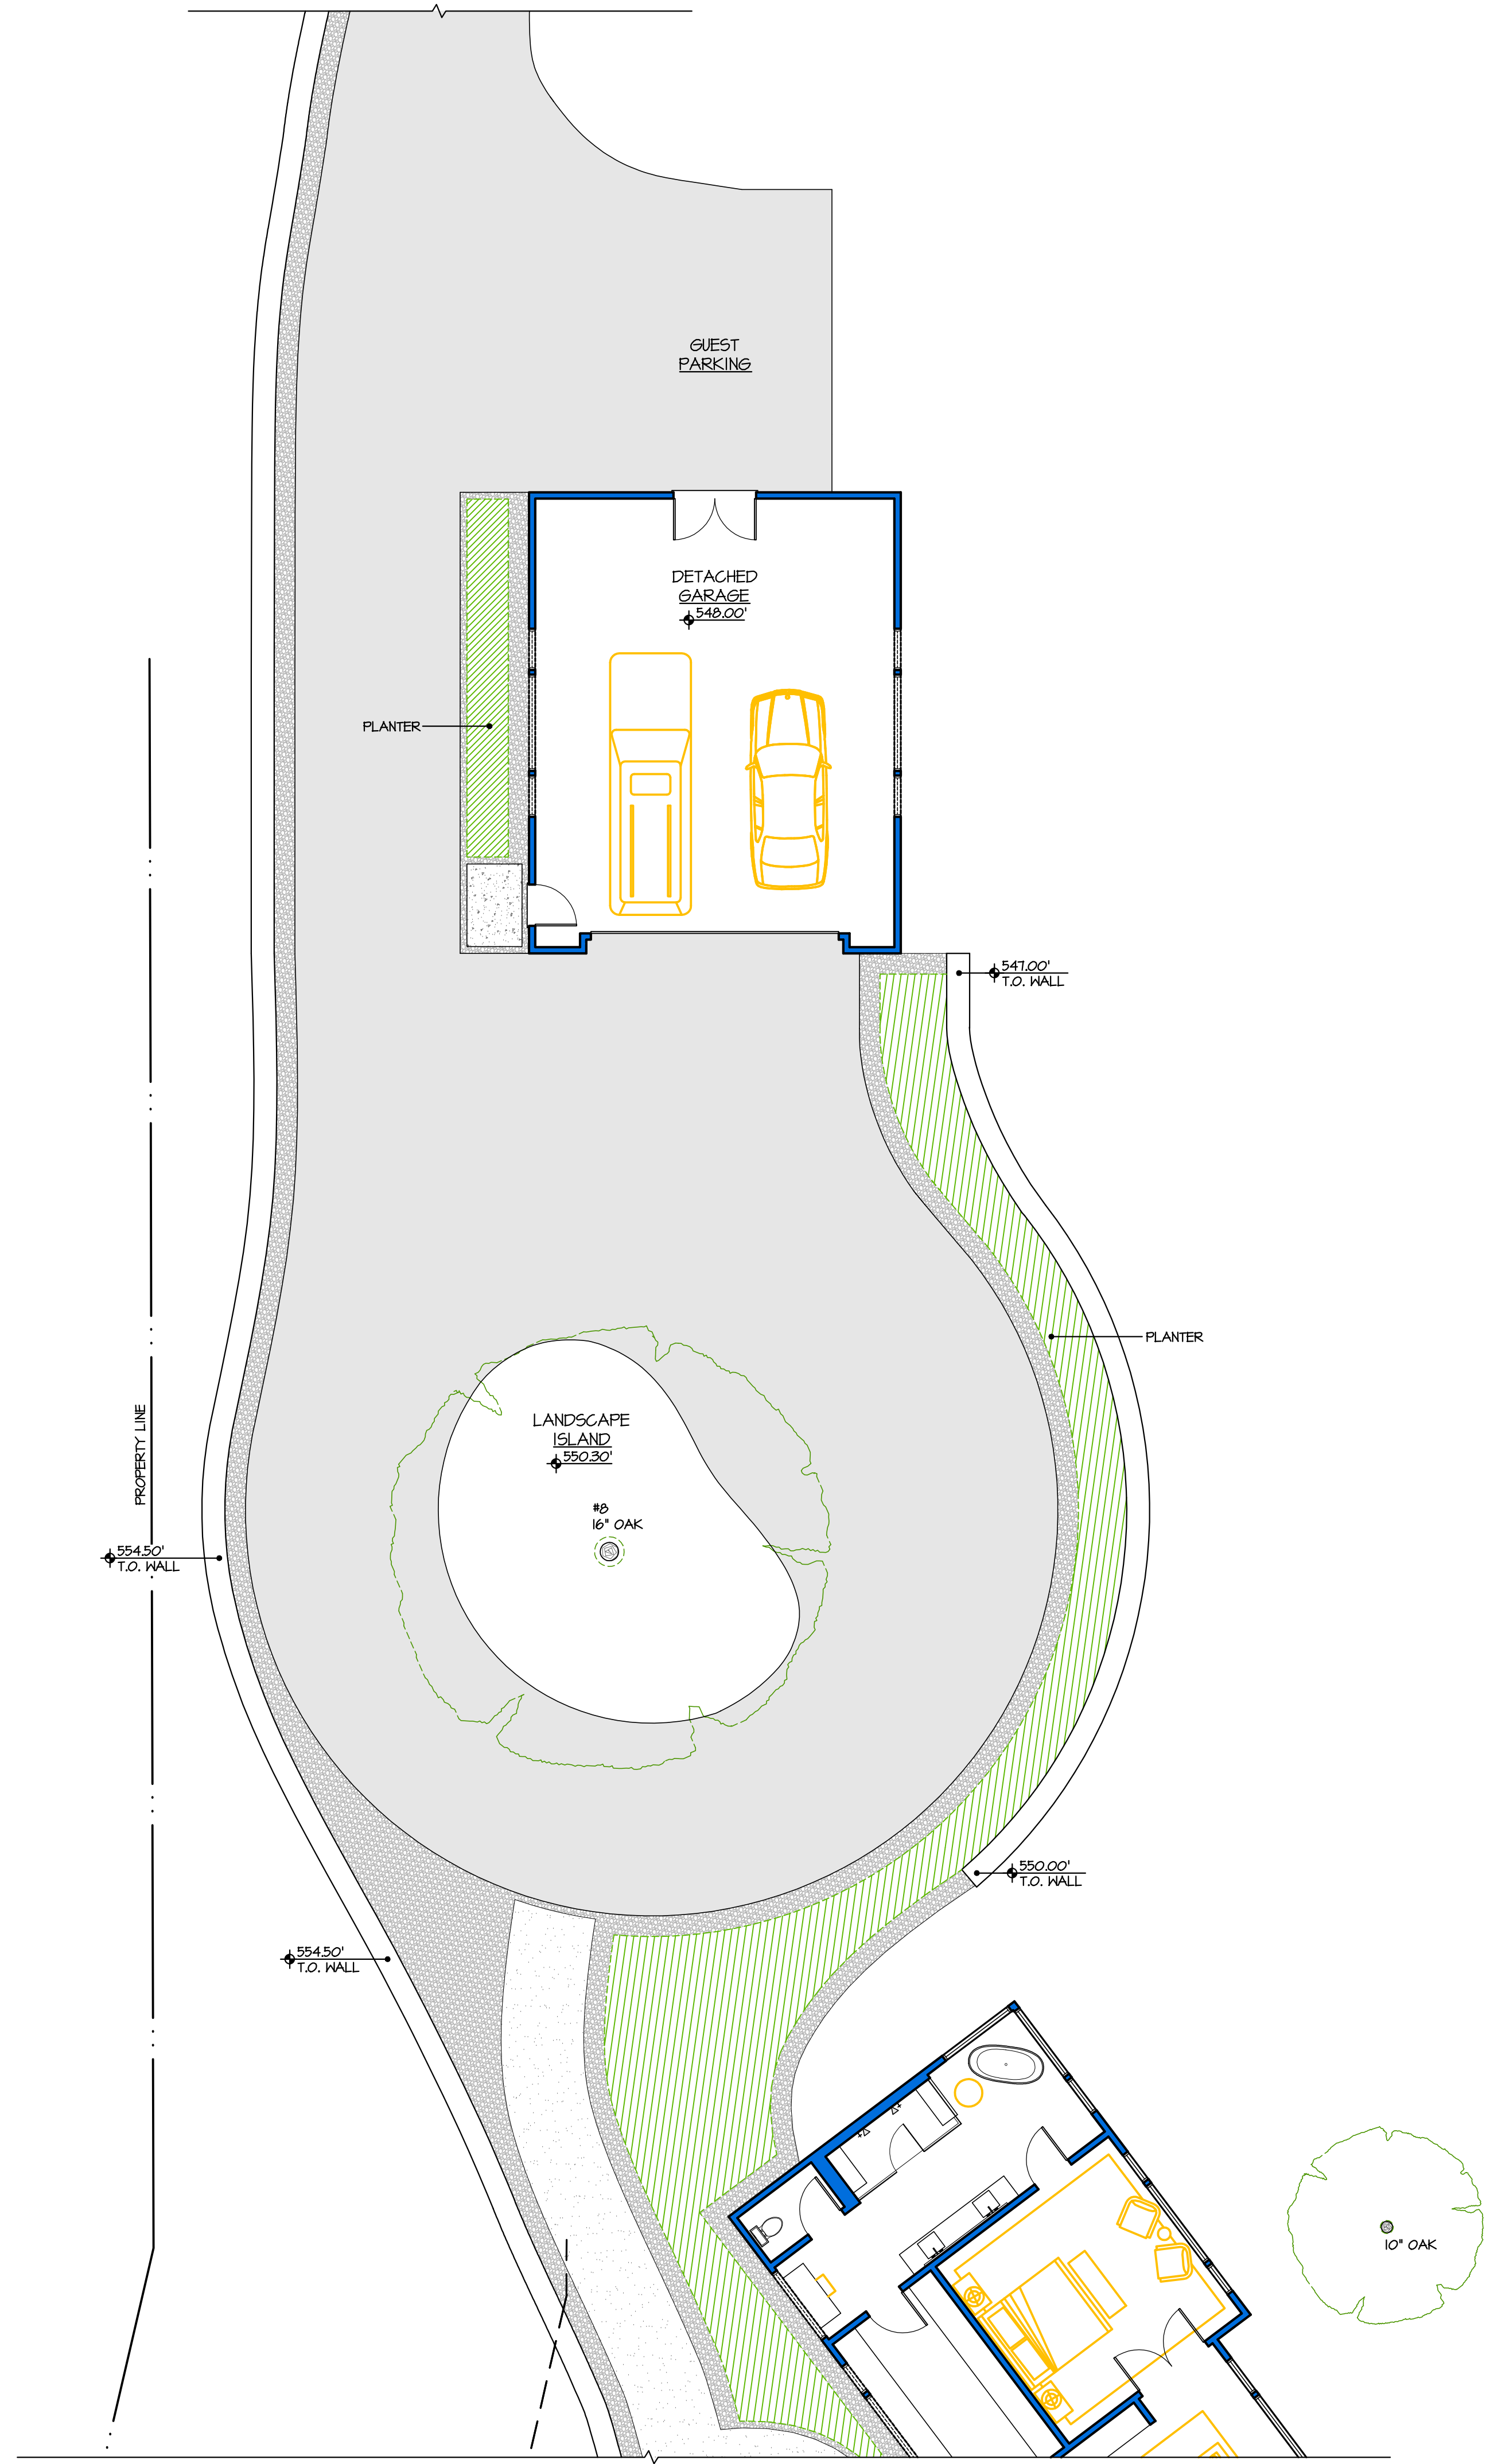
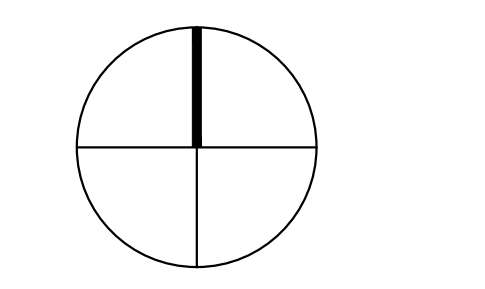
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Main House Floor Plan

Drawing Number


a 2.1

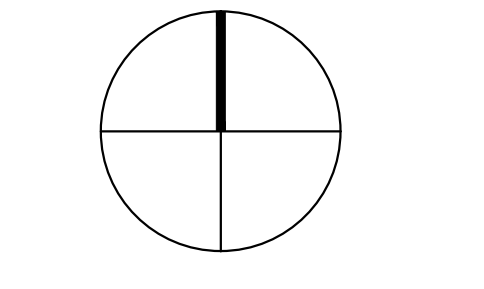

1 MAIN HOUSE FLOOR PLAN

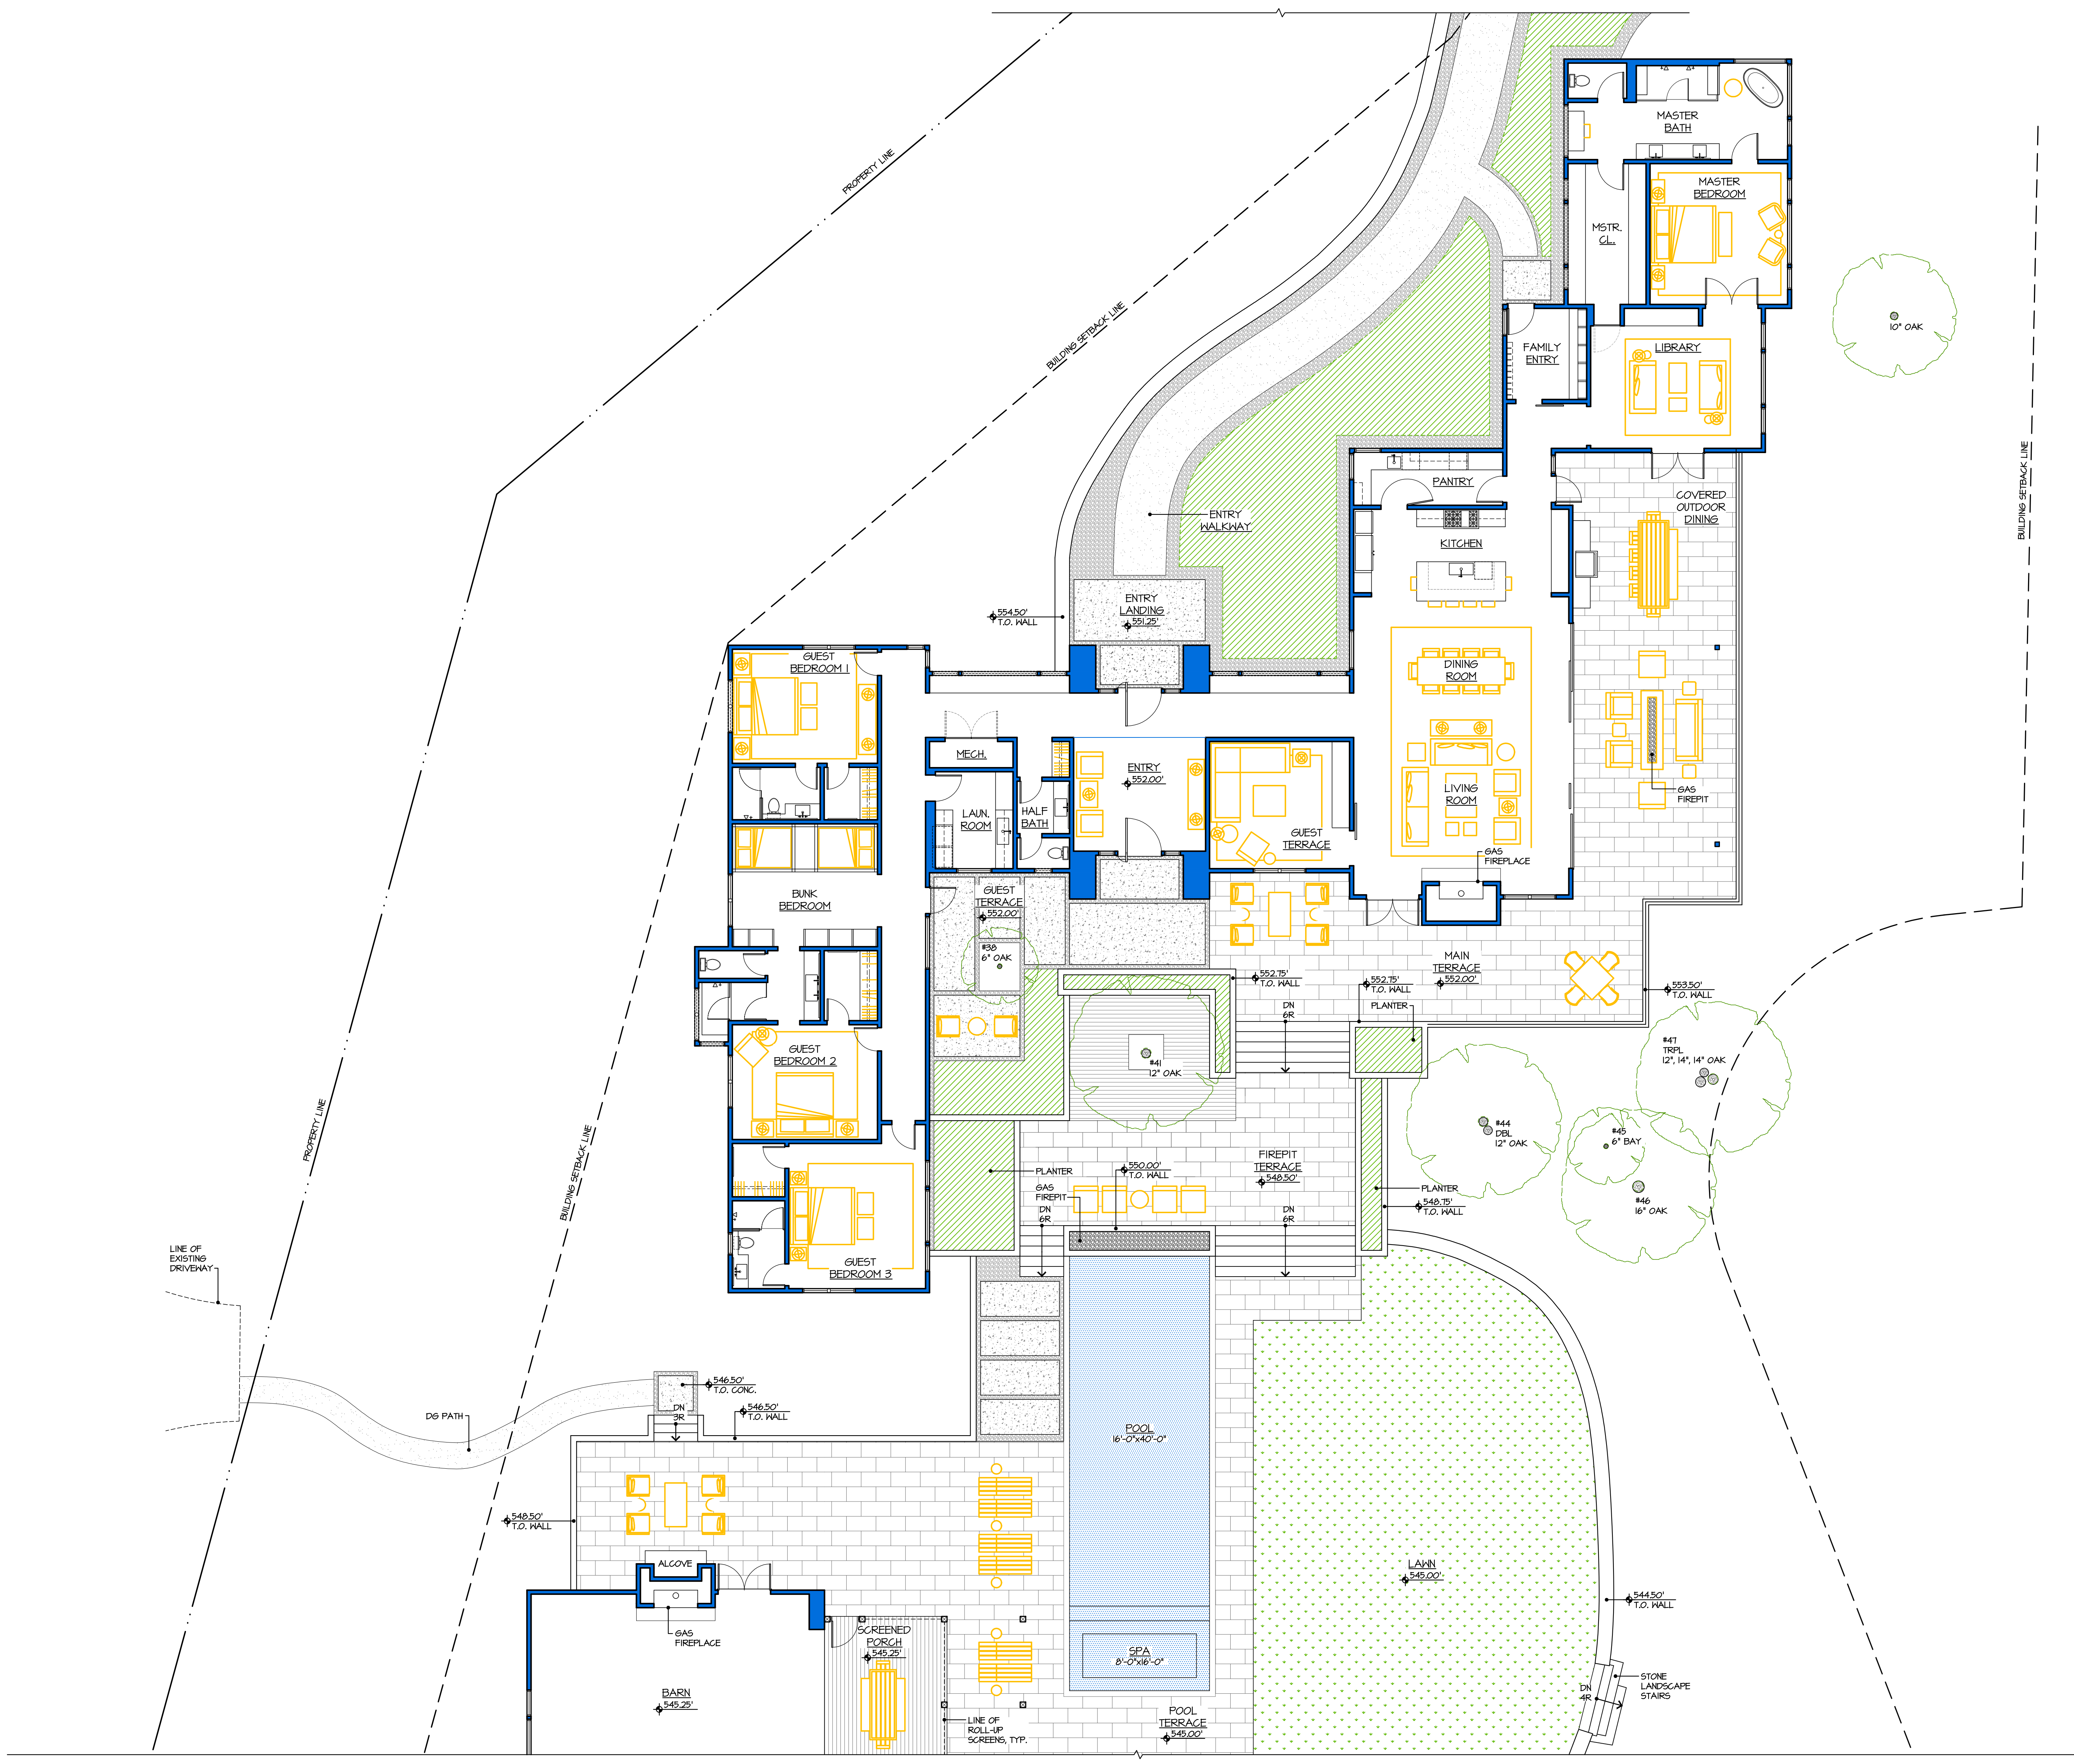

1 DETACHED GARAGE FLOOR PLAN

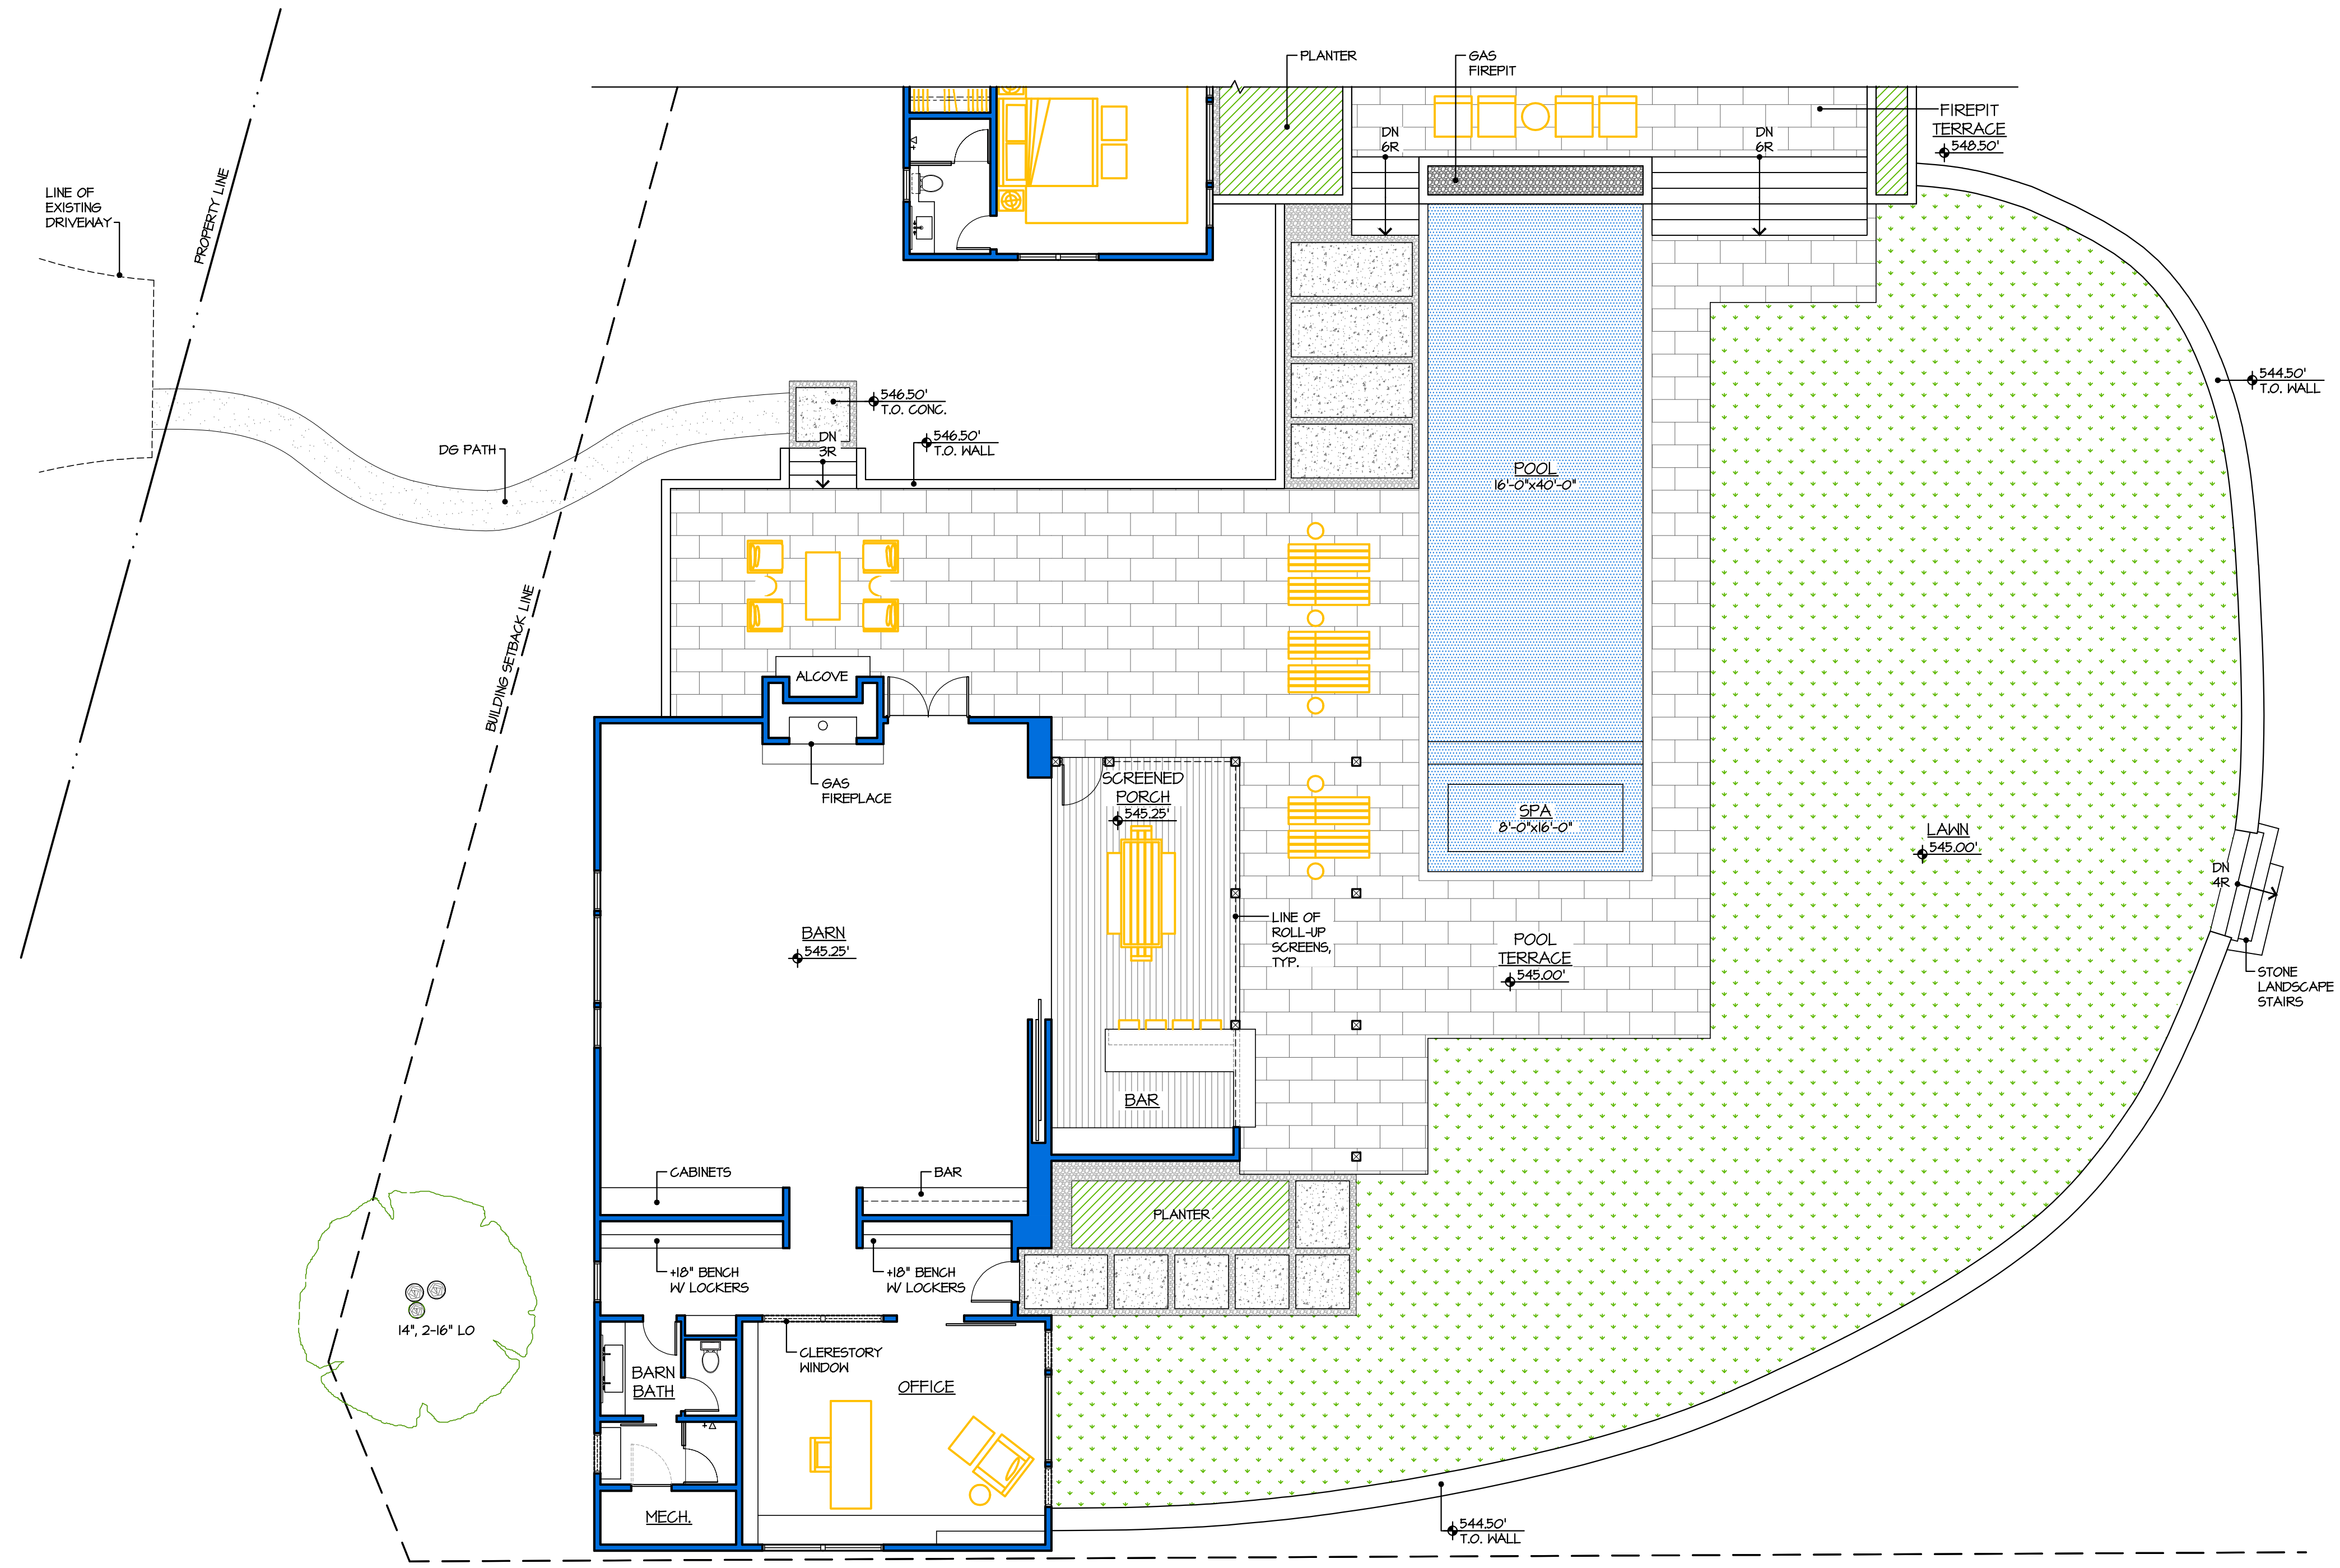

2 BARN FLOOR PLAN

EXTERIOR FINISH LEGEND

SEE SHEET A-3.2

GENERAL NOTES

SEE SHEET A-3.2

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1 SOUTH ELEVATION
MAIN HOUSE

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Drawing Title
Exterior Elevations

Drawing Number

a 3.1



2 NORTH ELEVATION
MAIN HOUSE

EXTERIOR FINISH LEGEND

FLASHINGS, GUTTERS + CHAINS: PAINTED METAL
COLOR: BLACK

DOUBLE LOGS STANDING SEAM PAINTED METAL
COLOR: BLACK

HOOD SIDING: GRAY BARNWOOD, 1x6, T&G
STAIN: NONE

HOOD SIDING ACCENT: WESTERN RED CEDAR, 5/8", STK, RESAWN, 1x3, T&G
STAIN: CHARCOAL

TRIM: 2x AND 3x GRAY BARNWOOD
STAIN: NONE

WINDOWS: ALUMINUM CLAD WOOD BY SIERRA PACIFIC
COLOR: BLACK

STRUCTURAL MEMBERS: DOUGLAS FIR #1
STAIN: MATCH GRAY BARNWOOD

SOFFITS: DOUGLAS FIR, GRADE D, RESAWN, 1x4, T&G
STAIN: GINGER

STONE VENEER: LEDGESTONE

GENERAL NOTES

- 1) ALL EXTERIOR MATERIALS TO COMPLY WITH R301 OF THE CALIFORNIA RESIDENTIAL CODE.
- 2) ALL EXPOSED MECHANICAL AND PLUMBING VENTING LOCATIONS TO BE APPROVED BY ARCHITECT PRIOR TO INSTALLATION AND PAINTED A COLOR THAT COMPLEMENTS THE SURROUNDING EXTERIOR MATERIALS.
- 3) WATER RESISTIVE BARRIERS SHALL BE INSTALLED AS REQUIRED IN SECTION R703.2 AND WHERE APPLIED OVER WOOD-BASED SHEATHING SHALL INCLUDE A WATER-RESISTIVE VAPOR-PERMEABLE BARRIER WITH A PERFORMANCE AT LEAST EQUIVALENT TO TWO LAYERS OF GRADE D PAPER. THE INDIVIDUAL LAYERS SHALL BE INSTALLED INDEPENDENTLY SUCH THAT EACH LAYER PROVIDES A SEPARATE CONTINUOUS PLANE AND ANY FLASHINGS (INSTALLED IN ACCORDANCE WITH SECTION R703.4) INTENDED TO DRAIN TO THE WATER-RESISTIVE BARRIER IS DIRECTED BETWEEN THE LAYERS. 2016 CRC R703.1.3
- 4) INSULATION MATERIALS, INCLUDING FACINGS, SUCH AS VAPOR RETARDERS AND VAPOR-PERMEABLE MEMBRANES INSTALLED WITHIN FLOOR-CEILING ASSEMBLIES, ROOF-CEILING ASSEMBLIES, CRACK SPACES AND ATTICS SHALL HAVE A FLAME SPREAD INDEX NOT TO EXCEED 450. WHEN TESTED IN ACCORDANCE WITH ASTM E84 OR UL 723. EXCEPT WHEN MATERIALS ARE INSTALLED IN CONCEALED SPACES THE INDEX'S DO NOT APPLY TO THE FACINGS WHEN FACING IS INSTALLED IN CONTACT WITH THE EXPOSED SURFACE OF THE CEILING, FLOOR OR WALL FINISH OR WHEN CELLULOSE LOOSE-FILL INSULATION WHICH IS NOT SPRAY APPLIED SHALL ONLY BE REQUIRED TO MEET THE SMOKE-DEVELOPED INDEX OF NOT MORE THAN 450. 2016 CRC SECTION R302.10
- 5) BUILDINGS SHALL HAVE APPROVED ADDRESS NUMBERS, BUILDING NUMBERS OR APPROVED BUILDING IDENTIFICATION PLACED IN A POSITION THAT IS PLAINLY LEGIBLE AND VISIBLE FROM THE STREET OR ROAD FRONTING THE PROPERTY. THESE NUMBERS SHALL CONTRAST WITH THEIR BACKGROUND. ADDRESS NUMBERS SHALL BE A MINIMUM OF 4 INCHES HIGH WITH A MINIMUM STROKE WIDTH OF 1/2 INCH WHERE ACCESS IS BY MEANS OF A PRIVATE ROAD AND THE BUILDING ADDRESS CANNOT BE VIEWED FROM THE PUBLIC WAY, A MONUMENT, POLE OR OTHER SIGN OR MEANS SHALL BE USED TO IDENTIFY THE STRUCTURE. 2016 CRC R301.1



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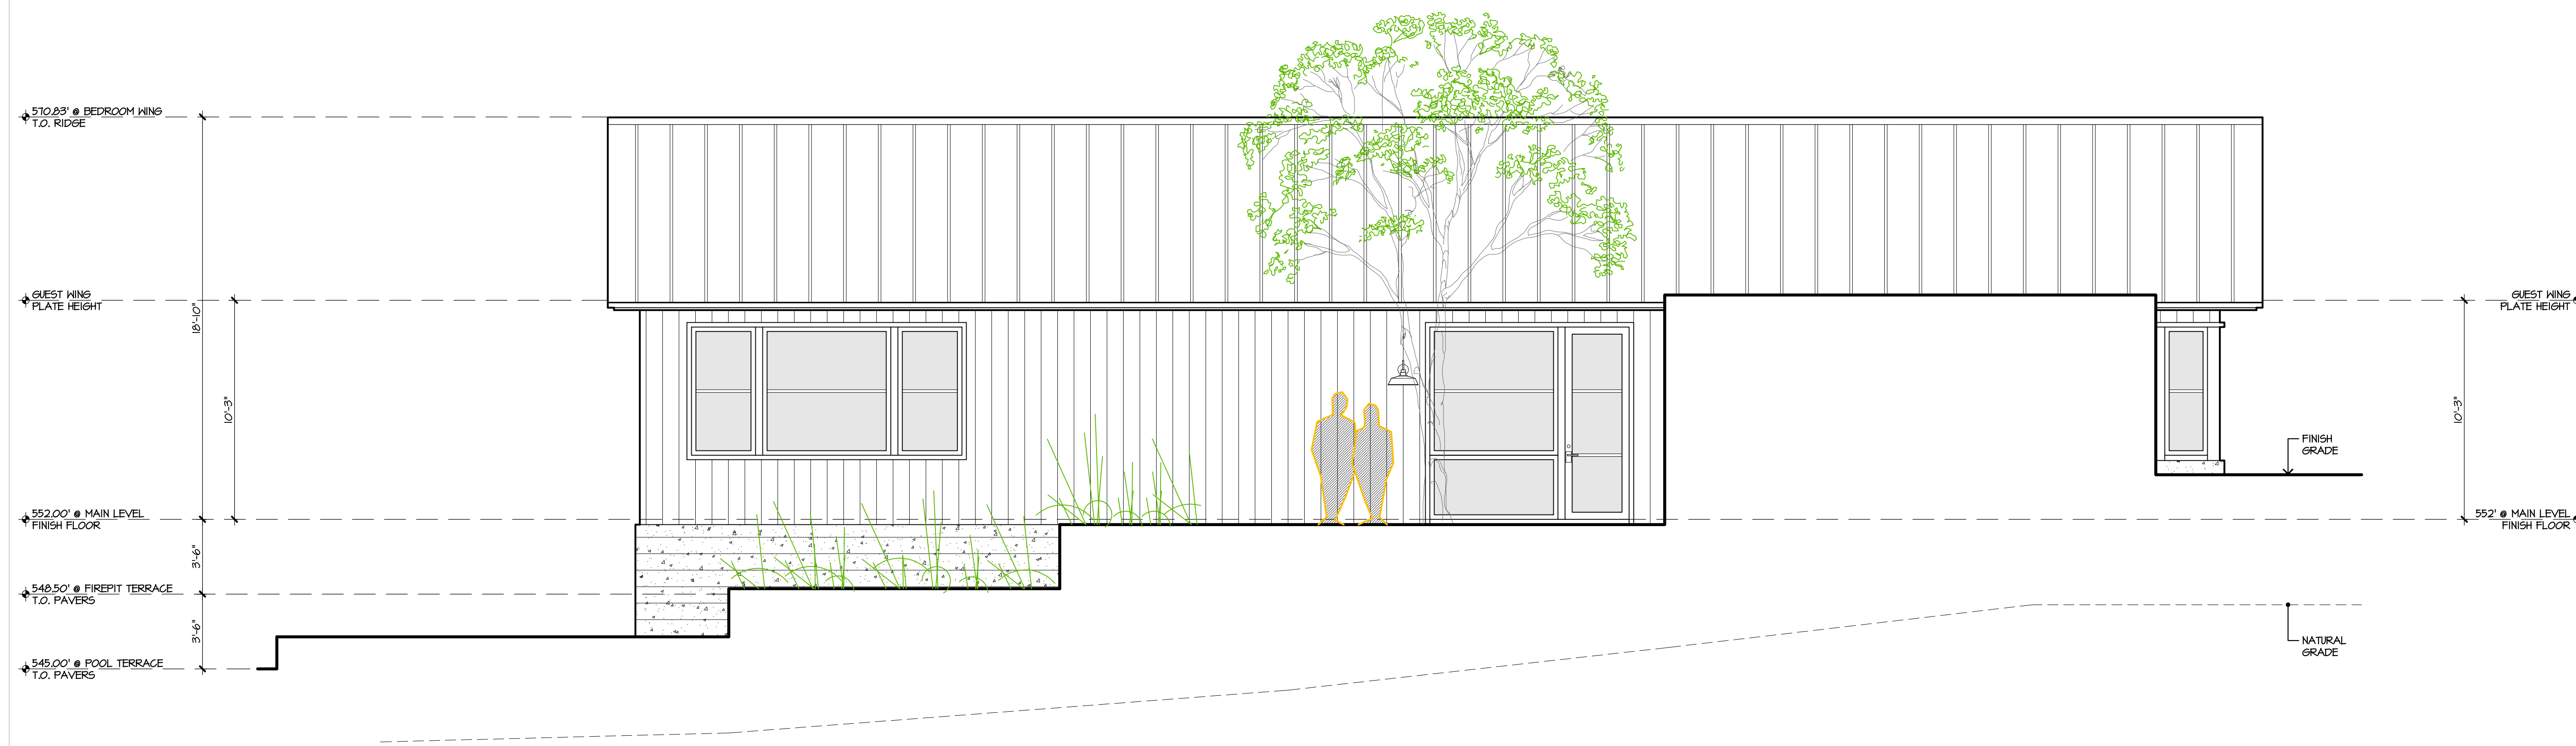
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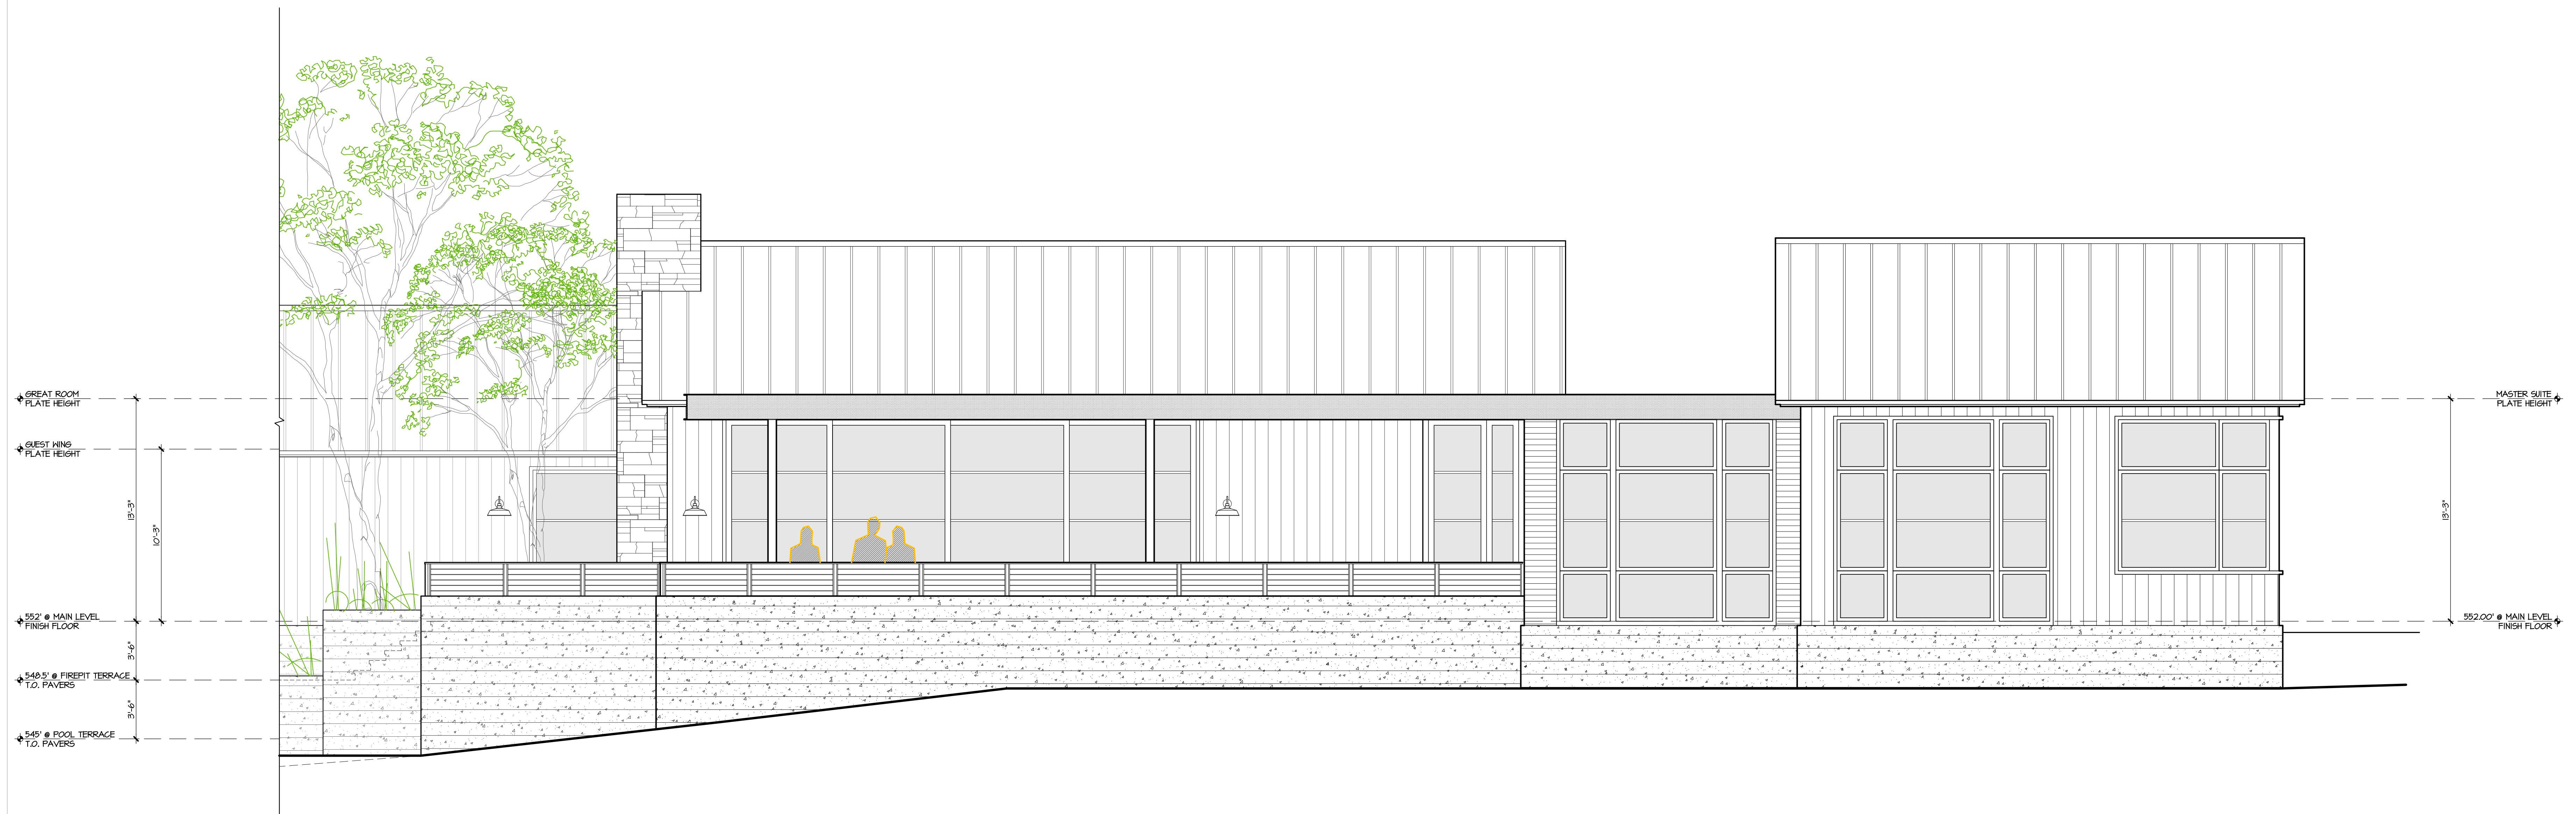
Drawing Title
Exterior Elevations

Drawing Number

a 3.2



1 EAST ELEVATION
MAIN HOUSE




2 EAST ELEVATION
MAIN HOUSE

EXTERIOR FINISH LEGEND

SEE SHEET A-3.2

GENERAL NOTES

SEE SHEET A-3.2

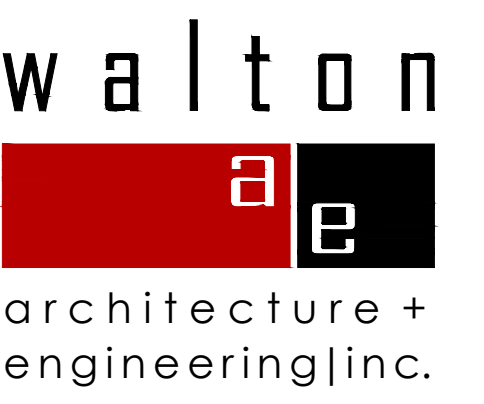

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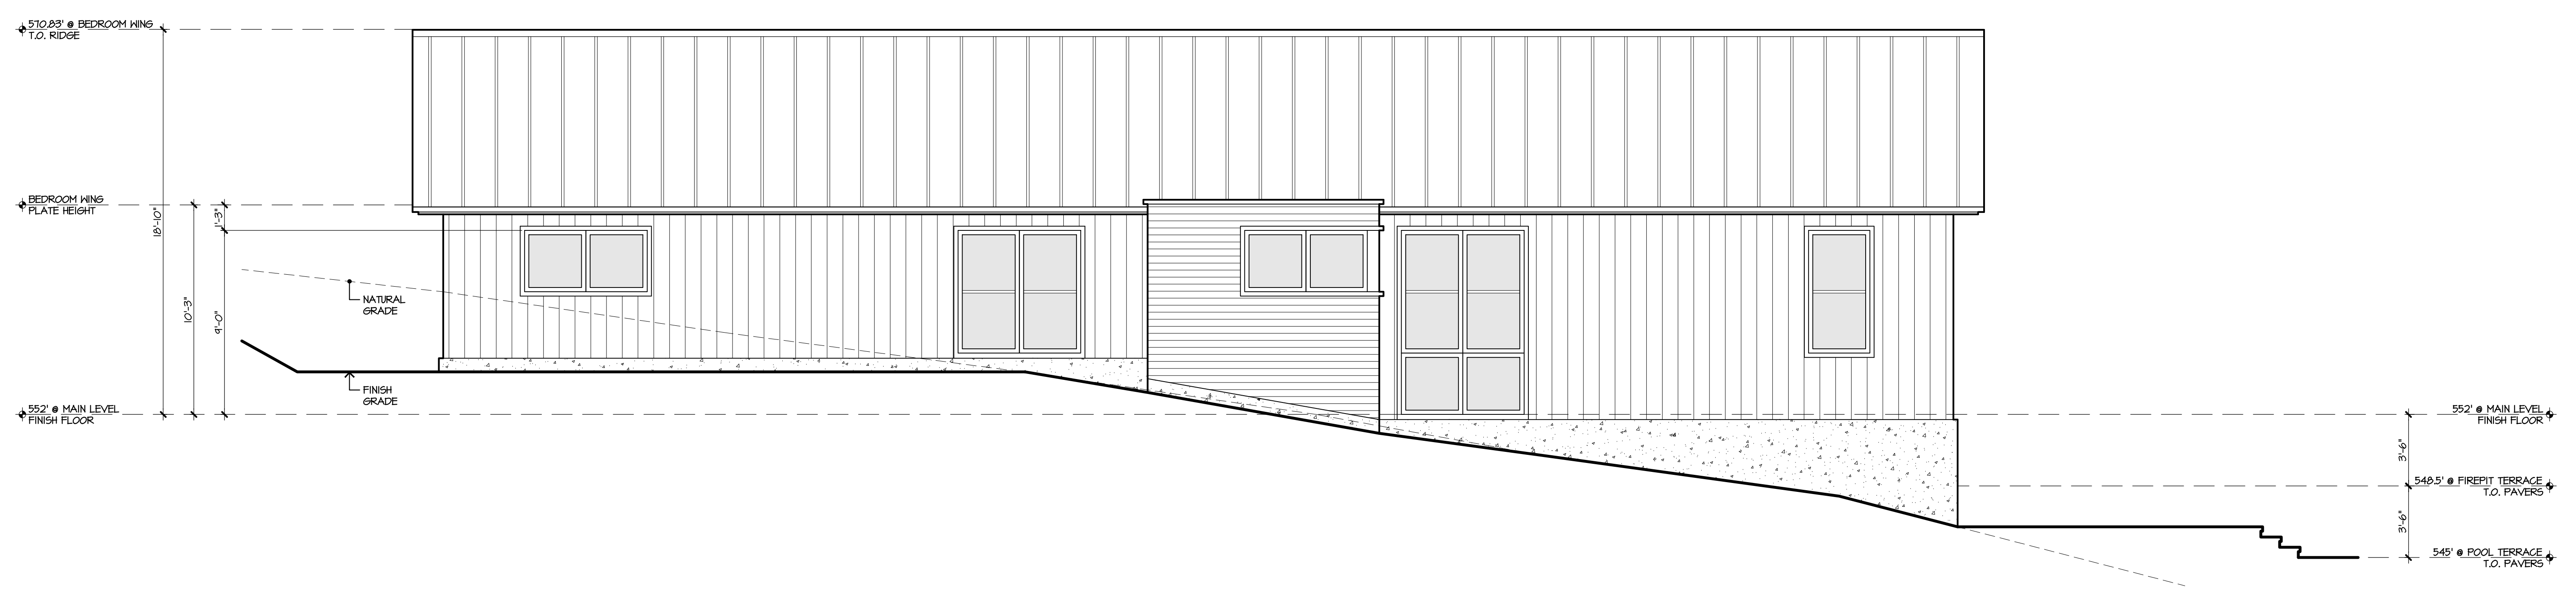
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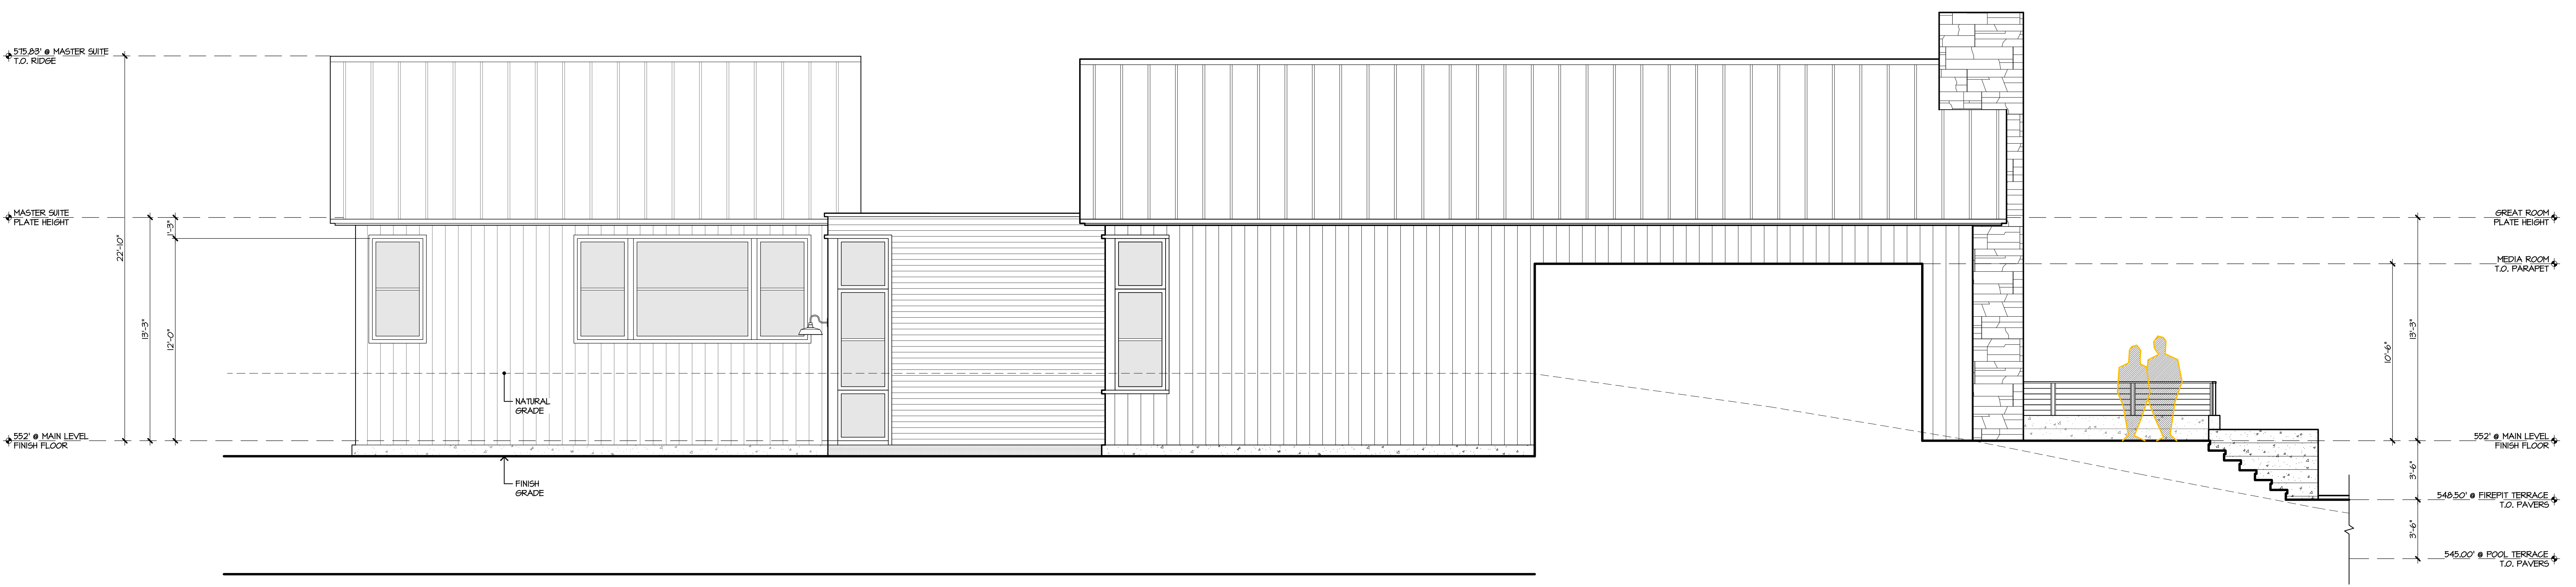
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Exterior Elevations

Drawing Number

a 3.3




1 WEST ELEVATION
MAIN HOUSE - BEDROOM KING



2 WEST ELEVATION - SECTION AT MEDIA ROOM
MAIN HOUSE

EXTERIOR FINISH LEGEND
SEE SHEET A-3.2

GENERAL NOTES
SEE SHEET A-3.2

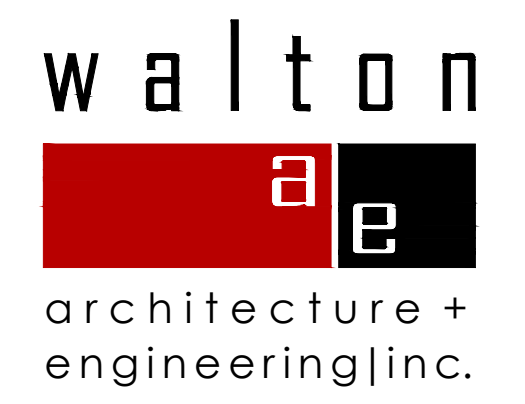

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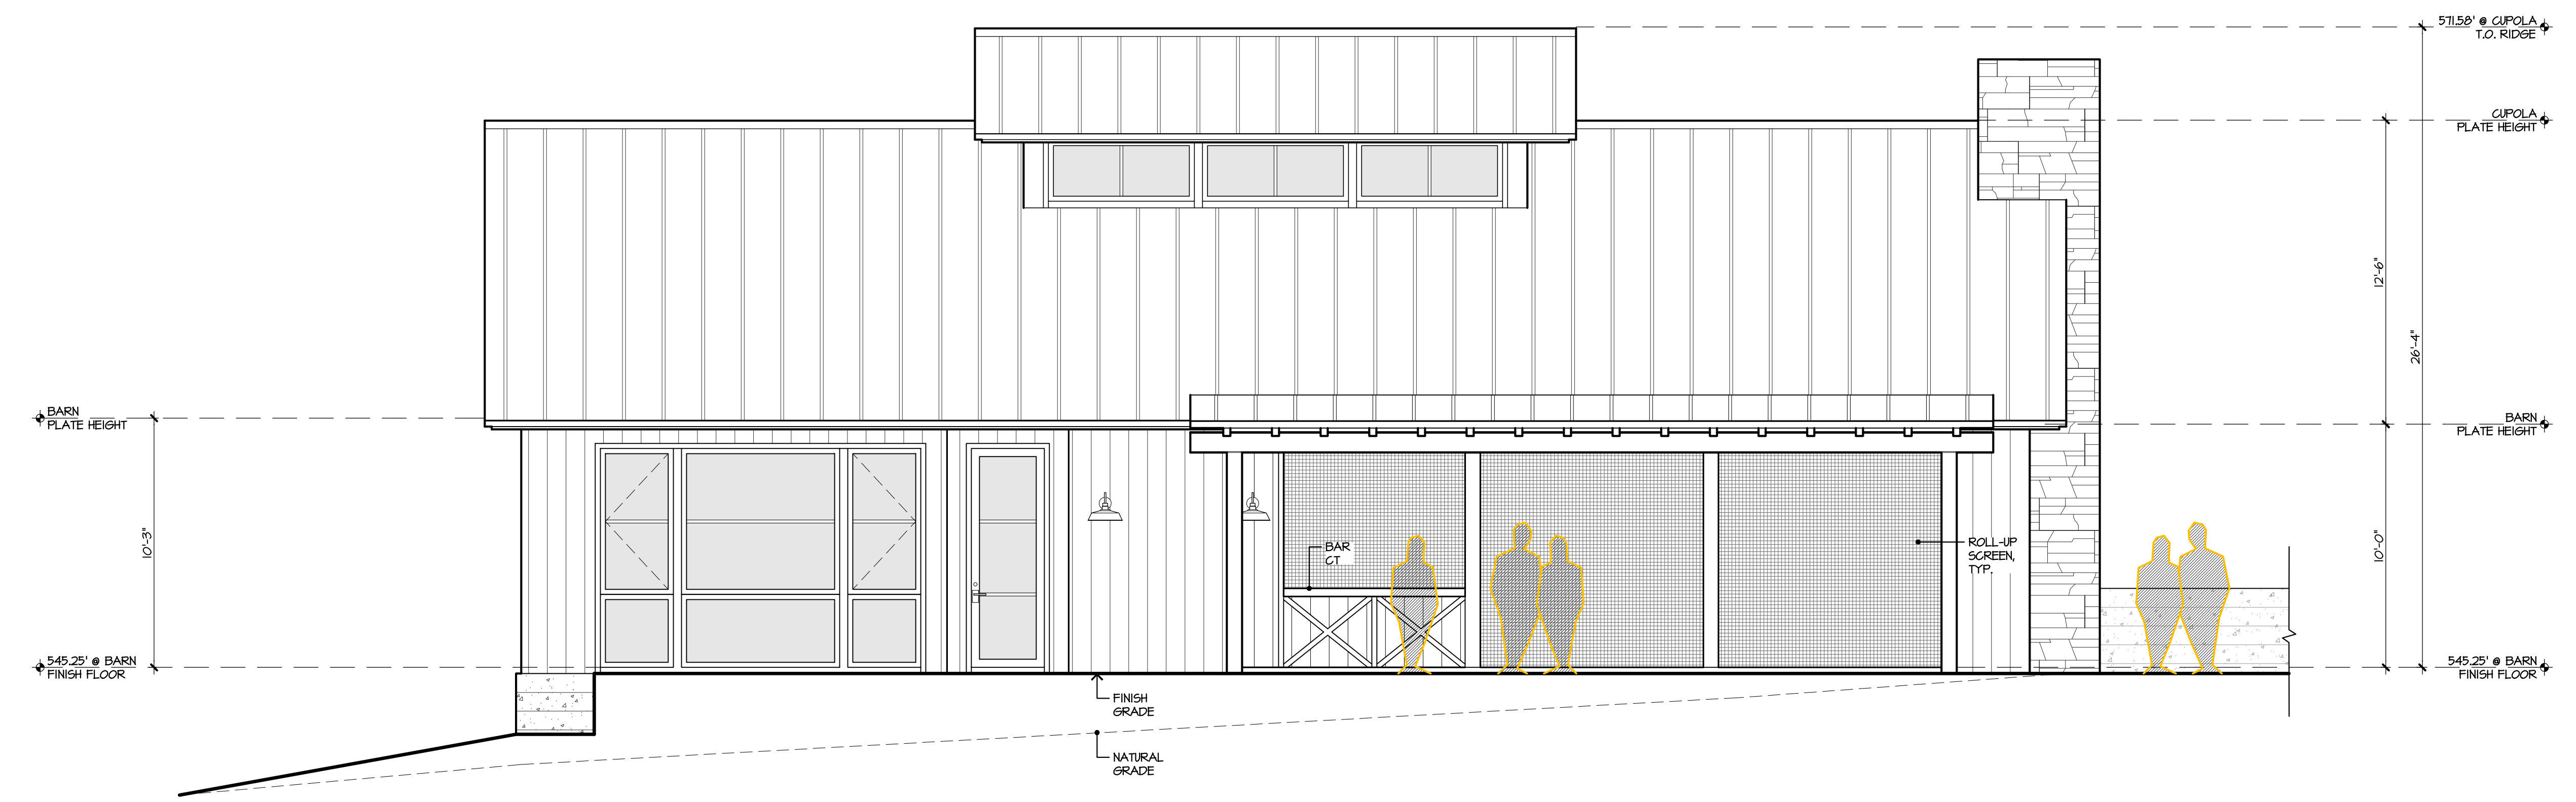
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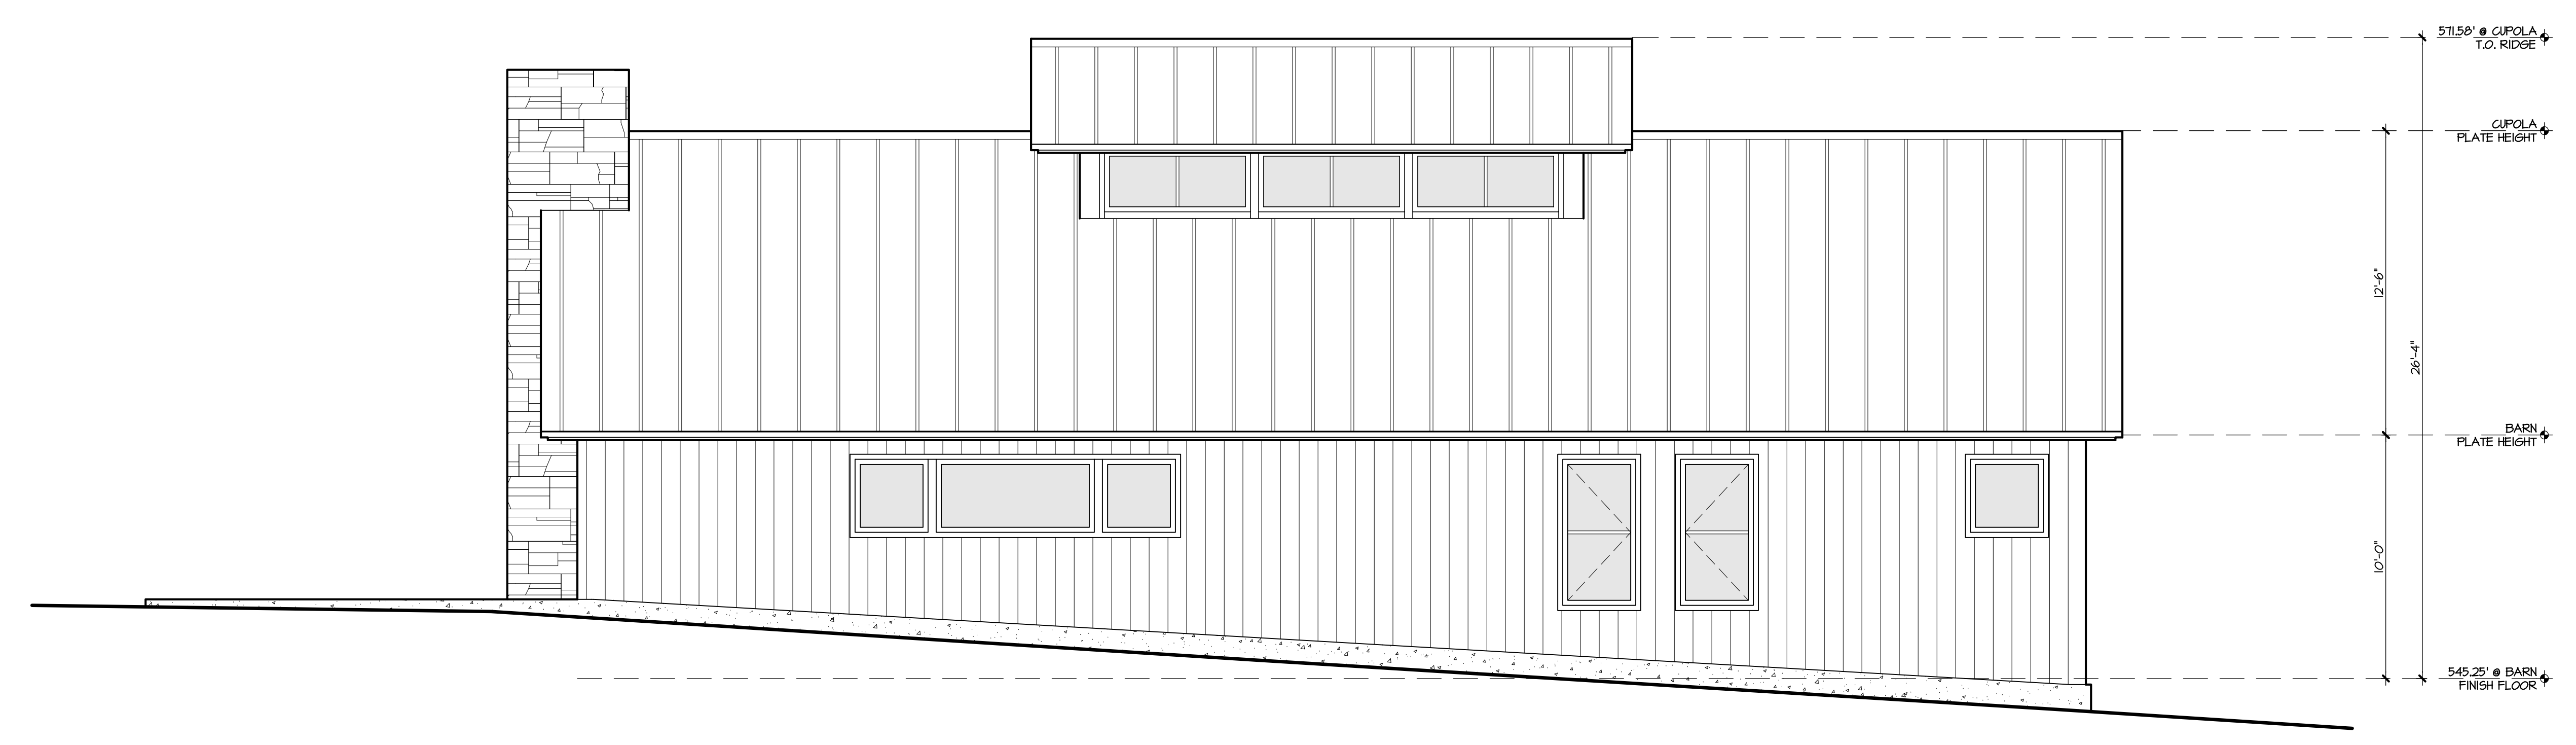
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Exterior Elevations

Drawing Number

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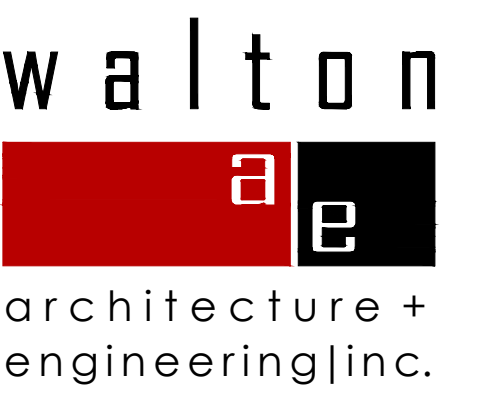


1 EAST ELEVATION
BARN



2 WEST ELEVATION
BARN

EXTERIOR FINISH LEGEND
 SEE SHEET A-3.2
 GENERAL NOTES
 SEE SHEET A-3.2



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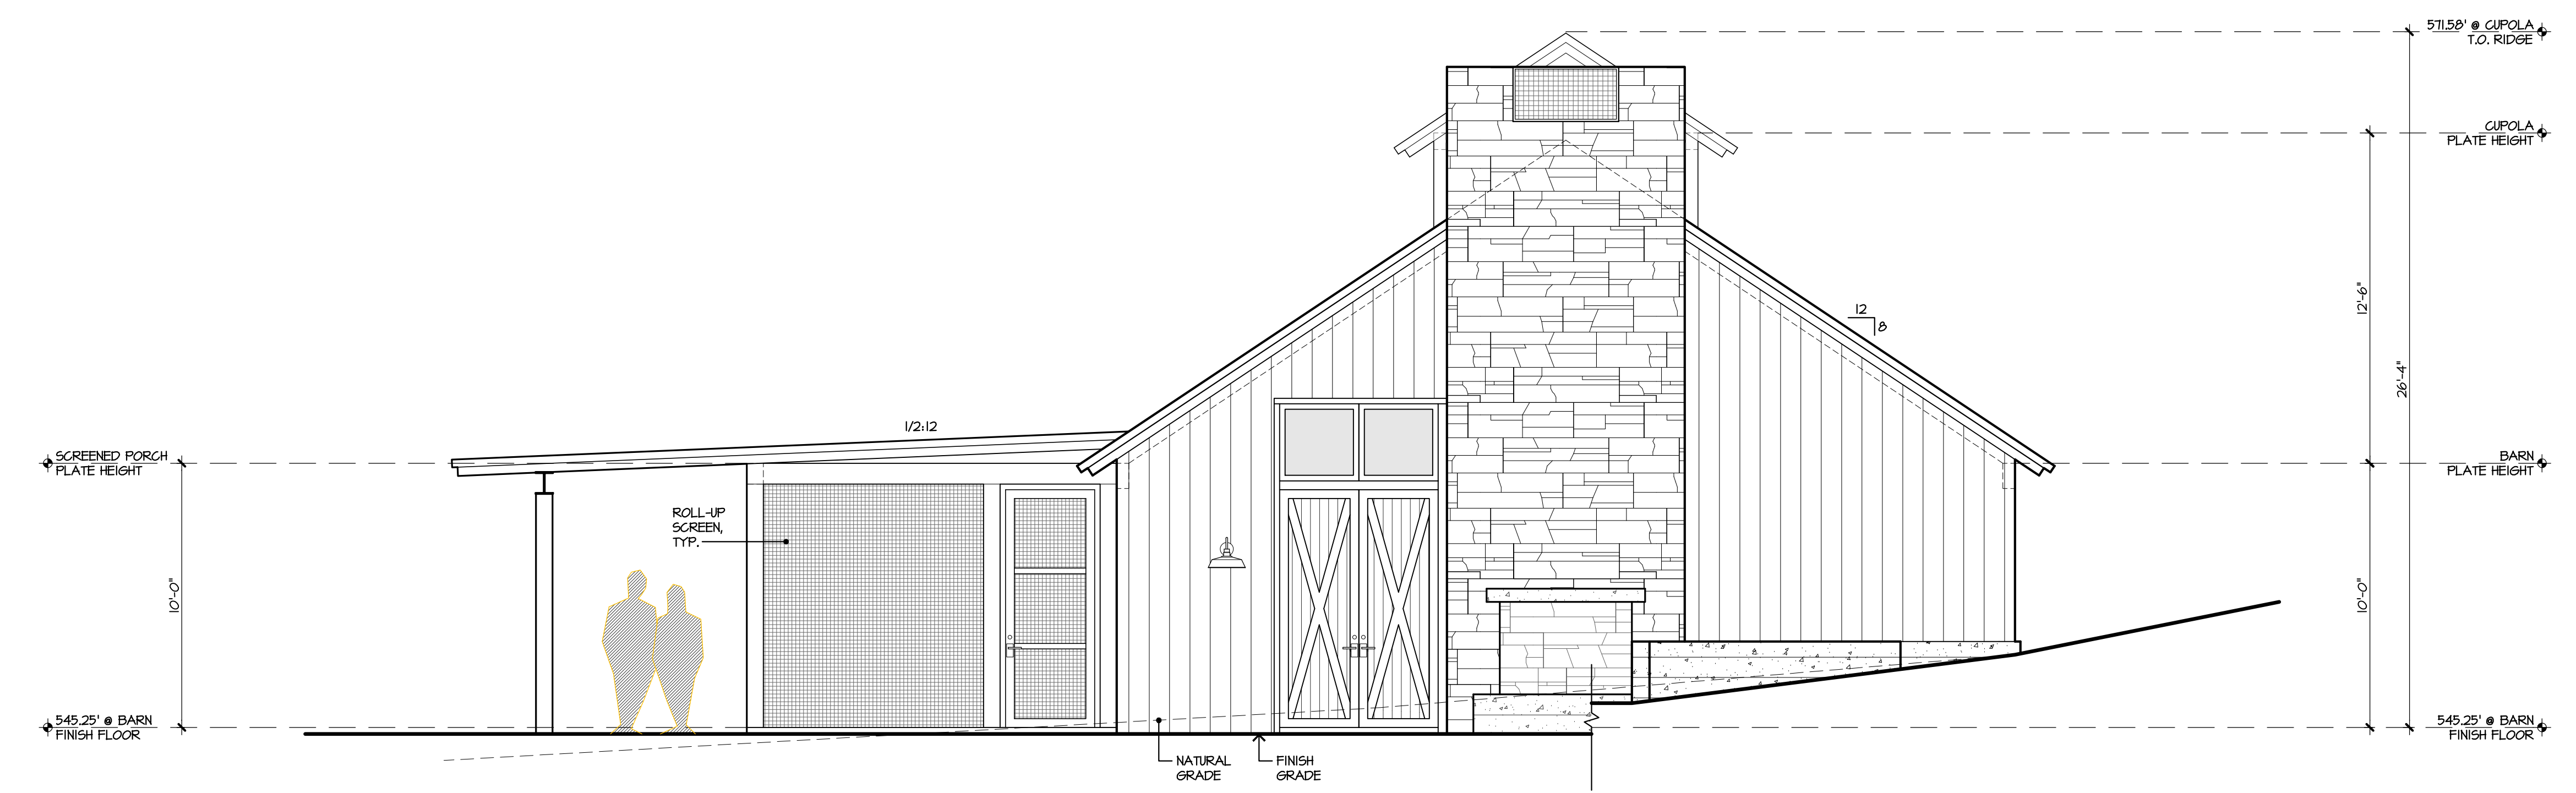
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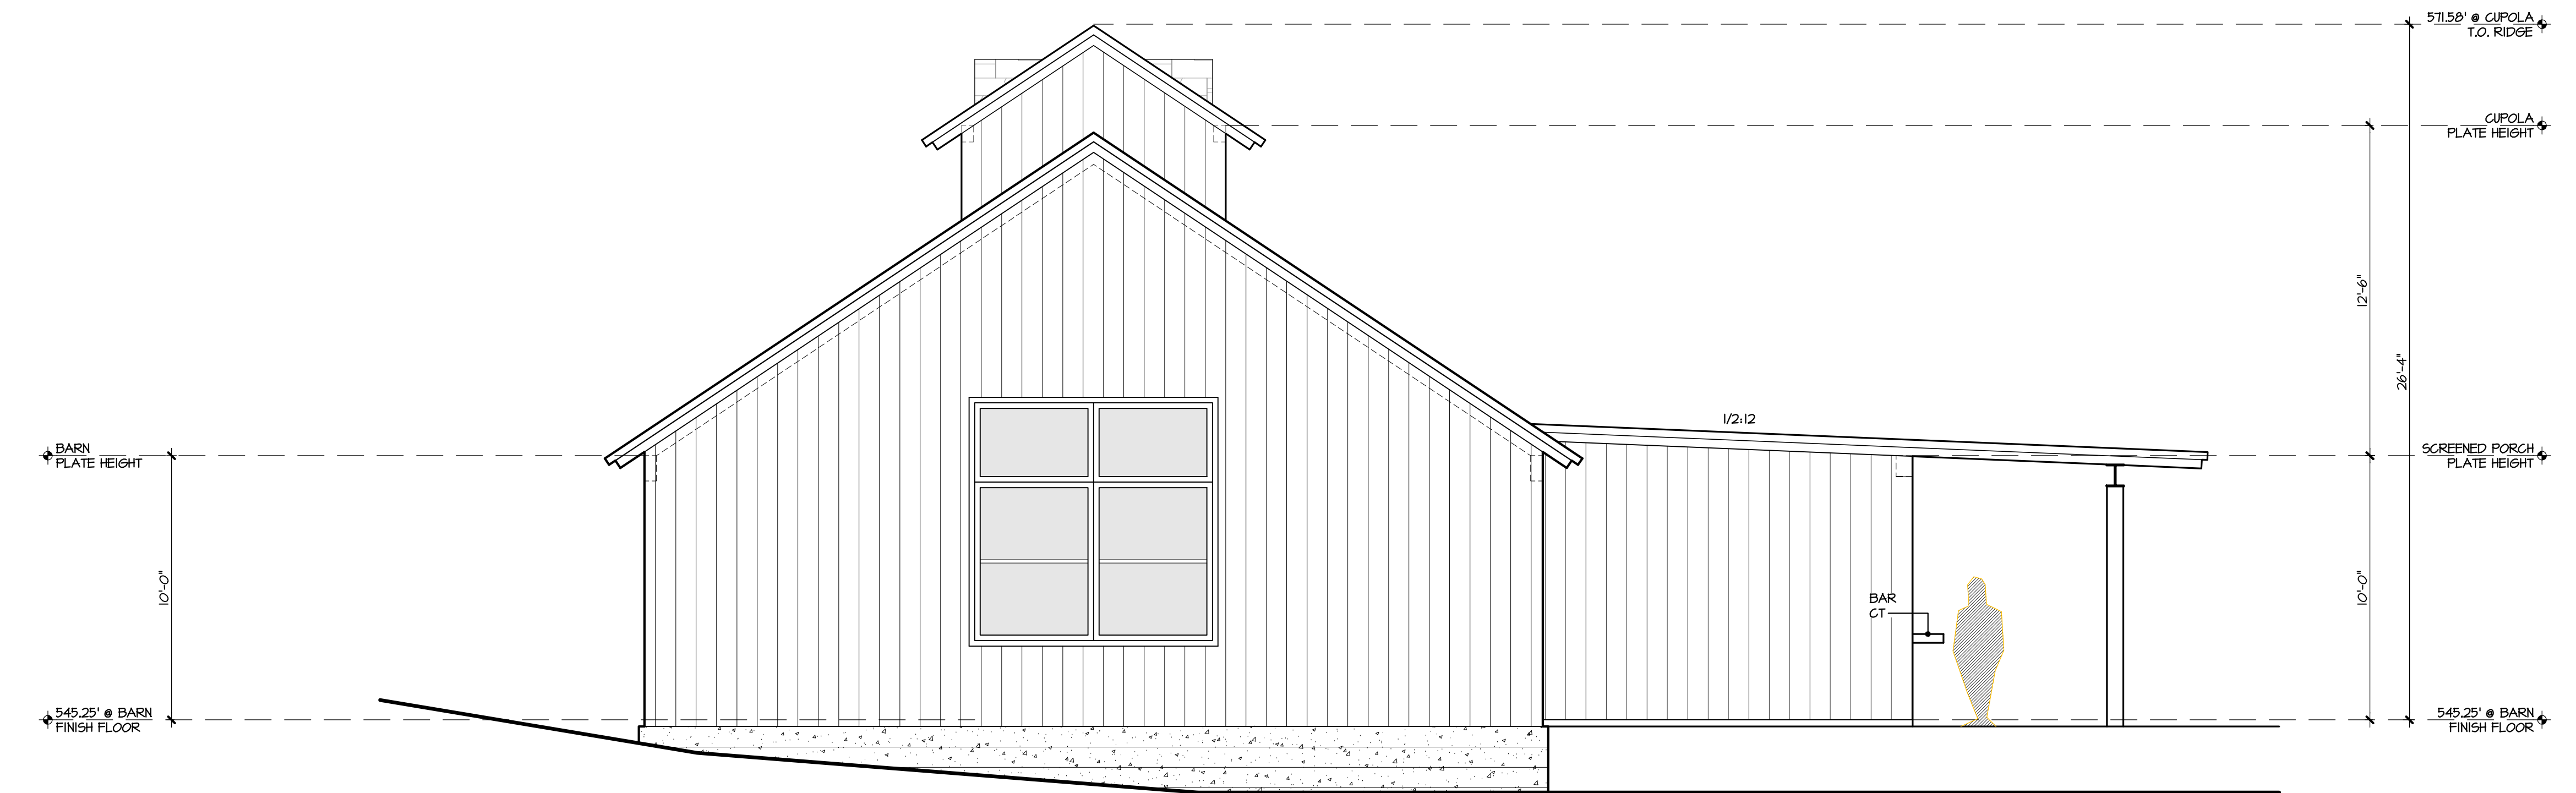
Drawing Title
 Exterior Elevations

Drawing Number

a 3.5



1 NORTH ELEVATION
 BARN



2 SOUTH ELEVATION
 BARN

EXTERIOR FINISH LEGEND

SEE SHEET A-3.2

GENERAL NOTES

SEE SHEET A-3.2

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PC Submittal - 07.28.17

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Issue Date

02 August 2017

Subject


Revisions

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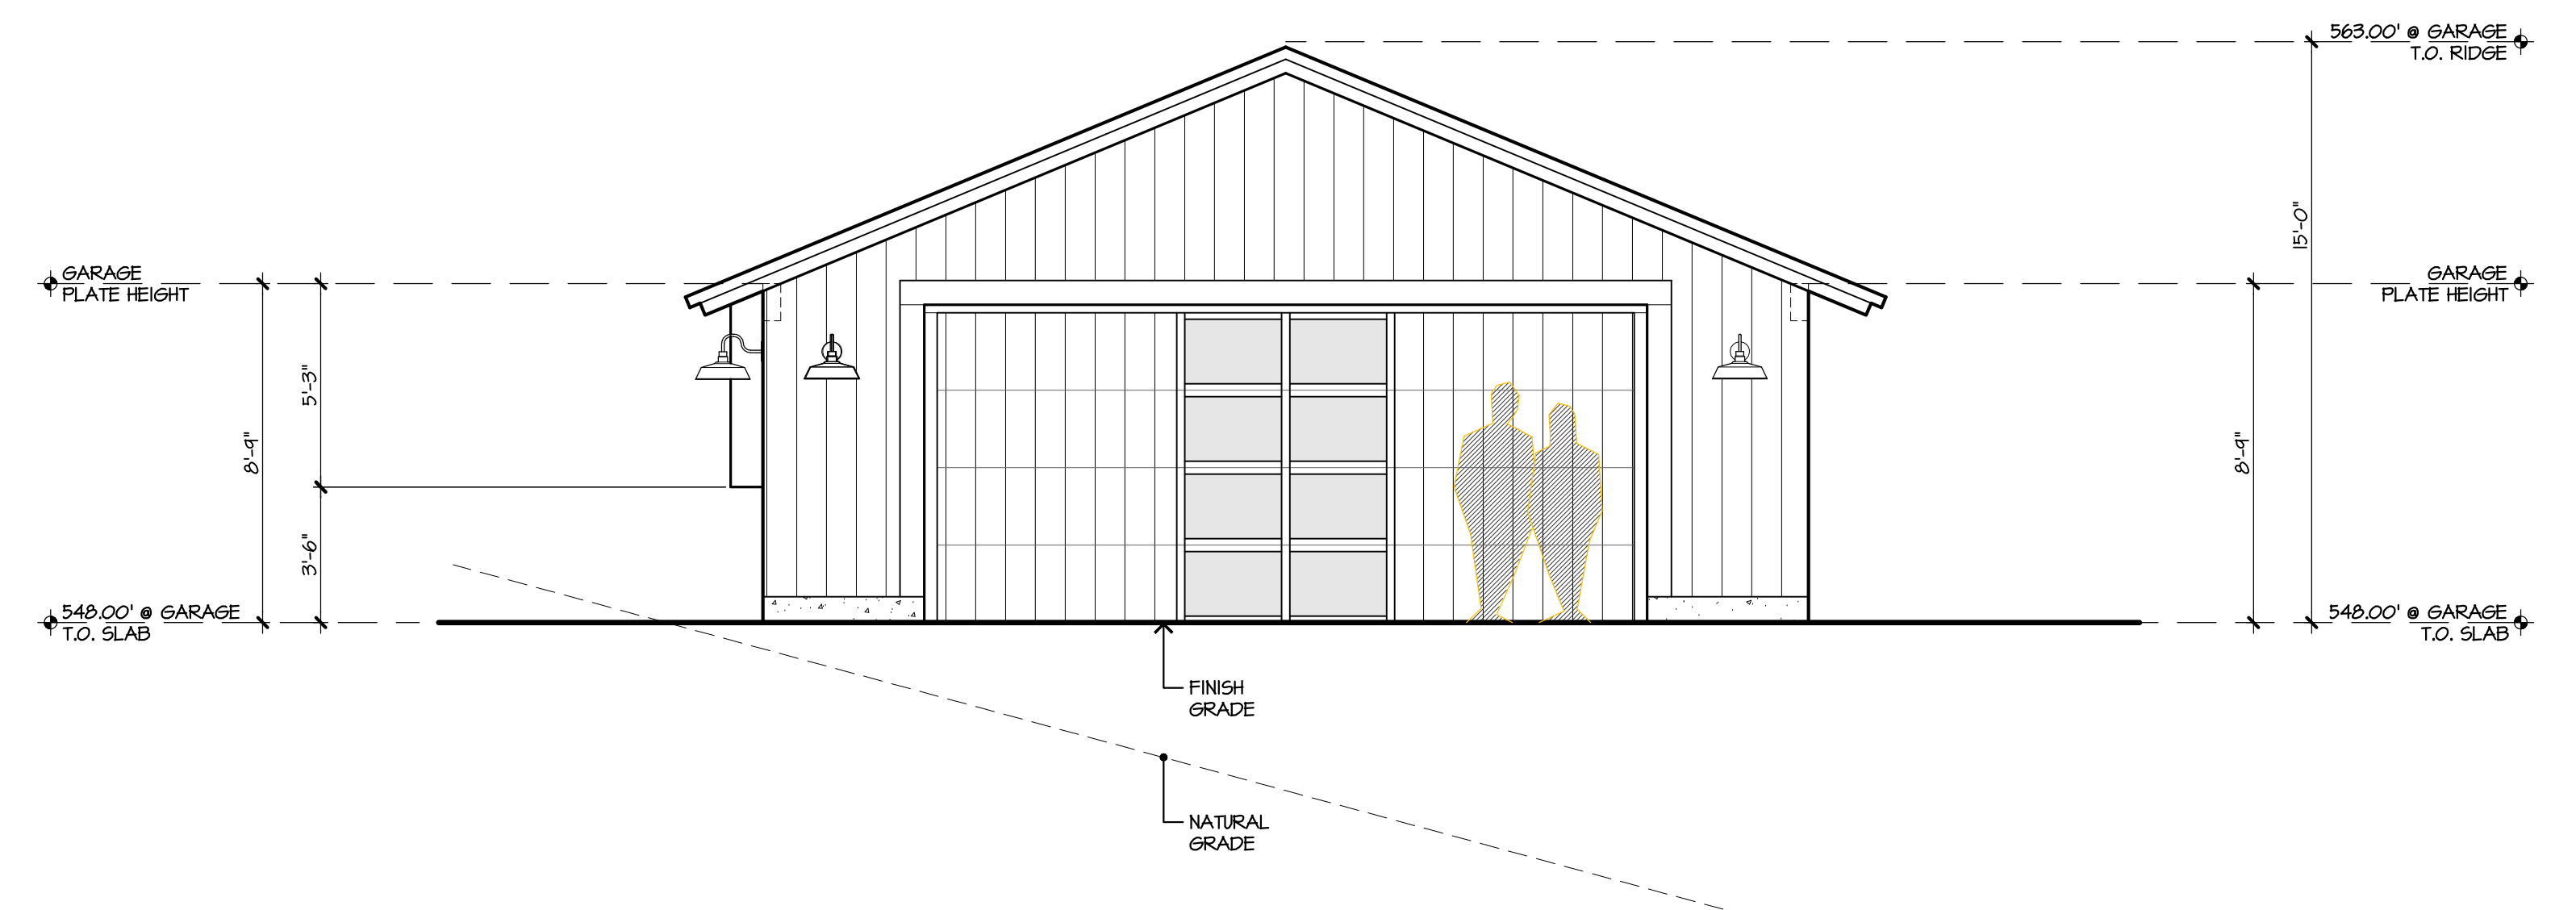
Exterior
 Elevations

Drawing Number


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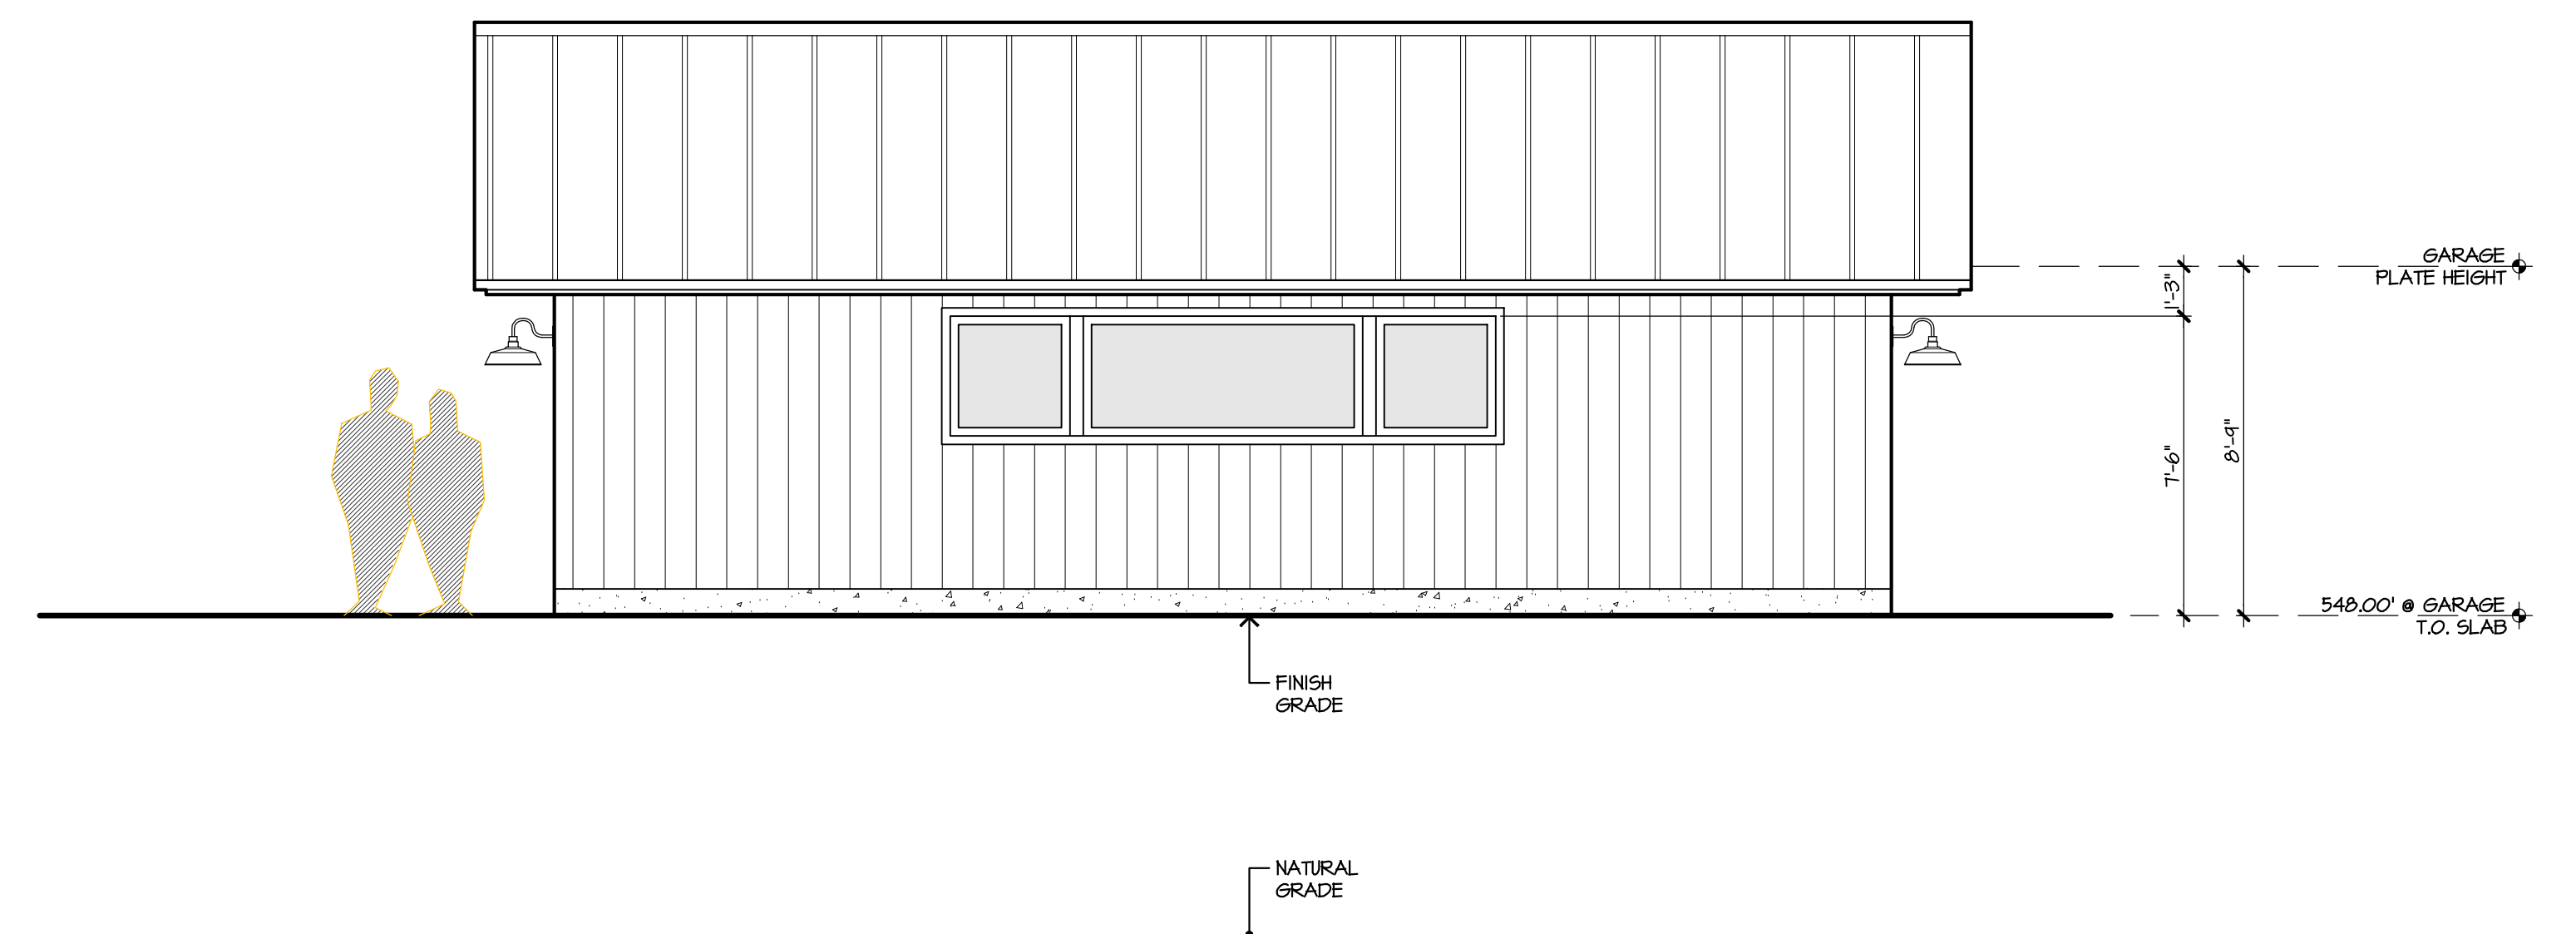
1 WEST ELEVATION
 DETACHED GARAGE

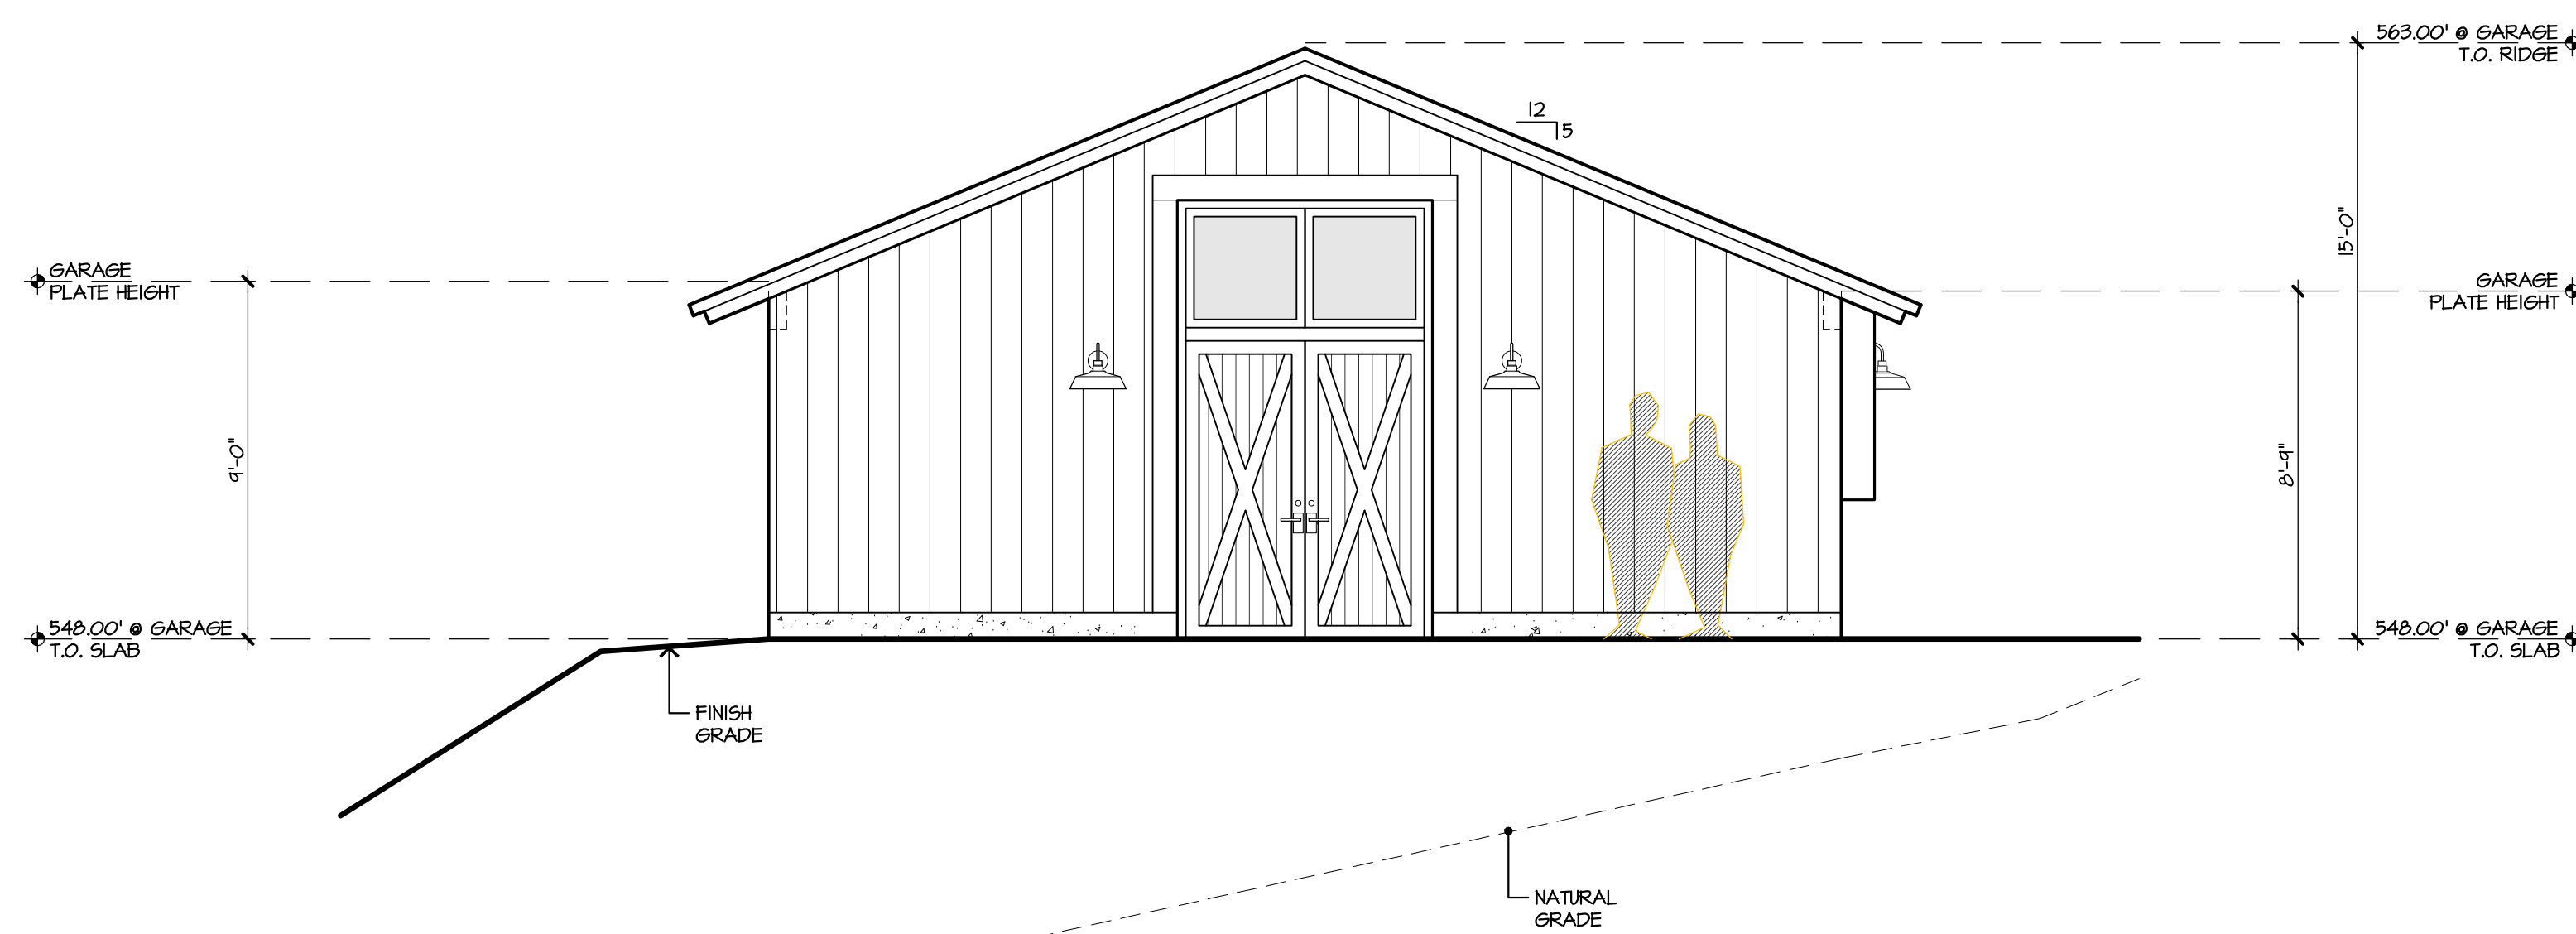


3 WEST ELEVATION
 DETACHED GARAGE



2 WEST ELEVATION
 DETACHED GARAGE

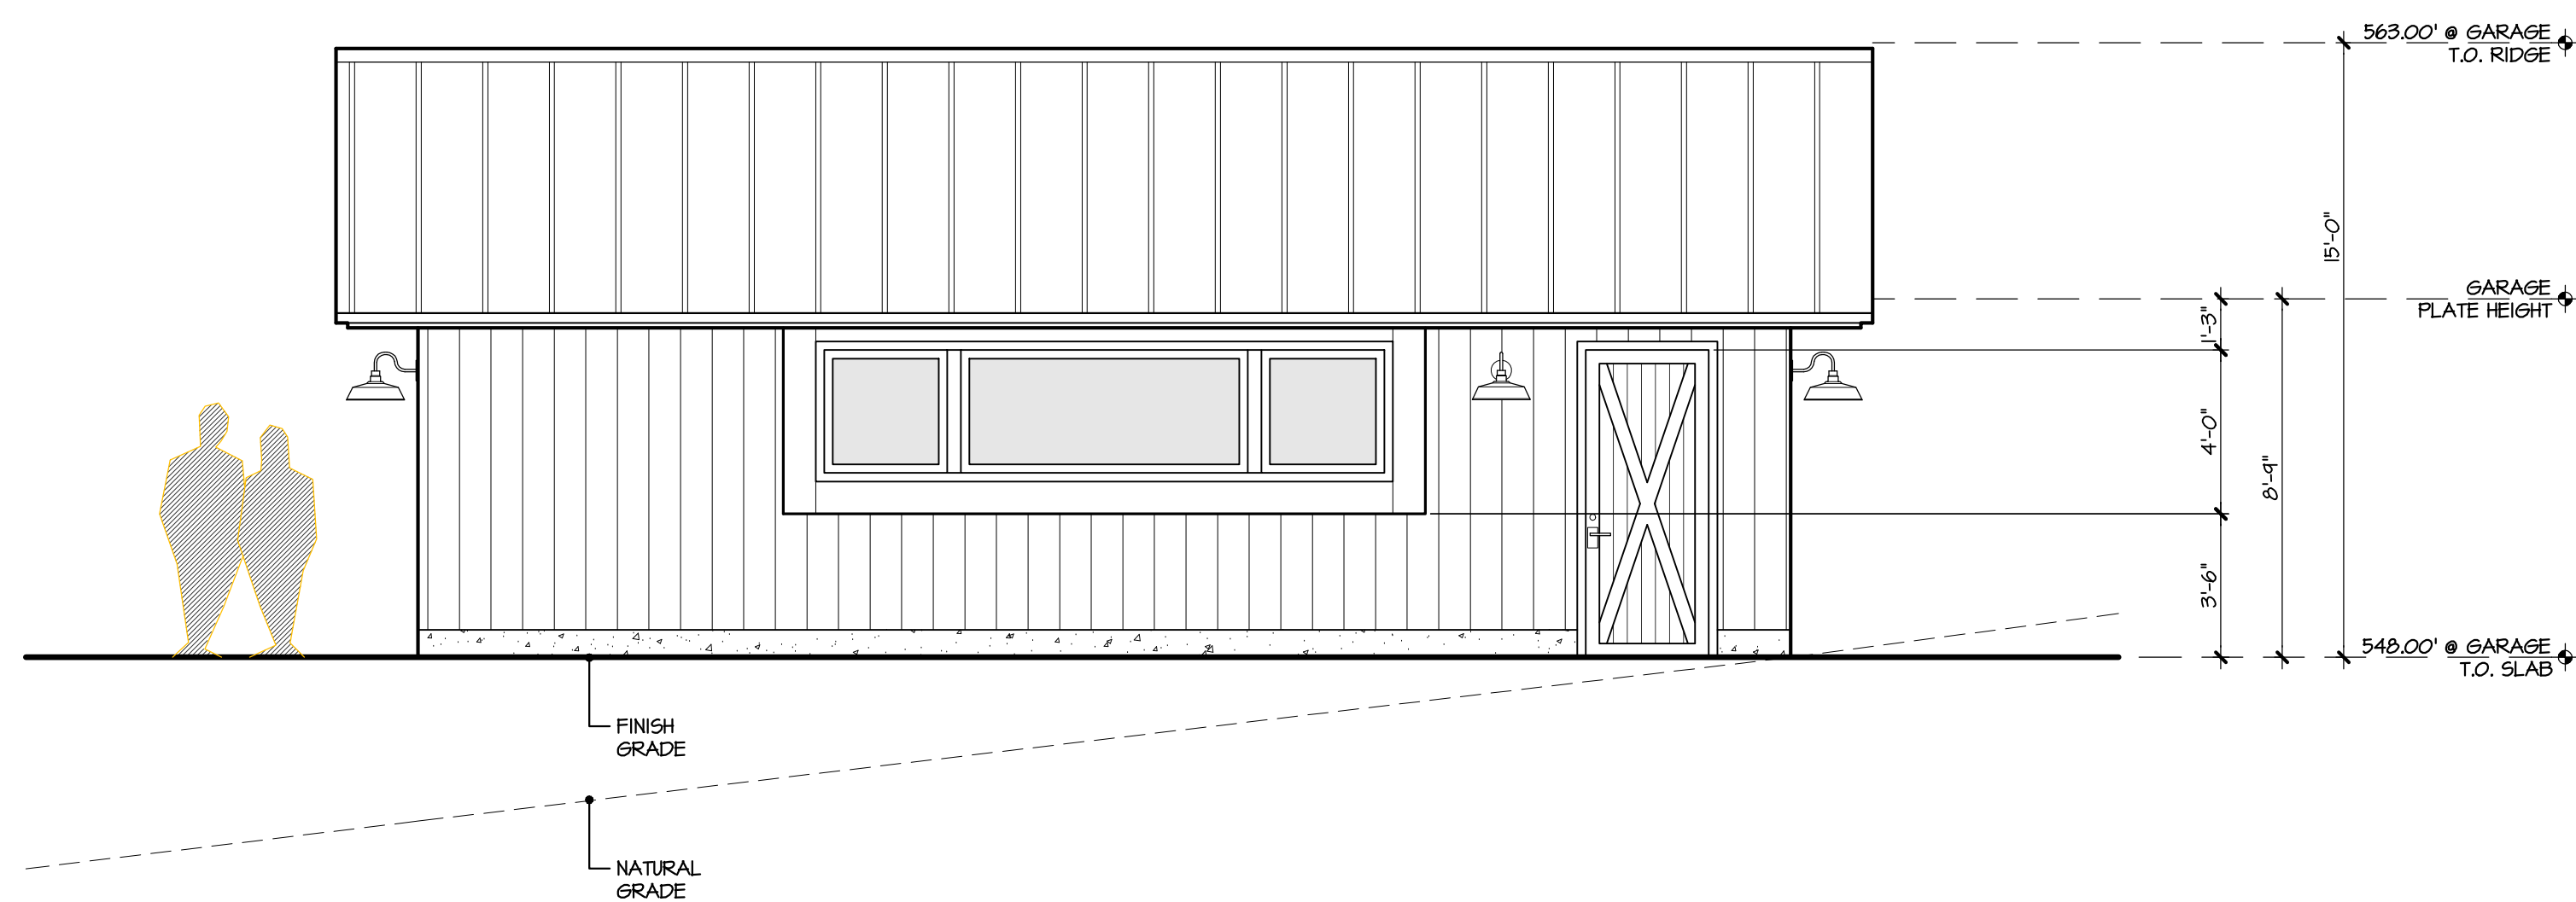

4 EAST ELEVATION
 DETACHED GARAGE

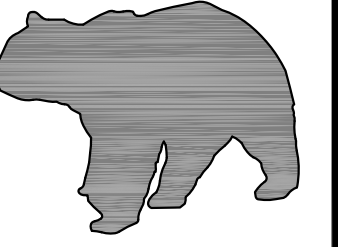


**BEAR FLAG
ENGINEERING
INC**

CIVIL ENGINEERING
LAND DEVELOPMENT
SEPTIC SYSTEM DESIGN
PROJECT MANAGEMENT
SURVEYING
BUILDING DESIGN


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**CUT-FILL TICK EXHIBIT
149 4TH STREET RESIDENCE**
149 4TH STREET EAST, SONOMA, CA
APN: 018-091-018

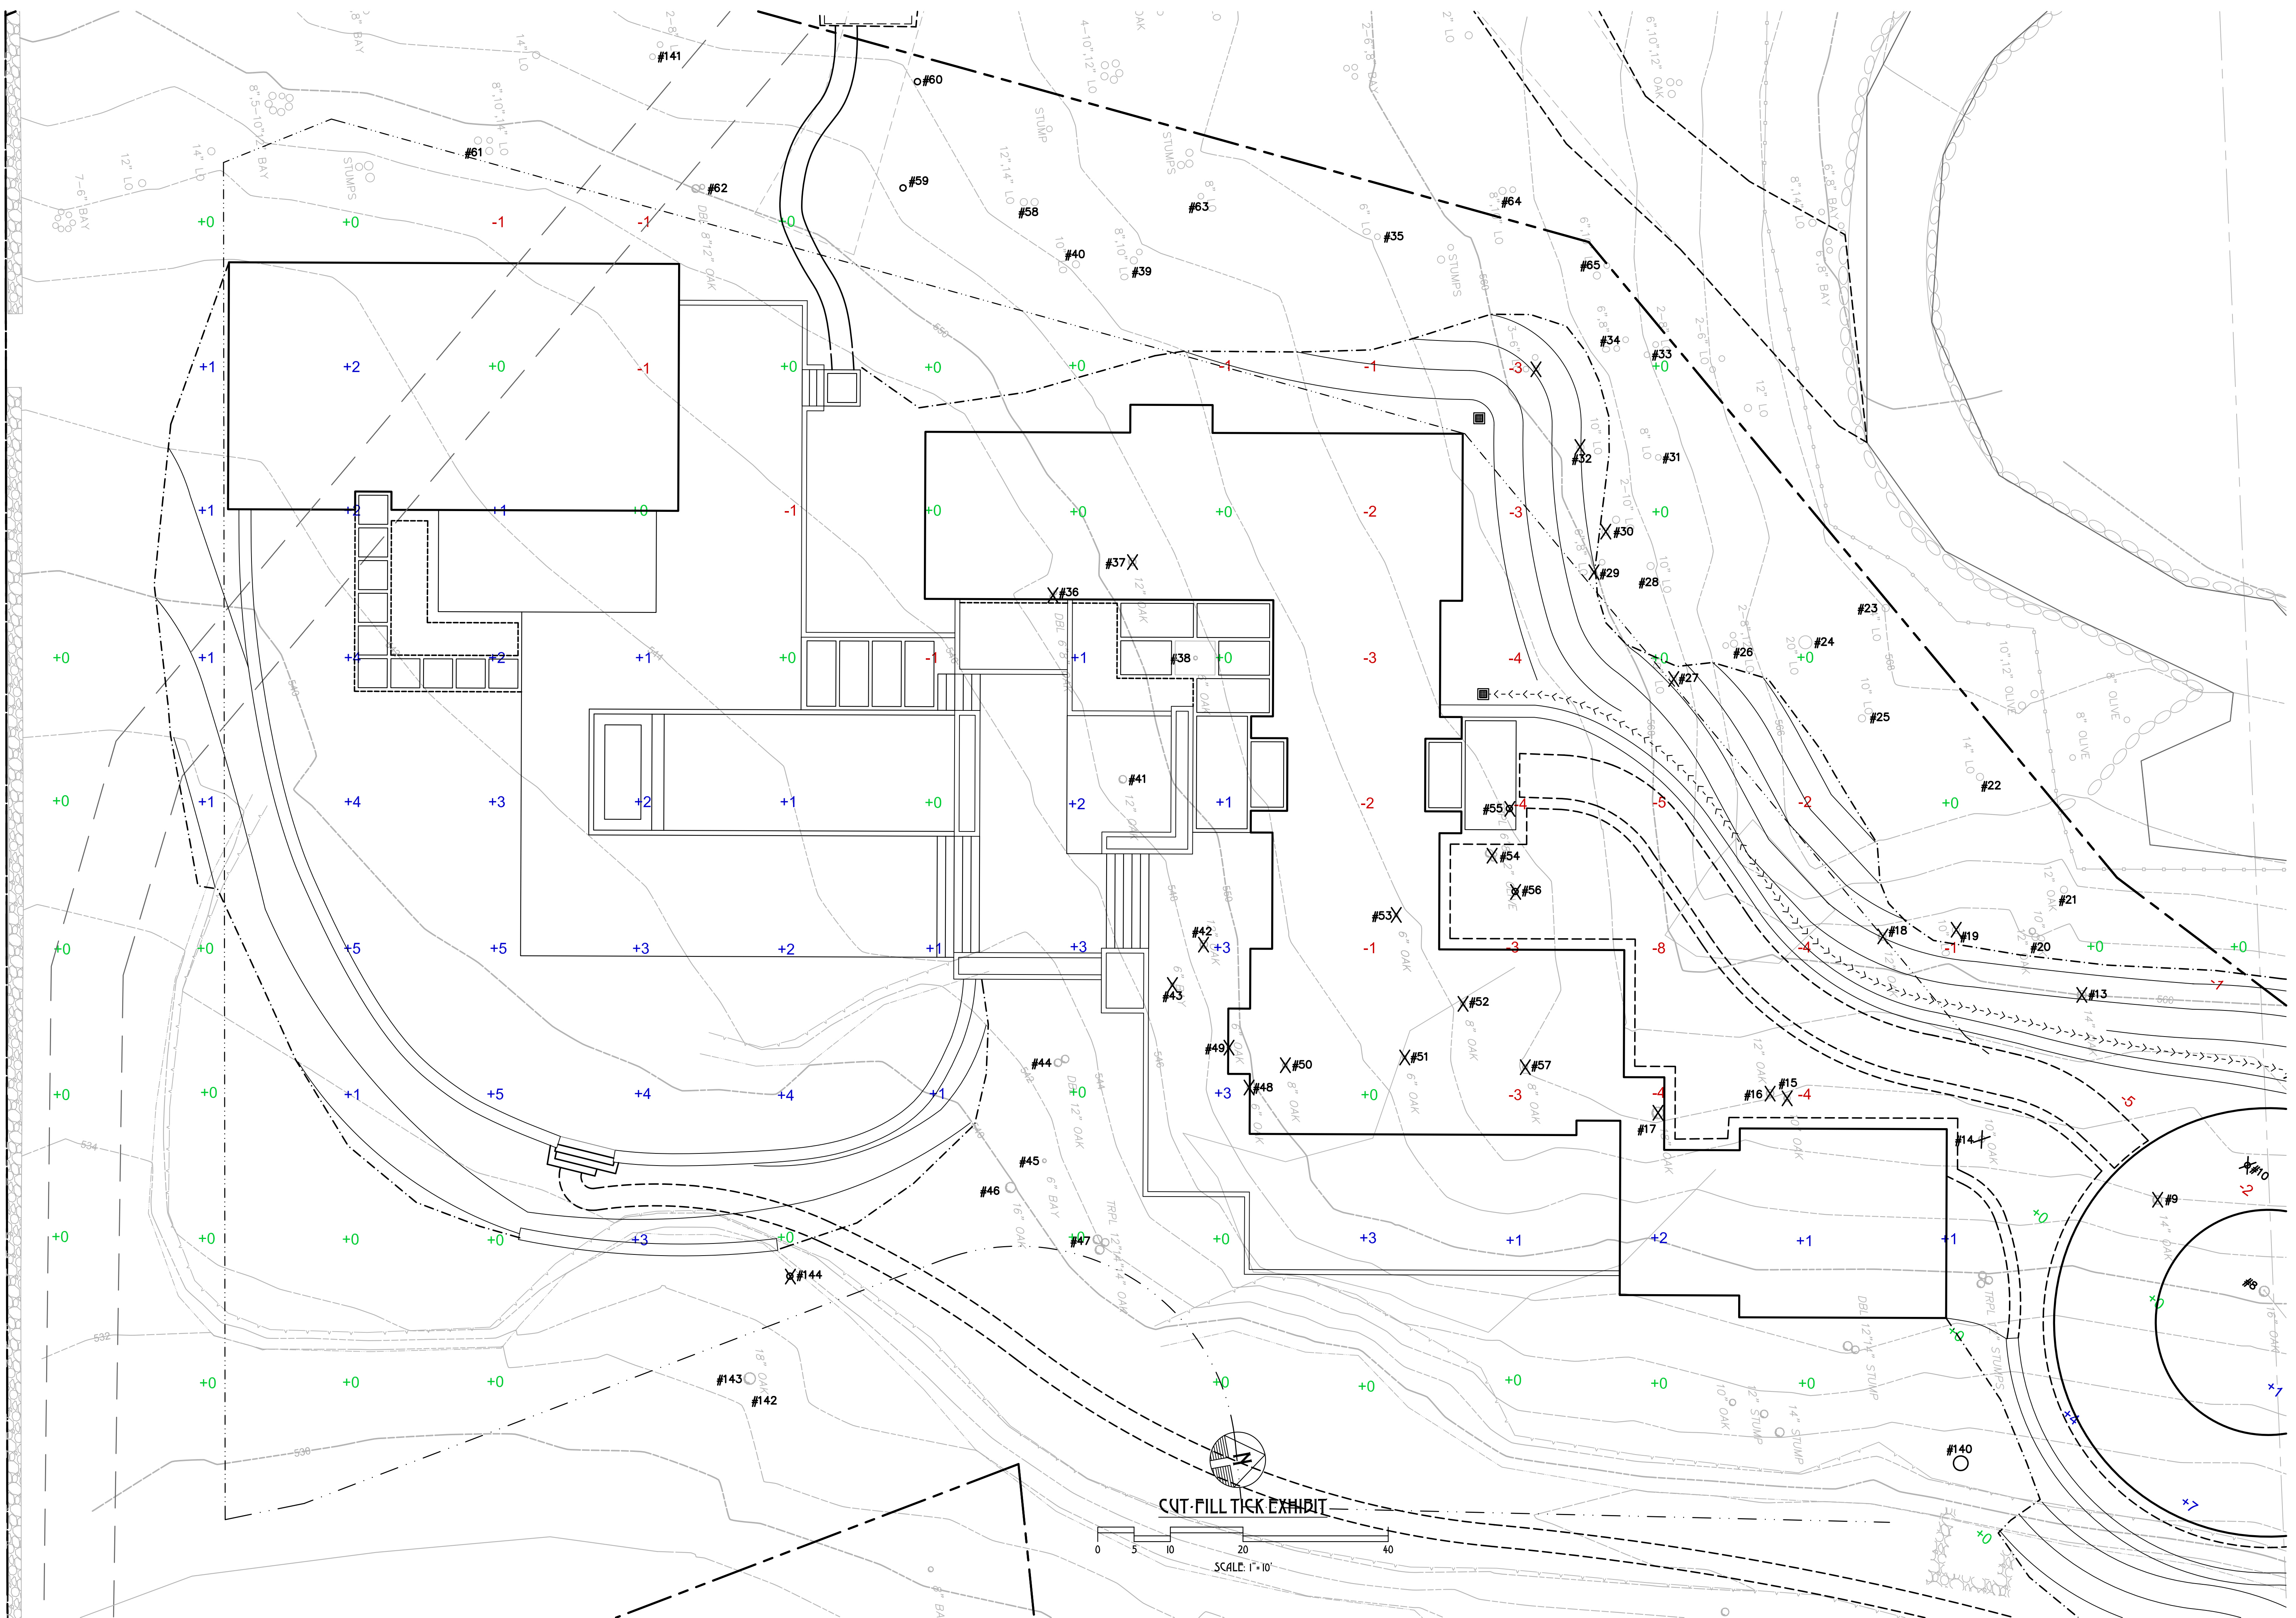

REV	DATE	DESCRIPTION

DATE: 7/28/2017
DESIGN: CSM
PROJECT: 16002
SHEET
1
OF 2 SHEETS

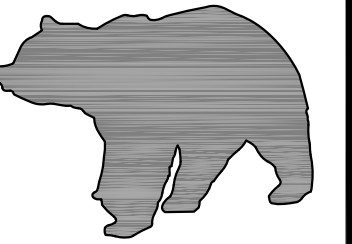


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INC**



CIVIL ENGINEERING
LAND DEVELOPMENT
SEPTIC SYSTEM DESIGN
PROJECT MANAGEMENT
SURVEYING
BUILDING DESIGN

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CUT-FILL TICK EXHIBIT
149 4TH STREET RESIDENCE
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



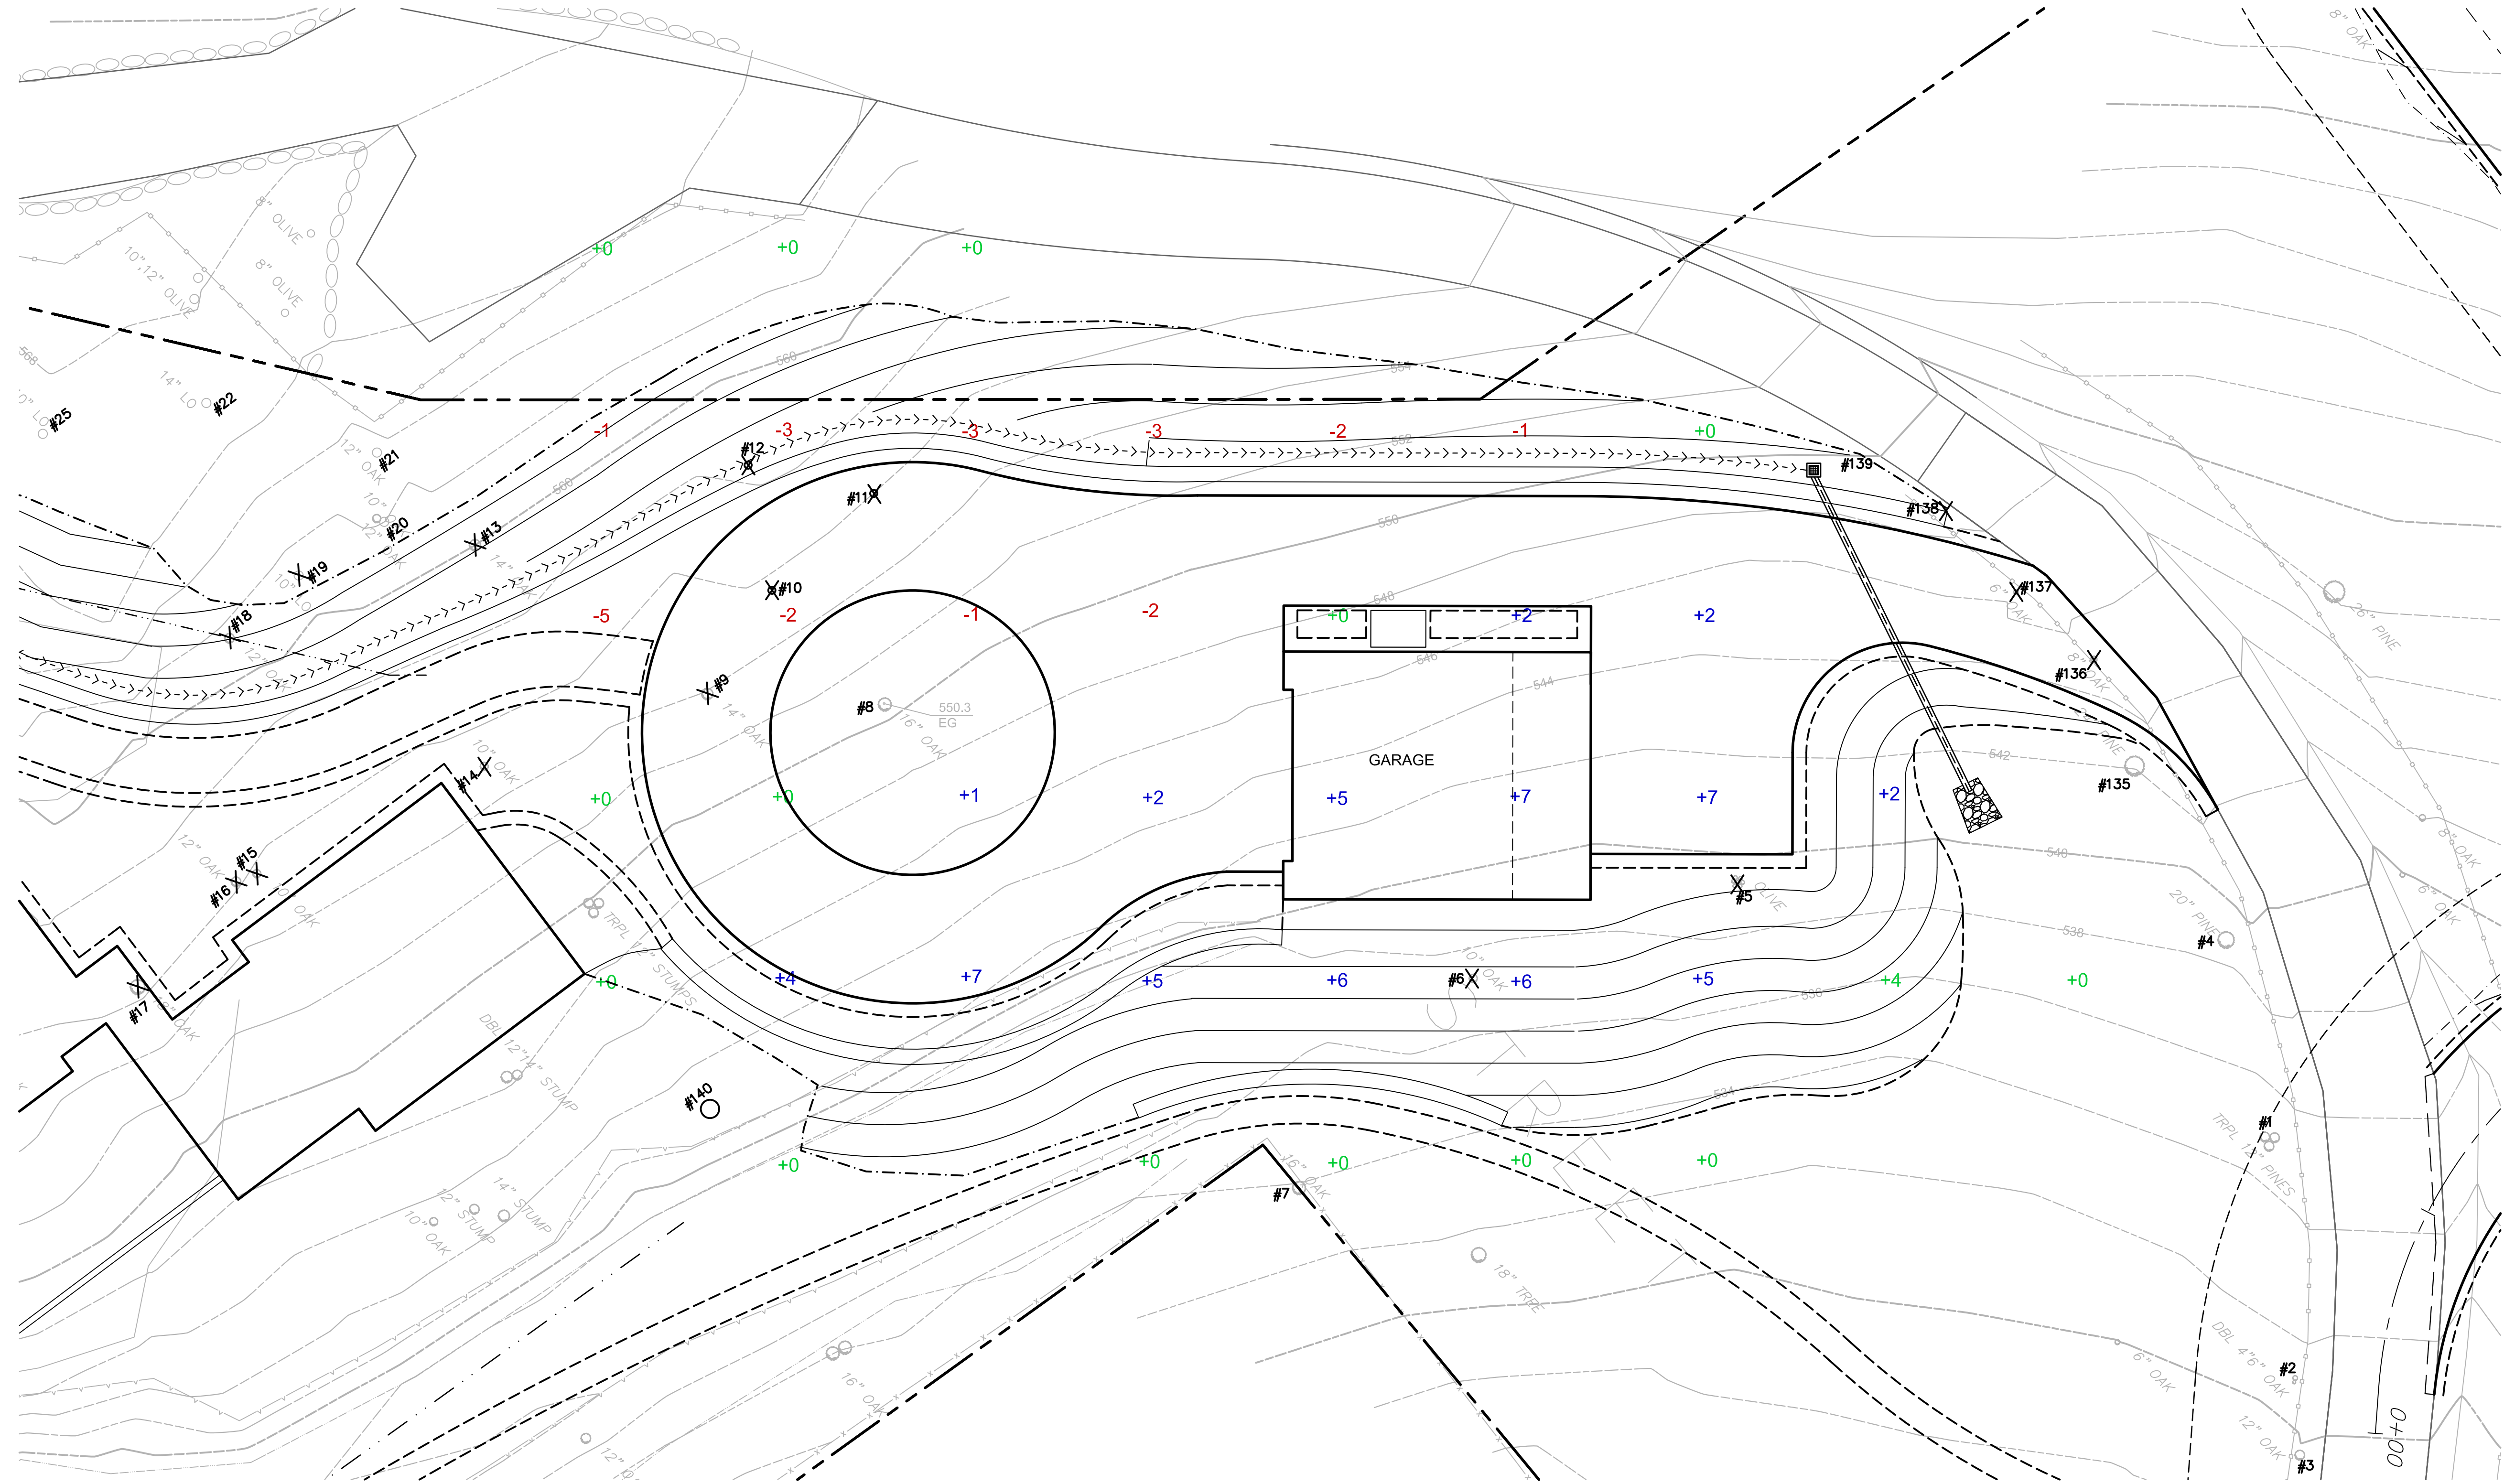

CUT-FILL TICK EXHIBIT

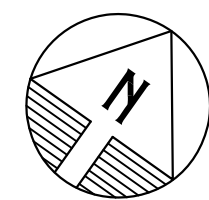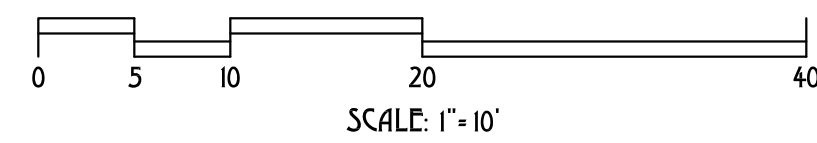


REV	DATE	DESCRIPTION



DATE:	7/28/2017
DESIGN:	CSM
PROJECT:	16002

SHEET
2
OF 2 SHEETS

- DRAINAGE LEGEND**
-  WATERSHED BOUNDARY
 -  WATERSHED LABEL
 -  POINT OF CONCENTRATION
 -  SWL-1 SWALE #1
 -  SD-1 STORM DRAIN #1
 -  OVERLAND FLOW DIRECTION

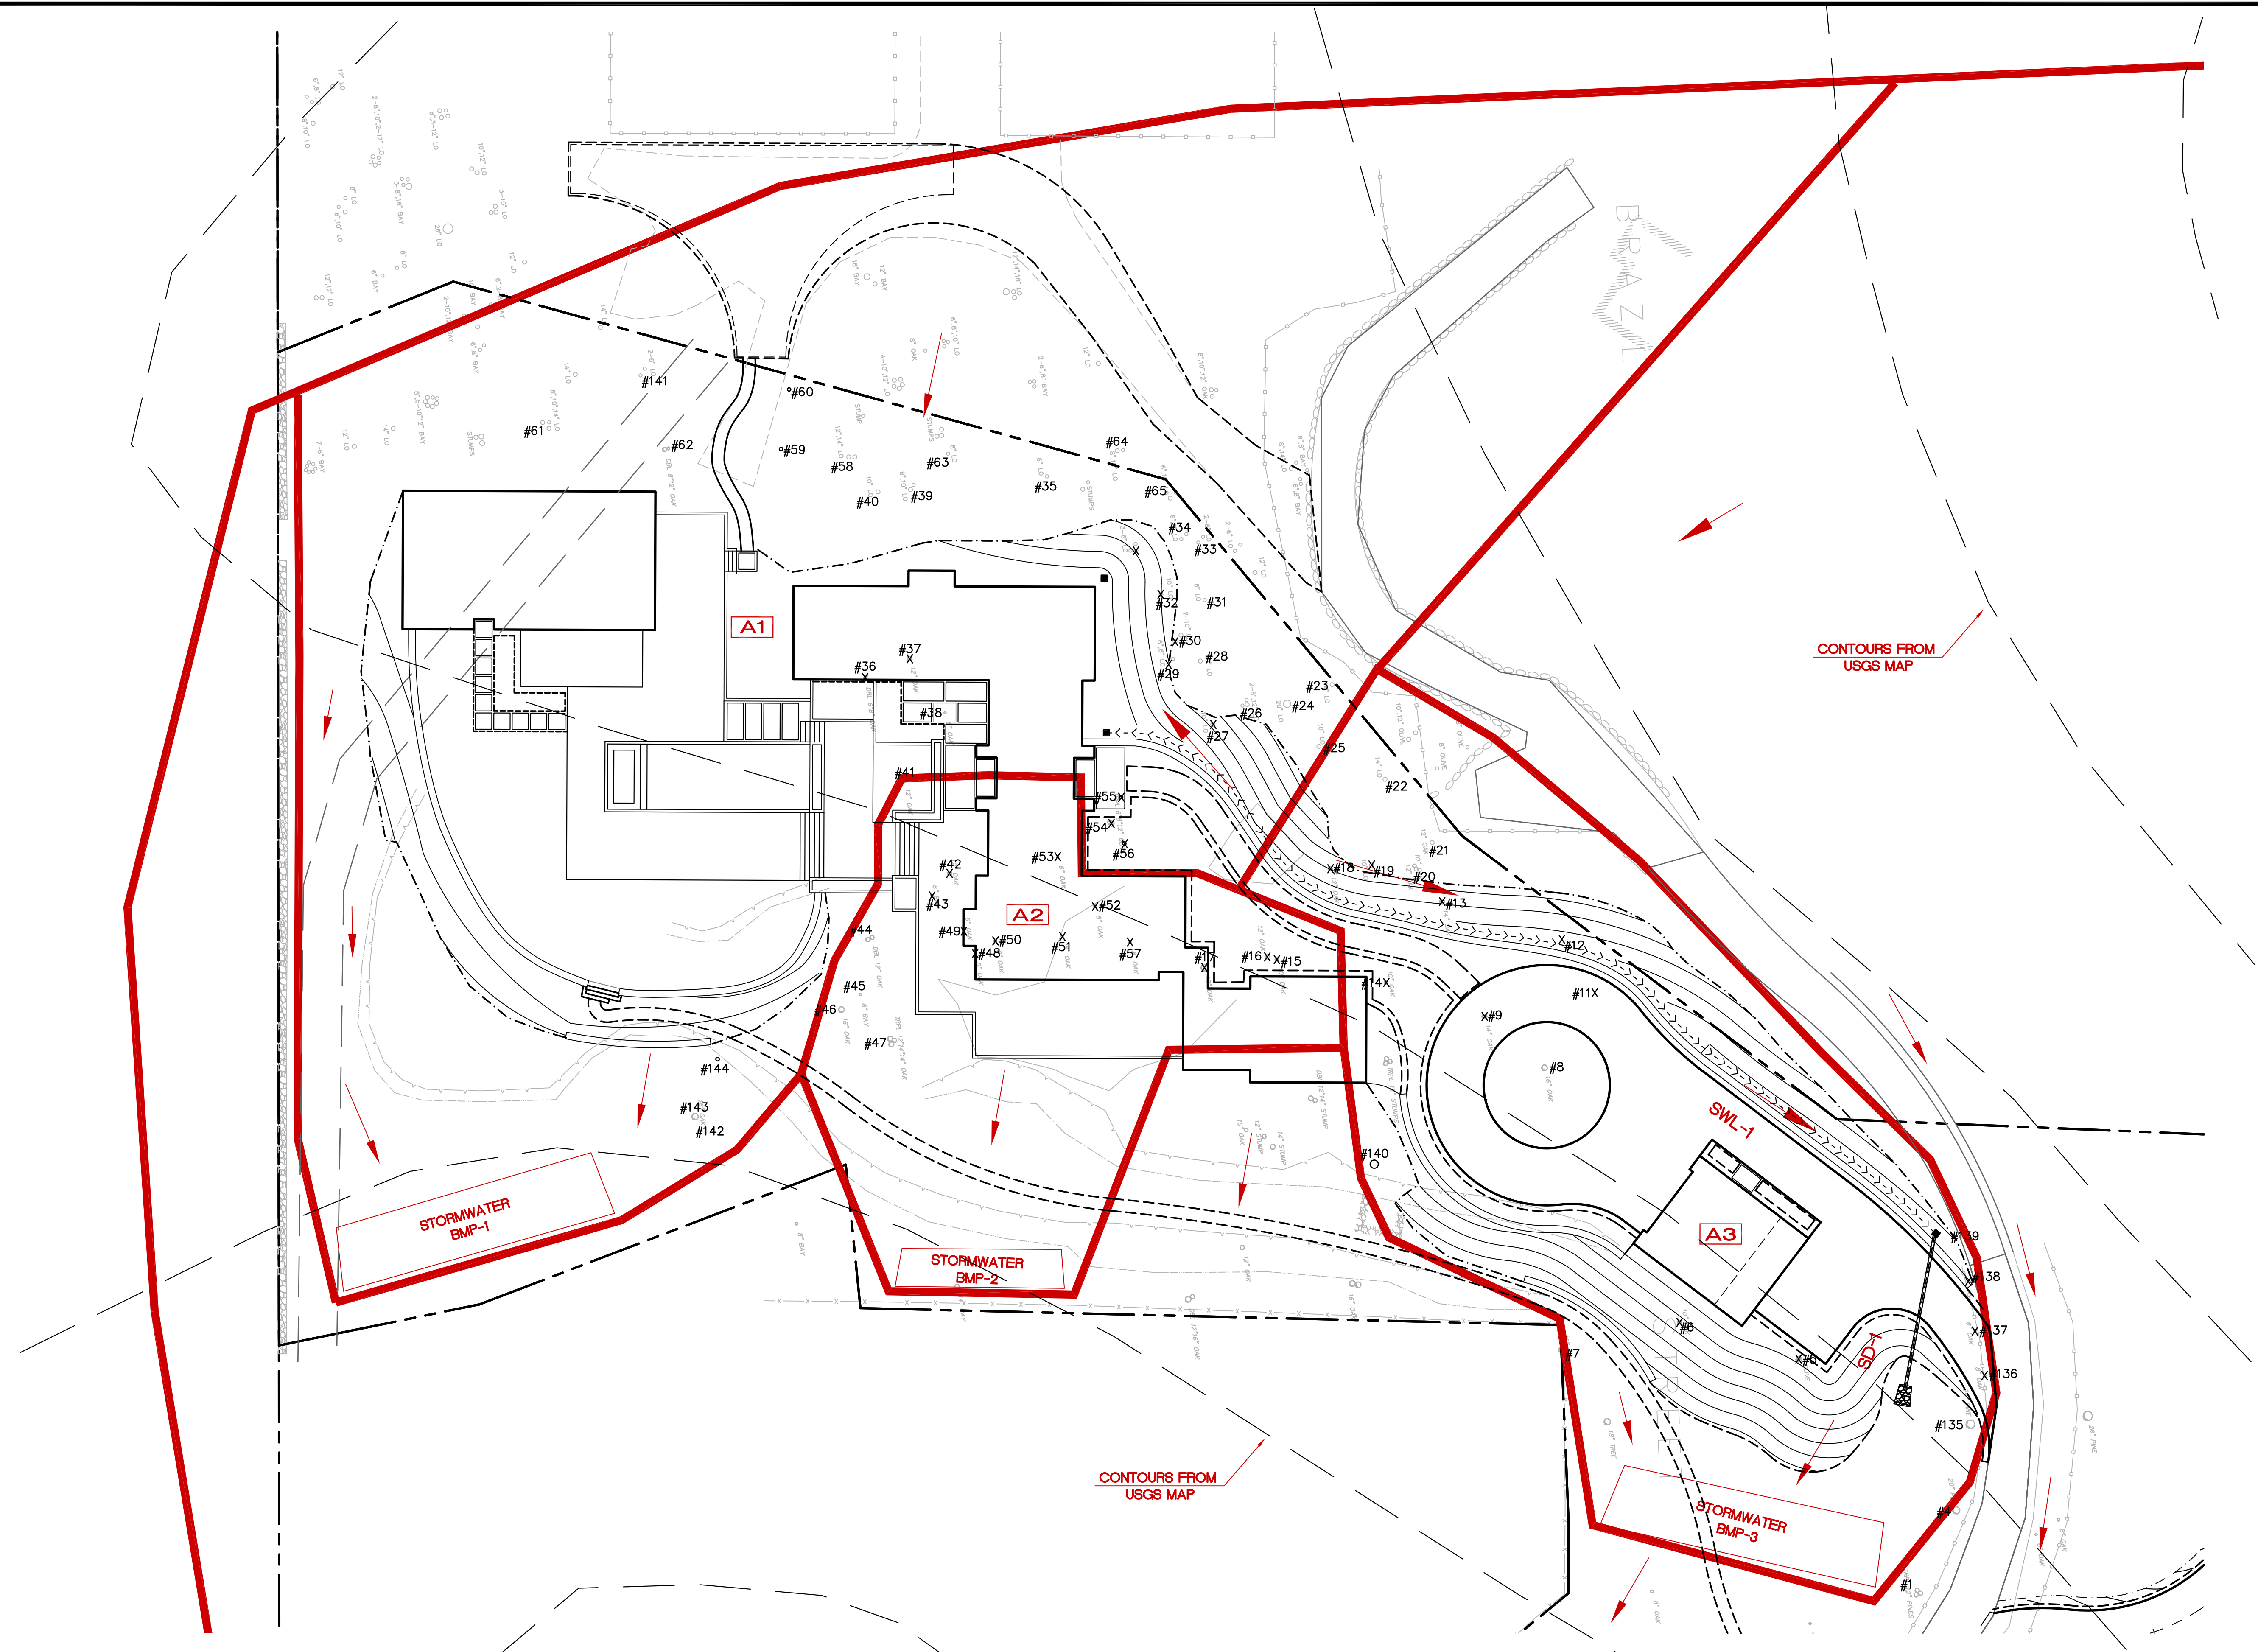

**POST-CONSTRUCTION
HYDROLOGY MAP**

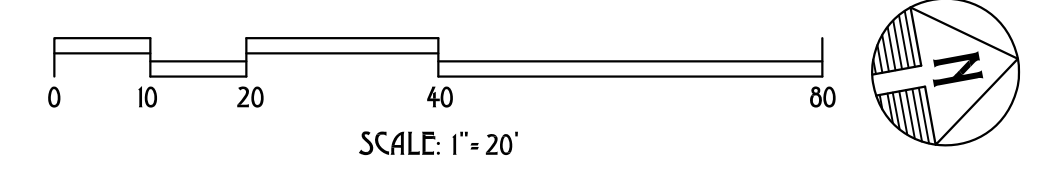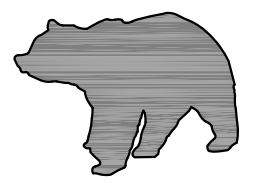
**BEAR FLAG
ENGINEERING, INC**

CIVIL ENGINEERING
LAND DEVELOPMENT
SEPTIC SYSTEM DESIGN
PROJECT MANAGEMENT
SURVEYING
BUILDING DESIGN

PO BOX 2193, SONOMA, CA 95476
PHONE: (707) 481-9472
BEARFLAGCIVIL@GMAIL.COM

**POST-CONSTRUCTION
HYDROLOGY MAP
149 4TH STREET RESIDENCE**

149 4TH STREET EAST, SONOMA, CA
APN: 018-091-018

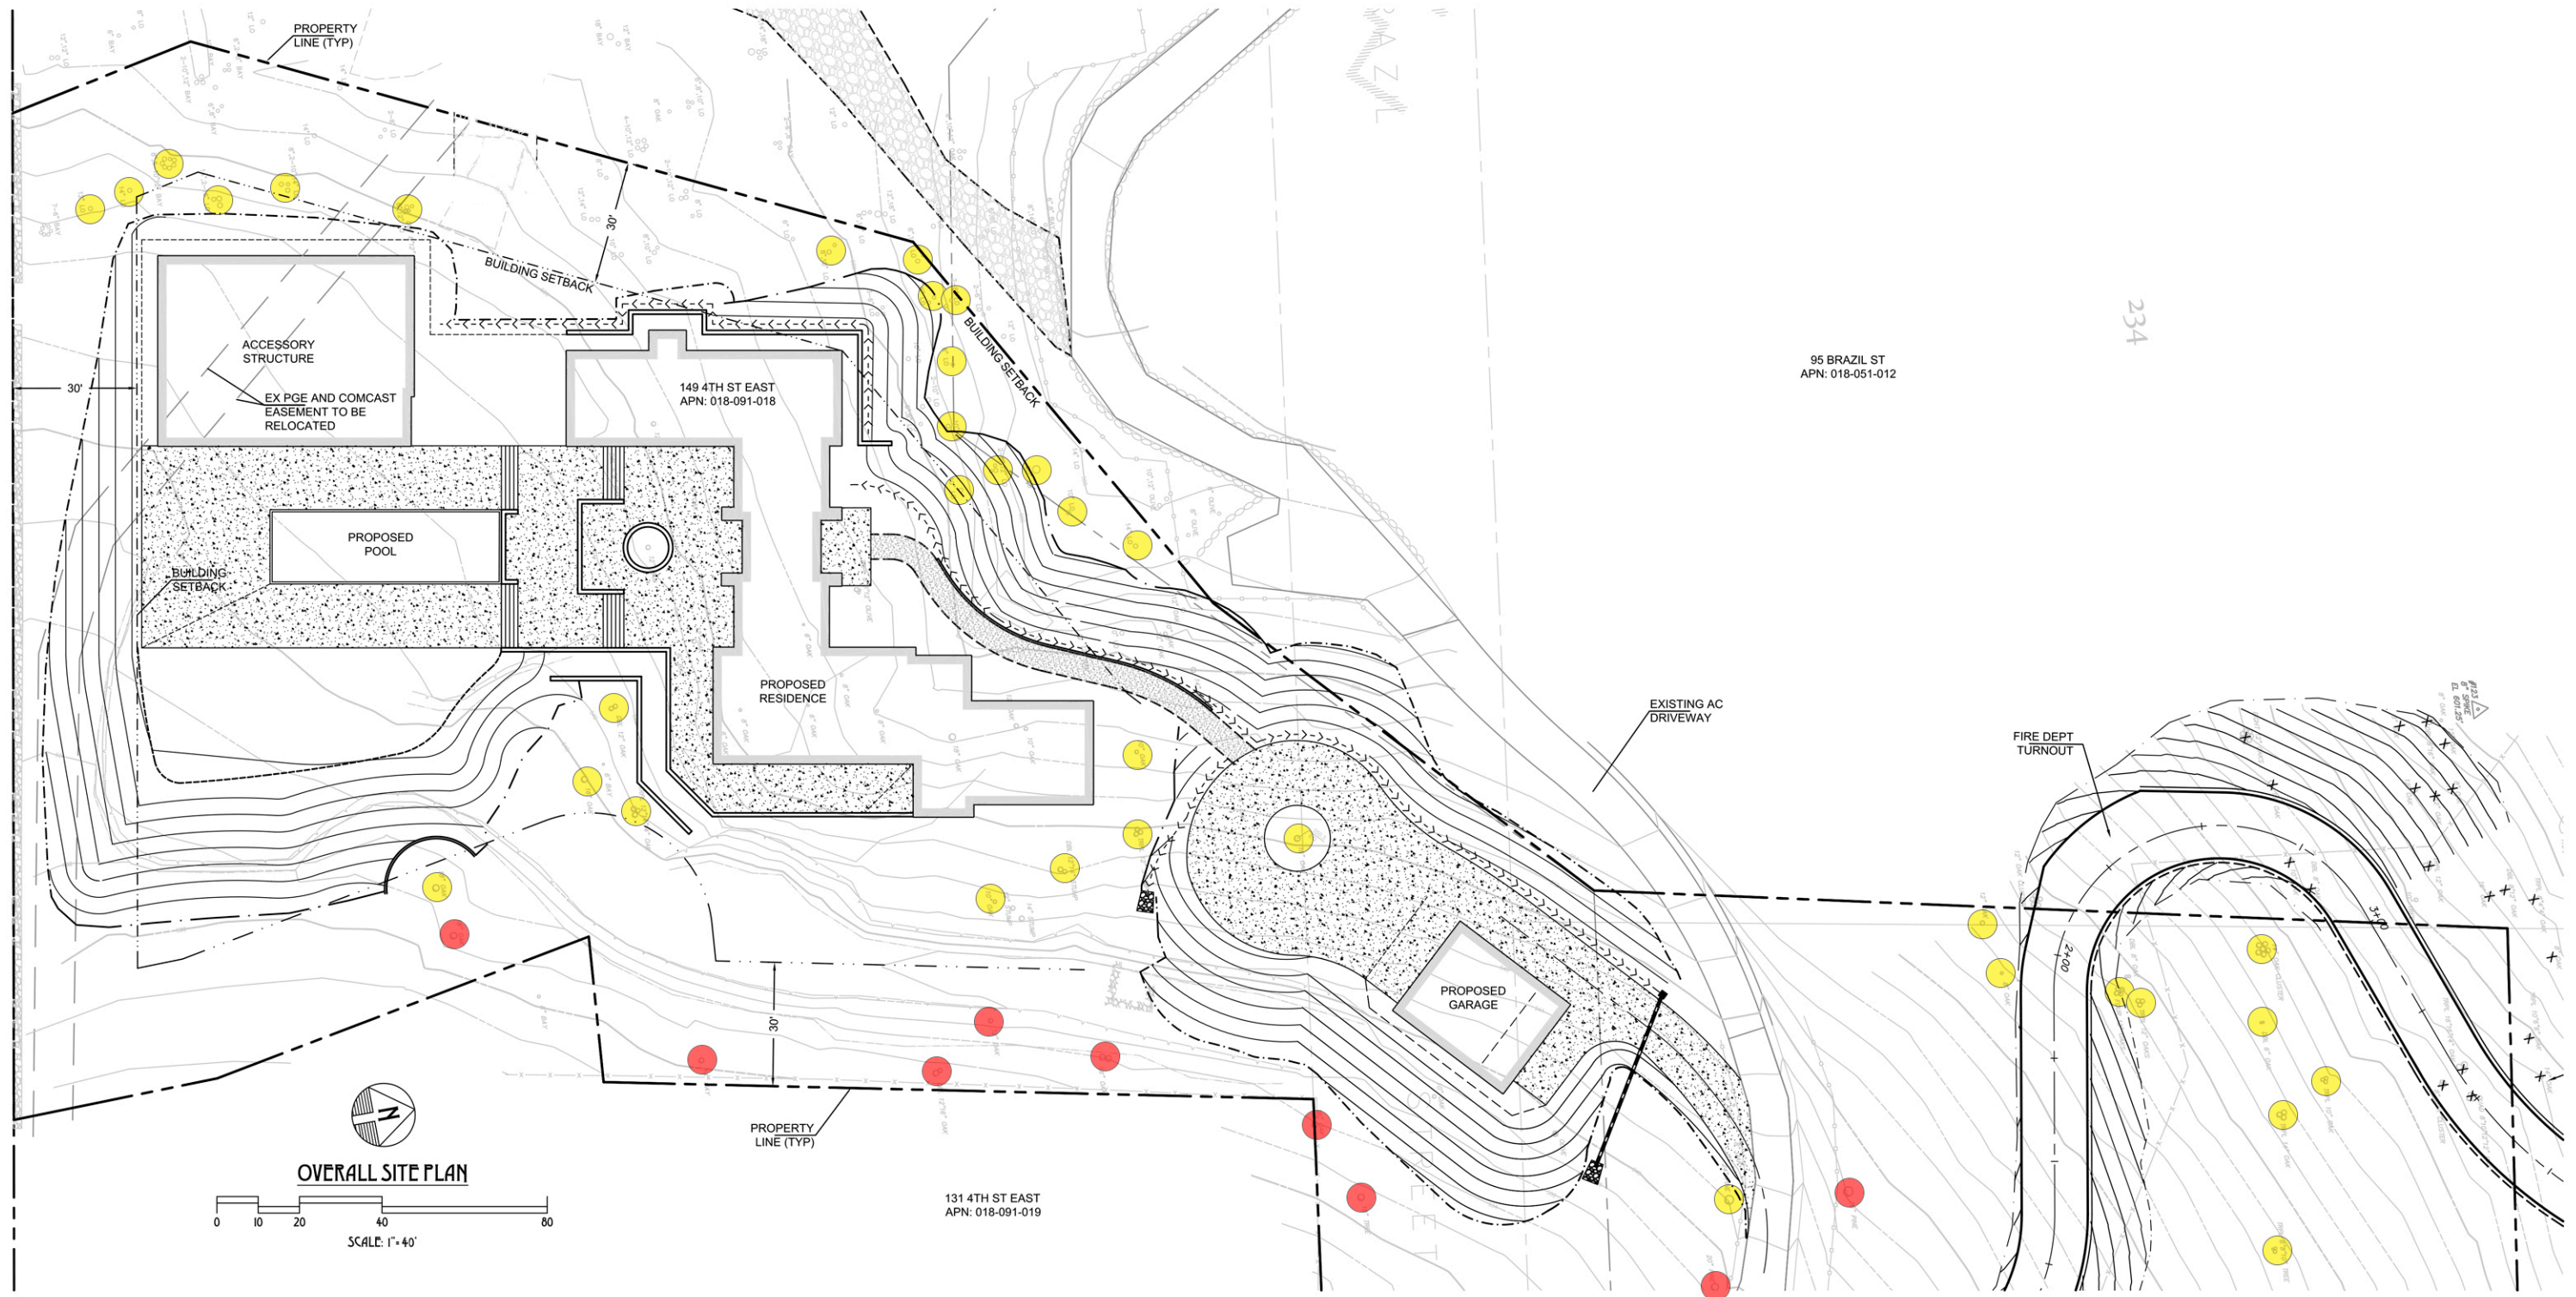

2017.03.29

4th STREET RESIDENCE

TREE DIAGRAM

NICK LEE ARCHITECTURE
 CONTACT:
 NICHOLAS LEE
 807, HAIGHT AVE
 ALAMEDA, CA, 94501
 PH: 415.378.4337

149 4th Street East , Sonoma CA
 APN: 018-091-018

SITE PLAN
 1" = 40'