ABBREVIATIONS

A C A /C	ACDUALT CONCDETE	ODNO	ODENING
A.CA/C	ASPHALT CONCRETE	OPNG.	OPENING
ACOUS.	ACOUSTICAL	OPP.	OPPOSITE
ADJ.	ADJACENT	OPP.HD.	OPPOSITE HAND
ALUM.	ALUMINUM	OZ.	OUNCE
AGG.	AGGREGATE	PERF.	PEFORATED
APPROX.	APPROXIMATE	PL.	PLASTIC
ARCH.	ARCHITECTURAL/ ARCHITECT	P/L	PROPERTY LINE
B.C.	BOTTOM OF CONC./ CURB	PLAS	PLASTER
BLDG.	BUILDING	PLYWD.	PLYWOOD
B.O.	BOTTOM OF	PR.	PAIR
BLK.	BLOCKING/ BLOCK		

BTWN.	BETWEEN
B.U.R.	BUILT-UP ROOF
B.W.	BOTTOM OF WALL
CAB.	CABINET
C.B.	CATCH BASIN
CEM.	CEMENT
CI	CENTERLINE

BEAM

BM.

CENTERLINE CLG. CEILING CMU. CONCRETE MASONRY UNIT CNTL. CONTROL JOINT

C.O. CLEANOUT COL. COLUMN CONC CONCRETE CONT. CONTINUOUS CTR. CENTER DEMO DEMOLITION D.F. DRINKING FOUNTAIN

DIA. DIAMETER DIM. DIMENSIONS DISP DISPENSER DN. DOWN DWGS DRAWINGS

EXISTING EA. EACH ELEC ELECTRICAL ELEV. ELEVATION EQ. EQUAL EQUAL EQUIP EQUIPMENT EX. EXISTING

EXP. **EXPANSION** EXT. EXTERIOR F.D. FLOOR DRAIN FDN. FOUNDATION FINISHED FLOOR FIN. FINISH FL. FLOOR FLR. FLOOR

FNDN. FOUNDATION F.O.C. FACE OF CONCRETE F.O.FRM'G FACE OF FRAMING FACE OF FINISH F.O.F F.O.P FACE OF PLYWOOD F.O.SHT'G. FACE OF SHEATHING

GAUGE GALV. GALVANIZED G.B. GRAB BAR GL. GLASS

GSM. GALVANIZED SHEET METAL GYP. GYPSUM

H.B. HOSE BID H.C. HANDICAPPED HDWE. HARDWARE H.M. HOLLOW METAL HORIZ. HORIZONTAL H.P. HIGH POINT HT. HEIGHT I.D. INSIDE DIAMETER JAN. JANITOR JT. JOINT

LAM. LAMINATE LANDSCAPE ARCHITECT L.ARCH.

LAV. LAVATORY LB. POUND LT. LIGHT MAX. MAXIMUM MECH. MECHANICAL MFR. MANUFACTURER MIN. MINIMUM MISC. MISCELLANEOUS

MTD. MOUNTED MTL. METAL Ν. NORTH NEW

NOT IN CONTRACT N.I.C. NOM. NOMINAL N.T.S. NOT TO SCALE O.C. ON CENTER O.D. OUTSIDE DIAMETER INDIVIDUAL LOT DATA

Required Parking (Stalls)

Private Open Space Proposed (SF)

Private Open Space Required (SF)

	Lot 1	Lot 2	Lot 3	Lot 4
	Single family - Exist.			
Unit Type	house	Single family	Duplex	Duplex
Density: Total Units Proposed	1	1	2	2
Density: Total Units Permitted	1	1.24	2	2.46
Gross Build Area (Residential SF)	530	1,146	2,386	2,386
Proposed Lot Size (SF)	2,292	2,704	4,450	5,391
Minimum Lot Size (SF)	8,000	8,000	8,000	8,000
Proposed Lot Length	45.9'	54.1'	89'	107.8'
Proposed Lot Width	50'	50'	50'	50'
Required Lot Width	N/A	N/A	N/A	N/A
Coverage	29%	29%	40%	35%
FAR (0.6 Max)	0.23	0.42	0.54	0.44
Site Coverage (includes paving)	76%	72%	78%	78%
Proposed Height	17' (Existing)	21'	21'	21'
Max Allowed Height	30'	30'	30'	30'
Proposed Setbacks				
Front	10' (E)	16' (N)	16' (N)	16' (N)
Side	4.25' (S)	9.17' (E)	3' (E)	3' (E)
Side	24' (N)	3' (W)	3' (W)	21.8' (W)
Rear	5.7' (W)	11.25' (S)	11.25' (S)	11.25' (S)
Required Setbacks				
Front	15'	15'	15'	15'
Side	5'	9'	9'	9'
Side	5'	9'	9'	9'
Rear	20'	20'	20'	20'
Proposed Parking (Stalls)	1	1	3	3
			_	

260

150

464

150

916

300

3

916

300

OWNER:

CIVIL

ARCHITECT:

LANDSCAPE:

FIELD LANDSCAPE ARCHITECTS

CHRISYATESDESIGN@GMAIL.COM

T: 415.926.5775

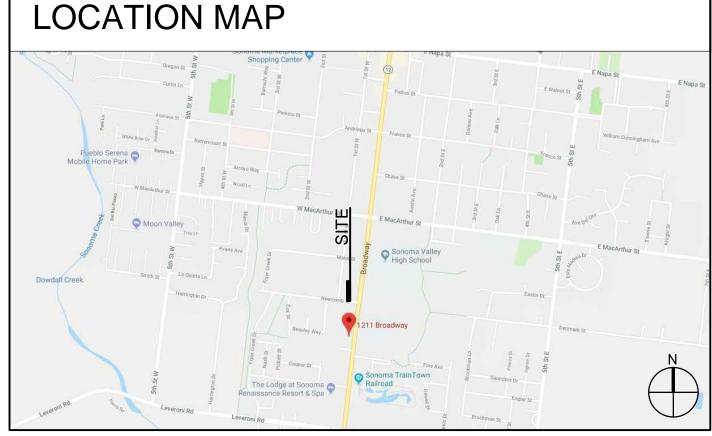
1265 Indiana St, San Francisco, CA 94107

Lot Info	rmation (Entire Lot)	
AP Number	ź	128-181-004
Address	1211 Bi	roadway, Sonoma
ot Area (SF)		14,837
Zoning Inform	mation (Entire Property)	
	Permitted/Req.	Proposed
Zoning	Mixed Use	Residential
Density (20 units per acre permitted)	6.8	6.0
FAR Overall (0.34 acres)	0.6	0.43
Height	30ft	21 ft
	none required due to	1
Affordable Units	lot sub-division	1
Open Space (private)	150 SF per unit	458 sf Typ. per unit
Total open space	900 SF (private)	2,556
Parking		
Lot 1 (single family)	1 stall carport	1 stall (no carport)
Lot 2 (single family)	1 stall carport	1 stall carport
Lot 3 (duplex)	2 carports + 1 stall	2 carports + 1 stall
Lot 4 (duplex)	2 carports + 1 stall	2 carports + 1 stall
Total parking spaces	8	8
Guest	None	None
FAR and C	Coverage Calculations	
-AR		
Level 1 (all structures)	3,582	
Level 2 (all structures)	2,866	0.43
Total	6,448	
Coverage		
Buildings	3,582	
Porch		
Car Port		34%
Garbage Storage	60	
Total	5,112	

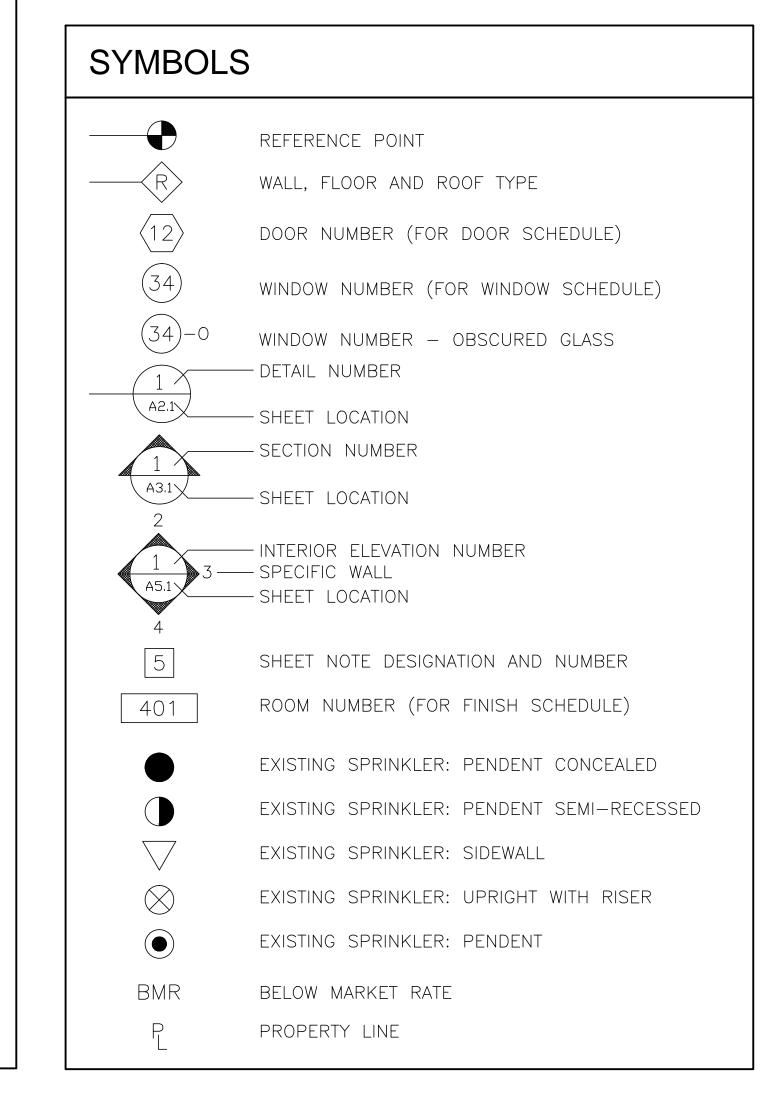
Porch 77% Garbage Storage Paving+Car Port (assumes code definition) 7,648 11,416

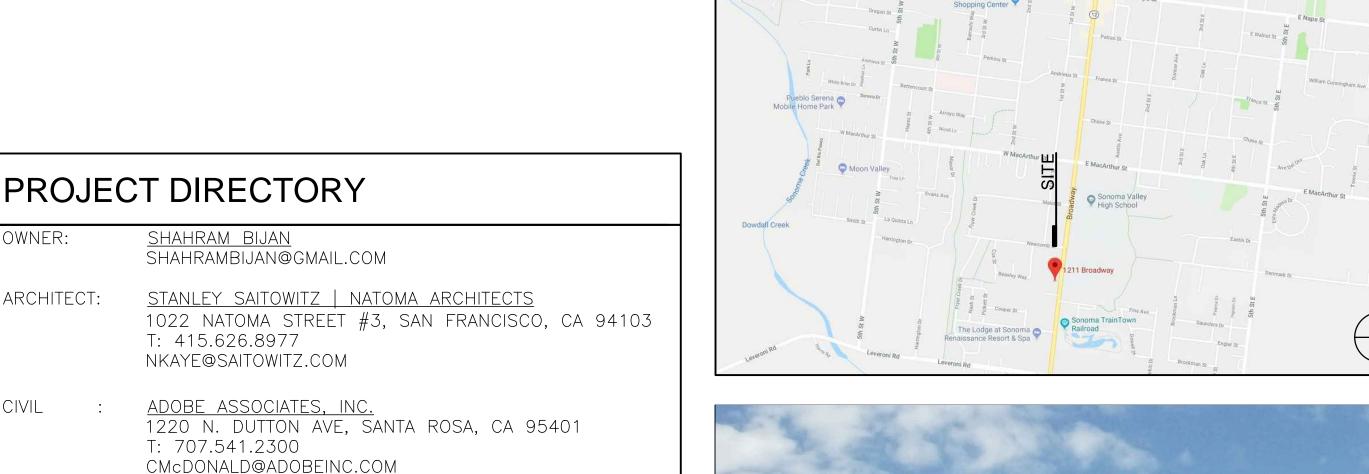
SHEET# SHEET NAME SHEET SCALE N.T.S. TITLE SHEET RENDERING N.T.S. A0.14 CODE ANALYSIS N.T.S. A0.15 SITE PLAN 1/16"=1'-0" 1"= 20' TENTATIVE MAP 1"= 20' EXISTING CONDITIONS MAP 1"= 10' C3.0 GRADING AND DRAINAGE PLAN 1"= 10' C4.0 UTILITY PLAN 3/32"=1'-0" DEMOLITION PLAN 3/32"=1'-0" LOT COVERAGE 3/32"=1'-0" GROUND FLOOR PLAN 3/32"=1'-0" A1.2 LEVEL 2 FLOOR PLAN A1.3 3/32"=1'-0" ROOF PLAN A1.4 UNIT PLANS 1/4"=1'-0" 3/32"=1'-0" A2.1 SECTION 3/32"=1'-0" ELEVATION 3/32"=1'-0" A3.2 ELEVATION 3/16"=1'-0" A3.3 ELEVATIONS SURVEY AS NOTED SCHEMATIC LANDSCAPE PLAN 1/16"=1'-0" 1/16"=1'-0" LIGHTING PLAN IRRIGATION PLAN 1/16"=1'-0" 11.0 12.0 NOTES AND LEGEND WELO CALCULATIONS AND WORKSHEETS N.T.S.

SHEET INDEX









TITLE PAGE

OWNER: SHAHRAM BIJAM

ARCHITECT:

T: 415.902.4212

STANLEY SAITOWITZ

T: 415.626.8977

T: 415.524.0246

ADOBE ASSOCIATES INC

T: 707.541.2300

LANDSCAPE:

ARCHITECTURE

T: 415.926.5775

1220 N. DUTTON AVE SANTA ROSA, CA 95401

CHRISTOPHER YATES LANDSCAPE

1265 INDIANA ST, SAN

RANCISCO, CA 94107

STRUCTURAL: DESIGN EVEREST

NATOMA ARCHITECTS INC.

425 1ST ST, 4904 SAN FRANCISCO, CA 94105

022 NATOMA STREET, NO.

SAN FRANCISCO, CA 94103

PLANNING 05/23/19 DATE: SCALE:

SS|NAI DRAWN: SHEET NO.



OWNER: SHAHRAM BIJAM
T: 415.902.4212

ARCHITECT:
STANLEY SAITOWITZ |
NATOMA ARCHITECTS INC.
1022 NATOMA STREET, NO. 3
SAN FRANCISCO, CA 94103
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ARCHITECTURE
1265 INDIANA ST, SAN
FRANCISCO, CA 94107
T: 415.926.5775

1211 BROADWAY

RENDERING

PLANNING

ATE: 05/23/19

SCALE: NTS

ORAWN: SSINAI

SHEET NO.

LEGEND

NON RATED WALL, PER TYPE V-B, R-3, CBC TBL 601, TBL 602 NOTE H

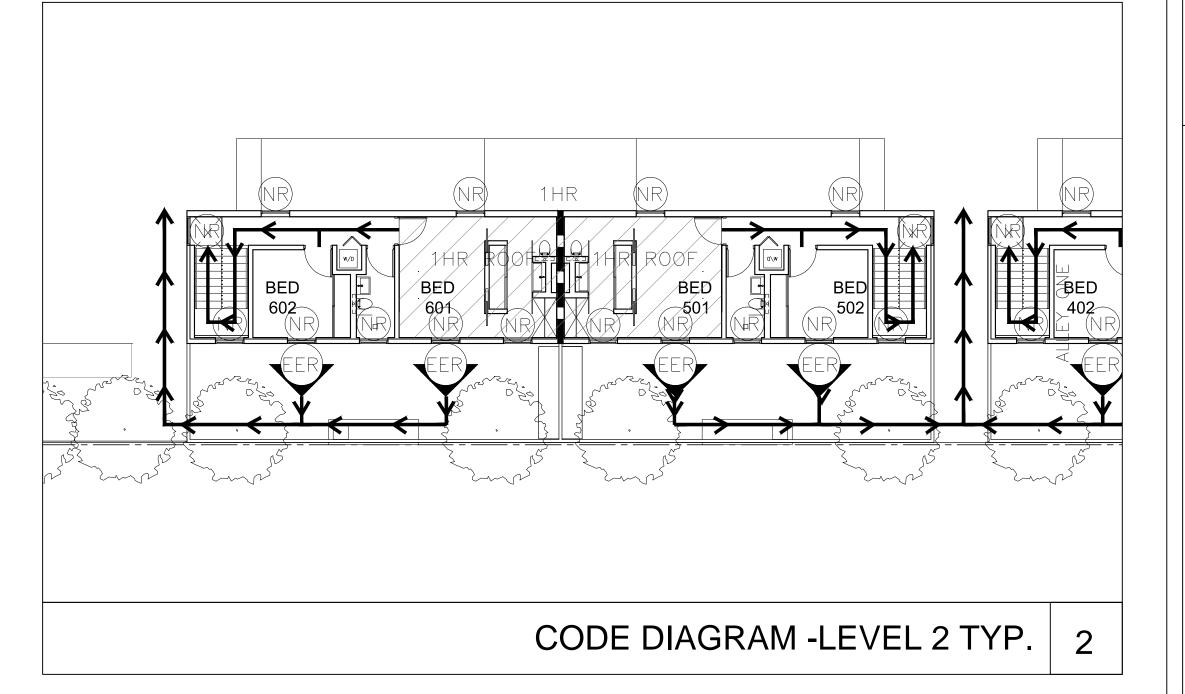
NON RATED WINDOW OR EXTERIOR DOOR PER TYPE V-B, R-3, CBC TBL 601, TBL 602 NOTE H

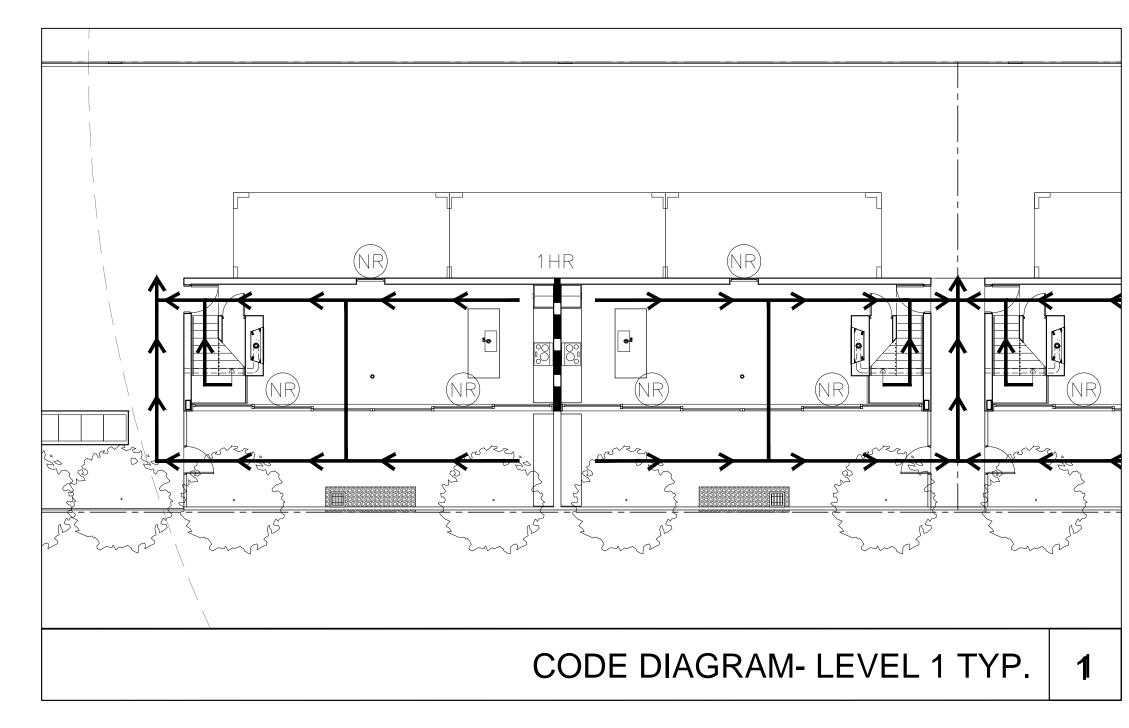
EXIT PATH

EMERGENCY ESCAPE AND RESCUE WINDOW OR DOOR, CBC 1030

CODE DIAGRAM - LEGEND

3





CODE ANALYSIS

| 4 |

OWNER:
SHAHRAM BIJAM
T: 415.902.4212

ARCHITECT:
STANIES SAITOWITZ

ARCHITECT:

STANLEY SAITOWITZ |

NATOMA ARCHITECTS INC.

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LANDSCAPE:
CHRISTOPHER YATES LANDSCAPE
ARCHITECTURE
1265 INDIANA ST, SAN

FRANCISCO, CA 94107 : 415.926.5775

CODE ANALYSIS

SET: PLANNING
DATE: 05/23/19

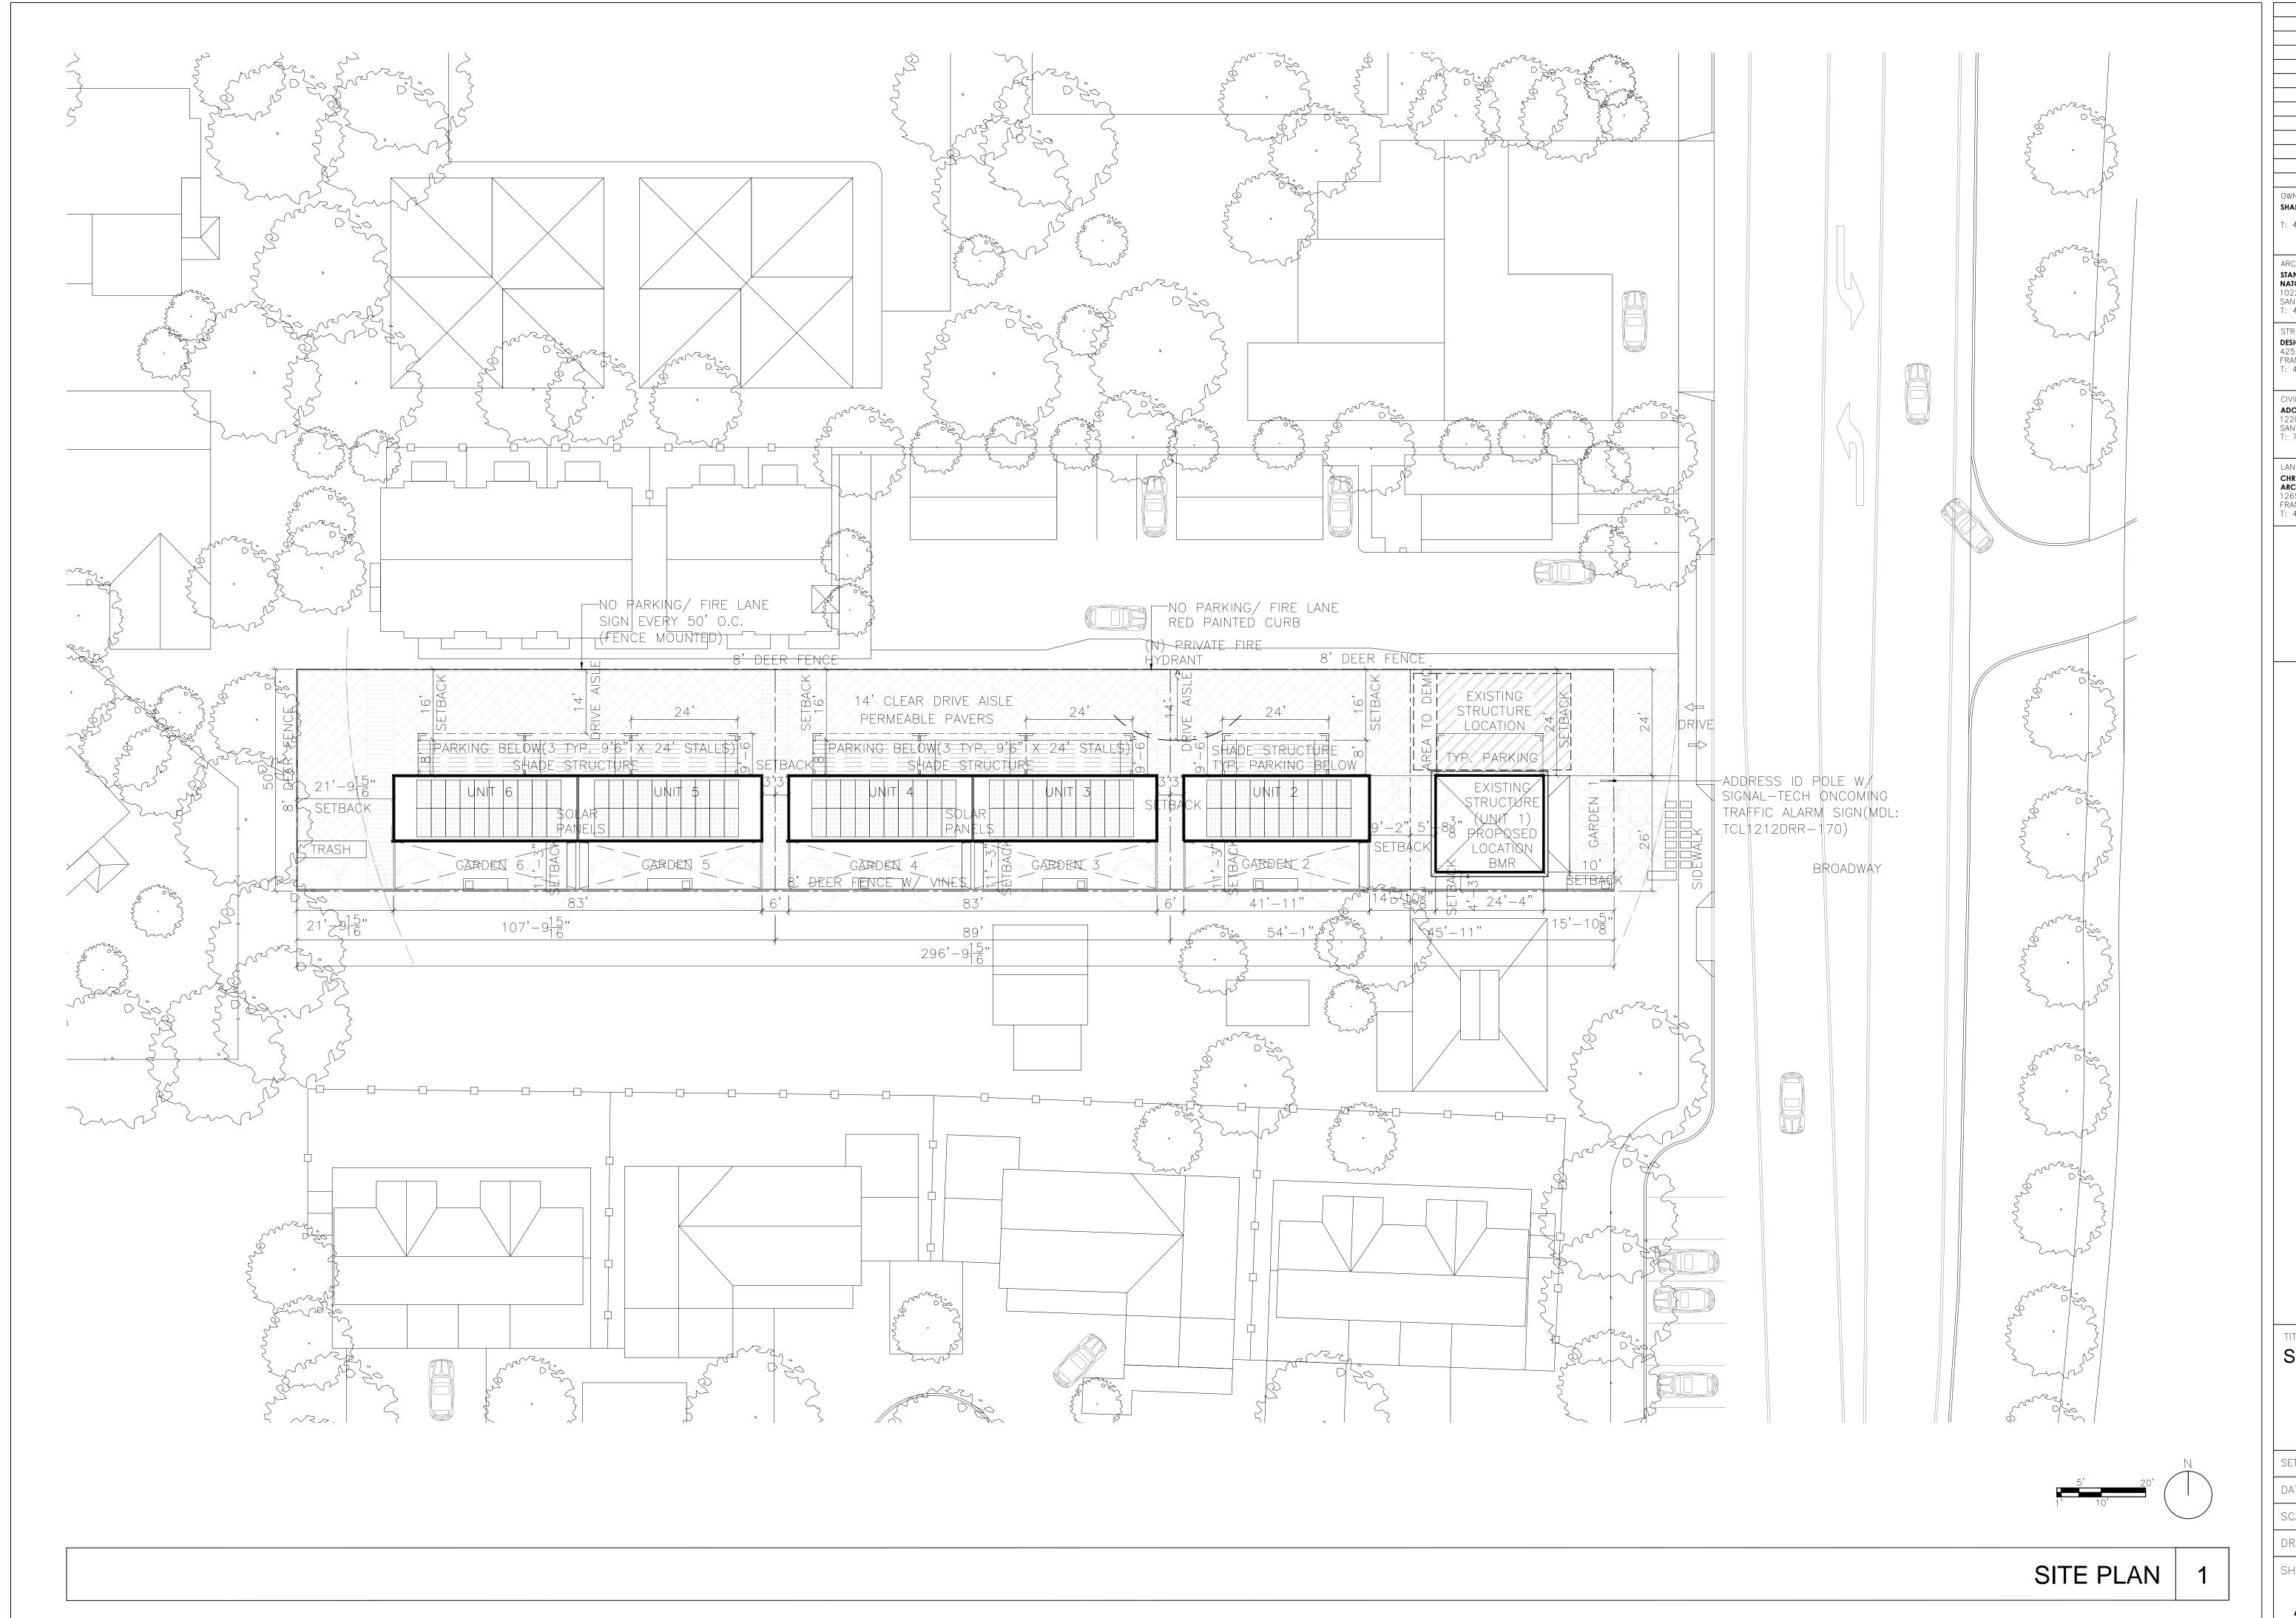
SCALE: 1/16"=1'-0"

DRAWN: SSINAI

OCUPYRICHI STANLEY SAITOW

COPYRIGHT STANLEY SAITOWIT NATIONAL ARCHITECTS INC.

8.0A



OWNER:
SHAHRAM BIJAM
T: 415.902.4212

ARCHITECT:
STANLEY SAITOWITZ |
NATOMA ARCHITECTS I
1022 NATOMA STREE

ARCHITECT:

STANLEY SAITOWITZ |

NATOMA ARCHITECTS INC.

1022 NATOMA STREET, NO. 3

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FRANCISCO, CA 94107
T: 415.926.5775

11 BROADWAY, SONOMA, CA, 95476

SITE PLAN

SET: PLANNING
DATE: 05/23/19

SCALE: 1/16"=1'-0"

DRAWN: SSINAI
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ONATOMA ARCHITECTS INC.

SHEET NO.

SHAHRAM BIJAN 1211 BROADWAY SONOMA, CALIFORNIA 95476

SUBDIVIDER

SHAHRAM BIJAN 1211 BROADWAY SONOMA, CALIFORNIA 95476

ARCHITECT

STANLEY SAITOWITZ | NATOMA ARCHITECTS INC. 1022 NATOMA STREET, NO. 3 SAN FRANCISCO, CALIFORNIA 94103 PHONE: (415) 626-8977 FAX: (415) 626-8978

ENGINEER

TIM SCHRAM, RCE 67890 ADOBE ASSOCIATES, INC. 1220 N DUTTON AVENUE SANTA ROSA, CALIFORNIA 95401 PHONE: (707) 541-2300 FAX: (707) 541-2301

SURVEYOR

AARON SMITH, PLS 7901 ADOBE ASSOCIATES, INC. 1220 N DUTTON AVENUE SANTA ROSA, CALIFORNIA 95401 PHONE: (707) 541-2300 FAX: (707) 541-2301

BENCHMARK

FOUND CALTRANS RIVET #1162 ON TOP OF CURB. ELEV = 59.26LOCATION PER PLAN.

LEGEND

PROPOSED	EXISTING	<u>DESCRIPTION</u>
		PROPERTY BOUNDARY
SSMH		SANITARY SEWER & MANHOLE
•	—_SS	SANITARY SEWER & CLEANOUT
		STORM DRAIN & MANHOLE
	SD	STORM DRAIN & DRAINAGE INLET (
		STORM DRAIN & AREA DRAIN (AD)
		ROOF DRAIN & DOWN SPOUT (DS)
——⊠—₃	- - -	WATER SERVICE / WM
		WATER MAIN & GATE/WATER VALVE
		FIRE HYDRANT WITH BOLLARDS
		DAYLIGHT LINE
		APPROXIMATE LIMIT OF GRADING/DISTURBANCE
320	320	- INDEX CONTOUR
	—— <i>319</i> ——	INTERMEDIATE CONTOUR
GB 		GRADE BREAK W/ SLOPE SYMBOL

ABBREVIATIONS

<u> </u>	DIVENTATIONS		
AAI AB AC APN BC BLDG BM CB CC CO CO DI DWG EC EG EP EL ESMT EX FL	ADOBE ASSOCIATES, INC. AGGREGATE BASE ASPHALT CONCRETE AREA DRAIN ASSESSOR PARCEL NUMBER	MAX ME MH MIN NTS NO PA PCC PL PPC PUE RCE RCWL S SAD SFH	MAXIMUM MATCH EXISTING MANHOLE MINIMUM NOT TO SCALE NUMBER PLANTING AREA POINT OF COMPOUND CUR PROPERTY LINE POWER POLE POINT OF REVERSE CURVE PUBLIC UTILITY ESMT REGISTERED CIVIL ENGINEE REINFORCED CONCRETE PI RECLAIMED WATER LINE SLOPE SEE ARCHITECTURAL DRAWINGS STORM DRAIN SINGLE FAMILY HOME SEE LANDSCAPE PLANS SANITARY SEWER STATION
FΗ	FIRE HYDRANT	TC	TOP OF CURB
FS	FINISHED SURFACE	TYP	ITPICAL

VERTICAL CURVE VERIFY IN FIELD

W WATER

WM WATER METER

WV WATER VALVE

LOT SIZE SUMMARY

FSS FIRE SAFE STANDARD GB GRADE BREAK

HANDICAP IG INVERT GRADE

GR GRATE

<u> </u>		<u> </u>	<u> </u>	/ I I V I / \ I
EXISTING L	OT S	ΙZΕ	-	14,837 SF
PROPOSED	LOT	1	SIZE	2,292 SF
PROPOSED	LOT	2	SIZE	2,704 SF
PROPOSED	LOT	3	SIZE	4,450 SF
PROPOSED	LOT	4	SIZE	5,391 SF

TENTATIVE MAP 1211 BROADWAY

1211 BROADWAY


Sonoma, California

APN 128-181-004



LOCATION MAP

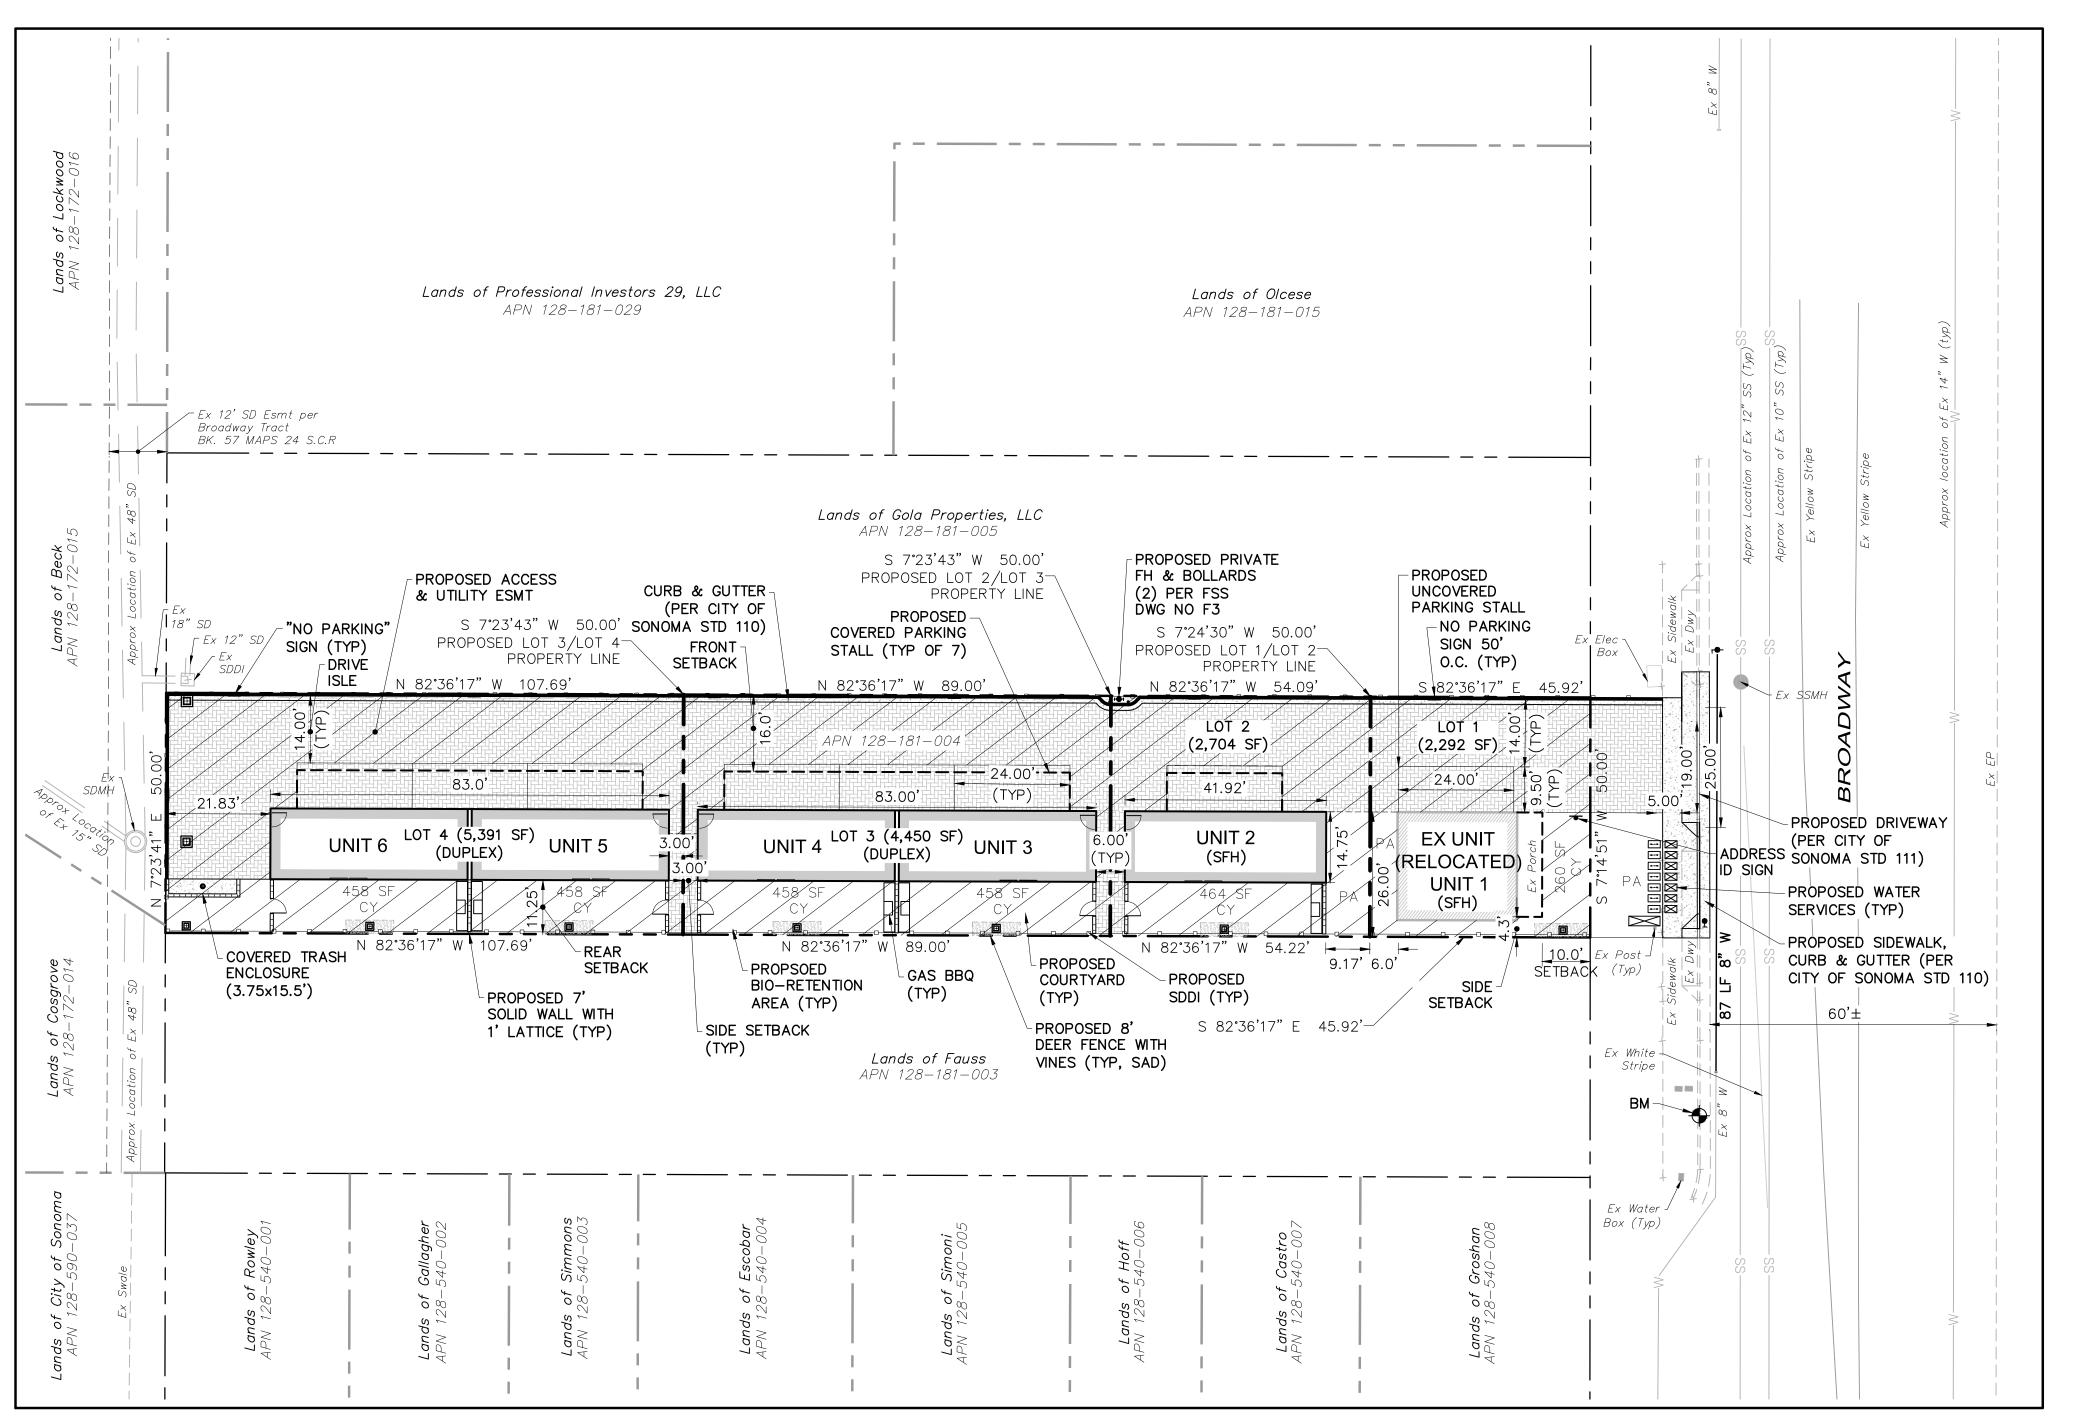NOT TO SCALE




GRADING QUANTITIES:

Site Grading is based upon subgrade to existing grade. No account has been taken for strippings, expansion or contraction. Volumes should be verified and determined independently by the contractor.

<u>CUT</u> <u>FILL</u> <u>TOTAL</u> <u>NET</u> <u>BASE ROCK</u> 415 CY 88 CY 503 CY -327 CY 160 CY

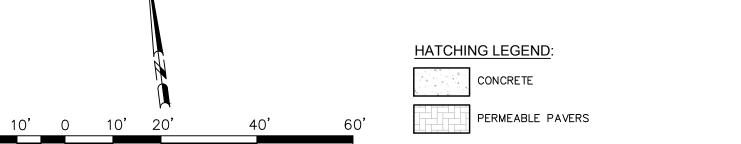Excess material to be off-hauled to an approved location or placed onsite under the direction of the project Soils Engineer. Earth materials placed onsite not shown on these plans may require revisions(s) to the grading permit. Area of Disturbance = 0.37 Acres



OVERALL SITE PLAN

Graphic Scale: 1" = 20'

SHEET INDEX

TENTATIVE MAP OVERALL SITE PLAN EXISTING CONDITIONS MAP GRADING & DRAINAGE PLAN UTILITY PLAN

SHEET NO.

STANLEY SAITOWITZ


ADDRESS:

NATOMA ARCHITECTS INC.

022 NATOMA STREET, NO. 3 SAN FRANCISCO, CA 94103

COMMISSION 05/23/19

SS|NAI DRAWN

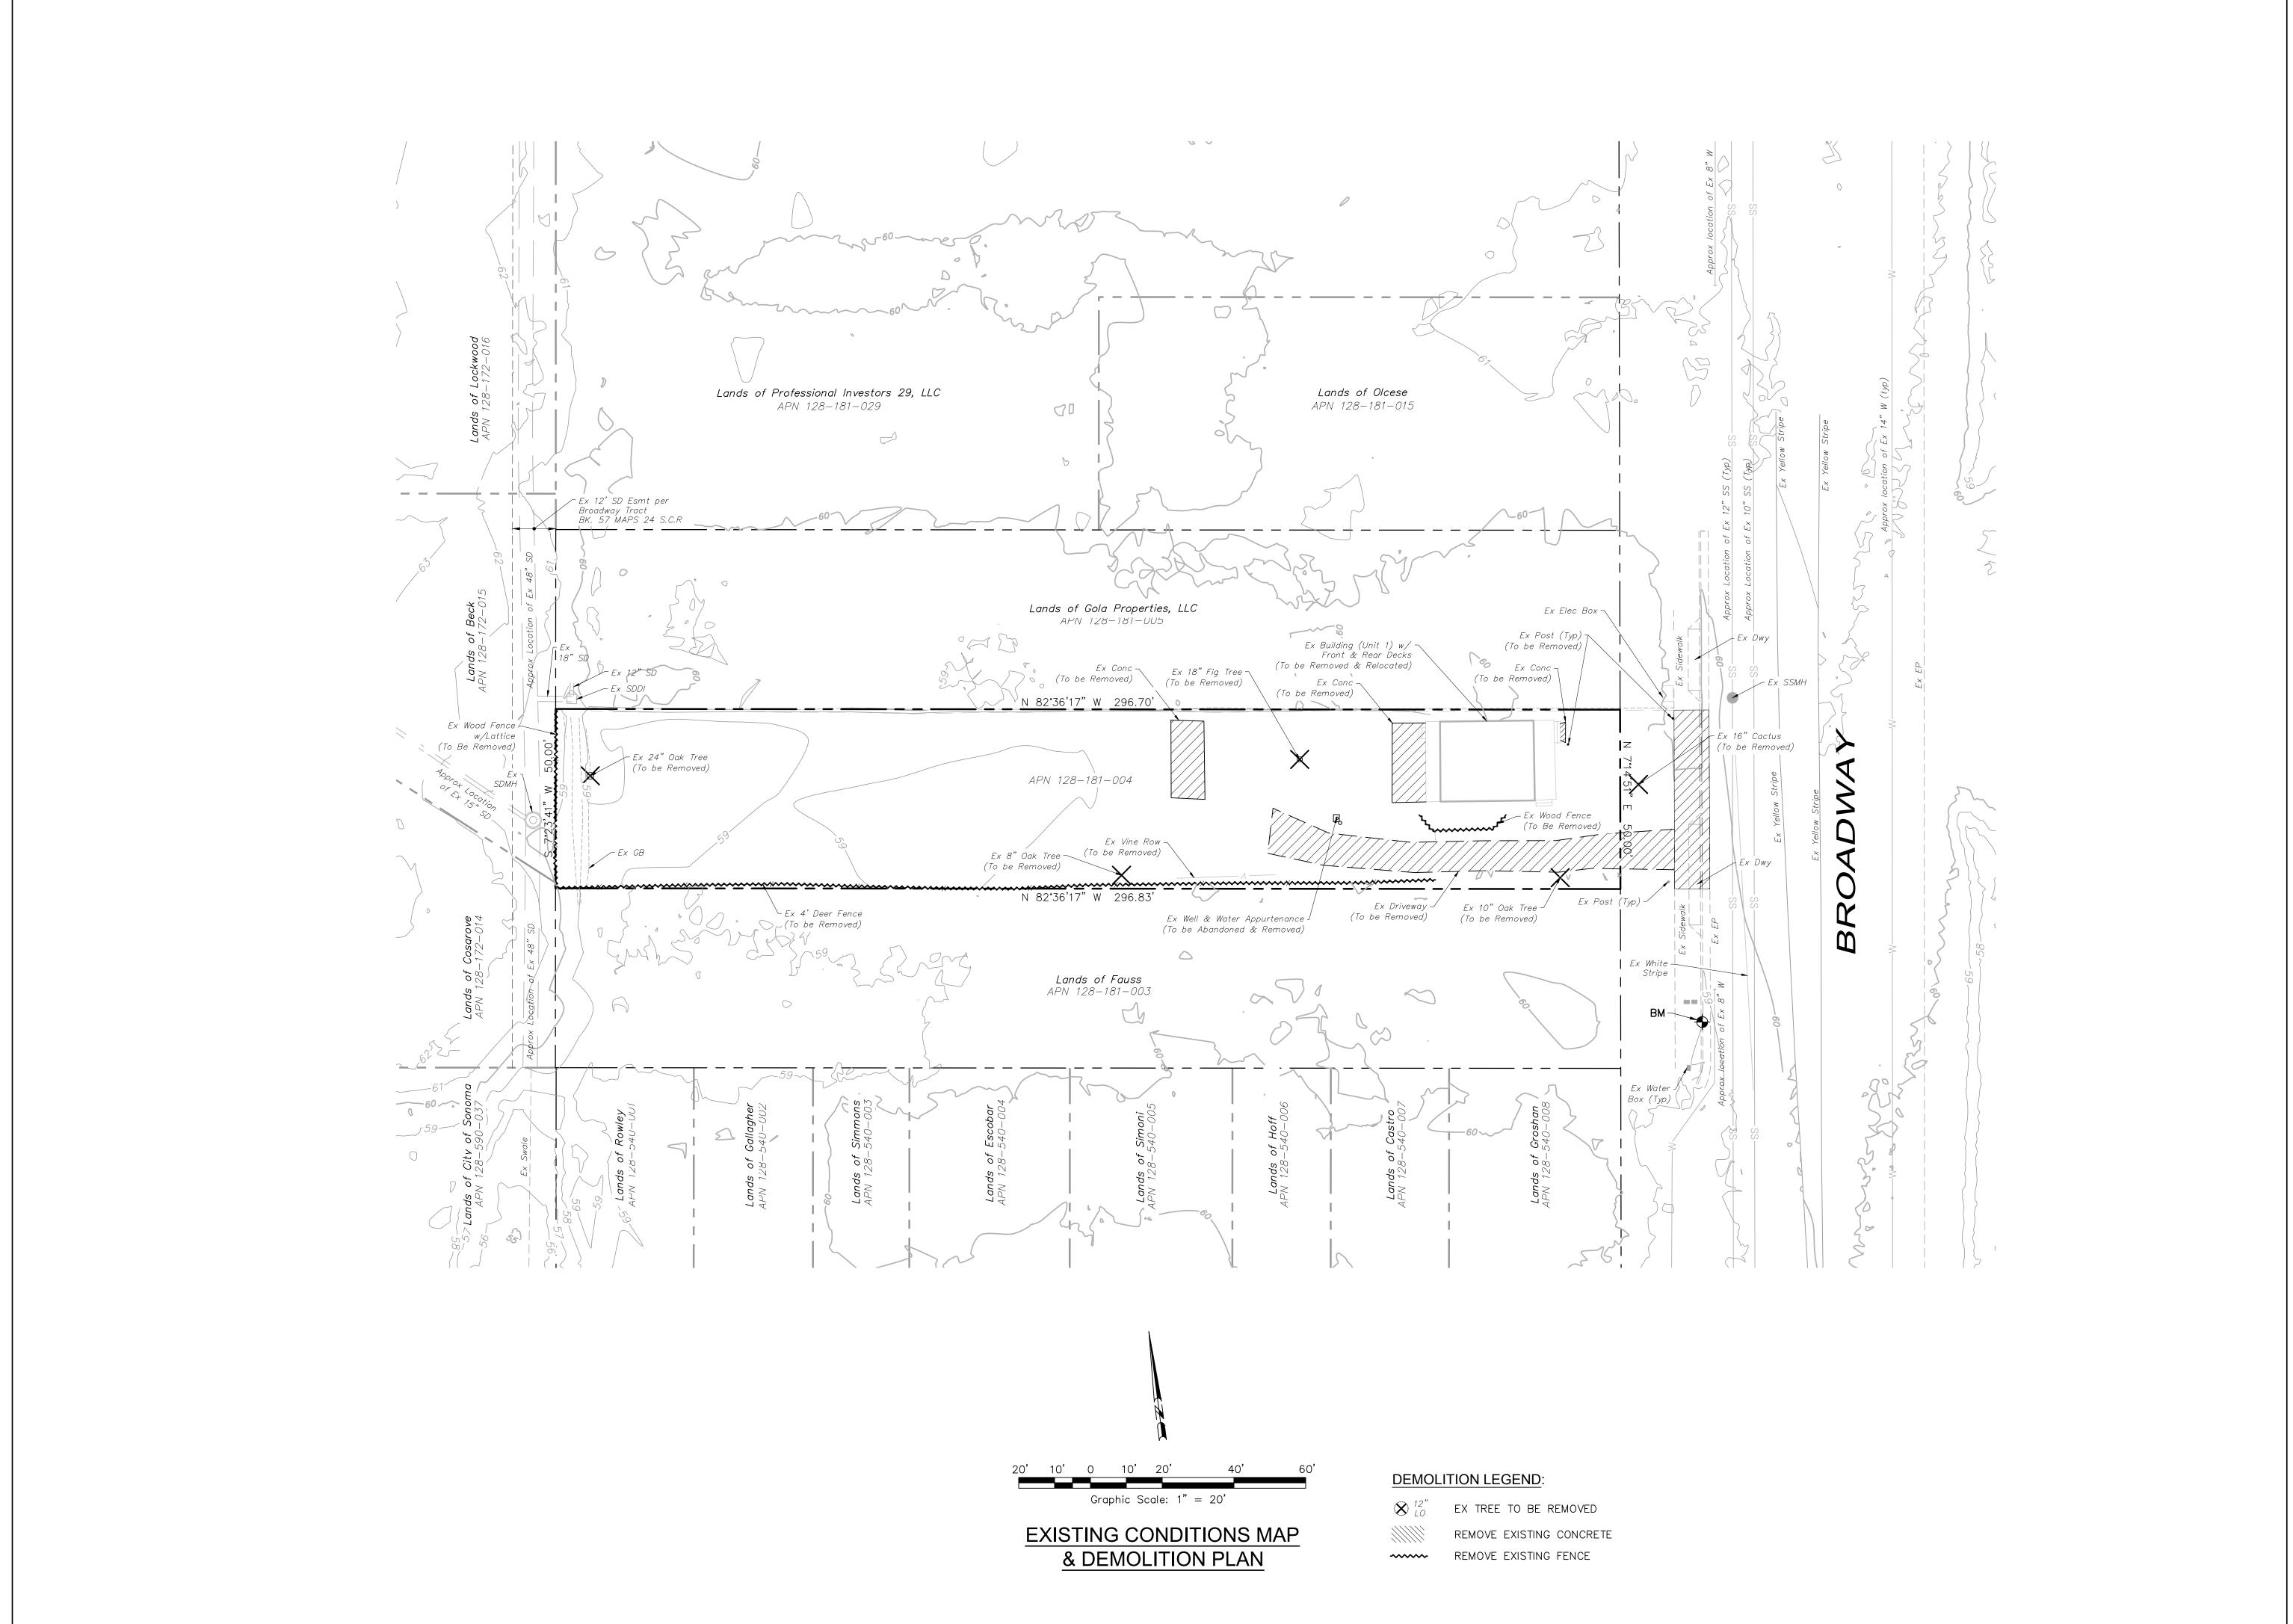

OWNER: **N/A** ADDRESS:

STANLEY SAITOWITZ NATOMA ARCHITECTS INC. 1022 NATOMA STREET, NO. 3 SAN FRANCISCO, CA 94103 T: 415.626.8977

STRUCTURAL: ADDRESS:

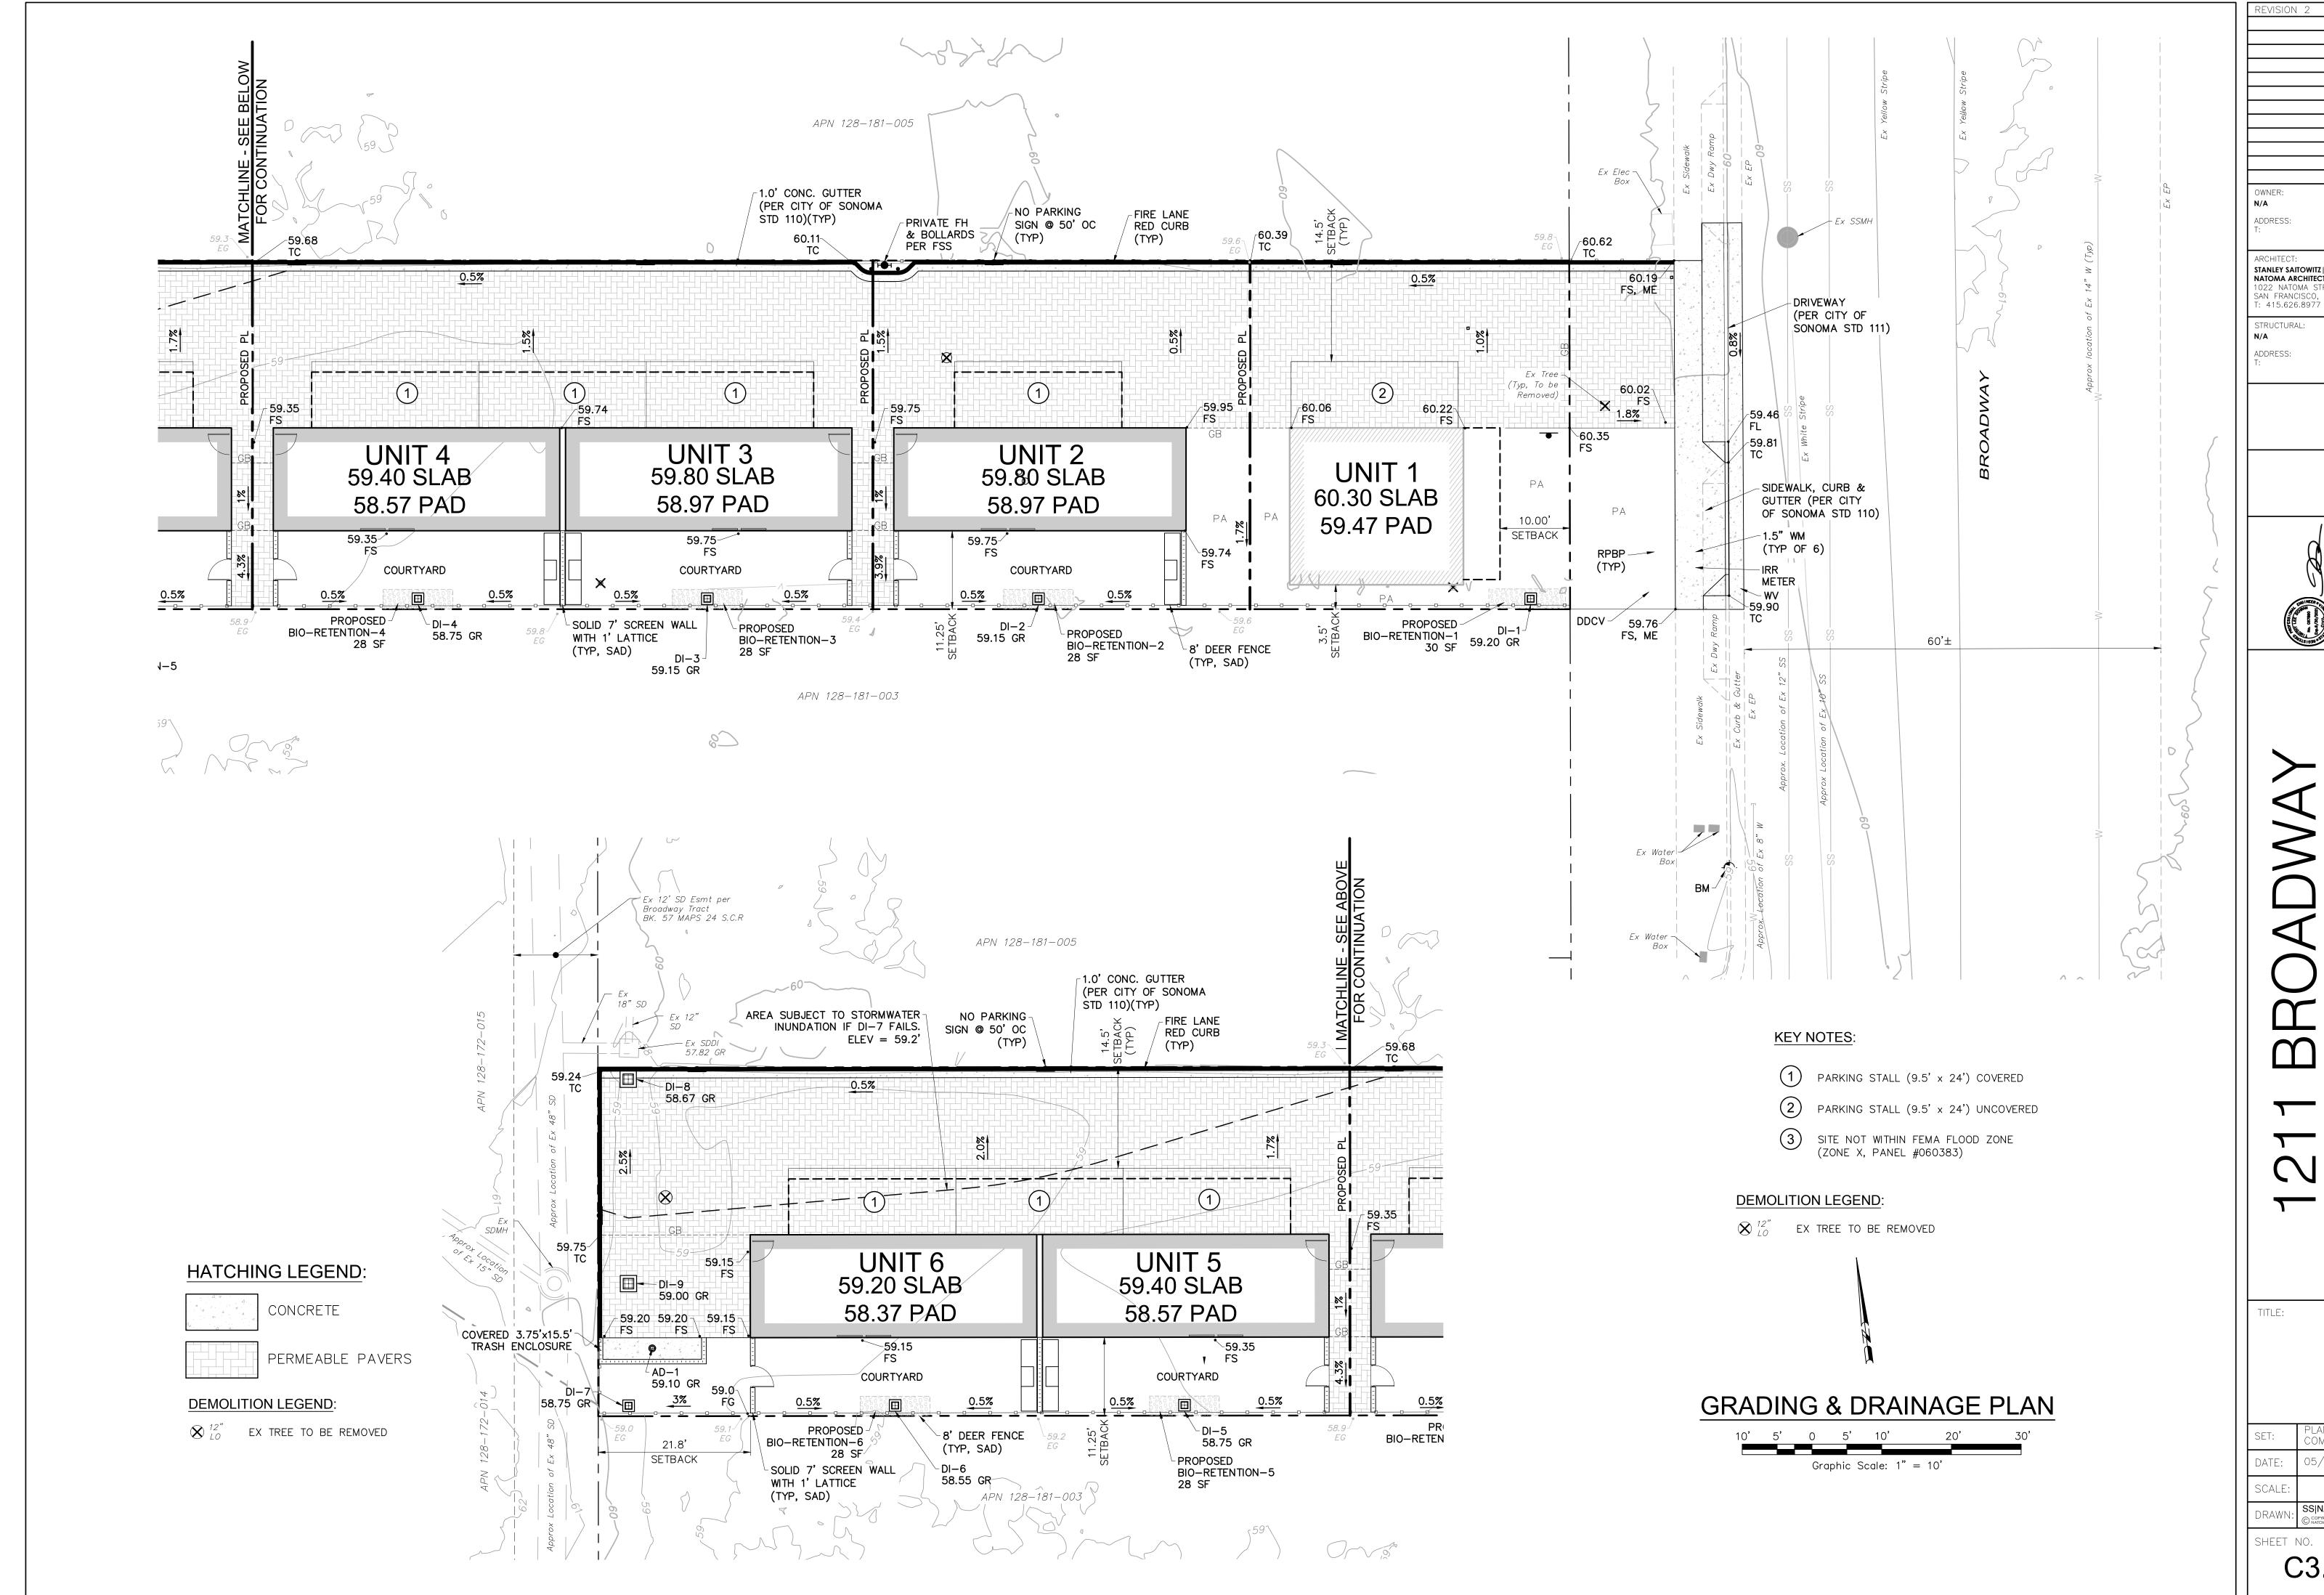


PLANNING COMMISSION 05/23/19

DRAWN

SHEET NO.

C2.0




STANLEY SAITOWITZ NATOMA ARCHITECTS INC. 1022 NATOMA STREET, NO. 3 SAN FRANCISCO, CA 94103



PLANNING COMMISSION 05/23/19


SS|NAI

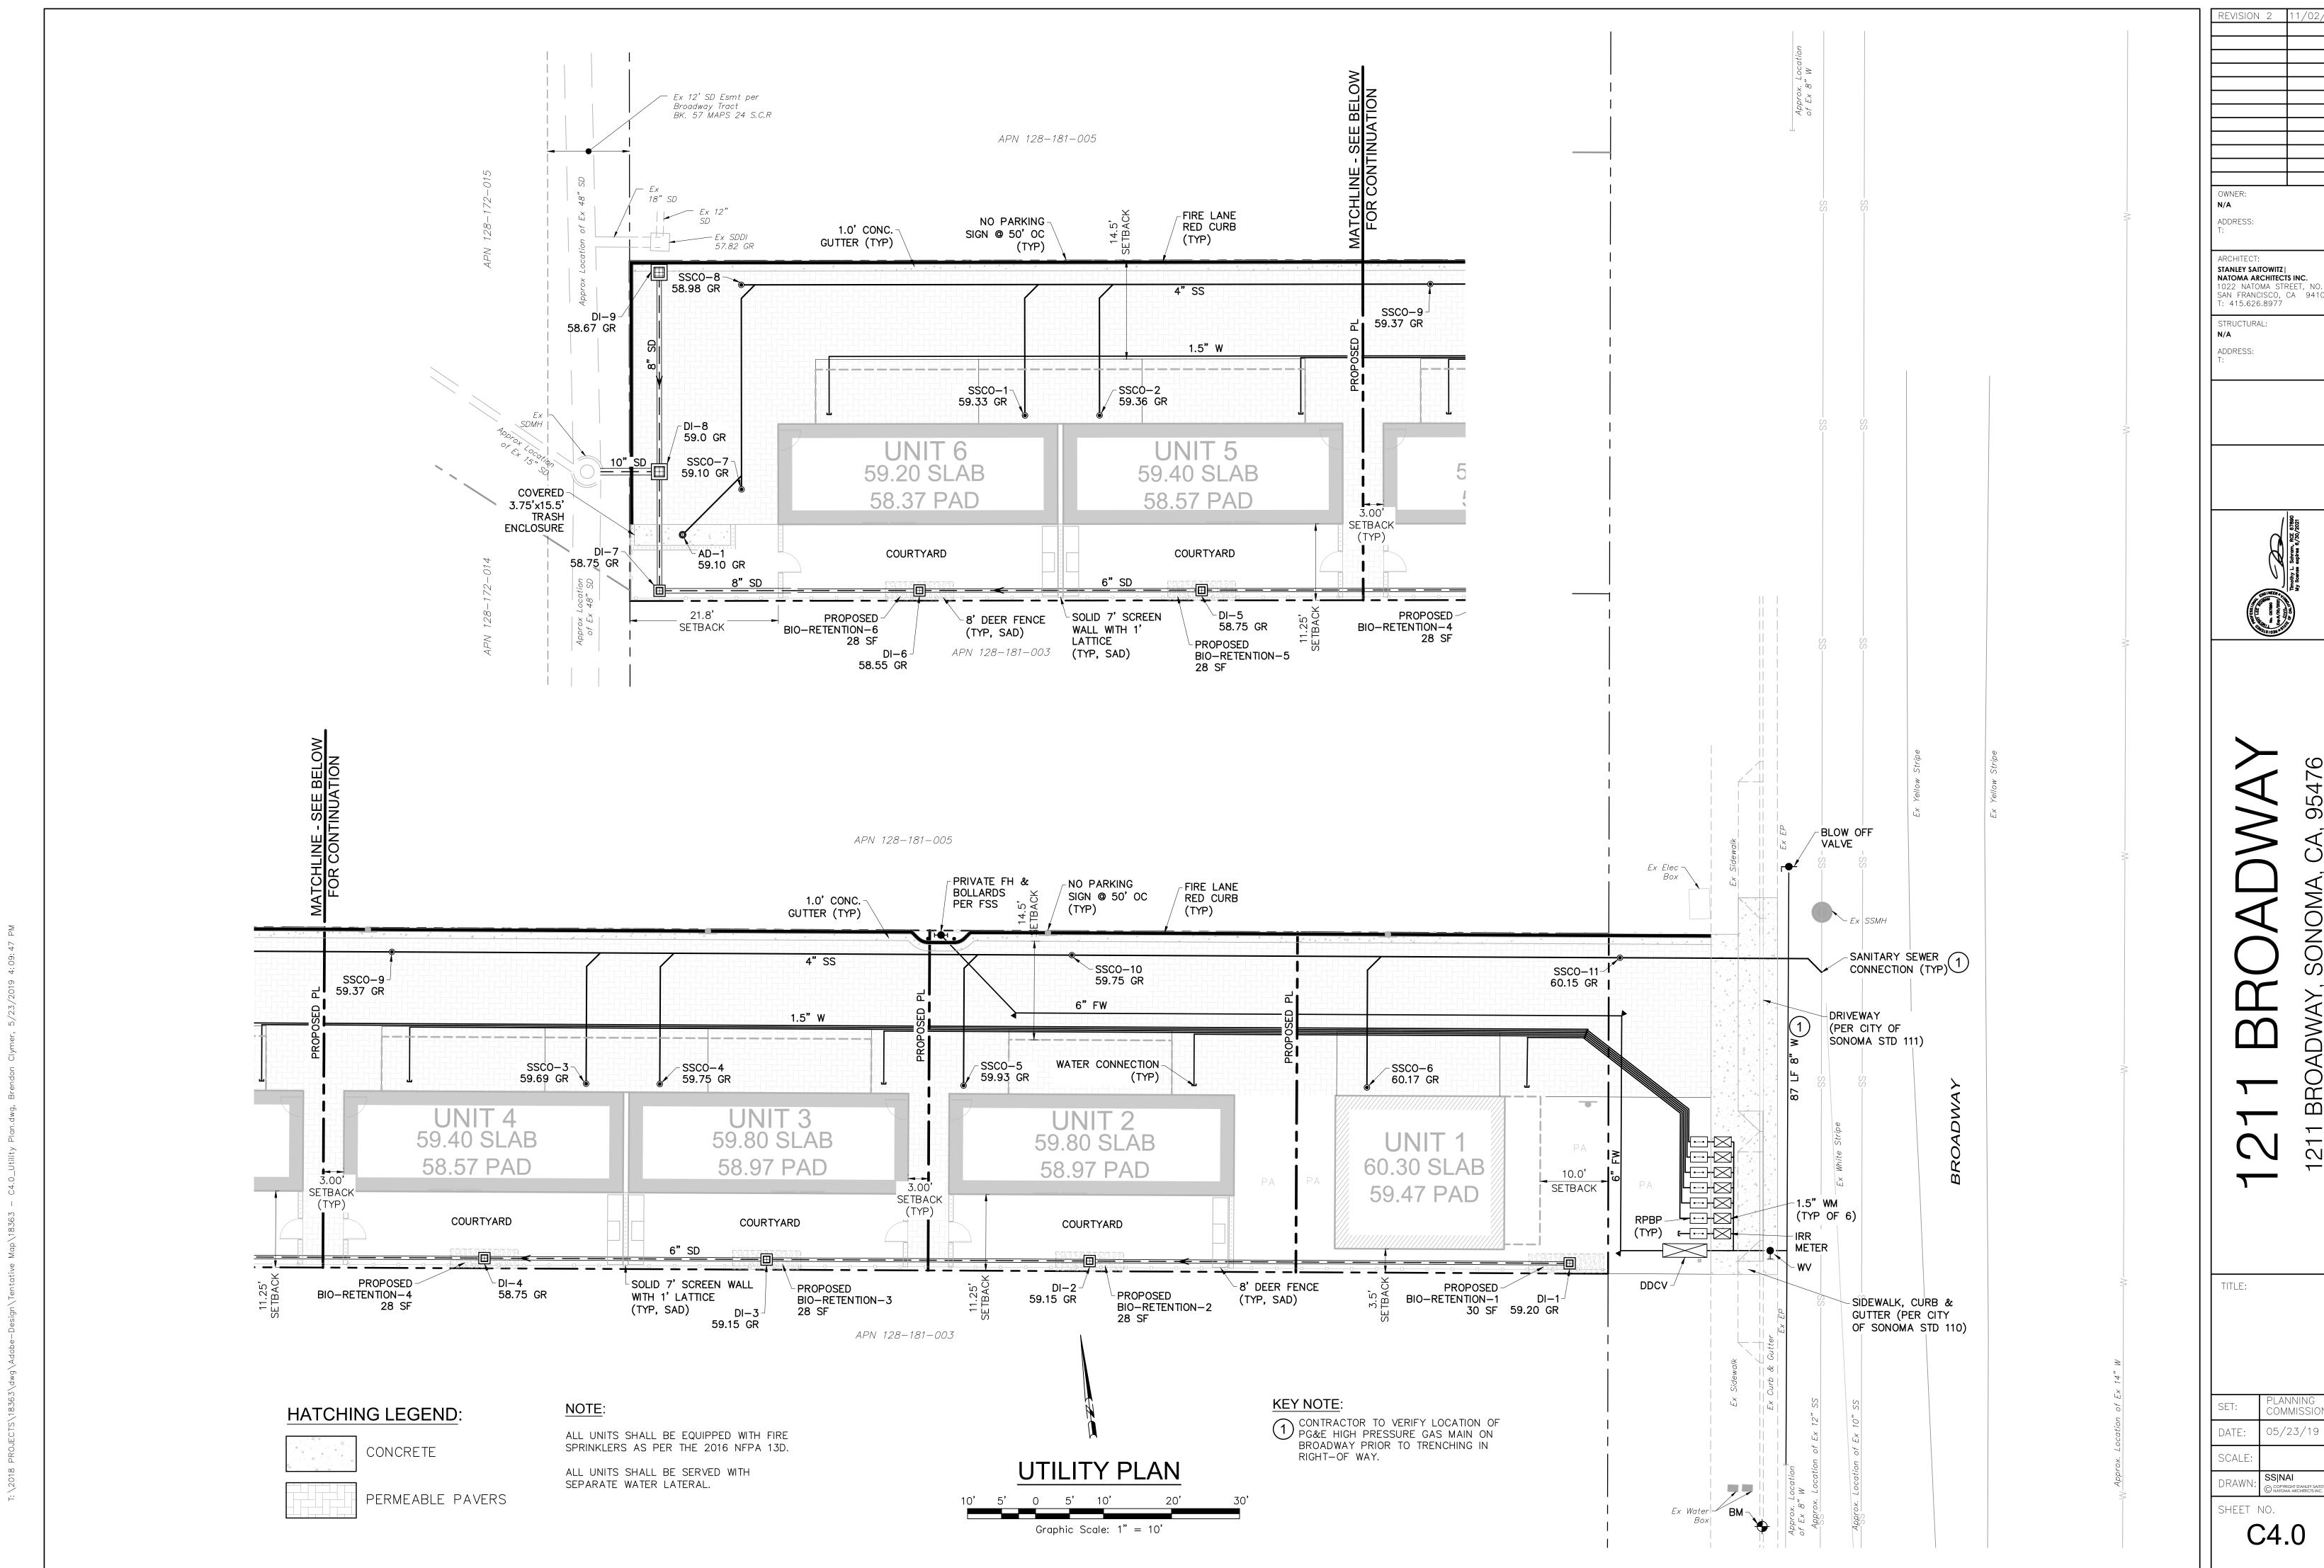C3.0



022 NATOMA STREET, NO. SAN FRANCISCO, CA 94103
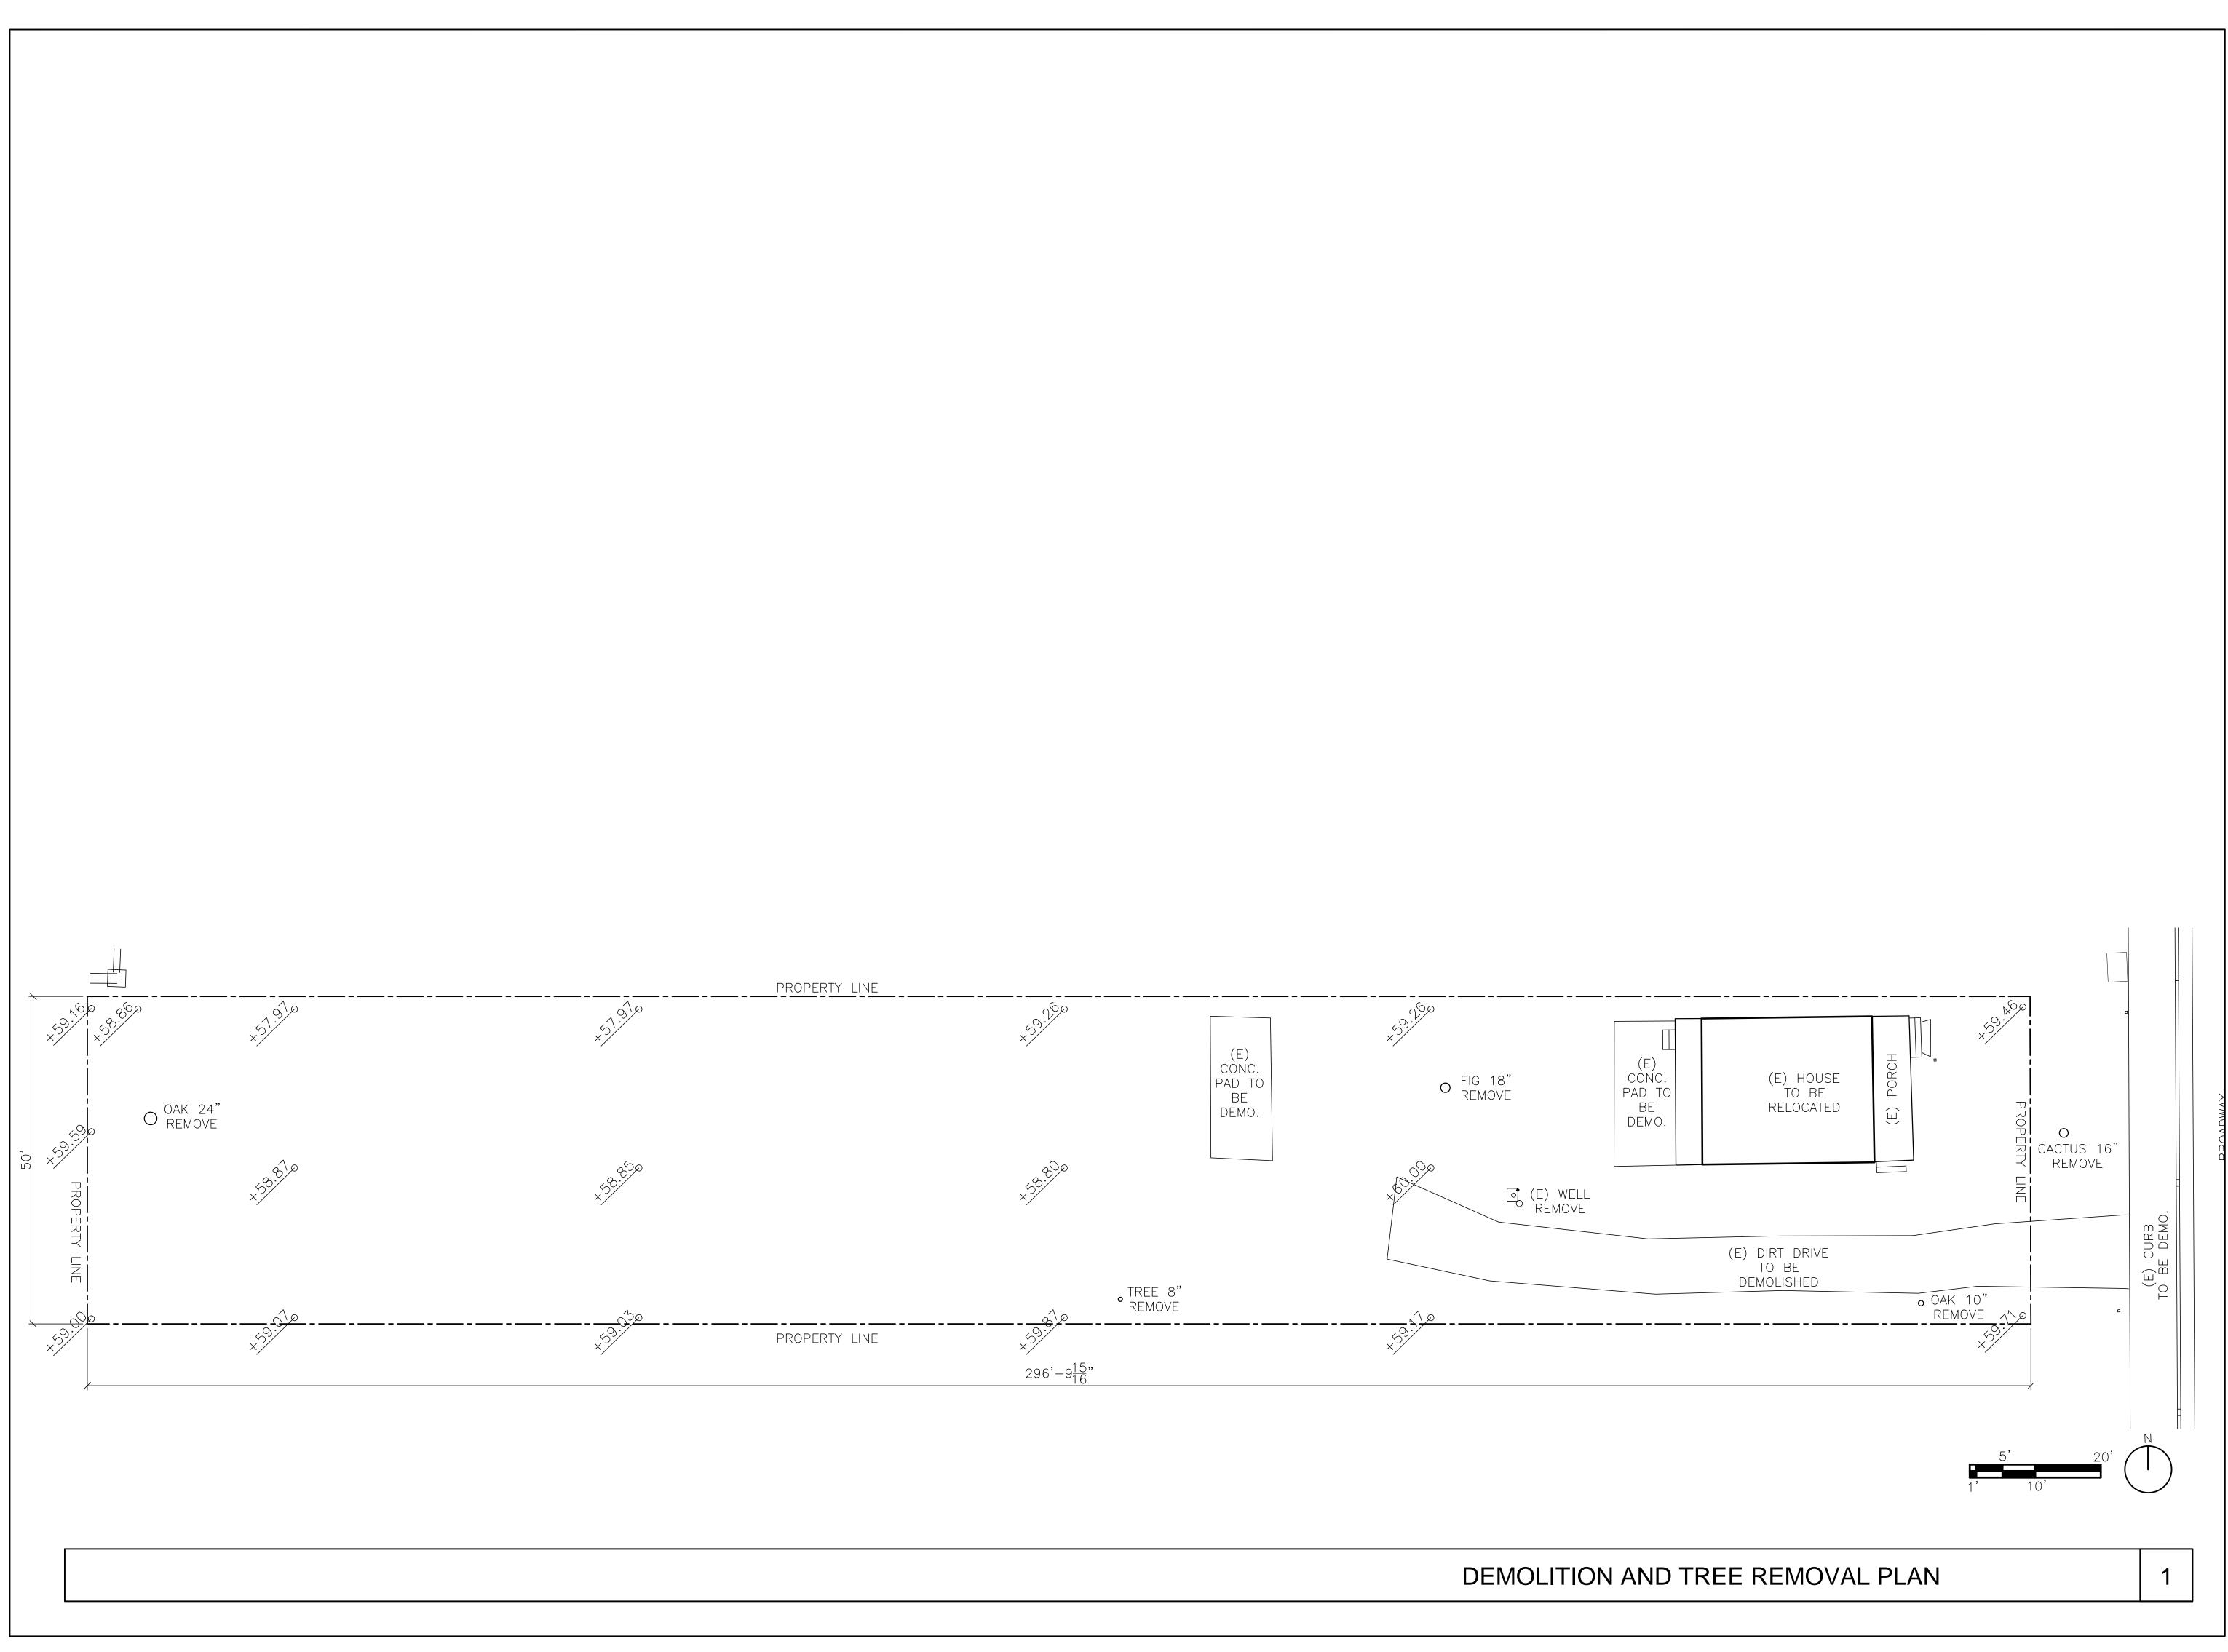
> PLANNING COMMISSION 05/23/19



OWNER: **SHAHRAM BIJAM**T: 415.902.4212

ARCHITECT:
STANLEY SAITOWITZ |
NATOMA ARCHITECTS INC.
1022 NATOMA STREET, NO. 3
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LANDSCAPE:
CHRISTOPHER YATES LANDSCAPE
ARCHITECTURE
1265 INDIANA ST, SAN
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T: 415.926.5775

1211 BROADWAY

DEMOLITION
AND TREE
REMOVAL
PLAN

SET: PLANNING


DATE: 05/23/19

SCALE: 3/32"=1'-0"

DRAWN: SSINAI

OCOPPRICHT STANLEY SANTOWITZ |

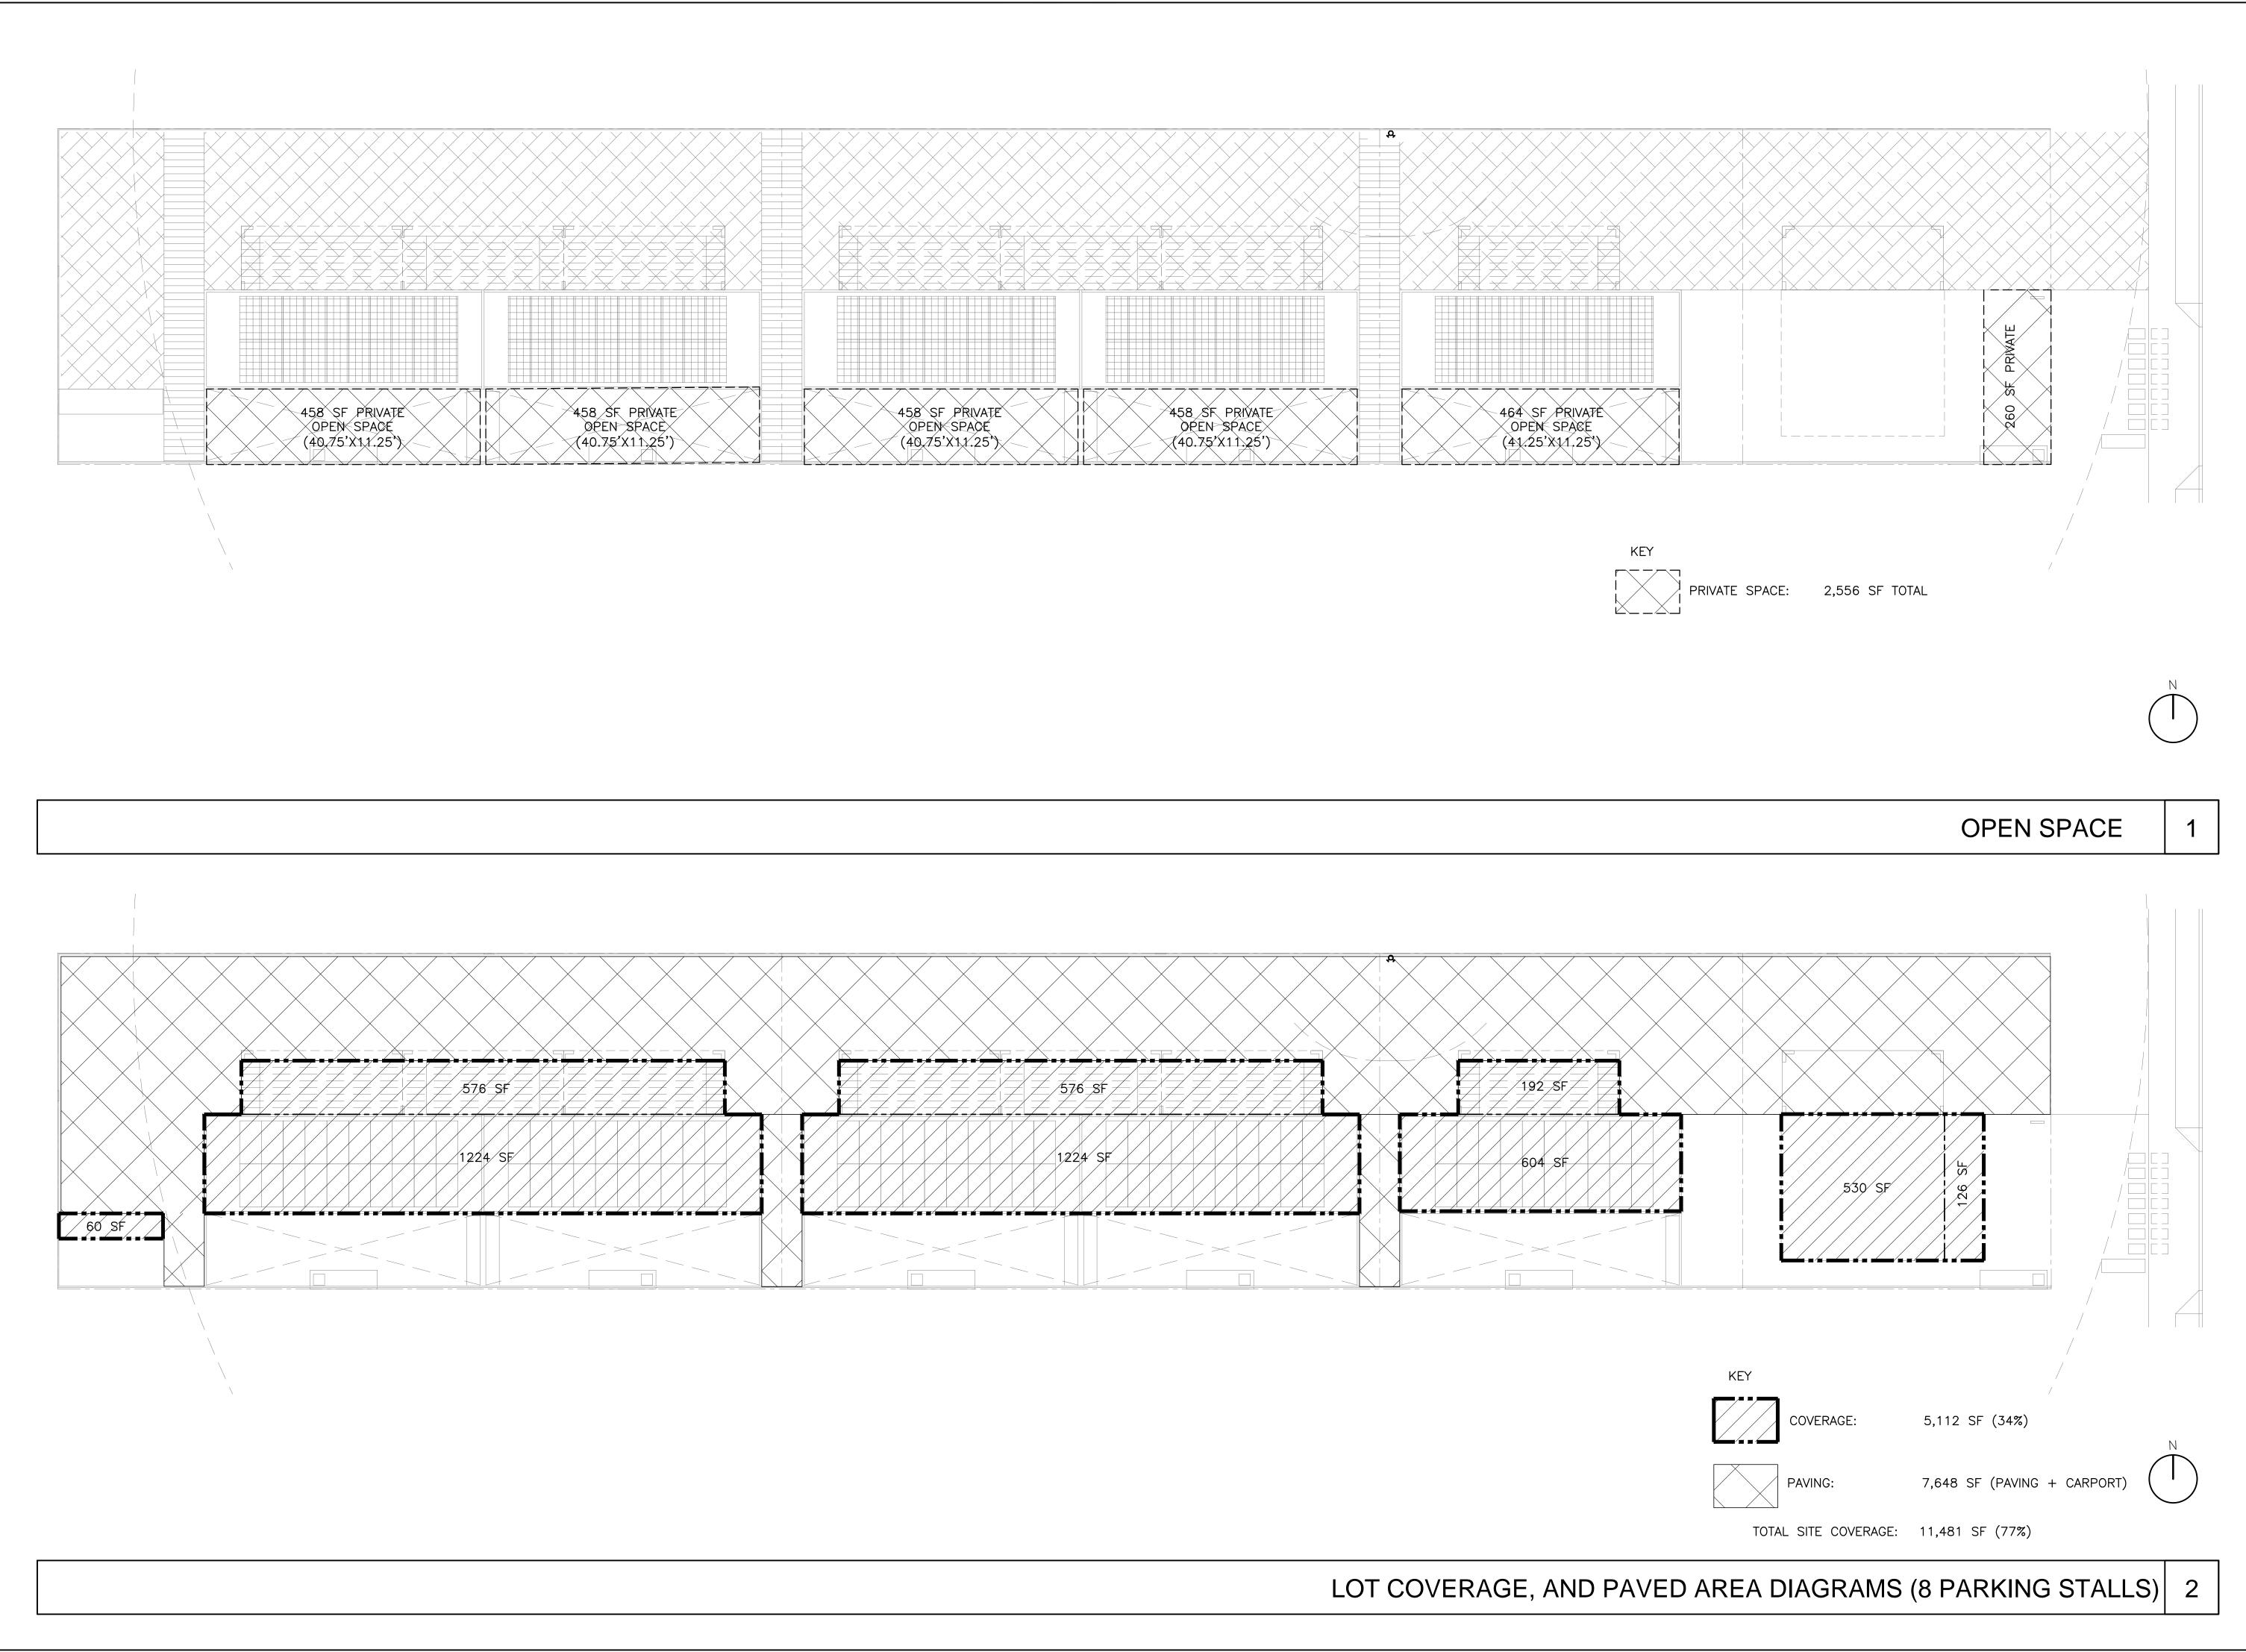SHEET NO.



OWNER: SHAHRAM BIJAM T: 415.902.4212

ARCHITECT: STANLEY SAITOWITZ NATOMA ARCHITECTS INC. 1022 NATOMA STREET, NO. 3 SAN FRANCISCO, CA 94103 T: 415.626.8977

STRUCTURAL: DESIGN EVEREST 425 1ST ST, 4904 SAN FRANCISCO, CA 94105 T: 415.524.0246

ADOBE ASSOCIATES INC 1220 N. DUTTON AVE SANTA ROSA, CA 95401

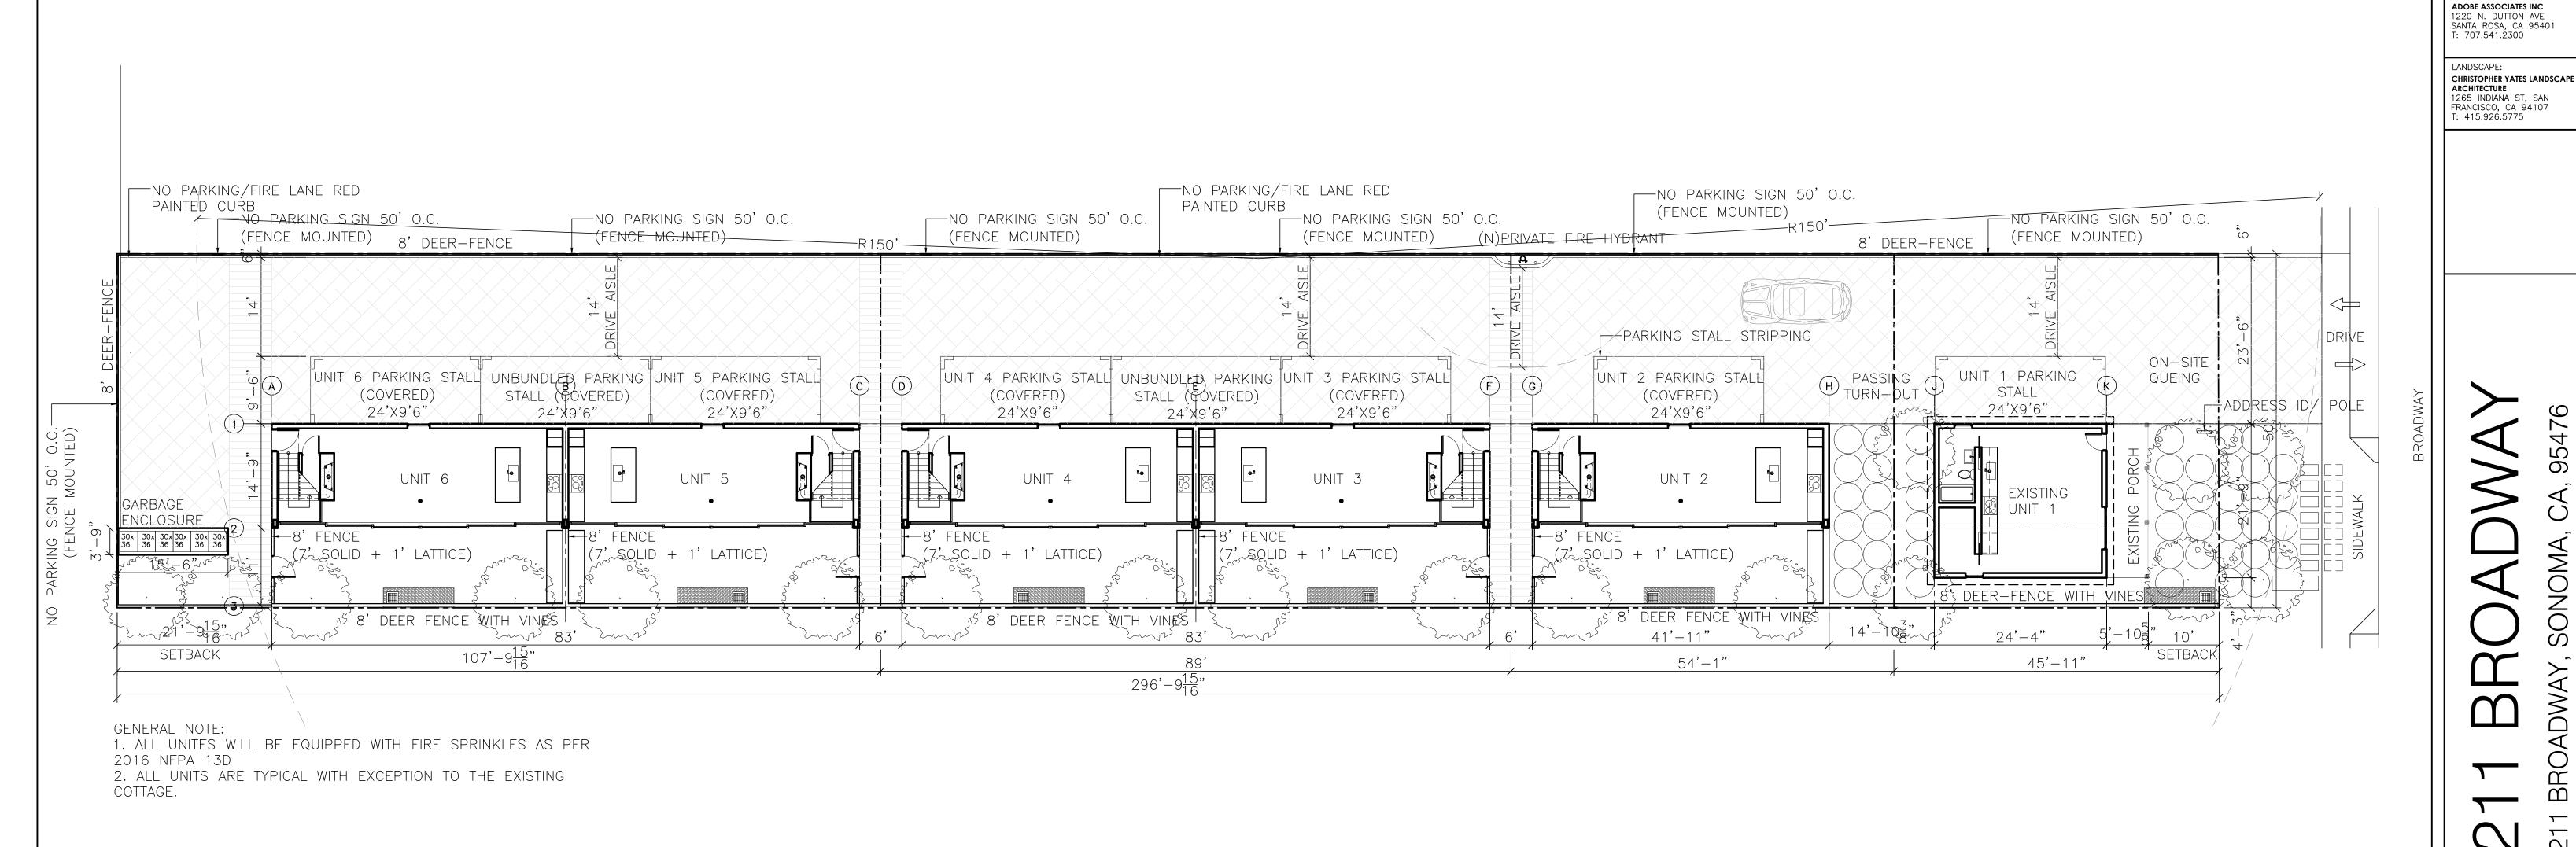
T: 707.541.2300

CHRISTOPHER YATES LANDSCAPE ARCHITECTURE 1265 INDIANA ST, SAN FRANCISCO, CA 94107 T: 415.926.5775

LOT COVERAGE

PLANNING 05/23/19

SHEET NO.



BB

OWNER: SHAHRAM BIJAM T: 415.902.4212

ARCHITECT: STANLEY SAITOWITZ NATOMA ARCHITECTS INC. 1022 NATOMA STREET, NO. 3 SAN FRANCISCO, CA 94103

T: 415.626.8977

425 1ST ST, 4904 SAN FRANCISCO, CA 94105 T: 415.524.0246

STRUCTURAL: DESIGN EVEREST

 \mathcal{O}

GROUND FLOOR PLAN

PLANNING


05/23/19 DATE: 3/32″=1′-0″

SS|NAI DRAWN:

SHEET NO.

GROUND FLOOR PLAN

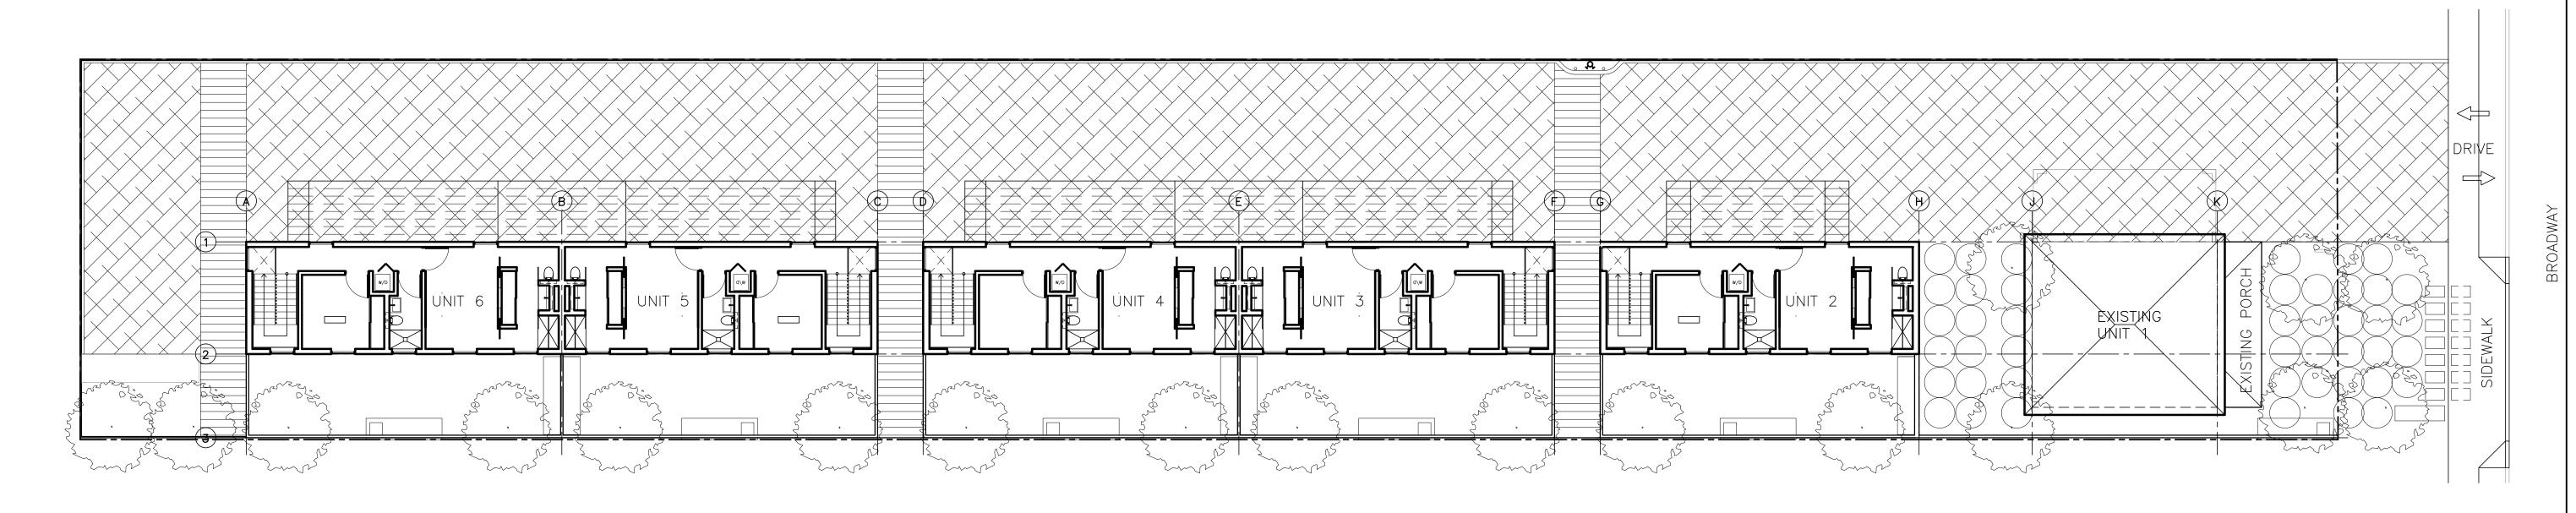
A1.1



GENERAL NOTE:

1. ALL UNITES WILL BE EQUIPPED WITH FIRE SPRINKLES AS PER
2016 NFPA 13D

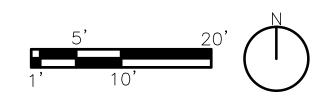2. ALL UNITS ARE TYPICAL WITH EXCEPTION TO THE EXISTING
COTTAGE.



LEVEL 2 FLOOR PLAN

SHAHRAM BIJAM T: 415.902.4212 ARCHITECT:

OWNER:

STANLEY SAITOWITZ NATOMA ARCHITECTS INC. 1022 NATOMA STREET, NO. 3 SAN FRANCISCO, CA 94103 T: 415.626.8977

STRUCTURAL: DESIGN EVEREST 425 1ST ST, 4904 SAN FRANCISCO, CA 94105 T: 415.524.0246

ADOBE ASSOCIATES INC 1220 N. DUTTON AVE SANTA ROSA, CA 95401 T: 707.541.2300

CHRISTOPHER YATES LANDSCAPE ARCHITECTURE

1265 INDIANA ST, SAN
FRANCISCO, CA 94107
T: 415.926.5775

SECOND FLOOR PLAN

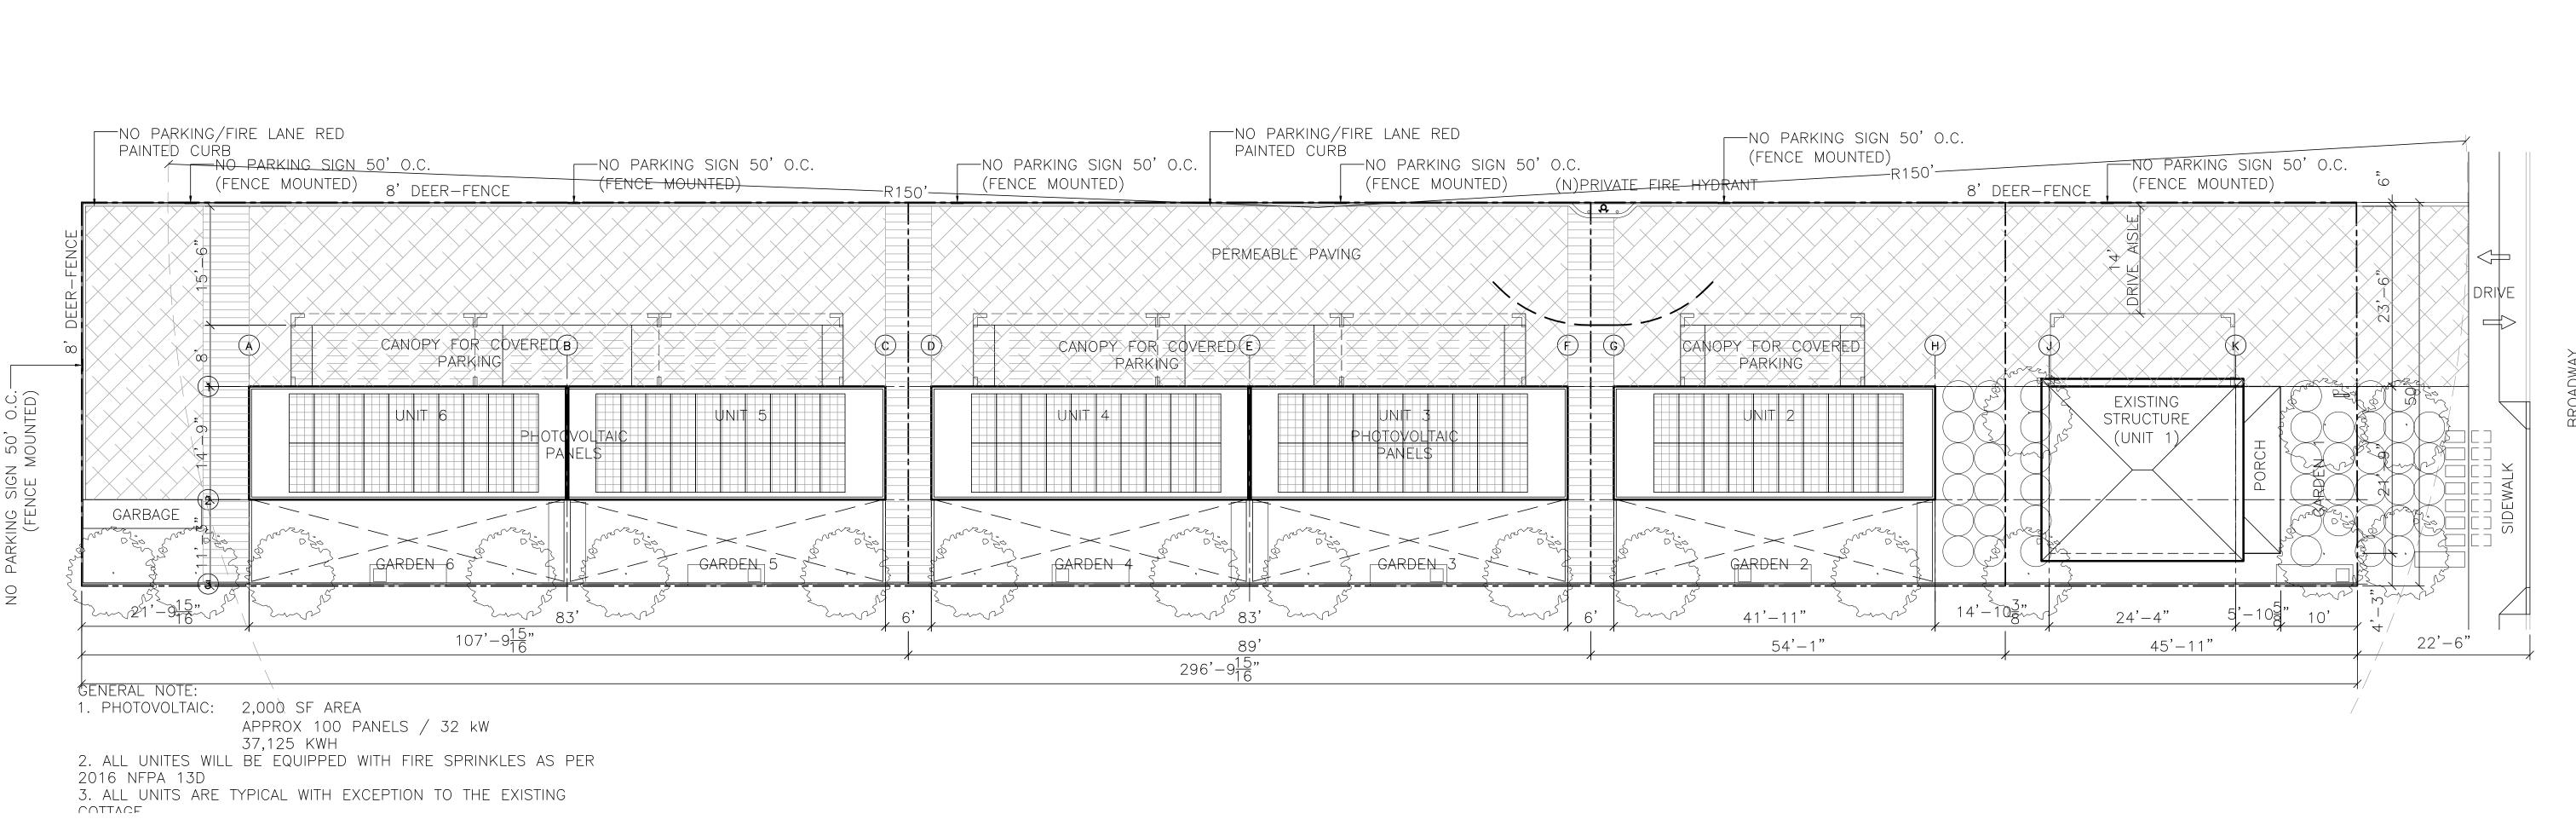
PLANNING 05/23/19 DATE:

3/16″=1′-0″

DRAWN:

SHEET NO.

A1.2



OWNER: SHAHRAM BIJAM T: 415.902.4212

ARCHITECT: STANLEY SAITOWITZ NATOMA ARCHITECTS INC. 1022 NATOMA STREET, NO. 3 SAN FRANCISCO, CA 94103 T: 415.626.8977

STRUCTURAL: DESIGN EVEREST 425 1ST ST, 4904 SAN FRANCISCO, CA 94105 T: 415.524.0246

ADOBE ASSOCIATES INC 1220 N. DUTTON AVE SANTA ROSA, CA 95401 T: 707.541.2300

CHRISTOPHER YATES LANDSCAPE ARCHITECTURE 1265 INDIANA ST, SAN FRANCISCO, CA 94107 T: 415.926.5775

 \bigcap

ROOF PLAN

PLANNING


05/23/19 DATE: 3/16"=1'-0"

SS|NAI DRAWN:

ROOF PLAN

SHEET NO.

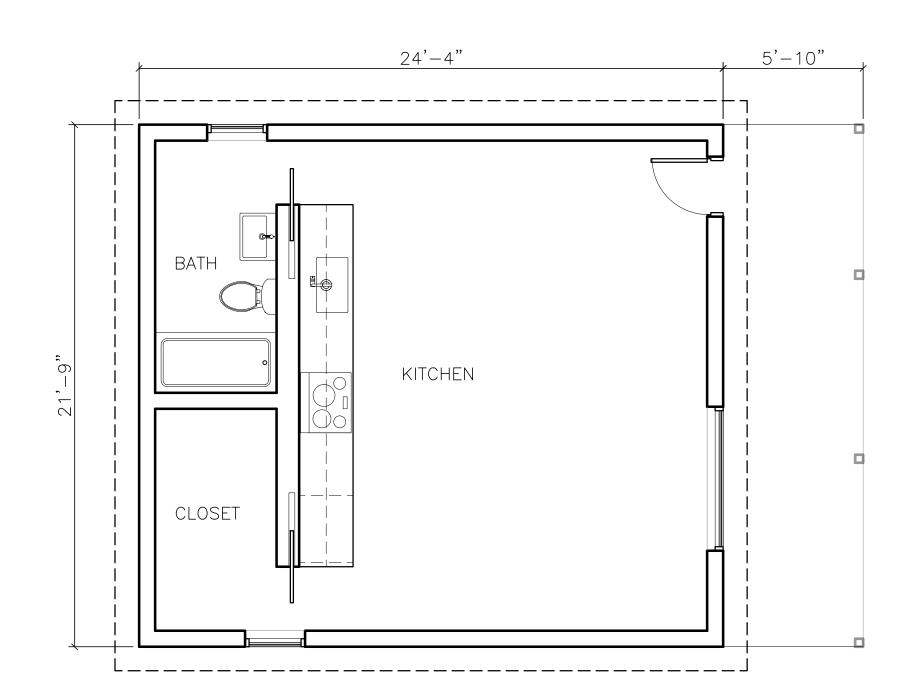A1.3




COTTAGE PLAN

41'-6" SECOND BEDROOM MASTER BEDROOM

GENERAL NOTE:

1. ALL UNITS ARE TYPICAL WITH EXCEPTION TO THE EXISTING COTTAGE.

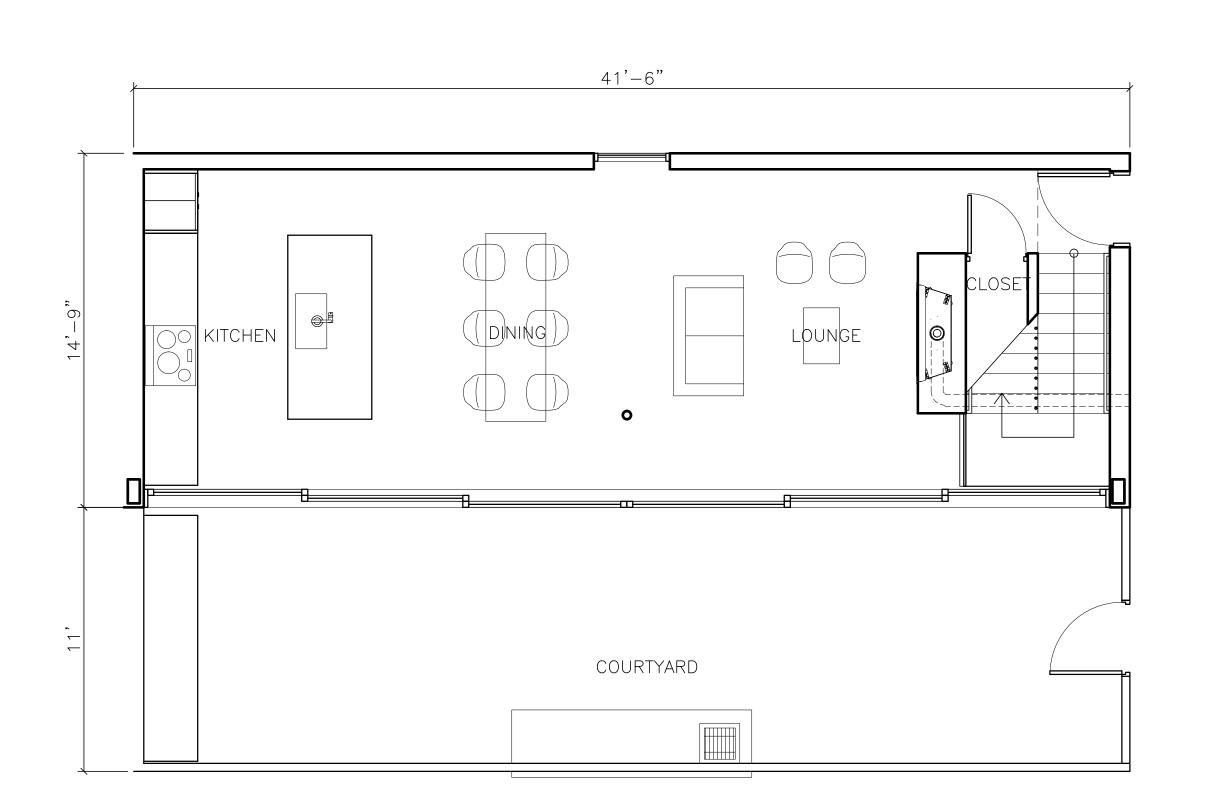2. ALL UNITES WILL BE EQUIPPED WITH FIRE SPRINKLES AS PER 2016 NFPA 13D



GROUND FLOOR UNIT PLAN

ARCHITECT:

SHAHRAM BIJAM T: 415.902.4212

STANLEY SAITOWITZ NATOMA ARCHITECTS INC. 1022 NATOMA STREET, NO. 3 SAN FRANCISCO, CA 94103 T: 415.626.8977

STRUCTURAL: DESIGN EVEREST 425 1ST ST, 4904 SAN FRANCISCO, CA 94105 T: 415.524.0246

ADOBE ASSOCIATES INC 1220 N. DUTTON AVE SANTA ROSA, CA 95401 T: 707.541.2300

CHRISTOPHER YATES LANDSCAPE ARCHITECTURE 1265 INDIANA ST, SAN FRANCISCO, CA 94107 T: 415.926.5775

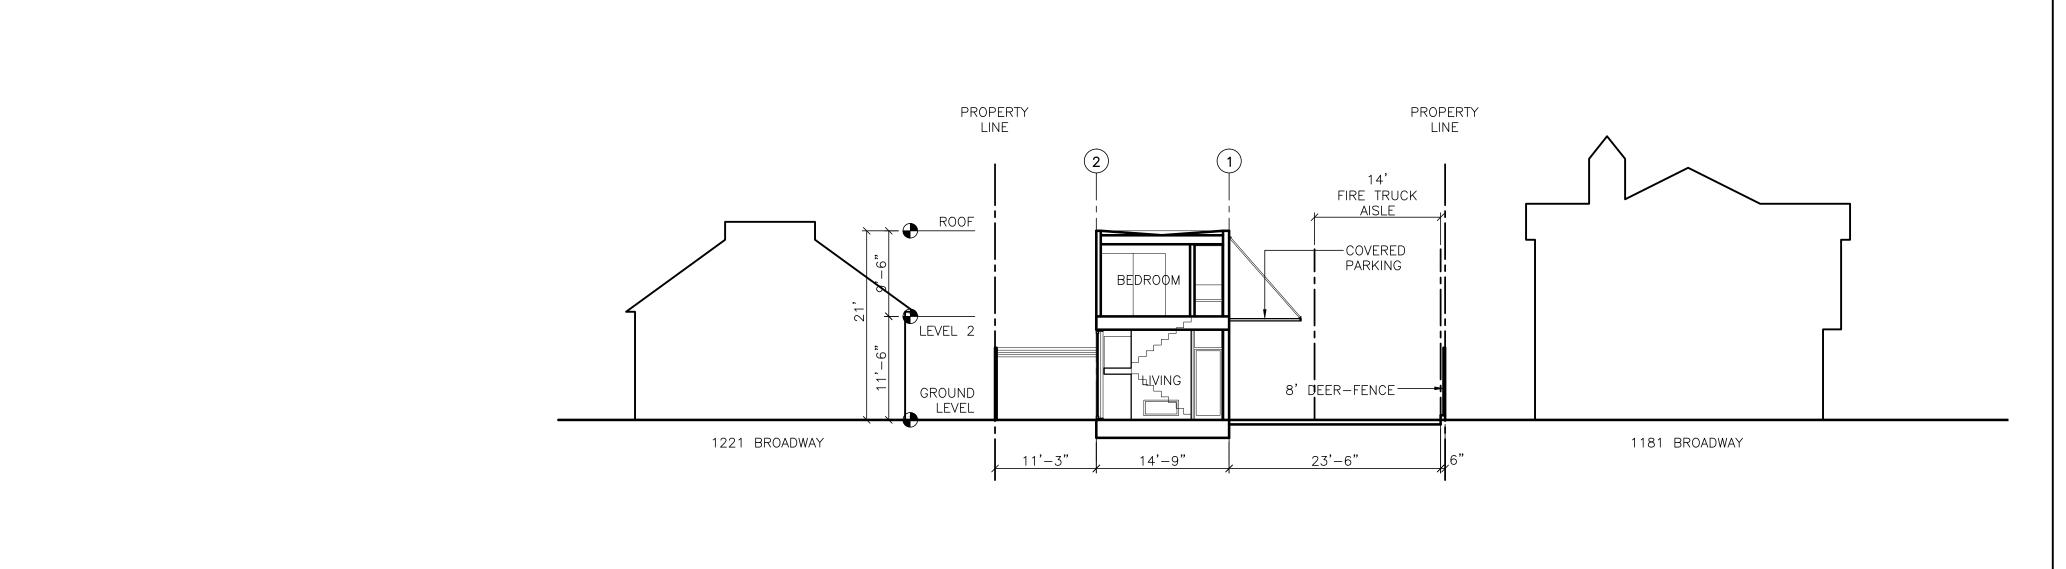
UNIT PLANS

PLANNING 05/23/19


DRAWN:

SHEET NO.

LEVEL 2 UNIT PLAN



EAST-WEST SECTION

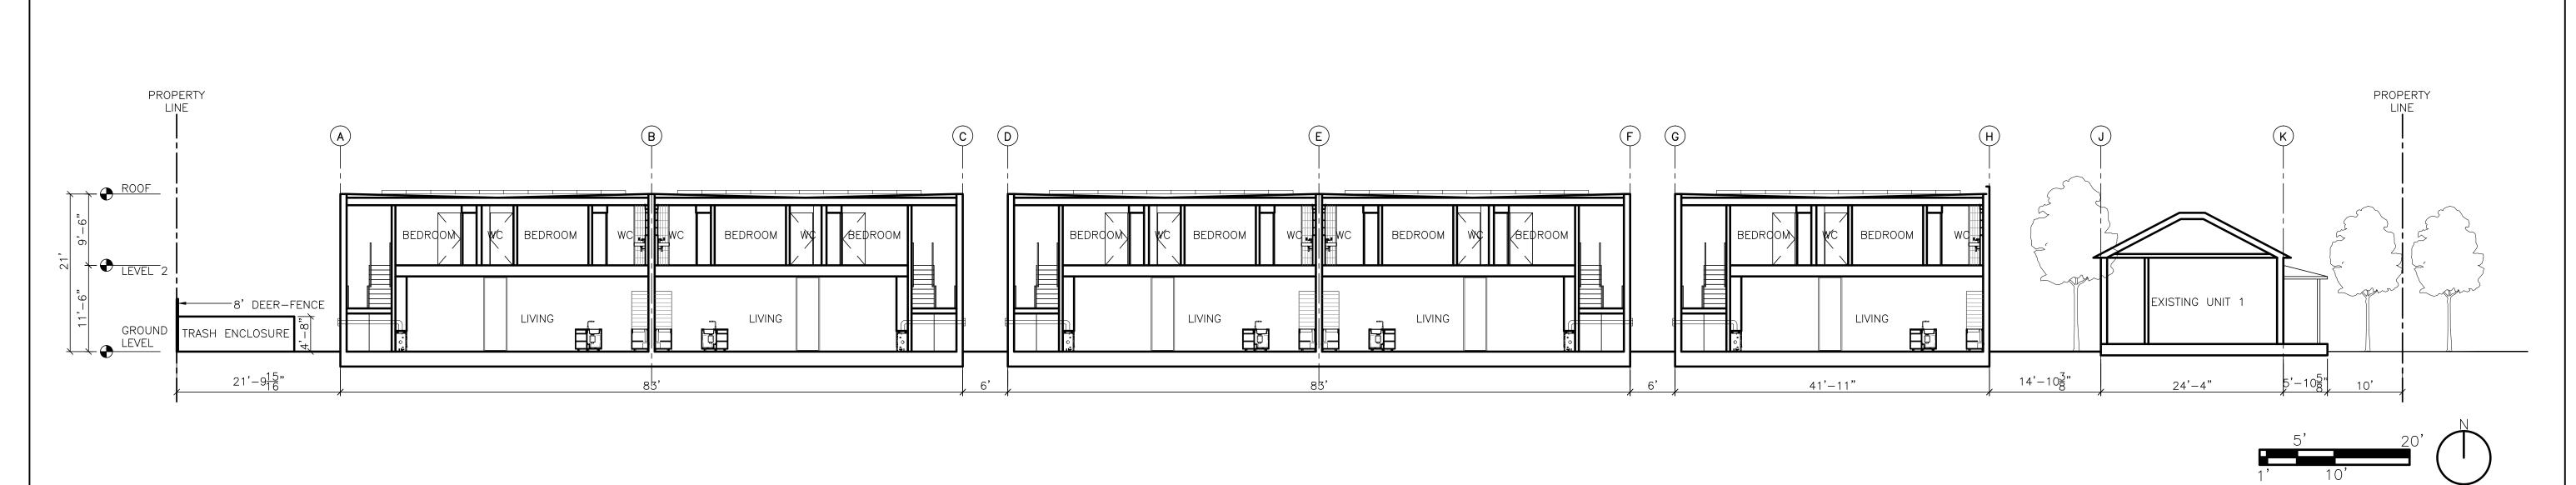

NORTH-SOUTH SECTION

STANLEY SAITOWITZ |
NATOMA ARCHITECTS INC.
1022 NATOMA STREET, NO. 3
SAN FRANCISCO, CA 94103
T: 415.626.8977 STRUCTURAL: DESIGN EVEREST 425 1ST ST, 4904 SAN FRANCISCO, CA 94105 T: 415.524.0246 ADOBE ASSOCIATES INC 1220 N. DUTTON AVE SANTA ROSA, CA 95401 T: 707.541.2300

OWNER: SHAHRAM BIJAM T: 415.902.4212

ARCHITECT:

CHRISTOPHER YATES LANDSCAPE ARCHITECTURE 1265 INDIANA ST, SAN FRANCISCO, CA 94107 T: 415.926.5775

BA BROADWAY,

SECTIONS

PLANNING 05/23/19 DATE:

SS|NAI

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NATOMA ARCHITECTS INC. DRAWN:



OWNER: SHAHRAM BIJAM T: 415.902.4212

ARCHITECT: STANLEY SAITOWITZ NATOMA ARCHITECTS INC.

1022 NATOMA STREET, NO. 3 SAN FRANCISCO, CA 94103 T: 415.626.8977

KEY: A. 113 YEAR OLD HOUSE FULLY RESTORED TO SECRETARY OF INTERIOR STANDARDS

B. OPERABLE EGRESS WINDOWS C. VERTICAL PROPORTIONED WINDOWS TO MATCH HOUSE

D. WHITE PAINTED CARPORT CANOPIES

E. BRIGHT WHITE CLAPBOARD SIDING TO MATCH ORIGINAL HOUS

G. ADDRESS ID/ COMPLEX DIRECTORY PER CFC 505.1.4 H. SLIDING GLASS WINDOWS J. TRASH ENCLOSURE

I. FENCE (7' SOLID + 1' LATTICE)

K. 8' DEER FENCE

L. 8' DEER FENCE W/ VINES

ELEVATIONS

2

PLANNING DATE: 05/23/19

3/32″=1′-0″ SS|NAI

© COPYRIGHT STANLEY SAITOWITZ NATOMA ARCHITECTS INC. DRAWN:

SHEET NO.

A3.1



KEY:
A. 113 YEAR OLD HOUSE FULLY RESTORED TO SECRETARY OF INTERIOR STANDARDS
B. OPERABLE EGRESS WINDOWS
C. VERTICAL PROPORTIONED WINDOWS TO MATCH HOUSE
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SOUTH ELEVATION

T: 415.902.4212

OWNER: SHAHRAM BIJAM

ARCHITECT:

STANLEY SAITOWITZ |

NATOMA ARCHITECTS INC.

1022 NATOMA STREET, NO. 3

SAN FRANCISCO, CA 94103

T: 415.626.8977

STRUCTURAL:
DESIGN EVEREST
425 1ST ST, 4904 SAN
FRANCISCO, CA 94105
T: 415.524.0246

CIVIL:

ADOBE ASSOCIATES INC
1220 N. DUTTON AVE
SANTA ROSA, CA 95401
T: 707.541.2300

LANDSCAPE:
CHRISTOPHER YATES LANDSCAPE
ARCHITECTURE
1265 INDIANA ST, SAN
FRANCISCO, CA 94107
T: 415.926.5775

1211 BROADWAY

GROUND -

BROADWAY

ELEVATIONS

SET: PLANNING

DATE: 05/23/19

SCALE: 3/32"=1'-0"


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MATOMA ARCHITECTS INC.

SHEET NO.

A3.2



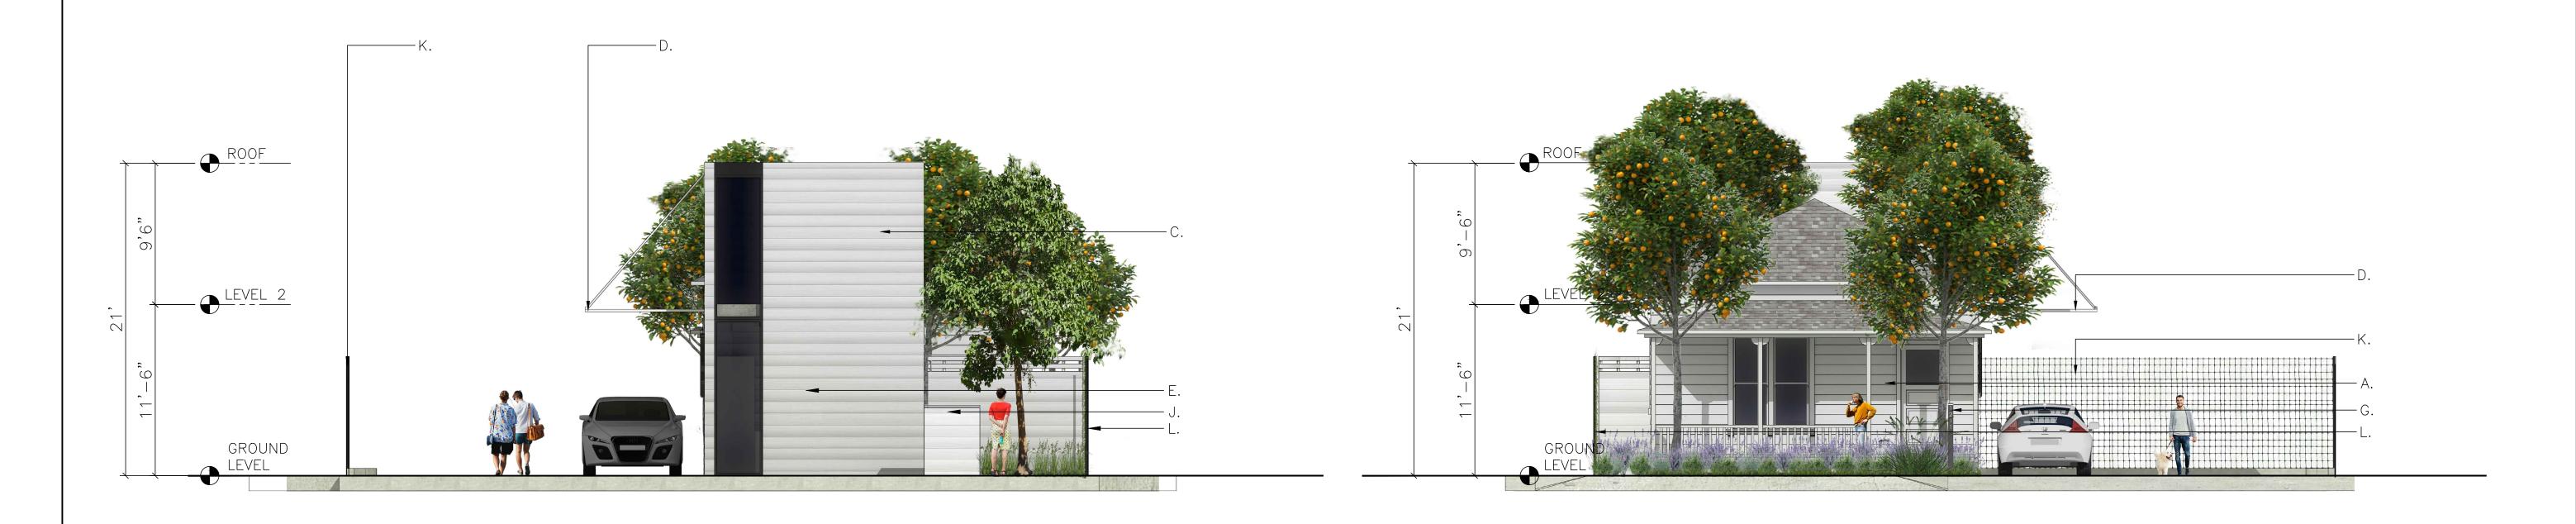ADOBE ASSOCIATES INC 1220 N. DUTTON AVE SANTA ROSA, CA 95401 T: 707.541.2300 LANDSCAPE: CHRISTOPHER YATES LANDSCAPE ARCHITECTURE
1265 INDIANA ST, SAN FRANCISCO, CA 94107 T: 415.926.5775

1022 NATOMA STREET, NO. 3 SAN FRANCISCO, CA 94103 T: 415.626.8977

DESIGN EVEREST 425 1ST ST, 4904 SAN FRANCISCO, CA 94105 T: 415.524.0246

SHAHRAM BIJAM T: 415.902.4212

ARCHITECT: STANLEY SAITOWITZ NATOMA ARCHITECTS INC.

STRUCTURAL:

BB 211

ELEVATIONS

PLANNING 05/23/19 DATE:

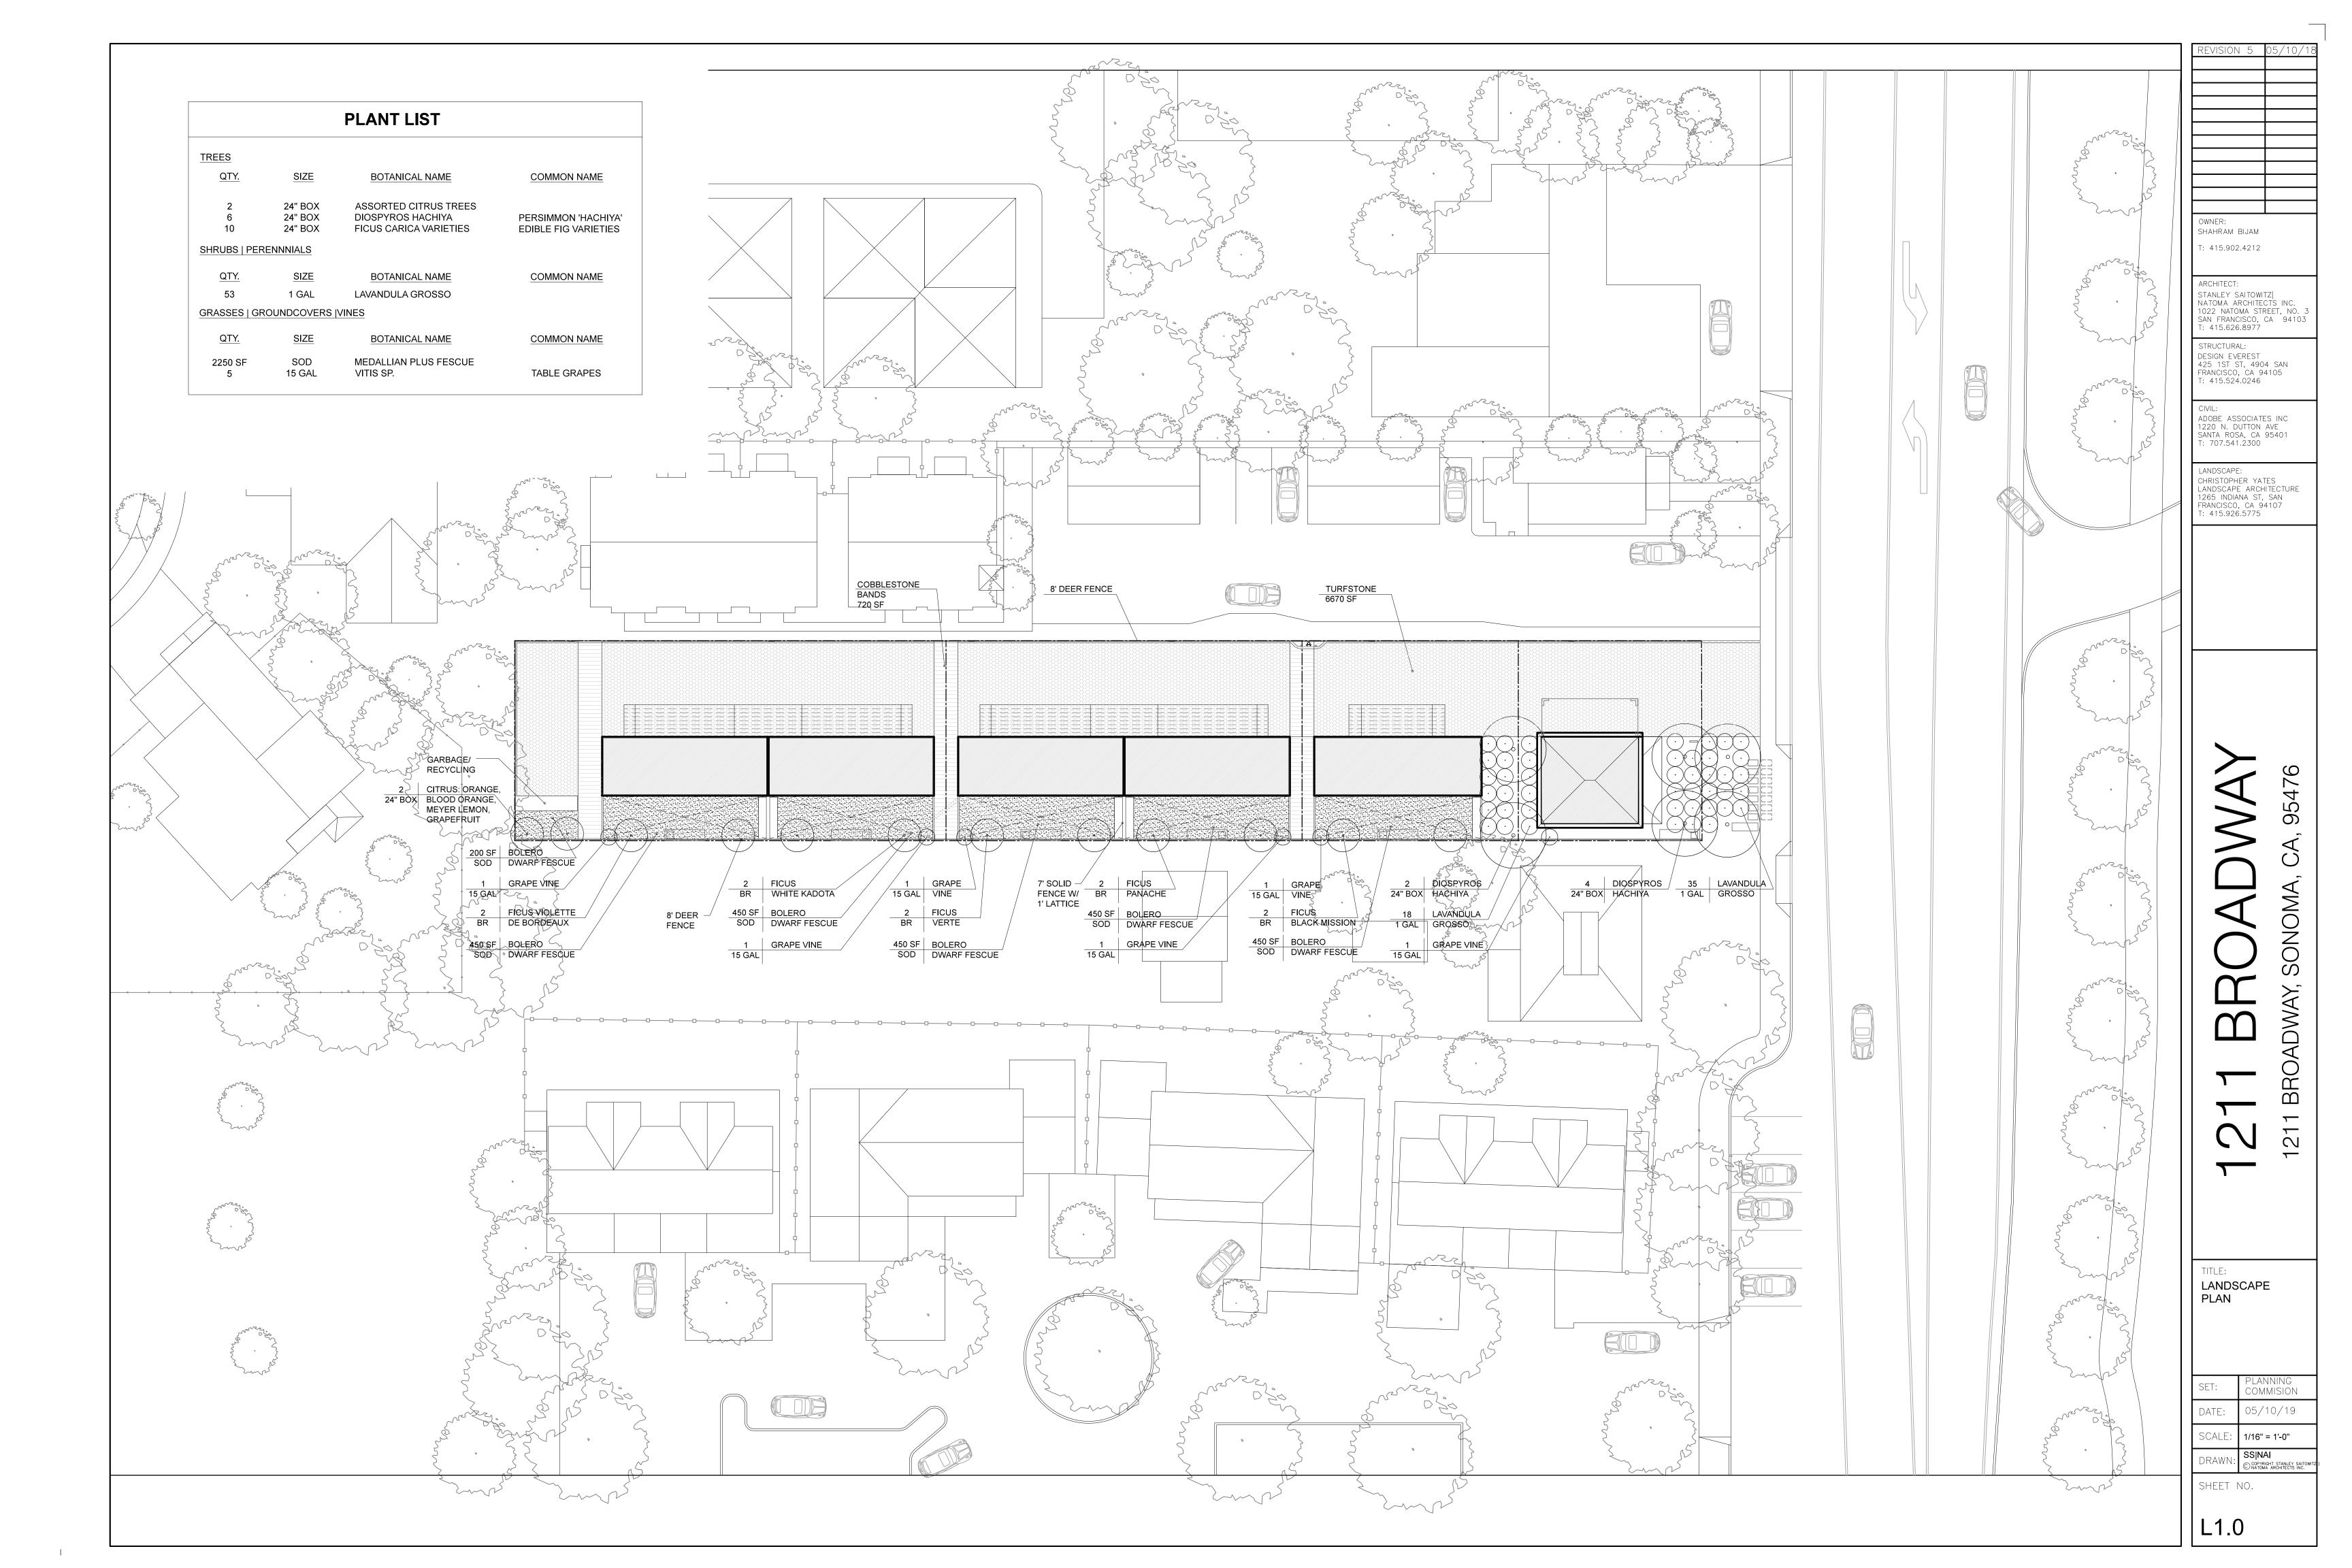
3/16″=1′-0″ DRAWN:

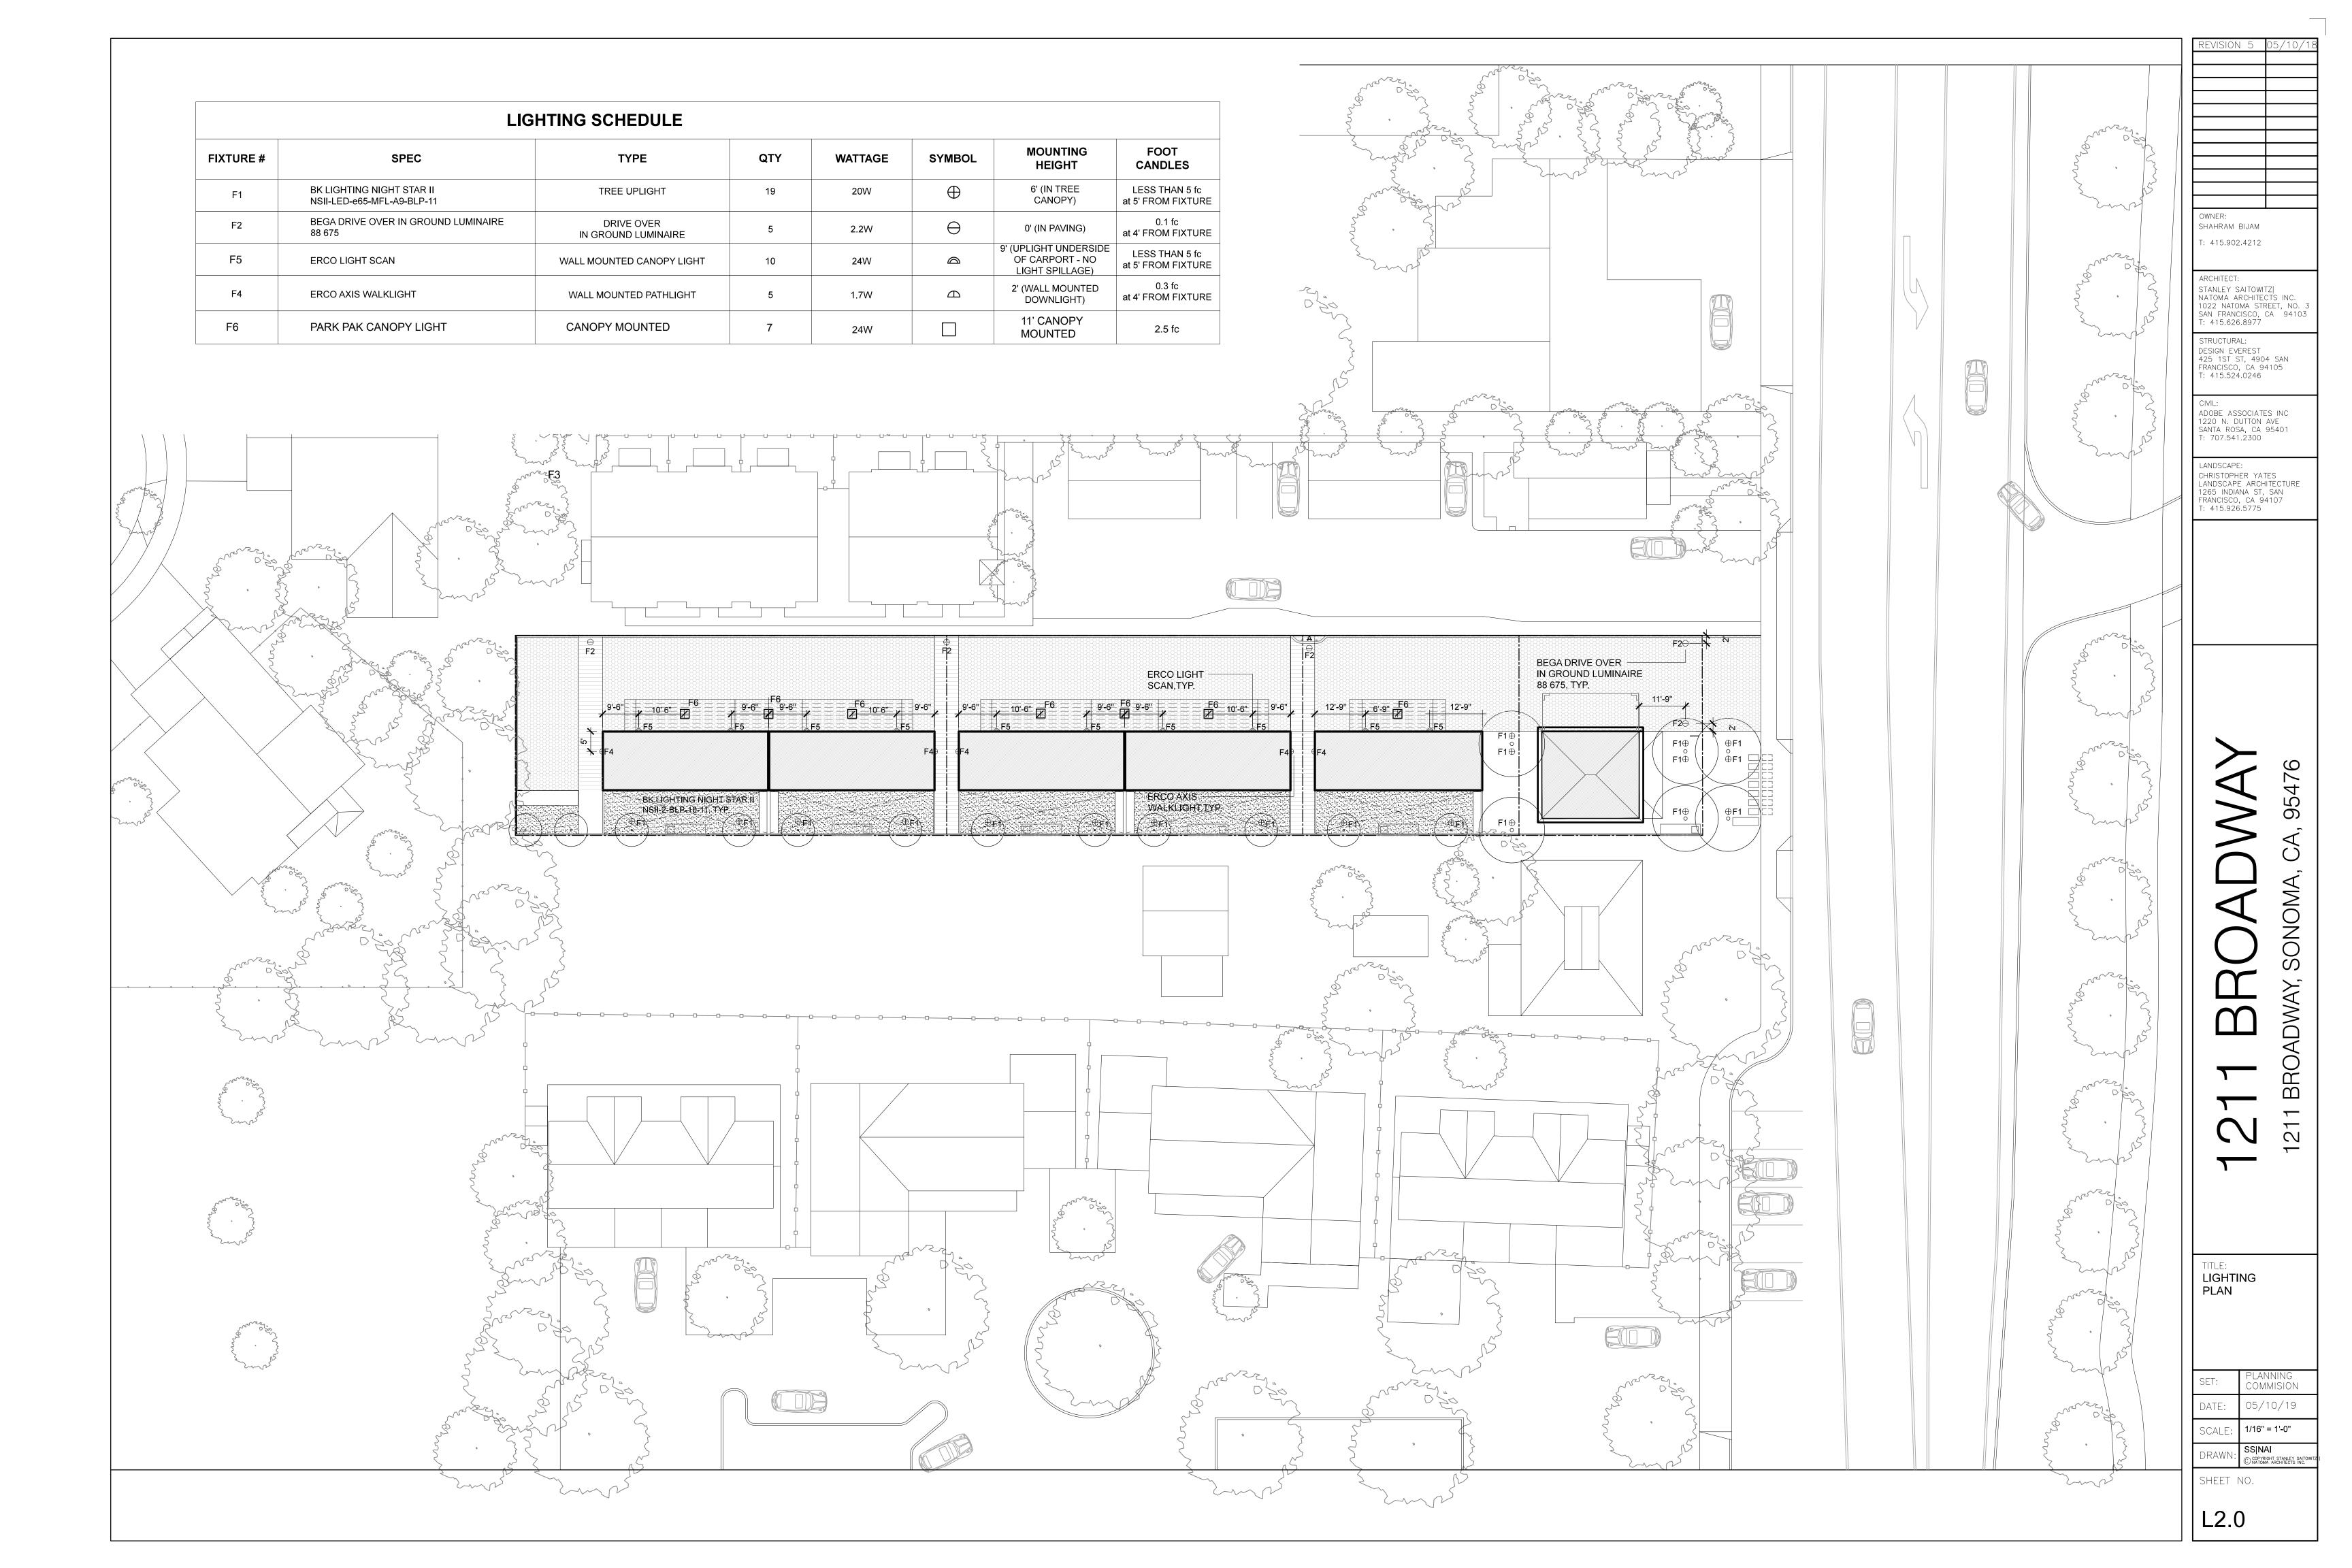
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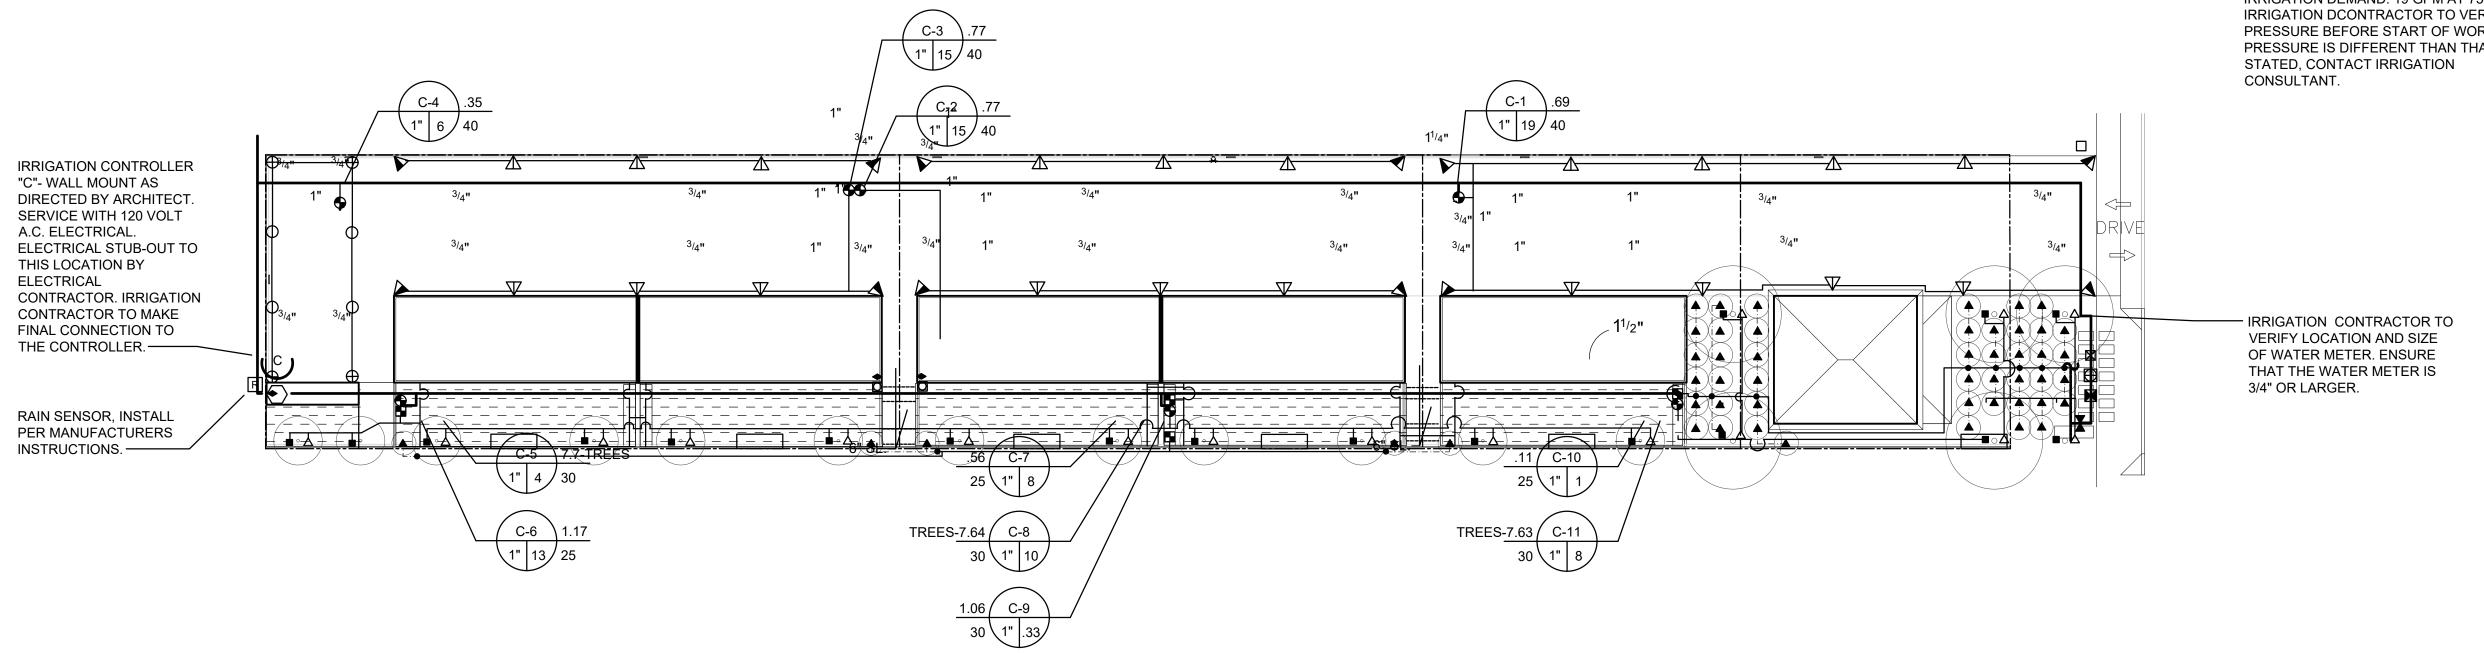




BROOKWATER IRRIGATION CONSULTANTS P.O. BOX 1967

GARDNERVILLE, NV 89410 TEL 775-266-3589, CELL 510-816-1796 E-MAIL ANN®BROOKWATER.COM

DUE TO THE SCALE OF THE PLANS, SOME IRRIGATION EQUIPMENT IS SHOWN OUTSIDE OF SOIL AREAS. INSTALL ALL EQUIPMENT IN SOIL.



IRRIGATION DEMAND: 19 GPM AT 75 PSI. IRRIGATION DCONTRACTOR TO VERIFY PRESSURE BEFORE START OF WORK. IF PRESSURE IS DIFFERENT THAN THAT

SHAHRAM BIJAM T: 415.902.4212

ARCHITECT: STANLEY SAITOWITZ | NATOMA ARCHITECTS INC. 1022 NATOMA STREET, NO. 3 SAN FRANCISCO, CA 94103 T: 415.626.8977

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LANDSCAPE: CHRISTOPHER YATES LANDSCAPE ARCHITECTURE
1265 INDIANA ST, SAN
FRANCISCO, CA 94107
T: 415.926.5775



95476 SONOMA

TITLE:
IRRIGATION
PLAN

PLANNING COMMISION 05/10/19 SCALE:

DRAWN: SSINAI
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NATOMA ARCHITECTS INC.

RRIGATION NOTES

THE CONTRACTOR SHALL REVIEW RELATED DRAWINGS AND SHALL ENSURE COORDINATION WITH ALL APPLICABLE TRADES PRIOR TO UBMITTING BID.

THE IRRIGATION SYSTEM SHALL BE INSTALLED IN CONFORMANCE WITH ALL APPLICABLE STATE AND LOCAL CODES AND ORDINANCES BY ICENSED CONTRACTORS AND EXPERIENCED WORKMEN. CONTRACTOR SHALL OBTAIN AND PAY FOR ALL REQUIRED PERMITS AND FEES RELATING O HIS WORK.

THIS DESIGN IS DIAGRAMMATIC. ALL PIPING, VALVES, ETC. SHOWN WITHIN PAVED AREAS IS FOR DESIGN CLARIFICATION ONLY AND SHALL BE NSTALLED IN PLANTING AREAS WHERE POSSIBLE. AVOID ANY CONFLICTS BETWEEN THE SPRINKLER SYSTEM, PLANTING AND ARCHITECTURAL EATURES. PARALLEL PIPES MAY BE INSTALLED IN COMMON TRENCH. PIPES ARE NOT TO BE INSTALLED DIRECTLY ABOVE ONE ANOTHER.

DO NOT WILLFULLY INSTALL THE SPRINKLER SYSTEM AS SHOWN ON THE DRAWINGS WHEN IT IS OBVIOUS IN THE FIELD THAT OBSTRUCTIONS. BRADE DIFFERENCES OR DIFFERENCES IN THE AREA DIMENSIONS EXIST THAT MIGHT NOT HAVE BEEN CONSIDERED IN THE ENGINEERING. SUCH DBSTRUCTIONS OR DIFFERENCES SHOULD BE BROUGHT TO THE ATTENTION OF THE OWNER'S AUTHORIZED REPRESENTATIVE. IN THE EVENT THAT THIS NOTIFICATION IS NOT PERFORMED, THE IRRIGATION CONTRACTOR SHALL ASSUME FULL RESPONSIBILITY FOR ANY REVISIONS NECESSARY.

IT IS THE RESPONSIBILITY OF THE IRRIGATION CONTRACTOR TO FAMILIARIZE HIMSELF WITH ALL GRADE DIFFERENCES, LOCATION OF WALLS, ETAINING WALLS, ETC. HE SHALL COORDINATE HIS WORK WITH THE GENERAL CONTRACTOR AND OTHER SUBCONTRACTORS FOR THE LOCATION AND THE INSTALLATION OF PIPE SLEEVES THROUGH WALLS, UNDER ROADWAYS, PAVING, STRUCTURES, ETC. CONTRACTOR TO VERIFY THE OCATION OF EXISTING UNDERGROUND UTILITIES AND STRUCTURES PRIOR TO THE EXCAVATION OF TRENCHES. CONTRACTOR IS TO REPAIR ANY DAMAGE CAUSED BY HIS WORK AT NO ADDITIONAL COST TO THE OWNER.

DUE TO THE SCALE OF THE DRAWINGS. IT IS NOT POSSIBLE TO INDICATE ALL OFFSETS. FITTINGS. SLEEVES. ETC., WHICH MAY BE REQUIRED. HE CONTRACTOR SHALL CAREFULLY INVESTIGATE THE STRUCTURAL AND FINISHED CONDITIONS AFFECTING ALL OF HIS WORK AND PLAN HIS VORK ACCORDINGLY, FURNISHING SUCH FITTINGS, ETC., AS MAY BE REQUIRED TO MEET SUCH CONDITIONS. DRAWINGS ARE GENERALLY DIAGRAMMATIC AND INDICATIVE OF THE WORK TO BE INSTALLED. THE WORK SHALL BE INSTALLED IN SUCH A MANNER AS TO AVOID CONFLICTS BETWEEN IRRIGATION SYSTEMS, PLANTING, AND ARCHITECTURAL FEATURES.

ELECTRICAL CONTRACTOR TO SUPPLY 120 VAC (2.5 AMP) SERVICE TO CONTROLLER LOCATION. IRRIGATION CONTRACTOR TO MAKE FINAL CONNECTION FROM ELECTRICAL STUB-OUT TO CONTROLLER. IRRIGATION CONTROL WIRE SHALL BE #14, U.L. APPROVED FOR DIRECT BURIAL COMMON WIRE SHALL BE #12 U.L. APPROVED AND SHALL BE WHITE IN COLOR. WIRING TO INDIVIDUAL REMOTE CONTROL VALVES SHALL BE COLOR OTHER THAN WHITE.

REMOTE CONTROL VALVES SHALL BE WIRED TO CONTROLLER IN SEQUENCE AS SHOWN ON PLANS. RUN WIRE FROM EACH RCV TO THE CONTROLLER. SPLICING WIRES TOGETHER OUTSIDE OF VALVE BOXES WILL NOT BE PERMITTED.

SPLICING OF 24-VOLT WIRES WILL NOT BE PERMITTED EXCEPT IN VALVE BOXES. LEAVE A 36" COIL OF EXCESS WIRE AT EACH SPLICE ND 100 FEET ON CENTER ALONG WIRE RUN. TAPE WIRE IN BUNDLES 10 FEET ON CENTER. NO TAPING PERMITTED INSIDE SLEEVES.

INSTALL THREE (3) SPARE CONTROL WIRES ALONG THE ENTIRE MAIN LINE. SPARE WIRES SHALL BE THE SAME COLOR (ONE WITH A WHITE TRIPE) AND OF A DIFFERENT COLOR THAN OTHER CONTROL WIRES. LOOP 36" EXCESS WIRE INTO EACH SINGLE VALVE BOX AND INTO ONE VALVE OX IN EACH GROUP OF VALVES.

VALVE LOCATIONS SHOWN ARE DIAGRAMMATIC. INSTALL IN GROUND COVER/SHRUB AREAS WHERE POSSIBLE (NOT IN LAWN AREA.)

INSTALL VALVE BOXES MINIMUM 12" FROM AND PERPENDICULAR TO WALK, CURB, LAWN, BUILDING OR LANDSCAPE FEATURE. AT MULTIPLE /ALVE BOX GROUPS, EACH BOX SHALL BE AN EQUAL DISTANCE FROM THE WALK, CURB, LAWN, ETC. AND EACH BOX SHALL BE AINIMUM 12" APART. SHORT SIDE OF VALVE BOXES SHALL BE PARALLEL TO WALK, CURB, LAWN, ETC.

3. ALL SPRINKLER HEADS SHALL BE SET PERPENDICULAR TO FINISH GRADE OF THE AREA TO BE IRRIGATED UNLESS OTHERWISE DESIGNATED ON THE PLANS.

4. IN LOCATIONS WHERE LOW HEAD DRAINAGE WILL CAUSE EROSION AND EXCESS WATER, USE POP-UP SPRINKLER MODELS WITH INTEGRAL CHECK VALVE OR A KING BROS. CV SERIES CHECK VALVE ON SHRUB RISERS IN LIEU OF SCHEDULE 80 COUPLING. FOR DRIP OR BUBBLER CIRCUITS, INSTALL KING BROS. CV SERIES CHECK VALVES IN LATERAL LINES FOR EVERY 10' OF ELEVATION CHANGE.

5. THE IRRIGATION CONTRACTOR SHALL FLUSH AND ADJUST ALL SPRINKLER HEADS FOR OPTIMUM PERFORMANCE AND TO PREVENT OVERSPRAY ONTO WALKS, ROADWAYS AND/OR BUILDINGS AS MUCH AS POSSIBLE. THIS SHALL INCLUDE SELECTING THE BEST DEGREE OF FIXED ARC (OR AN ADJUSTABLE ARC IF FIXED ARC DOES NOT MATCH THE ARC TO BE IRRIGATED) TO FIT THE SITE CONDITIONS AND TO THROTTLE THE LOW CONTROL AT EACH VALVE TO OBTAIN THE OPTIMUM OPERATING PRESSURE FOR EACH SYSTEM. ALL MAIN LINES SHALL BE FLUSHED PRIOR TO THE INSTALLATION OF IRRIGATION HEADS. AT 30 DAYS AFTER INSTALLATION EACH SYSTEM SHALL BE FLUSHED TO ELIMINATE GLUE AND DIRT PARTICLES FROM THE LINES.

WHEN VERTICAL OBSTRUCTIONS (STREET LIGHTS, TREES, FIRE HYDRANTS, ETC.) INTERFERE WITH THE SPRAY PATTERN OF THE HEADS SO S TO PREVENT PROPER COVERAGE, THE IRRIGATION CONTRACTOR SHALL FIELD ADJUST THE SPRINKLER SYSTEM BY INSTALLING A QUARTER, HIRD OR HALF CIRCLE HEAD AT THE SIDES OF THE OBSTRUCTION SO AS TO PROVIDE PROPER COVERAGE. ALL ADJUSTMENTS SHALL BE MADE AT O ADDITIONAL COST TO THE OWNER.

NOTIFY ARCHITECT OF ANY ASPECTS OF LAYOUT THAT WILL PROVIDE INCOMPLETE OR INSUFFICIENT WATER COVERAGE OF PLANT MATERIAL AND DO NOT PROCEED UNTIL HIS INSTRUCTIONS ARE OBTAINED.

LOCATE BUBBLERS ON UPHILL SIDE OF TREES. TREE BUBBLERS ARE FOR ESTABLISHMENT AND DROUGHT CONDITIONS. THEY ARE TO BE TURNED OFF AFTER TREES ARE ESTABLISHED AND TURNED ON DURING DROUGHT CONDITIONS.

IN ADDITION TO THE SLEEVES AND CONDUITS SHOWN ON THE DRAWINGS, THE IRRIGATION CONTRACTOR SHALL BE RESPONSIBLE FOR COORDINATING THE INSTALLATION OF SLEEVES AND CONDUITS OF SUFFICIENT SIZE UNDER ALL PAVED AREAS.

ALL EXCAVATIONS ARE TO BE FILLED WITH COMPACTED BACKFILL. CONTRACTOR TO REPAIR ALL SETTLED TRENCHES PROMPTLY, FOR A ERIOD OF 1 YEAR AFTER COMPLETION OF WORK. ADDITIONALLY, CONTRACTOR SHALL WARRANT THAT THE IRRIGATION SYSTEM WILL BE FREE

THE SPRINKLER SYSTEM DESIGN IS BASED ON THE MINIMUM OPERATING PRESSURE SHOWN ON THE IRRIGATION DRAWINGS. THE RRIGATION CONTRACTOR SHALL VERIFY WATER PRESSURE PRIOR TO CONSTRUCTION. REPORT ANY DIFFERENCE BETWEEN THE WATER PRESSURE INDICATED ON THE DRAWINGS AND THE ACTUAL PRESSURE READING AT THE IRRIGATION POINT OF CONNECTION TO THE OWNER'S AUTHORIZED REPRESENTATIVE.

IRRIGATION DEMAND: 19 GPM at 75 PSI.

OPERATE IRRIGATION CONTROLLER(S) BETWEEN THE HOURS OF 10:00 PM AND 7:00 AM.

IRRIGATION CONTRACTOR TO NOTIFY ALL LOCAL JURISDICTIONS FOR INSPECTION AND TESTING OF INSTALLED BACKFLOW PREVENTION DEVICE.

THE CONTRACTOR SHALL NOTIFY UNDERGROUND SERVICE ALERT AT 811 AT LEAST 48 HOURS PRIOR TO ANY EXCAVATION.

ROM DEFECTS IN MATERIALS AND WORKMANSHIP FOR A PERIOD OF 1 YEAR AFTER FINAL ACCEPTANCE OF WORK.

DRIPLINE NOTES:

1. PLANS ARE DIAGRAMMATIC. INSTALL DRIPLINE AND COMPONENTS PER MANUFACTURERS INSTRUCTIONS AND INSTALLATION DETAILS.

2. INSTALL DRIPLINE A MAXIMUM OF 18" APART (12" IN BIORETENTION/TURF AREAS) WITH EMITTERS TRIANGULARLY SPACED. INSTALL 2" FROM PERIMETER OF PLANTED AREA. THERE SHOULD BE A MINIMUM OF TWO DRIPLINE LATERALS IN EACH PLANTED AREA. DRIPLINE SHALL BE INSTALLED AT A CONSISTANT DEPTH THROUGHOUT THE CIRCUIT.

3. PLACE AIR/VACUUM RELIEF VALVES AT THE HIGHEST POINTS OF EACH ZONE AND JUST BELOW CHECK VALVES ON SLOPES. INSTALL ONE AIR/VACUUM RELIEF VALVE FOR EVERY 750' OF TOTAL DRIPLINE PER ZONE.

4. PLACE FLUSH VALVES AT THE HYDRAULIC CENTER OF THE EXHAUST HEADER OR AT LOW POINT ON SLOPES. INSTALL MINIMUM OF ONE FOR EVERY 15 GPM.

5. INSTALL IN-LINE CHECK VALVES ON SLOPES GREATER THAN 3% AND WHERE LOW-LINE DRAINAGE COULD CAUSE WET AREAS IN THE LOWEST AREAS OF AN IRRIGATION ZONE. CHECK VALVES SHALL BE PLACED EVERY 4-5 FEET BETWEEN DRIPLINE LATERALS AND BEFORE THE FLUSH VALVE.

6. ON ALL SLOPES AND MOUNDS, PLACE THE DRIPLINE LATERALS PARALLEL TO THE SLOPE CONTOUR WHERE POSSIBLE. INCREASE THE LATERAL SPACING BY 25% ON THE LOWER ONE-THIRD OF THE SLOPE TO AVOID EXCESS DRAINAGE.

7. PVC SUPPLY AND FLUSH LINE SIZING GUIDE (ALL SUPPLY AND FLUSH LINES SHALL BE THE SAME SIZE FOR THE ENTIRE ZONE):

• 0-8 GPM – 3/4" • 8.1-15 GPM – 1"

• 15.1-25 GPM – 1 1/4"

8. FITTINGS SHALL BE OF THE SAME MANUFACTURER AS DRIPLINE.

9. STAPLE DRIPLINE TO GROUND EVERY 3 FEET. USE ADDITIONAL STAPLES OVER EACH TEE, ELBOW OR CROSS. USE U-SHAPED STAPLES TO AVOID PINCHING THE DRIPLINE.

10. THOROUGHLY FLUSH EACH INSTALLATION SEGMENT TO ENSURE NO DEBRIS CONTAMINATION OCCURS.

11. IN TURF OR NOW-MOW GRASS AREAS, A TEMPORARY OVERHEAD SPRAY SYSTEM WILL NEED TO BE PROVIDED UNTIL THE TURF SEED OR SOD IS ESTABLISHED. OVERHEAD WATERING CAN BE DISCONTINUED WHEN EDGES OF THE SOD CANNOT BE PULLED UP. RUN THE DRIPLINE SYSTEM SEVERAL TIMES DAILY IN ADDITION TO THE TEMPORARY OVERHEAD SYSTEM.

12. RUN THE DRIPLINE SYSTEM EVERY DAY OR EVERY OTHER DAY TO ESTABLISH PLANT MATERIAL. MAINTAIN A CONSISTENT MOISTURE BALANCE IN THE SOIL. IT IS IMPORTANT TO KEEP THE SOIL MOIST WITHOUT SATURATION.

SINGLE OUTLET DRIP EMITTER IRRIGATION NOTES

1. THE CONTRACTOR SHALL PROVIDE A DRIP EMITTER SYSTEM FOR ALL SHRUBS AS INDICATED ON THE IRRIGATION PLAN AND DETAILS.

2. ACTUAL LAYOUT OF EMITTER SYSTEM SHALL BE DETERMINED BY THE CONTRACTOR IN THE FIELD USING THE IRRIGATION PLAN AND THE DRIP IRRIGATION DETAILS AS A GUIDE, WHILE USING THE PLANTING PLAN FOR THE LOCATION AND QUANTITIES OF EMITTERS.

3. EACH 15 GALLON SHRUB OR ESPALIER SHALL RECEIVE TWO 2 GPH EMITTER ON EITHER SIDE OF THE SHRUB, VIA DISTRIBUTION TUBING. EACH 1 GALLON SHRUB SHALL RECEIVE ONE 1 GPH EMITTER VIA DISTRIBUTION TUBING. REFER TO THE PLANTING PLAN FOR THE LOCATION AND QUANTITY OF SHRUBS.

4. INSTALL FLUSH PLUGS AT THE END OF THE RIGID PVC AS SHOWN ON PLANS.

5. THE DRIP EMITTER SYSTEM LAYOUT SHALL BE APPROVED BY THE LANDSCAPE ARCHITECT PRIOR TO BEGINNING CONSTRUCTION AND AFTER PLANTING HAS BEEN COMPLETED

IRRIGATION LEGEND

				FLOW RATE	MAX.	MAX.	DETAIL #
SYMBOL	MODEL NUMBER	DESCRIPTION	PSI	(GPM)	RADIUS		DETAIL#
Θ Φ	PROS-06-PRS40-CV-MP2000-90,180	HUNTER 6" POP-UP LAWN SPRAY W/MP ROTATOR	40	.19,.37	14'	12.5'	XX
A	PROS-06-PRS40-CV-MP3000-90	HUNTER 6" POP-UP LAWN SPRAY W/MP ROTATOR	40	.86	30'	22'	xx
∇	PROS-06-PRS40-CV-MP3000-180	HUNTER 6" POP-UP LAWN SPRAY W/MP ROTATOR	40	1.82	30'	22'	
•	T-DPCO4-DC-FOR 1 GALLON PLANTS T-DPCO8-DC-RED-FOR 15 GALLON PLANTS	TORO NGE PRESSURE COMPENSATING EMITTER TORO NGE PRESSURE COMPENSATING EMITTER	40 40	1 GPH 2 GPH	- -	- -	
•	PCN-50	HUNTER PRESSURE COMPENSATING BUBBLER INSTALL ONE PER TREE	30	.5	-	-	XX
Δ	RZWS-18-50-CV	HUNTER ROOT WATERING SYSTEM INSTALL ONE PER TREE	30	.5	-	-	xx
	T-DL-MP9	TORO DL2000 POP-UP OPERATION INDICATOR					XX
NOT SHOWN	T-YD-500-34	TORO DL2000 AIR/VACUUM RELIEF VALVE					XX
•	T-FCH-H-FIPT	TORO DL2000 FLUSHING VALVE					XX
•	COMPRESSION FITTING STUB-OUT FROM P	/C RIGID PIPE TO POLY TUBING					XX
							XX
							xx
							XX
•	P220-27 SERIES / LT-T SERIES TORO REMOTE CONTROL VALVE WITH PRESSURE REGULATION AND KBI PVC BALL VA						
5	DZK-700-1-LF	1-LF TORO DRIP ZONE VALVE KIT (W/150 MESH SCREEN FILTER, PRE-SET 25 PSI REGULATOR/KBI PVC BALL VALVE					xx
H	T-113-LF	NIBCO LEAD FREE GATE VALVE (LINE SIZE)					
(MC-18E	IRRITROL 18 STATION CONTROLLER - WALL MOUNTED IN STAINLESS STEEL TOP ENTRY ENCLOSURE					
R	CL-100-WIRELESS	IRRITROL CLIMATE LOGIC WIRELESS WEATHER STATION					
		CONTROLLER AND STATION NUMBER					
C-1 .38	3	APPLICATION RATE (INCHES)					\ \ \ \ \ \ \ \ \ \ \ \ \ \ \ \ \ \ \
1" 15 25/	/1 -	OPERATING PRESSURE (PSI) or AIR RELIEF VALVE QUAI	YTITY				XX
		APPROXIMATE GALLONS PER MINUTE					
		REMOTE CONTROL VALVE SIZE					XX
		MAIN LINE: 1120-SCHEDULE 40 PVC SOLVENT WELD PLA SCHEDULE 40 PVC SOLVENT WELD FITTINGS. 18" COVER		PIPE WITH SCHE	EDULE 80 A	ND	xx
		LATERAL LINE: 1120-CLASS 200 PSI PVC SOLVENT WELD SOLVENT WELD FITTINGS. 12" COVER.	PIPE \	WITH SCHEDUL	E 40 PVC		xx
		SUB-SURFACE DRIPLINE BENEATH PLANTERS OF SHRU ROOT GUARD. USE ONLY DL2000 DRIPLINE LOC-EZE FIT .53 GPH PER EMITTER)					xx
		DRIP TUBING: TORO BLUE STRIPE POLYETHELENE HOS TORO 1/4" BLUE STRIPE DISTRIBUTION TUBING FOR EAC FITTINGS.					,,,

IRRIGATION LEGEND

BROOKWATER

IRRIGATION CONSULTANTS P.O. BOX 1967

GARDNERVILLE, NV 89410 TEL 775-266-3589, CELL 510-816-1796 E-MAIL ANN@BROOKWATER.COM

-VISION 5 SHAHRAM BIJAM : 415.902.4212

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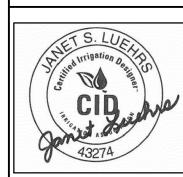
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415.626.8977

ADOBE ASSOCIATES INC SANTA ROSA, CA 95401 707.541.2300

CHRISTOPHER YATES LANDSCAPE ARCHITECTURE 265 INDIANA ST. SAN RANCISCO. CA 94107 415.926.5775



AND NOTES

05/10/19 CALE DRAWN:

1012IMMO

1211 Broadway, Sonoma, CA				
HYDROZONE SUMMARY				
*Hydrozone Description	Total Sq. Ft.	% of Landscape		
Cool Season Turf (CST)	0	0.0%		
Warm Season Turf (WST)	0	0.0%		
High Water Use Plants (HW)	0	0.0%		
Bioretention Plants (BR)	0	0.0%		
Medium Water Use Plants (MW)	4,870	40.8%		
Low Water Use Plants (LW)	7,069	59.2%		
Very Low Water Use Plants (VLW)	0	0.0%		
Water Feature	0	0.0%		
Special Landscape Area (SLA)	0	0.0%		
TOTAL	11,939	100.0%		

**Irrigation Method	Total Sq. Ft.	% of Landscape
Rotor (FC-R, PC-R)	0	0.0%
Multi-Stream Rotator (MR)	6,968	58.4%
Spray (S)	2,371	19.9%
Bubbler (B)	252	2.1%
Drip (D)	1,013	8.5%
In-Line Drip (DL)	1,335	11.2%
Micro Spray (MS)	0	0.0%
Other (O)	0	0.0%
	11,939	

CITY OF

Sonoma

LANDSCAPE WATER USE STATEMENT

PROJECT NAME: 1211 Broadway, Sonoma, CA PROJECT ADDRESS: 1211 Broadway, Sonoma, CA

PREPARED BY: JANET LUEHRS (CID, CLIA #43274)

BROOKWATER INC., IRRIGATION CONSULTANTS

480 SAINT JOHN STREET, SUITE 220

PLEASANTON, CA 94566 925-855-0417

925-855-0357 (FAX)

Janet@Brookwater.com (e-mail)

"I have complied with the criteria of the Water Efficient Landscape Ordinance and applied them accordingly for the efficient use of water in the irrigation design plan."

Signed: Janet Luchus

ART ONE	MAXIMUM APPLIED WATER ALLOWANCE (MAWA)	
		$MAWA = ETo \times .62 \times [(ETAF \times HA) + ((1-ETAF) \times SLA)]$
	YEARLY ETo	44.0
	CONVERSION FACTOR	0.62
	ETAF	0.55
	TOTAL IRRIGATED LANDSCAPE AREA (HA)	11,939 SQUARE FEET
	SPECIAL LANDSCAPE AREA (SLA)	0 SQUARE FEET
	LANDSCAPE WATER ALLOWANCE	178,929 GALLONS PER YEAR
	TOTAL ACRE FEET	0.55 ACRE FEET
ART TWO	ESTIMATED TOTAL WATER USE (ETWU)	

PART TWO	ESTIMATED TOTAL WATER USE (ETWU)	
	(AVERAGE <i>ETAF</i> AND <i>ETWU</i> FROM WATER EFF	ICIENT LANDSCAPE WORKSHEET
	AVERAGE ETAF FOR REGULAR LANDSCAPE AREAS (TOTAL ETAF x AREA / TOTAL AREA)	0.50
	ETWU FOR REGULAR LANDSCAPE AREAS	162,073 GALLONS PER YEAR
	SITE WIDE ETAF	0.50
	ETWU FOR ALL LANDSCAPE AREAS	162,073 GALLONS PER YEAR
	TOTAL ACRE FEET	0.50 ACRE FEET

1211 Broadway, Sonoma, CA WATER EFFICIENT LANDSCAPE WORKSHEET									
Reference Evapotranspiration (Eto)		43.95							
		HYDROZONE*	PLANT	IRRIGATION	IRRIGATION	ETAF	HYDROZONE	ETAF x	ESTIMATED
ZONE NO.	PLANT TYPE	(PLANT WATER USE)	FACTOR (PF)	METHOD**	EFFICIENCY (IE)	(PF/IE)	AREA (HA) (Sq Ft)	HA	TOTAL WATER USE (ETWU)
	DSCAPE AREA	,	\ /		\ /	, ,	V / V = 1 - 7		- 1
C-1	TURF	LW	0.30	MR	0.75	0.40	2,634	1,054	28,710
C-2	TURF	LW	0.30	MR	0.75	0.40	1,864	746	20,317
C-3	TURF	LW	0.30	MR	0.75	0.40	1,864	746	20,317
C-4	TURF	LW	0.30	MR	0.75	0.40	606	242	6,605
C-5	TREE	MW	0.50	В	0.81	0.62	25	15	421
C-6	TURF	MW	0.50	S	0.75	0.67	1,066	711	19,365
C-7	TURF	MW	0.50	S	0.75	0.67	1,305	870	23,707
C-8	TREE	MW	0.50	В	0.81	0.62	126	78	2,119
C-9	TURF	MW	0.50	DL	0.81	0.62	1,335	824	22,455
C-10	SHRUB	MW	0.50	D	0.81	0.62	1,013	625	17,039
C-11	TREE	LW	0.30	В	0.81	0.37	101	37	1,019
TOTALS (REGULAR LANDSCAPE AREAS)							11,939	5,948	162,073
`		,					,	•	·
SPECIAL LAND	SCAPE AREA								
	0			0		1.00	0	0	0
TOTALS (SPECIAL LANDSCAPE AREAS)							0	0	0
TOTALS FOR ALL AREAS							11,939	5,948	162,073



REVISION 5 05/10/1


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STANLEY SAITOWITZ |
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ADOBE ASSOCIATES INC 1220 N. DUTTON AVE SANTA ROSA, CA 95401 T: 707.541.2300

LANDSCAPE:
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ARCHITECTURE
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WATER USE CALCULATIONS

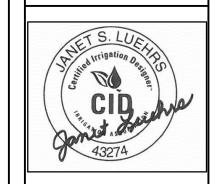PLANNING COMMISION