WILLIAMS COUNTY LAW ENFORCEMENT CENTER INFIRMARY

TELE 701.572.6759

3313 Main Street Suite 200, Williston ND 5880

WILLIAMS COUNTY

PROJECT DESCRIPTION

ISSUE DATES

WILLIAMS COUNTY

LAW ENFORCEMENT

CENTER INFIRMARY

WILLISTON

CONSULTANTS

206 EAST BROADWAY WILLISTON, ND

INDEX

GENERAL

G001 TITLE SHEET

G100 LIFE SAFETY PLAN

STRUCTURAL

S001 GENERAL STRUCTURAL NOTES S002 MECHANICAL CUTOUT S201 ROOM EQUIPMENT INSTALL

ARCHITECTURAL

A021 WALL TYPES, GENERAL ARCHITECTURAL NOTES

A100 OVERALL FIRST FLOOR DEMOITION PLAN

A101 ENLARGED DEMOLITION PLANS

A200 OVERALL FLOOR PLAN

A201 ENLARGED FLOOR PLANS, BUILDING SECTION

A301 REFLECTED CEILING PLANS

A500 ENLARGED CELL PLANS & INTERIOR ELEVATIONS

A501 INTERIOR ELEVATIONS

A801 OPENING SCHEDULE, DOOR & FRAME TYPES, DETAILS

A901 FINISH PLAN

FIRE PROTECTION, PLUMBING & MECHANICAL

MECHANICAL SYMBOLS & LEGENDS

FIRST FLOOR FIRE PROTECTION DEMOLITION PLAN

FIRST FLOOR FIRE PROTECTION PLAN

BASEMENT & UNDERGROUND PLUMBING DEMOLITION PLANS

FIRST FLOOR PLUMBING DEMOLITION PLANS

BASEMENT PLUMBING PLANS

FIRST FLOOR PLUMBING PLANS

PLUMBING SCHEDULES, DETAILS & RISER DIAGRAMS

BASEMENT MECHANICAL DEMOLITION PLANS

M101 FIRST FLOOR MECHANICAL DEMOLITION PLANS

BASEMENT MECHANICAL PLANS

FIRST FLOOR HYDRONICS PLANS

M301 FIRST FLOOR VENTILATION PLANS

MECHANICAL DETAILS & SCHEDULES

ELECTRICAL

E001 ELECTRICAL LEGEND

E101 FIRST FLOOR ELECTRICAL DEMOLITION PLAN

E201 FIRST FLOOR POWER PLAN

E202 SECOND FLOOR PLAN-ELECTRICAL

E203 THIRD FLOOR PLAN-ELECTRICAL

E301 FIRST FLOOR LIGHTING PLAN E401 FIRST FLOOR SYSTEMS PLAN

E501 FIRST FLOOR FIRE ALARM PLAN

E601 FIRST FLOOR SECURITY PLAN

E801 SCHEDULE AND DETAILS

E901 SCHEDULES


E902 SCHEDULES


PROJECT LOCATION



REGISTRATION

I hereby certify that this plan, specification, or report was prepared by me or under my direct supervision and that I am a duly Registered Architect under the laws of the State of North

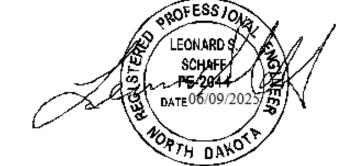

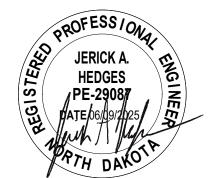

CD CONSTRUCTION DOCUMENTS MARK DESCRIPTION

| PROJECT NO: | 20232310 |
|-------------|----------|
| DRAWN BY: | BEY |
| CHECKED BY: | GL/MC |
| | |

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DRAWING TITLE

TITLE SHEET

G100

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jerick.hedges@eapc.net MINOT: (701) 839-4547 2080 36th Avenue SW, Suite 210 Minot, ND 58701

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STRUCTURAL ENGINEER SAM WILKE


sam.wilke@eapc.net FARGO: (701) 461-7464 112 N. Roberts St Suite 300 Fargo, ND 58102


STRUCTURAL DESIGNER (EIT)


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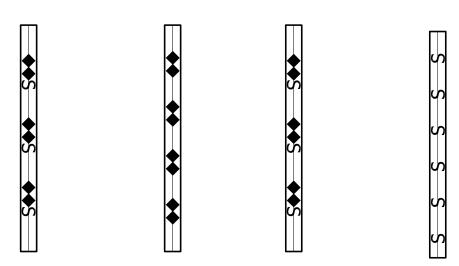




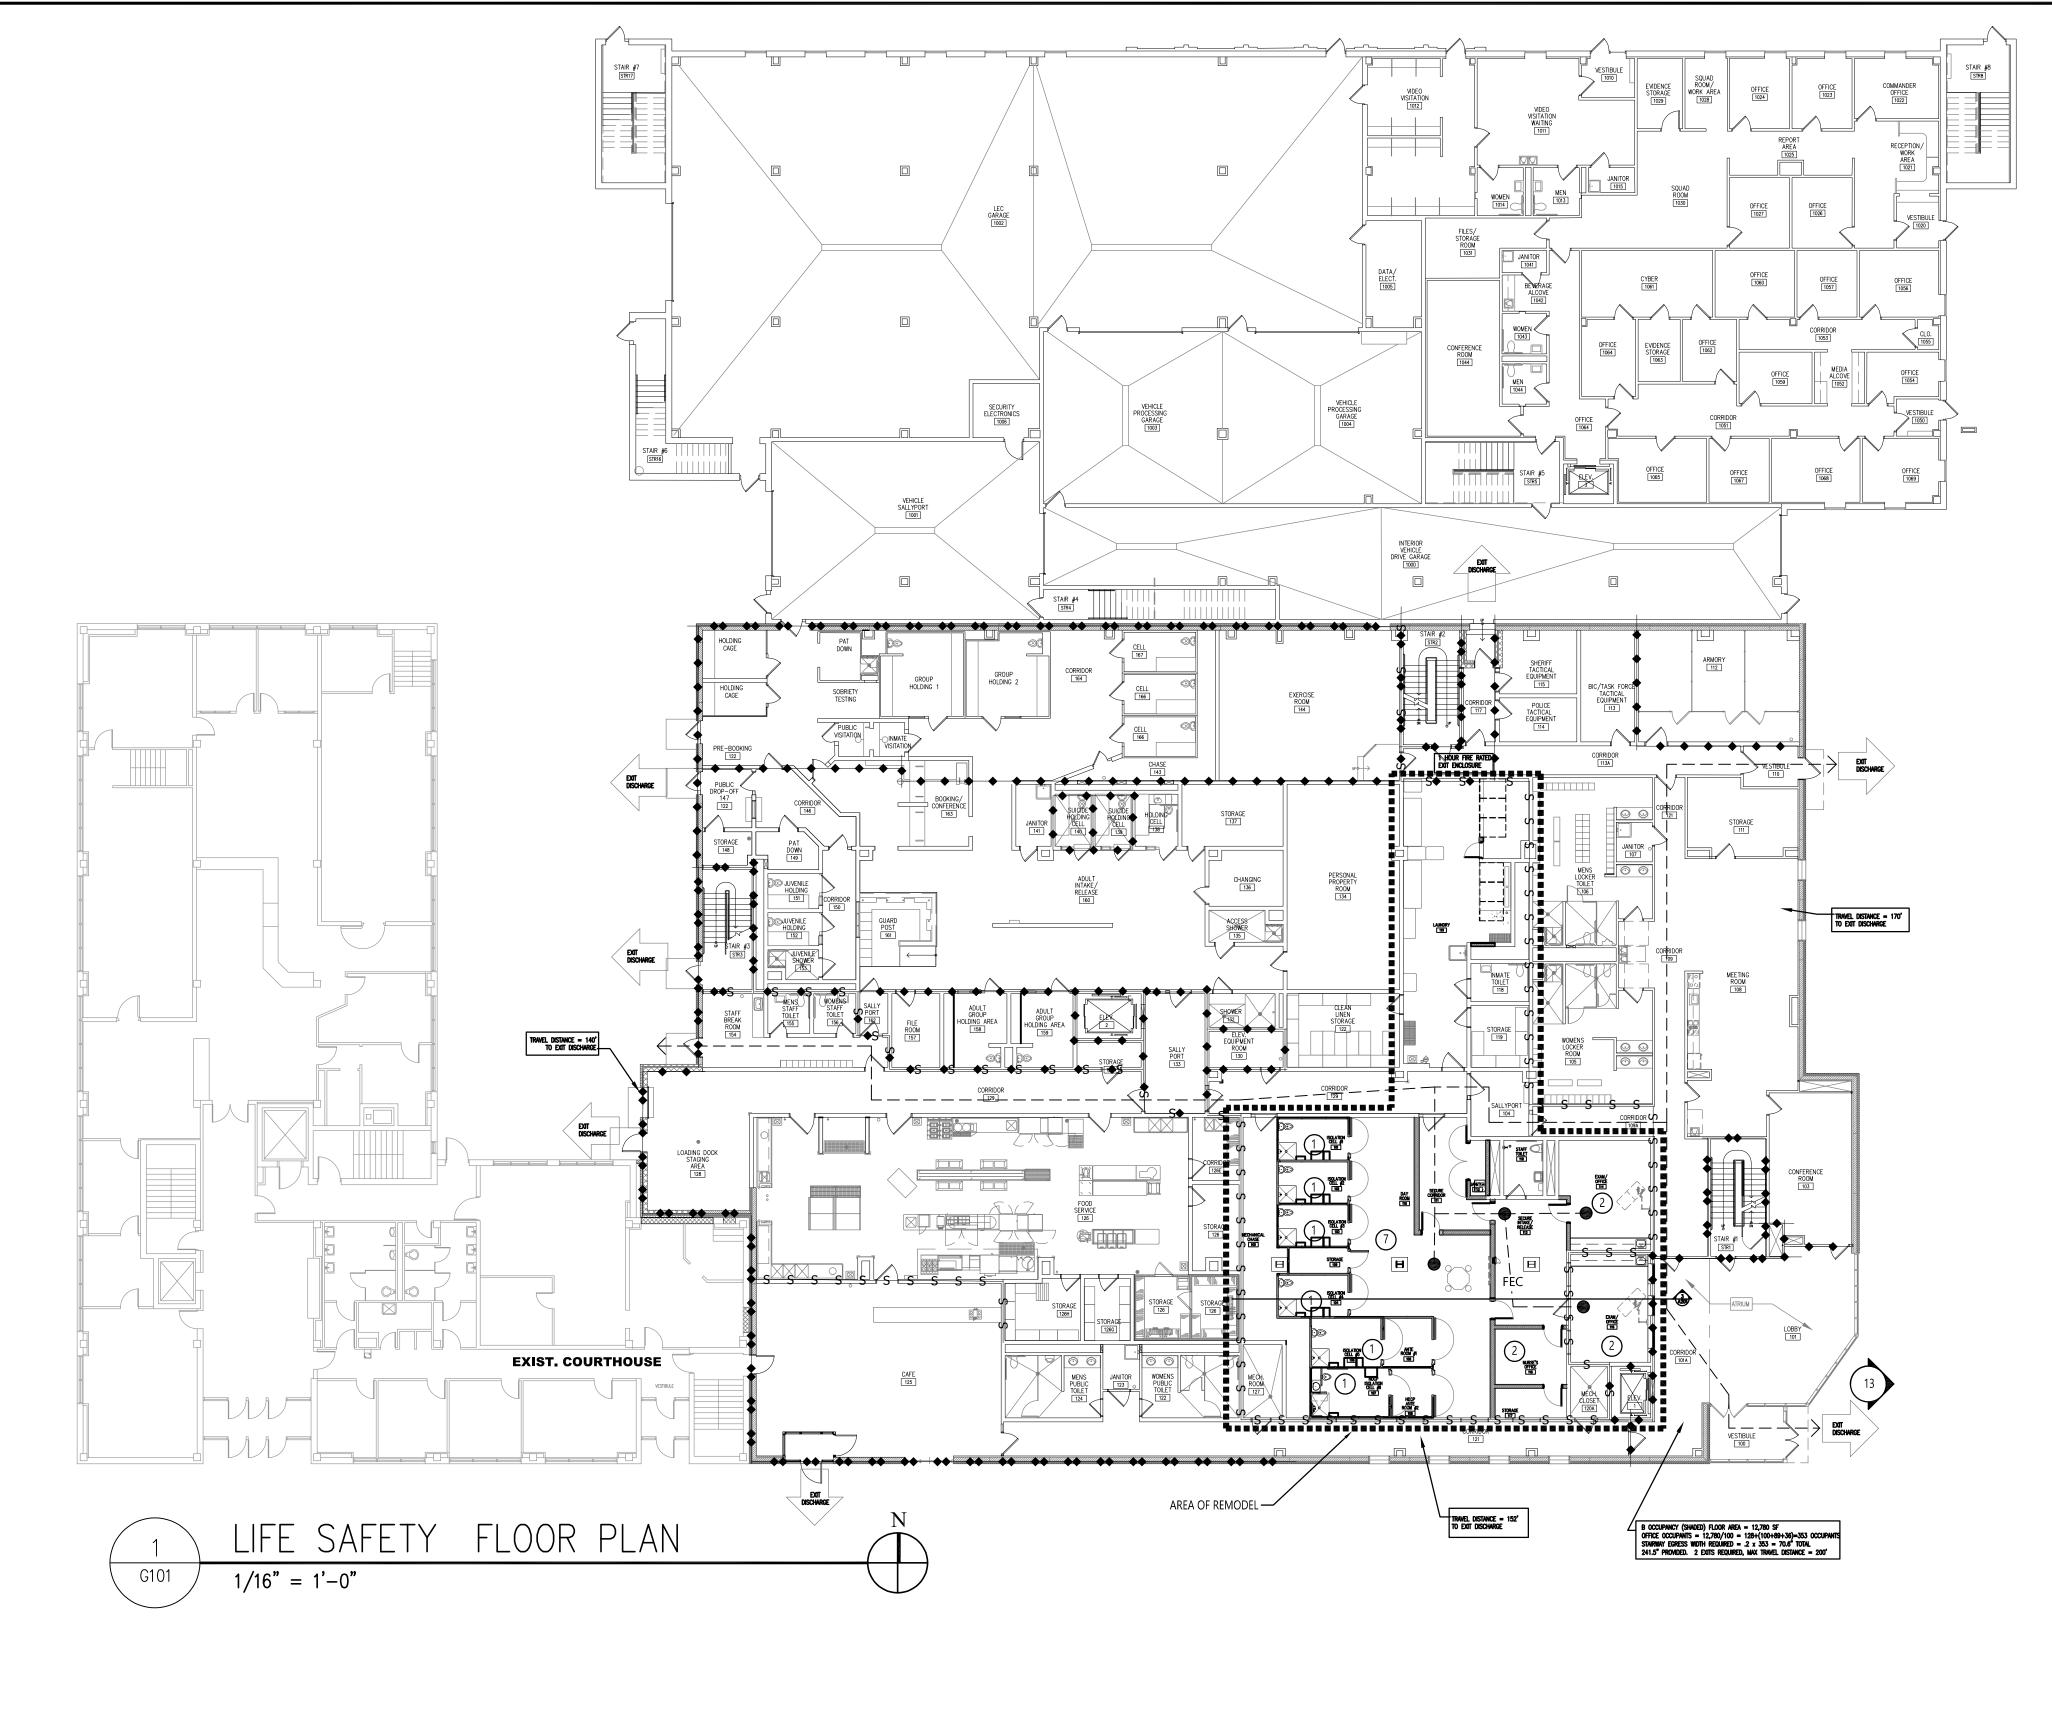

FIRE AND SMOKE WALL LEGEND

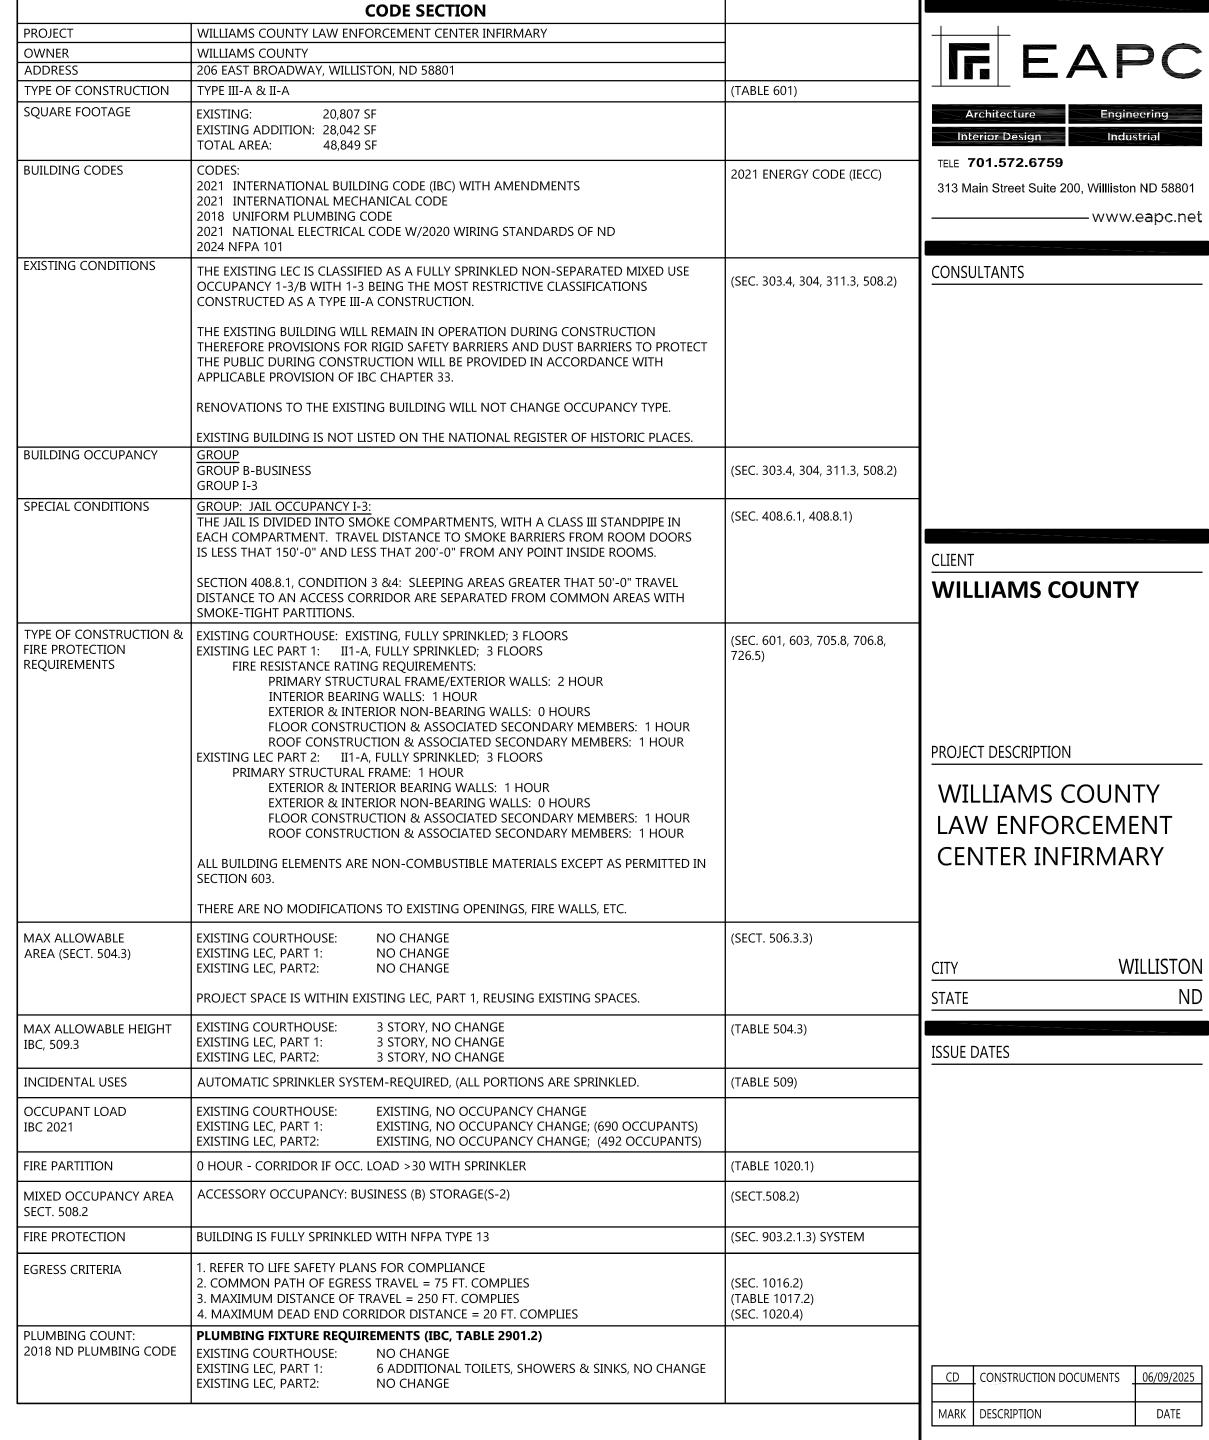2HR

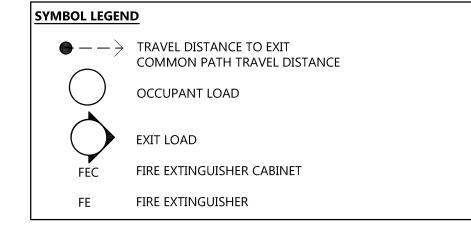

1HR FIRE

2HR FIRE

SMOKE WALL FIRE/SMOKE

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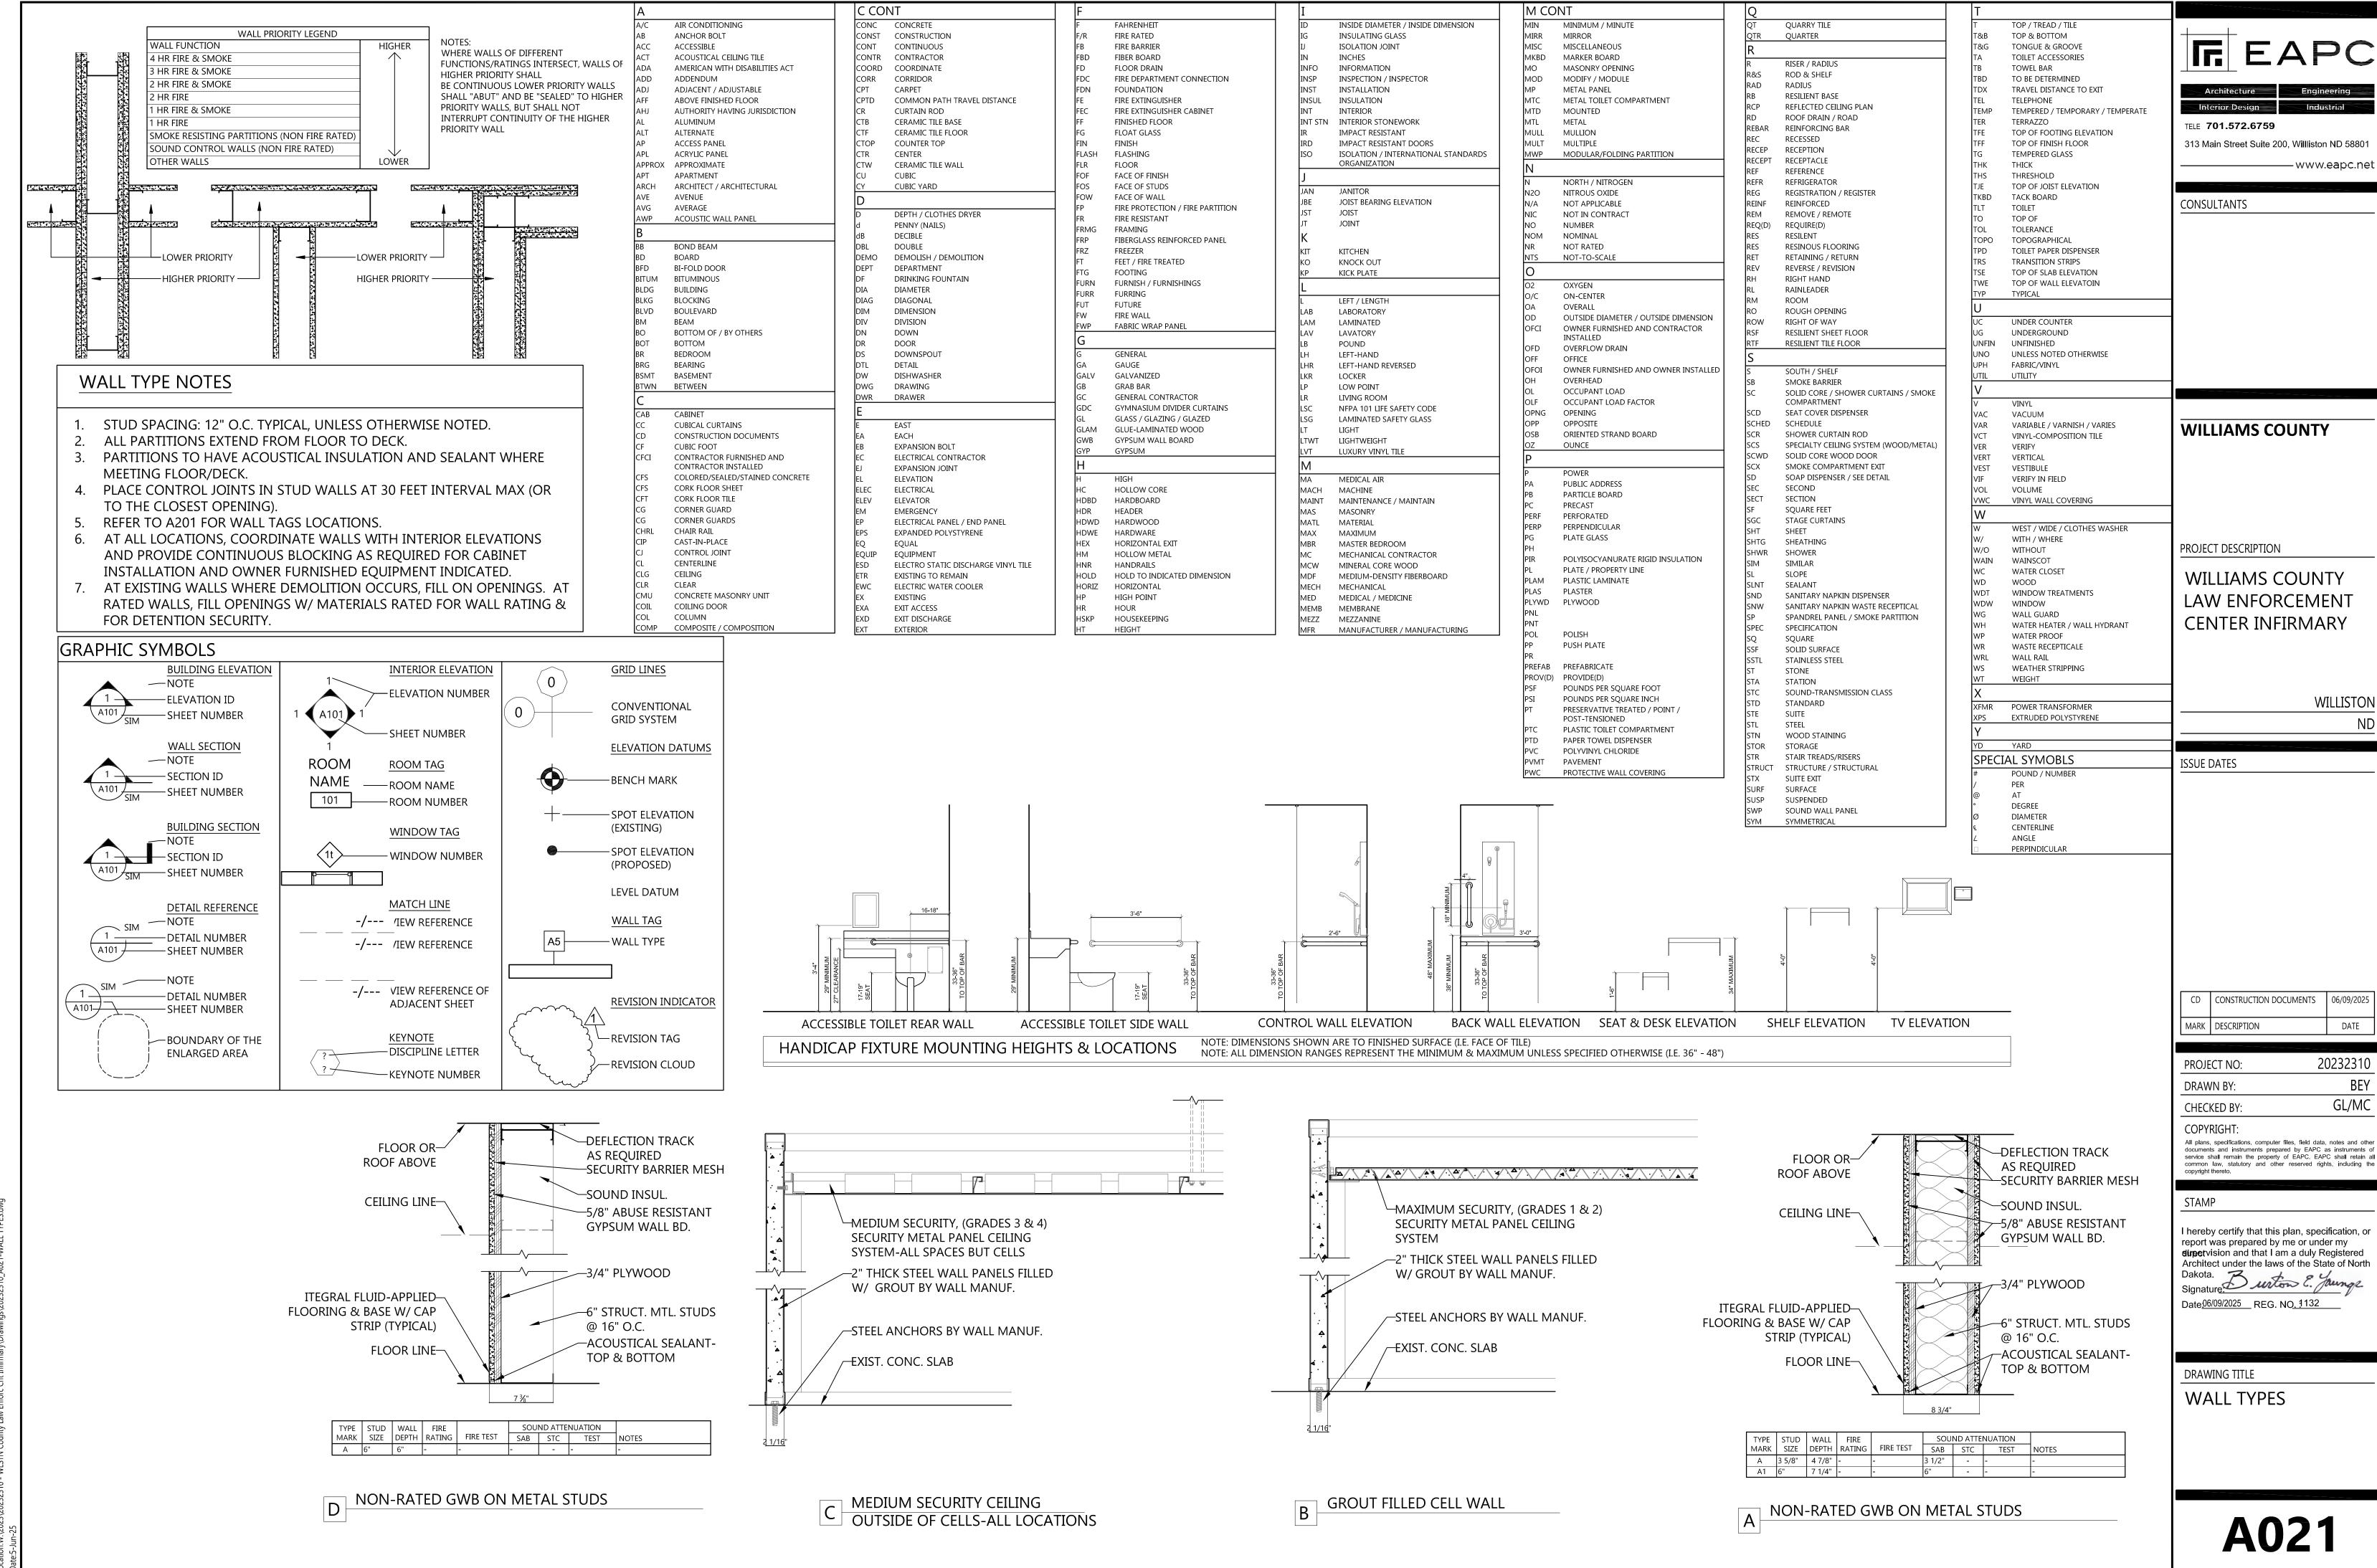
Architect under the laws of the State of North

Date: 06/09/2025 REG. NO. : 1132

CODE SHEET

20232310

GL/MC




A021

DATE

BEY

GL/MC

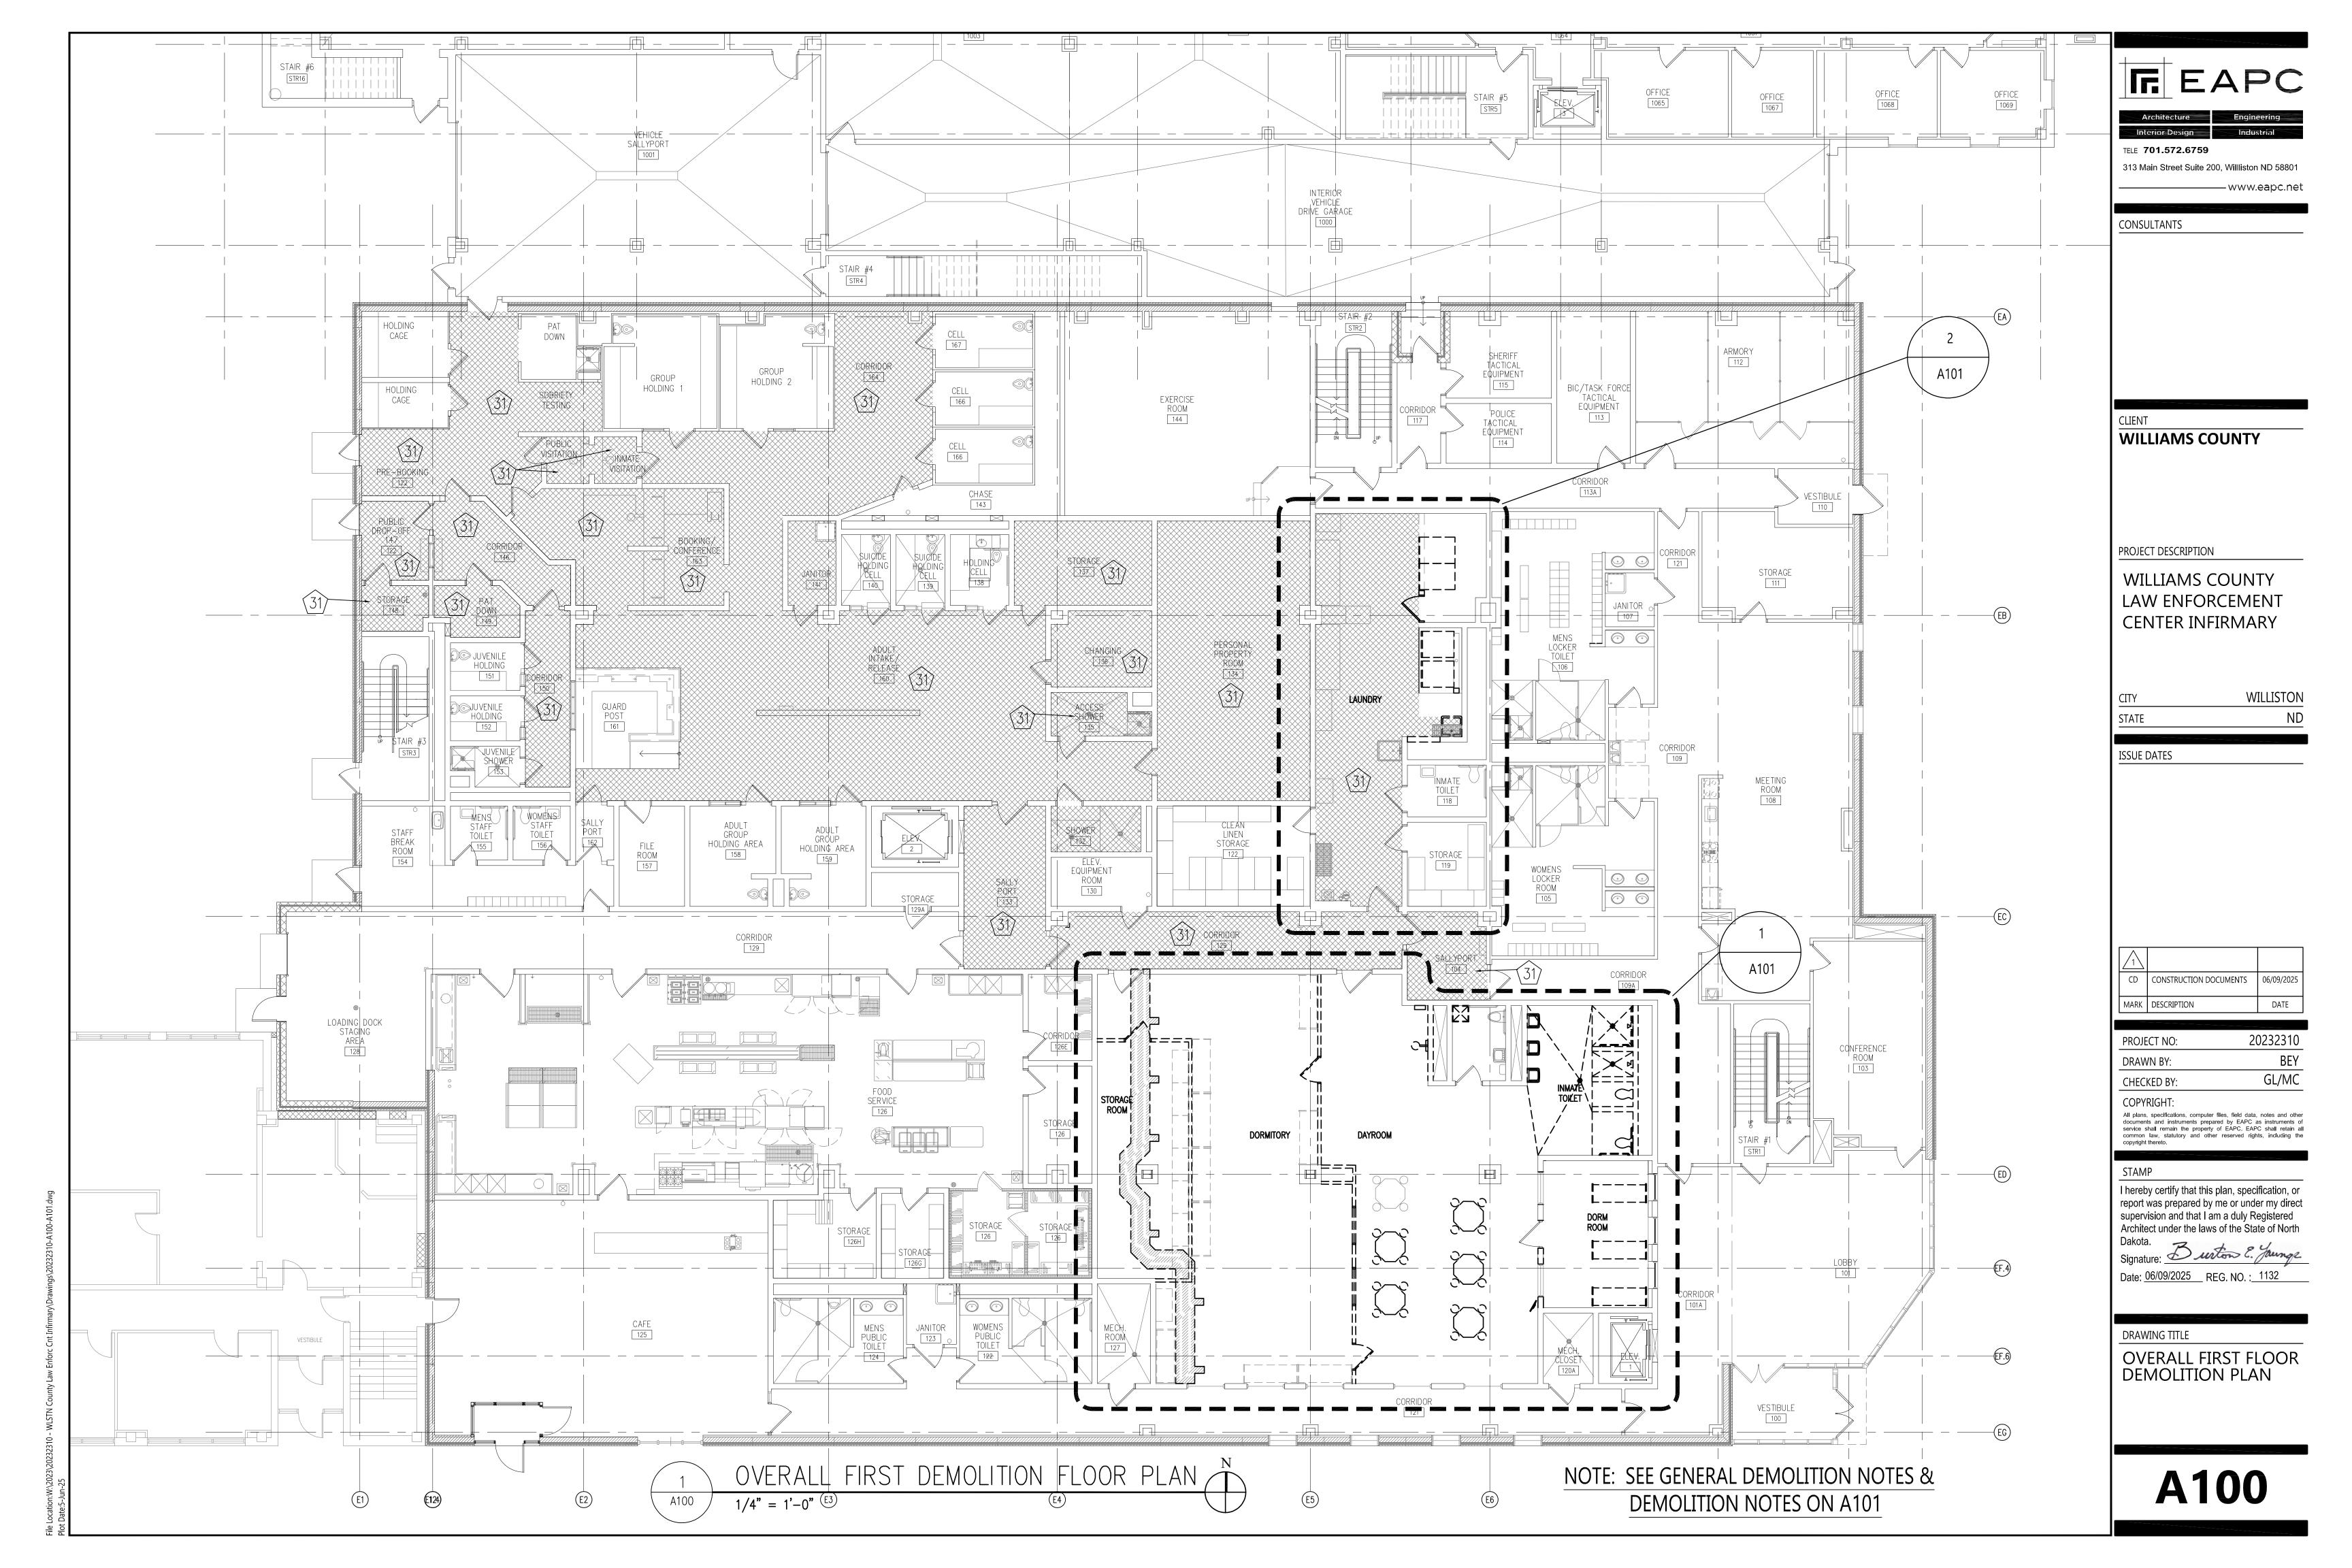

A. PATCH OR REPAIR ALL HOLES @ FLOORS, WALLS AND CEILINGS WHERE NEW FINISHES ARE INDICATED ON ROOM FINISH SCHEDULE OR AS NECESSARY TO MATCH EXISTING ADJACENT SURFACES TO INCLUDE GROUTING AND LEVELING FLOOR AND OR PLASTER PATCHING WALLS.

B. REMOVE FINISHES ON EXISTING FLOORS, WALLS, AND CEILINGS WHERE

NOTED OTHERWISE.

STORAGE

(18)(21)

28

127

NEW FINISHES ARE INDICATED ON ROOM FINISH SCHEDULE. UNLESS

- C. THE OWNER RESERVES THE RIGHT TO SALVAGE ANY OR ALL ITEMS SUBJECT TO DEMOLITION - WHEN ITEMS ARE REQUESTED TO BE TURNED OVER TO THE OWNER, THE OWNER WILL MAKE NECESSARY ARRANGEMENTS FOR TRANSPORTATION TO THE STORAGE LOCATION -ANY & ALL ITEMS NOT REQUESTED FOR OWNER SALVAGE SHALL BECOME THE PROPERTY OF THE CONTRACTOR AND SHALL BE DISPOSED
- OF PROPERLY. D. SEE MECHANICAL AND ELECTRICAL DRAWINGS FOR ADDITIONAL DEMOLITION. COORDINATE WITH PLUMBING AND ELECTRICAL CONTRACTORS AS NECESSARY TO CONDUCT WORK. CUT. PATCH & REPAIR TO RESTORE SURFACES TO BE READY FOR FINISHES, UNLESS
- OTHERWISE NOTED. WHEN TEMPORARY BARRIERS ARE PLACED IN CORRIDORS, ALLOW CLEARANCE FOR ACCESS OF OCCUPANTS TO THE ADJACENT AREAS.
- F. ALL EXISTING MOVABLE FURNITURE/EQUIPMENT WILL BE MOVED BY OWNER PRIOR TO CONSTRUCTION UNLESS OTHERWISE NOTED.
- G. ALL DEBRIS REMOVED FROM CONSTRUCTION AREA MUST BE COVERED WHEN TRANSPORTED FROM BUILDING.

_ _ _ _ _ _ _

- **DEMOLITION NOTES:**
- (1.) REMOVE EXISTING BUNKS & TURN OVER TO THE OWNER.
- (2.) REMOVE EXIST. SHELVING & TURN OVER TO THE OWNER. REMOVE EXIST. FLOOR MOUNTED SECURITY TABLES W/ SEATS & TURN OVER TO THE OWNER.
- 4.) REMOVE EXIST, WALL MOUNTED SECURITY SEAT & TURN OVER TO THE OWNER.
- REMOVE EXIST. WALL MOUNTED TABLET CHARGER & TURN OVER TO THE OWNER.
- REMOVE EXIST. WALL MOUNTED INMATE COMMUNICATION KIOSK & TURN OVER TO OWNER.
- (7.) REMOVE EXIST. FLOOR SINK & FAUCET, CAP ALL LINES. VERIFY W/ MECHANICAL. (8.) REMOVE EXIST. WALL MOUNTED LAVATORY & MIRRORS, CAP ALL LINES. TURN MIRRORS OVER TO THE OWNER.
- VERIFY W/ MECHANICAL.
- 9.) REMOVE EXIST. WALL MOUNTED SECURITY HANDICAP SHOWER UNIT, ROBE HOOK, SHOWER ROD, & GRAB BARS. TURN OVER TO THE OWNER. CAP ALL LINES, VERIFY W/ MECHANICAL.
- (10.) REMOVE EXIST. WALL MOUNTED SECURITY SHOWER UNIT & SHOWER ROD. TURN OVER TO THE OWNER. CAP
- ALL LINES VERIFY W/ MECHANICAL. (11.) REMOVE EXIST. FLOOR MOUNTED SECURITY TOILET UNIT, SHOWER ROD & CAP ALL LINES. CAP ALL LINES,
- (12.) REMOVE EXIST. FLOOR MOUNTED SECURITY HANDICAP TOILET UNIT, SHOWER ROD, & GRAB BARS. TURN GRAB BARS & SHOWER ROD OVER TO THE OWNER. CAP ALL LINES VERIFY W/ MECHANICAL.
- (13.) CAP FLOOR DRAINS & LEVEL FLOOR. CAP ALL LINES, VERIFY W/ MECHANICAL.

DAYROOM

±===={|

18/21

CORRIDOR

121

- (14.) REMOVE EXIST. BROKEN SECURITY GLAZING & REPLACE W/ NEW SECURITY GLAZING AS SPECIFIED.
- 15.) REMOVE EXIST. WALL MOUNTED TELEVISION & SECURITY WIRE BOX. TURN OVER TO THE OWNER.
- 16.) REMOVE EXIST. DOOR, FRAME, & HARDWARE. TURN OVER TO THE OWNER.
- 7.) REMOVE EXIST. ONE-WAY WINDOWS. TURN OVER TO THE OWNER.
- 18.) COMPLETELY REMOVE EXIST. CEILING.
- (19.) COMPLETELY REMOVE EXIST. WALL & BASE.
- (20.) EXIST. MASONRY COLUMNS TO REMAIN.
- (21.) REMOVE EXIST. SECURITY CAMERAS & TURN OVER TO THE OWNER.
- 22.) REMOVE EXIST. DRYERS, TURN OVER TO THE OWNER.
- (23.) REMOVE EXIST. WASHING MACHINES, TURN OVER TO THE OWNER.
- (24.) EXIST. CONC. WASHING MACHINE PEDESTAL TO REMAIN. MODIFY PER DRAWINGS & MECH.
- 25.) REMOVE & SALVAGE EXIST. SLOP SINK & FAUCET FOR RELOCATION.
- (26.) Remove exist. Floor & Base. See A900 Series Sheets for Floor Replacement. (27.) Remove exist. Drywall & MTL. Stud Wall and Masonry above.
- (28.) SAW CUT & REMOVE EXIST. CONC. SLAB COORDINATE W/ MECH. & PLUMBING. CONTRACTOR.
- (29.) PREPARE EXIST. SLOPED CONC. FOR LEVELING MATERIALS. CUT DOWN PER MANUFACTURERS RECOMMENDATIONS MINIMUM 1".

CORRIDOR

109A

ドナーーーゴ

__=====

DORM

ROOM

MÉCH CLOSE 120A

- (30.) REMOVE, STORE, & REINSTALL EXIST. MTL. TABLE & SEATS
- (31.) NOTE ON A100. SEE A900 SERIES SHEETS FOR FLOOR REPLACEMENT.

WILLIAMS COUNTY

Interior Design

313 Main Street Suite 200, Willliston ND 58801

-----www.eapc.net

TELE **701.572.6759**

CONSULTANTS

PROJECT DESCRIPTION

WILLIAMS COUNTY LAW ENFORCEMENT **CENTER INFIRMARY**

WILLISTON ND STATE

ISSUE DATES

CONSTRUCTION DOCUMENTS MARK DESCRIPTION

20232310 PROJECT NO: BEY DRAWN BY: GL/MC CHECKED BY:

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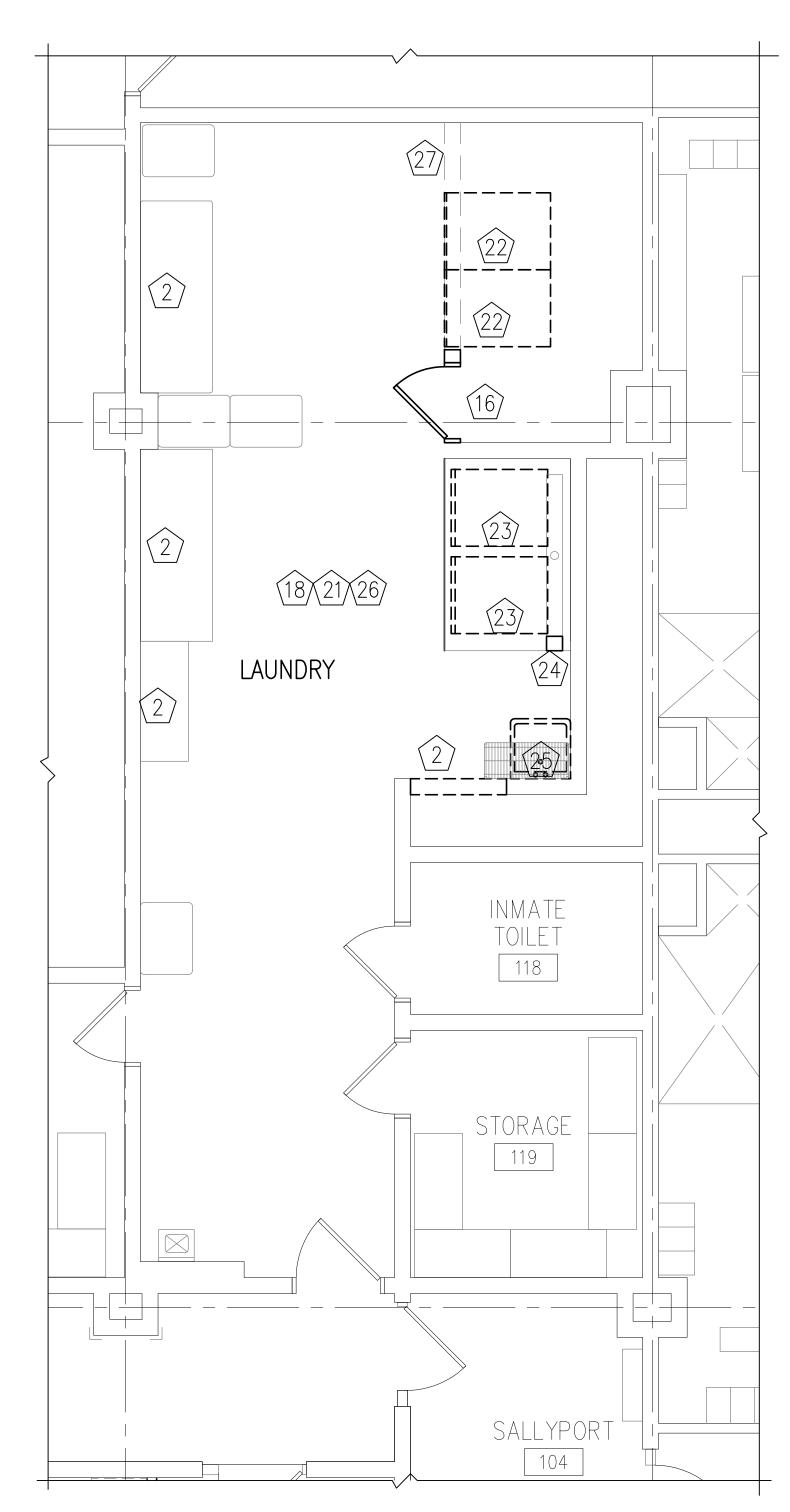
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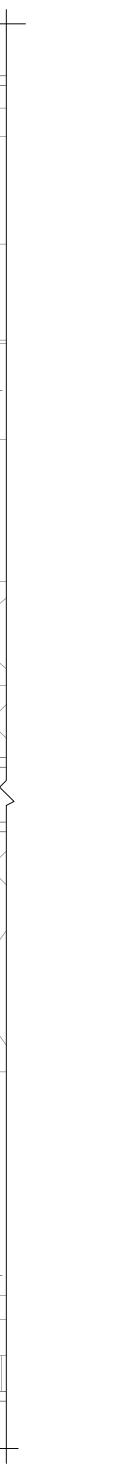
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Signature: Durton E. Jaunge Date: 06/09/2025 REG. NO. : 1132

DRAWING TITLE EXIST. FIRST FLOOR PLAN

A101







1/4" = 1'-0"


DORMITORY

18/21


ENLARGED DEMOLITION FLOOR PLAN






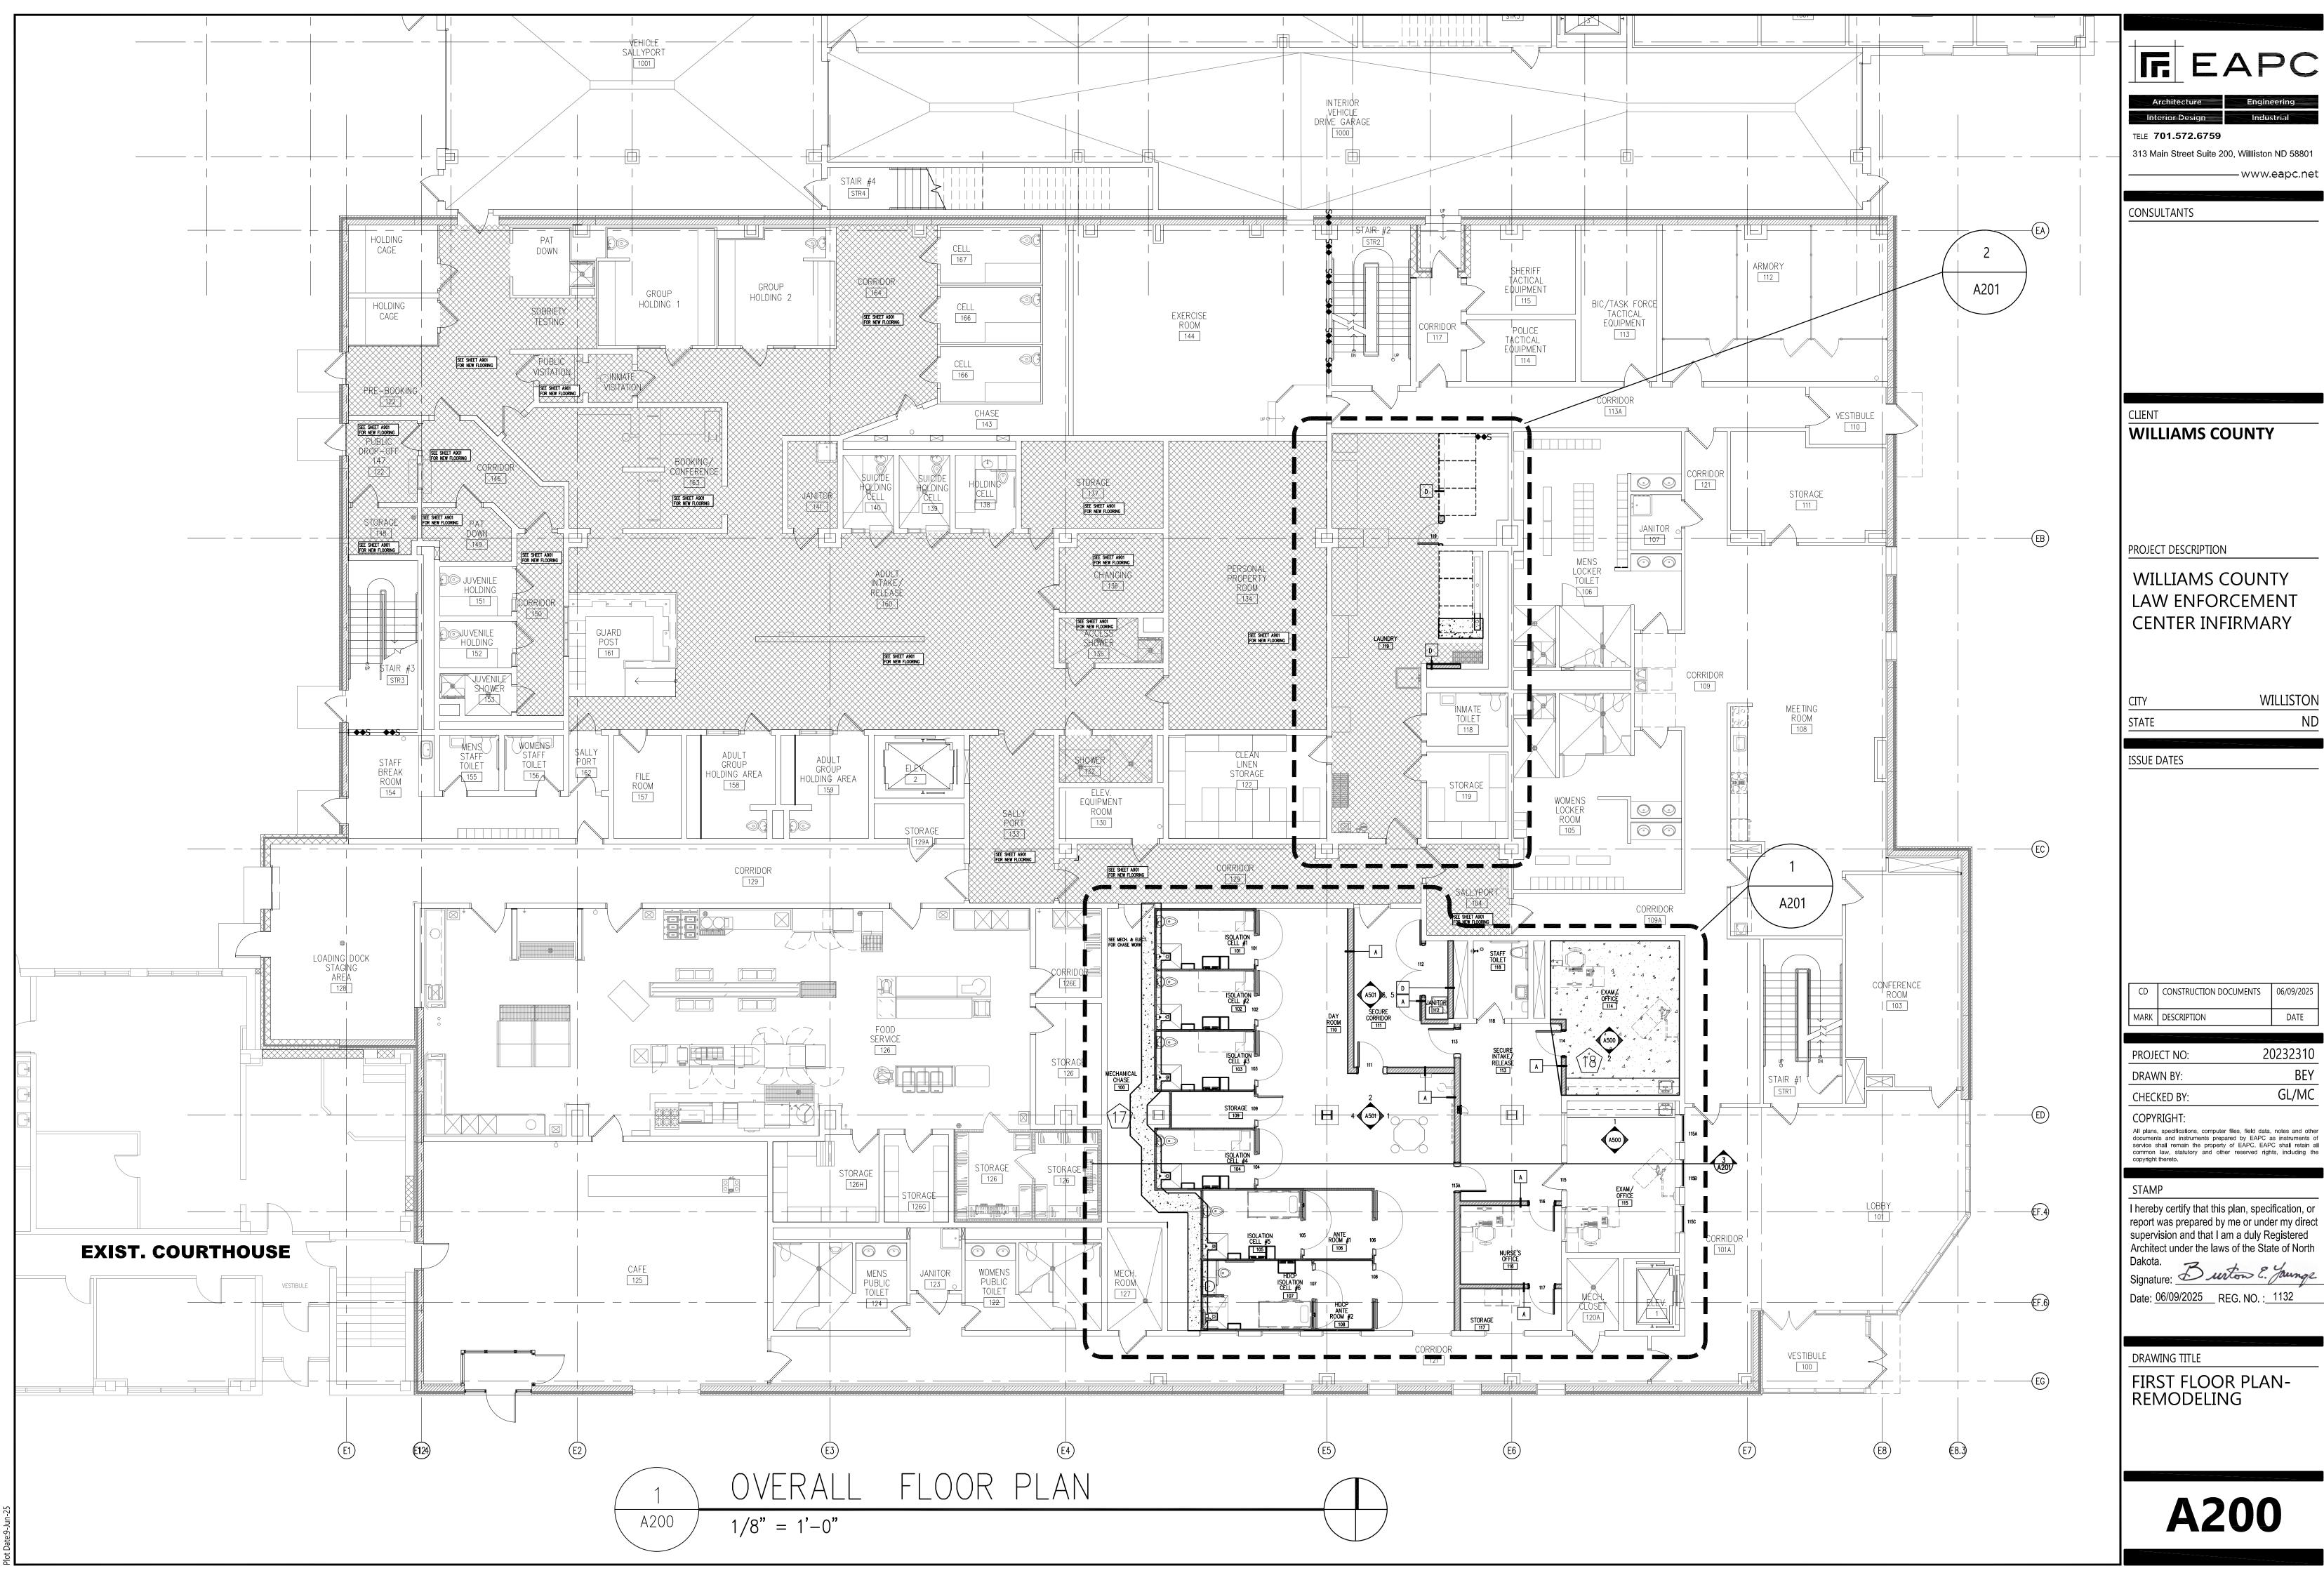


F. EAPC

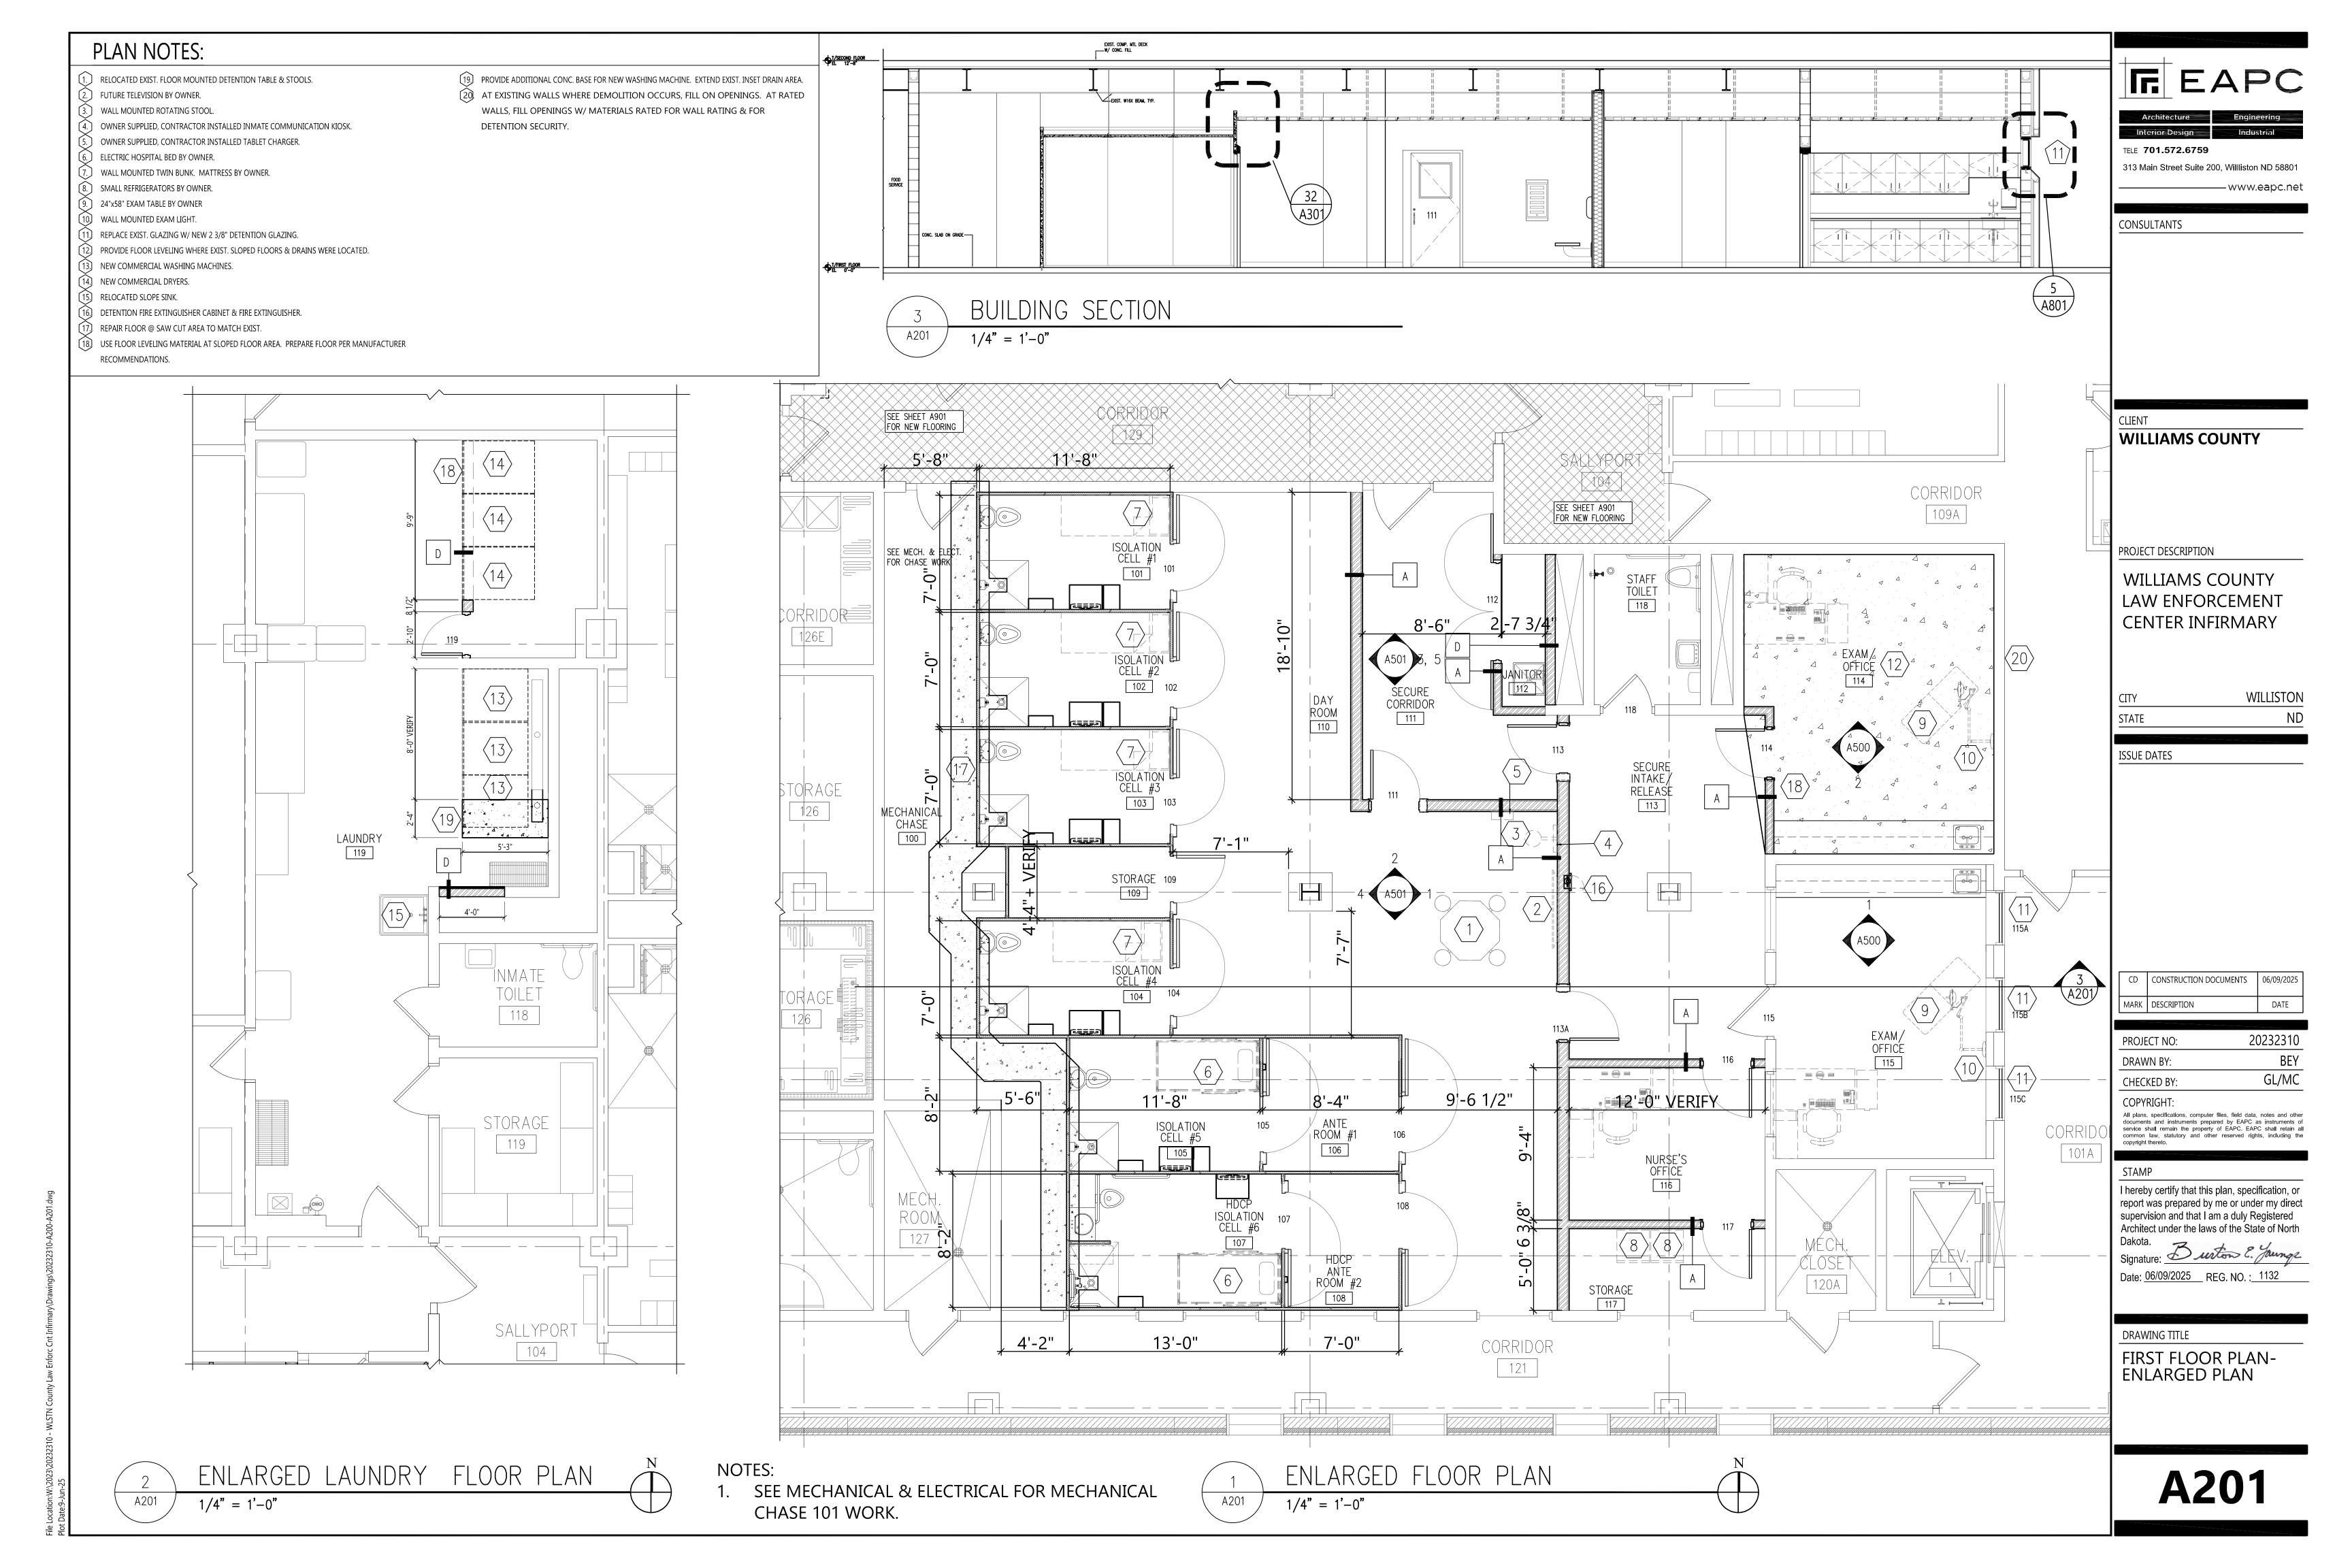

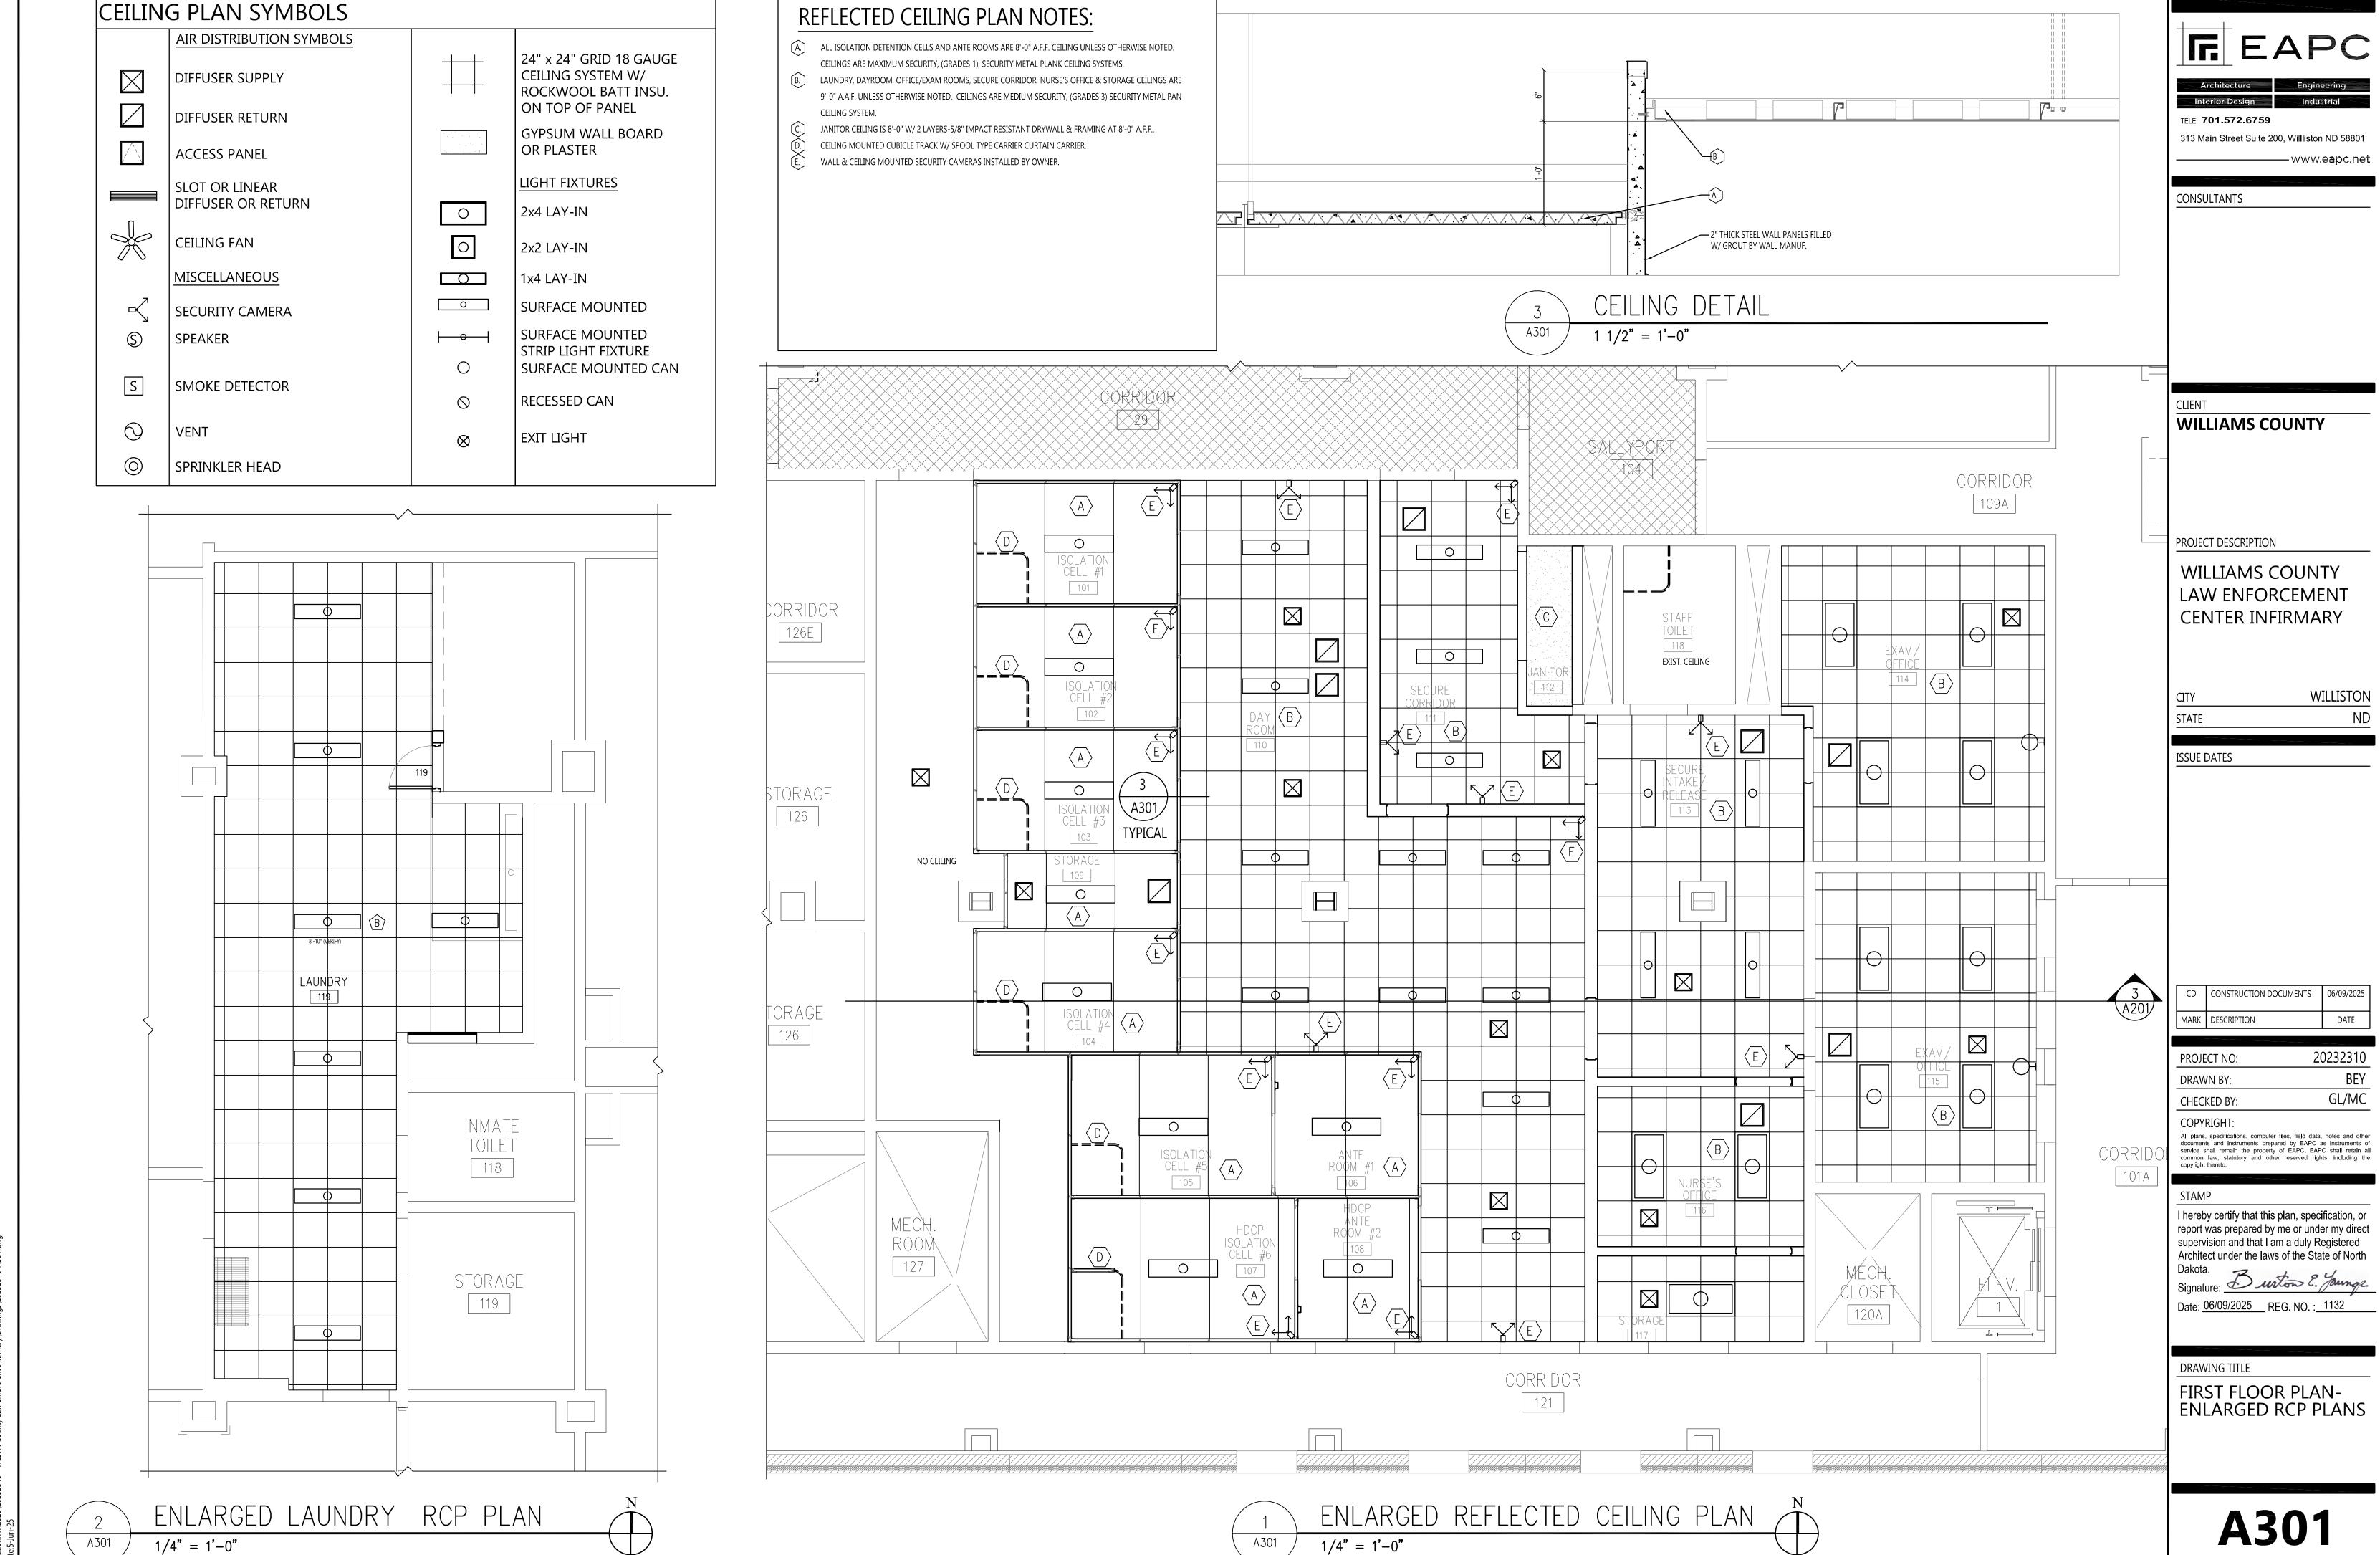

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Architecture Interior Design

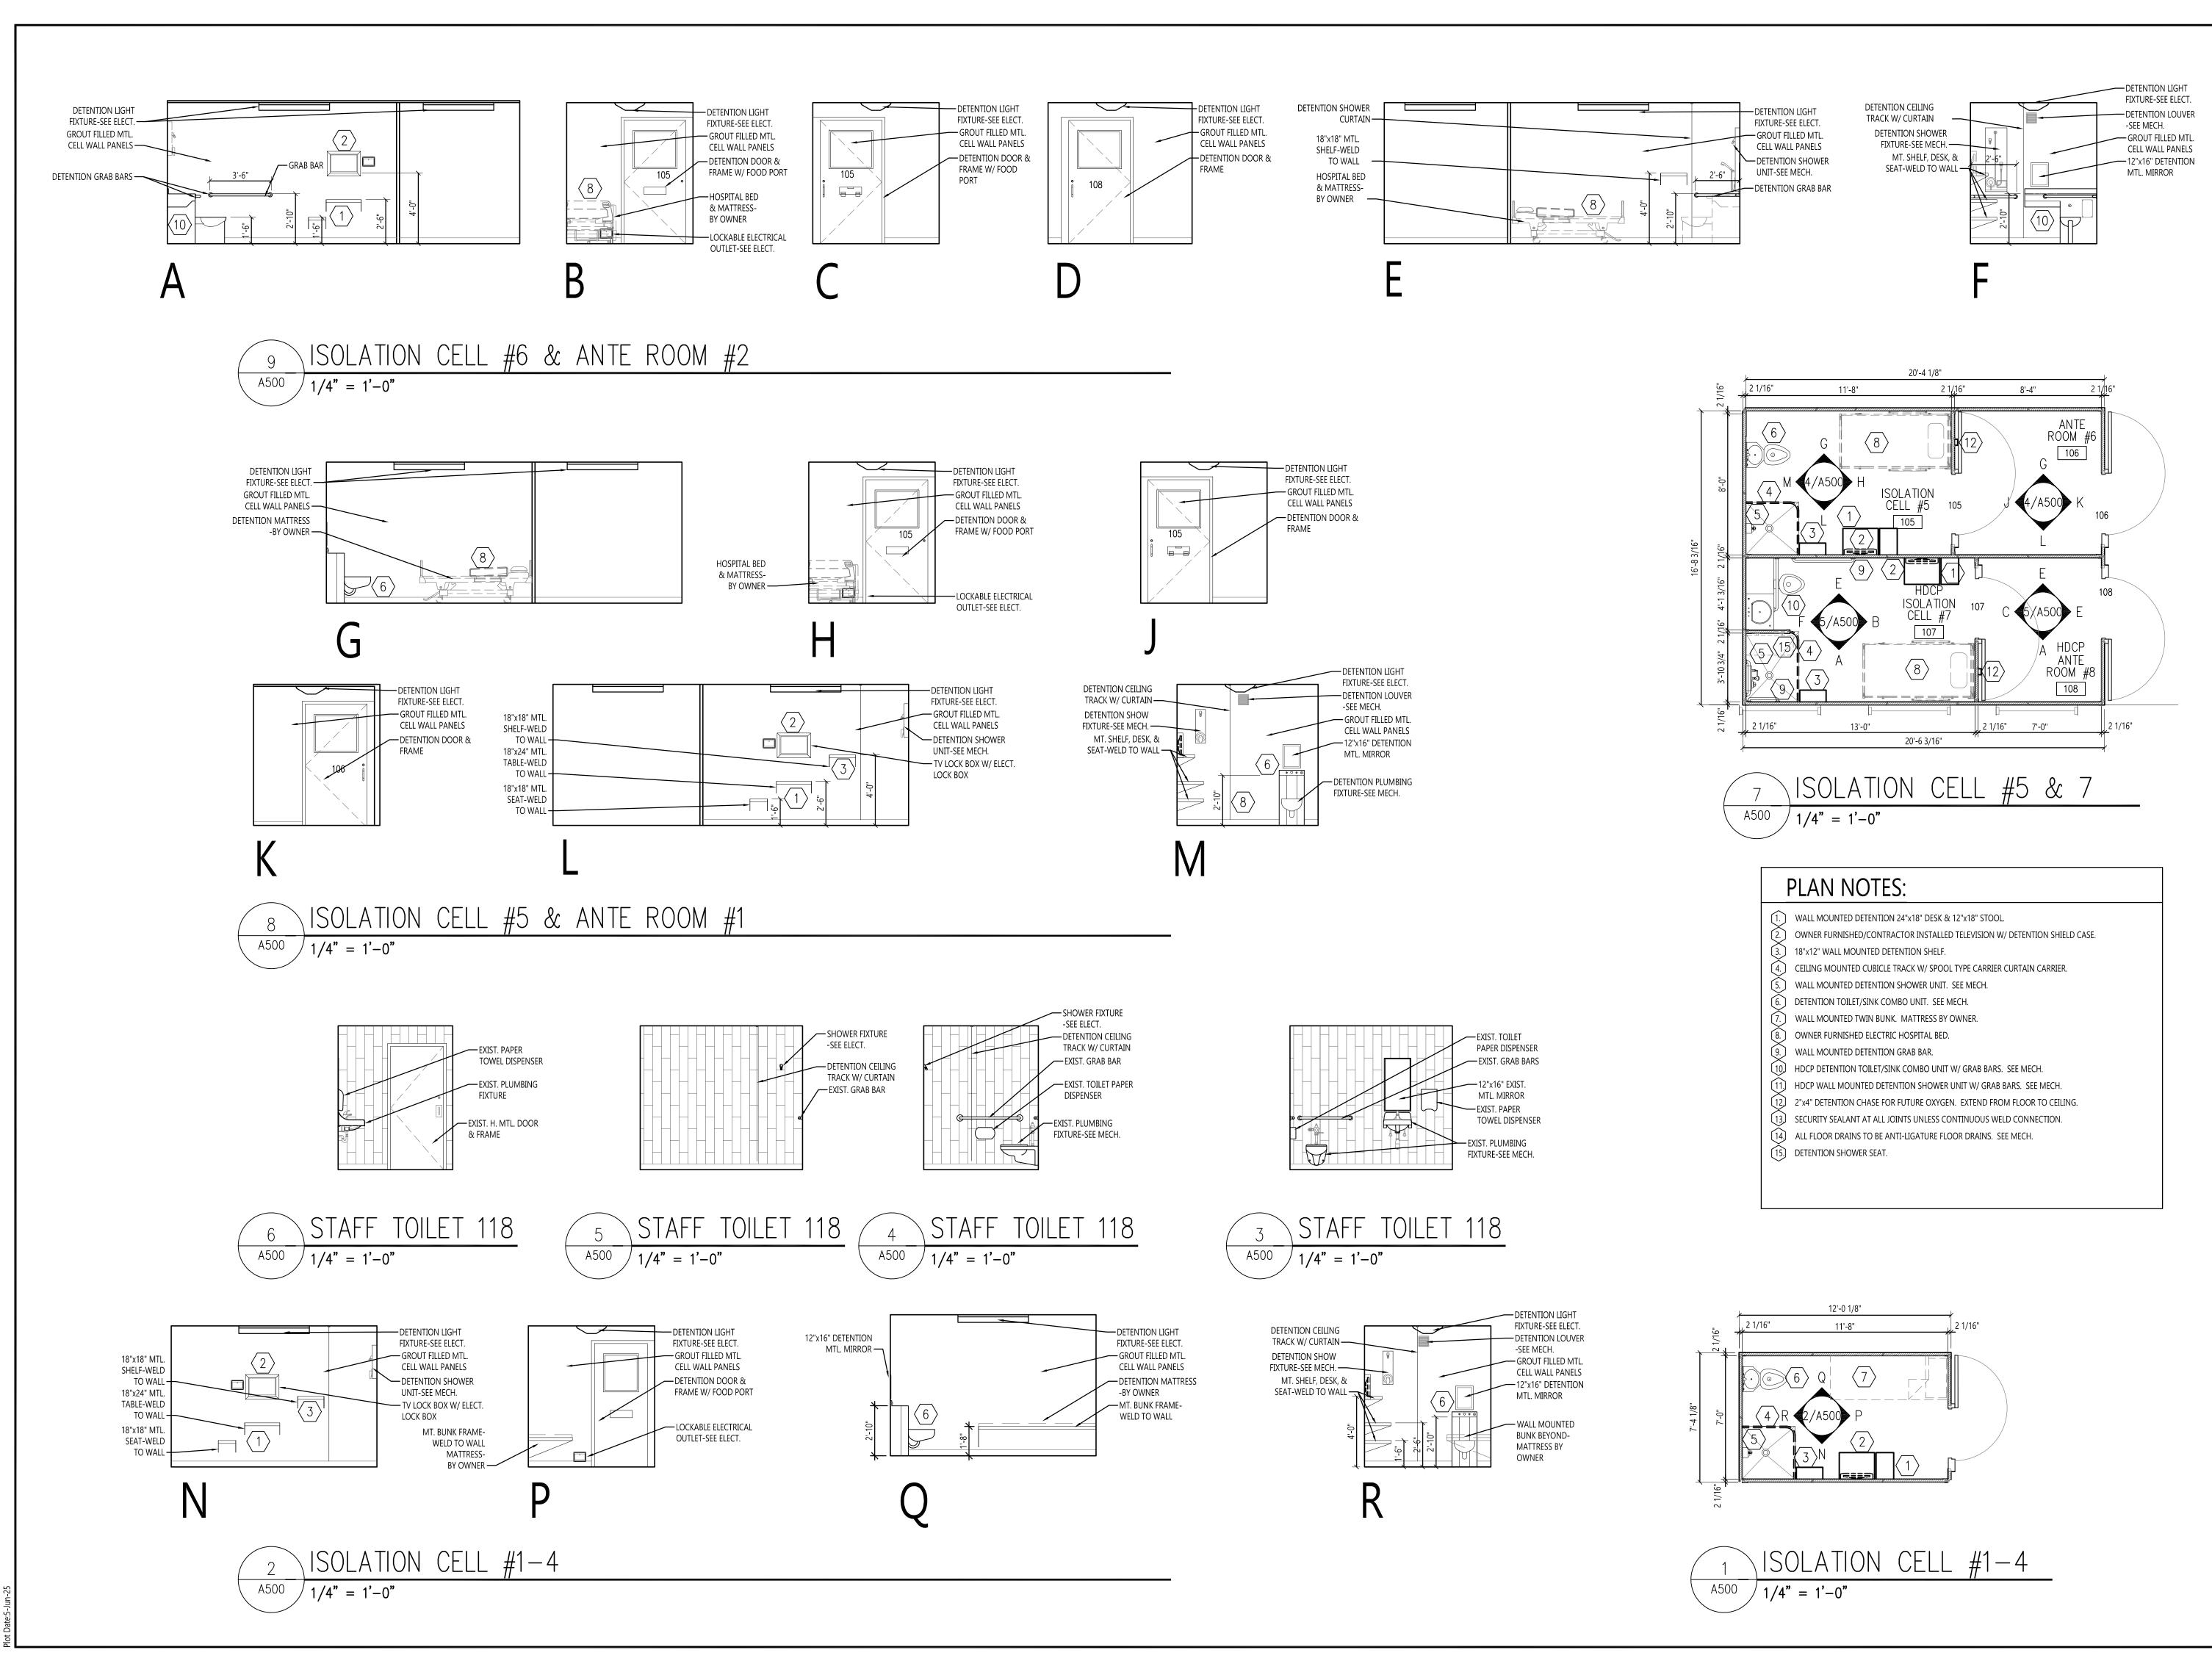TELE **701.572.6759**

313 Main Street Suite 200, Williston ND 58801

CONSULTANTS

WILLIAMS COUNTY

PROJECT DESCRIPTION

WILLIAMS COUNTY LAW ENFORCEMENT **CENTER INFIRMARY**

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ISSUE DATES

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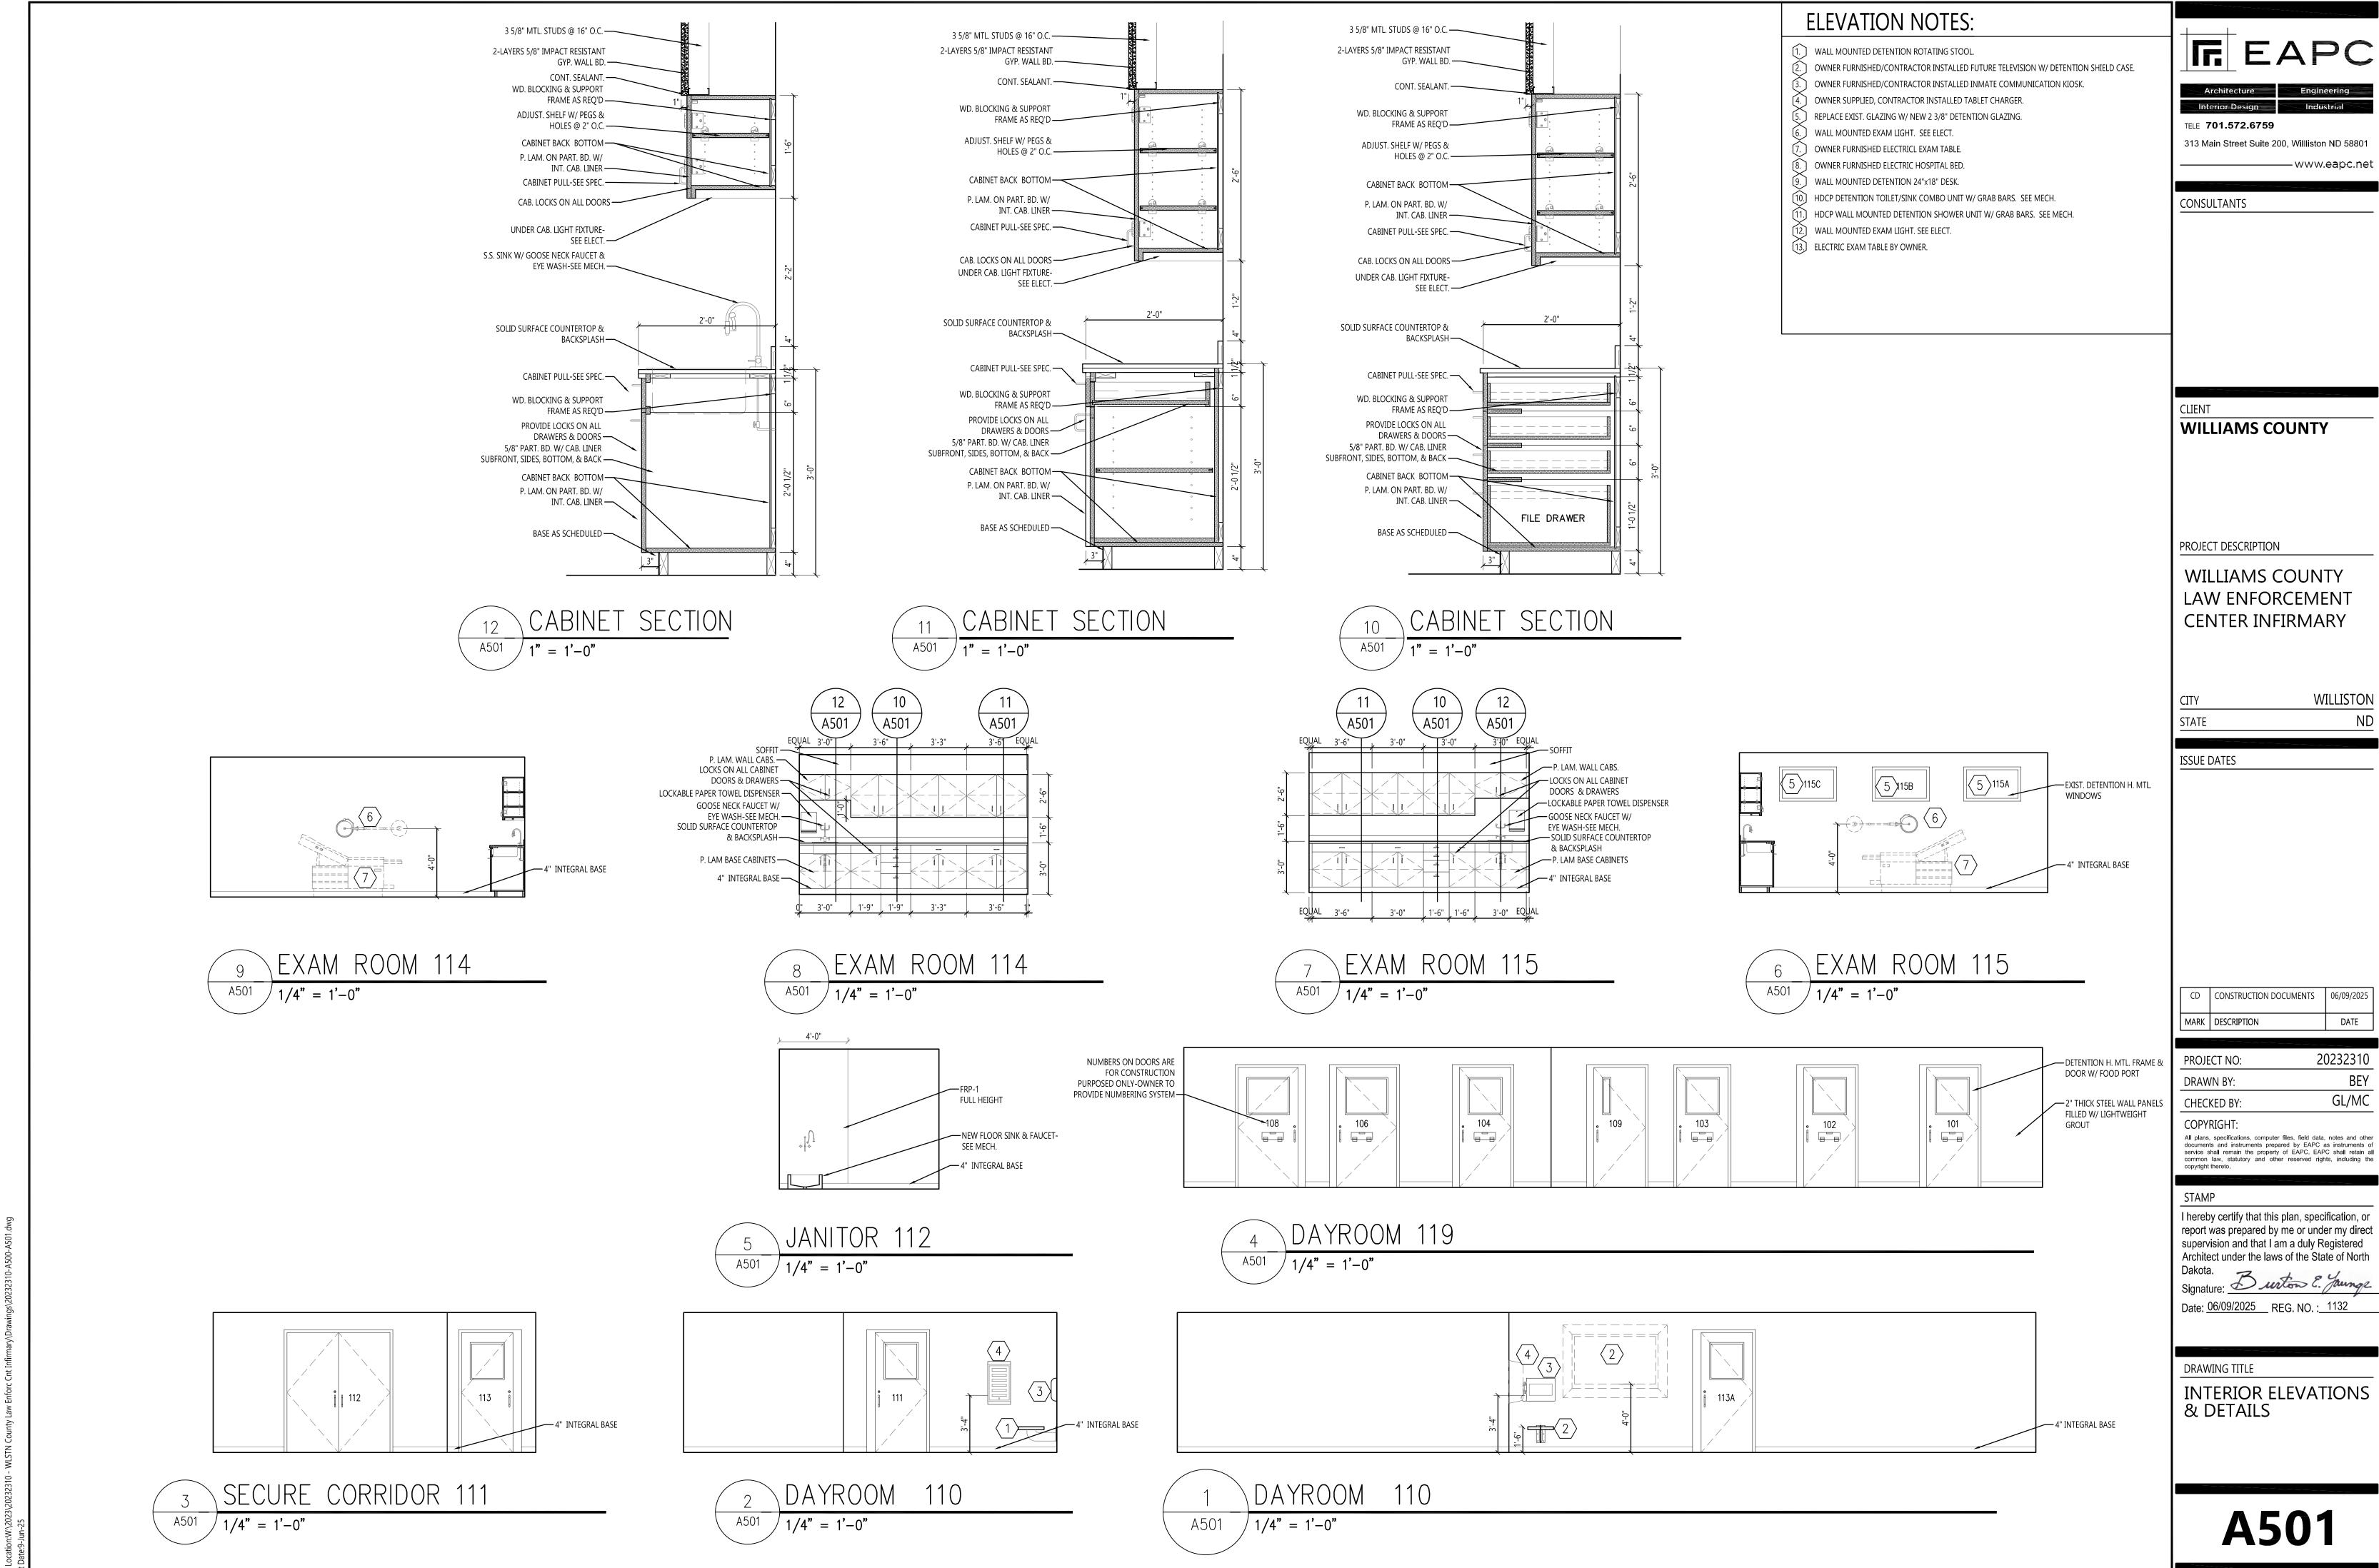
Signature: Durton E. Jaunge

Date: 06/09/2025 REG. NO. : 1132

DRAWING TITLE

INTERIOR ELEVATIONS & DETAILS

A500




A501

DATE


BEY

GL/MC

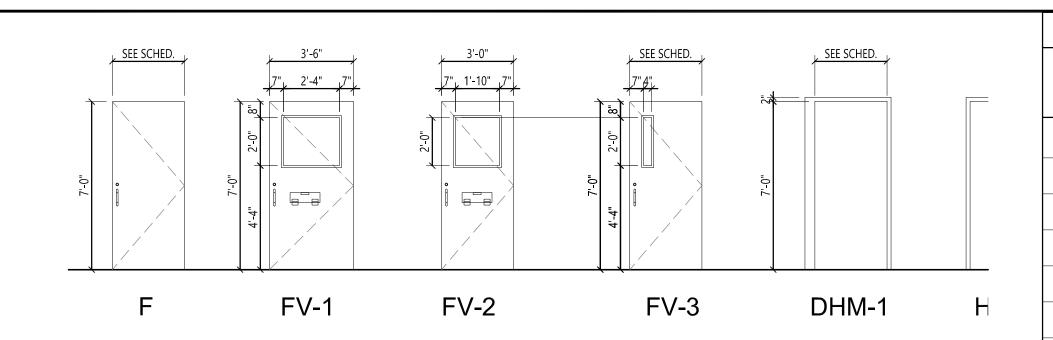

DOOR & FRAME TYPES

A801 1/4" = 1'-0"

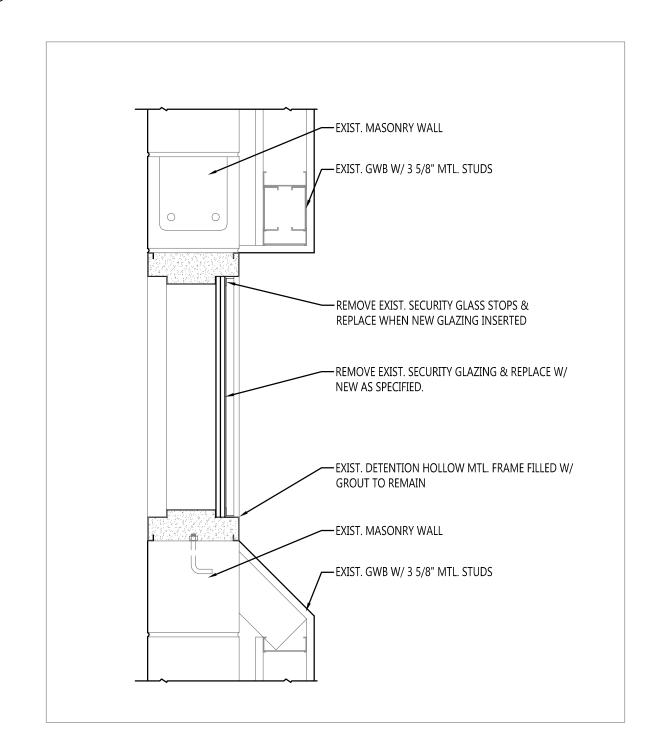

| DOOR SCHEDULE | | | | | | | | | | | | | | |
|---------------|--------------------|--------|--------|-------------------|----------|--------|--------|--------|----------|--------|----------------|-------|-------|--|
| | | | DO | OR | | FRA | ME | DETA | ILS SEE | | FIRE | | | F EAPC |
| DR NO | DOOR SIZE | TYPE | MTL | GLASS | HDWE | ELEV. | MTL | HEAD | JAMB | SILL | RATING SIGNAGE | NOTES | DR NO | |
| 101 | 3'-0"x7'-0"x2" | FV-2 | DHM | SG-60 (11/16") | #101 | DHM-1 | DHM | 3/A801 | 3/A801 | 3/A801 | _ | #1 | 101 | Architecture Engineering Interior Design Industrial |
| 102 | 3'-0"x7'-0"x2" | FV-2 | DHM | SG-60 (11/16") | #101 | DHM-1 | DHM | 3/A801 | 3/A801 | 3/A801 | _ | #1 | 102 | TELE 701.572.6759 |
| 103 | 3'-0"x7'-0"x2" | FV-2 | DHM | SG-60 (11/16") | #101 | DHM-1 | DHM | 3/A801 | 3/A801 | 3/A801 | _ | #1 | 103 | 313 Main Street Suite 200, Willliston ND 58801 |
| 104 | 3'-0"x7'-0"x2" | FV-2 | DHM | SG-60 (11/16") | #101 | DHM-1 | DHM | 3/A801 | 3/A801 | 3/A801 | _ | #1 | 104 | www.eapc.net |
| 105 | 3'-6"x7'-0"x2" | FV-1 | DHM | SG-60 (11/16") | #101 | DHM-1 | DHM | 3/A801 | 3/A801 | 3/A801 | _ | #1 | 105 | CONSULTANTS |
| 106 | 3'-6"x7'-0"x2" | FV-1 | DHM | SG-60 (11/16") | #101 | DHM-1 | DHM | 3/A801 | 3/A801 | 3/A801 | _ | #1 | 106 | |
| 107 | 3'-6"x7'-0"x2" | FV-1 | DHM | SG-60 (11/16") | #101 | DHM-1 | DHM | 3/A801 | 3/A801 | 3/A801 | _ | #1 | 107 | |
| 108 | 3'-6"x7'-0"x2" | FV-1 | DHM | SG-60 (11/16") | #101 | DHM-1 | DHM | 3/A801 | 3/A801 | 3/A801 | _ | #1 | 108 | |
| 109 | 3'-0"x7'-0"x2" | FV-3 | DHM | SG-60 (11/16") | #101 | DHM-1 | DHM | 3/A801 | 3/A801 | 3/A801 | _ | #1 | 109 | |
| 111 | 3'-0"x7'-0"x2" | FV-2 | DHM | SG-26 (11/16") | #102 | DHM-1 | DHM | 2/A801 | 2/A801 | 2/A801 | _ | | 111 | |
| 112 | 2-3'-0"x7'-0"x2" | F | HM | _ | #104 | HM-1 | DHM | 1/A801 | 1/A801 | 1/A801 | _ | #3 | 112 | |
| 113 | 3'-0"x7'-0"x2" | FV-2 | DHM | SG-60 (11/16") | #102 | DHM-1 | DHM | 2/A801 | 2/A801 | 2/A801 | _ | | 113 | |
| 113A | 3'-0"x7'-0"x2" | FV-2 | DHM | SG-60 (11/16") | #102 | DHM-1 | | 1 ' | <u> </u> | 2/A801 | _ | | 113A | CLIENT |
| 114 | 3'-0"x7'-0"x1 3/4" | FV-3 | DHM | SG-60 (11/16") | #102 | DHM-1 | DHM | 1/A801 | 1/A801 | 1/A801 | _ | | 114 | WILLIAMS COUNTY |
| 115 | 3'-0"x7'-0"x1 3/4" | EXIST. | EXIST. | EXIST. | #102 | EXIST. | EXIST. | EXIST. | | | _ | | 115 | |
| 115A | 3'-4"x2'-0" | | _ | SG-60-RW (11/16") | <u> </u> | _ | DHM | 5/A801 | | | 45 MIN - | #2 | 115A | |
| 115B | 3'-4"x2'-0" | | _ | SG-60-RW (11/16") | _ | _ | DHM | 5/A801 | 5/A801 | 5/A801 | 45 MIN - | #2 | 115B | |
| 115C | 3'-4"x2'-0" | _ | _ | SG-60-RW (11/16") | _ | _ | DHM | 5/A801 | 5/A801 | 5/A801 | 45 MIN - | #2 | 115C | DDOIECT DESCRIPTION |
| 116 | 3'-0"x7'-0"x1 3/4" | FV-3 | DHM | SG-20 (11/16") | #102 | DHM-1 | DHM | 1/A801 | 1/A801 | 1/A801 | _ | | 116 | PROJECT DESCRIPTION |
| 117 | 3'-0"x7'-0"x1 3/4" | F | DHM | _ | #103 | HM-1 | DHM | 1/A801 | 1/A801 | 1/A801 | _ | #3 | 117 | WILLIAMS COUNTY |
| 118 | 3'-0"x7'-0"x1 3/4" | EXIST. | EXIST. | EXIST. | EXIST. | EXIST. | EXIST. | EXIST. | EXIST. | EXIST. | _ | | 118 | LAW ENFORCEMENT CENTER INFIRMARY |
| 119 | 2'-6"x7'-0"x1 3/4" | F | HM | _ | #103 | HM-1 | DHM | 2/A801 | 2&4/A80 | 2/A801 | | #3 | 119 | CLIVILIX IIVI IIVIVIMIX I |
| | | | | | | | | | | | | | | |


NOTES:

- ALL METAL CELL DOORS TO BE UNDERCUT BY $1\frac{1}{2}$ ".


- EXIST. WINDOW FRAME TO REMAIN-REPLACE GLAZING. SEE SPECIFICATIONS.
- SEE SPECIFICATION SECTION 08 7100 FOR HARDWARE.

DETENTION WINDOW DETAILS $1 \ 1/2" = 1'-0"$


DETENTION DOOR DETAILS

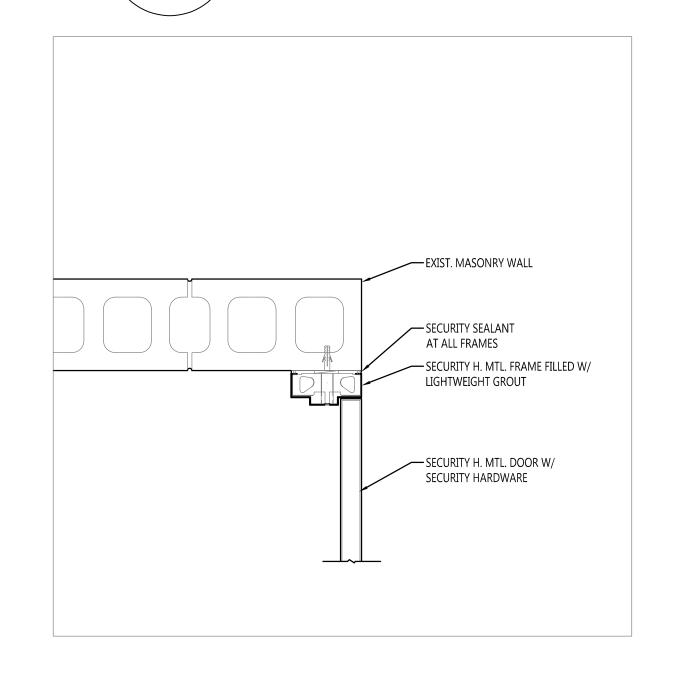



 $1 \ 1/2" = 1'-0"$

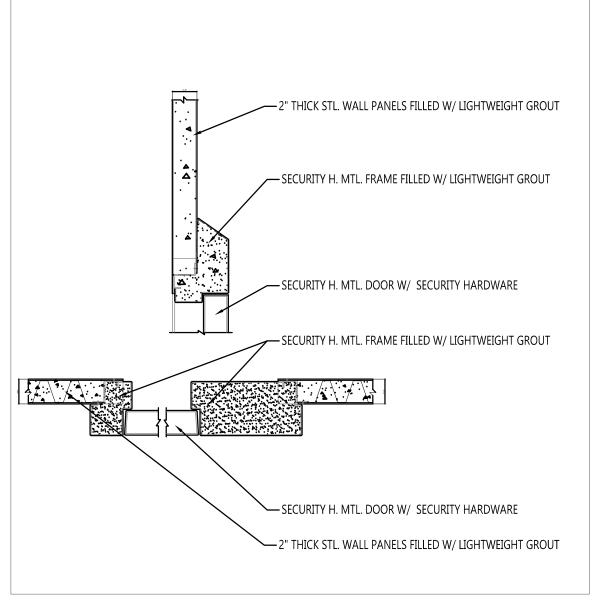


DETENTION DOOR DETAILS $1 \ 1/2" = 1'-0"$

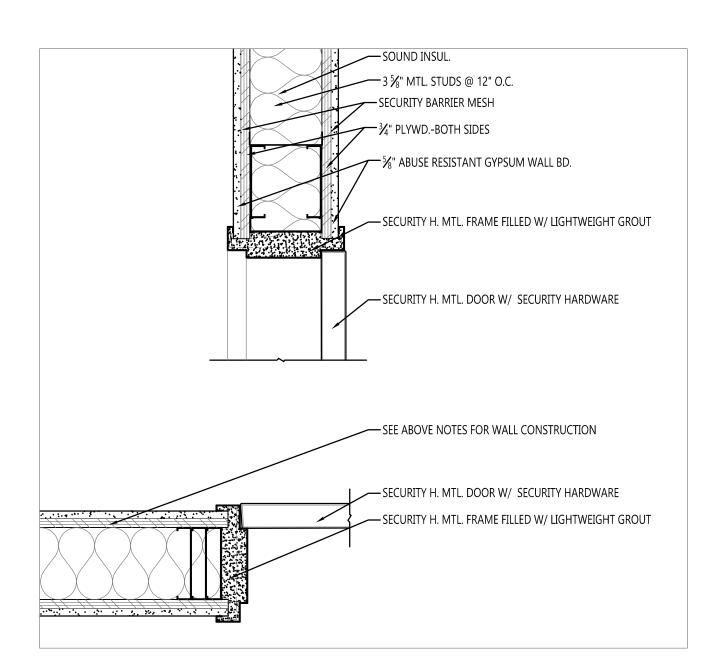

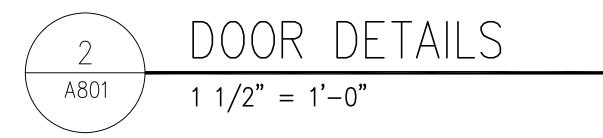

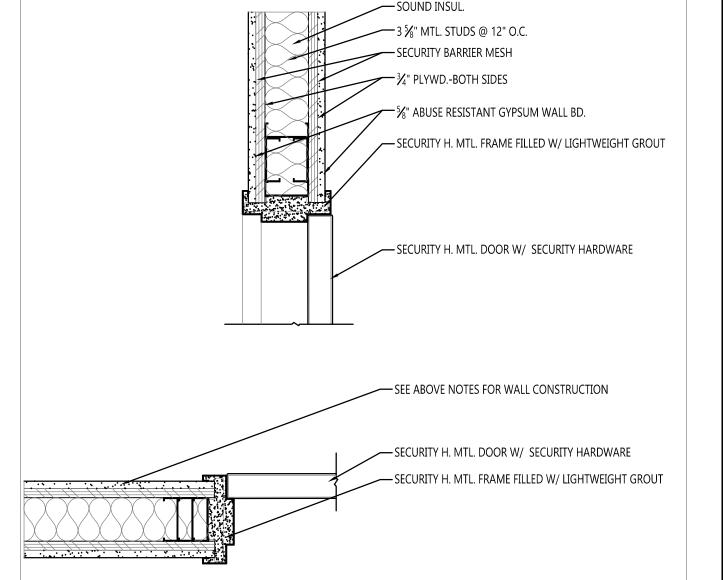

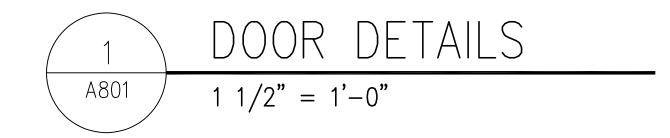



WILLISTON

| PROJECT NO: | 20232310 |
|-------------|----------|
| DRAWN BY: | BEY |
| CHECKED BY: | GL/MC |
| | |

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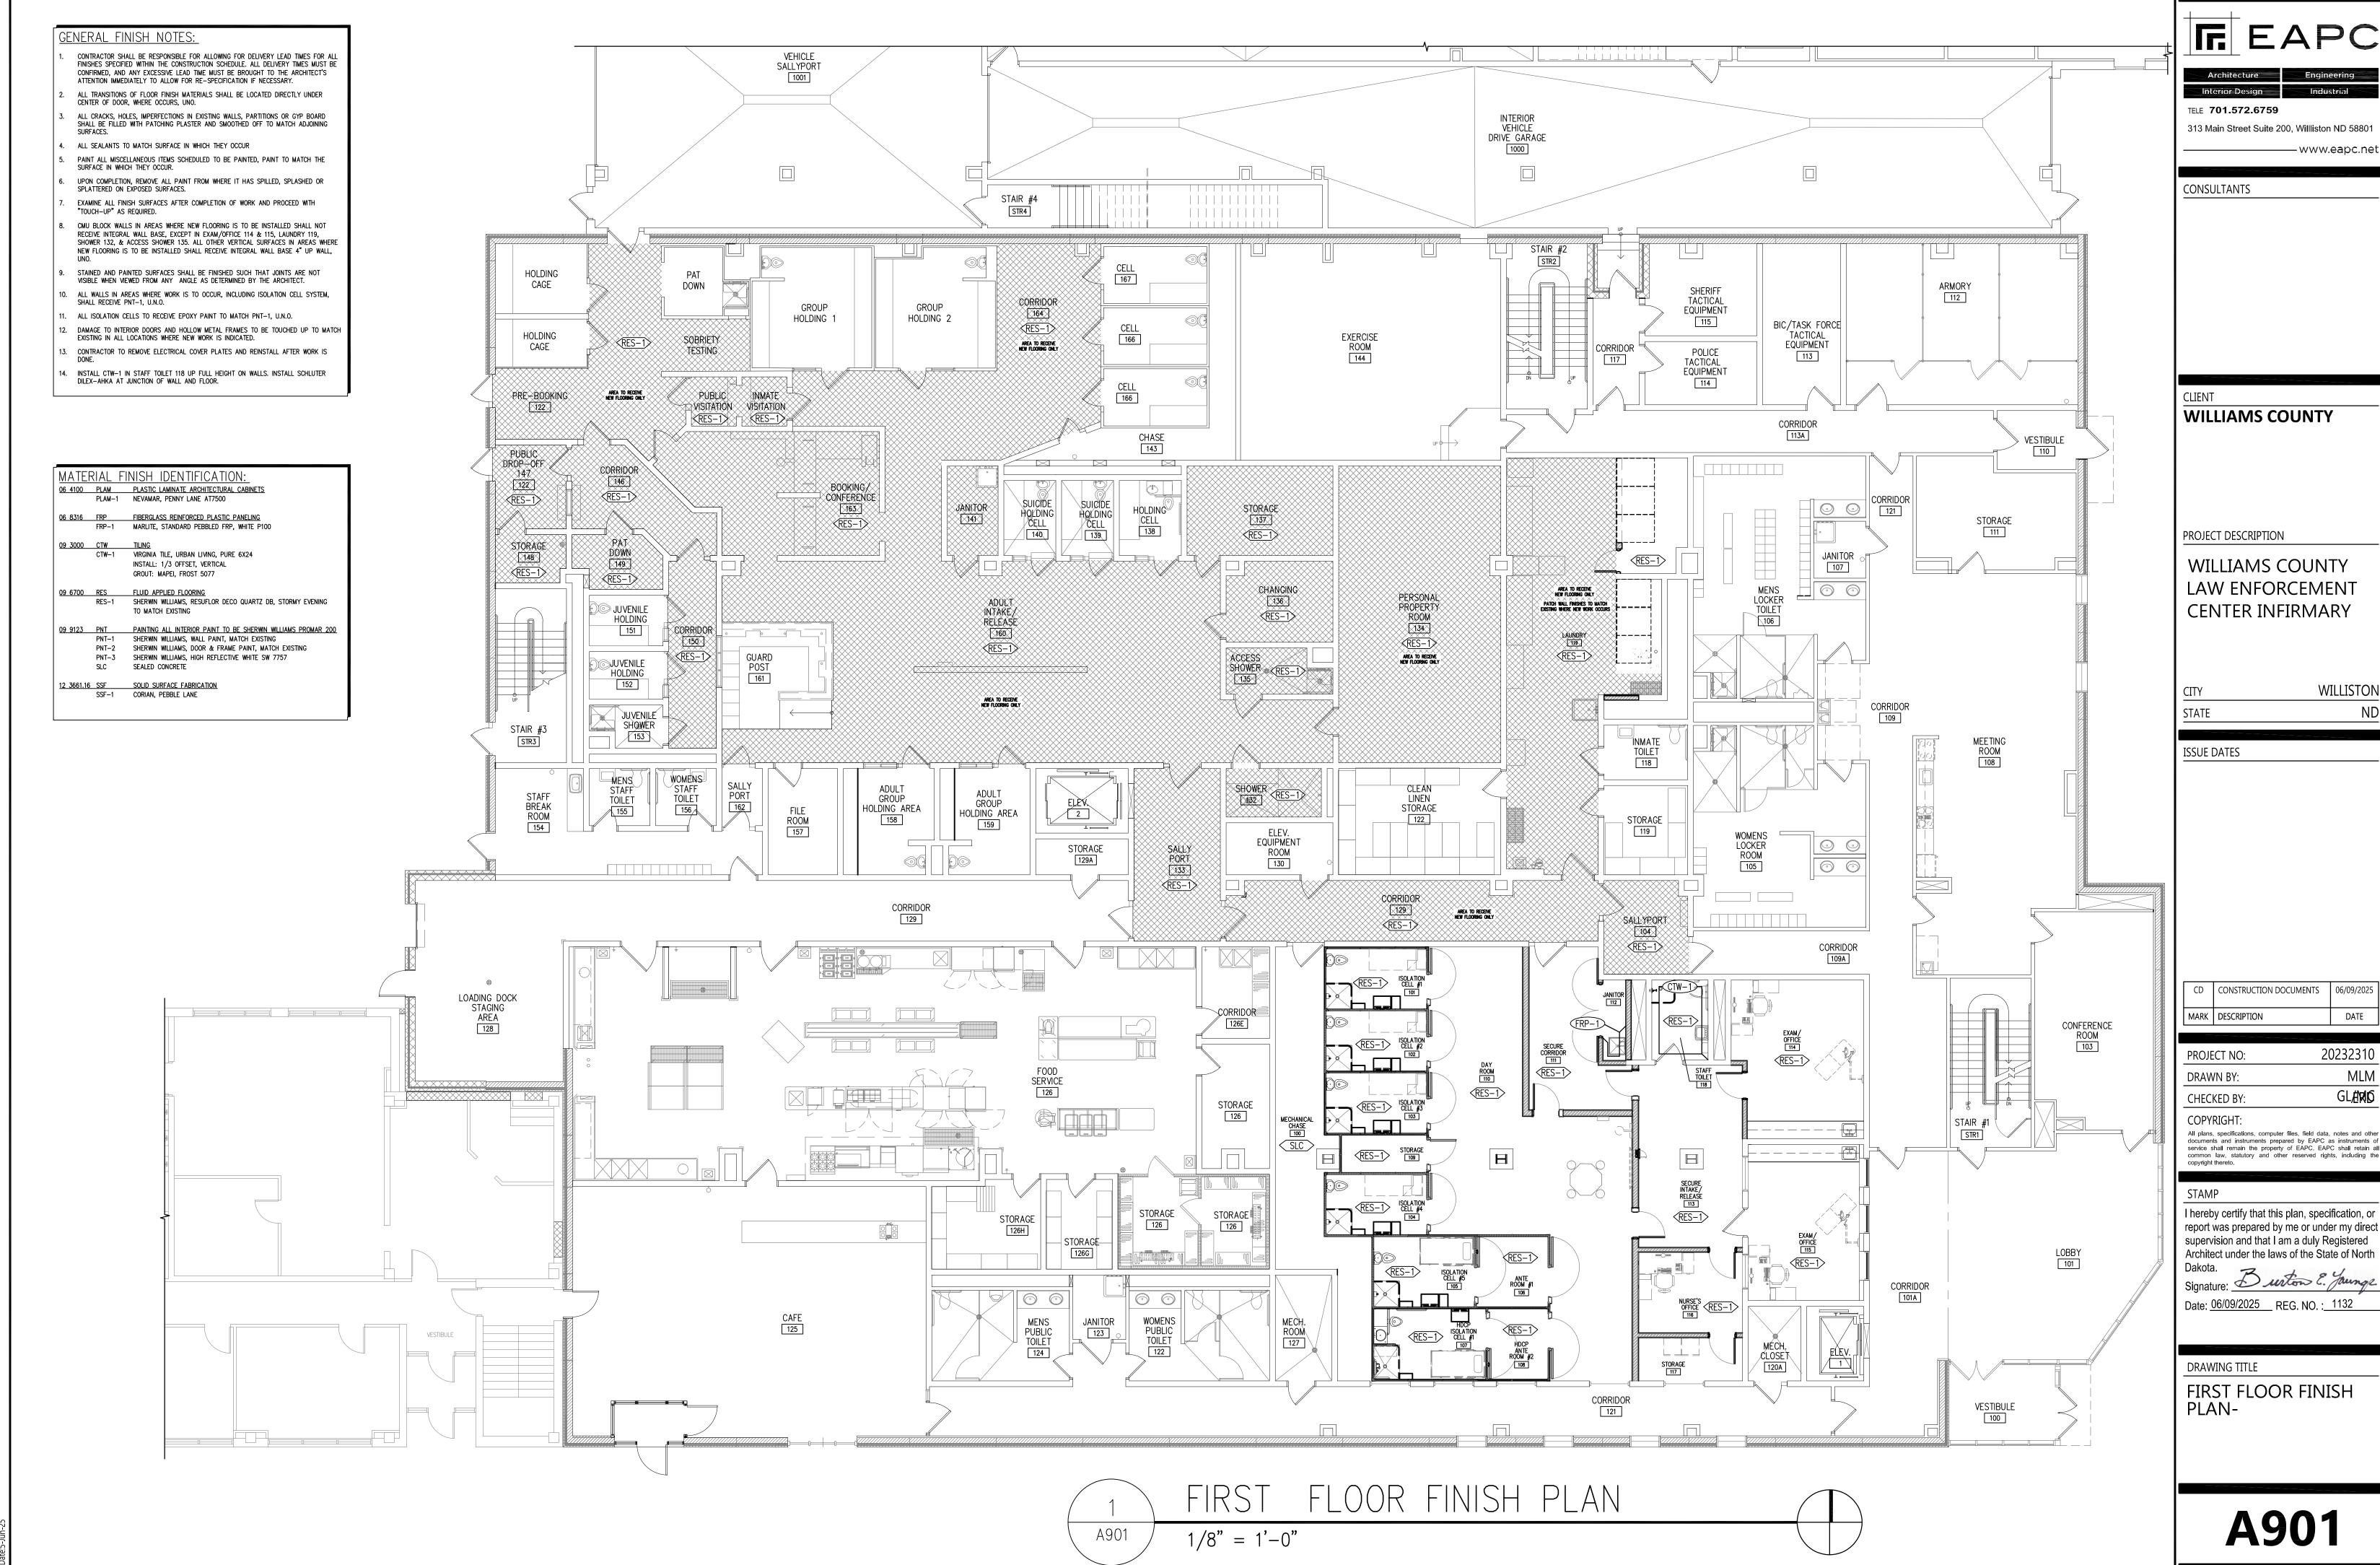
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Date: 06/09/2025 REG. NO. : 1132

DRAWING TITLE DOOR SCHEDULE, TYPES, & DETAILS

A801



313 Main Street Suite 200, Williston ND 58801

WILLIAMS COUNTY LAW ENFORCEMENT **CENTER INFIRMARY**

WILLISTON

CD | CONSTRUCTION DOCUMENTS | 06/09/2025

20232310 MLM GLÆMIÐ

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Date: <u>06/09/2025</u> REG. NO. : <u>1132</u>

FIRST FLOOR FINISH PLAN-

A901

| DESIGN CRITERIA AND LOADS (IN ADDITION TO THOSE INDICATED ON PLANS & DETAILS) | | | | | | | |
|---|---------------------------|---------|--|--|--|--|--|
| OCCUPANCY | | IV | | | | | |
| | | | | | | | |
| DEAD LOADS | DEAD LOADS (SUPERIMPOSED) | | | | | | |
| | 15 PSF | | | | | | |
| | | | | | | | |
| | | | | | | | |
| LIVE LOADS | LIVE LOADS | | | | | | |
| | | 125 PSF | | | | | |
| | | 100 PSF | | | | | |
| | | | | | | | |

| CONCRETE | | |
|----------------------|--|-----------------------------|
| | 28 DAY COMPRESSIVE STRENGTH | f'c |
| | FOUNDATION WALLS/PIERS/ WALLS/COLUMNS/SLABS/BEAMS | 4,000 PSI |
| | PROVIDE 6% (+/- 1/5%) ENTRAINED AIR IF E | XTERIOR CONCRETE |
| | | |
| REINFORCING STEEL | | |
| | REINFORCING BARS | ASTM A615 GR 60 DEFORMED |
| | | _ |
| COLD FORMED | | |

METAL FRAMING

SHEET STEE

| | | GRADE, TYPE H, METALLIC COATED G60 MIN |
|------------|----------------------------|---|
| | SHEET STEEL FOR CLIPS | ASTM A653, STRUCTURAL STEEL ZINC COATED G60 MIN, GRADE 50 |
| | 1 | |
| | | |
| STRUCTURAL | | |
| STEEL | | |
| STRUCTRUAL | WIDE FLANGE (W) & TEE (WT) | ASTM A992, Fy=50 KSI |

ASTM A1003, STRUCTURAL

| STRUCTURAL STEEL | | |
|-----------------------|---|----------------------------------|
| STRUCTRUAL MEMBERS | WIDE FLANGE (W) & TEE (WT) | ASTM A992, Fy=50 KSI |
| | CHANNEL (C&MC) & ANGLE (L) | ASTM A36, Fy=36 KSI |
| | STRUCTURAL BARS & PLATES | ASTM A36, Fy=36 KSI |
| | HOLLOW STRUCTURAL SECTIONS - RECT/SQ (HSS) | ASTM A500, GRADE C, Fy=50 KSI |
| | STRUCTURAL PIPE (SCHED 40 UNO) | ASTM A53, GRADE B, Fy=35 KSI |
| FASTENERS | HIGH STRENGTH BOLTS | ASTM A325-N |
| | ANCHOR RODS | ASTM F-1554, GRADE 36 |
| | THREADED RODS | ASTM A36 |
| | COMMON BOLTS | ASTM A307 |
| | SHEAR STUD CONNECTORS | ASTM A108, TYPE B (Fu=65KSI) |
| WELDS | WELD ELECTRODES | E70XX |

CONCRETE REINFORCING STEEL LAP SPLICE & DEVELOPMENT LENGTH SCHEDULE

| | MINIMUM LAP LENGTHS (Ls) | SPLICE | MINIMUM DEVELOPMENT LENGTH (Ld) | | | |
|---|-----------------------------|------------|------------------------------------|------------|--|--|
| BAR SIZE | TOP BARS ¹ | OTHER BARS | TOP BARS ¹ | OTHER BARS | | |
| #3 | 2'-0" | 1'-7" | 1'-7" | 1'-3" | | |
| #4 | 2'-8" | 2'-1" | 2'-1" | 1'-7" | | |
| #5 | 3'-4" | 2'-7" | 2'-7" | 2'-0" | | |
| #6 | 4'-0" | 3'-1" | 3'-1" | 2'-5" | | |
| #7 | 5'-10" | 4'-6" | 4'-6" | 3'-6" | | |
| #8 | 6'-8" | 5'-2" | 5'-2" | 3'-11" | | |
| #9 | 7'-7" | 5'-10" | 5'-10" | 4'-6" | | |
| 1. HORIZONTAL BARS WITH MORE THAN 12" DEPTH OF CONCRETE CAST BELOW THEM | | | | | | |

CAST IN PLACE CONCRETE (NON-PRESTRESSED) COVER

| ACI 318- STRUCTURAL CONCRETE | | | | |
|------------------------------|--|----------|--|--|
| UNLESS NO | COVER (INCHES) | | | |
| | | | | |
| CAST AGAINST | AND PERMANENTLY EXPOSED TO EARTH | 3 | | |
| | | | | |
| exposed to ea | RTH OR WEATHER | | | |
| | #6 THROUGH #18 BARS | 2 | | |
| | # 5 AND SMALLER | 1 1/2 | | |
| | | | | |
| NOT EXPOSED T | O WEATHER OR IN CONTACT WITH GROUND | | | |
| SLABS, WALLS, | #14 & #18 BARS | 1 1/2 | | |
| JOISTS | #11 BARS AND SMALLER | 3/4 | | |
| BEAMS, COLUMNS | PRIMARY REINFORCEMENT, TIES, STIRRUPS, SPIRALS | 1 1/2 | | |
| | SLAB ON GRADE/ SLAB ON METAL DECK | CENTERED | | |
| | | | | |

GENERAL REQUIREMENTS:

ANY DISCREPANCIES.

- DESIGN AND CONSTRUCTION OF THIS PROJECT IS PER THE 2021 INTERNATIONAL BUILDING CODE (IBC) INCLUDING REFERENCED STANDARDS AND LOCAL/STATE AMENDMENTS OR BUILDING CODES.
- 2. THIS PROJECT IS SUBJECT TO SPECIAL INSPECTIONS AS DESCRIBED IN CHAPTER 17 OF THE IBC AND SHALL BE PROVIDED BY AN INDEPENDENT AGENCY.
- GENERAL CONTRACTOR, CONTRACTOR, CONSTRUCTION MANAGER/AGENCY OR OTHER SIMILAR ENTITY OR REFERENCE ARE SYNONYMOUS AS IT RELATES TO USE OF AND RESPONSIBILITIES ASSIGNED BY THE CONTRACTOR DOCUMENTS.
- 4. CONTRACTOR SHALL BE RESPONSIBLE FOR COORDINATION OF STRUCTURAL SYSTEMS WITH OTHER TRADES AND CONTRACT DOCUMENTS, NOTIFY THE EOR OF ANY DISCREPANCIES.
- CONTRACTOR SHALL PROVIDE VERIFICATION OF QUANTITIES AND DIMENSIONS, MEANS AND METHODS OF CONSTRUCTION, SAFE AND SECURE PERFORMANCE OF THE WORK, AND TO NOT ALTER OR CUT ANY STRUCTURAL MEMBER WITHOUT APPROVAL FROM THE EOR.
- 6. THE STRUCTURAL DESIGN REPRESENTS THE COMPLETED STATE ANY TEMPORARY BRACING OR SHORING REQUIRED TO MAINTAIN STABILITY DURING CONSTRUCTION SHALL BE DESIGNED, FURNISHED, AND INSTALLED BY THE CONTRACTOR.
- CONTRACTOR SHALL FIELD VERIFY ALL EXISTING DIMENSIONS, ELEVATIONS, FRAMING MEMBERS, AND SITE CONDITIONS PRIOR TO STARTING THE WORK AND NOTIFY THE EOR OF
- EXACT LOCATION AND SIZE OF ROOF/FLOOR/WALL OPENINGS, SLEEVES, OR MECHANICAL PENETRATIONS TO BE COORDINATED BY THE CONTRACTOR; SIMILAR FOR HOUSEKEEPING PADS, INSERTS AND EMBEDS, DEPRESSIONS, BOX-OUTS, SLOPES, DOORS AND WINDOWS, NON-BEARING WALLS, STAIRS, FINISHES, WATERPROOFING, RAILINGS, MECHANICAL EQUIPMENT LOCATIONS, LEDGES, INSULATION AND OTHER NON-STRUCTURAL ITEMS NECESSARY TO COMPLETE THE WORK.
- 9. CONTRACTOR SHALL PROVIDE CONTRACTOR APPROVED AND STAMPED SHOP DRAWINGS AND PRODUCT DATA FOR REVIEW WITH GENERAL CONFORMANCE TO THE CONTRACTOR DOCUMENTS.
- 10. CONTRACTOR SHALL BE RESPONSIBLE FOR NOTIFICATION AND COORDINATION WITH TESTING AND INSPECTION AGENCIES DURING CONSTRUCTION OR WHOEVER REMAINS RESPONSIBLE FOR PERFORMING WORK IN COMPLIANCE WITH THE CONTRACT DOCUMENTS.
- 11. CONSTRUCTION OBSERVATION BY THE STRUCTURAL ENGINEER IS FOR GENERAL CONFORMANCE WITH THE CONTRACT DOCUMENTS ONLY.
- 12. DEFERRED SUBMITTAL ITEMS REQUIRE SHOP DRAWINGS AND CALCULATIONS STAMPED AND SIGNED BY A PROFESSIONAL ENGINEER IN THE STATE WHERE THE PROJECT IS LOCATED AS
- A. METAL STUD DESIGN AND CONNECTIONS
- B. STRUCTURAL STEEL CONNECTIONS

CAST-IN-PLACE CONCRETE

- CONTRACTOR WORK SHALL CONFORM WITH REQUIREMENTS OF ACI 301 AND ACI 318 OR ACI 350, ALONG WITH ACI 305 AND ACI 306 WHEN WEATHER CONDITIONS DICTATE HOT OR COLD WEATHER PROVISIONS.
- CONCRETE SHALL BE A REDI-MIXED PRODUCT IN CONFORMANCE WITH APPROVED MIX DESIGN SUBMITTALS FOR EACH COMBINATION OF STRENGTH OR APPLICATION AS PREPARED BY THE SUPPLIER OR AND INDEPENDENT TESTING AGENCY.
- CONCRETE MIX DESIGN PARAMETERS: NORMAL WEIGHT; FLY ASH LIMITED TO 25% BY MASS; MAX W/C RATIO = 0.50; SLUMP = 4" (+/-1"); MAX AGGREGATE = 1 INCH; ADMIXTURE AS PER
- APPROVED MIX DESIGN. DO NOT USE ADMIXTURES OR CURING ACCELERATORS CONTAINING CALCIUM CHLORIDE.
- 5. TOLERANCES AND FORMWORK SHALL BE DESIGNED, ERECTED, SUPPORTED, BRACED, AND
- MAINTAINED TO CONFORM WITH REQUIREMENTS OF ACI 114 AND ACI 347. 6. CHAMFER EXPOSED EDGES OF CONCRETE 3/4" WHERE NOT SPECIFICALLY SHOWN OR NOTED
- 7. SEE CONCRETE REINFORCING NOTES SECTION, STANDARD DETAILS AND TABLES FOR
- ADDITIONAL REINFORCING AND LAYOUT REQUIREMENTS. 8. PROVIDE DOWEL BARS BETWEEN MEMBERS WITH STANDARD HOOKS TO SUPPORT MEMBER
- AND LAP SPLICED WITH PRIMARY REINFORCING; DOWELS SHALL BE SAME SIZE AND SPACED TO MATCH PRIMARY REINFORCING UNLESS NOTED OTHERWISE. 9. INSERTS, SLEEVES, OPENINGS, AND OTHER EMBEDDED ITEMS SHOWN ON THE STRUCTURAL DRAWINGS SHALL BE LOCATED AND VERIFIED BY THE CONTRACTOR; THOSE NOT SHOWN
- 10. CONTRACTOR TO LAY OUT AND SUBMIT LOCATION OF CONSTRUCTION JOINTS AND CONCRETE CONSTRUCTION FOR REVIEW AND APPROVAL. SEE STANDARD DETAILS FOR SLAB ON GRADE CONSTRUCTION, CUT JOINTS WITHIN 24 HOURS OF CONCRETE PLACEMENT, SPACED NOT MORE THAN 36 TIMES THE SLAB THICKNESS, AND AN ASPECT RATIO NOT
- 11. UNLESS SPECIFICALLY DETAILED OR SHOWN ON THE STRUCTURAL DRAWINGS. PENETRATIONS OR OPENINGS IN SLABS AND WALL SHALL:
 - A. NOT EXCEED 12 INCHES IN ANY DIMENSION.

EXCEEDING 1.5.

ON STRUCTURAL OR ARCHITECTURAL DRAWINGS.

B. NOT BE LOCATED WITHIN 6 INCHES FROM AN EDGE. C. NOT BE LOCATED WITHIN A BEAM OR COLUMN.

OF OPENING DIAMETER CLEAR BETWEEN THEM.

SHALL BE INSTALLED ONLY AFTER APPROVAL BY THE EOR.

- D. NOT BE CLOSER THAN 10 TIMES THE SLAB THICKNESS FROM A CONCENTRATED LOAD
- EXCEEDING 2,000 LBS. E. WHEN PLACED IN GROUPS, SHALL BE PLACED WITH NO LESS THAN ONE PENETRATION

CONCRETE REINFORCEMENT:

- CONCRETE REINFORCEMENT DETAILING AND PLACEMENT SHALL CONFORM WITH REQUIREMENTS OF ACI 315 AND CRSI MANUAL.
- SEE STANDARD DETAILS AND TABLES FOR ADDITIONAL INFORMATION RELATED TO STEEL REINFORCING COVER, LAPS, AND MISCELLANEOUS DETAILING.
- REINFORCING STEEL SHALL BE TIED, ACCURATELY PLACED, AND SUPPORTED BY STANDARD
- ACCESSORIES. ACCESSORY LEGS EXPOSED TO VIEW SHALL BE STAINLESS STEEL.
- REINFORCING STEEL AND EMBEDDED ITEMS SHALL BE LOCATED AND HELD IN PLACE PRIOR TO CONCRETE PLACEMENT; PLACEMENT OR PUSHING ("WET STICKING") INTO CONCRETE IS NOT ALLOWED.
- REINFORCEMENT LAP SPLICES SHALL BE CLASS B PLUS 6" AT NON-CONTACT SLICES, UNLESS NOTED OTHERWISE, AND SPLICED AT LOCATIONS SHOWN OR NOTED WITHIN THE STRUCTURAL DOCUMENTS; EXCEPTION REINFORCEMENT NOTED AS "CONTINUOUS" MAY BE SPLICED AT LOCATIONS DETERMINED BY THE CONTRACTOR.
- DO NOT WELD REINFORCING UNLESS SPECIFICALLY SHOWN ON PLANS OR WITH WRITTEN PERMISSION FROM THE EOR.

CAST-IN-PLACE CONCRETE FIELD QUALITY CONTROL:

- TESTING AND INSPECTING:
- CONTRACTOR SHALL ENGAGE A QUALIFIED TESTING AND INSPECTING AGENCY TO PERFORM FIELD TESTS AND INSPECTIONS AND PREPARE TEST REPORTS.
- CONCRETE TESTS:
- TESTING OF COMPOSITE SAMPLES OF FRESH CONCRETE OBTAINED ACCORDING TO
- ASTM C172 SHALL BE PREFORMED ACCORDING TO THE FOLLOWING REQUIREMENTS: A. TESTING FREQUENCY: OBTAIN ONE COMPOSITE SAMPLE FOR EACH DAY'S POUR OF EACH CONCRETE MIXTURE EXCEEDING 5 CU. YD. (4 CU. M), BUT LESS THAN 25 CU. YD. (19 CU. M), PLUS ONE SET FOR EACH ADDITIONAL 50 CU.YD. (38 CU. M) OR FRACTION THERE OF.
 - a. WHEN FREQUENCY OF TESTING WILL PROVIDE FEWER THAN THREE COMPRESSIVE-STRENGTH TEST FOR EACH CONCRETE MIXTURE, TESTING SHALL BE CONDUCTED FROM AT LEAST THREE RANDOMLY SELECTED BATCHES OR FROM EACH BATCH IF FEWER THAN FIVE ARE USED.
- SLUMP: ASTM C143/C 143M; ONE TEST AT POINT OF PLACEMENT FOR EACH COMPOSITE SAMPLE, BUT NOT LESS THAN ONE TEST FOR EACH DAY'S POUR OF EACH CONCRETE MIXTURE. PERFORM ADDITIONAL TESTS WHEN CONCRETE
- CONSISTENCY APPEARS TO CHANGE. AIR CONTENT: ASTM C231, PRESSURE METHOD, FOR NORMAL-WEIGHT CONCRETE; ONE TEST FOR EACH COMPOSITE SAMPLE, BUT NOT LESS THAN ONE TEST FOR EACH
- DAY'S POUR OF EACH CONCRETE MIXTURE.
- CONCRETE TEMPERATURE: ASTM C1064/C 1064M; ONE TEST HOURLY WHEN AIR TEMPERATURE IS 40 DEG F (4.4 DEG C) AND BELOW AND WHEN 80 DEG F (27 DEG C) 18. LATERAL DEFLECTION OF STUDS SHALL BE LIMITED TO: AND ABOVE, AND ONE TEST FOR EACH COMPOSITE SAMPLE.
- E. COMPRESSION TEST SPECIMENS: ASTM C31/C31M.
- a. CAST AND LABORATORY CURE TWO SETS (4 TOTAL) OF TWO STANDARD CYLINDER SPECIMENS FOR EACH COMPOSITE SAMPLE.
- COMPRESSIVE-STRENGTH TESTS: ASTM C39/C39M; TEST ONE SET OF TWO LABORATORY-CURED SPECIMENS AT 7 DAYS AND ONE SET OF TWO SPECIMENS AT 28 DAYS.
- a. A COMPRESSIVE-STRENGTH TEST SHALL BE THE AVERAGE COMPRESSIVE STRENGTH FROM A SET OF TWO SPECIMENS OBTAINED FORM SAME
- COMPOSITE SAMPLE AND TESTED AT AGE INDICATED. G. WHEN STRENGTH OF FIELD-CURED CYLINDERS IS LESS THAN 85 PERCENT OF COMPANION LABORATORY-CURED CYLINDERS, CONTRACTOR SHALL VALUATE OPERATIONS AND PROVIDE CORRECTIVE PROCEDURES FOR PROTECTING AND CURING IN-PLACE CONCRETE.
- H. STRENGTH OF EACH CONCRETE MIXTURE WILL BE SATISFACTORY IF EVERY AVERAGE OF ANY THREE CONSECUTIVE COMPRESSIVE-STRENGTH TEST EQUALS OR EXCEEDS SPECIFIED COMPRESSIVE STRENGTH AND NO COMPRESSIVE-STRENGTH TEST VALUE FALLS BELOW SPECIFIED COMPRESSIVE STRENGTH BY MORE THAN 500 PSI (3.4 MPa).
- TEST RESULTS SHALL BE REPORTED IN WRITING TO ENGINEER, CONCRETE MANUFACTURER, AND CONTRACTOR WITHIN 48 HOURS OF TESTING. REPORTS OF COMPRESSIVE-STRENGTH TESTS SHALL CONTAIN PROJECT IDENTIFICATION NAME AND NUMBER, DATE OF CONCRETE PLACEMENT, NAME OF CONCRETE TESTING AND INSPECTING AGENCY, LOCATION OF CONCRETE BATCH IN WORK. DESIGN COMPRESSIVE STRENGTH, AND TYPE OF BREAK FOR BOTH 7 AND 28 DAY TESTS.
- NON DESTRUCTIVE TESTING:
- IMPACT HAMMER, SONOSCOPE, OR OTHER NON DESTRUCTIVE DEVICE MAY BE PERMITTED BY ENGINEER BUT WILL NOT BE USED AS SOLE BASIS FOR AN APPROVAL OR REJECTION OF CONCRETE.
- 5. ADDITIONAL TESTS:
- TESTING AND INSPECTING AGENCY SHALL MAKE ADDITIONAL TEST OF CONCRETE WHEN TEST RESULTS INDICATE THAT SLUMP, AIR ENTRAINMENT, COMPRESSIVE STRENGTH, OR OTHER REQUIREMENTS HAVE NOT BEEN MET, AS DIRECTED BY ENGINEER. TESTING AND INSPECTING AGENCY MAY CONDUCT TEST TO DETERMINE ADEQUACY OF CONCRETE BY CORED CYLINDERS COMPLYING WITH ASTM C42/C42M OR BY OTHER METHODS AS DIRECTED BY ENGINEER.
- ADDITIONAL TESTING AND INSPECTING, AT CONTRACTOR'S EXPENSE, WILL BE PREFORMED TO DETERMINE COMPLIANCE OF REPLACED OR ADDITIONAL WORK WITH SPECIFIED
- 7. CORRECT DEFICIENCIES IN THE WORK THAT TEST REPORTS AND INSPECTIONS INDICATE DOES NOT COMPLY WITH THE CONTRACT DOCUMENTS.

COLD-FORMED METAL FRAMING:

- 1. FINAL DESIGN AND DETAILING BY SUPPLIER SHALL PROVIDE ALL COLD FORM METAL FRAMING ACCESSORIES, BRACING, CLIPS, STIFFENERS, ANCHORAGE, AND FASTENERS NECESSARY TO
- CONSTRUCT THE COMPLETED FRAMING SYSTEM PER AISI STANDARDS. PROVIDE INSULATION EQUAL TO THAT SPECIFIED ELSEWHERE IN ALL MULTIPLY-MEMBER JAMB

STUDS AND MULTIPLY-MEMBER HEADERS WHICH WILL NOT BE ACCESSIBLE TO THE

- INSULATION CONTRACTOR. 3. CLEAN ALL SURFACES THAT WILL BE IN CONTACT WITH LIGHT GAUGE FRAMING PRIOR TO
- POSITION ALL MEMBERS PLUMB OR LEVEL AND SQUARE WITH PERPENDICULAR ADJOINING
- ALL FRAMING TO BE HELD FIRMLY IN POSITION UNTIL PERMANENTLY FASTENED. FULLY SEAT STUDS IN TRACK THE FULL DEPTH OF THE TRACK UNLESS NOTED OTHERWISE ON

7. SPLICED MEMBERS ARE NOT ALLOWED UNLESS SPECIFICALLY NOTED AND APPROVED BY THE

- 8. TRACK SHALL BE SECURELY ANCHORED TO THE SUPPORTING STRUCTURE. SPLICES IN TRACKS SHALL BE SECURELY ANCHORED TO A COMMON STRUCTURAL ELEMENT OR SHALL BE
- BUTT-WELDED TOGETHER. 9. WALL STUD BRIDGING SHALL BE ATTACHED TO PREVENT STUD ROTATION. BRIDGING ROWS
- SHALL BE SPACED VERTICALLY AT 48 INCHES ON CENTER, UNLESS NOTED OTHERWISE. 10. PROVIDE VERTICAL DEFLECTION ALLOWANCE IN STUD TRACK OR SIMILAR DIRECTLY BELOW
- 11. CONSTRUCT CORNERS USING A MINIMUM OF THREE STUDS. DOUBLE OR TRIPLE STUDS AT DOOR AND WINDOW OPENINGS AS SHOWN ON THE DRAWINGS. FASTEN TOGETHER WITH (2 #10 AT 12" O/C IF BACK-TO-BACK OR PROVIDE SIMILAR BOXED ARRANGEMENT WITH TRACK.
- 12. LIGHT GAUGE CONTRACTOR SHALL DESIGN AND PROVIDE BOXED HEADERS CONSISTING OF (2) TRACK SECTIONS AND (2) STUD SECTIONS AT ALL FRAMED OPENINGS, UNLESS NOTED OTHERWISE. SEE ARCHITECTURAL PLANS FOR OPENING SIZES AND LOCATIONS.
- 13. PROVIDE A MIN. OF (2) FULL HEIGHT STUDS AT JAMBS OF FRAMED OPENINGS.
- ALL EXTERIOR STUDS SHALL BE A MINIMUM OF 43 MIL THICKNESS. FINAL DESIGN BY LIGHT GAUGE SUPPLIER.
- 15. CONTRACTOR SHALL PROVIDE DELEGATED DESIGN SERVICES.

BUILDING FRAMING AT NON-LOAD BEARING WALLS.

- 16. ANY STUD, JOIST OR OTHER INDICATED WITH INCOMPLETE DESIGNATION (E.G. "6" MTL STUDS AND NOT A COMPLETE DESIGNATION (E.G. 600S162-43) SHALL BE INTERPRETED AS A COMPONENT FOR WHICH DELEGATED DESIGN OF THE MISSING INFORMATION IS REOUIRED.
- 17. NOTCHING OF STUDS, JOISTS, BEAMS, TRUSS MEMBERS, ETC IS NOT PERMITTED WITHOUT PRIOR APPROVAL BY THE DESIGN ENGINEER.
- EXTERIOR STUDS @ BRICK: L/480 EXTERIOR STUDS @ METAL PANEL: L/240

WILLIAMS COUNTY LAW ENFORCEMENT

CENTER INFIRMARY

PROJECT DESCRIPTION

WILLIAMS COUNTY

LAW ENFORCEMENT

TELE 701.609.5290 FAX 701.609.5290*51

313 Main Street, Suite 308, Williston, ND 58801

CONSULTANTS

CLIENT

CENTER

WILLISTON CITY ND STATE

ISSUE DATES

RS FINAL REVIEW 06/09/2025 MARK DESCRIPTION DATE

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STRUCTURAL NOTES



01 EXISTING 4" CONCRETE SLAB OVER 2"x20 GA COMPOSITE METAL DECK (6" TOTAL THICKNESS).



Architecture Engineering
Interior Design Industrial

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WILLIAMS COUNTY LAW ENFORCEMENT CENTER

PROJECT DESCRIPTION

WILLIAMS COUNTY LAW ENFORCEMENT CENTER INFIRMARY

CITY WILLISTON
STATE ND

ISSUE DATES

RS FINAL REVIEW 06/09/2025


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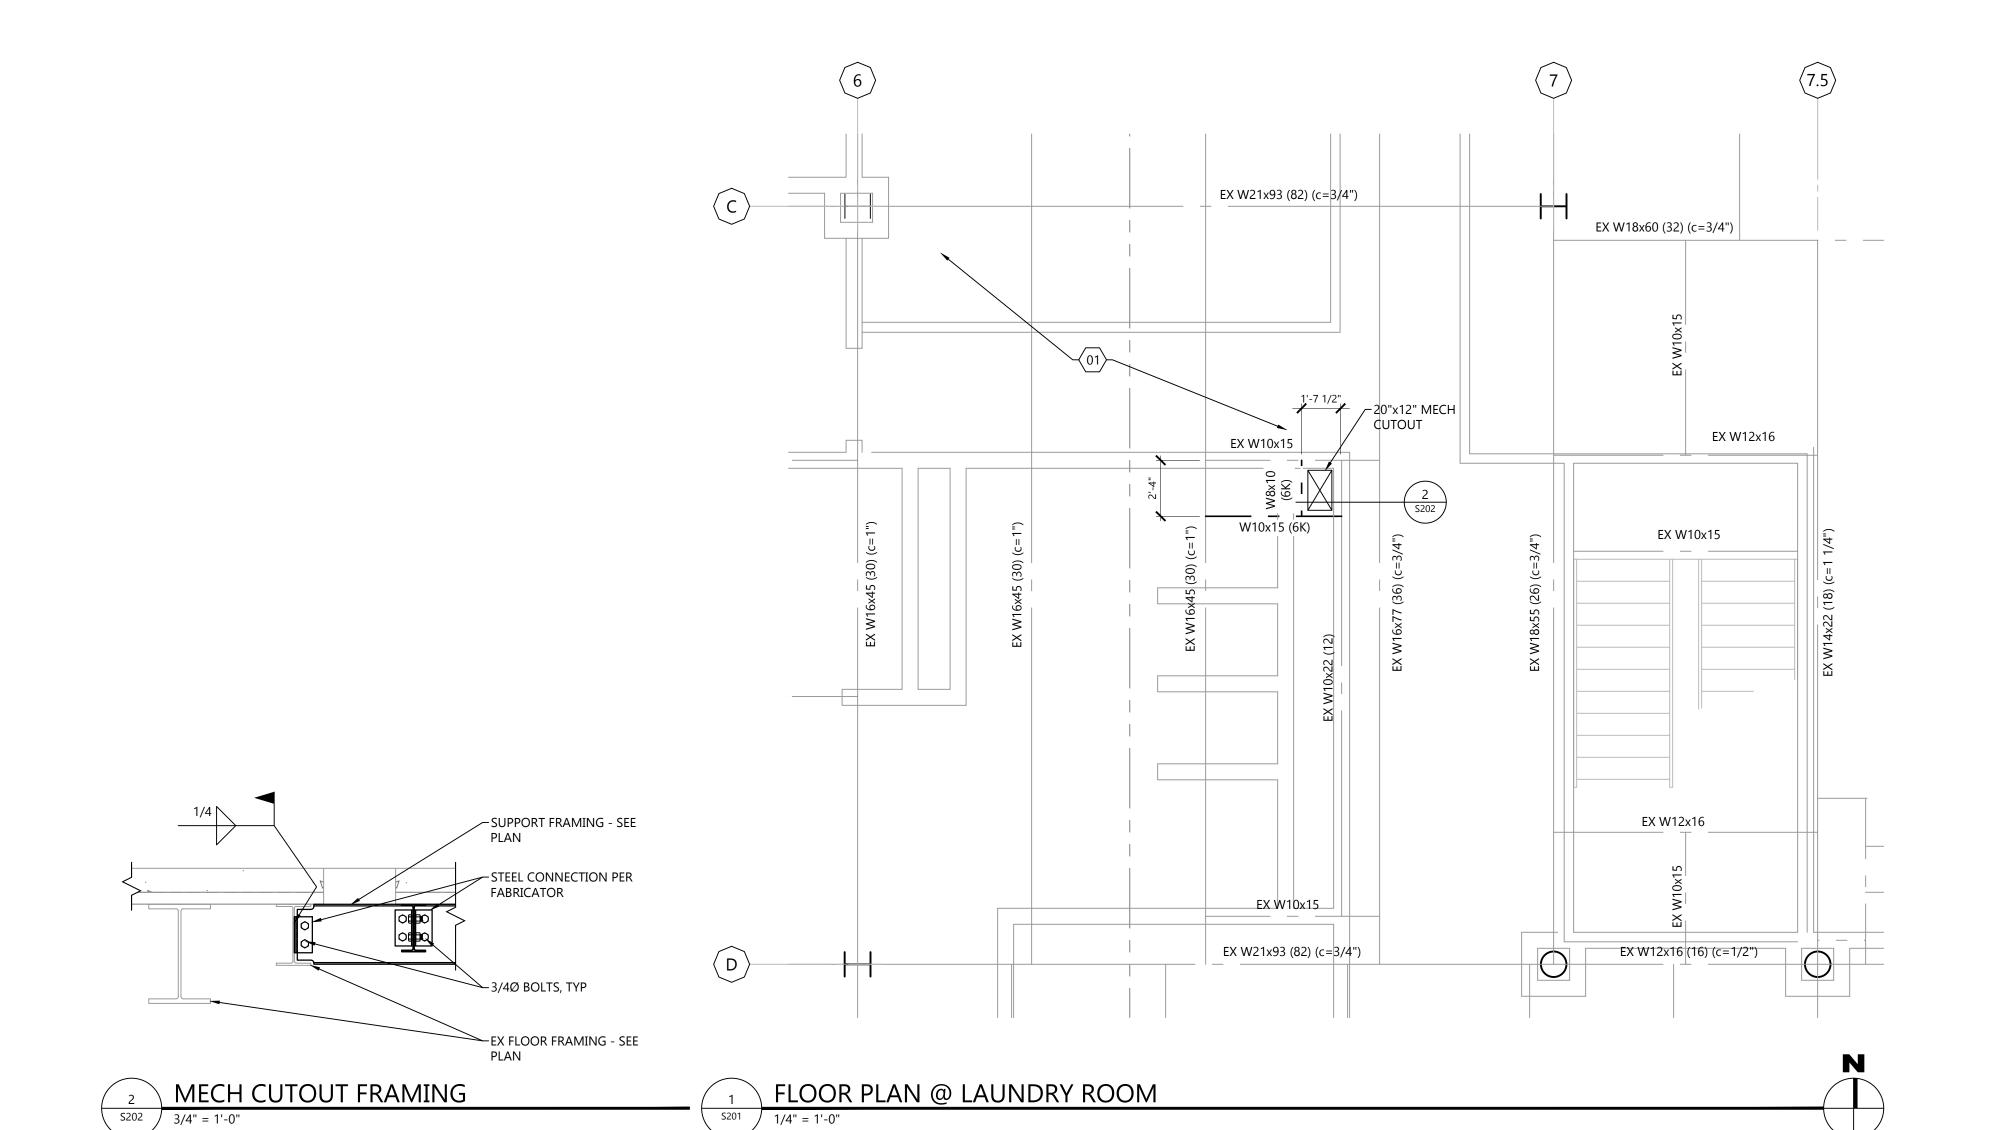
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MECHANICAL CUTOUT

S202



 $\langle \#\# \rangle$ < < Indicates Keynote on Plan

01 SAW CUT AND REMOVE EXISTING EDGE OF TRENCH DRAIN.

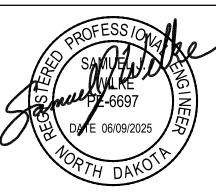02 WASHER CONCRETE PAD, MATCH EXISTING.

03 CFS STUD WALL, MATCH EXISTING.

04 EXISTING 4" CONCRETE SLAB OVER 2"x20 GA COMPOSITE METAL DECK (6" TOTAL THICKNESS).

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WILLIAMS COUNTY LAW ENFORCEMENT CENTER

PROJECT DESCRIPTION

WILLIAMS COUNTY LAW ENFORCEMENT CENTER INFIRMARY

WILLISTON CITY ND STATE

ISSUE DATES

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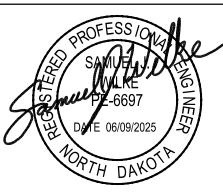
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