PRELIMINARY SITE PLANS

TAILGATERS

WILLIAMSTON ROAD & I-96
CITY OF WILLIAMSTON, INGHAM COUNTY, MICHIGAN

DATE SUBMITTED DATE APPROVED PERMIT / APPROVAL

11/8/2024 PRELIMINARY SITE PLAN SUBMITTAL



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SD-500	ARCHITECTURAL SITE DETAILS
SD-501	ARCHITECTURAL SITE DETAILS
	OUTDOOR LIVING LANDSCAPE PLAN
24110-C	LANDSCAPE PLAN

DESIGN TEAM


OWNER


TG PROPERTIES WILLIAMSTON, LLC 3450 OKEMOS ROAD OKEMOS, MI 48309 CONTACT: JEFF HADDAD EMAIL: JEFF@MYTAILGATERS.COM PEA GROUP 58105 VAN DYKE RD. WASHINGTON TWP., MI 48094 CONTACT: DOUG BRINKER, PE PHONE: 844.813.2949 EMAIL: DBRINKER@PEAGROUP.COM

CIVIL ENGINEER

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GROUP

t: 844.813.2949 www.peagroup.com

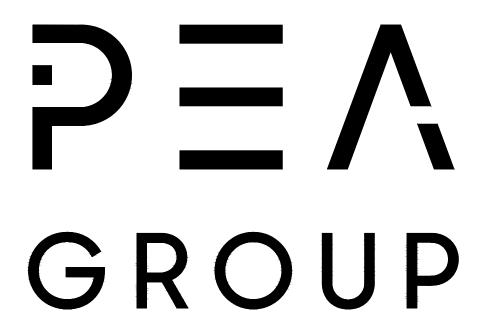EX. SANITARY CLEANOUT & MANHOLE EX. COMBINED SEWER MANHOLE —— -- EX. STORM SEWER EX. CLEANOUT & MANHOLE EX. SQUARE, ROUND & BEEHIVE CATCH BASIN O^{Y.D.}® ® EX. YARD DRAIN, U.G. ROOF DRAIN & DOWNSPOUT EX. UNIDENTIFIED STRUCTURE $exttt{M} o exttt{\%} exttt{O}^{ exttt{GP}}$ EX. MAILBOX, SIGN, LIGHTPOLE & GUARD POST

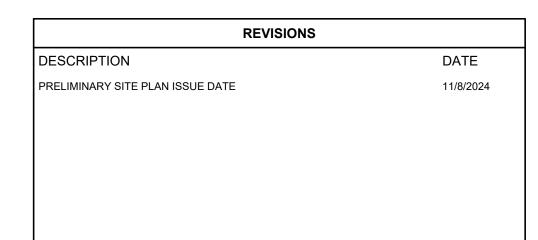EX. DEC. TREE, CONIFEROUS TREE & SHRUB EX. TREE TAG, & TREE LINE EX. SPOT ELEVATION EX. CONTOUR EX. WETLAND

EX. WATER VALVE BOX & SHUTOFF

IRON FOUND / SET NAIL FOUND / NAIL & CAP SET BRASS PLUG SET MONUMENT FOUND / SET

SECTION CORNER FOUND RECORDED / MEASURED / CALCULATED REFERENCE DRAWINGS:


JONES & HENRY ENGINEERS, LTD. WILLIAMSTON RD. DATED MAY 199





THE LOCATIONS AND ELEVATIONS OF EXISTING UNDERGRUTHITIES AS SHOWN ON THIS DRAWING ARE ONLY APPROXIMATE. NO GUARANTEE IS EITHER EXPRESSED OR IMPLIED AS TO THE COMPLETENESS OR ACCURACY THEREOI THE CONTRACTOR SHALL BE EXCLUSIVELY RESPONSIBLE FOR DETERMINING THE EXACT UTILITY LOCATIONS AND ELEVATIONS PRIOR TO THE START OF CONSTRUCTION.

CAUTION!!

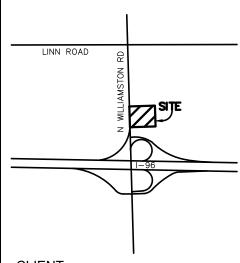

TG PROPERTIES WILLIAMSTON LLC 3450 OKEMOS ROAD

(2) South 87 degrees 48 minutes 43 seconds West,

PROJECT TITLE

TAILGATERS
WILLIAMSTON ROAD & I-96
VILLAGE OF WILLIAMSTON, INGHAM COUNTY, MI

BENCHMARKS (NAVD 88, GPS DERIVED)

BM #300 NORTHEAST BOLT ON FIRE HYDRANT, LOCATED NORTH OF THE EXISTING DRIVE OF SUBJECT PROPERTY ALONG THE EAST SIDE OF WILLIAMSTON ROAD. ELEV. — 897.64

REVISIONS

ORIGINAL ISSUE DATE: NOVEMBER 8, 2024

DRAWING TITLE **TOPOGRAPHIC SURVEY**

PEA JOB NO.	2024-1335
P.M.	BW
DN.	HZ
DES.	DB
DRAWING NUMBER	


TAG No	O. CODE E	DBH II	COMMON NAME American Elm	LATIN NAME Ulmus americana	COND Fair	COMMENTS
1065	GA	8	Green Ash	Fraxinus pennsylvanica	Poor	
1066	СТ	16	Cottonwood	Populus deltoides	Fair	
1067	BX E	6	Box elder American Elm	Acer negundo Ulmus americana	Fair Fair	
1069	BW	12	Black Walnut	Juglans nigra	Good	
1070	BW	9	Black Walnut	Juglans nigra	Fair	x3
1071	BX	11	Boxelder	Acer negundo	Poor	
1072	BX BW	17	Boxelder Black Walnut	Acer negundo Juglans nigra	Fair Fair	x6
1074	MW	13	White Mulberry	Morus alba	Fair	
1075	MW	12	White Mulberry	Morus alba	Fair	
1076	BW CT	11	Black Walnut Cottonwood	Juglans nigra Populus deltoides	Fair Fair	
1078	CT	7	Cottonwood	Populus deltoides	Fair	
1079	MW	16	White Mulberry	Morus alba	Fair	
1080	BX BW	14 21	Box elder	Acer negundo	Fair Good	<u>x</u> 1
1081	E	10	Black Walnut American Elm	Juglans nigra Ulmus americana	Fair	
1083	Е	12	American Elm	Ulmus americana	Fair	
1084	RP	15	Red Pine	Pinus resinosa	Poor	
1085	MW BX	8 10	White Mulberry Box elder	Morus alba Acer negundo	Fair Poor	x1
1087	E	6	American Elm	Ulmus americana	Poor	
1088	E	14	American Elm	Ulmus americana	Poor	
1089	BX BX	7	Box elder Box elder	Acer negundo	Fair Fair	
1090	HK	6	Hackberry	Acer negundo Celtis occidentalis	Fair	
1092	BW	8	Black Walnut	Juglans nigra	Fair	
1093	CT	13	Cottonwood	Populus deltoides	Fair	
1094	BW BW	6	Black Walnut Black Walnut	Juglans nigra Juglans nigra	Good Fair	
1096	СТ	11	Cottonwood	Populus deltoides	Good	
1097	BW	6	Black Walnut	Juglans nigra	Good	
1098	BW BW	10	Black Walnut	Juglans nigra	Good Fair	
1100	BX	10	Black Walnut Box elder	Juglans nigra Acer negundo	Very poor	
1101	BX	11	Boxelder	Acer negundo	Poor	
1102	BW	22	Black Walnut	Juglans nigra	Good	
1103	BW CT	23	Black Walnut Cottonwood	Juglans nigra Populus deltoides	Good Good	
1105	CT	12	Cottonwood	Populus deltoides	Good	
1106	МН	8	Bittemut Hickory	Carya cordiformis	Fair	
1107	MH E	12 8	Bittemut Hickory American Elm	Carya cordiformis Ulmus americana	Good Fair	
1109	MH	8	Bittemut Hickory	Carya cordiformis	Good	
1110	BW	17	Black Walnut	Juglans nigra	Good	
1111	E E	20 15	American Elm American Elm	Ulmus americana	Fair Fair	
1113	BW	10	Black Walnut	Ulmus americana Juglans nigra	Fair	
1114	Е	10	American Elm	Ulmus americana	Poor	
1115	E E	6	American Elm	Ulmus americana	Fair	
1116	E E	8	American Elm American Elm	Ulmus americana Ulmus americana	Fair Fair	
1118	МН	22	Bitternut Hickory	Carya cordiformis	Fair	
1119	MH	18	Bitternut Hickory	Carya cordiformis	Fair	
1120	MH MH	9	Bitternut Hickory Bitternut Hickory	Carya cordiformis Carya cordiformis	Fair Fair	
1122	swo	6	Swamp White Oak	Quercus bicolor	Fair	
1123	MH	30	Bitternut Hickory	Carya cordiformis	Fair	
1124	MH	8	Bitternut Hickory Bitternut Hickory	Carya cordiformis Carya cordiformis	Fair Fair	
1126	МН	1 8			- ++	
	MH MH	8	Bitternut Hickory	Carya cordiformis	Fair	
1127	MH BW	8	Bittemut Hickory Black Walnut	Carya cordiformis Juglans nigra	Fair	
1128	MH BW E	8 6 16	Bitternut Hickory Black Walnut American Elm	Carya cordiformis Juglans nigra Ulmus americana	Fair Fair	
	MH BW	8	Bittemut Hickory Black Walnut American Elm American Elm	Carya cordiformis Juglans nigra Ulmus americana Ulmus americana	Fair	
1128 1129	MH BW E E	8 6 16 12	Bitternut Hickory Black Walnut American Elm	Carya cordiformis Juglans nigra Ulmus americana	Fair Fair Fair	
1128 1129 1130 1131 1132	MH BW E E E SM BC	8 6 16 12 19 31 15	Bitternut Hickory Black Walnut American Elm American Elm American Elm Silver Maple Wild Black Cherry	Carya cordiformis Juglans nigra Ulmus americana Ulmus americana Ulmus americana Acer saccharinum Prunus serotina	Fair Fair Fair Good Good Fair	
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1128 1129 1130 1131 1132 1133 1134 1135 1136 1137 1138 1139 1140 1141 1142 1142 1144 1145 1146 1147 1148 1149 1150 1151 1152 1153 1154 1155 1156 1157 1158 1159 1160 1161 1162 1163	MH BW E E E SM BC E BC BC E BC BC E BC BC	8 6 16 12 19 31 15 19 7 6 7 12 10 6 8 7 6 32 17 18 6 6 7 8 14 9 18 7 8 9 9 12 13 18	Bittemut Hickory Black Walnut American Elm American Elm American Elm Silver Maple Wild Black Cherry American Elm Wild Black Cherry American Elm Wild Black Cherry American Elm Silver Maple American Elm Wild Black Cherry Domestic Cherry Domestic Cherry Silver Maple Thornapple/Hawthome American Elm American Elm American Elm Silver Maple Thornapple/Hawthome American Elm American Elm American Elm American Elm American Elm American Elm Cherry Wild Black Cherry Under Maple Wild Black Cherry Wild Black Cherry Cottonwood Cottonwood Cottonwood	Carya cordiformis Juglans nigra Ulmus americana Ulmus americana Ulmus americana Ulmus americana Acer saccharinum Prunus serotina Ulmus americana Acer saccharinum Acer saccharinum Ulmus americana Prunus serotina Ulmus americana Prunus serotina Ulmus americana Ulmus americana Ulmus americana Prunus serotina Ulmus americana Prunus serotina Ulmus avium Acer saccharinum Acer saccharinum Prunus avium Acer saccharinum Prunus serotina Ulmus americana Acer saccharinum Prunus serotina	Fair Fair Good Good Fair Fair Fair Fair Fair Fair Fair Fair	
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1128 1129 1130 1131 1132 1133 1134 1135 1136 1137 1138 1139 1140 1141 1142 1144 1145 1146 1147 1148 1149 1150 1151 1152 1153 1154 1155 1156 1157 1158 1159 1160 1161 1162 1163 1164 1165	MH BW E E E SM BC E BC BC BC BC BC BC	8 6 16 12 19 31 15 19 7 6 7 12 10 6 8 7 6 32 17 18 6 6 7 8 14 9 18 7 8 9 9 12 13 18	Bittemut Hickory Black Walnut American Elm American Elm American Elm Silver Maple Wild Black Cherry American Elm Wild Black Cherry American Elm Wild Black Cherry American Elm Silver Maple Silver Maple American Elm Wild Black Cherry Domestic Cherry Silver Maple Thornapple/Hawthome American Elm American Elm Silver Maple Thornapple/Hawthome American Elm Silver Maple Thornapple Hawthome American Elm Cottonwood Cottonwood Cottonwood Cottonwood Cottonwood	Carya cordiformis Juglans nigra Ulmus americana Ulmus americana Ulmus americana Ulmus americana Acer saccharinum Prunus serotina Ulmus americana Acer saccharinum Acer saccharinum Ulmus americana Ulmus americana Prunus serotina Ulmus americana Ulmus americana Ulmus americana Ulmus americana Prunus serotina Ulmus americana Prunus serotina Prunus avium Acer saccharinum Acer saccharinum Prunus avium Acer saccharinum Prunus avium Acer saccharinum Prunus serotina Ulmus americana Ulmus adeltoidas Populus deltoides Populus deltoides Populus deltoides Populus deltoides	Fair Fair Good Good Fair Fair Fair Fair Fair Fair Fair Fair	
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1128 1129 1130 1131 1132 1133 1134 1135 1136 1137 1138 1139 1140 1141 1142 1142 1144 1145 1146 1147 1148 1149 1150 1151 1152 1153 1154 1155 1156 1157 1158 1159 1160 1161 1162 1163 1164 1165 1166 1167 1168	MH BW E E E SM BC E BC BC E BC BC BC	8 6 16 12 19 31 15 19 7 6 7 12 10 6 8 7 6 32 17 18 6 6 7 8 14 9 18 7 8 9 9 12 13 13 18 21 6 6	Bittemut Hickory Black Walnut American Elm American Elm Silver Maple Wild Black Cherry American Elm Wild Black Cherry American Elm Wild Black Cherry American Elm Wild Black Cherry American Elm Silver Maple Silver Maple Silver Maple American Elm Wild Black Cherry Domestic Cherry Domestic Cherry Understic Cherry Domestic Cherry Silver Maple Thornapple/Hawthome American Elm American Elm Silver Maple Thornapple Hawthome American Elm American Elm Silver Maple Thornapple Hawthome American Elm Cherry Uild Black Cherry Wild Black Cherry Wild Black Cherry Cottonwood	Carya cordiformis Juglans nigra Ulmus americana Ulmus americana Ulmus americana Ulmus americana Ulmus serotina Ulmus americana Prunus serotina Ulmus americana Ulmus americana Prunus serotina Ulmus americana Acer saccharinum Acer saccharinum Ulmus americana Prunus serotina Ulmus americana Prunus serotina Ulmus americana Ulmus americana Ulmus americana Prunus serotina Ulmus americana Prunus serotina Prunus serotina Prunus serotina Prunus avium Acer saccharinum Crataegus spp. Ulmus americana Ulmus americana Acer saccharinum Prunus serotina Prunus serotina Prunus serotina Prunus serotina Prunus serotina Prunus deltoides Populus deltoides	Fair Fair Good Good Fair Fair Fair Fair Fair Fair Fair Fair	
1128 1129 1130 1131 1132 1133 1134 1135 1136 1137 1138 1139 1140 1141 1142 1144 1145 1146 1147 1148 1149 1150 1151 1152 1153 1154 1155 1156 1157 1158 1159 1160 1161 1162 1163 1164 1165 1166 1167	MH BW E E E SM BC E BC BC BC BC BC BC	8 6 16 12 19 31 15 19 7 6 7 12 10 6 8 7 6 32 17 18 6 6 7 8 14 9 18 7 8 6 13 9 9 12 13 14 9 18 19 10 10 10 10 10 10 10 10 10 10	Bittemut Hickory Black Walnut American Elm American Elm American Elm Silver Maple Wild Black Cherry American Elm Wild Black Cherry American Elm Wild Black Cherry American Elm Wild Black Cherry American Elm Silver Maple Silver Maple American Elm Wild Black Cherry Domestic Cherry Domestic Cherry Understic Cherry Domestic Cherry Silver Maple Thornapple/Hawthome American Elm American Elm Silver Maple Thornapple Hawthome American Elm Silver Maple Thornapple Hawthome American Elm Silver Maple Thornapple Cherry Utild Black Cherry Wild Black Cherry Cottonwood Cottonwood Cottonwood Cottonwood Cottonwood Cottonwood Cottonwood Cottonwood Cottonwood	Carya cordiformis Juglans nigra Ulmus americana Ulmus americana Ulmus americana Acer saccharinum Prunus serotina Ulmus americana Acer saccharinum Acer saccharinum Ulmus americana Prunus serotina Prunus avium Acer saccharinum Acer saccharinum Prunus avium Acer saccharinum Prunus serotina Ulmus americana Acer saccharinum Prunus serotina Prunus serotina Prunus serotina Acer saccharinum Prunus deltoides Populus deltoides	Fair Fair Good Good Fair Fair Fair Fair Fair Fair Fair Fair	

AG NO.	CODE CT	DBH 11	COMMON NAME Cottonwood	Populus deltoides	COND Fair	COMMENTS
1172	E	6	American Elm	Ulmus americana	Fair	
1173	BX	6	Boxelder	Acer negundo	Fair	
1174	BG	8	Bigtooth Aspen	Populus grandidentata	Fair	
1175	E E	11	American Elm American Elm	Ulmus americana Ulmus americana	Fair Fair	
1177	BC	17	Wild Black Cherry	Prunus serotina	Good	
1178	BC	12	Wild Black Cherry	Prunus serotina	Good	
1179	E E	9	American Elm American Elm	Ulmus americana Ulmus americana	Fair Fair	
1181	E	6	American Elm	Ulmus americana	Fair	
1182	Е	6	American Elm	Ulmus americana	Good	
1183	Е	8	American Elm	Ulmus americana	Poor	
1184	E GA	9 7	American Elm Green Ash	Ulmus americana Fraxinus pennsylvanica	Fair Good	
1186	E	14	American Elm	Ulmus americana	Good	
1187	Е	7	American Elm	Ulmus americana	Fair	
1188	SM	18	Silver Maple	Acer saccharinum	Good	
1189	BX CT	10 6	Box elder Cottonwood	Acer negundo Populus deltoides	Fair	
1191	CT	11	Cottonwood	Populus deltoides	Fair	
1192	Е	9	American Elm	Ulmus americana	Good	
1193	BX	9	Boxelder	A cer negundo	Fair	
1194	E E	12 8	American Elm American Elm	Ulmus americana Ulmus americana	Good Good	
1196	E	7	American Elm	Ulmus americana	Fair	
1197	Е	8	American Elm	Ulmus americana	Fair	
1198	Е	7	American Elm	Ulmus americana	Fair	
1199	SU	12	Sugar Maple	Acer saccharum	Good	
1200 1201	E E	6	American Elm American Elm	Ulmus americana Ulmus americana	Fair Fair	
1201	E	6	American Elm	Ulmus americana	Good	
1206	Е	9	American Elm	Ulmus americana	Fair	
1207	Е	6	American Elm	Ulmus americana	Fair	
1208 1209	E E	10 8	American Elm American Elm	Ulmus americana Ulmus americana	Poor Fair	
1210	SU	10	Sugar Maple	Acer saccharum	Good	
1211	SU	6	Sugar Maple	Acer saccharum	Fair	
1212	SU	7	Sugar Maple	Acer saccharum	Good	
1213 1214	E SU	12	American Elm Sugar Maple	Ulmus americana Acer saccharum	Fair Good	
1214	E	6	American Elm	Ulmus americana	Fair	
1216	ВС	12	Wild Black Cheny	Prunus serotina	Fair	
1217	SU	14	Sugar Maple	Acer saccharum	Good	
1218 1219	SU BX	7	Sugar Maple Box elder	Acer saccharum Acer negundo	Fair Fair	
1219	CT	12	Cottonwood	Populus deltoides	Good	
1221	CT	13	Cottonwood	Populus deltoides	Good	
1222	CT	8	Cottonwood	Populus deltoides	Fair	
1223 1224	CT CT	8 6	Cottonwood Cottonwood	Populus deltoides Populus deltoides	Fair Fair	
1224	CT	8	Cottonwood	Populus deltoides	Fair	
1226	CT	8	Cottonwood	Populus deltoides	Fair	
1227	CT	8	Cottonwood	Populus deltoides	Good	
1228 1229	CT CT	11 7	Cottonwood Cottonwood	Populus deltoides Populus deltoides	Good Fair	
1230	CT	7	Cottonwood	Populus deltoides	Fair	
1231	МН	8	Bitternut Hickory	Carya cordiformis	Fair	xl
1232	CT	7	Cottonwood	Populus deltoides	Fair	
1233 1234	CT MH	7	Cottonwood Bitternut Hickory	Populus deltoides Carya cordiformis	Good Fair	
1235	BX	6	Boxelder	Acer negundo	Fair	
1236	МН	7	Bitternut Hickory	Carya cordiformis	Good	
1237	МН	6	Bitternut Hickory	Carya cordiformis	Good	
1238 1239	CT CT	7 9	Cottonwood Cottonwood	Populus deltoides Populus deltoides	Good Good	
1239	CT	7	Cottonwood	Populus deltoides	Good	
1241	CT	11	Cottonwood	Populus deltoides	Fair	
1242	CT	9	Cottonwood	Populus deltoides	Fair	
1243 1244	CT CT	6 7	Cottonwood Cottonwood	Populus deltoides Populus deltoides	Fair Fair	
1244	CT	10	Cottonwood	Populus deltoides Populus deltoides	Fair Fair	
1246	ВС	21	Wild Black Cherry	Prunus serotina	Fair	
1247	CT	6	Cottonwood	Populus deltoides	Fair	
1248 1249	CT CT	7	Cottonwood Cottonwood	Populus deltoides Populus deltoides	Good Fair	
1249	CT	7	Cottonwood	Populus deltoides Populus deltoides	Fair Fair	
1251	CT	6	Cottonwood	Populus deltoides	Fair	
1252	CT	8	Cottonwood	Populus deltoides	Fair	
1253	CT	10	Cottonwood	Populus deltoides	Good	
1254 1255	CT CT	9	Cottonwood Cottonwood	Populus deltoides Populus deltoides	Fair Fair	ivy covered
1256	CT	6	Cottonwood	Populus deltoides	Good	
1257	CT	7	Cottonwood	Populus deltoides	Fair	
1258	CT	10	Cottonwood	Populus deltoides	Good	
1259 1260	CT CT	10	Cottonwood Cottonwood	Populus deltoides Populus deltoides	Fair Fair	
1261	CT	6	Cottonwood	Populus deltoides Populus deltoides	Fair	
1262	CT	7	Cottonwood	Populus deltoides	Good	
1263	CT	11	Cottonwood	Populus deltoides	Good	
1264 1265	CT CT	9	Cottonwood Cottonwood	Populus deltoides Populus deltoides	Good	
1265	MH	6	Cottonwood Bitternut Hickory	Populus deltoides Carya cordiformis	Good Good	
1267	CT	8	Cottonwood	Populus deltoides	Good	
1268	CT	8	Cottonwood	Populus deltoides	Good	
1269	CT	10	Cottonwood	Populus deltoides	Fair	
1270 1271	CT CT	16 11	Cottonwood Cottonwood	Populus deltoides Populus deltoides	Fair Fair	
1271	MH	6	Bitternut Hickory	Carya cordiformis	Fair Fair	x1
1272	MH	7	Bitternut Hickory	Carya cordiformis	Good	
	МН	10	Bitternut Hickory	Carya cordiformis	Good	xl
1274 1275	CT		Cottonwood	Populus deltoides	Fair	

TAG NO. 1277	CODE	DBH 9	COMMON NAME Cottonwood	LATIN NAME Populus deltoides	COND Fair	COMMENTS
1278	MH	6	Bitternut Hickory	Carya cordiformis	Good	
1279	CT	9	Cottonwood	Populus deltoides	Good	
1280 1281	CT CT	14	Cottonwood Cottonwood	Populus deltoides Populus deltoides	Fair Good	
1282	СТ	12	Cottonwood	Populus deltoides	Good	
1283	MH	7	Bittemut Hickory	Carya cordiformis	Good	
1284 1285	CT CT	13 11	Cottonwood Cottonwood	Populus deltoides Populus deltoides	Good Fair	
1286	C.I.	6	Cottonwood	Populus deltoides	Fair	
1287	CT	10	Cottonwood	Populus deltoides	Fair	
1288 1289	CT CT	10 11	Cottonwood Cottonwood	Populus deltoides Populus deltoides	Good Good	
1290	E	8	American Elm	Ulmus americana	Fair	
1291	CT	12	Cottonwood	Populus deltoides	Good	
1292 1293	BX CT	13 14	Box elder Cottonwood	Acer negundo Populus deltoides	Fair Good	x1
1294	CT	10	Cottonwood	Populus deltoides	Fair	
1295	СТ	10	Cottonwood	Populus deltoides	Fair	
1296 1297	CT CT	11	Cottonwood Cottonwood	Populus deltoides Populus deltoides	Fair Fair	
1297	CT	14	Cottonwood	Populus deltoides	Fair	
1299	СТ	9	Cottonwood	Populus deltoides	Fair	
1300	CT	14	Cottonwood	Populus deltoides	Good	
1301 1302	BX BX	8	Box elder Box elder	Acer negundo Acer negundo	Fair Fair	
1303	BX	6	Boxelder	Acer negundo	Fair	x3
1304	BX	8	Boxelder	Acer negundo	Fair	x2
1305 1306	AA BW	14 6	Tree-of-Heaven Black Walnut	Ailanthus altissima Juglans nigra	Fair Good	
1307	BW	7	Black Walnut	Juglans nigra Juglans nigra	Good	
1308	BX	17	Boxelder	Acer negundo	Good	
1309	CT	10	Cottonwood White Mulberry	Populus deltoides	Fair Fair	
1310	MW CT	7 15	White Mulberry Cottonwood	Morus alba Populus deltoides	Fair Fair	
1312	CT	11	Cottonwood	Populus deltoides	Fair	
1313	CT	11	Cottonwood	Populus deltoides	Fair	
1314 1315	BX BW	12 8	Box elder Black Walnut	Acer negundo Juglans nigra	Fair Good	
1316	CT CT	17	Cottonwood	Populus deltoides	Fair	
1317	BX	14	Boxelder	Acer negundo	Fair	xl
1318 1319	CT BW	9	Cottonwood Black Walnut	Populus deltoides Juglans nigra	Fair Fair	
1319	BW	11	Black Walnut	Jugians nigra Jugians nigra	Good	
1321	MW	9	White Mulberry	Morus alba	Fair	
1322	BX	10	Boxelder	Acer negundo	Fair	
1323 1324	BW BX	12 10	Black Walnut Boxelder	Juglans nigra Acer negundo	Good Fair	x1
1325	BX	6	Boxelder	Acer negundo	Fair	
1326	BW	15	Black Walnut	Juglans nigra	Fair	
1327 1328	CT BX	14 6	Cottonwood Box elder	Populus deltoides Acer negundo	Fair Fair	
1329	СТ	17	Cottonwood	Populus deltoides	Good	
1330	BX	7	Boxelder	Acer negundo	Fair	<u>x</u> 1
1331 1332	BW CT	12 9	Black Walnut Cottonwood	Juglans nigra Populus deltoides	Good Fair	
1333	CT	16	Cottonwood	Populus deltoides	Good	
1334	BW	17	Black Walnut	Juglans nigra	Good	
1335 1336	BX GA	6	Boxelder Green Ash	Acer negundo Fraxinus pennsylvanica	Fair Fair	x2 x1
1337	BX	7	Boxelder	Acer negundo	Fair	
1338	CT	18	Cottonwood	Populus deltoides	Good	
1339 1340	BX BW	10 18	Box elder Black Walnut	Acer negundo Juglans nigra	Fair Good	xl
1341	SM	15	Silver Maple	Acer saccharinum	Fair	
1342	SM	9	Silver Maple	Acer saccharinum	Fair	
1343 1344	BX BX	11	Box elder Box elder	Acer negundo Acer negundo	Fair Fair	x3
1345	Е	12	American Elm	Ulmus americana	Fair	
1346	MW	10	White Mulberry	Morus alba	Fair	
1347 1348	SM SM	9	Silver Maple Silver Maple	Acer saccharinum Acer saccharinum	Good Fair	x3
1349	СТ	16	Cottonwood	Populus deltoides	Good	
1350	SM	6	Silver Maple	Acer saccharinum	Good	
1351 1352	SM SM	6 10	Silver Maple Silver Maple	Acer saccharinum Acer saccharinum	Fair Good	
1353	BX	13	Boxelder	Acer negundo	Fair	
1354	SM	10	Silver Maple	A cer saccharinum	Good	
1355 1356	CT BW	14 14	Cottonwood Black Walnut	Populus deltoides Juglans nigra	Fair Fair	
1357	CT	11	Cottonwood	Populus deltoides	Fair	
1358	AS	8	Quaking Aspen	Populus tremuloides	Fair	
1359 1360	BX AS	16 8	Boxelder Quaking Aspen	Acer negundo Populus tremuloides	Fair Fair	
1361	CT	15	Cottonwood	Populus deltoides	Fair	
1362	СТ	16	Cottonwood	Populus deltoides	Fair	
1363 1364	MW AS	7 10	White Mulberry Quaking Aspen	Morus alba Populus tremuloides	Fair Fair	
1365	SM	6	Silver Maple	A cer saccharinum	Good	
1366	CT	14	Cottonwood	Populus deltoides	Good	
1367 1368	CT CT	7	Cottonwood Cottonwood	Populus deltoides Populus deltoides	Fair Fair	
1369	СТ	14	Cottonwood	Populus deltoides	Good	
1370	BW	8 1 ô	Black Walnut	Juglans nigra	Fair	
1371 1372	E SWO	10 20	American Elm Swamp White Oak	Ulmus americana Quercus bicolor	Fair Good	
1372	BX	9	Swamp White Oak Boxelder	Acer negundo	Good Fair	
1374	CT	17	Cottonwood	Populus deltoides	Fair	
1375	BX	7	Box elder	Acer negundo	Fair Fair	
1376 1377	BX CT	10 17	Box elder Cottonwood	Acer negundo Populus deltoides	Fair Good	
1 2777	~ .			. g menonee		






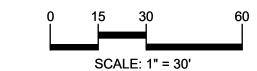



CAUTION!!

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TG PROPERTIES WILLIAMSTON LLC
3450 OKEMOS ROAD OKEMOS, MI 48864

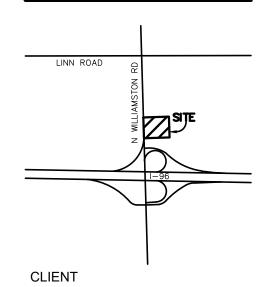PROJECT TITLE

TAILGATERS
WILLIAMSTON ROAD & I-96
VILLAGE OF WILLIAMSTON, INGHAM COUNTY, MI


REVISIONS		
-		-

ORIGINAL ISSUE DATE: NOVEMBER 8, 2024


DRAWING TITLE

TREE LIST


	PEA JOB NO.	2024-1335
	P.M.	BW
	DN.	HZ
	DES.	DB
·	DRAWING NUMBER:	

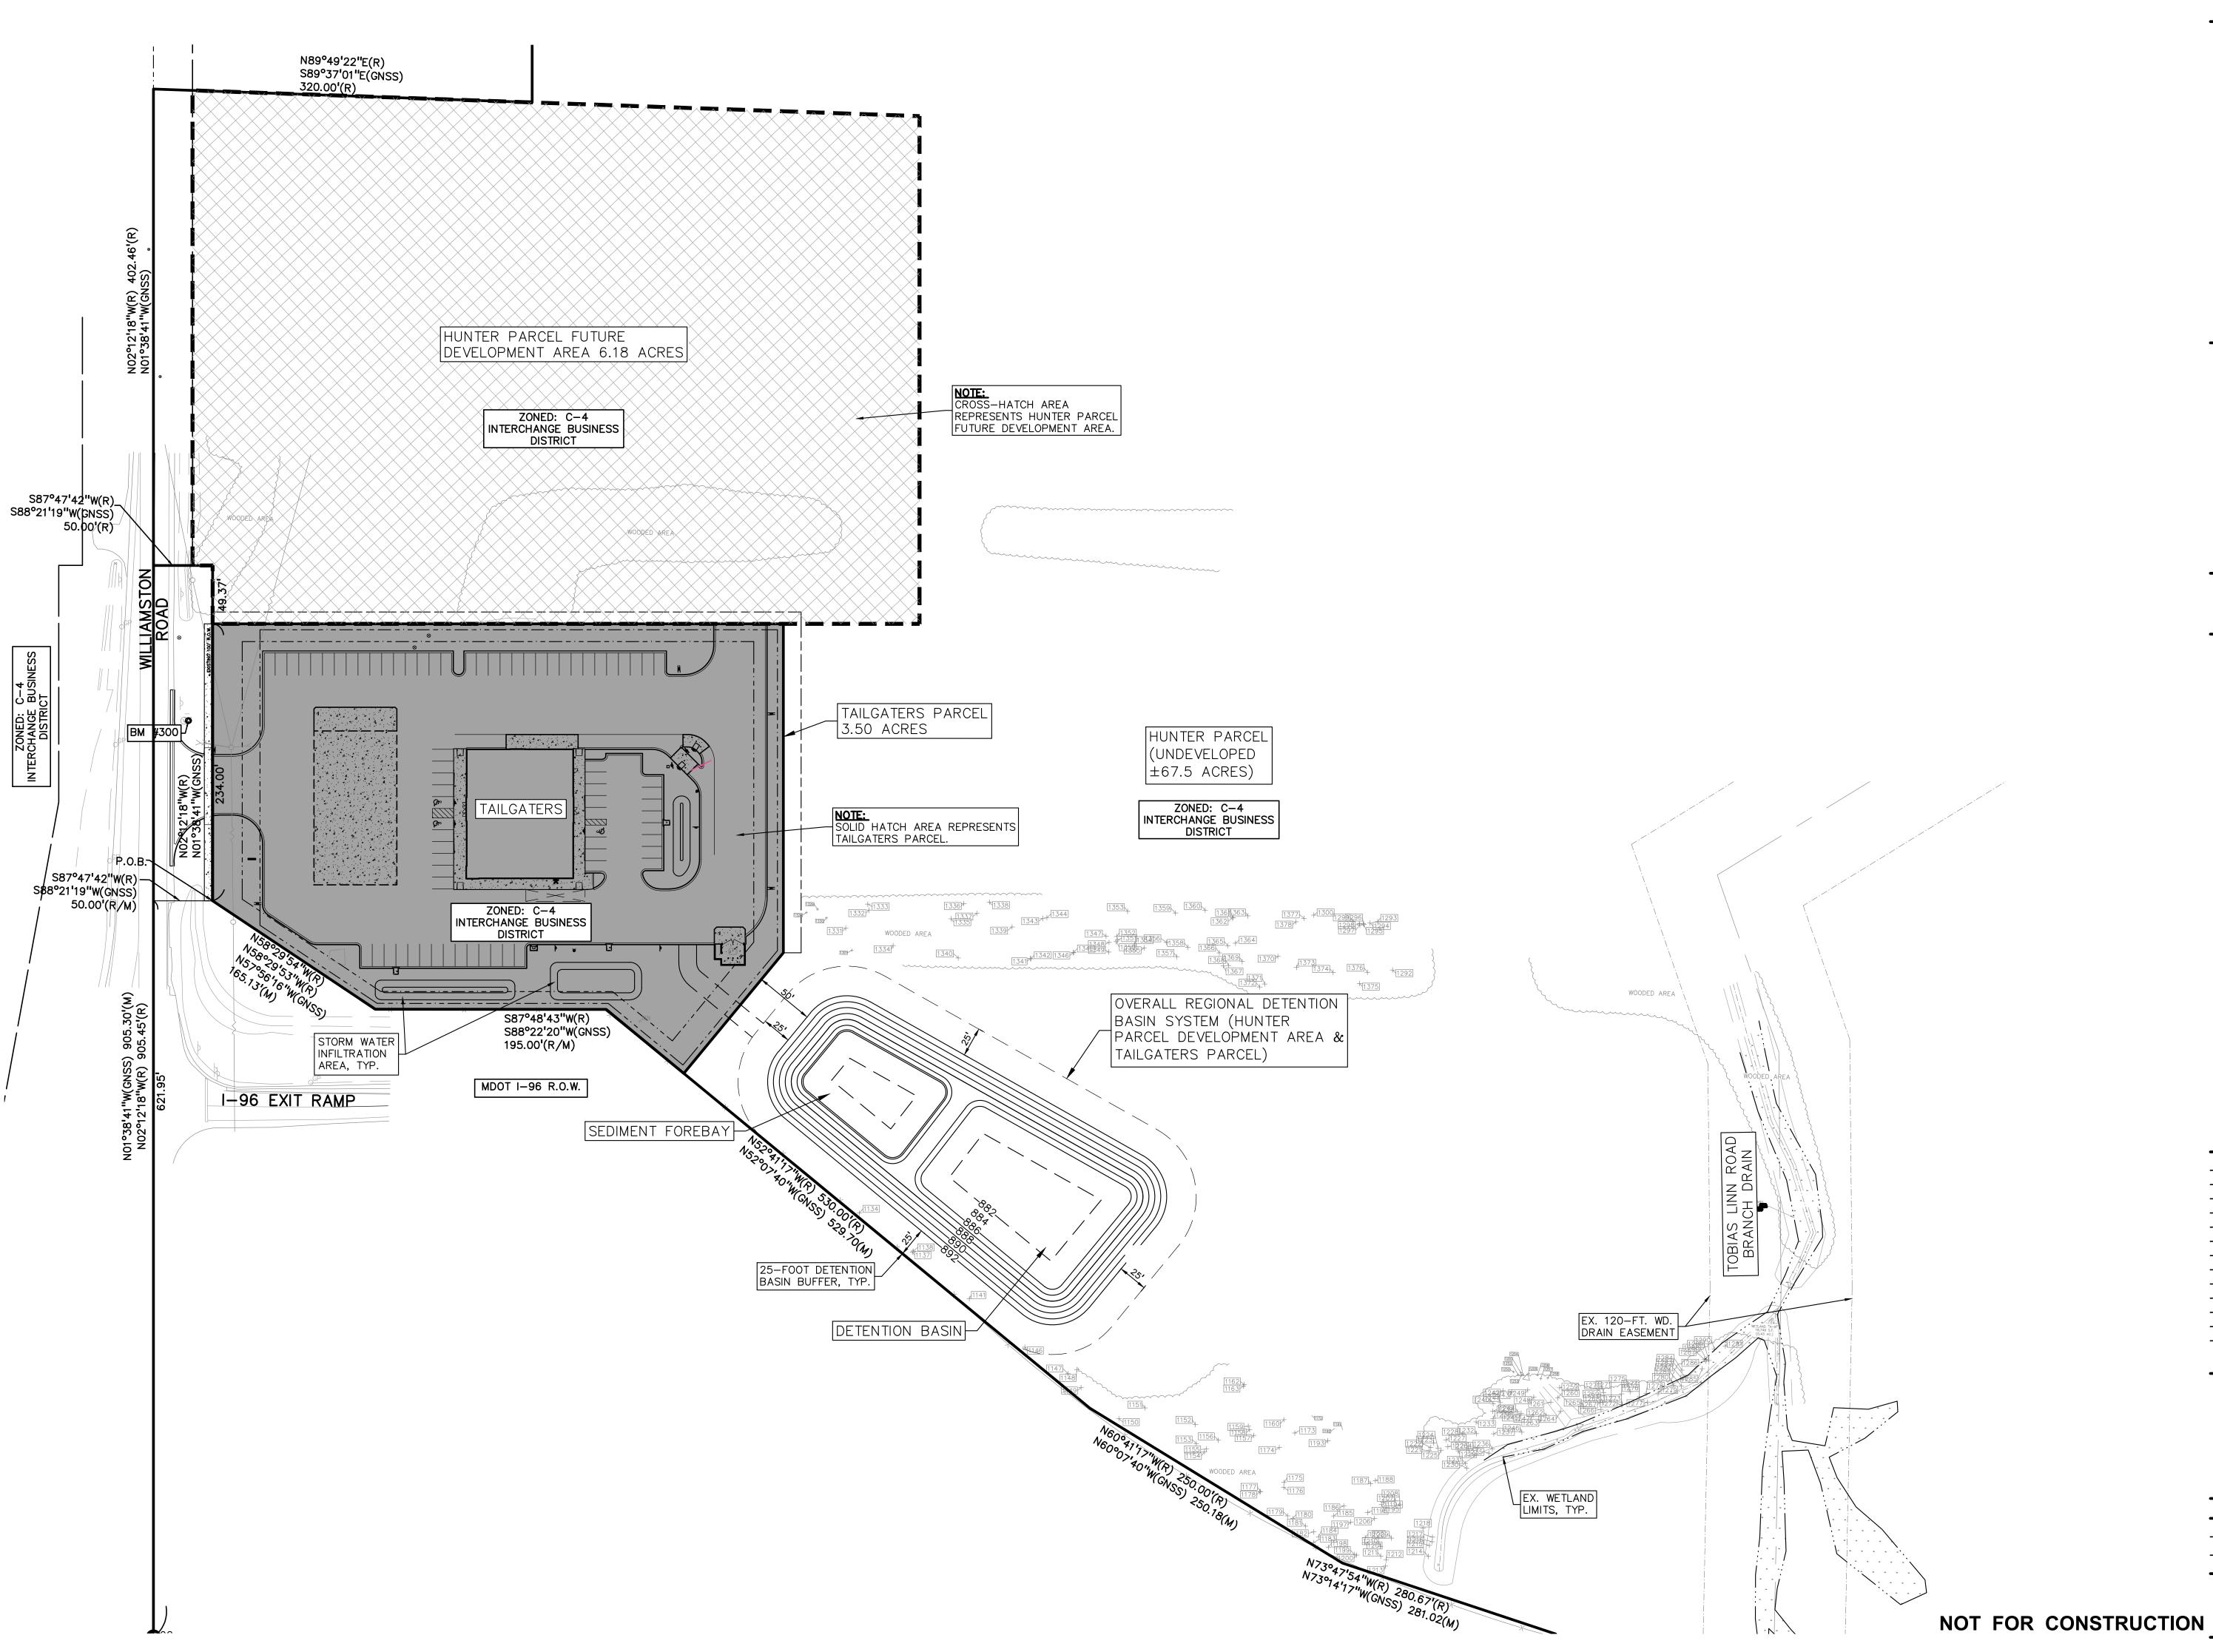

PEA GROUP t: 844.813.2949 www.peagroup.com

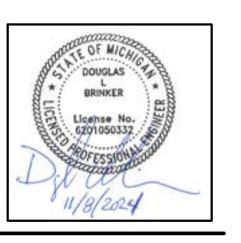



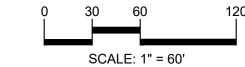



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CLIENT

TG PROPERTIES WILLIAMSTON LLC 3450 OKEMOS ROAD OKEMOS, MI 48864

PROJECT TITLE

TAILGATERS
WILLIAMSTON ROAD & I-96
VILLAGE OF WILLIAMSTON, INGHAM COUNTY, MI


REVISIONS


ORIGINAL ISSUE DATE: NOVEMBER 8, 2024

OVERALL SITE
PLAN

	PEA JOB NO.	2024-1335
·	P.M.	BW
	DN.	HZ
	DES.	DB
,	DRAWING NUMBER:	

C-3.0

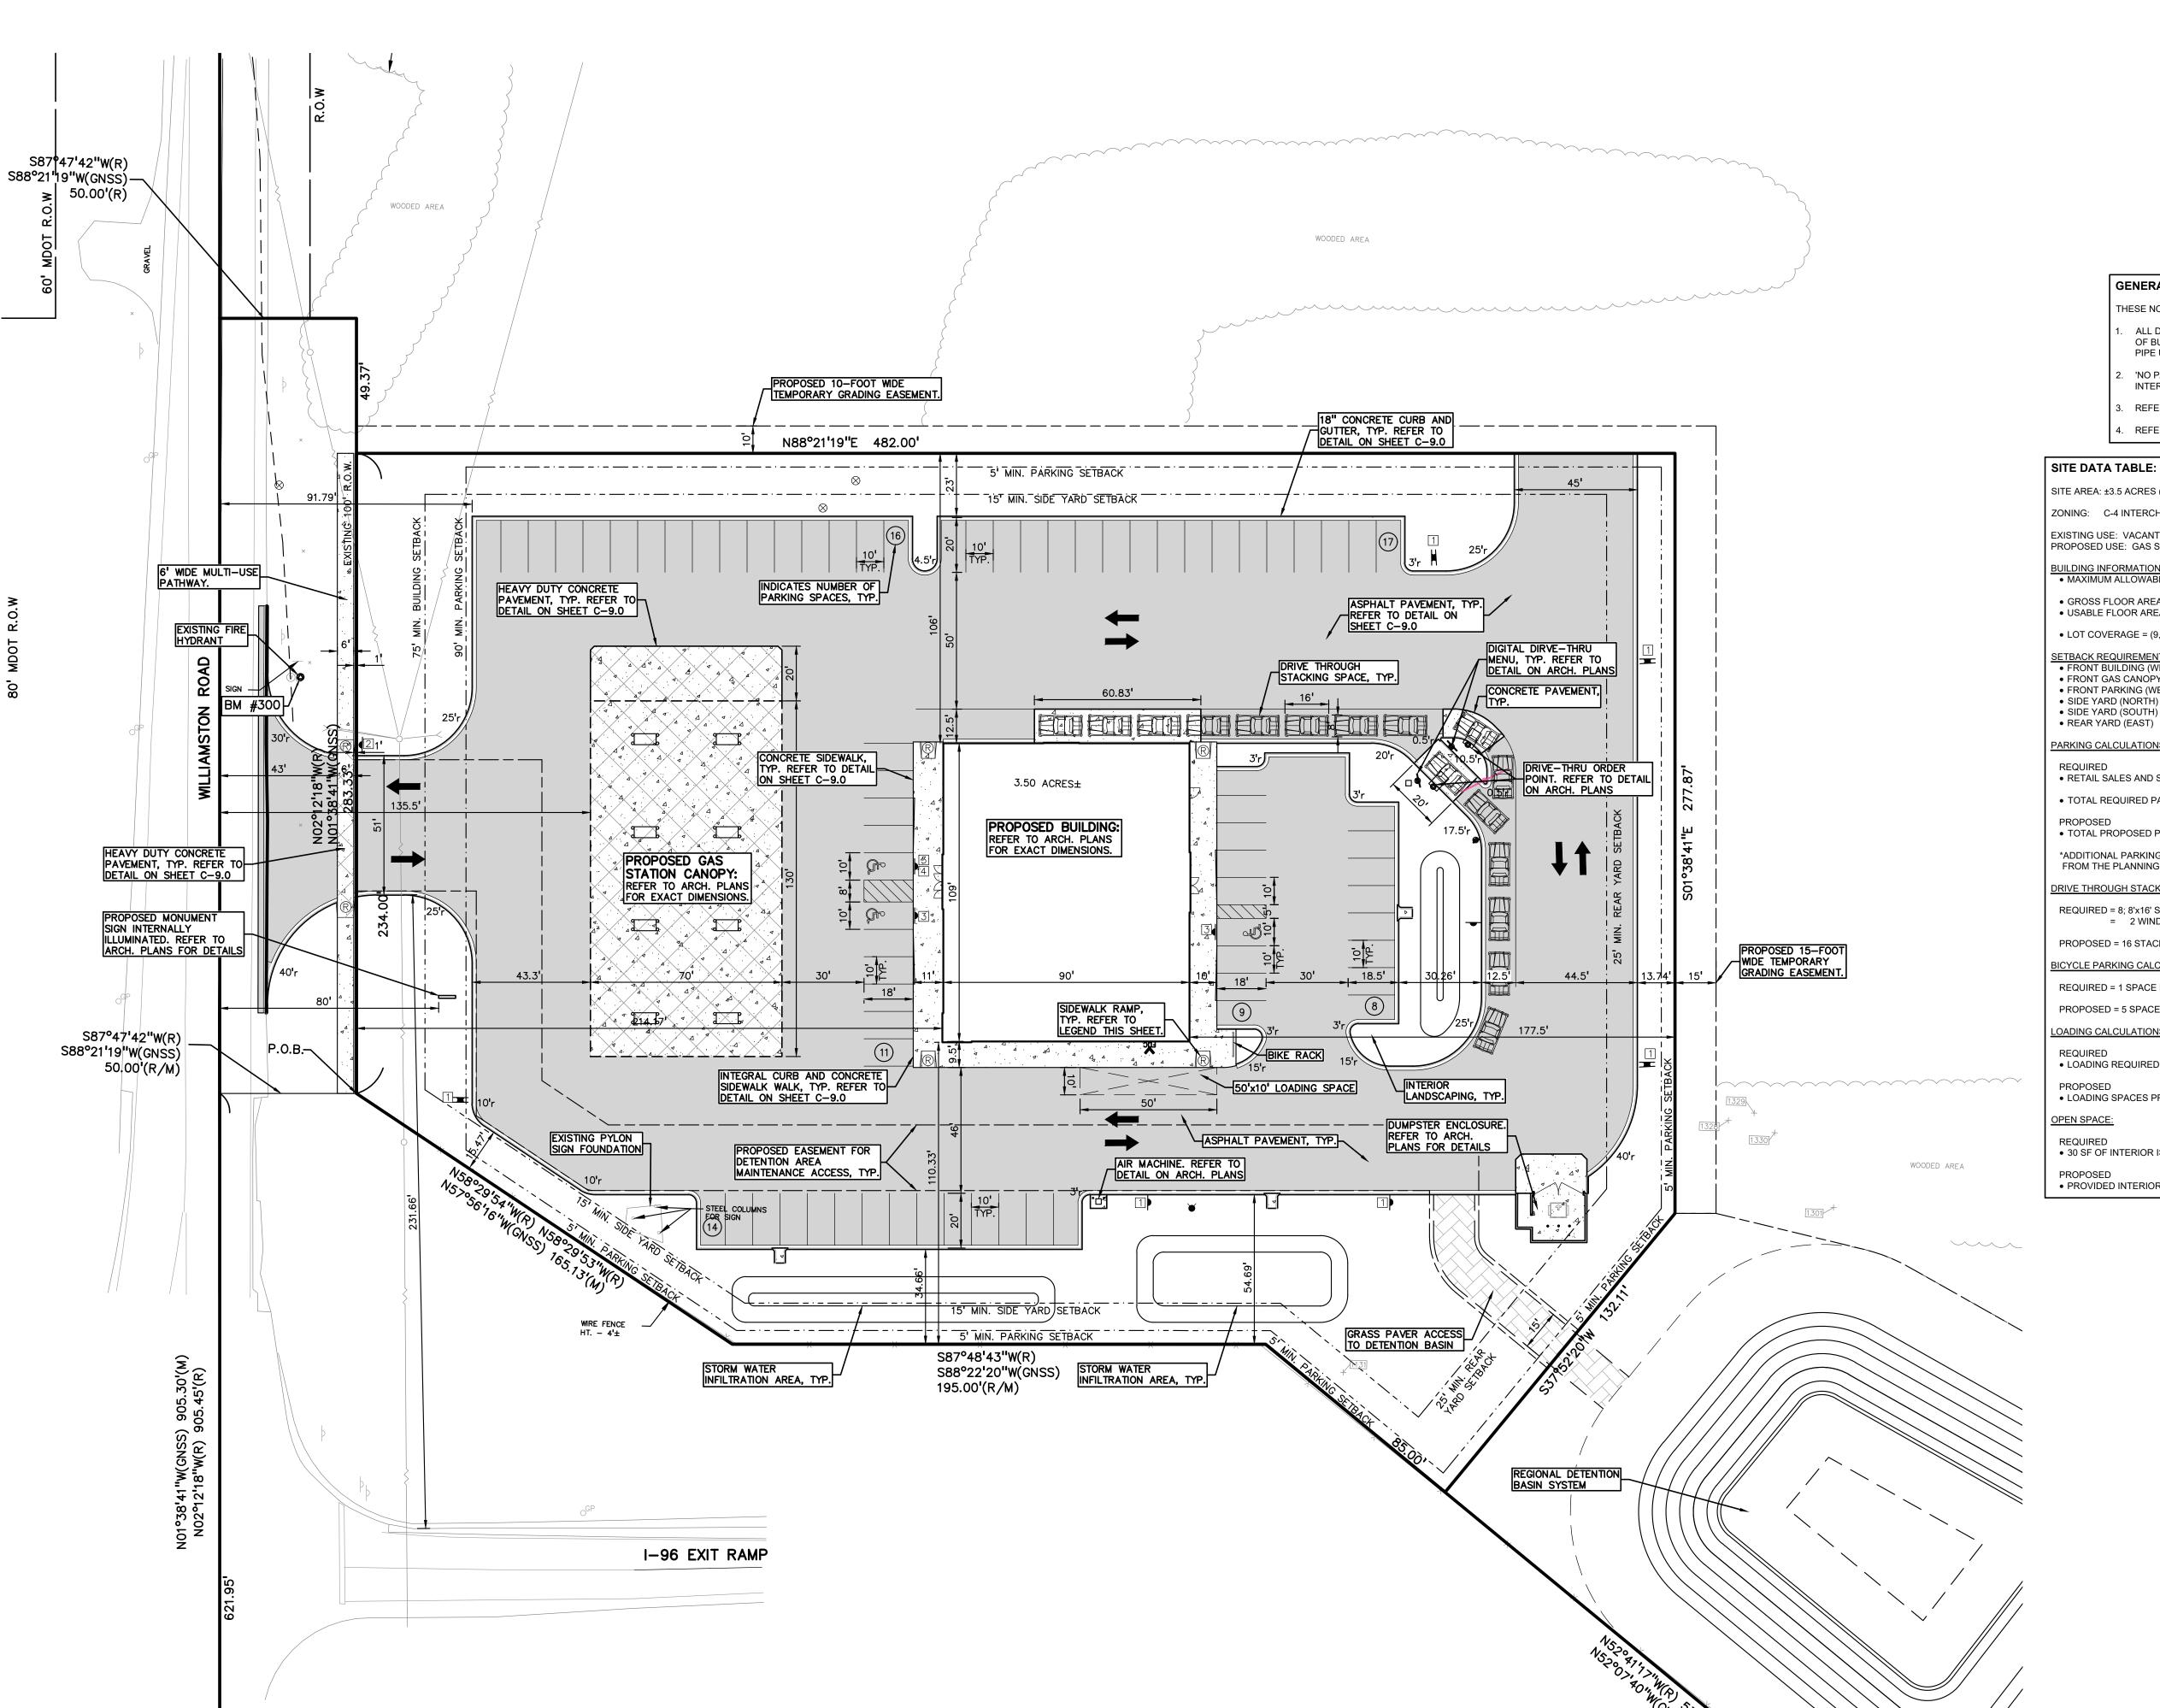

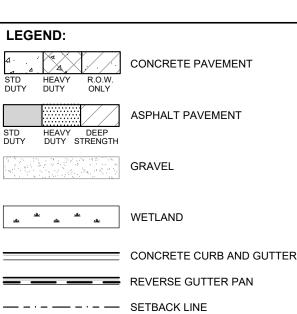

LIGHTPOLE

——X——— FENCE

GUARD RAIL

t: 844.813.2949 www.peagroup.com

SCALE: 1" = 30'

THE LOCATIONS AND ELEVATIONS OF EXISTING UNI JTILITIES AS SHOWN ON THIS DRAWING ARE ONLY

APPROXIMATE. NO GUARANTEE IS EITHER EXPRESSED OR IMPLIED AS TO THE COMPLETENESS OR ACCURACY THEREO THE CONTRACTOR SHALL BE EXCLUSIVELY RESPONSIBLE FOR DETERMINING THE EXACT UTILITY LOCATIONS AND ELEVATIONS PRIOR TO THE START OF CONSTRUCTION.

CAUTION!!

CLIENT

TG PROPERTIES

3450 OKEMOS ROAD

PROJECT TITLE

REVISIONS

TAILGATERS

WILLIAMSTON ROAD & I-96 VILLAGE OF WILLIAMSTON, INGHAM COUNTY, MI

WILLIAMSTON LLC

GENERAL NOTES:

THESE NOTES APPLY TO ALL CONSTRUCTION ACTIVITIES ON THIS PROJECT.

- ALL DIMENSIONS SHOWN ARE TO BACK OF CURB, FACE OF SIDEWALK, OUTSIDE FACE OF BUILDING, PROPERTY LINE, CENTER OF MANHOLE/CATCH BASIN OR CENTERLINE OF
- 'NO PARKING-FIRE LANE' SIGNS SHALL BE POSTED ALONG ALL FIRE LANES AT 100 FOOT INTERVALS OR AS DIRECTED BY THE FIRE OFFICIAL.
- REFER TO NOTES & DETAILS SHEET FOR ON-SITE PAVING DETAILS.
- REFER TO NOTES & DETAILS SHEET FOR ON-SITE SIDEWALK RAMP DETAILS

SITE AREA: ±3.5 ACRES (152,714 SF)

ZONING: C-4 INTERCHANGE BUSINESS DISTRICT WITH WILLIAMSTON ROAD OVERLAY DISTRICT

PROPOSED USE: GAS STATION, RETAIL SALES, AND DRIVE-THRU RESTAURANT (9,833 SF)

BUILDING INFORMATION: • MAXIMUM ALLOWABLE BUILDING HEIGHT = 30 FT. (19-FT. PROPOSED)

PIPE UNLESS OTHERWISE NOTED.

- GROSS FLOOR AREA = 9,833 SF. • USABLE FLOOR AREA = 7,866 SF.
- LOT COVERAGE = (9,833 / 152,714) = 6.4%

,	,	
SETBACK REQUIREMENTS:	REQUIRED:	PROPOSED:
FRONT BUILDING (WEST)	75'	214.17'
 FRONT GAS CANOPY (WEST) 	75'	135.5'
 FRONT PARKING (WEST) 	90'	91.79'
SIDE YARD (NORTH)	15'	106.0'
SIDE YARD (SOUTH)	15'	110.33'
 REAR YARD (EAST) 	25'	177.5'

PARKING CALCULATIONS:

• RETAIL SALES AND SERVICE ESTABLISHMENT = 1 SPACE PER 350 SF.

• TOTAL REQUIRED PARKING = 9,833 SF/350 SF = 29 SPACES

• TOTAL PROPOSED PARKING SPACES = 75 SPACES INC. 3 H/C SPACES

*ADDITIONAL PARKING IN EXCESS OF 200% OF THE MINIMUM REQUIRED SHALL REQUIRE APPROVAL FROM THE PLANNING COMMISSION PER SECTION 74-6.202.

DRIVE THROUGH STACKING SPACE CALCULATIONS:

REQUIRED = 8; 8'x16' STACKING SPACES REQUIRED PER RESTAURANT SERVICE WINDOW = 2 WINDOWS x 8 SPACES/WINDOW = 16 SPACES REQUIRED

PROPOSED = 16 STACKING SPACES

BICYCLE PARKING CALCULATIONS:

REQUIRED = 1 SPACE PER 10 REQUIRED VEHICLE PARKING SPACES = 29/10 = 3 SPACE REQUIRED PROPOSED = 5 SPACES

LOADING CALCULATIONS:

REQUIRED

• LOADING REQUIRED = 1 SPACE REQUIRED FOR BUILDINGS UP TO 20,000 SF

PROPOSED • LOADING SPACES PROVIDED = 1

OPEN SPACE:

REQUIRED


• 30 SF OF INTERIOR ISLAND LANDSCAPING REQUIRED PER PARKING SPACE = 75 SPACES X 30 = 2250 SF

PROPOSED • PROVIDED INTERIOR ISLAND LANDSCAPING = 4,900 SF

SIGN LEGEND:

'NO PARKING FIRE LANE' SIGN 'STOP' SIGN 'BARRIER FREE PARKING' SIGN 'VAN ACCESSIBLE' SIGN

REFER TO DETAIL SHEET FOR SIGN DETAILS

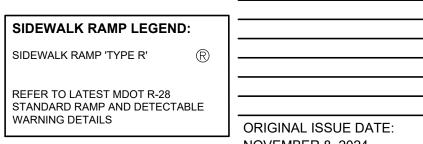



NOVEMBER 8, 2024 DRAWING TITLE

PRELIMINARY SITE PLAN


·	PEA JOB NO.	2024-1335
·	P.M.	BW
	DN.	HZ
	DES.	DB

DRAWING NUMBER:

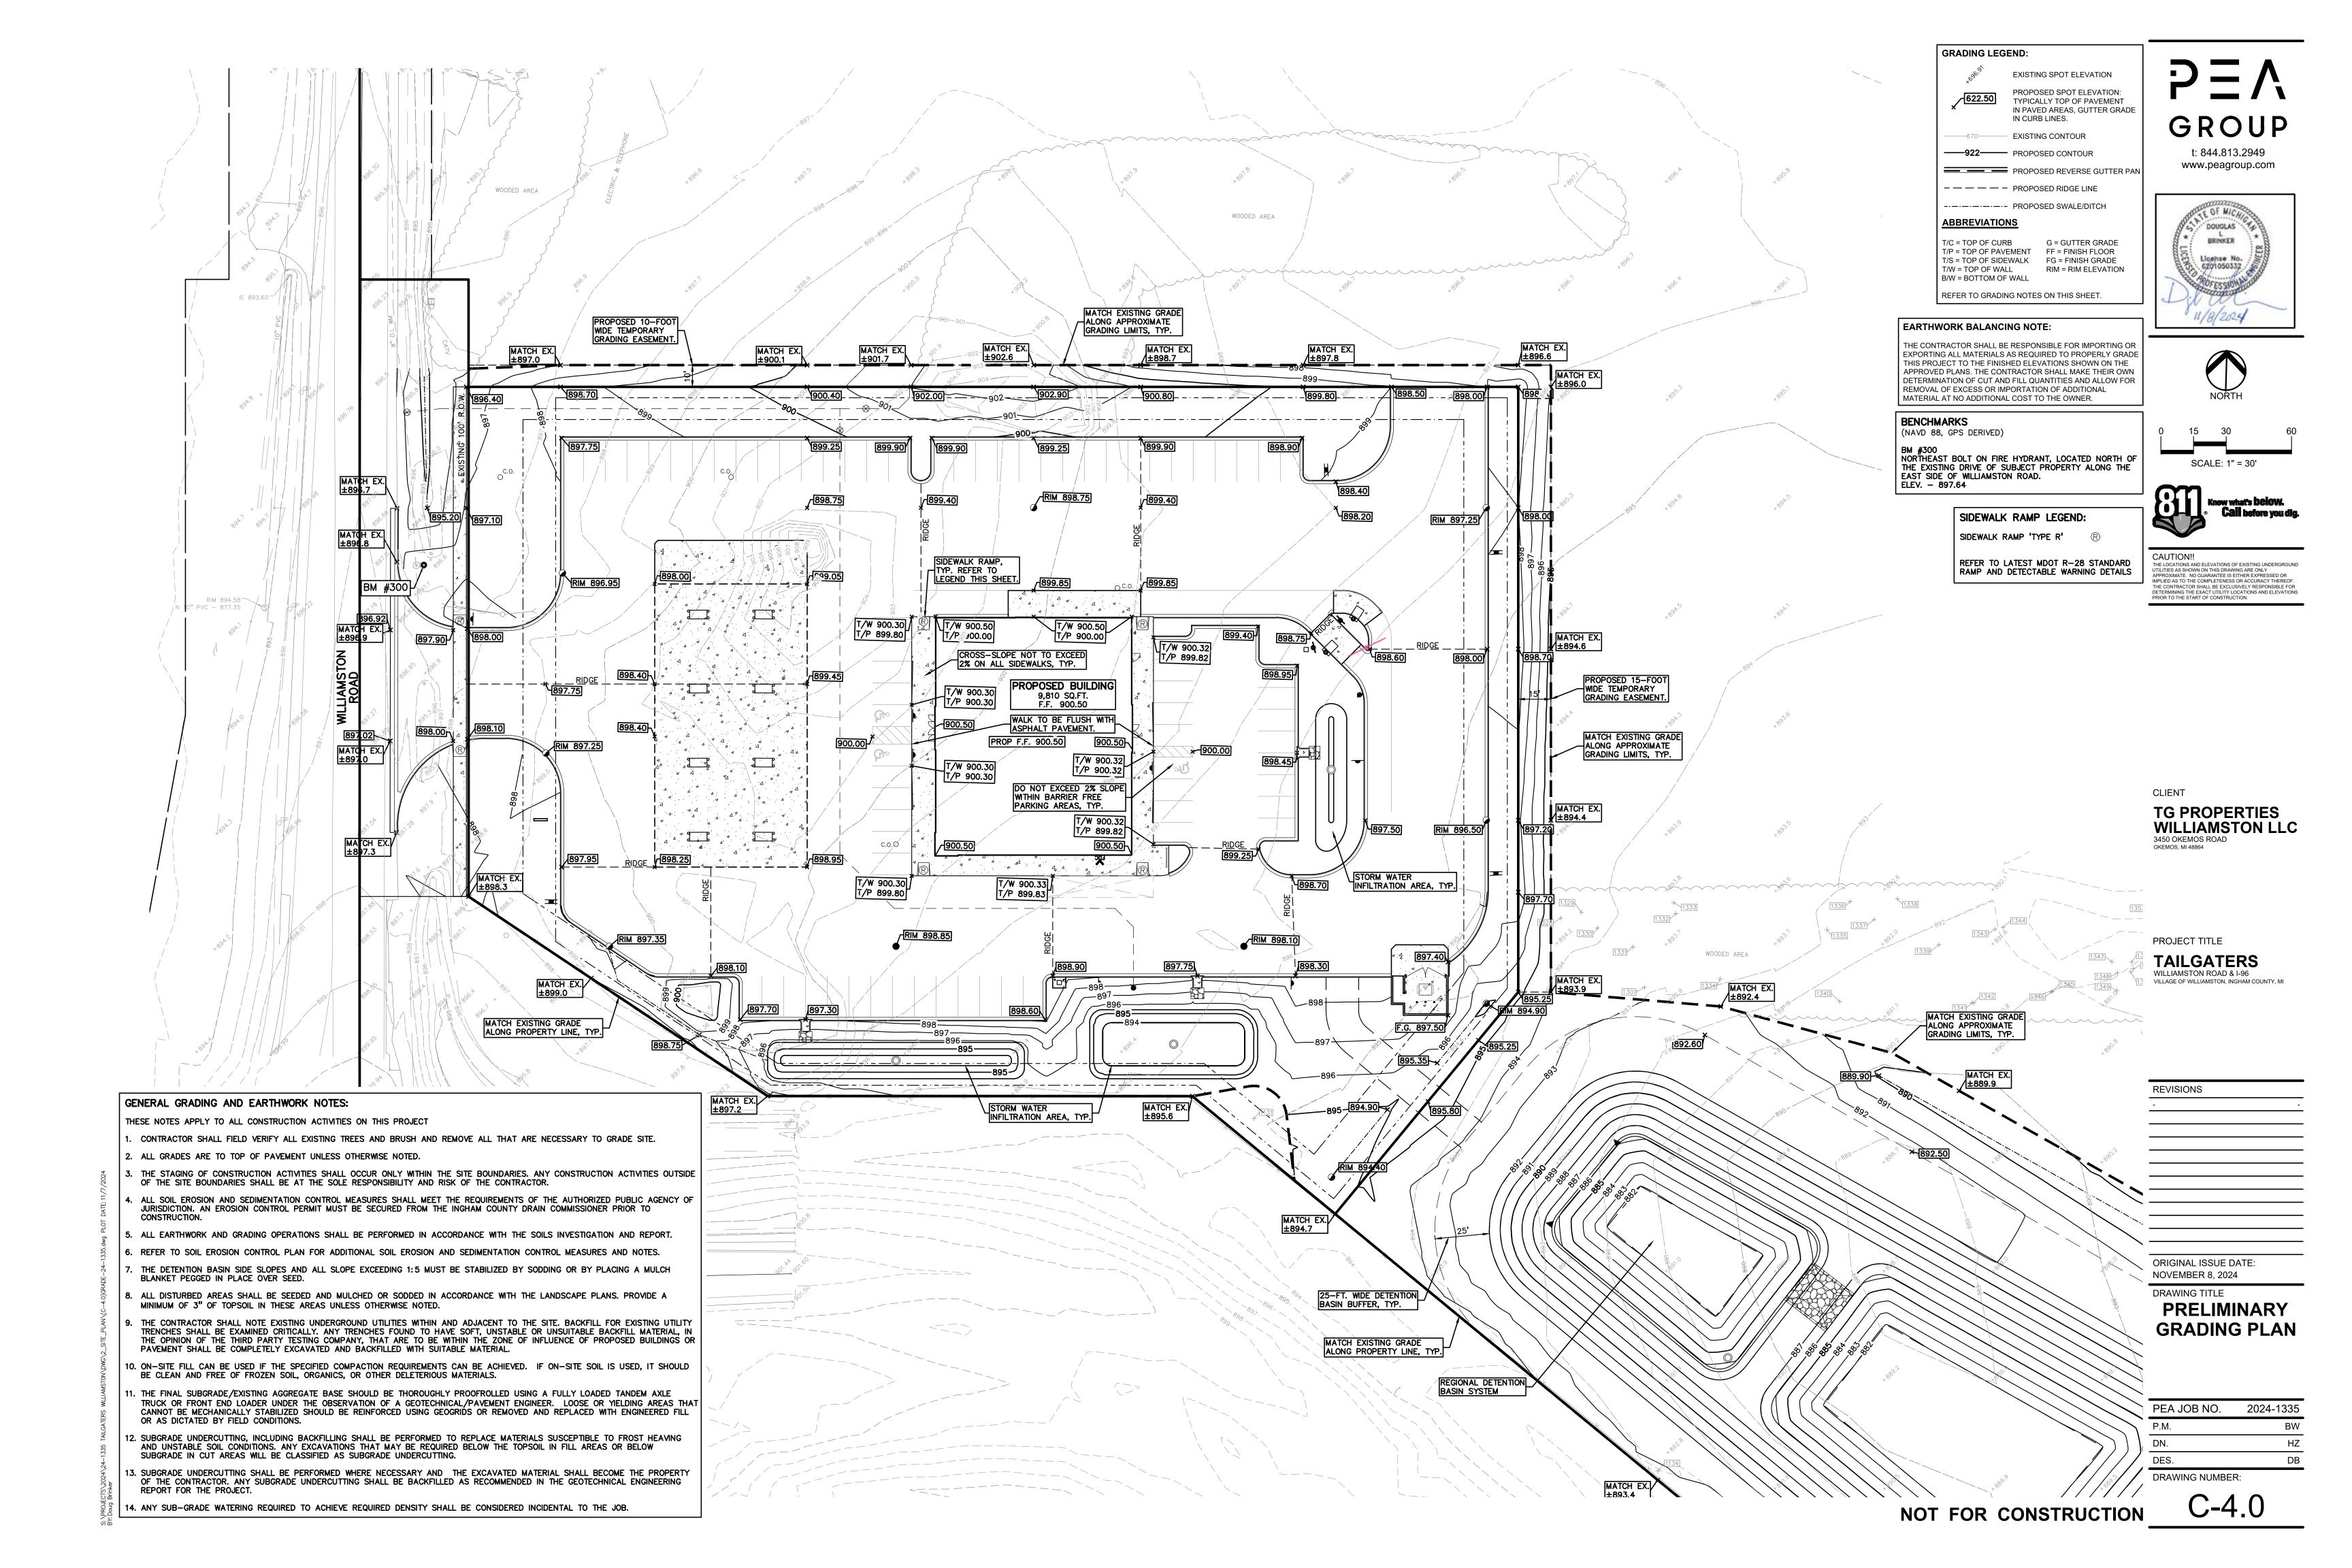


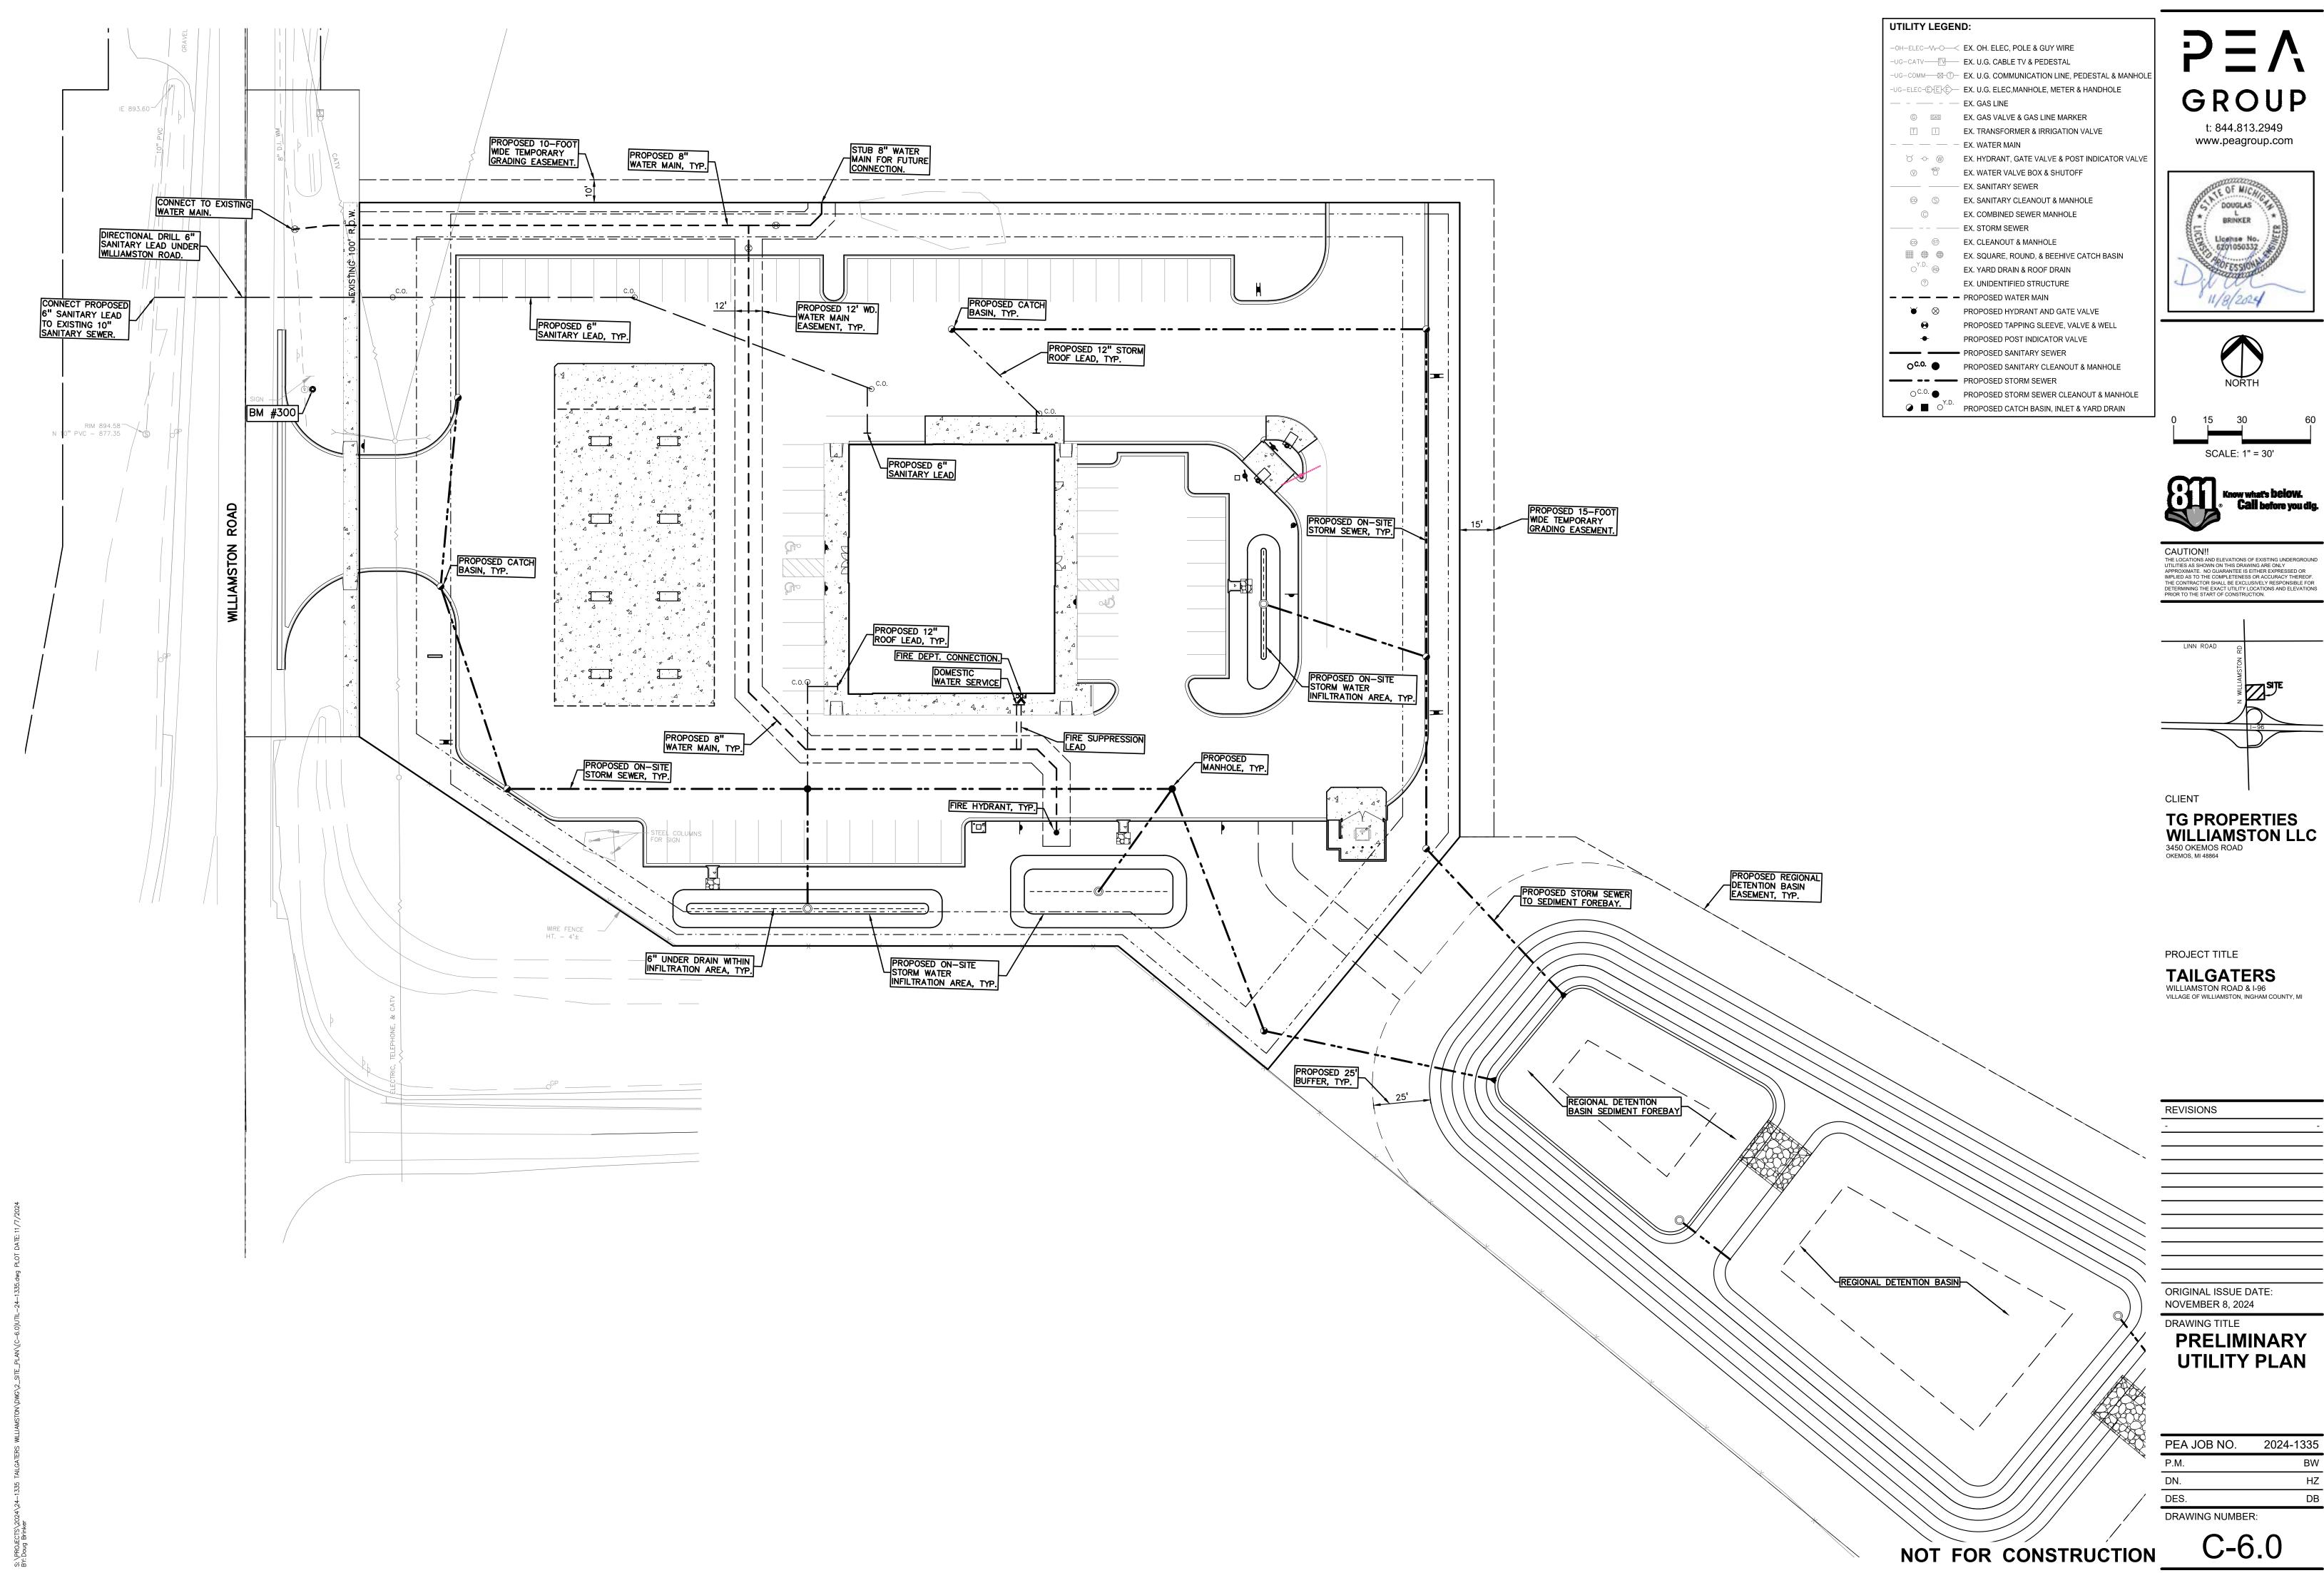

THE LOCATIONS AND ELEVATIONS OF EXISTING UNDERGROUND UTILITIES AS SHOWN ON THIS DRAWING ARE ONLY APPROXIMATE. NO GUARANTEE IS EITHER EXPRESSED OR IMPLIED AS TO THE COMPLETENESS OR ACCURACY THEREOF. THE CONTRACTOR SHALL BE EXCLUSIVELY RESPONSIBLE FOR DETERMINION THE EXACT UTILITY LOCATIONS AND ELEVATIONS PRIOR TO THE START OF CONSTRUCTION.

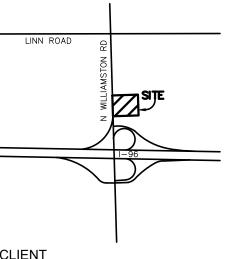

PEA JOB NO. 2024-1335

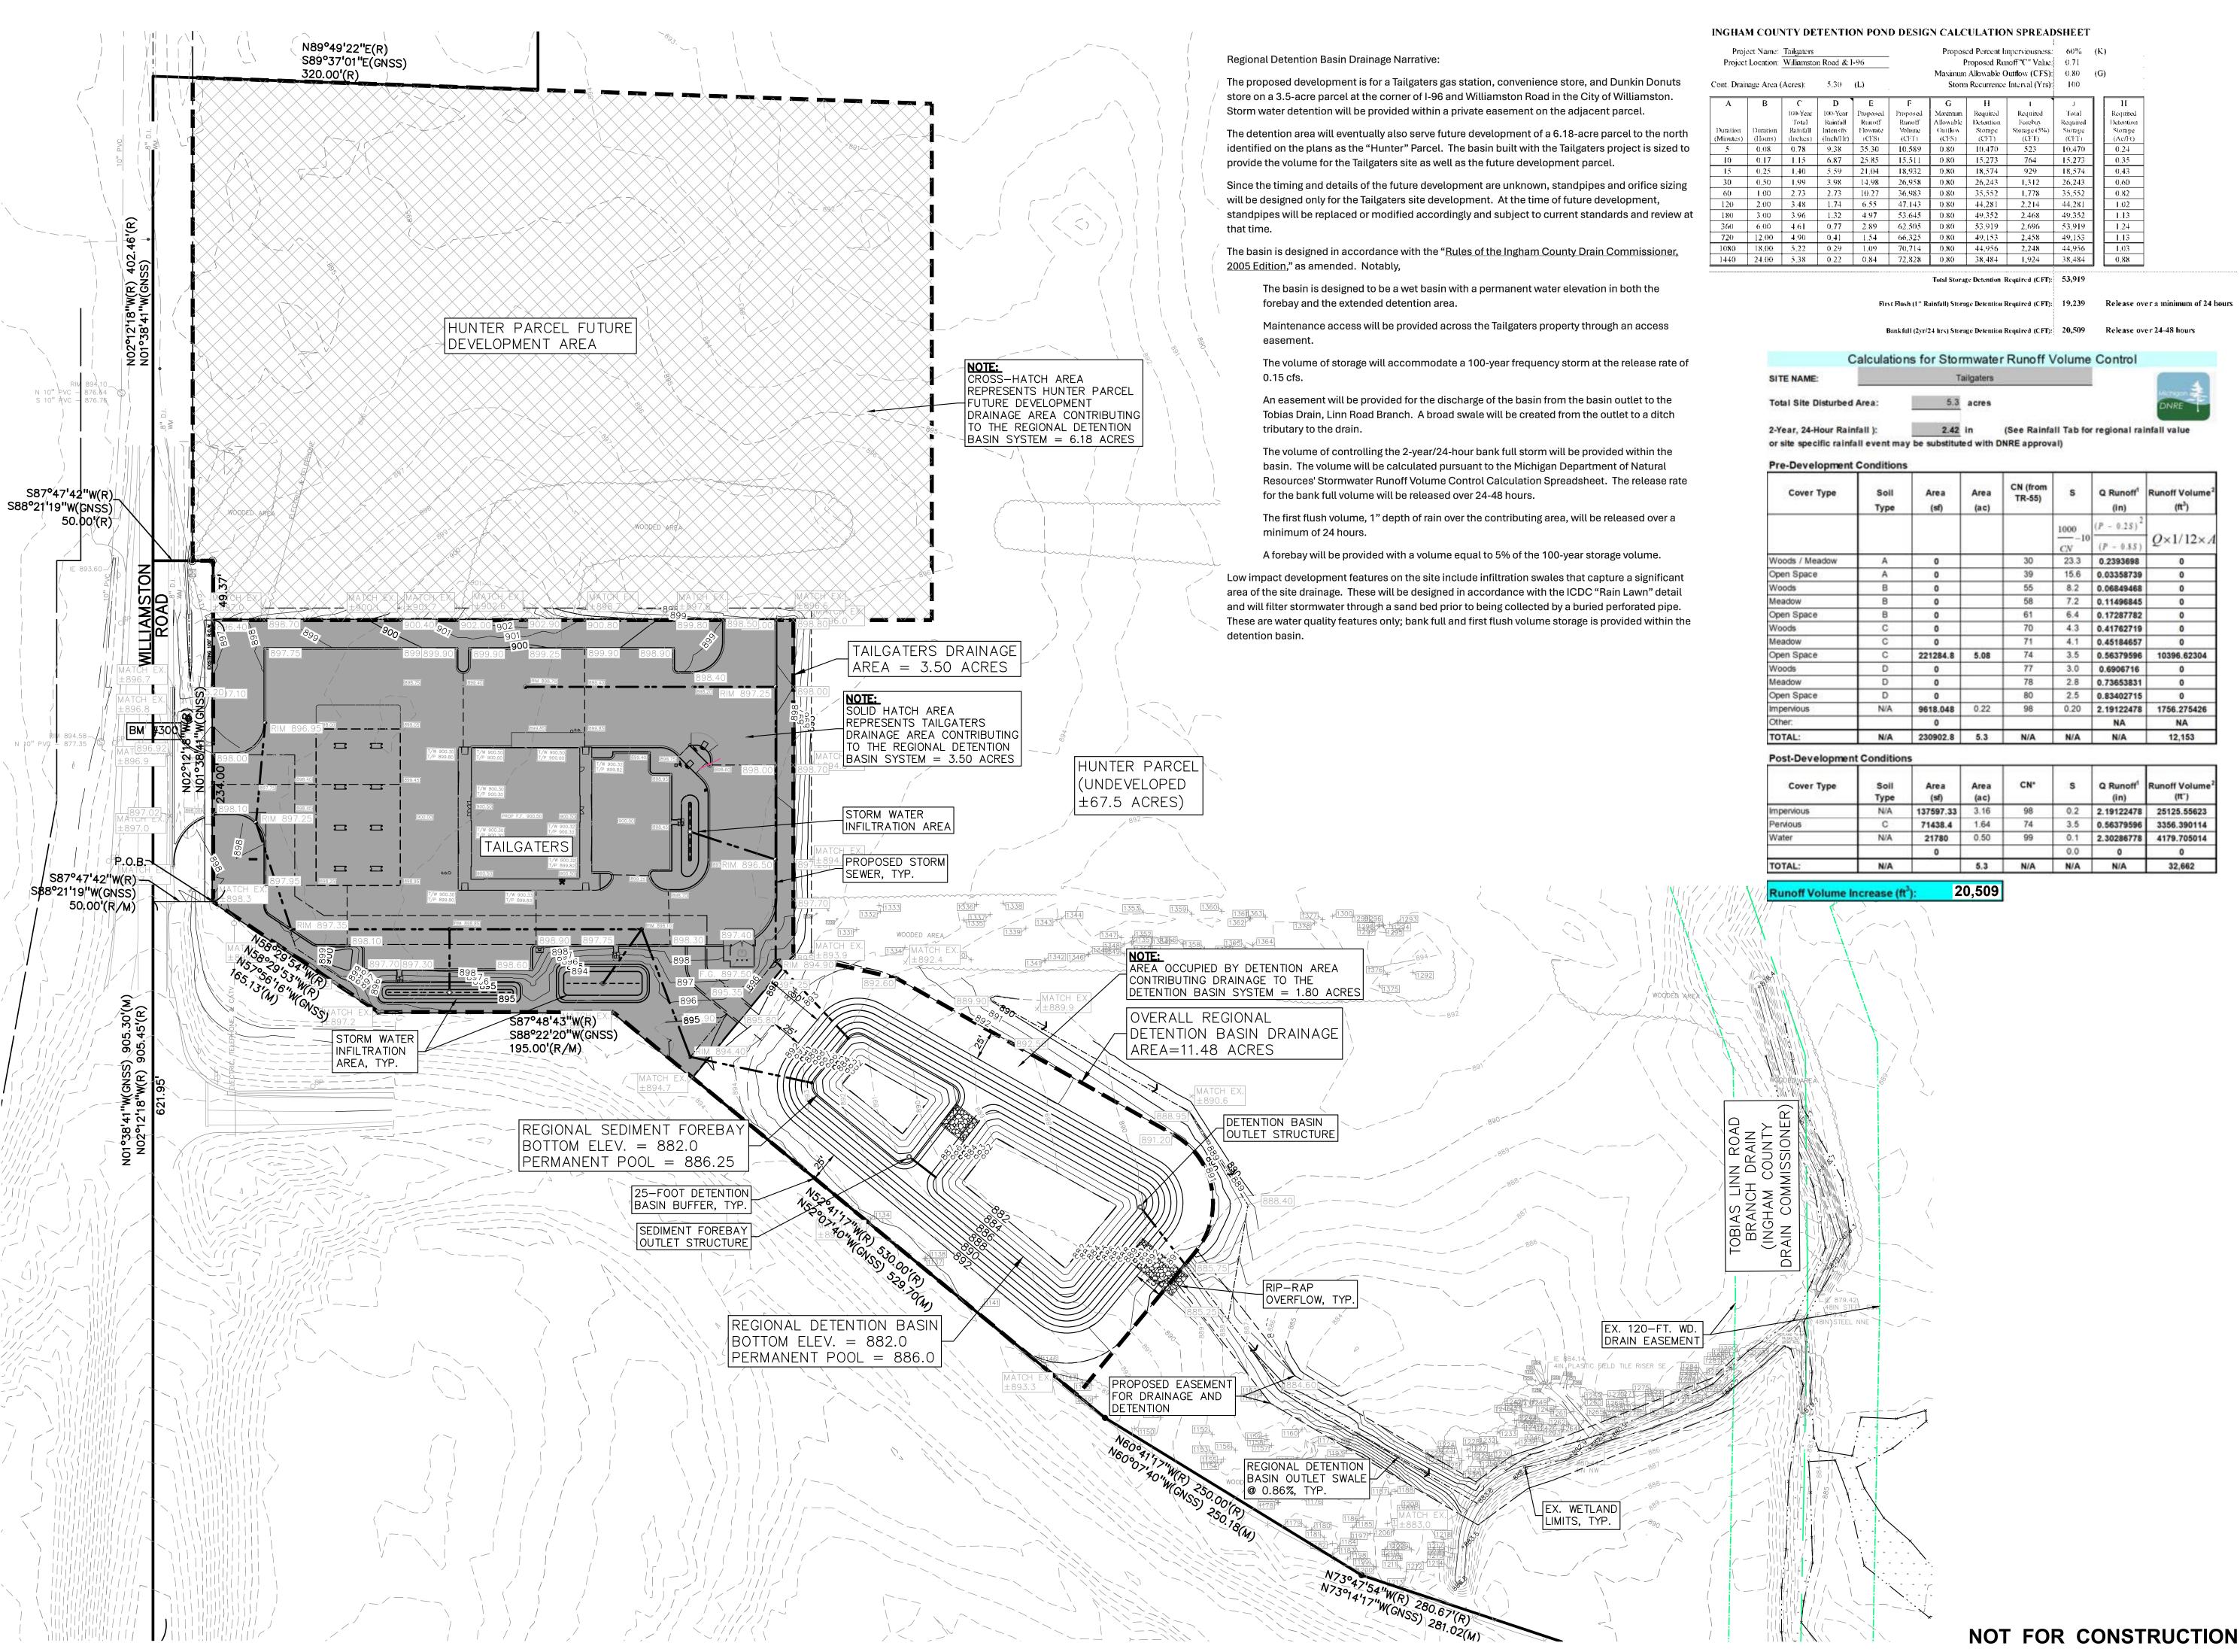

DOUGLAS BRINKER

t: 844.813.2949


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ost-Development Conditions							
Cover Type	Soil Type	Area (sf)	Area (ac)	CN*	s	Q Runoff ¹ (in)	Runoff Volume
npervious	N/A	137597.33	3.16	98	0.2	2.19122478	25125.55623
Pervious	С	71438.4	1.64	74	3.5	0.56379596	3356.390114
Vater	N/A	21780	0.50	99	0.1	2.30286778	4179.705014
		0			0.0	0	0
OTAL:	N/A		5.3	N/A	N/A	N/A	32,662

SCALE: 1" = 60'



CAUTION!! I'HE LOCATIONS AND ELEVATIONS OF EXISTING UNDERGRO JTILITIES AS SHOWN ON THIS DRAWING ARE ONLY APPROXIMATE. NO GUARANTEE IS EITHER EXPRESSED OR IMPLIED AS TO THE COMPLETENESS OR ACCURACY THEREOF IE CONTRACTOR SHALL BE EXCLUSIVELY RESPONSIBLE FOR DETERMINING THE EXACT UTILITY LOCATIONS AND ELEVATIONS PRIOR TO THE START OF CONSTRUCTION.

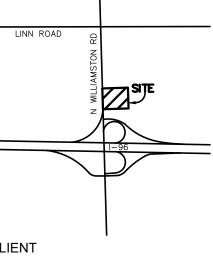

TG PROPERTIES WILLIAMSTON LLC 3450 OKEMOS ROAD

PROJECT TITLE

TAILGATERS WILLIAMSTON ROAD & I-96
VILLAGE OF WILLIAMSTON, INGHAM COUNTY, MI

ORIGINAL ISSUE DATE: NOVEMBER 8, 2024 DRAWING TITLE

REGIONAL DETENTION BASIN DRAINAGE MAP

PEA JOB NO. 2024-1335 DRAWING NUMBER:

GENERAL NOTES:


THESE NOTES APPLY TO ALL CONSTRUCTION ACTIVITIES ON THIS PROJECT.

- ALL CONSTRUCTION, WORKMANSHIP AND MATERIALS SHALL BE IN ACCORDANCE WITH CURRENT OSHA, MDOT AND MUNICIPALITY STANDARDS AND REGULATIONS.
- THE CONTRACTOR SHALL NOTIFY THE CITY ENGINEER AND/OR THE AUTHORITY HAVING JURISDICTION 3 BUSINESS DAYS PRIOR TO THE BEGINNING OF CONSTRUCTION.
- THE CONTRACTOR SHALL CONTACT THE ENGINEER SHOULD THEY ENCOUNTER ANY DESIGN ISSUES DURING CONSTRUCTION. IF THE CONTRACTOR MAKES DESIGN MODIFICATIONS WITHOUT THE WRITTEN DIRECTION OF THE DESIGN ENGINEER, THE CONTRACTOR DOES SO
- ALL NECESSARY PERMITS, TESTING, BONDS AND INSURANCES ETC., SHALL BE PAID FOR BY THE CONTRACTOR. THE OWNER SHALL PAY FOR ALL CITY INSPECTION FEES.
- THE CONTRACTOR SHALL NOTIFY THE APPROPRIATE 811/ONE CALL UTILITY LOCATING CENTER, THE CITY ENGINEER AND/OR THE AUTHORITY HAVING JURISDICTION 3 BUSINESS DAYS PRIOR TO THE BEGINNING OF CONSTRUCTION. IF NO NOTIFICATION IS GIVEN AND DAMAGE RESULTS, SAID DAMAGE WILL BE REPAIRED AT SOLE EXPENSE OF THE CONTRACTOR. IF EXISTING UTILITY LINES ARE ENCOUNTERED THAT CONFLICT IN LOCATION WITH NEW CONSTRUCTION, THE CONTRACTOR SHALL NOTIFY THE DESIGN ENGINEER SO
- CONTRACTOR SHALL VERIFY THAT THE PLANS AND SPECIFICATIONS ARE THE VERY LATEST PLANS AND SPECIFICATIONS AND FURTHERMORE, VERIFY THAT THESE PLANS AND SPECIFICATIONS HAVE BEEN APPROVED. ALL ITEMS CONSTRUCTED BY THE CONTRACTOR PRIOR TO RECEIVING FINAL APPROVAL, HAVING TO BE ADJUSTED OR RE-DONE, SHALL BE AT THE CONTRACTORS EXPENSE. SHOULD THE CONTRACTOR ENCOUNTER A CONFLICT BETWEEN THESE PLANS AND/OR SPECIFICATIONS, THEY SHALL SEEK CLARIFICATION IN WRITING FROM THE ENGINEER BEFORE COMMENCEMENT OF CONSTRUCTION. FAILURE TO DO SO SHALL BE AT SOLE
- ANY WORK WITHIN THE STREET OR HIGHWAY RIGHTS-OF-WAY SHALL BE PERFORMED IN ACCORDANCE WITH THE REQUIREMENTS OF THE AGENCIES HAVING JURISDICTION AND SHALL NOT BEGIN UNTIL ALL NECESSARY PERMITS HAVE BEEN ISSUED FOR THE WORK.
- ALL PROPERTIES OR FACILITIES IN THE SURROUNDING AREAS, PUBLIC OR PRIVATE, DESTROYED OR OTHERWISE DISTURBED DUE TO CONSTRUCTION, SHALL BE REPLACED AND/OR RESTORED TO THE ORIGINAL CONDITION BY THE CONTRACTOR.
- THE CONTRACTOR SHALL PROVIDE ALL NECESSARY BARRICADING, SIGNAGE, LIGHTS AND TRAFFIC CONTROL DEVICES TO PROTECT THE WORK AND SAFELY MAINTAIN TRAFFIC IN ACCORDANCE WITH LOCAL REQUIREMENTS AND THE MANUAL OF UNIFORM TRAFFIC CONTROL DEVICES (LATEST EDITION). THE DESIGN ENGINEER, OWNER, CITY, AND STATE SHALL NOT BE HELD LIABLE FOR ANY CLAIMS RESULTING FROM ACCIDENTS OR DAMAGES CAUSED BY THE CONTRACTOR'S FAILURE TO COMPLY WITH TRAFFIC AND PUBLIC SAFETY REGULATIONS DURING THE CONSTRUCTION PERIOD.
- O. THE USE OF CRUSHED CONCRETE IS PROHIBITED ON THE PROJECT WITHIN 100 FEET OF ANY WATER COURSE (STREAM, RIVER, COUNTY DRAIN, ETC.) AND LAKE, REGARDLESS OF THE APPLICATION OR LOCATION OF THE WATER COURSE OR LAKE RELATIVE TO THE
- . IT SHALL BE THE RESPONSIBILITY OF THE CONTRACTOR TO ADJUST THE TOP OF ALL EXISTING AND PROPOSED STRUCTURES (MANHOLES, CATCH BASINS, INLETS, GATE WELLS ETC.) WITHIN GRADED AND /OR PAVED AREAS TO FINAL GRADE SHOWN ON THE PLANS. ALL SUCH ADJUSTMENTS SHALL BE INCIDENTAL TO THE JOB AND WILL NOT BE PAID FOR SEPARATELY.

- IN AREAS WHERE NEW PAVEMENTS ARE BEING CONSTRUCTED, THE TOPSOIL AND SOIL CONTAINING ORGANIC MATTER SHALL BE REMOVED PRIOR TO PAVEMENT CONSTRUCTION.
- REFER TO ARCHITECTURAL PLANS FOR DETAILS OF FROST SLAB AT EXTERIOR BUILDING DOORS.
- CONSTRUCTION TRAFFIC SHOULD BE MINIMIZED ON THE NEW PAVEMENT. IF CONSTRUCTION TRAFFIC IS ANTICIPATED ON THE PAVEMENT STRUCTURE, THE INITIAL LIFT THICKNESS COULD BE INCREASED AND PLACEMENT OF THE FINAL LIFT COULD BE DELAYED UNTIL THE MAJORITY OF THE CONSTRUCTION ACTIVITIES HAVE BEEN COMPLETED. THIS ACTION WILL ALLOW REPAIR OF LOCALIZED FAILURE, IF ANY DOES OCCUR, AS WELL AS REDUCE LOAD DAMAGE ON THE PAVEMENT SYSTEM.
- ALL EXPANSION JOINTS AND CONCRETE PAVEMENT JOINTS TO BE SEALED.
- CONCRETE PAVEMENT JOINTING UNLESS SHOWN OTHERWISE IN THE PLANS OR REQUIRED BY THE AUTHORITY HAVING JURISDICTION; 5.1. WHERE PROPOSED CONCRETE ABUTS A STRUCTURE, PROVIDE A MINIMUM 1/2" EXPANSION JOINT. THE JOINT FILLER BOARD MUST
- BE AT LEAST THE FULL DEPTH OF THE CONCRETE AND HELD DOWN A 1/2" TO ALLOW FOR SEALING. 5.2. WHERE PROPOSED CONCRETE ABUTS EXISTING CONCRETE OR IN BETWEEN POURS OF PROPOSED CONCRETE (CONSTRUCTION JOINT), PROVIDE 5/8" DOWELS EVERY 30" CENTER TO CENTER HALF WAY ALONG THE THICKNESS OF THE PROPOSED PAVEMENT. ALTERNATE DOWELS SIZES AND SPACING MUST BE APPROVED THE ENGINEER PRIOR TO COMMENCING WORK AND VIA THE
- WHERE PROPOSED CONCRETE ABUTS EXISTING OR PROPOSED SIDEWALK OR CURBING, PROVIDE A MINIMUM 1/2" EXPANSION JOINT. 5.4. CONTROL, LONGITUDINAL AND/OR TRANSVERSE JOINTS SHALL BE PLACED TO PROVIDE PANELS WITHIN THE PAVEMENT AS SQUARE AS POSSIBLE WITH THE FOLLOWING MAXIMUM SPACING PARAMETERS:
- 5.4.1. 6-INCH THICK CONCRETE PAVEMENT: 12' X 12' 5.4.2. 8-INCH THICK CONCRETE PAVEMENT: 15' X 15'
- 5.5. IRREGULAR—SHAPED PANELS MAY REQUIRE THE USE OF REINFORCING MESH OR FIBER MESH AS DETERMINED BY THE ENGINEER. THE USE OF MESH MUST BE APPROVED THE ENGINEER PRIOR TO COMMENCING WORK AND VIA THE SUBMITTAL PROCESS. 5.6. IF A JOINT PLAN IS NOT PROVIDED IN THE PLANS, THE CONTRACTOR SHALL SUBMIT ONE TO THE ENGINEER FOR REVIEW PRIOR TO COMMENCING WORK AND VIA THE SUBMITTAL PROCESS.
- CONCRETE CURBING JOINTING UNLESS SHOWN OTHERWISE IN THE PLANS OR REQUIRED BY THE AUTHORITY HAVING JURISDICTION 6.1. JOINTS WHEN ADJACENT TO ASPHALT PAVEMENT
- 6.1.1. PLACE CONTRACTION JOINTS AT 10' INTERVALS 6.1.2. PLACE 1/2" EXPANSION JOINT AT CATCH BASINS, EXISTING AND PROPOSED SIDEWALK OR EXISTING CURBING.
- 6.1.3. PLACE 1" EXPANSION JOINT: 6.1.3.1. AT SPRING POINTS OF INTERSECTIONS OR ONE OF THE END OF RADIUS LOCATIONS IN A CURVE
- 6.1.3.2. AT 400' MAXIMUM INTERVALS ON STRAIGHT RUNS 6.1.3.3. AT THE END OF RADIUS AT OPPOSITE ENDS IN A CURBED LANDSCAPE ISLAND
- 6.2. JOINTS WHEN TIED TO CONCRETE PAVEMENT 6.2.1. PLACE CONTRACTION JOINTS OPPOSITE ALL TRANSVERSE CONTRACTION JOINTS IN PAVEMENT
- 6.2.2. PLACE 1/2" EXPANSION JOINT AT CATCH BASINS, EXISTING AND PROPOSED SIDEWALK OR EXISTING CURBING. 6.2.3. PLACE 1" EXPANSION JOINT OPPOSITE ALL TRANSVERSE EXPANSION JOINTS IN PAVEMENT
- 6.2.4. CURB AND GUTTER AND CONCRETE SHALL BE TIED TOGETHER SIMILAR TO A LONGITUDINAL LANE TIE JOINT (MDOT B1 JOINT) 6.3. IN BETWEEN POURS OF PROPOSED CONCRETE CURBING (CONSTRUCTION JOINT):
- 6.3.1. CARRY THE REBAR CONTINUOUSLY BETWEEN POURS 6.3.2. IF THE REBAR IS NOT LONG ENOUGH TO CARRY CONTINUOUSLY, THEN TIE TWO PIECES OF REBAR PER THE LATEST MDOT **SPECIFICATIONS**
- CONCRETE SIDEWALK JOINTING UNLESS SHOWN OTHERWISE IN THE PLANS OR REQUIRED BY THE AUTHORITY HAVING JURISDICTION 7.1. PLACE TRANSVERSE CONTRACTION JOINTS EQUAL TO THE WIDTH OF THE WALK WHEN WIDTH IS LESS THAN 8'
- 7.2. PLACE TRANSVERSE AND LONGITUDINAL CONTRACTION JOINTS EQUAL TO 1/2 THE WIDTH OF THE WALK WHEN WIDTH IS EQUAL TO
- 7.3. PLACE 1" EXPANSION JOINT WHERE ABUTTING SIDEWALK RAMP AND/OR RADIUS IN INTERSECTION 7.4. PLACE TRANSVERSE 1/2" EXPANSION JOINT AT MAXIMUM OF 100' SPACING
- 7.5. PLACE 1/2" EXPANSION JOINT WHEN ABUTTING A FIXED STRUCTURE, OTHER PAVEMENT (CONCRETE PAVEMENT AND DRIVE APPROACHES), UTILITY STRUCTURES, LIGHT POLE BASES AND COLUMNS




(LR7-22) NO PARKING SIGN DETAIL

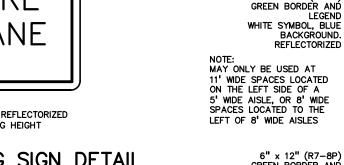





VAN 6" x 12" (R7-8P) GREEN BORDER AND ACCESSIBLE LEGEND REFLECTORIZED

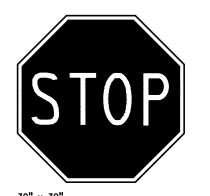

WHITE ON RED REFLECTORIZED 7'-0" MOUNTING HEIGHT STOP SIGN DETAIL

VAN ACCESSIBLE PARKING SIGN DETAIL

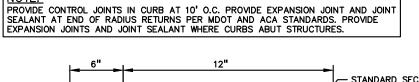

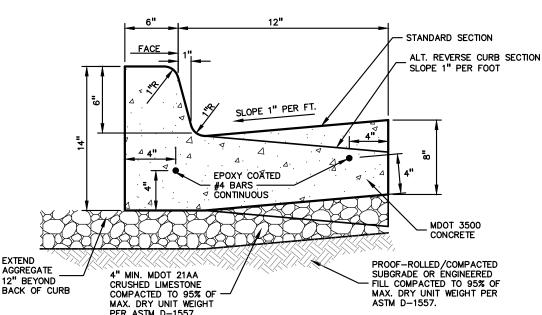

18"x6" STANDARD CONCRETE CURB AND GUTTER

CLEAN FILL PER

_ CURRENT MDOT SPEC RESTORE AREA PER


PROVIDE 1" DEPTH SAWCUT CONTROL JOINTS AT INTERVALS EQUAL TO THE WIDTH OF THE

PROOF-ROLLED/COMPACTED

SUBGRADE OR ENGINEERED

FILL COMPACTED TO 95% OF
MAX. DRY UNIT WEIGHT PER
ASTM D-1557.

SIDEWALK (NOT TO EXCEED 8' INTERVAL).

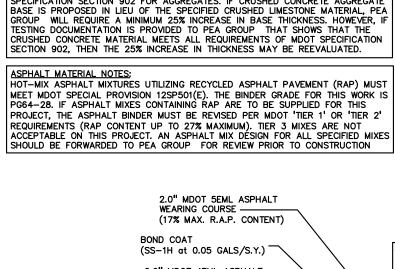

LEVELING COURSE ——

8" MDOT 21AA CRUSHED LIMESTONE BASE COURSE COMPACTED TO 95% MAX. DR

PROOF-ROLLED/COMPACTED SUBGRADE OR ENGINEERED FILL COMPACTED TO 95% OF MAX. DRY UNIT WEIGHT PER ASTM D-1557.

UNIT WEIGHT PER ASTM D-1557

(27% MAX. R.A.P. CONTENT)

STANDARD DUTY ASPHALT DETAIL

"NON-WALKING" AREA

PERMANENT

SIDEWALK RAMP TYPE R

OBSTRUCTION

ADA ACCESSIBLE SIGNS AND POSTS,

(PROVIDE SIGN LOCATIONS PER PLAN)

TYP. REFER TO ADA ACCESSIBLE SIGN AND POST DETAIL

NO PARKING

5'-0" MIN

- ROLLED CURB

4" WIDE BLUE

© OF PARKING

© SPACE

12" HIGH WHITE LETTERS, ARIAL FONT OR APPROVED EQUAL

8'-0" MIN.

(8' WIDE AISLES ONLY)

DETECTABLE WARNING

- SURFACE 24" ACROSS

FULL WIDTH (SEE NOTES)

AGGREGATE BASE NOTE:
THIS PAVEMENT SECTION DESIGN ASSUMES THE USE OF MDOT 21AA CRUSHED
LIMESTONE BASE MATERIAL THAT MEETS THE REQUIREMENTS OF MDOT STANDARD
SPECIFICATION SECTION 902 FOR AGGREGATES. IF CRUSHED CONCRETE AGGREGATE

	ASPHALT MIX DESIGN CHART					
	COMMERCIAL ADT 0-300	COMMERCIAL ADT 301-1000	COMMERCIAL ADT 1001-3400	COMMERCIAL ADT ≥3401	APPLICATION RATE (LB/YD²), MINIMUM – MAXIMUM	COURSE APPLICATION
	2EL	2EML	2EMH	2EH	435-550	BASE
	3EL	3EML	ЗЕМН	3EH	330-410	BASE AND/OR LEVELING
	4EL	4EML	4EMH	4EH	220-275	LEVELING AND/OR TOP
	5EL	5EML	5EMH	5EH	165-220	TOP
[PG 58-28	PG 64-28	PG 64-28	PG 70-28P		

2.0" MDOT 5EMH ASPHALT WEARING COURSE

(17% MAXIMUM R.A.P. CONTENT)

(SS-1H at 0.05 GALS/S.Y.)

(27% MAXIMUM R.A.P. CONTENT)

10" MDOT 21AA CRUSHED LIMESTONE BASE COURSE

COMPACTED TO 95% MAX. DRY UNIT WEIGHT PER ASTM D-1557


PROOF-ROLLED / COMPACTED SUBGRADE OR ENGINEERED

FILL COMPACTED TO 95% OF
MAX. DRY UNIT WEIGHT PER
ASTM D-1557.

2.5" MDOT 4EMH ASPHALT





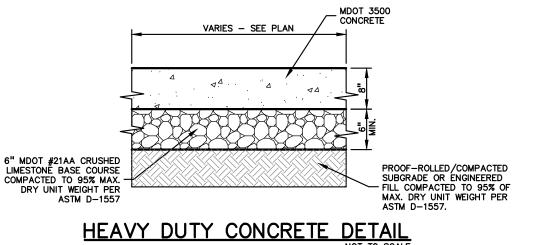

*MAXIMUM LANDING SLOPE IS 2.0% IN EACH DIRECTION OF TRAVEL. LANDING

**MAXIMUM RAMP CROSSING SLOPE IS

2.0%. RUNNING SLOPE 5%-7% (8.3%

© OF PARKING **©**

ALL DIMENSIONS ARE TO CENTER OF STRIPE UNLESS OTHERWISE INDICATED


4" WIDE BLUE

MAXIMUM). SEE NOTES.

MINIMUM DIMENSIONS 5' X 5'. SEE NOTES.

24" CENTERS 1'-6" MIN. PLANE OF WEAKNESS JOINTS CURB & GUTTER 1" EXPANSION __

ALL SPECIFIED THICKNESSES ARE FINAL COMPACTED THICKNESSES, TYP.

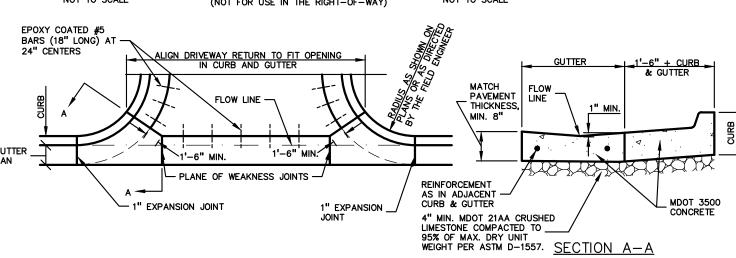


MDOT DRIVEWAY OPENING-DETAIL 'M'


HEAVY DUTY ASPHALT DETAIL





PRIOR TO THE START OF CONSTRUCTION.


DETERMINING THE EXACT UTILITY LOCATIONS AND ELEVATIONS

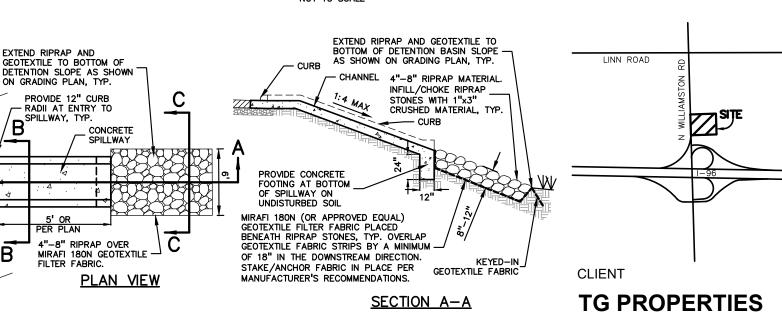


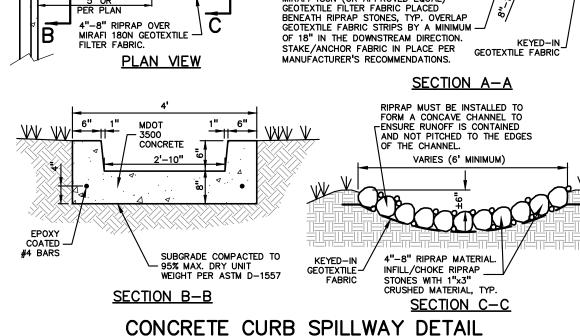

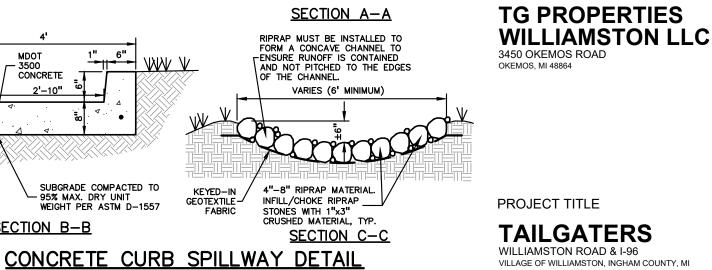

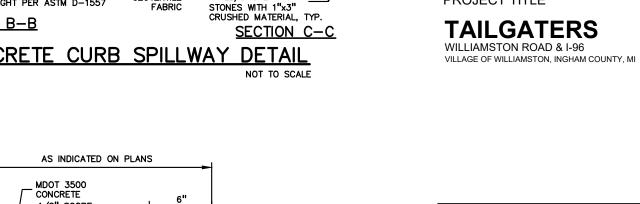

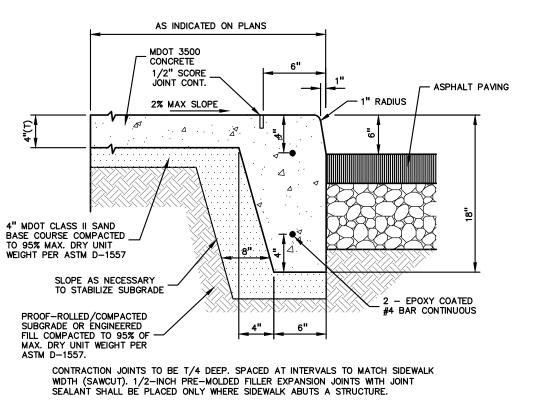

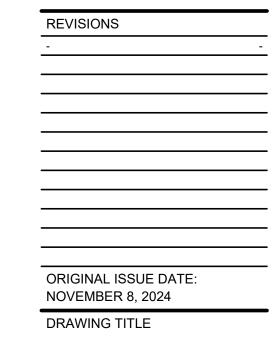

INTEGRAL CURB AND SIDEWALK

NOTES AND DETAILS

PEA JOB NO.	2024-1335
P.M.	BW
DN.	HZ
DES.	DB
DRAWING NUMBER:	

<u>CONCRETE SIDEWAL</u>

WIDTH VARIES - SEE PLAN

NOTE: CROSS-SLOPE OF SIDEWALK MUST NOT EXCEED 2.0%, EXCEPT IN TRANSITION AREA

MATCHING INTO EXISTING SIDEWALK

4" MDOT CLASS II SAND BASE COURSE COMPACTED TO 95%

RESERVED

PARKING

ONLY

12" x 18" (R7-8) GREEN BORDER AND LEGEND WHITE SYMBOL, BLUE BACKGROUND. REFLECTORIZED

ADA ACCESSIBLE

PARKING SIGN DETAIL


ALTERNATE REVERSE CURB SECTION TO

BE USED ONLY WHEN DRAINING AWAY FROM CURB. SEE PLAN FOR LOCATION.


ADA ACCESSIBLE SIGN NOTES:

ONE SIGN IS REQUIRED AT EACH ADA ACCESSIBLE PARKING SPACE. 2. ALL SIGNS SHALL COMPLY WITH THE LATEST STANDARDS OF THE MICHIGAN MANUAL OF UNIFORM TRAFFIC CONTROL DEVICES (MMUTCD). WHEN TWO ADA ACCESSIBLE PARKING SPACES ARE ADJACENT AND FACING EACH OTHER, TWO SIGNS ARE REQUIRED, BUT CAN BE MOUNTED ON THE SAME POST. 4. SIGN POSTS SHALL BE 2" NOM. SQUARE 14-GAUGE GALVANIZED STEEL TUBE WITH 7/16" HOLES AT 1" CENTERS. POSTS SHALL TELESCOPE INSIDE ANCHOR POSTS A

MINIMUM OF 12". 5. ANCHOR POSTS SHALL BE 2.25" NOM. SQUARE 12-GAUGE GALVANIZED STEEL POST, A MINIMUM OF 3 FEET LONG.
6. IF THESE NOTES AND DETAILS CONFLICT WITH LOCAL CODES AND ORDINANCES, THE STRICTER REQUIREMENT SHOULD BE USED. 7. ALTERNATE MATERIALS MAY BE USED IF IN COMPLIANCE WITH ADA GUIDELINES AND LOCAL REQUIREMENTS.

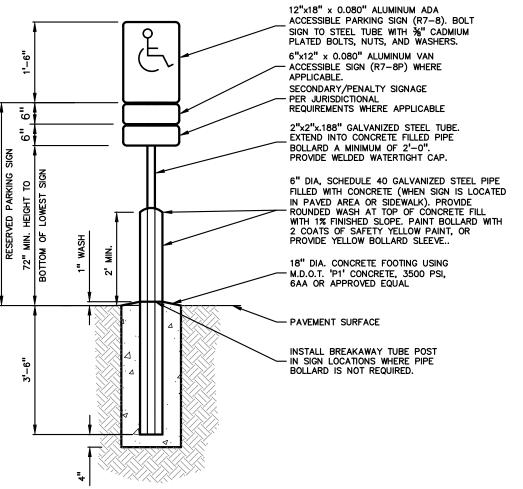

ADA ACCESSIBLE SIGN AND POST DETAIL

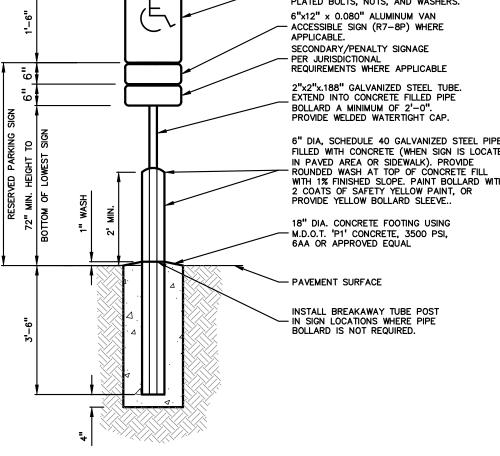


STALL WIDTH 8'-0" MIN. AT VAN ACCESSIBLE STALL ALTERNATE ADA ACCESSIBLE PARKING STALL DETAIL


NOTE: VAN ACCESSIBLE SPACES MUST BE LOCATED TO THE


LEFT OF THE 8' STRIPED


ACCESS AISLE


8'-0" MIN.

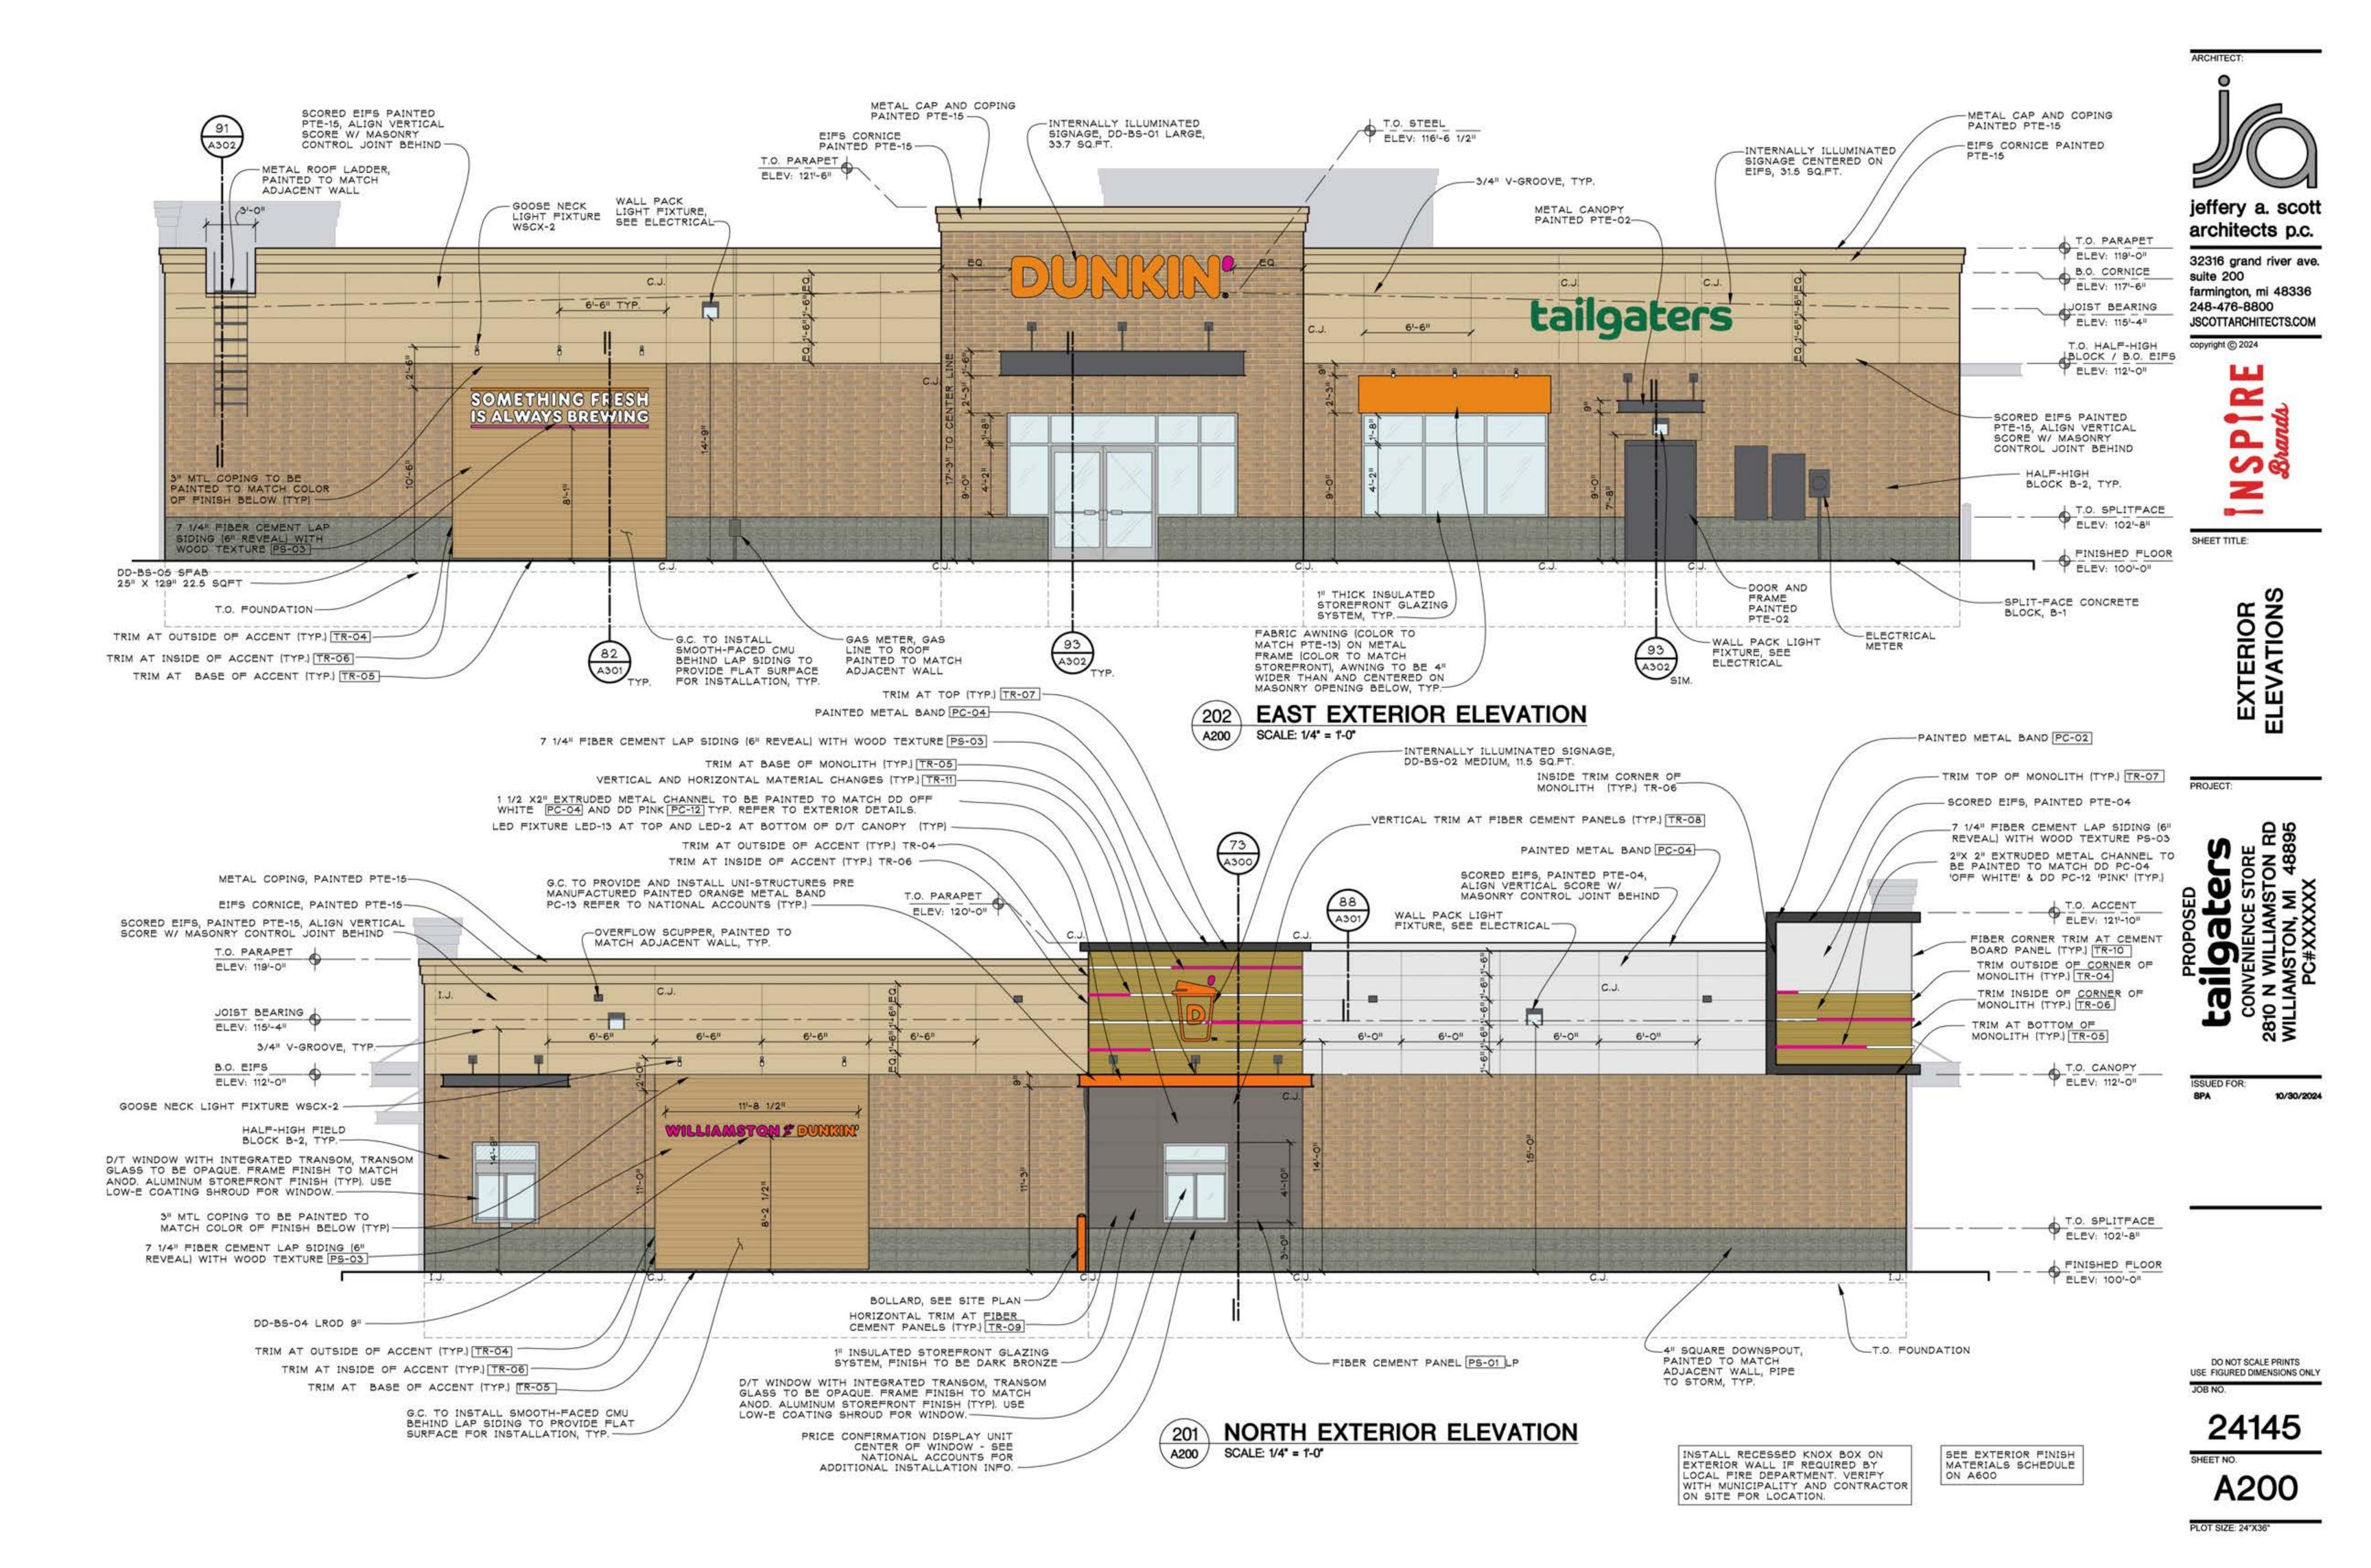

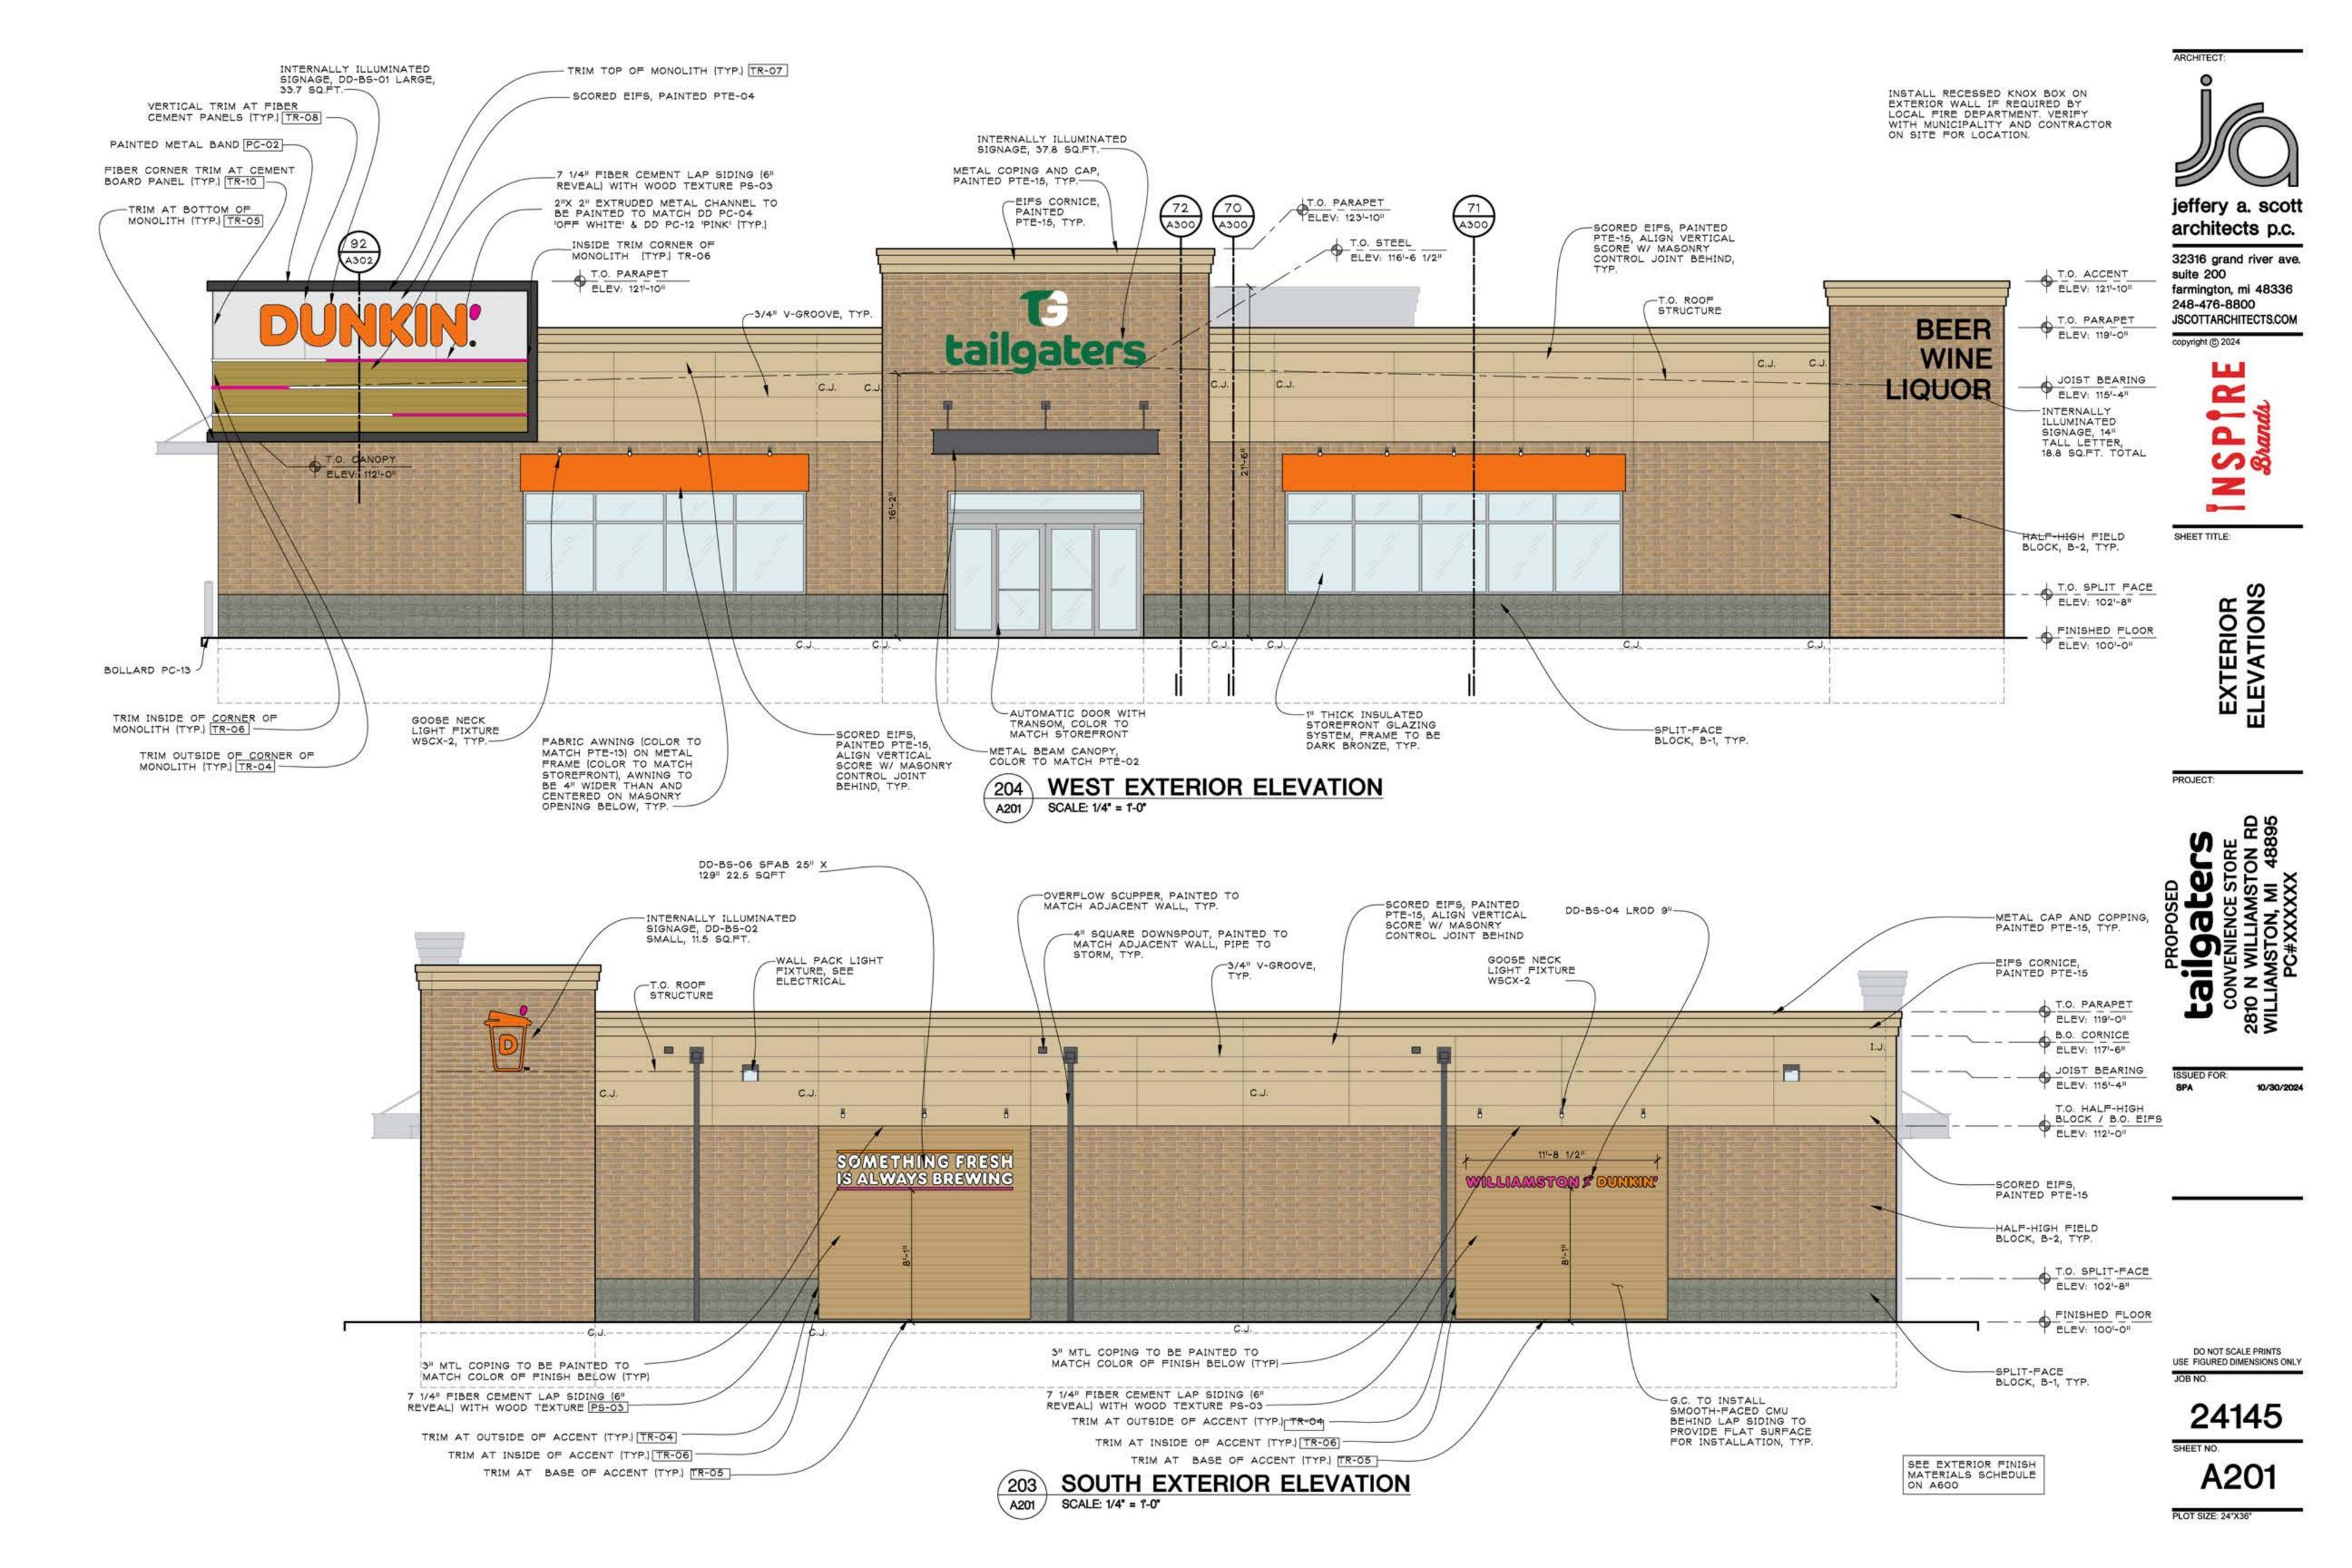

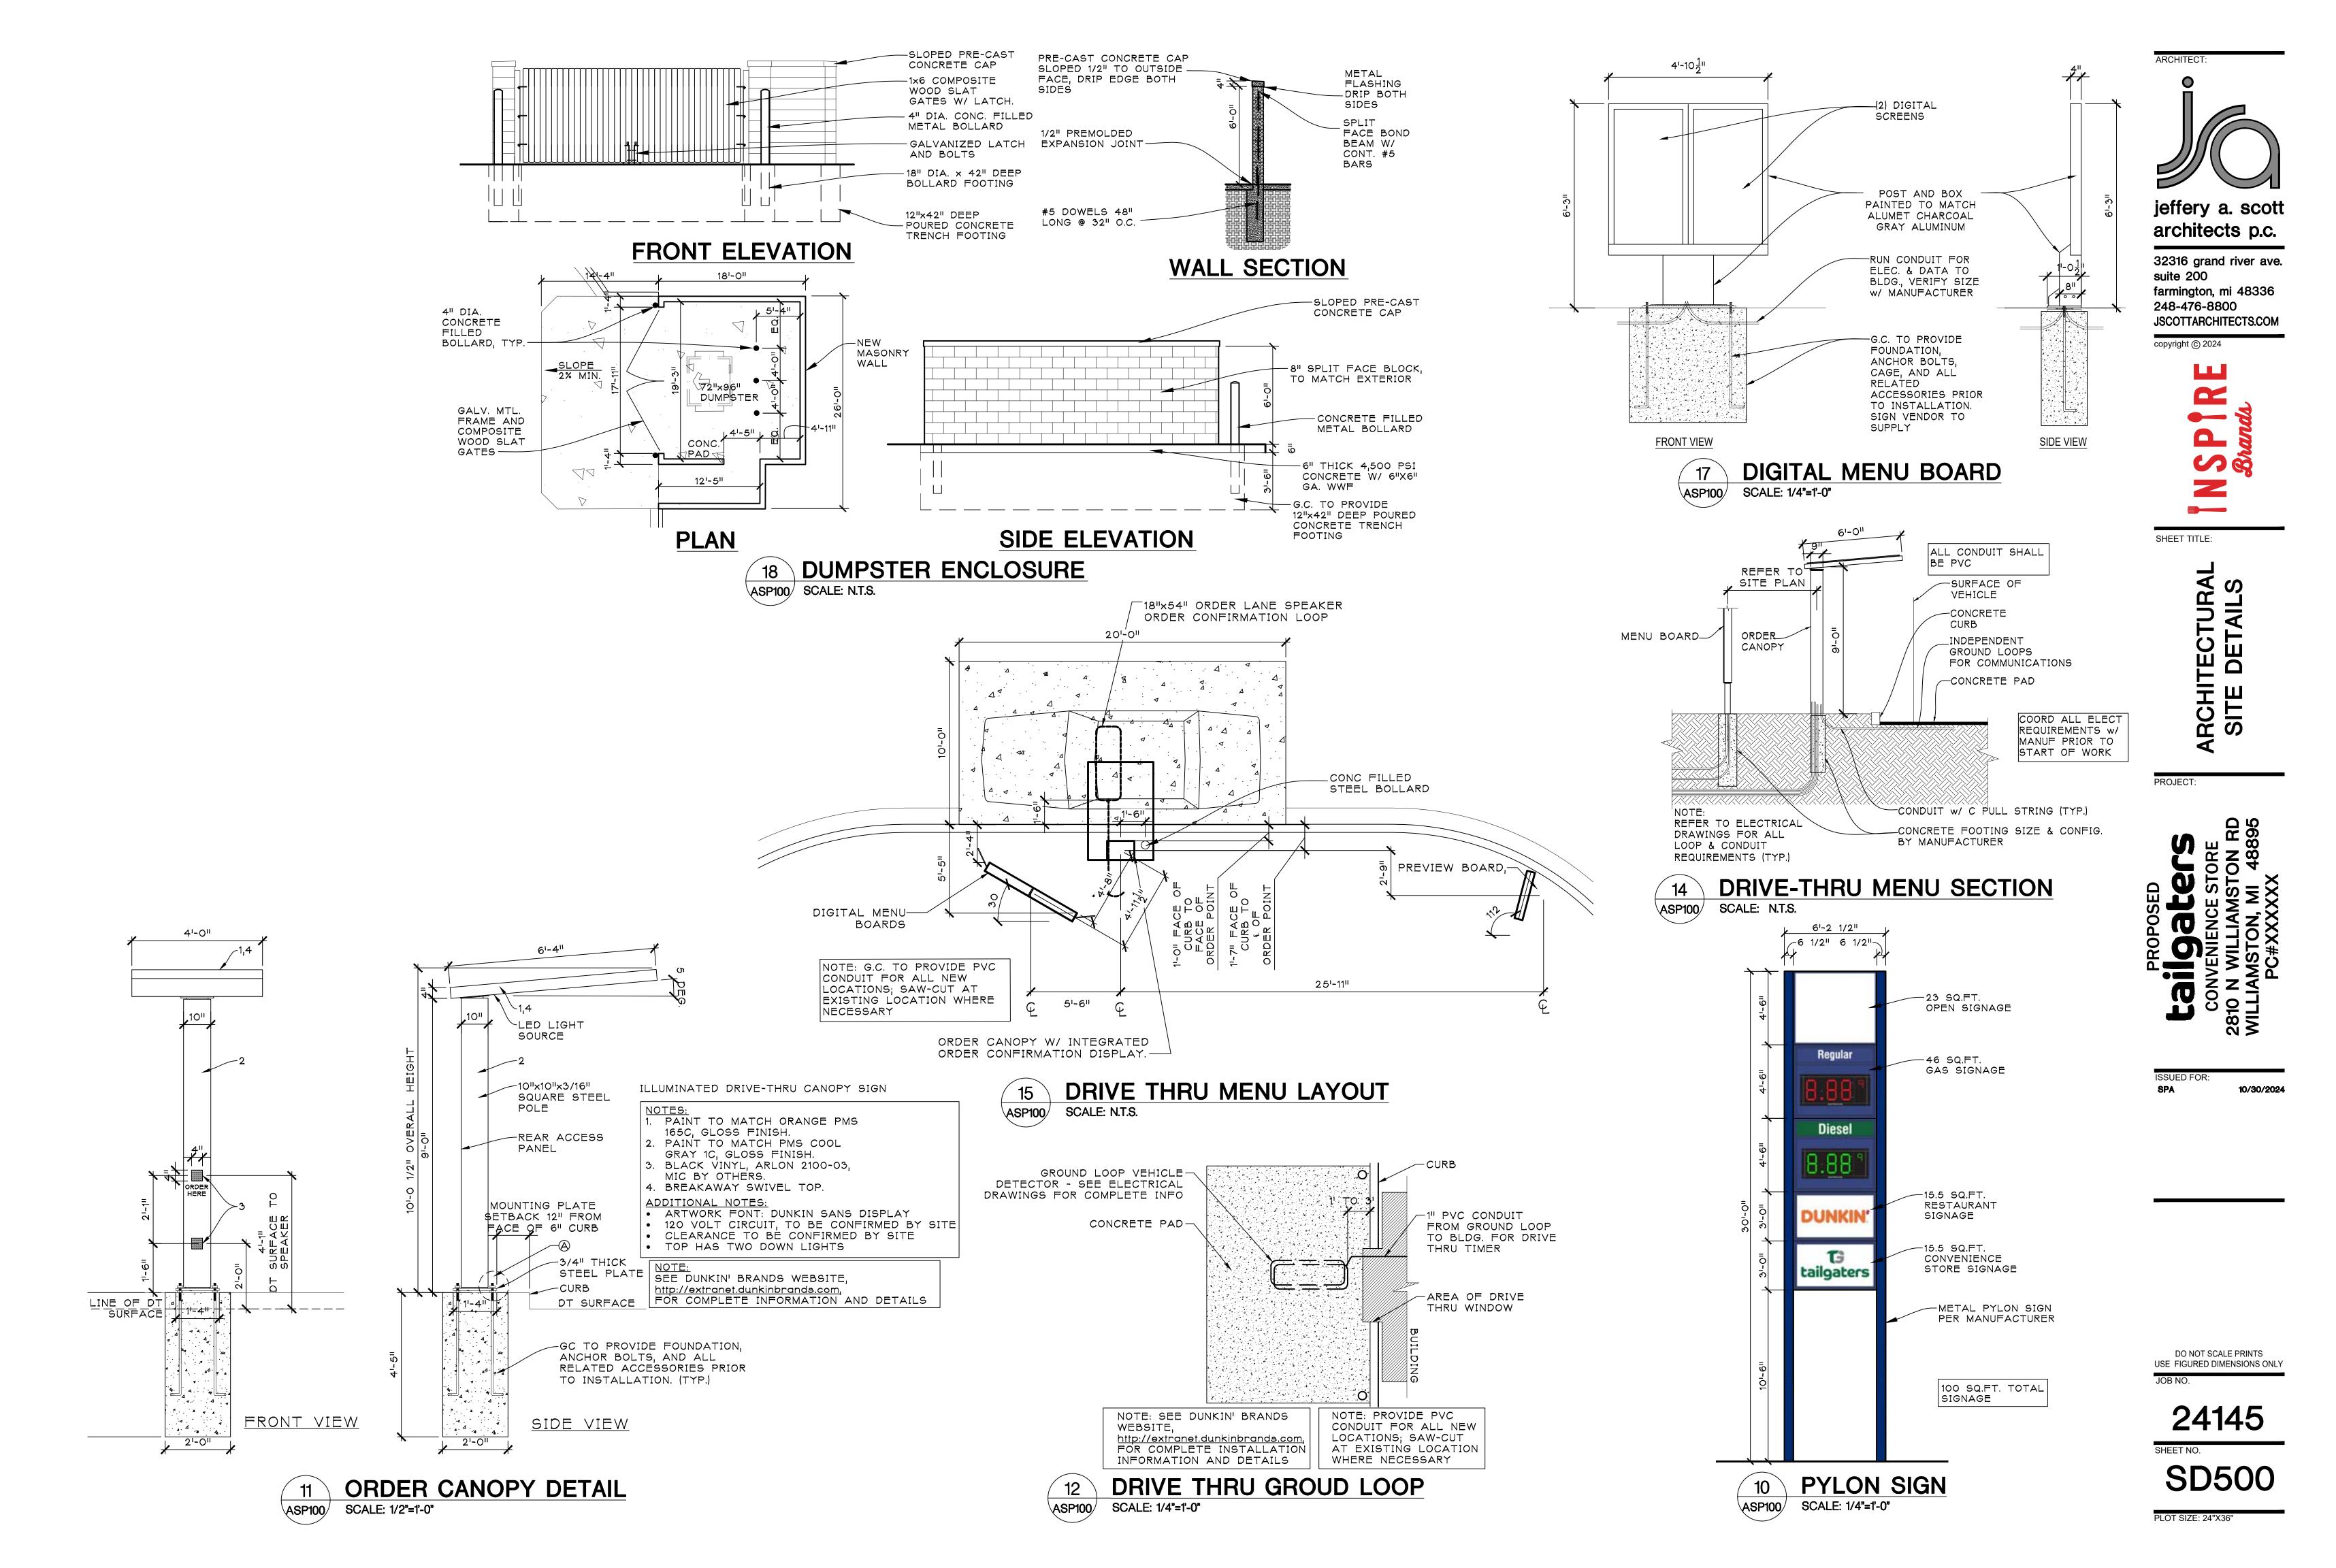

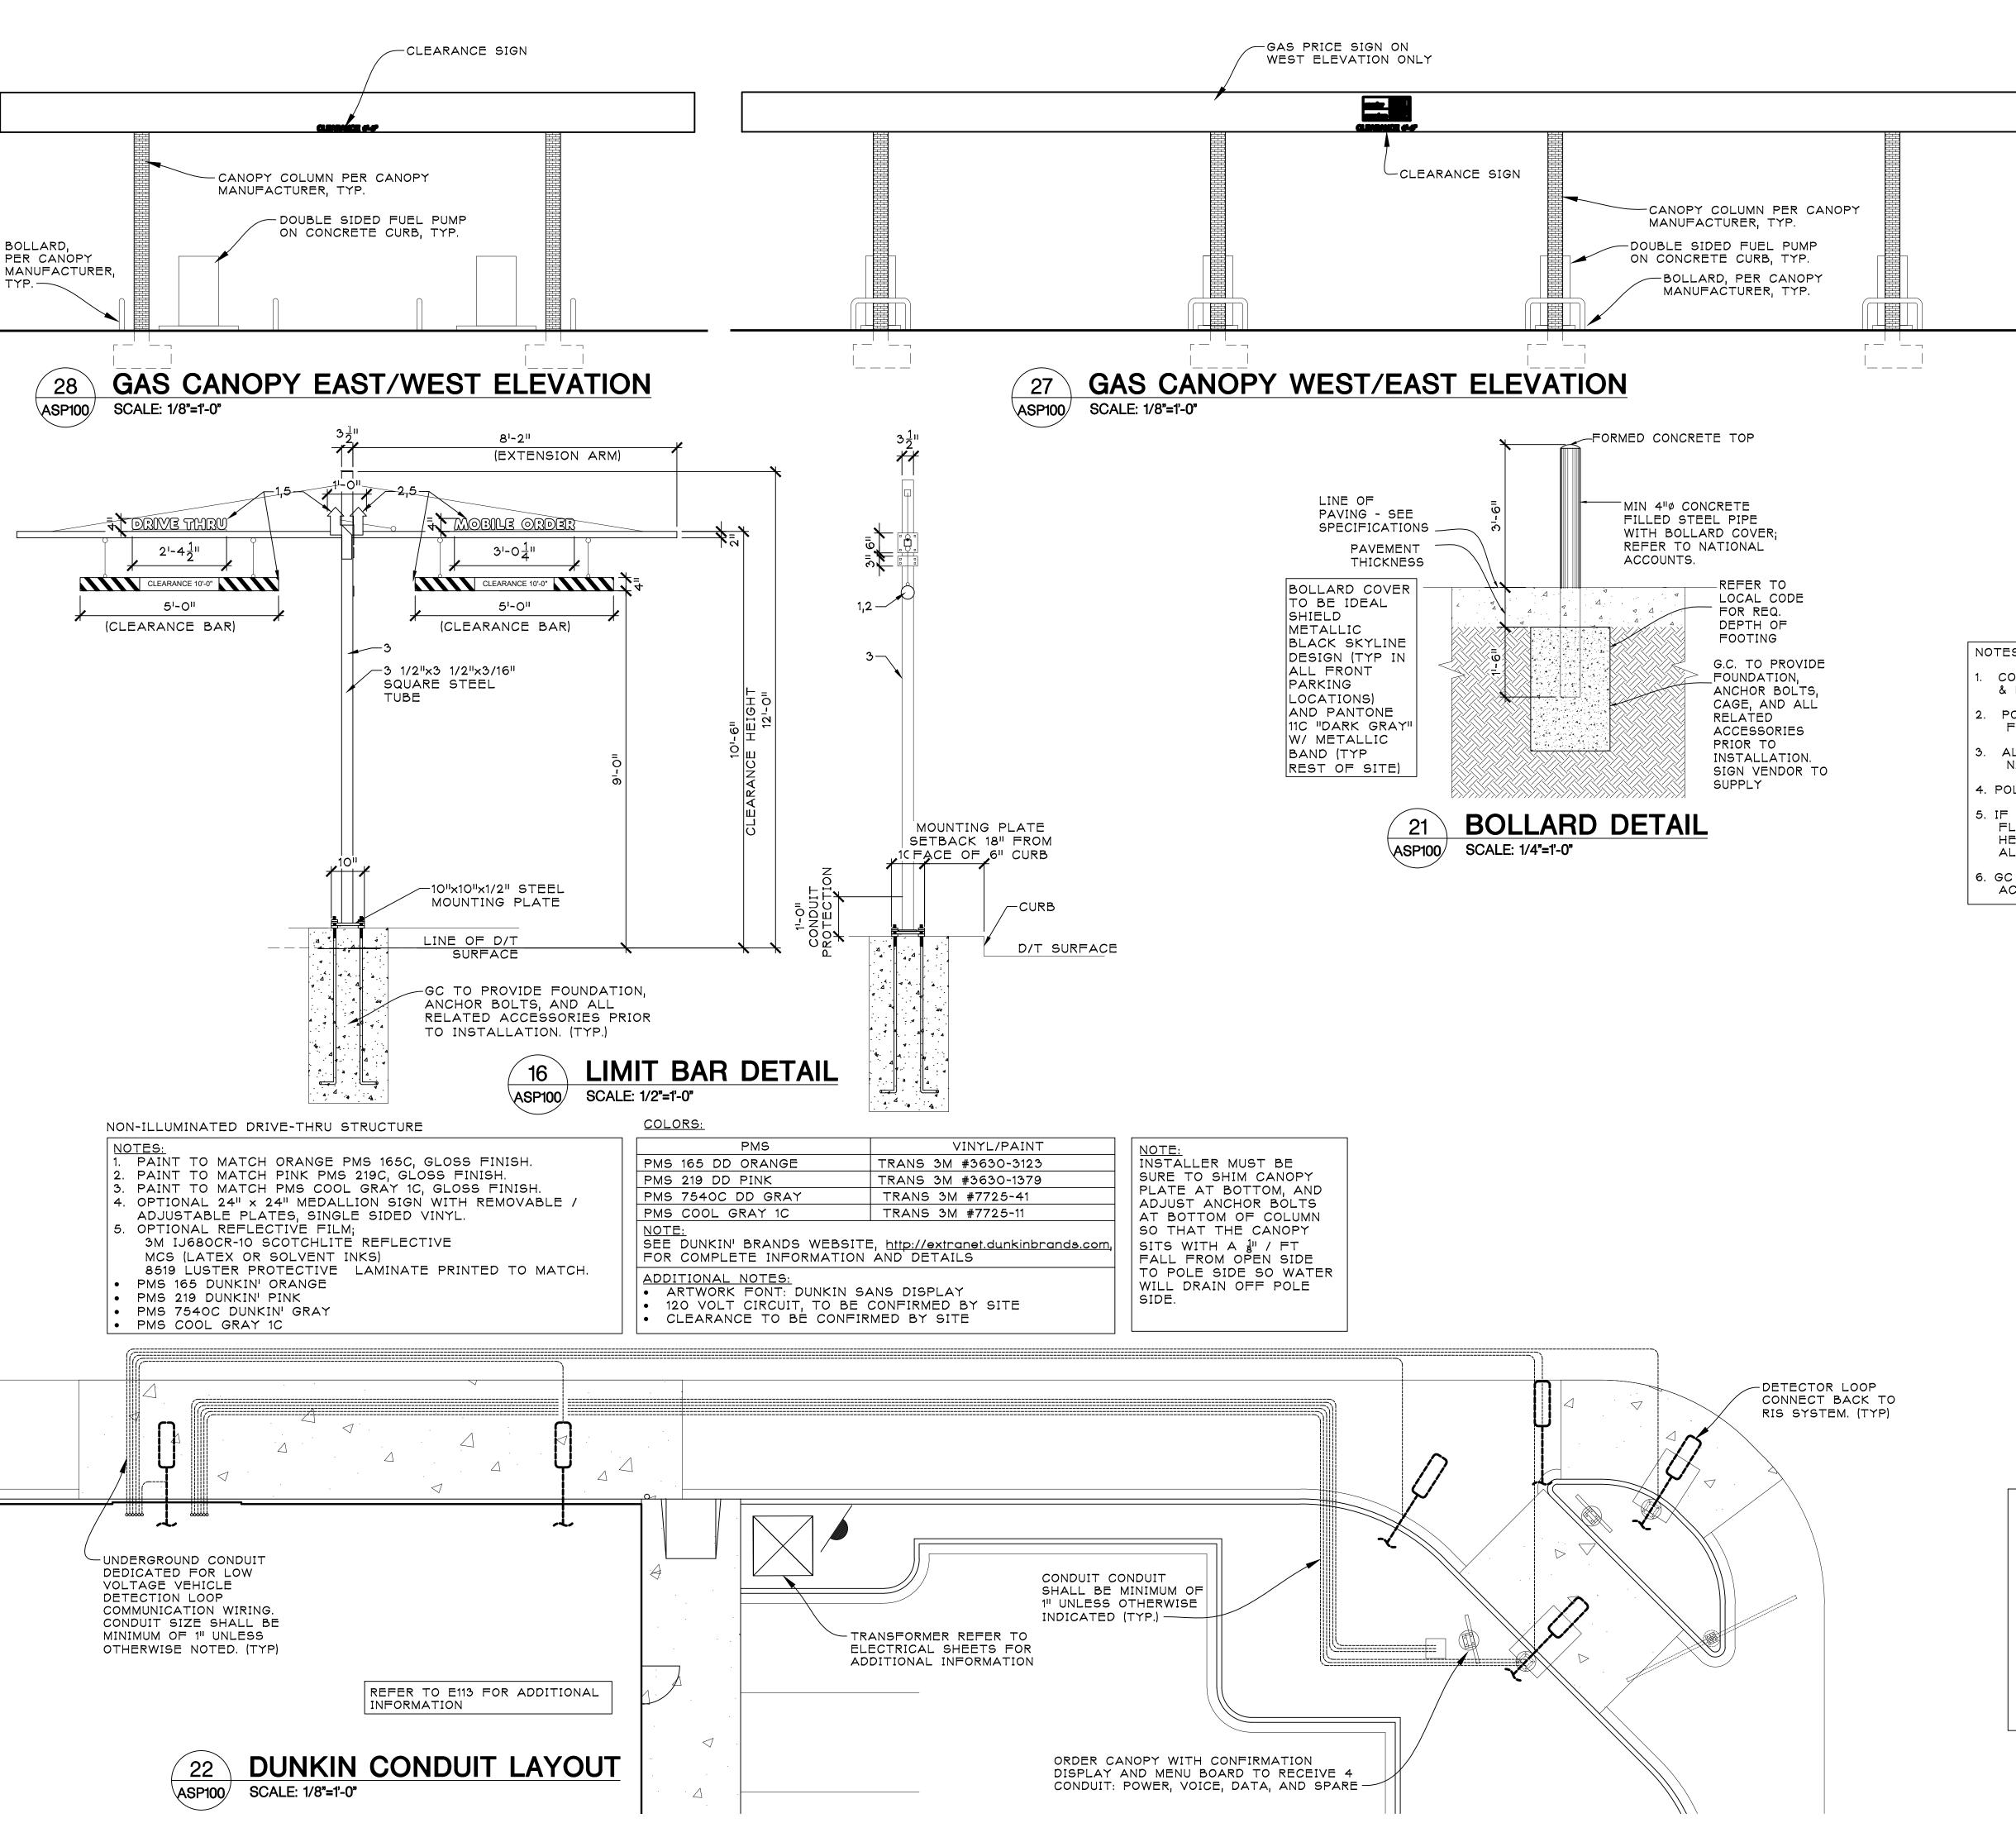

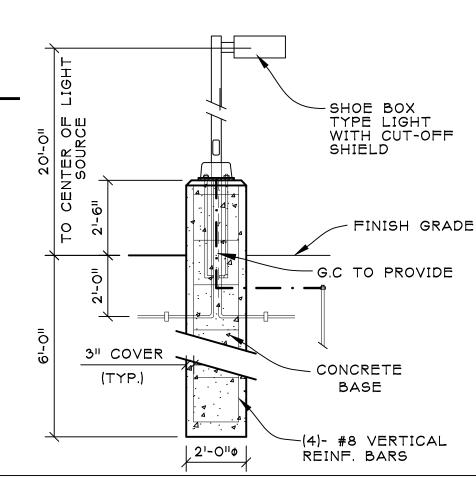


- CONTRACTOR SHALL REFER TO SITE PLAN FOR NUMBER & LOCATION OF AREA LIGHTS REQUIRED.
- 2. POLE, ARM, FIXTURE, ANCHOR BOLTS, AND BASE COVER FURNISHED & INSTALLED BY CONTRACTOR.
- 3. ALL ELECTRICAL WIRING SHALL COMPLY W/ LOCAL & NATIONAL CODE.
- 4. POLE, ARM AND FIXTURE ARE PREFINISHED BY MFG.
- 5. IF POLE IS ADJACENT TO CURB, SET TOP OF BASE FLUSH W/ TOP OF CURB. IN THIS INSTANCE THE POLE HEIGHT SHALL BE ADJUSTED, TO MEET THE MAXIMUM ALLOWED HEIGHT TO THE CENTER OF THE LIGHT SOURCE.
- 6. GC TO PROVIDE FOUNDATION, POWER AND ALL RELATED ACCESSORIES PRIOR TO INSTALLATION.

LIGHT POLE BASE DETAIL

NO SCALE

SITE POLE DETAIL
ASP100 SCALE: N.T.S.

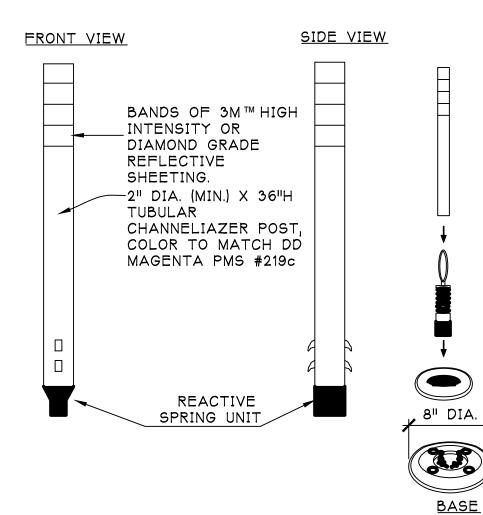

NOTES:

1. INSTALLATION TO BE COMPLETED IN ACCORDANCE WITH MANUFACTURERS SPECIFICATIONS. DELINEATOR CAN BE MECHANICALLY FASTENED OR INSTALLED WITH EPOXY

2. POST SHALL BE CONSTRUCTED OF SEMI-FLEXIBLE HIGH IMPACT POLYMER RESISTANT TO: ULTRAVIOLET LIGHT, OZONE, AND HYDROCARBONS.
3. UNIT SHALL HAVE A REACTIVE SPRING ASSEMBLY

TESTED TO 145LB. TENSION WITH STAINLESS STEEL CABLE.

4. DELINEATOR SHALL HAVE AN "ANTI-TWIST" FEATURE THAT ASSURES THE SIGN WILL RETURN TO ITS ORIGINAL POSITION AFTER IMPACT.

5 SHALL MEET M.U.T.C.D. SPECIFICATIONS.
6. NCHRP-350 APPROVED.
7. REFER TO NATIONAL ACCOUNTS FOR ADDITIONAL

INFORMATION

24 LANE DELINEATORS
ASP100 SCALE: 1/2"=1'-0"

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NSPIRE Brands

SHEET TITLE:

ARCHITECTURAL SITE DETAILS

PROJECT:

LailgatersCONVENIENCE STORE

810 N WILLIAMSTON RD
///LIAMSTON, MI 48895
PC#XXXXXX

ISSUED FOR: **SPA 10/30/2024**

DO NOT SCALE PRINTS
USE FIGURED DIMENSIONS ONLY

24145

SD501

PLOT SIZE: 24"X36"

