



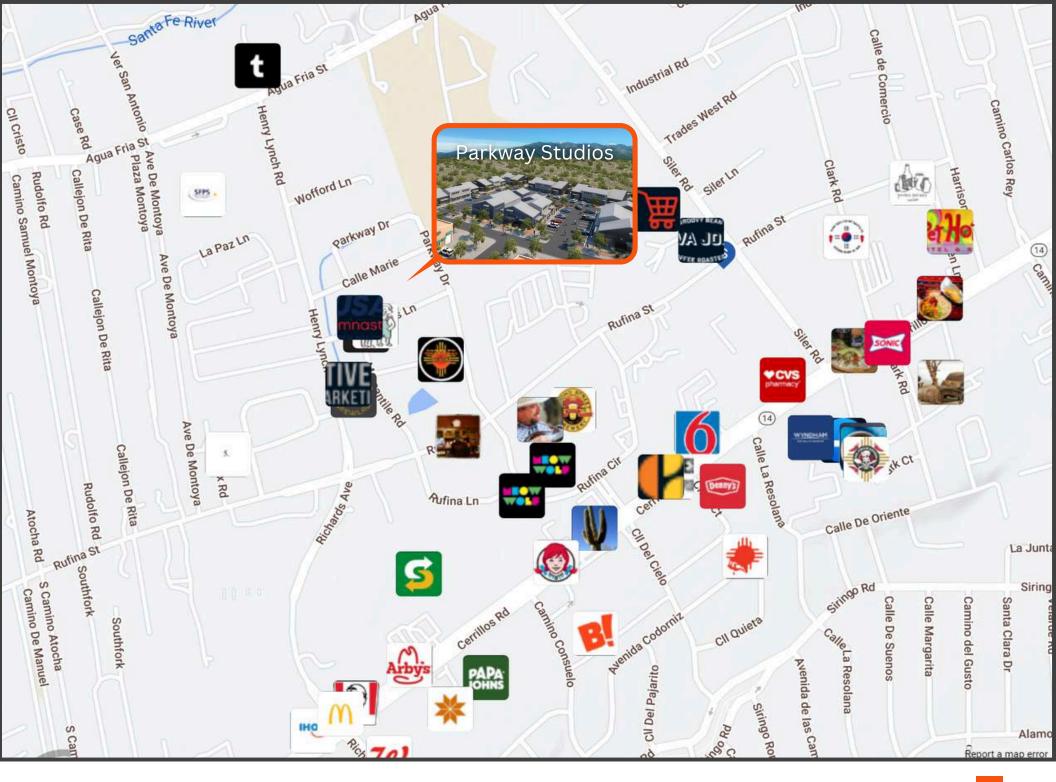
OFFERING SUMMARY	
ADDRESS	1189 Parkway Drive, Santa Fe, NM 87507
BUILDING SF	1,587 SF
LAND ACRES	0.04
HEATED SF	1,677 SF
YEAR BUILT	2025
FINANCIAL SUMMARY	
PRICE PER UNIT	\$525,000
PRICE PSF	\$352.58

• The Studios at Parkway Phase 2, currently under construction, is Santa Fe's newest commercial, industrial, and flex-use condominium development in the thriving Siler/Rufina Warehouse, Art & Innovation District.

Designed with an industrial aesthetic, The Studios offer open, light-filled spaces with contemporary touches that create an inspiring environment for business. Each unit spans nearly 1,677 square feet, including 1,587 square feet of interior space ("walls in"), and features tall ceilings, large aluminum glass roll-up garage doors, expansive storefront windows, and finished concrete floors. Inside, you'll find LED lighting, handcrafted steel staircases with wood treads, and smooth drywall finishes. The ground floor encompasses 1,092 square feet, while the second story adds 584 square feet.

These units are designed with flexibility in mind, with an option for Live-Work as an accessory to commercial use. Each unit has separately metered utilities, kitchen-ready hookups, a designated area for a shower, and thoughtfully landscaped grounds tailored for shipping and receiving. Zoned I-1, these state-of-the-art condominiums are suitable for a range of uses, from offices, galleries, and artist studios to warehouses, wellness businesses, and light industry. Additionally, the roof is prepared for solar PV installation, and the property is located in a Federal Opportunity Zone.









# PROPERTY FEATURES

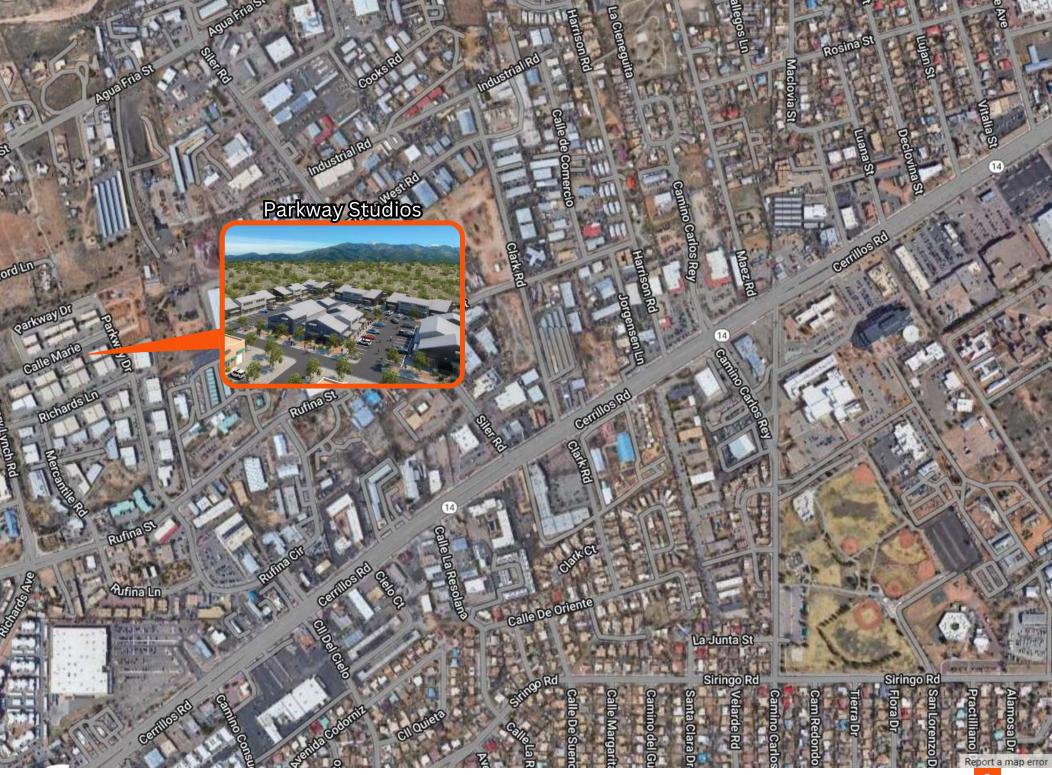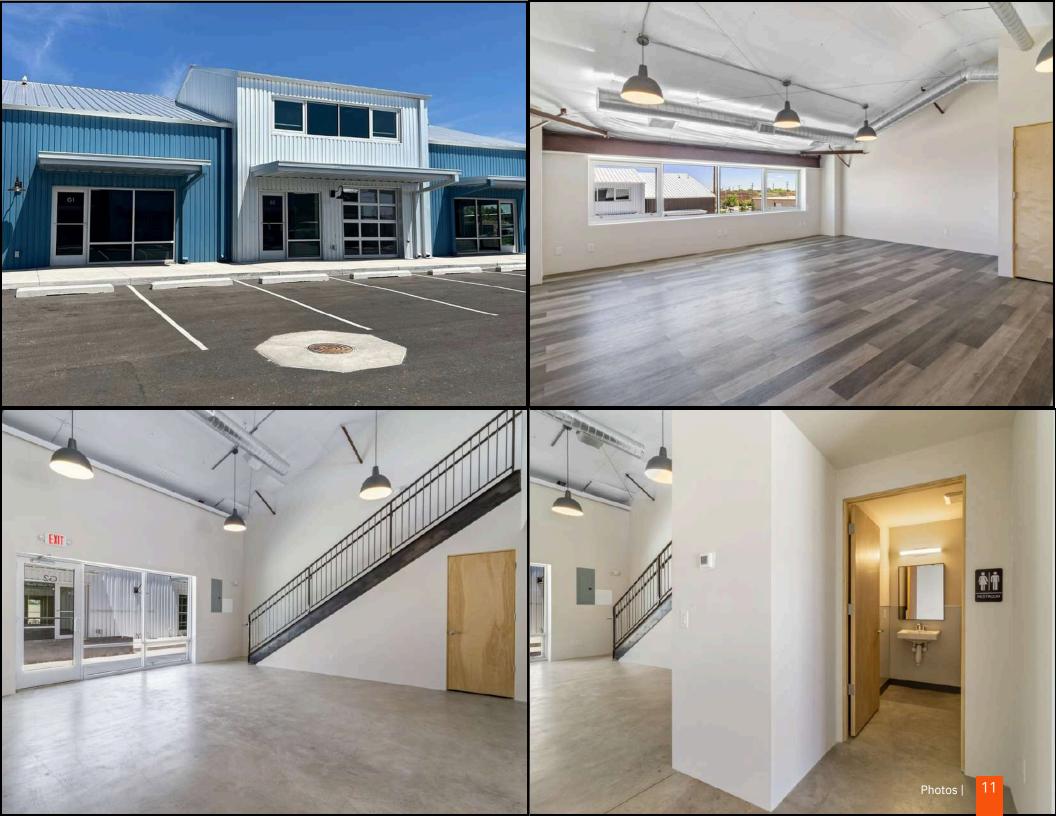NUMBER OF UNITS	12
BUILDING SF	1,587
LAND SF	1,677
LAND ACRES	0.04
YEAR BUILT	2025-2026
ZONING TYPE	I-1












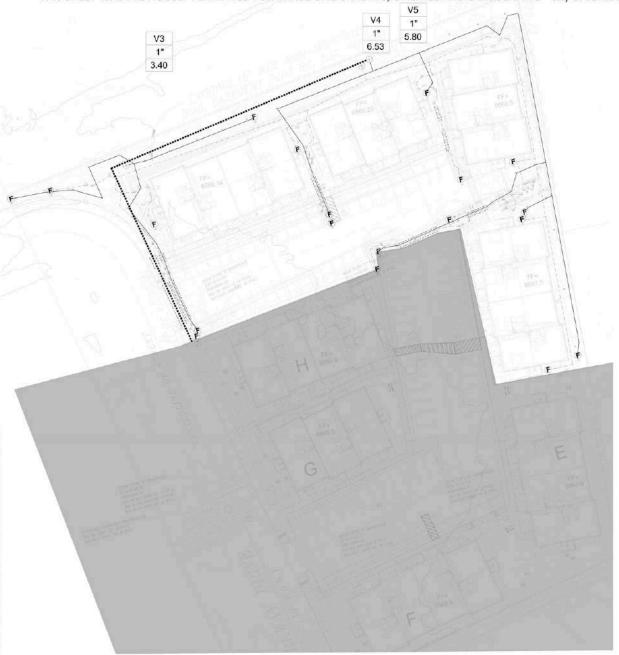THIS SHEET WAS PREVIOUSLY PERMITTED FOR PHASE ONE GRADING, UTILITIES AND LANDSCAPING - City of Santa Fe Permit Nos. 2021 - 17577 - 17578 - LSUG.



### WATER BUDGET PHASE 2

YEAR 1 AND 2 DRIP IRRIBATION TO TREES AND SHRUBS 4 MONTHS AT 1 RUN TIME REP MOINTH 4 MONTHS AT 1 RUN TIME PER WEEK 4 MONTHS AT 1 RUN TIMES PER VEEK APPERS, OF RUN CYCLES PIER YEAR 46 TREES 279 GALLONS PER RUN CYCLE

YEAR 3 AND BEYOND DRIP RRIGATION TO TREES AND GHRUBS 4 MONTHE AT 1 RUNTIME PER MONTH 4 MONTHE AT 1 RUNTIME PER WEEK 4 MONTHE AT 3 RUN TIMES PER VEEK APPROX. IT RUN CYCLES PER YEAR 45 TREESEZY GALLONS PER RUN CYCLE

98 SHRUBS/166 CALLONS PER RUN CYCLE 472 GALLONS PER RUN CYCLE X 77 RUN TIMES- 36,344 CPYL11 ACRE FT.

NOTE. THIS WATER BUDGET IS APPROXIMATE AND IS TO BE USED AS A GUIDELINE AND ADJUSTED ACCORDING TO CONDITIONS.

### IRRIGATION NOTES:

I. PRIGATION SYSTEM STANDARGO QUILLINED IN SECTION 14-64(E) OF THE SPCC WATER HINNESS TING AND REGIONATION SYSTEM STANDARGO QUILLINED IN SECTION 14-64(E) OF THE SPCC WATER HINNESS TING AND REGIONATION STANDARGO THE CITY OF SAVILARY.

2. ALL NEW PLANTINGS TO BE WATERED BY AUTO DR P INFOATION GYSTEM.
3. WALLEN MANAGEMENT AND THE MANTENANCE OF THE RISHGATION SYSTEM SITTED SOLD RESPONSIBILITY OF THE PROCEDURE OF THE RISHGATION SYSTEM SITTED SOLD RESPONSIBILITY OF THE PROCEDURE OF THE RISHGATION SYSTEM SITEM SOLD RESPONSIBILITY OF THE PROCEDURE OF THE RISHGATION OF STANDARGO STANDARGO OF THE PROCEDURE OF THE STANDARGO SYSTEM SITEMA SOLD CONSIST OF A WATER METER, BACKETON PREVENTION, AND MASTER VALUE.

SINES AND SELECTED STANDARGO S

LANDSCAPE BECS.

12. TREES AND SHRUBS ARE SET ON SEPARATE VALVES.

13. ANY RIGIDATION SHOWN IN PHASE 2 IS NOT PART OF THIS CONTRACT, IRRIGATION FOR PHASE 2 TO BE COMPLETED AT A LATER DATE.

Phase 2 Valv	ve Schedule
Valve 3	3.40 gpm
Valve 4	6.53 gpm
Valve 5	5.80 gpm
Highest Flow	6.53 gpm

NOTE EACH VALVE TO BE RUN SEPARATELY NOTE: TREES AND SHRUBS ARE ON SEPARATE VALVES.

### IRRIGATION LEGEND

Valve Size Valve Type

Symbol	Item / Description	Manufacturer / Model	Size	
С	Controller (Location TBD)	Rainbird ESP-BLXMe	8 Station	
×	Ball Gate Valve -assumed point of connection	Spears Ball Valve	1*	
BF MV	Reduced Pressure Backflow Preventen/Master Valve Assembly in Valve Box	Febox 825Y Rainbird PEB NDS 12*	†* **	
•	Automatic Drip Valve with pressure regulating filter in valve box	Rainbird PEB Rainbird PRF-100-RBY NDS 12*	r	
$\sim$	Poly Drip Line w / Flush Cap 6 emitters per tree 2 emitters per shrub 4-6" depth bury	Agrifim TAE	И. 2 GPH	
	PVC Masterline 30" depth bury	Sch. 40	2"	
	New PVC Sleeve	Class 200	as noted 2 min.	
VI	Volve Sequence			



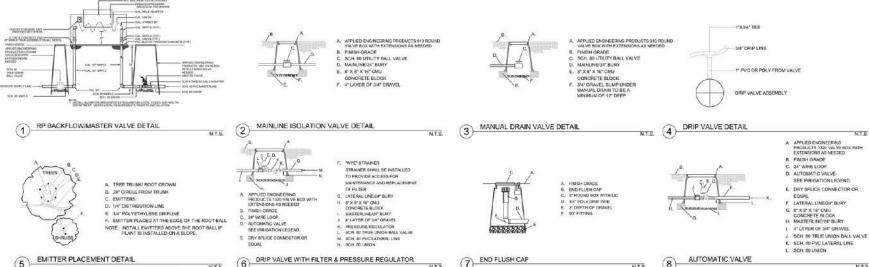
1189 Parkway Dr. Santa Fe, NM



Irrigation Plan

Sheet Number:

# THIS SHEET WAS PREVIOUSLY PERMITTED FOR PHASE ONE GRADING, UTILITIES AND LANDSCAPING - City of Santa Fe Permit Nos. 2021 - 17577 - 17578 - LSUG.





WALL MOUNTED AUTOMATIC CONTROLLER

D. JUNCTION BOX

A. CONTROLLER (see plan for model) B. 2" PVC 3CH 40 CONDUIT AND FITTINGS C. WIRES TO REMOTE CONTROL VALVES

E. 1" PVC SCH. 40 CONDUIT AND FITTINGS TO POWER SUPPLY

(8)



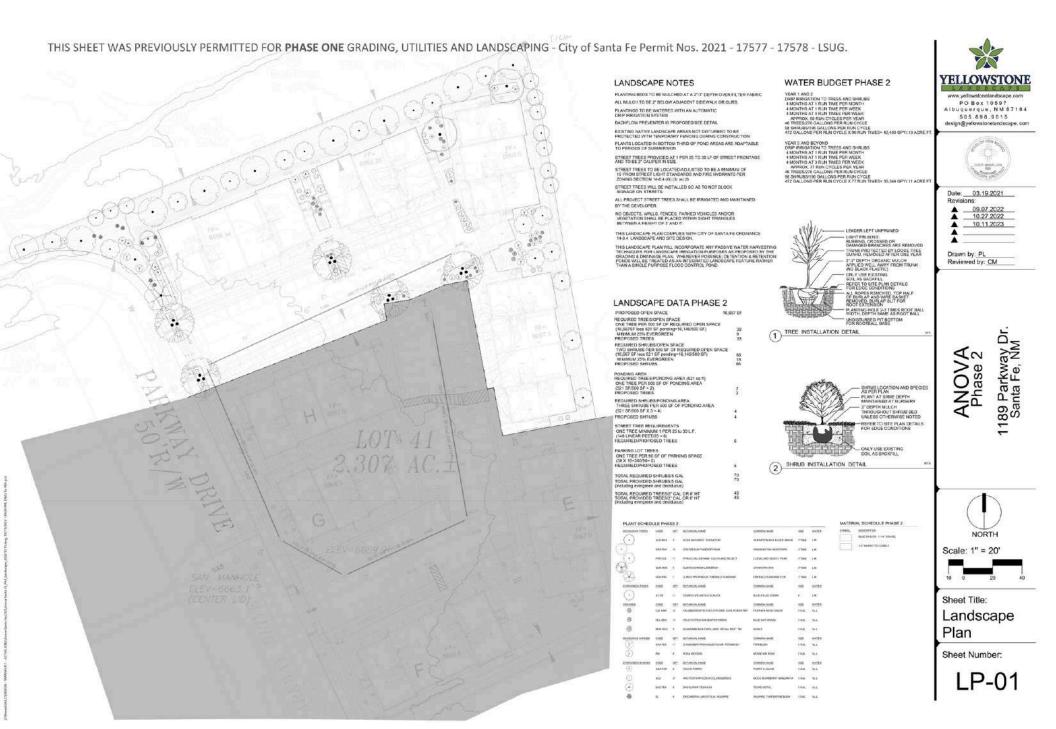


Date: 03,19,2021 Revisions: 07.29.2021 09.07.2022 10.27.2022 10.11.2023

Drawn by: PL Reviewed by: CM

Sheet Title: Irrigation **Details** 


Sheet Number:



Zoning: I-1 - Light Industrial

Lot Area - 2.307 acres/ 100,510 sf

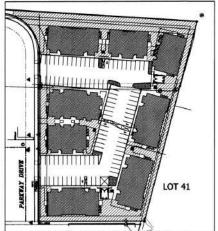
Lot Coverage (Phases 1 & 2) - 36% - 36,158 sf total roofed area



OPEN SPACE KEY PLAN - 1" = 60'-0"


Open Space Required = 25,128 sf Open Space Provided = 26,348 sf PARKING LOT ISLANDS

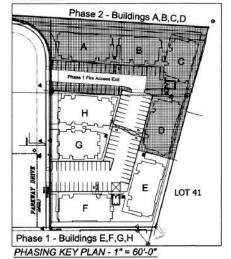Required = 990 sf Provided = 1102 st



ORIGINAL UTILITY EASEMENTS AND STORMWATER AGREEMENT SHALL STAY IN PLACE BASED ON EARLIER PLAT FILED IN COUNTY RECORDS ON THE 28TH DAY OF JUNE AD 2004, AT 13:32 O'CLOCK PM AND WAS DULY RECORDED IN BOOK 562, PAGE 028031 OF THE RECORDS OF SANTA FE COUNTY (#1335-001).

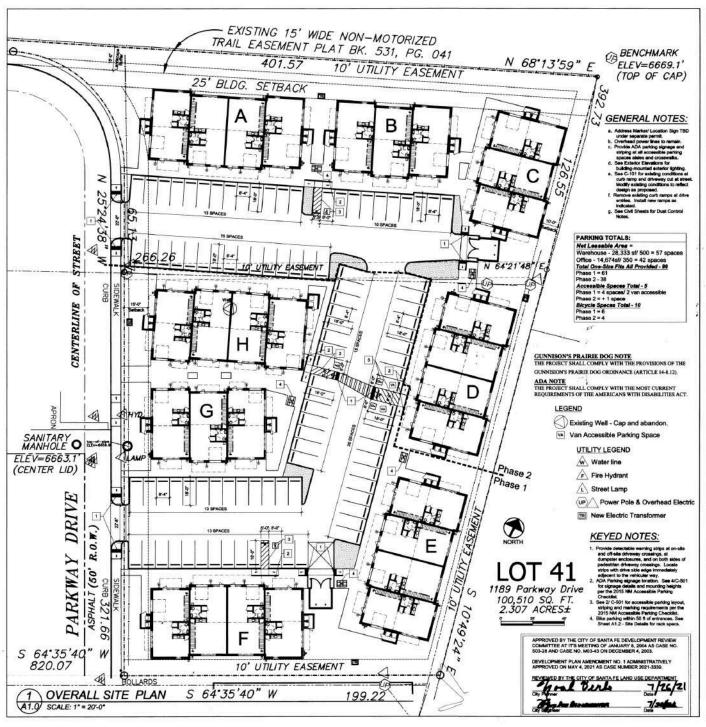NOTARY PRINCE MY COMMISSION EXPIRES 7-24-24



DEVELOPMENT PLAN **AMENDMENT** FINAL APPROVAL



REVISIONS:

**Final Comments** 7/19/21

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March 22, 2021

ANOVA

1189 Parkway Dr.

Santa Fe. NM 87507

Overall Site Plan

A1.0

THIS SHEET WAS PREVIOUSLY PERMITTED FOR PHASE ONE GRADING, UTILITIES & LANDSCAPE. City of Santa Fe Permit #17577 & #17578. THIS PROJECT WAS PREVIOUSLY APPROVED & PERMITTED FOR PHASE ONE - City of Santa Fe Building Permit Numbers 2002 - 24831, 24832, 24833, and 34834 - BLDC

# PHASE 2 **PERMIT SET**



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March 6, 2024

ANOVA PHASE 2

1189 Parkway Dr. Santa Fe, NM 87507

Dimensioned Site Plan

A1.1

### KEYED NOTES:

- Provide detectable warning strips at on-site and off-site driveway crossings, at dumpster enclosures, and on both sides of pedestrian driveway crossings. Locate strips with drive side edge immediately adjacent to the
- vehicular way.

  2. ADA Parking signage location. See 4/C-501 for signage details and mounting heights per the 2015 NM Accessible Parking Checklist.

  3. Not used
- 4. Bike parking within 50 ft of entrances. See
- Sheet A1.2 Site Details for rack specs.

  5. New concrete ourb ramp per NM DOT specs and drive entry apron, remove existing sidewalk and curb ramp as needed and patch
- Existing curb ramp to remain.
- New asphalt parking lot and drive aisle,
   South HVAC wall of Bidg, C stops at intersection with Trash Enclosure. Site Trash Enclosure prior to construction of HVAC
- screen wall

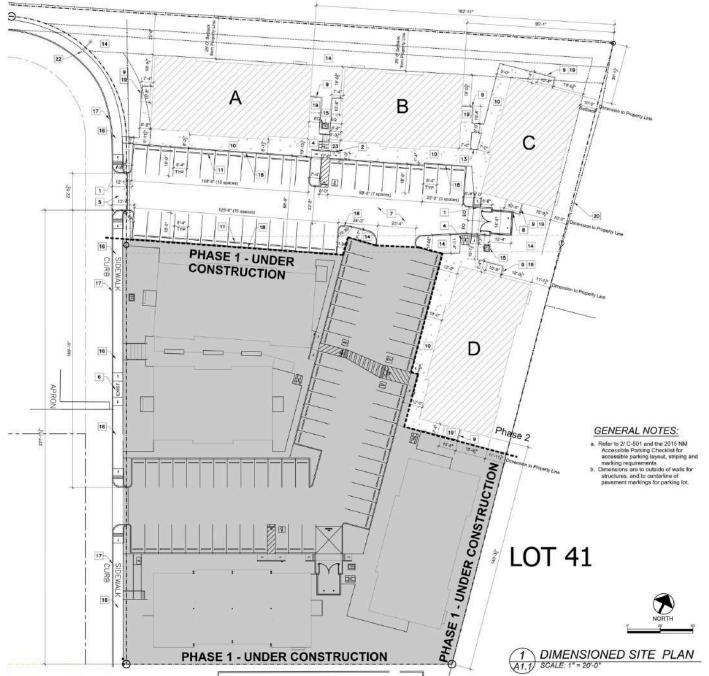
  New HVAC screen wall to be split face CMU with solid 2\* split face cap block.

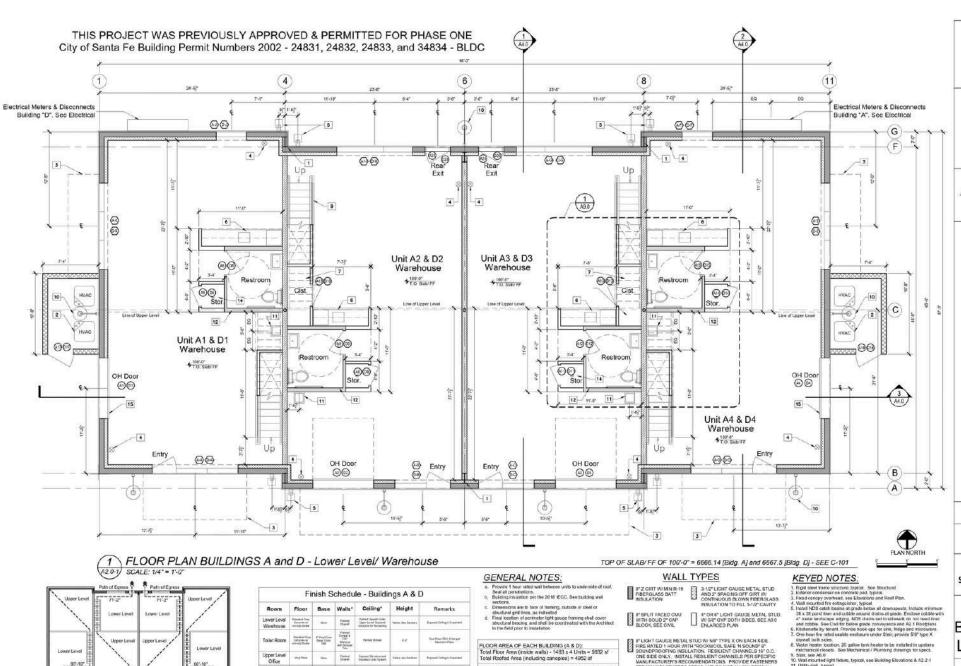
  10. New concrete sidewalk meets building face
- as indicated, typical.

  11. Standard concrete parking wheel stop.
- typical.

  12. Concrete pad and apron at dumpster enclosure location. Slope to drain through gate opening
- gate opening
  13. Tree well/ planter bed, no concrete.
  14. Landscape Area, see Landscape Sheets.
  15. Electrical transformer on concrete pad.
- Electrical transformer on concrete pag, typical.
   Existing concrete sidewalk to remain, UNO.
   Existing concrete curb to remain, UNO.
   New concrete curb to remain, UNO parking lot. Provide curb ramps where curb is
- broken, as indicated.

  19. Concrete pad/ sidewalk inside HVAC enclosure, typical. Slope to drain through gate
- opening 20. Existing perimeter fence on property line to
- Dumpster Endosure, see Site Details.
   New street light coordinate with PNM & City of Santa Fe.
- 23. Steps with handrall, see Sheet A1.2





See Sheet Alt D. Enlarged Bearings Flori

Femal Subgistmanut

Potest Dyesti

Mechanica Room

\* Provide min 5/8\* gypsum drywai

Path of Foress

scale: 1/16" = 1'-0"

Lower Level

86'-10" E

EXIT TRAVEL DISTANCE KEY PLAN

PHASE 2 **PERMIT SET** 



REVISIONS: 1 June 4, 2024

ADA Compliance -Restrooms

World S nirted to Building a Susta DESIGN SANTO AL

June 4, 2024

1

ANOVA PHASE 2

1189 Parkway Dr.

Santa Fe, NM 87507

Floor Plan Bldgs. A & D Lower Level

A2.0-1

FLOOR AREA OF EACH BUILDING (A & D): Total Floor Area (inside walls) - 1483 x 4 Units = 5932 sf Total Roofed Area (including canopies) = 4952 af

HEATED CONSTRUCTION AREA OF EACH BLDG. (A8D) Lower Level (including exterior wells) = 4371 s Upper Level (including exterior walls) = 2339 sf Total Heated Construction Area = 6710 sf

PLIGHT GAUGE METAL STUD WISST TYPE X.ON EACH SIDE FIRE RATED 1 HOUR WITH PRODUCES AFE IN SOUND FE SOUND FROM STUDIES AND THE SOUND FROM STUDIES AND THE STUDIE

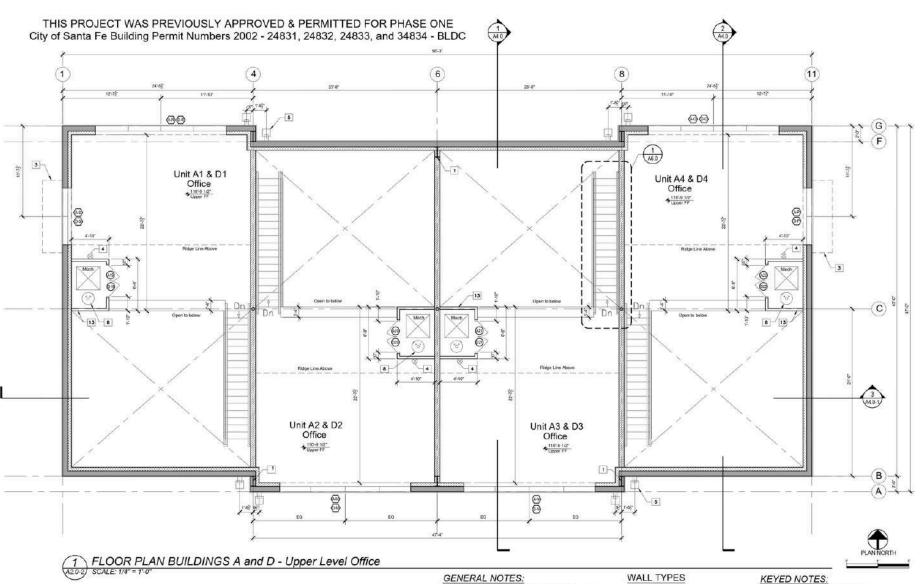
See Sheet S-3 "Structural Details and Sections" for light gauge metal training specs.

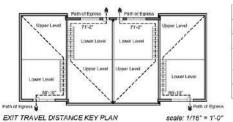
Utility sink, typical.
 Provide sound proofing libergless batt insulation on all sides of restroor.

The Provide acuter professional programs and insulation on an assass or restriction in wall contry.

13. Provide 576\* Type X drywall on both sides of walls at Mechanical Rooms.

15. Mount vortical track for OH door on well above for all and units.





Room	Floor	Base	Walls*	Ceiling*	Height	Remerks
Lower Level Warehouse	Marshall Shirt Spiriture of spiriture of	form	Paresc Travel	funeri Dywelfulnder Igger Leine, Esposed Stoccum turkenweng	'teres les lecters	Exposed fasting is tripotried
Toilet Room	Elandard firsy Commits of nor only States	P Viry/Cres Base, Natur 18th	Parent Dynast s 1920 Warnest old Gridden Trice	Fichel Orpesi	**	See Steet A2-3, Enlarged Section (*Tare.
Upper Level Office	Thyl Plant	New	Parison Street	Copied Hulbra and Hashbridge System	Name on Sectors	Exposed Calling a Ungained
Mechanical Room	Stratural Connects Fundi Subherr	Rine	Dryest Tape and Nue	Copied Studios and Successive Types	Spales, one Sactions	Report College Strained

### GENERAL NOTES:

- Provide 1 hour rated wall between units to underside of sool Sool all ponetrations.
   Building insulation per the 2018 IECC. See building wall sections.

- sections.

  Dimensions are to took of framing, cutside of steel or structural grid fines, as indicated.

  Final location of permetter light gauge framing shell cover structural triacing, and shall be conditioned with the Architect in the field onto to installation.

FLOOR AREA OF EACH BUILDING (A & D): Total Floor Area (inside walls) - 1483 x 4 Units = 5932 sf Total Roofed Area (including canopies) = 4952 ef

HEATED CONSTRUCTION AREA OF EACH BLDG. (ASD) Lower Level (including exterior walls) = 4371 af Upper Level (including exterior walls) = 2339 sf Total Heated Construction Area = 6710 sf

8" Z GERT W/MIN R-19 FIBERGLASS BATT INSULATION

3-1/2" LIGHT GAUGE METAL STUD AMD 2" SPACING OFF GIRT W/ CONTINUOUS BLOWN FIBERGLASS INSULATION TO FEL 5-1/2" CAVITY

4" OR 6" LIGHT GAUGE METAL STUD WI SIE" GYP BOTH SIDES, SEE AS,0 ENLARGED PLAN 8" SPLIT FACED CMU WITH SOUD 2" CAP BLOCK, SEE CIVIL

8° LIGHT GAUGE VETAL STUD W/ 58° TYPE X ON EACH SIDE.
FRE RATED 1 HOUR WITH "ROCKWOOL SAFE N SOUND" S'
SOUNDPROORNON INSULATION. RESILENT CHAINELS 16° O.C.
OC'S 306 ONLY. NISTAL RESILENT CHAINELS 9°C STEPERS
WANUTACTURED RECOMMENDATIONS. PROVINCE FASTENERS
FOR INMOSPROTUREDS SPICE AND ON TOTAL LOW DRIVING.
FASTENERS TO EXTEND PAST RESILENT CHANNELS AND INTO
STUDE.

See Sheet S-3 "Structural Details and Sections" for light gauge metal framing spece

- Rigid steel frame structure, typical. See Structural.

- 1. Rigid sized frame structure, kyrácal. See Structura.
  2. Enderia conditivemen or somerche pad, kyrácal.
  3. Fued carcepy evenhead, ose Eleválises and Rod Plán.
  4. Wall mouracide fice estinguiders, hyrácal di coverspouts. Include minimum 31% 38 post piem and poble a vicand drains all grade. Endose pobles with and ecobies. See Chall for below grade conveyaces and 472. If copylars is Editable ecobies. See Chall for below grade occupações and 472. If copylars is Editable ecobies. See Chall for below grade occupações and 472. If copylars is Editable ecobies. See Chall for below grade occupações and 472. If copylars is Editable ecobies. See Meditable, soft anticipações and microsvave.
  7. Cinc hour fire raiso di sebbe condodire unide State; provide 58° typs X chyvall Both sides.
  8. Water haware focation. 29 gallon tants hauter to be installed in upstalars mechanical costoss. See Meditamical I Plantining disweps for spors.
  10. Nutil mounted (grif firstus, vipical, see Beliching Elevations 6 A 2-2-1
  11. Utility sees. Typical.
  12. Produce sound proofing therapass bad insulation on all sales of restocort in validation.

- Provice 516\* type X drywall on both sides of walls at Mechanical Rooms
   Provice floor drain in Storage Rooms, typical
   Mount vertical track for OH door on wall above for all end units.

PHASE 2 **PERMIT SET** 



REVISIONS:

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SANTO DESIGNS

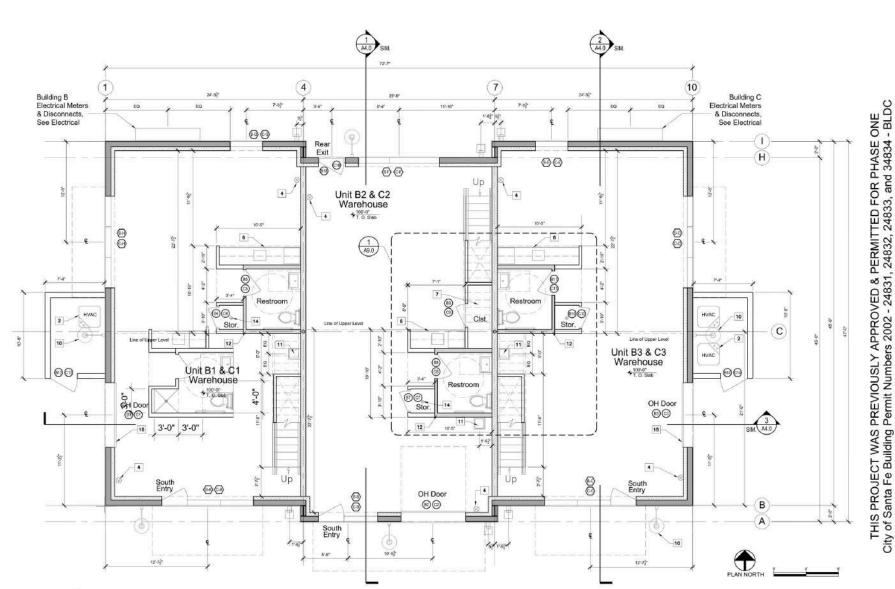
March 6, 2024

ANOVA PHASE 2

1189 Parkway Dr. Santa Fe, NM 87507

Floor Plan Bldgs. A & D Upper Level

A2.0-2



TOP OF SLAB/ FF OF 100'-0" = 6668.26 [Bidg B] and 6669.5 [Bidg C] - SEE C-101

### GENERAL NOTES:

- Provide 1 hour rated wall between units to underside of roof. Seal all penetrations.

  Building insulation per the 2018 IECC. See building wall

- sections.

  c. Dimensions are to face of framing, outside of steel or structural grid lines, as indicated.

  d. Final location of per inneter light gauge framing shall cover structural bracing, and shall be coordinated with the Architect in the field prior to installation.

FLOOR AREA OF EACH BUILDING (B&C): Total Floor Area (inside walls) - 1483 x 3 Units = 4449 sf Total Roofed Area (including canopies) = 3749 sf

HEATED CONSTRUCTION AREA OF EACH BLDG (B&C) Lower Level (including exterior walls) = 3300 sf Upper Level (including exterior walls) = 1774 sf Total Heated Construction Area = 5074 sf

## WALL TYPES

8° Z GIRT W/ MIN R-19 FIBERGLASS BATT INSULATION

3-1/2" LIGHT GAUGE METAL STUD AND 2" SPACING OFF GIRT W CONTINUOUS BLOWN FIBERGLASS INSULATION TO FILL 5-1/2" CAVITY

4" OR 6" LIGHT GAUGE METAL STUD W/ 5/6" GYP BOTH SIDES, SEE A9.0 ENLARGED PLAN

8" LICHT GAUGE METAL STUD W 5/8" TYPE X ON EACH SIDE, FIRE RATED 1 HOUR WITH "ROCKWOOL SAFE"N SOUND" 6" SOUNDPROOFING INSULATION, RESILIENT CHANNELS 16" O.C. ONE SIDE ONLY. INSTALL RESILIENT CHANNELS PER SPECIFIC MANUFACTURER'S RECOMMENDATIONS. PROVIDE FASTENERS PER MANUFACTURERS SPECS AND DO NOT ALLOW DRYWALL FASTENERS TO EXTEND PAST RESILIENT CHANNELS AND INTO

### **KEYED NOTES:**

- I. Rigid steel frame structure, typical. See Structural.

- 1. Regid steel frame structure, kyczel. See Structural.
  2. Ederico ronderses on concrete lego Al, piscel.
  3. Faed canopy overhood, see Elevations and Roof Plan.
  4. Wall mountaff the exhibiguisher, 1920 seel of downspouts. Include minimum Bix x 3ft pool for an and cobbles acredit drains at grade. Enriciosa cobbie with 4" metal landscape edging, NDS drains set in sickessik do not need inter-and cobbles acredit conveyance and 42.7 Roofsphare.
  5. Kithannenda by name, Provide hook-ups fet serk, holge and minimum Structure.
  6. Kithannenda by name, Provide hook-ups fet serk, holge and minimum services were conveyance and fet in the service with the service was a service of the service with the service was serviced and serviced was serviced was serviced and serviced was serviced w
- 7. One hour fire falled usable enclosure under Star; provide StS\* (type X drywall both socies.
  8. Water heater location, 20 gallon tank heater to be installed in upstains mechanical closests. See Mechanical Plumbing drawing for specs.
  9. Star; see A6.0
  10. Wall innounced light future, typical, see Building Elevations 8. A2.2-1
  11. Didly enk, typical.
  12. Provide sounder providing theorytess bett insulation on all sides of restroom
  13. Provide StS\* type X drywall on both side or fusile at Mechanical Rooms
  14. Provide for craim in Storage Rooms, typical
  15. Mount vertical track for CH door on wall above for all end units.

PHASE 2 **PERMIT SET** 



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March 6, 2024

ANOVA PHASE 2

1189 Parkway Dr. Santa Fe, NM 87507

Floor Plan Bldgs. B & C

A2.0-3

Lower Level

EXIT TRAVEL DISTANCE KEY PLAN scale: 1/16" = 1'-0"

A2.0-3,

SCALE: 1/4" = 1'-0"

Floor Remarks Pantos Dowell

Finish Schedule - Buildings B & C

FLOOR PLAN BUILDINGS B & C - Lower Level Warehouse

Room

Warehouse

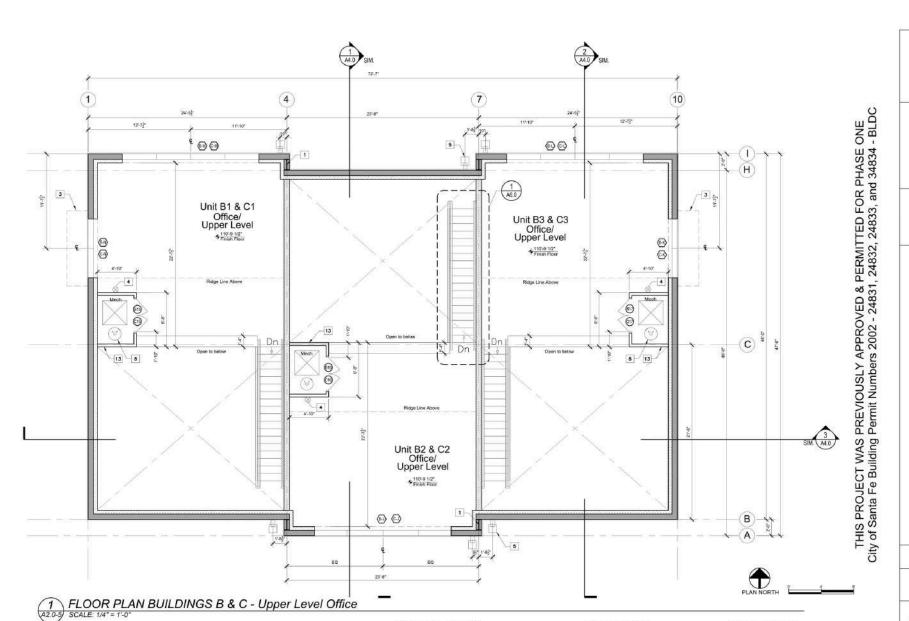
Upper Level Office

Mechanical

Room

\* Provide min 5/8\* gypsum drywal

See Sheet 5-3 "Structural Details and Sections" for light gauge metal framing specs



# Path of Egress

EXIT TRAVEL DISTANCE KEY PLAN scale: 1/16" = 1'-0"

Finish Schedule - Buildings B & C						
Room	Floor	Base	Walls*	Ceiling*	Height	Remarks
Lower Level Warehouse	Standard Skey Controls of convolp Service	New	Ported Drynal	Portract Crywall Unchr Upon Lavet, Floreset Bracture for Remaining	Verse, San Sertions	Equival Calling is Unpervious
Toilet Roam	Standard Gray Concests of converts Selater	e' may Cove Serv. Cole 180	Parties Change & Pitte Well-scot sett Schools Title	Patent Drynal	(84%)	See Sheet AO.C. Enlarged Heatment Ratio
Upper Level Office	Voy17644	tene	Percent Strong	Exposed Structure and Insulation Liner System.	Verye, see Sections	Enganesi Carling is Linyan no
Mechanical Room	Shadood Congres Panel Subbox	New	Drynal Fun and Mul	Capaciel Etunive and healthire Low System.	Names, see Sections	Expressi Carling is Unperson

GENERAL NOTES:

Provide 1 hour rated wall between units to underside of roof. Seal at penetrations.
 Building insulation per the 2018 IECC. See building wall sections.

sections.

Omensions are to face of framing, outside of steel or structural grid lines, as indicated.

Final location of perimeter light gauge framing shall cover structural foreing, and shall be coordinated with the Architect in the field prior to installation.

FLOOR AREA OF EACH BUILDING (B&C): Total Floor Area (inside walls) - 1483 x 3 Units = 4449 sf Total Roofed Area (including canopies) = 3749 sf

HEATED CONSTRUCTION AREA OF EACH BLDG (B&C) Lower Level (including exterior walls) = 3300 sf Upper Level (including exterior walls) = 1774 sf Total Heated Construction Area = 5074 sf

### WALL TYPES

3-1/2" LIGHT GAUGE METAL STUD AND Z' SPACING OFF GIRT W/ CONTINUOUS BLOWN FIBERGLASS INSULATION TO FILL 5.1/2" CAVITY

8° SPLIT FACED CMU WITH SOLID 2° CAP BLOCK, SEE CIVIL

4" OR 6" LIGHT GAUGE METAL STUD W 5/8" GYP BOTH SIDES, SEE AGO ENLARGED PLAN

B\*LIGHT GAUGE METAL STUD WI 56\* TYPE X ON EACH SIDE.
FIRE RATED 1 HOUR WITH "FROCKWOOL SAFE IN SOUND!" 6\* OC.
ONS SIDE ONLY. INSTALL RESULENT CHANNELS 16\* OC.
ONS SIDE ONLY. INSTALL RESULENT CHANNELS 16\* OC.
ONE SIDE ONLY. INSTALL RESULENT CHANNELS 16\* OC.
MANUFACTURETS RECOMMENDATIONS. PROVIDE FASTEMENS
FREI INSURFACTURETS SPECA AND DO NOT ALLOY DRYWAY.
PASTEMENS TO EXTEND PAST RESILENT CHANNELS AND INTO
STUDS.

See Sheet S-3 "Structural Details and Sections" for light gauge metal framing specs

### **KEYED NOTES:**

drywal both sides.

8. Water heater location. 20 gallon tank heater to be installed in upstains mechanical closets. See Mechanical / Planting drawings for specs.

9. Stair, see A6.0

Viall mounted light fature, typical, see Building Elevations & A2.2-1

Hilly sink, typical.
 Provide sound proofing fiberglass batt insulation on all sides of restroor

Thomas sound prototing hisegiasis batt insulation on all scoss of restracting with earthy.
 Thomas 50° type X drywall on both sides of wells at Mechanical Rooms
 The Provide Both or thain in Storage Rooms; typical
 Mount vertical track for OH door on well above for all end units.

PHASE 2 **PERMIT SET** 



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March 6, 2024

ANOVA PHASE 2

1189 Parkway Dr. Santa Fe, NM 87507

Floor Plan Bldgs. B & C Upper Level

A2.0-4



March 6, 2024 ANOVA PHASE 2

**Buildings** 

**B&C** 


A3.1

PHASE 2

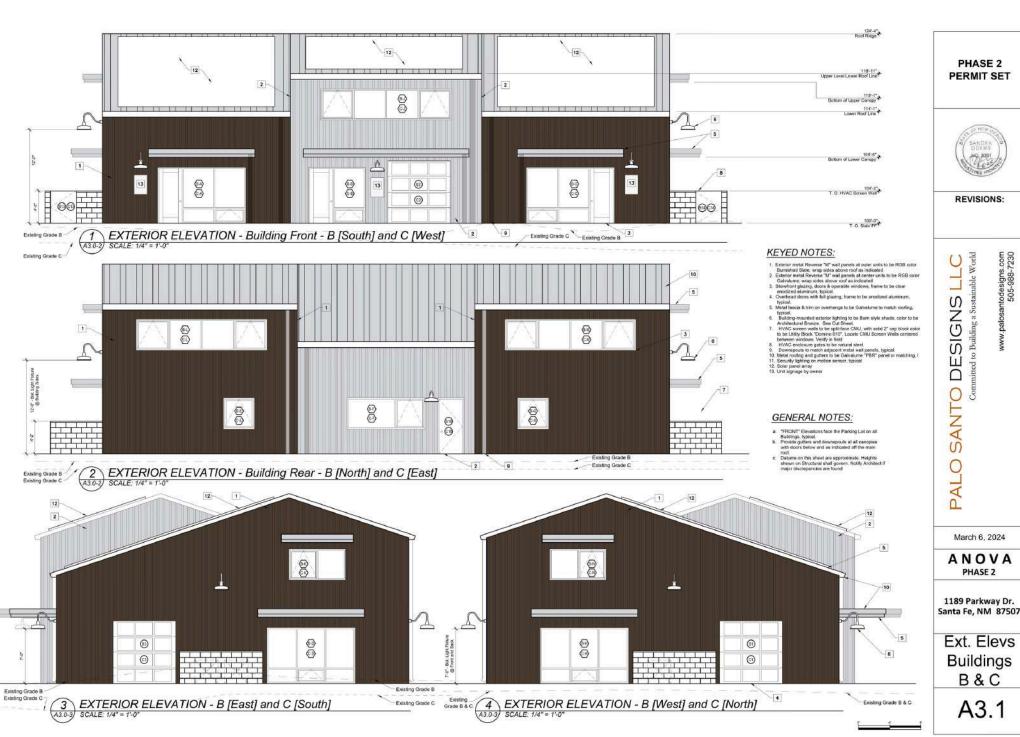**PERMIT SET** 

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Owner/Broker
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