

SIDIS NT.

A-1



FINAL LOCATION OF ALL INTERIOR PARTITIONS TO BE DETERMINED AT SITE.

ALL EXTERIOR DECKS, STEPS, RAILS AND SUPPORTS SHOULD MEET STATE AND LOCAL CODES


LOCATION AND ENGINEERING OF ANY RETAINING WALLS IS BY OTHERS (B.O.)

ANY CONSTRUCTION BY OTHERS NOTED AS TO BE VERIFIED (T.B.V.), IS TO BE VERIFIED FOR ACCURACY BY THE OWNER AND/OR BUILDER.

THE STAIR RISER AND TREAD DIMENSIONS ARE CALCULATED FROM THE TOP OF THE 1ST FLR DECK TO THE TOP OF THE SECOND FLOOR DECK. BUILDER TO ADJUST FOR FLOOR FINISHES AS NEEDED.

FIREPLACE AND/OR WOODSTOVE INSTALLATION IS TO COMPLY WITH ALL LOCAL, STATE AND NATIONAL FIRE SAFETY CODES AND REGULATIONS.

ALL DOORS, WALLS AND CEILINGS BETWEEN
THE GARAGE AND LIVING SPACES ARE TO MEET
ALL FIRE AND SAFETY CODE REGULATIONS.

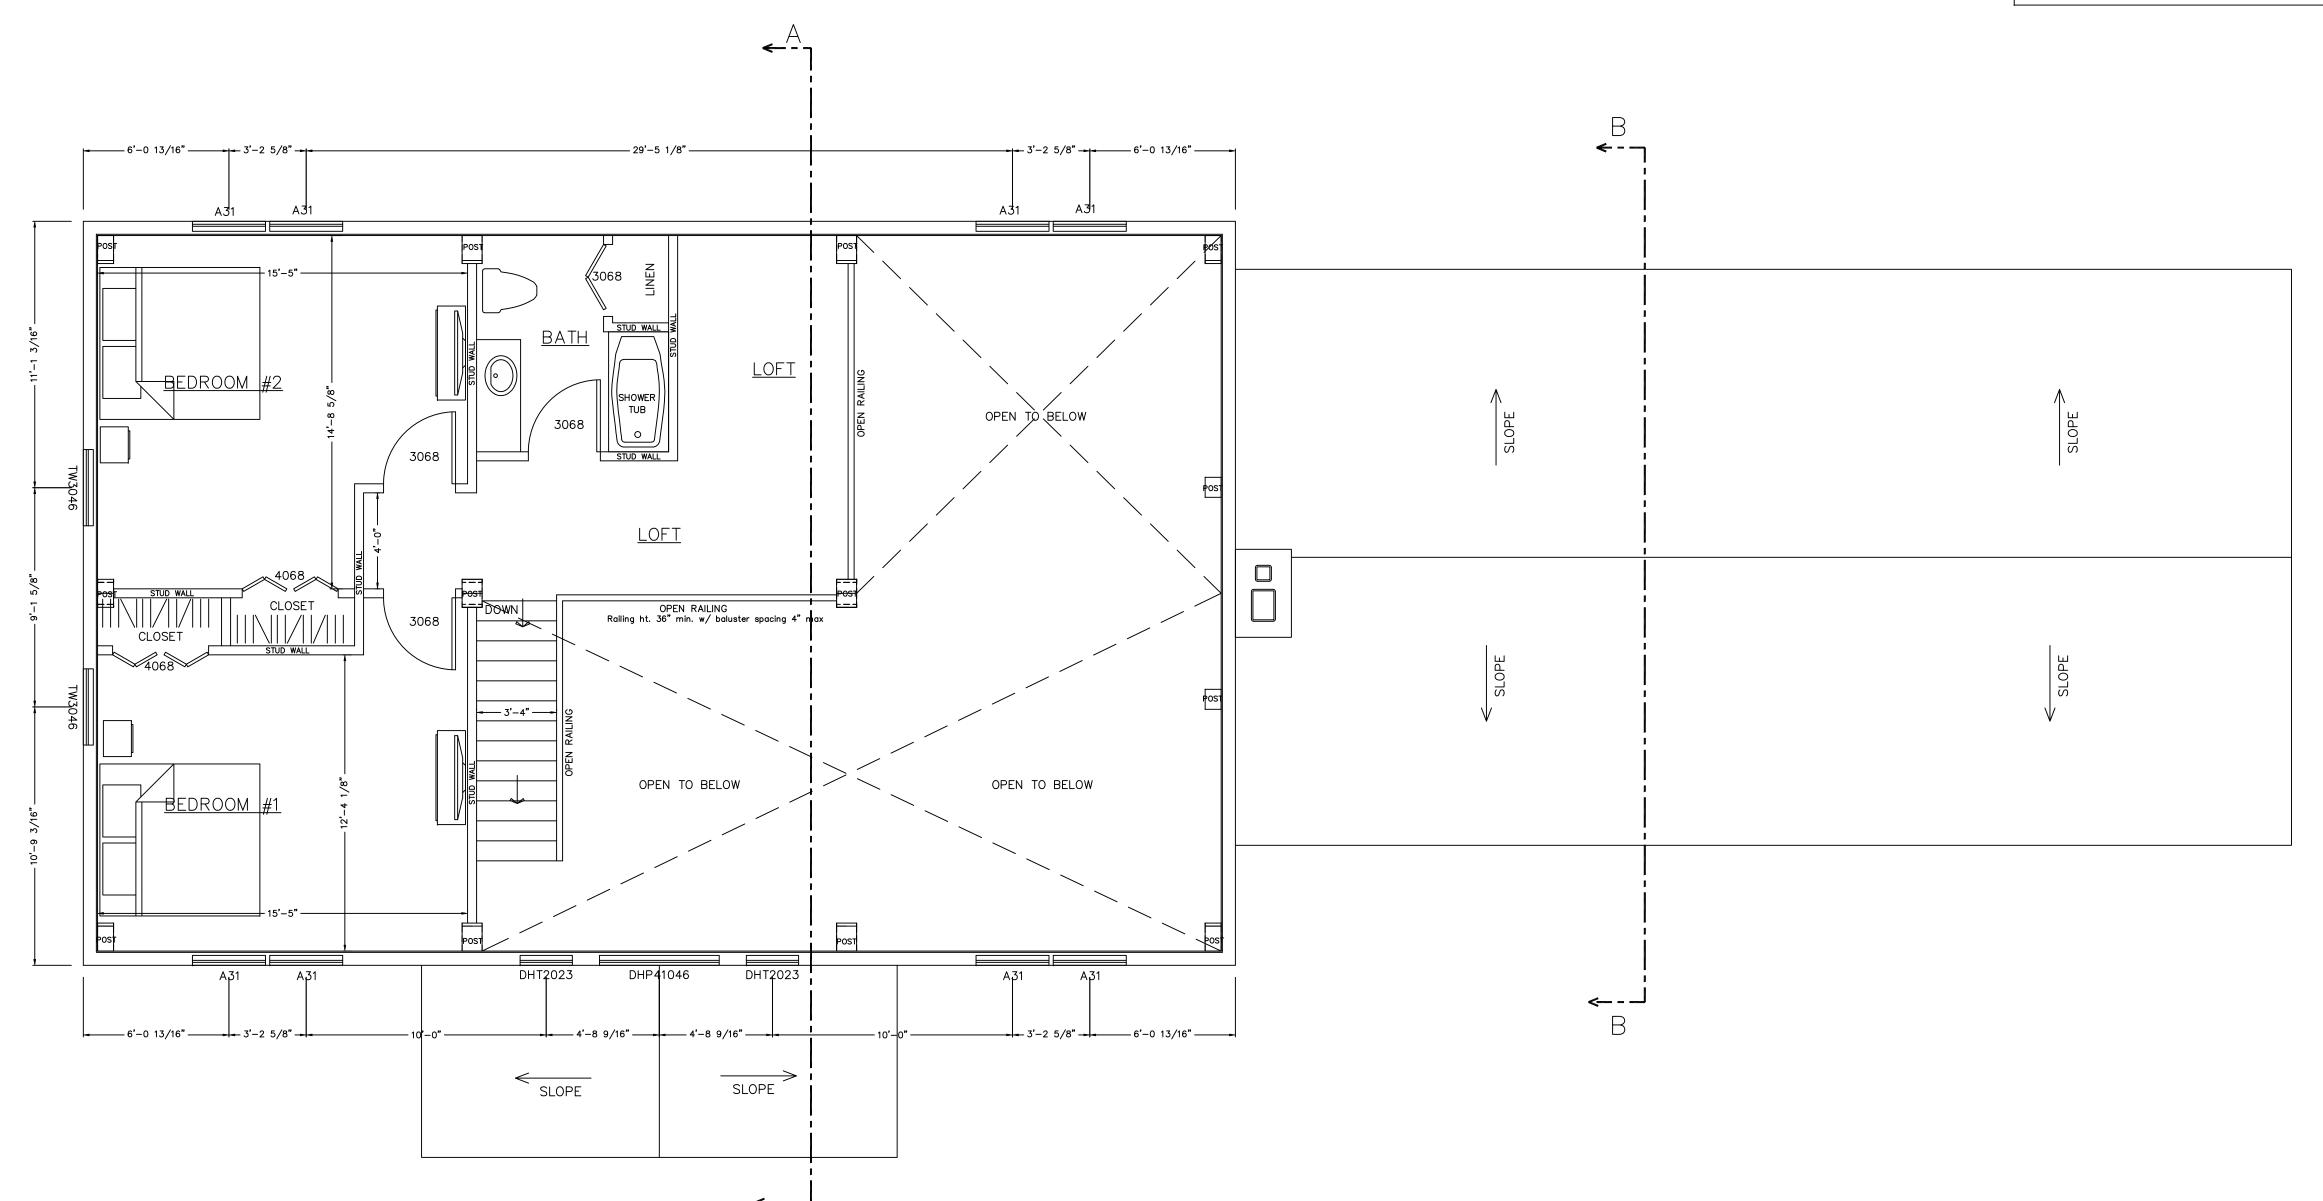

SECOND FLOOR PLAN PROJECT
NORTH

NOTE:

DIMENSIONS TO BE CONFIRMED BY GENERAL

CONTRACTOR BEFORE CONSTRUCTION BEGINS.

PRIOR TO CONSTRUCTION OF TIMBER FRAME, ALL 1st FLOOR FRAMING MUST BE IN PLACE AND LEVEL

SOLID BLOCKING REQ'D UNDER ALL TIMBER POSTS: BLOCKING TO BE VERTICAL GRAIN TO MINIMIZE COMPRESSION

HARDWIRE SMOKE DETECTORS (W/ BATTERY B.U.) EACH FLOOR

COPYRIGHT LAWS PROHIBIT REPRODUCTION OR USE OF THIS DRAWING, IN WHOLE OR IN PART, WITHOUT THE EXPRESSED WRITTEN PERMISSION OF DW TIMBER FRAME DESIGN

E: 1/4" = 1'40"

DATE: NUMBER & DISCRIPTION

3/9/15

N BY: DEW

KED BY:

2/18/16

REVISION

10/8/15

2/18/16

DRAWN BY: DEW
CHECKED BY:


WKINS RESIDENCE NCHBURG, TN

JB NAME:

RAME DESIGN ANEL HOME DESIGN

A-2

DO NOT SCALE DIMENSIONS ON THESE DRAWINGS. THESE IMAGES ARE MACHINE REPRODUCTIONS AND MAY CONTAIN A MARGIN OF ERROR.

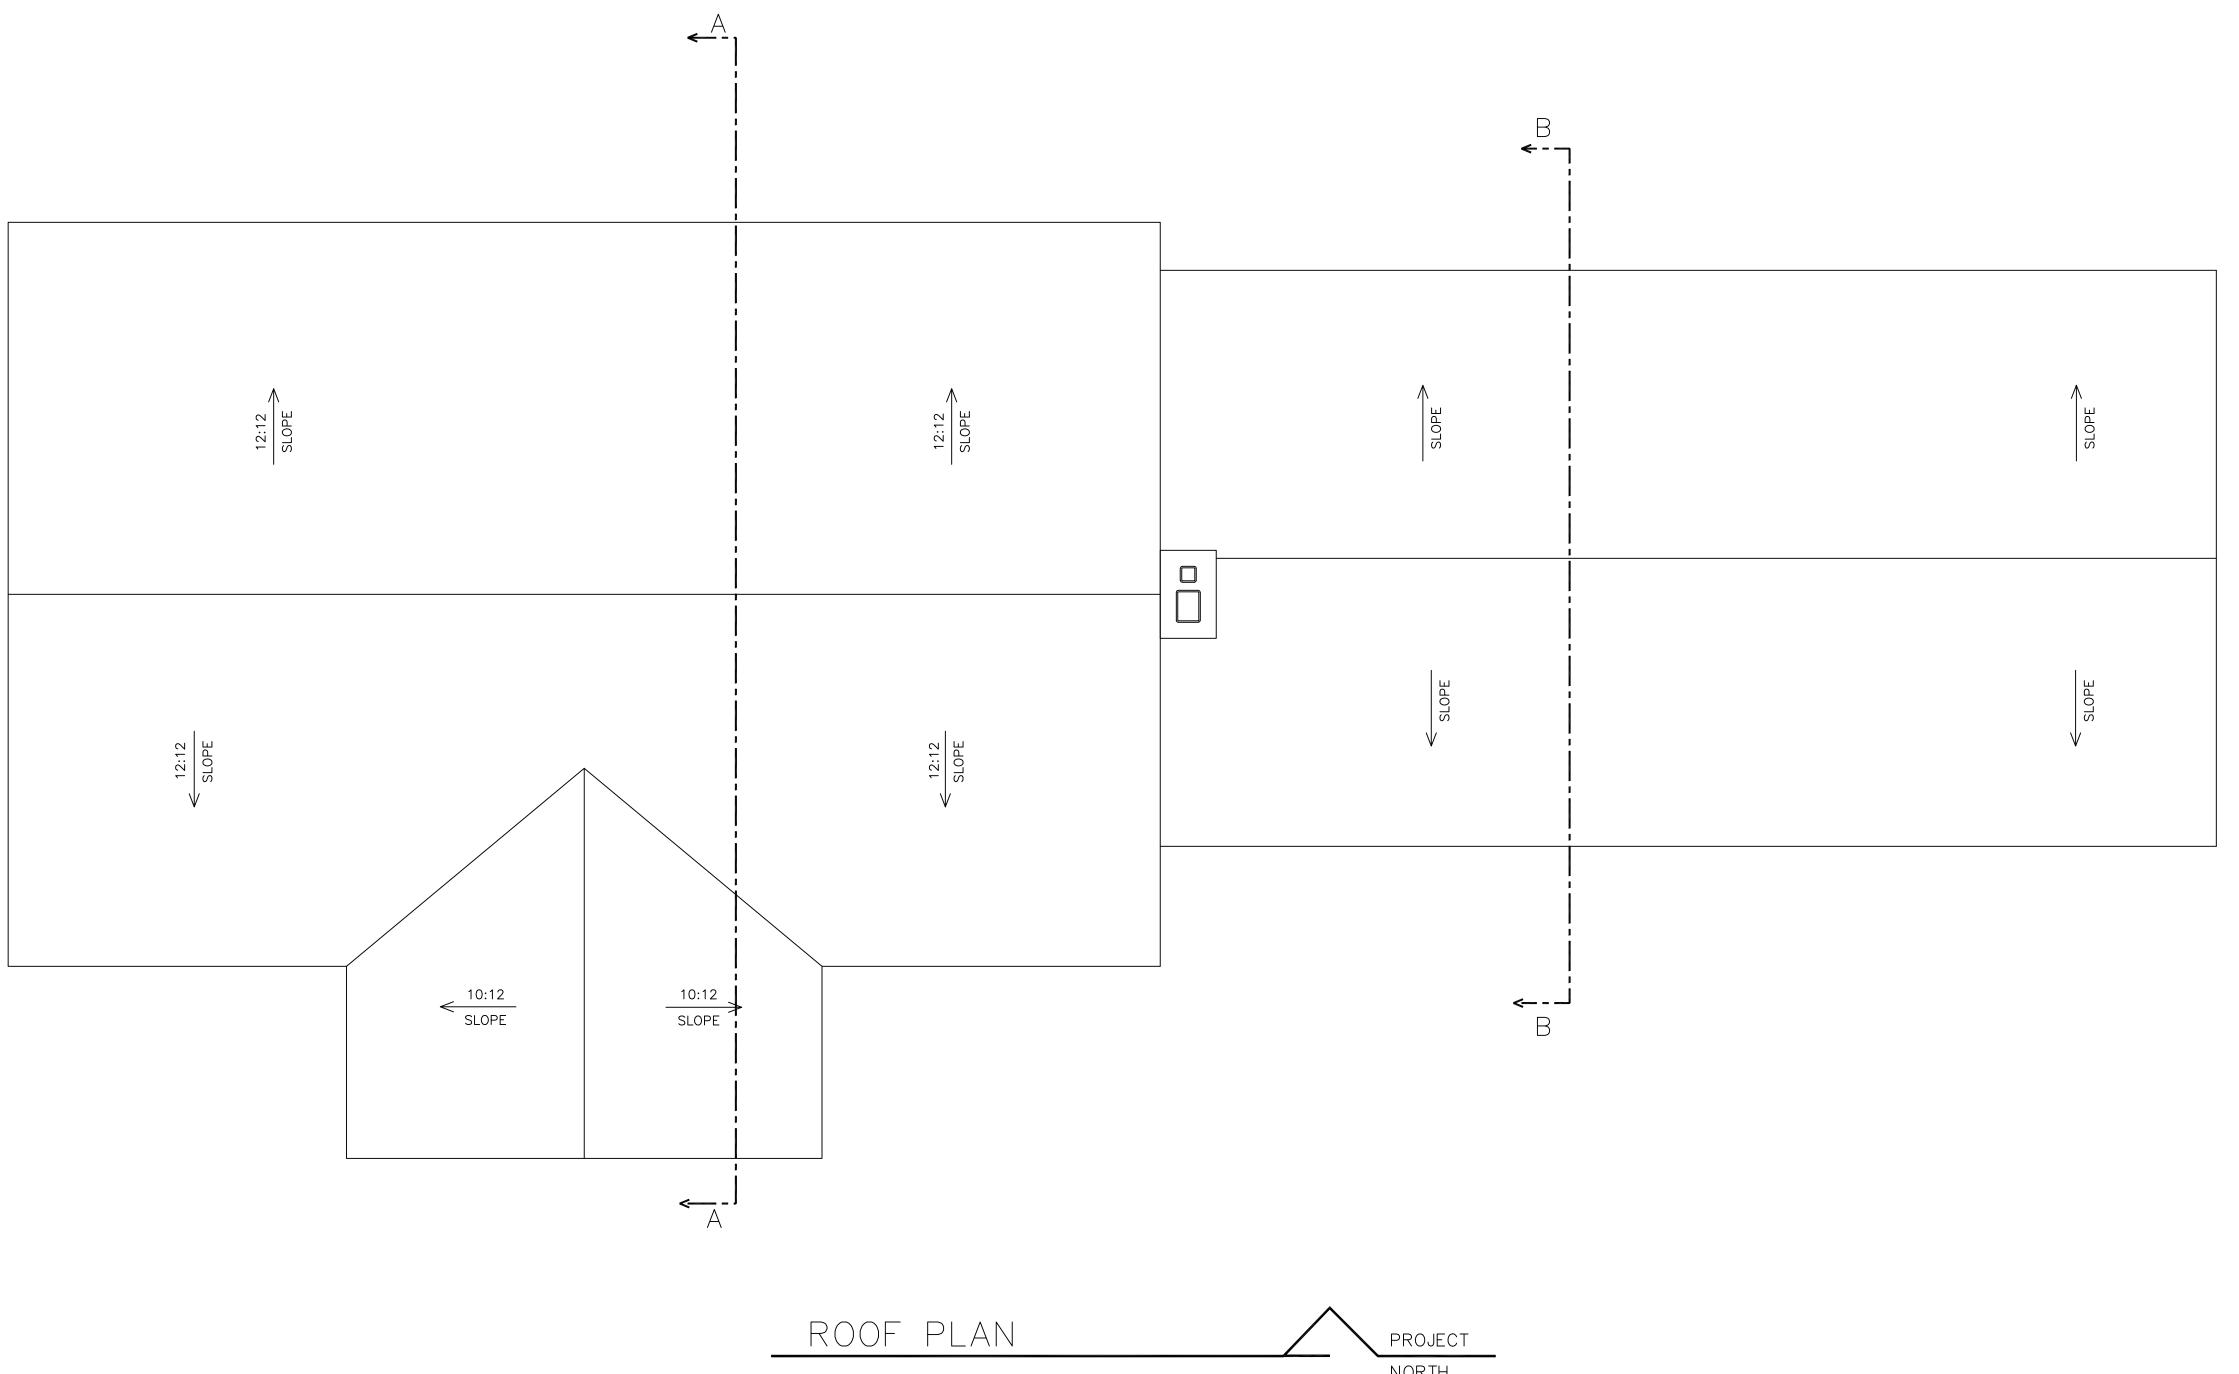

HAWKINS RESIDENC

A-3



SOUTH ELEVATION

COPYRIGHT LAWS PROHIBIT REPRODUCTION OR USE OF THIS DRAWING, IN WHOLE OR IN PART, WITHOUT THE EXPRESSED WRITTEN PERMISSION OF DW TIMBER FRAME DESIGN


SCALE: 1/4" = 1'-0"		REVISIONS
DATE: 3/11/15	DATE:	DATE: NUMBER & DISCRIPTION
617117	10/8/15	
DRAWN BY:	2/18/16	
7		
CHECKED BY:		

HAWKINS RESIDENCE LYNCHBURG, TN

DW TIMBER FRAME DESIGN TIMBER FRAME & PANEL HOME DES

A-4

DO NOT SCALE DIMENSIONS ON THESE DRAWINGS. THESE IMAGES ARE MACHINE REPRODUCTIONS AND MAY CONTAIN A MARGIN OF ERROR.

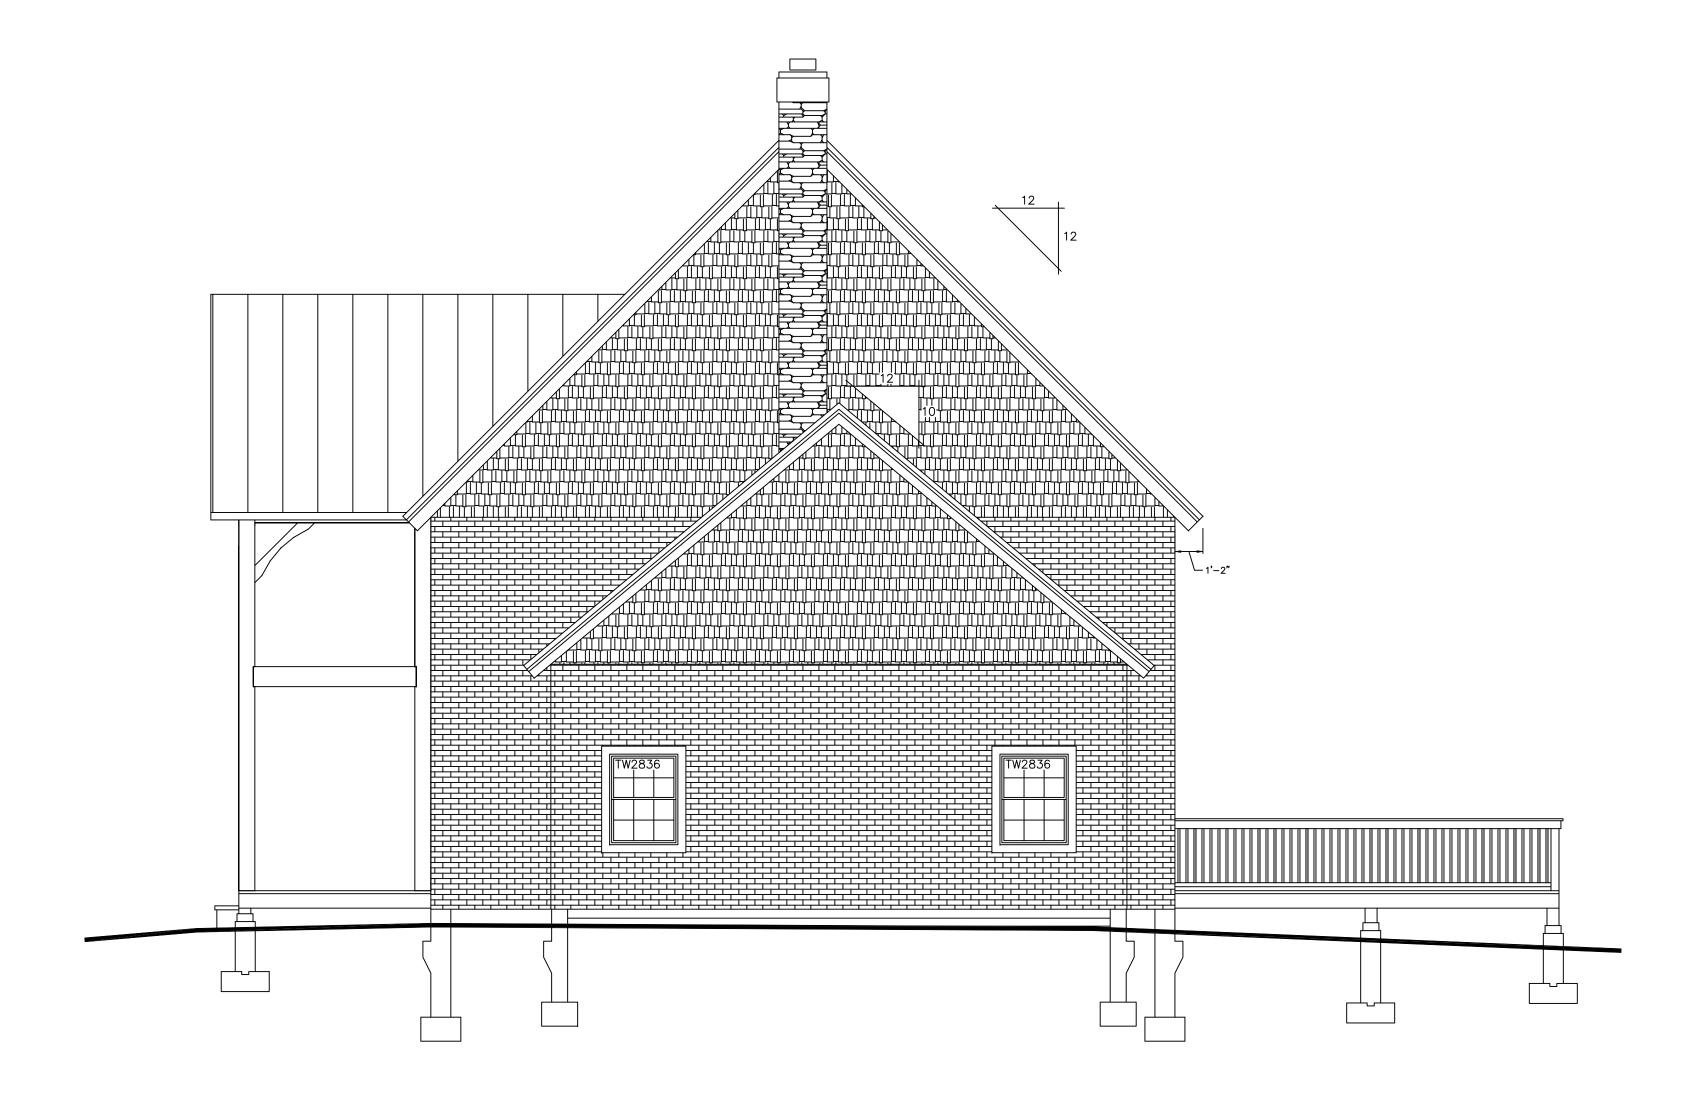

EAST ELEVATION

E: 1/4" = 1'.O"

DATE: NUMBER & DISCRIPTION

10/8/15

N BY: DEW

KED BY:

WKINS RESIDENCE VCHBURG, TN


В NAME:

NAN MON

W TIMBER FRAME DESIGNER FRAME & PANEL HOME DESIGNER FRAMEDESIGN.NET

DO NOT SCALE DIMENSIONS ON THESE DRAWINGS. THESE IMAGES ARE MACHINE REPRODUCTIONS AND MAY CONTAIN A MARGIN OF ERROR.

COPYRIGHT LAWS PROHIBIT REPRODUCTION OR USE OF THIS DRAWING, IN WHOLE OR IN PART, WITHOUT THE EXPRESSED WRITTEN PERMISSION OF DW TIMBER FRAME DESIGN

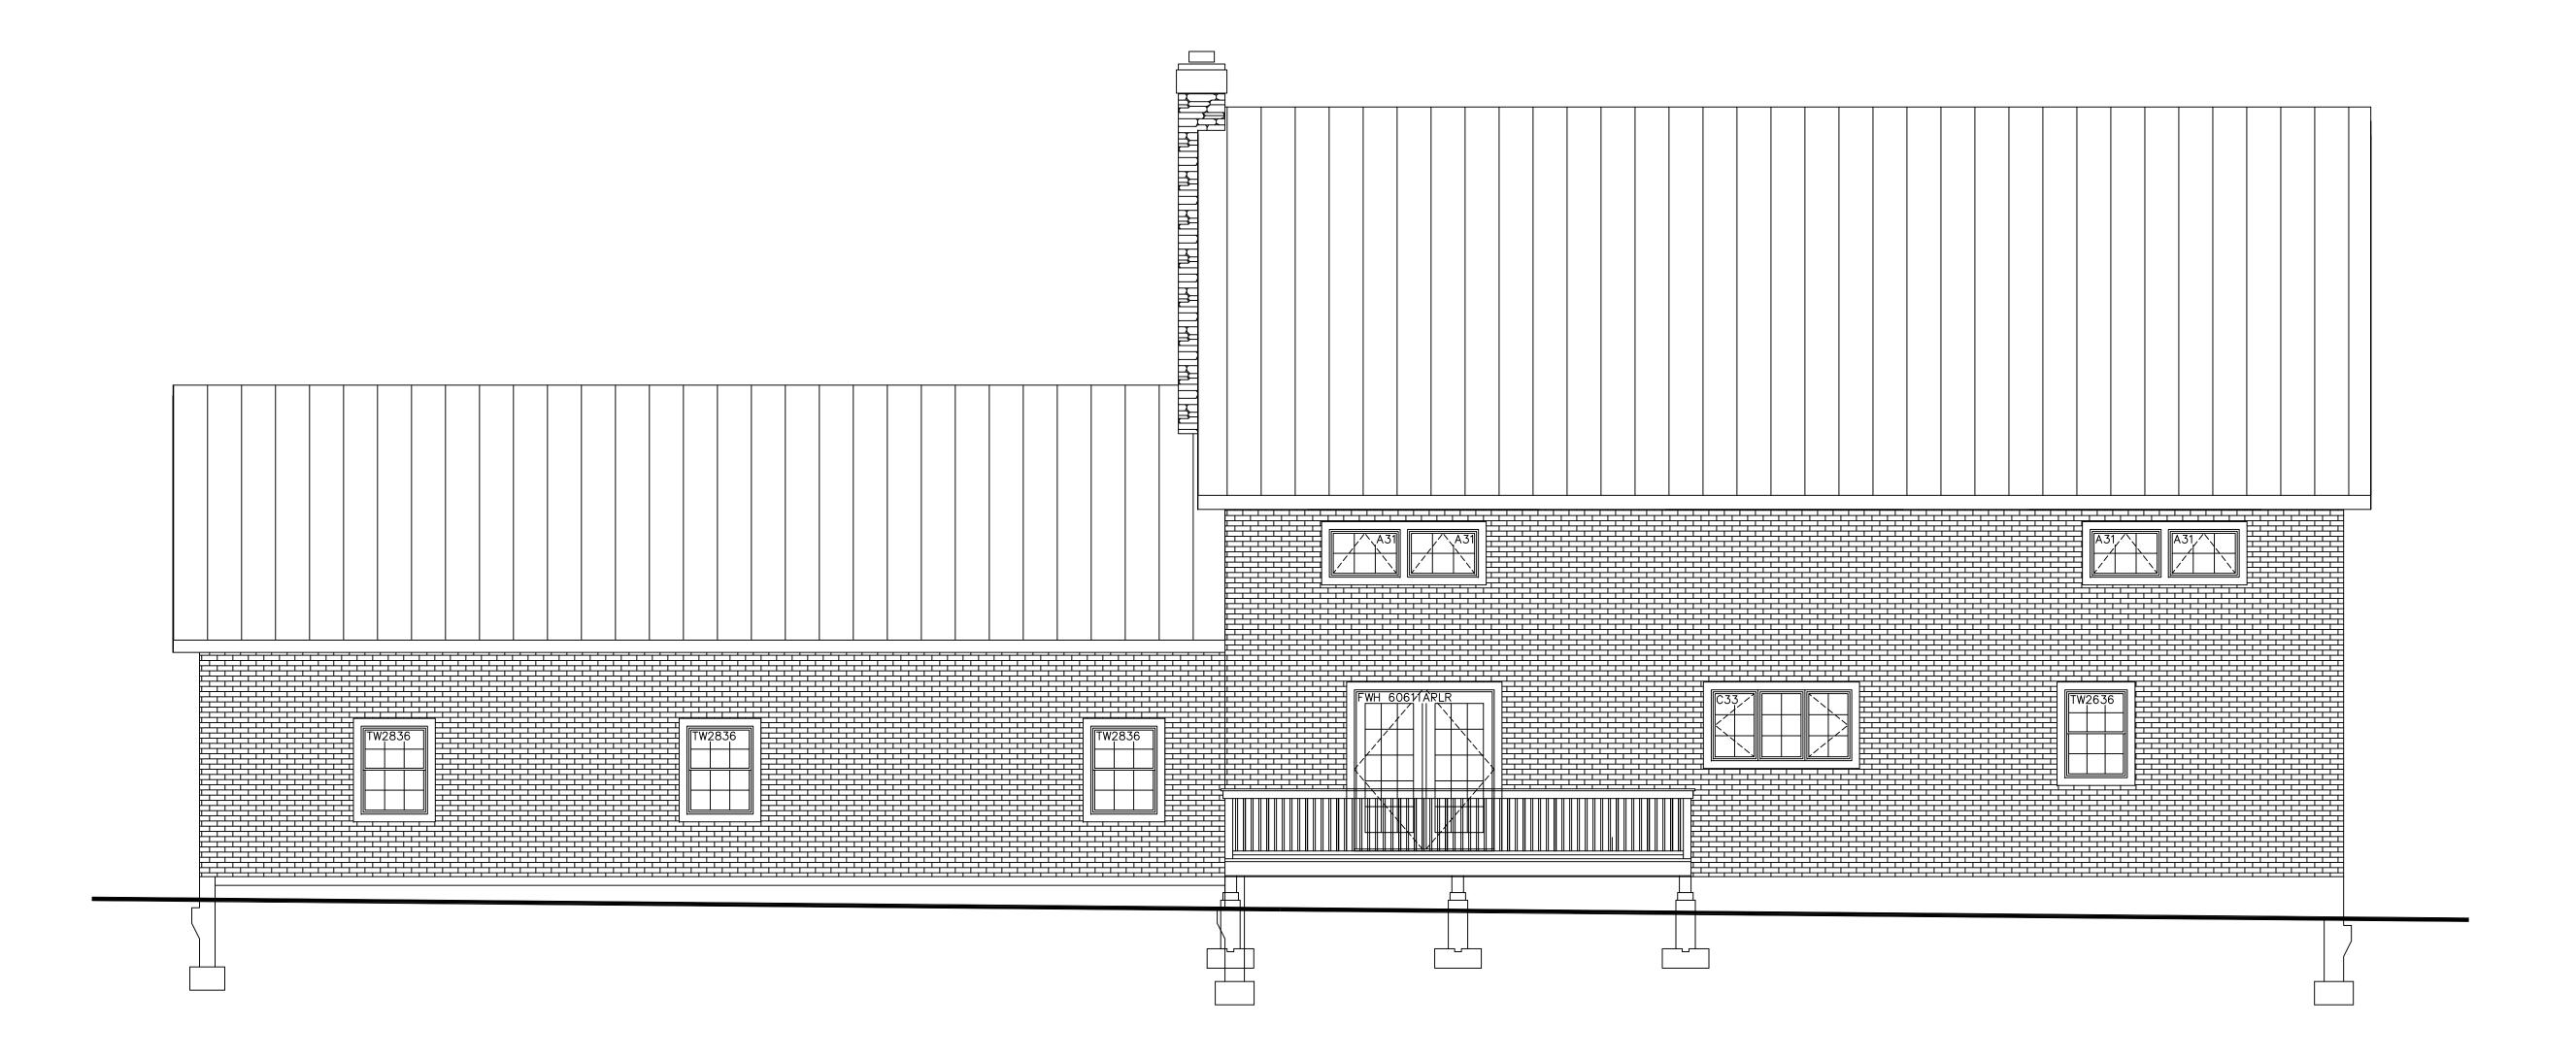


NORTH ELEVATION

174" = 1.0"	
DATE: 2/11/15	DATE
21 71 73	10/8/
DRAWN BY:	2/18/
DEW	
CHECKED BY:	

DW TIMBER FRAME DESIGN BER FRAME & PANEL HOME DESIGN

A-6

DO NOT SCALE DIMENSIONS ON THESE DRAWINGS. THESE IMAGES ARE MACHINE REPRODUCTIONS AND MAY CONTAIN A MARGIN OF ERROR.

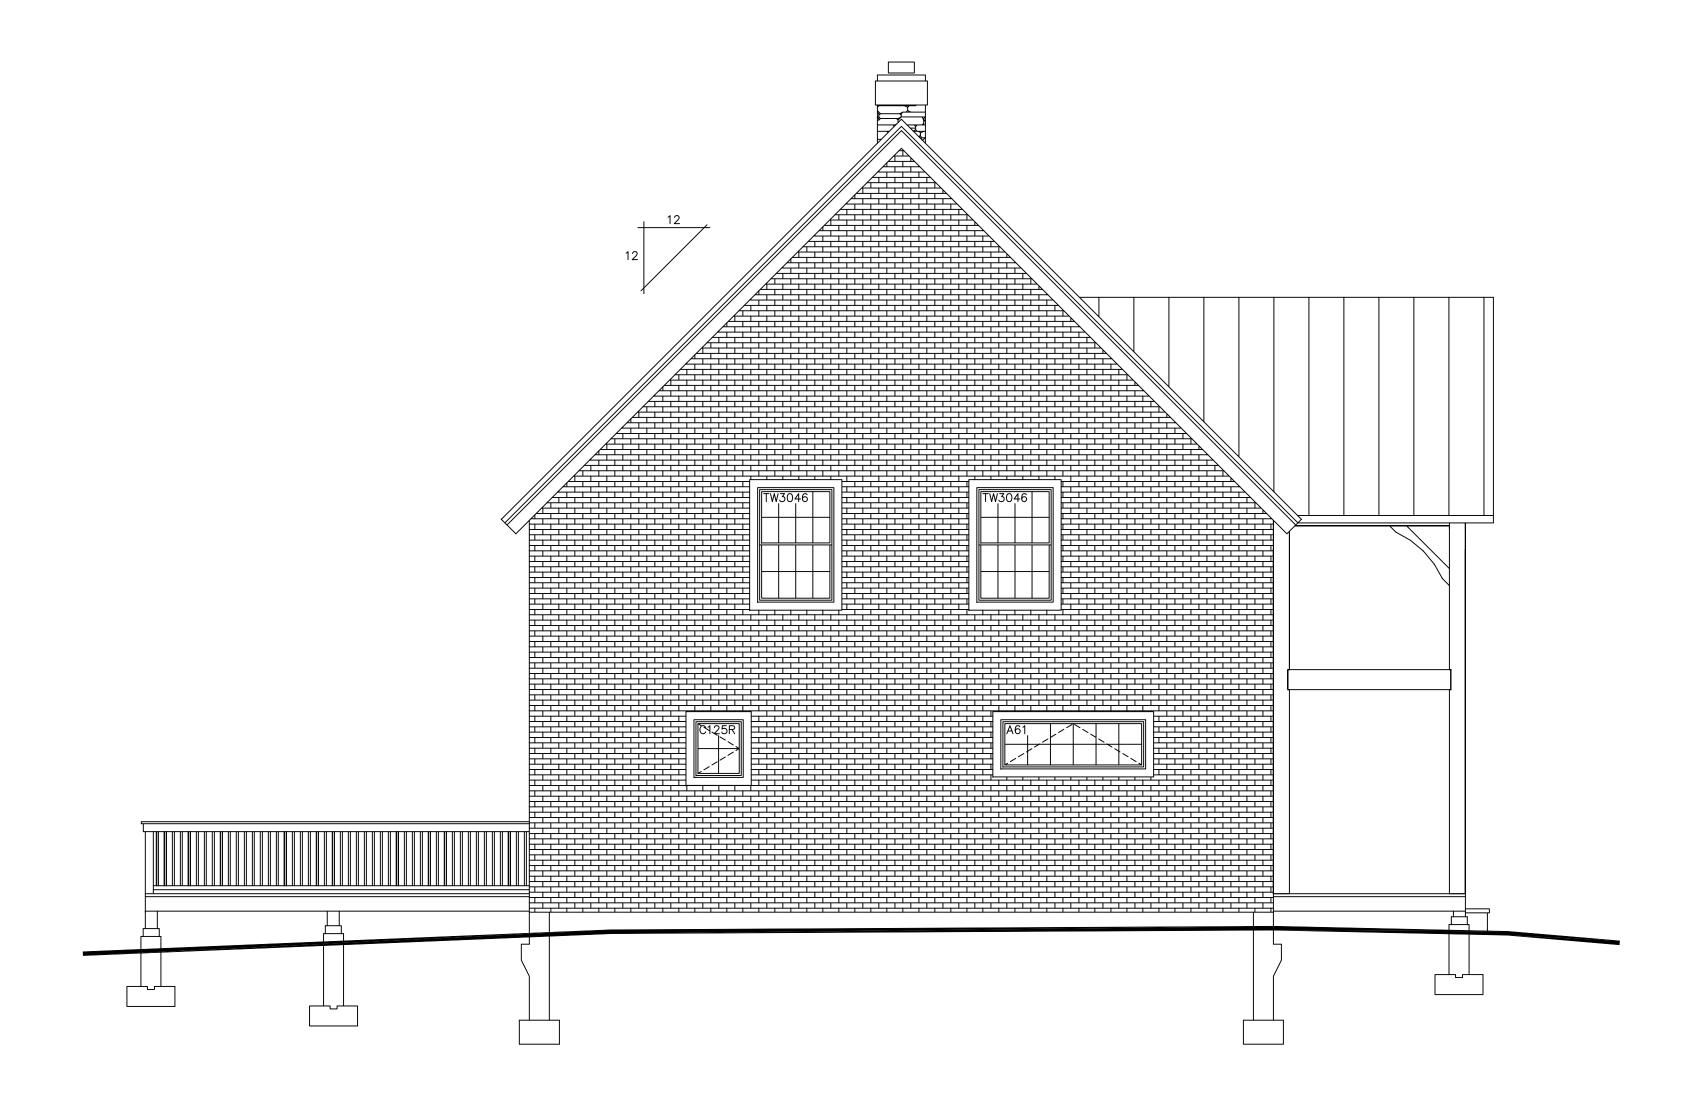

WEST ELEVATION

DATE: 2/11/15
DRAWN BY: DEW
CHECKED BY:

HAWKINS RESIDENC LYNCHBURG, TN

A-7



- 1. ALL FOUNDATION FOOTING CONCRETE TO BE 3000 PSI DESIGN MIX.
- 2. ALL FOUNDATION WALL CONCRETE TO
- BE 3000 PSI, MIN.

 3. ALL FLOOR SLAB TO BE 3500 PSI
- DESIGN MIX. WET CURE 7 DAYS.

 4. CONCRETE SLAB TO BE 4" THICK
- W/ 6x6x#10 W.W.F.5. CONCRETE SLAB TO HAVE CONTROL
- 6. MINIMUM SOIL BEARING CAPACITY OF
- 2000 PSF.

 8. STEEL BARS TO BE GRADE 60.
- 9. CONCRETE TO BE PLACED WITH A
- SLUMP NOT TO EXCEED 5".

 10. LAP SPLICES IN STEEL TO BE 30
 BAR DIAMETER.
- 11. ALL STEEL REINFORCING SPECIFICATIONS
 TO BE REVIEWED AND APPROVED BY LOCAL
 ENGINEER & MUST MEET ALL APPLICABLE CODES.
- 12. CONCRETE WORK SHALL CONFORM
 TO ALL REQUIREMENTS OF ACI 301
 "SPECIFICATIONS FOR STRUCTURAL
- CONCRETE FOR BUILDINGS".

 13. ALL FOOTINGS TO BEAR ON UNDISTURBED SOIL BELOW FROST LINE.
- 14. ALL FOOTING SIZES AND CONC. SPEC.'S SHALL BE VERIFIED BY LOCAL ENGINEER.

SOILS NOTES:

- 1. PLACE FOOTINGS ON UNDISTURBED
- 2. BACK FILL SHALL BE PLACED IN
 12" LOOSE LIFTS AND COMPACTED TO
 95% ASTM DD 1557 INSIDE BUILDING
- AND 90% OUTSIDE.

 3. BACK FILL SHALL BE PLACED
 SIMULTANEOUSLY ON EACH SIDE
 OF THE WALL.

GENERAL NOTES:


- DOOR AND WINDOW OPENINGS
 PER OWNER
- 2. G.C. IS RESPONSIBLE TO MAKE
 ALL WINDOW WELLS MEET LOCAL
 & APPLICABLE CODES

LEGEND:

T.O.F. = TOP OF FOOTING T.O.S. = TOP OF SLAB T.O.W. = TOP OF WALL T.B.V. = TO BE VERIFIED

T.B.D. = TO BE DETERMINED

OUTLINE OF TIMBER POST ABOVE
OUTLINE OF TIMBER POST ABOVE
OUTLINE OF TIMBER POST ABOVE

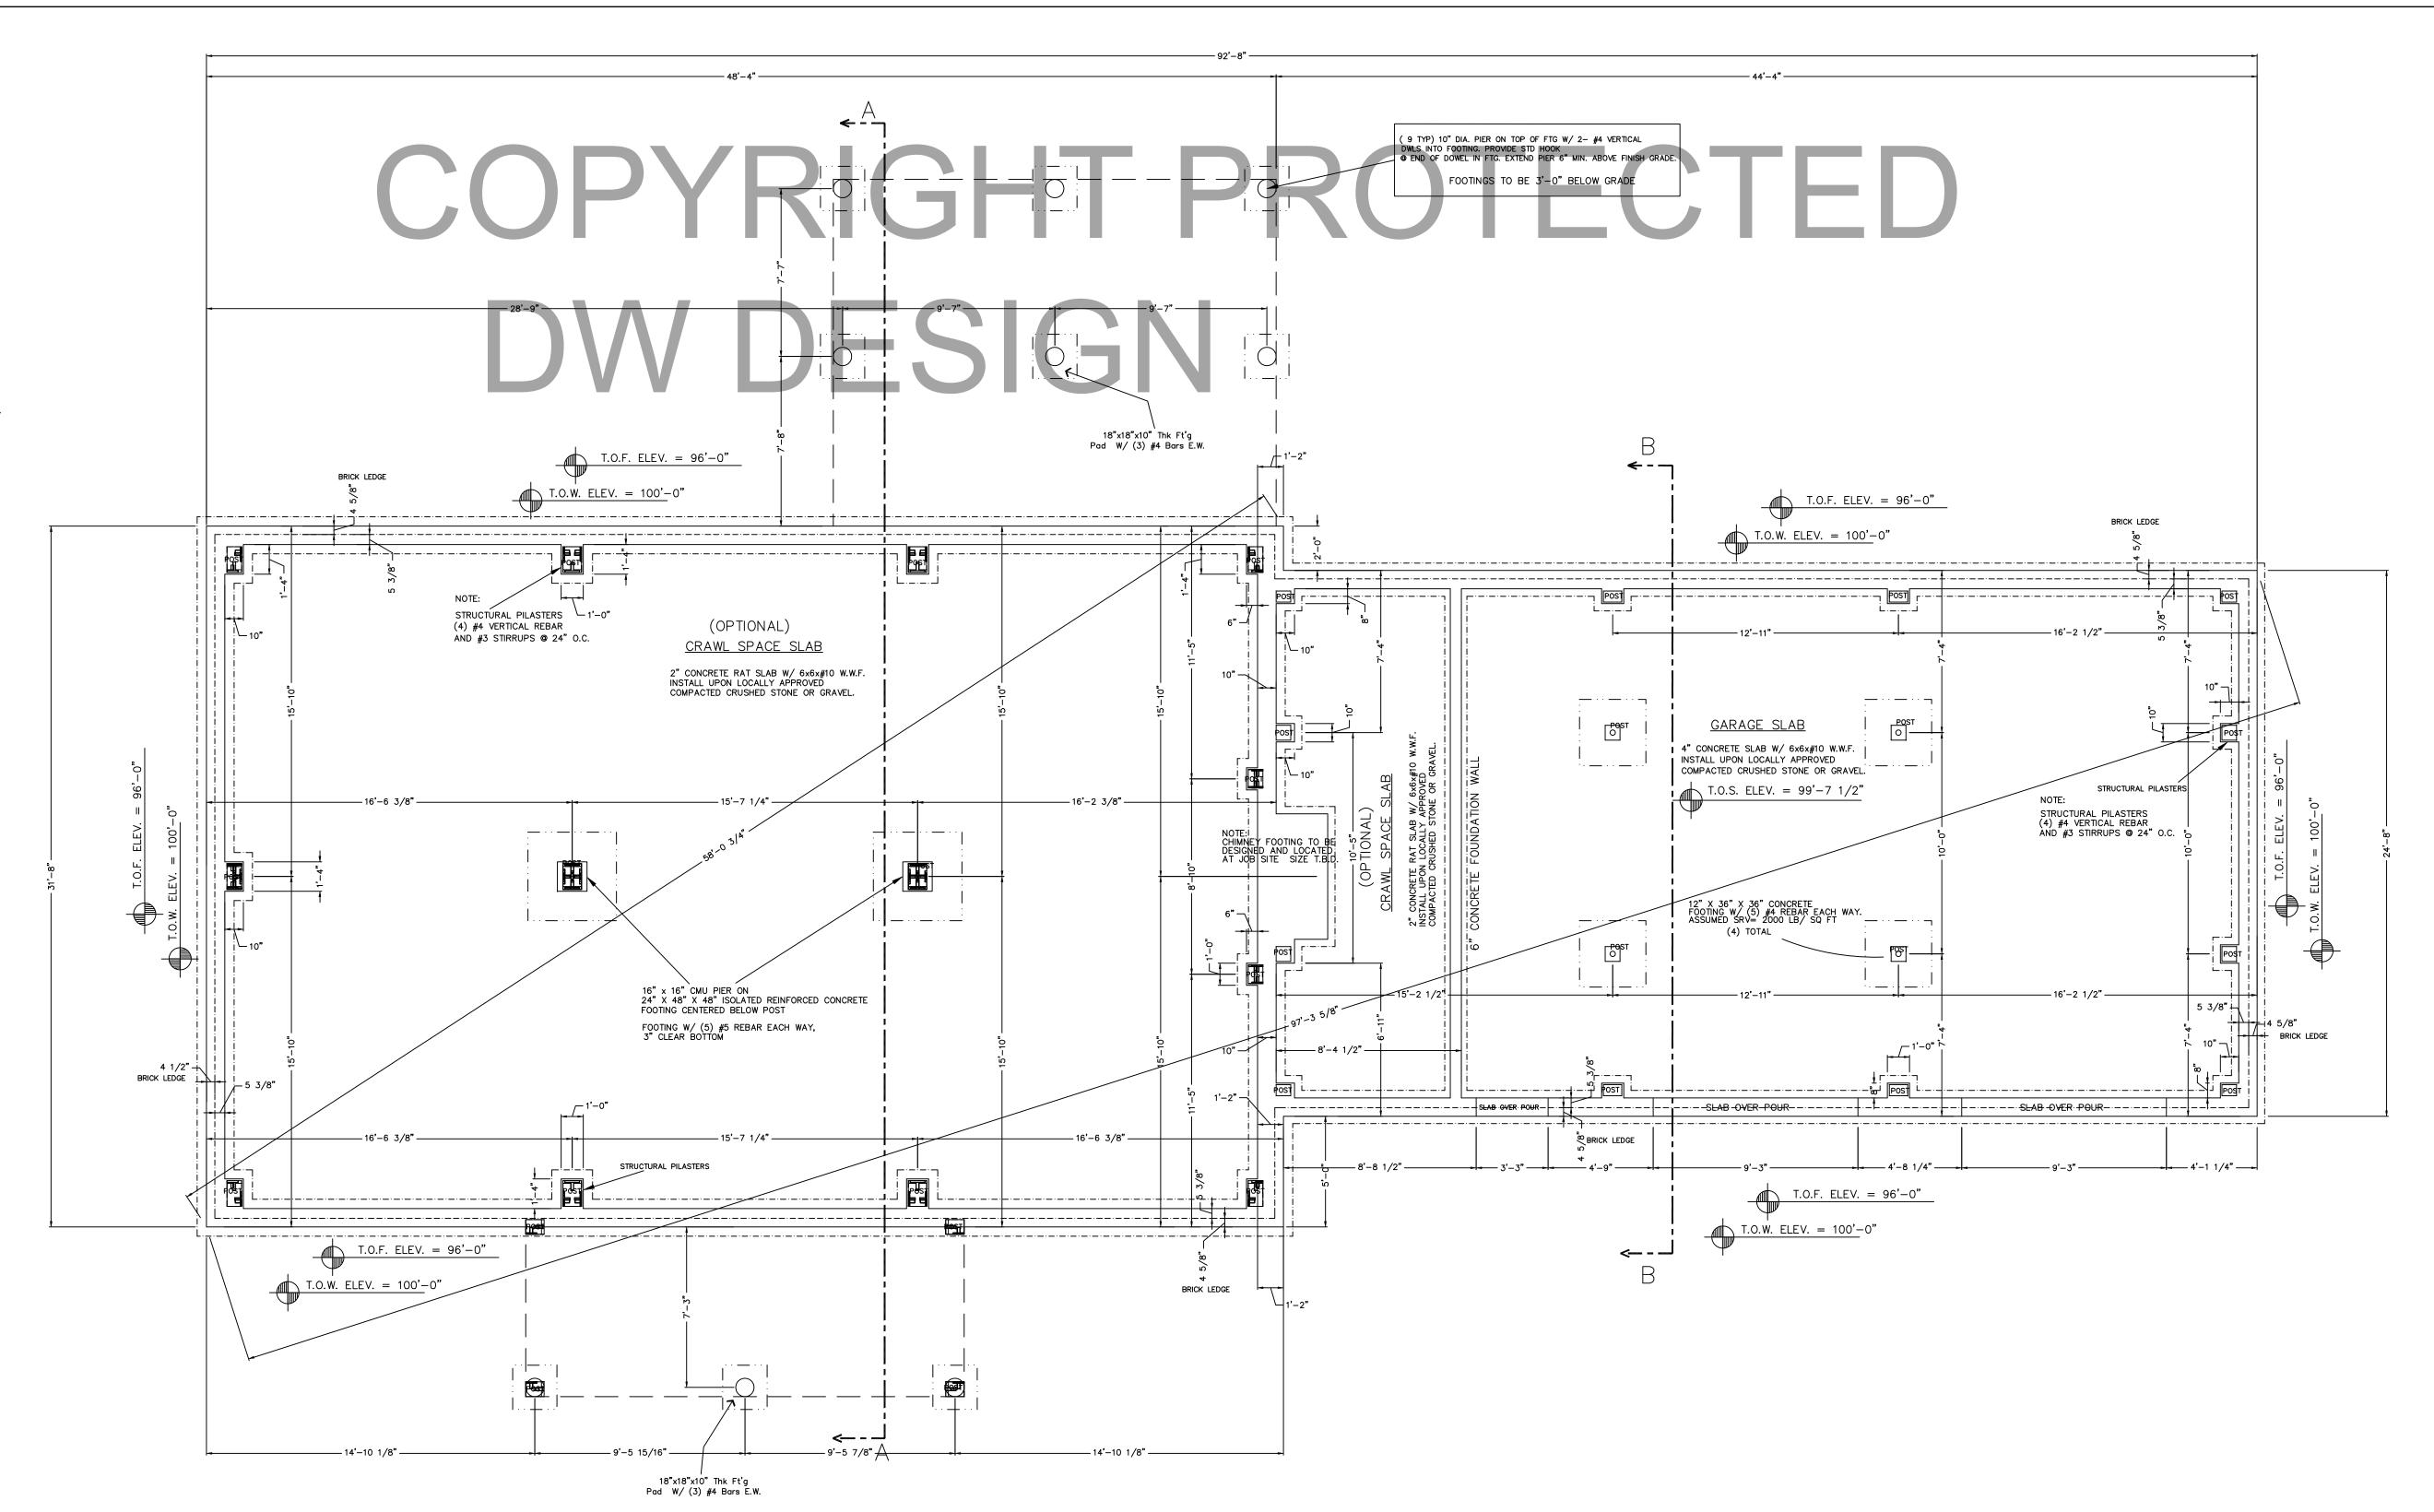

FOUNDATION PLAN

PROJECT

10" CONCRETE FOUNDATION WALL ON AN 12" x 20" CONTINUOUS CONCRETE FOOTING. FOOTING TO BE BELOW FROST LINE AND BE REINFORCED AS REQUIRED.

NOTE:
ALL FOUNDATION ELEVATIONS ARE
BASED FROM TOP OF FOUNDATION WALL

SEE NOTE:
REFERENCE LEVEL

NOTE:
SIMPSON STRAPPING
METAL STAP EMBEDDED IN CONCRETE
AND NAILED TO ALL TIMBER POSTS

NOIL:

DIMENSIONS TO BE CONFIRMED BY GENERAL

CONTRACTOR BEFORE CONSTRUCTION BEGINS.

PRIOR TO CONSTRUCTION OF TIMBER FRAME, ALL 1st FLOOR FRAMING MUST BE IN PLACE AND LEVEL

SOLID BLOCKING REQ'D UNDER ALL TIMBER POSTS: BLOCKING TO BE VERTICAL GRAIN TO MINIMIZE COMPRESSION

HARDWIRE SMOKE DETECTORS (W/ BATTERY B.U.) EACH FLOOR

COPYRIGHT LAWS PROHIBIT REPRODUCTION OR USE OF THIS DRAWING, IN WHOLE OR IN PART, WITHOUT THE EXPRESSED WRITTEN PERMISSION OF DW TIMBER FRAME DESIGN

DO NOT SCALE DIMENSIONS ON THESE DRAWINGS. THESE IMAGES ARE MACHINE REPRODUCTIONS AND MAY CONTAIN A MARGIN OF ERROR.

SCALE:
1/4" = 1'-O"

DATE: DATE: NUMBER & DISCRIPTION


10/8/15


CHECKED BY:

CHECKED BY:

HAWKINS RESIDENCE
LYNCHBURG, TN

FD-1

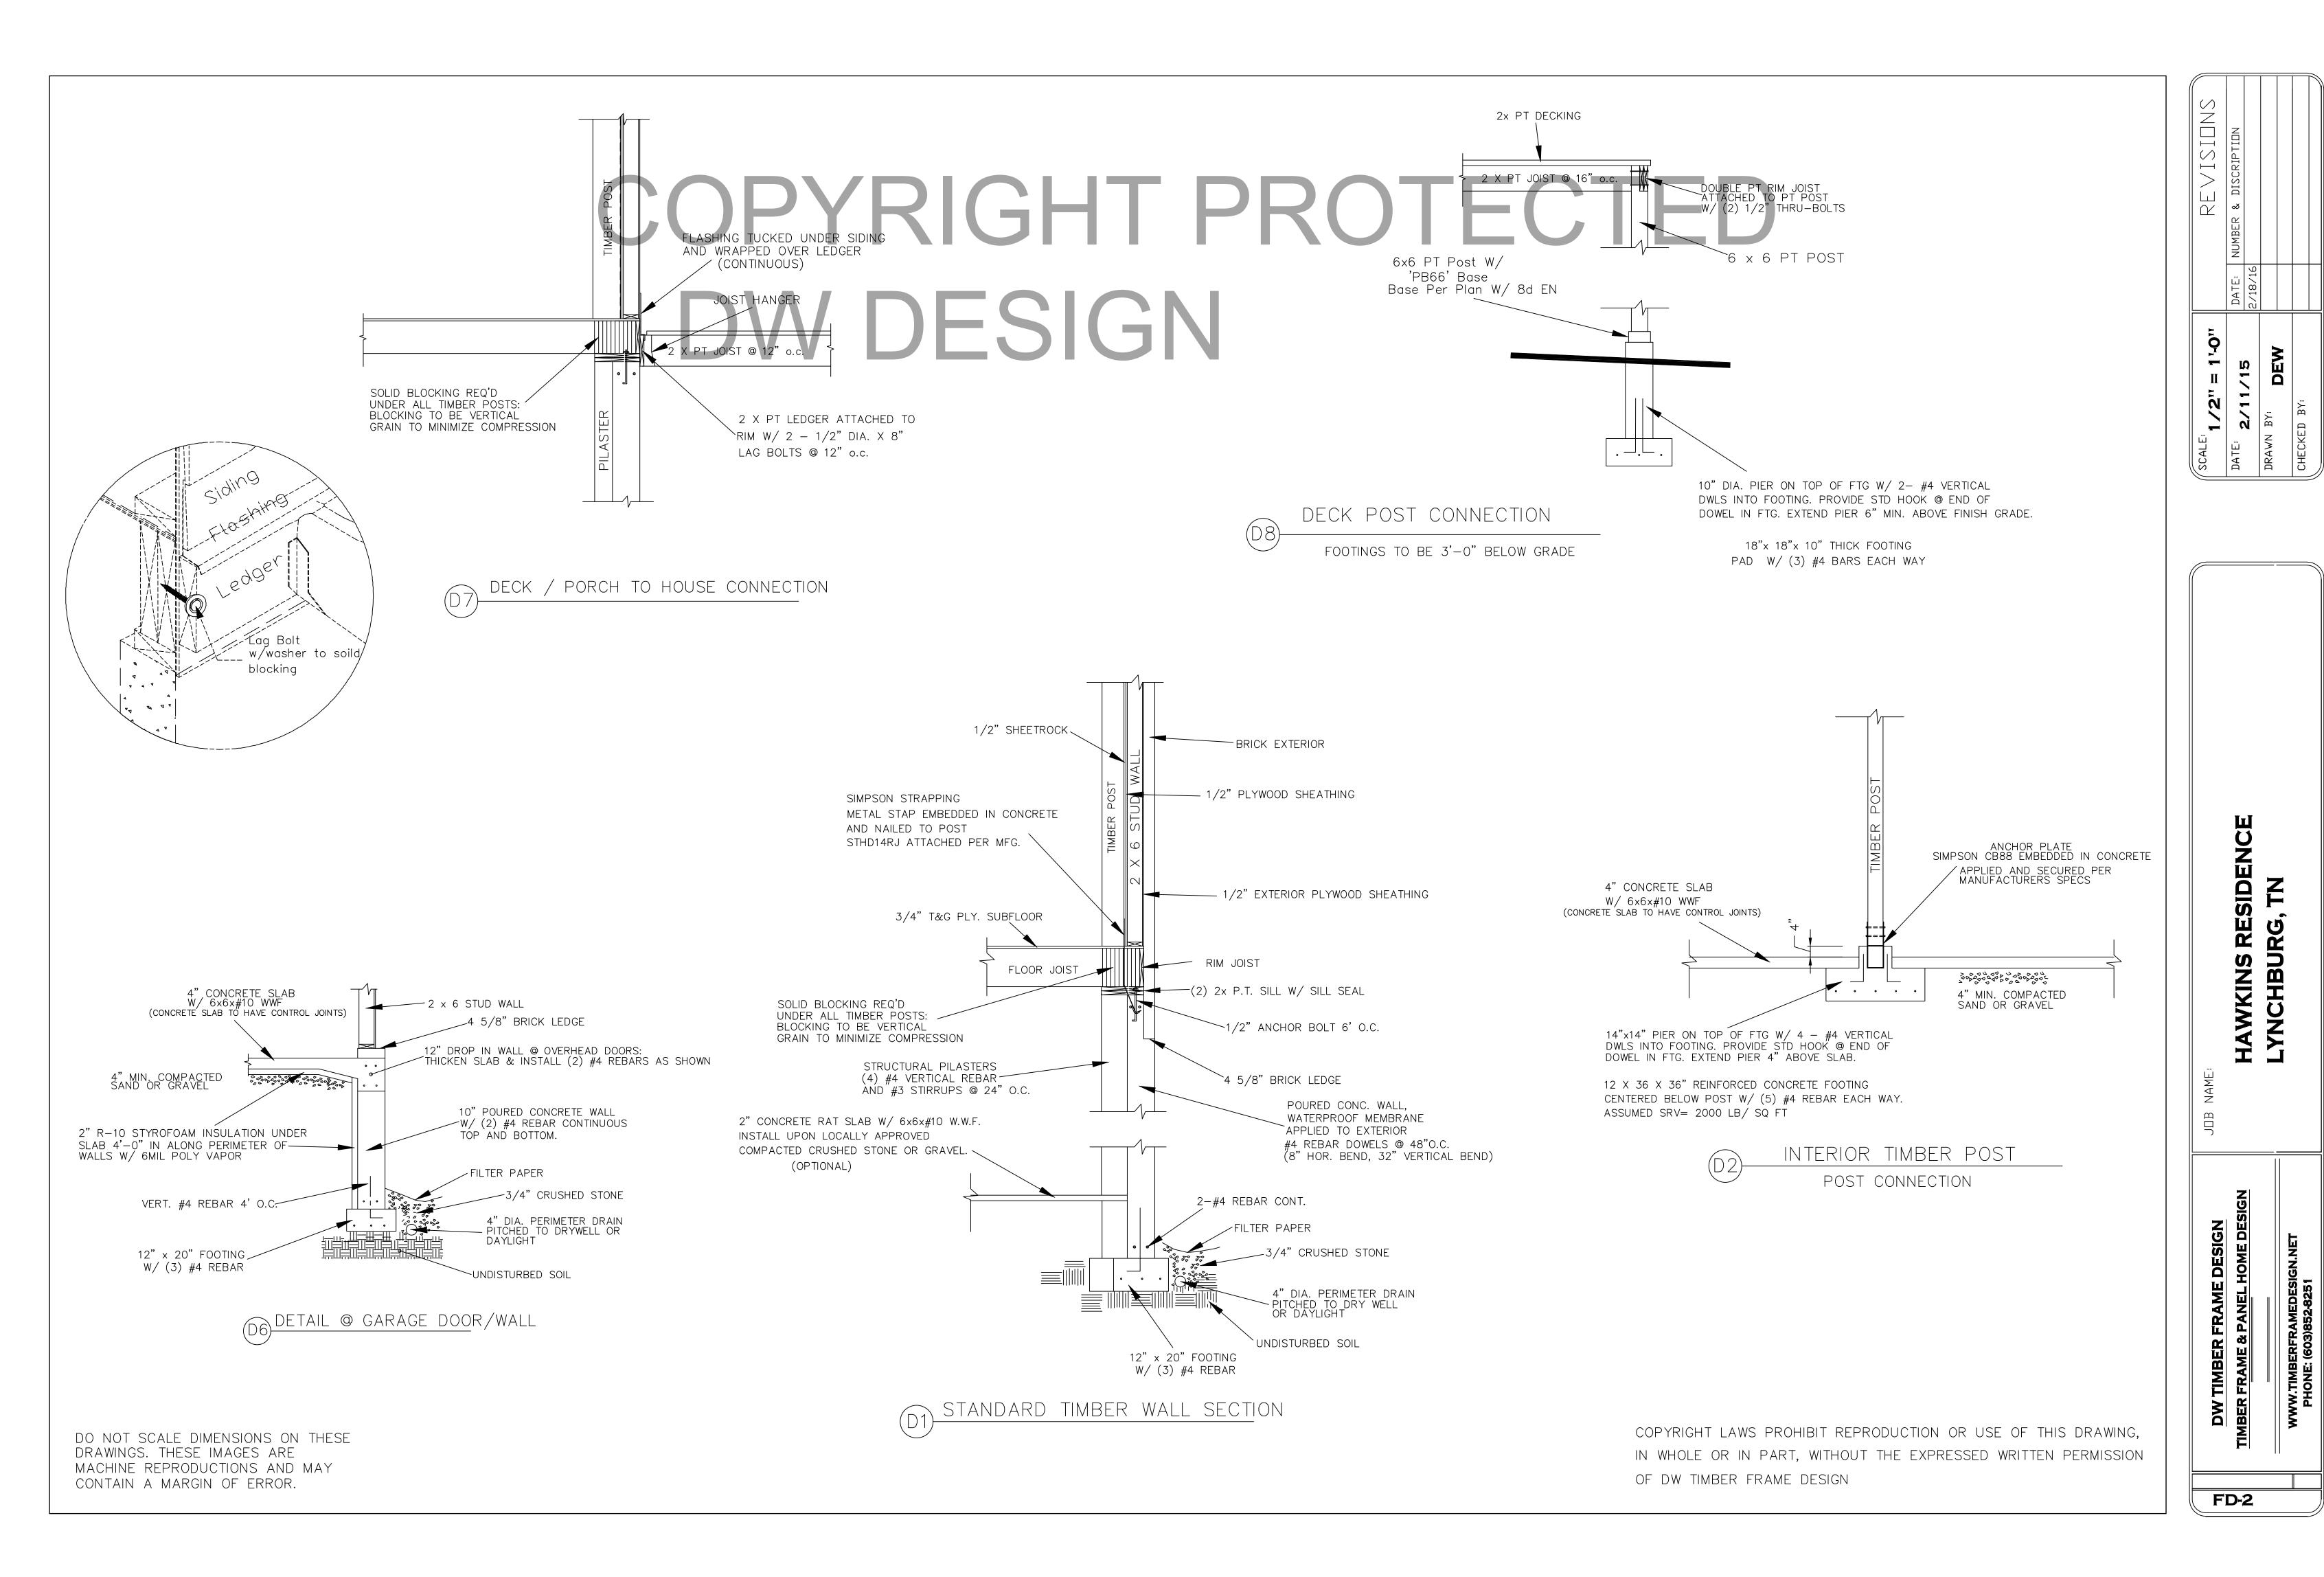

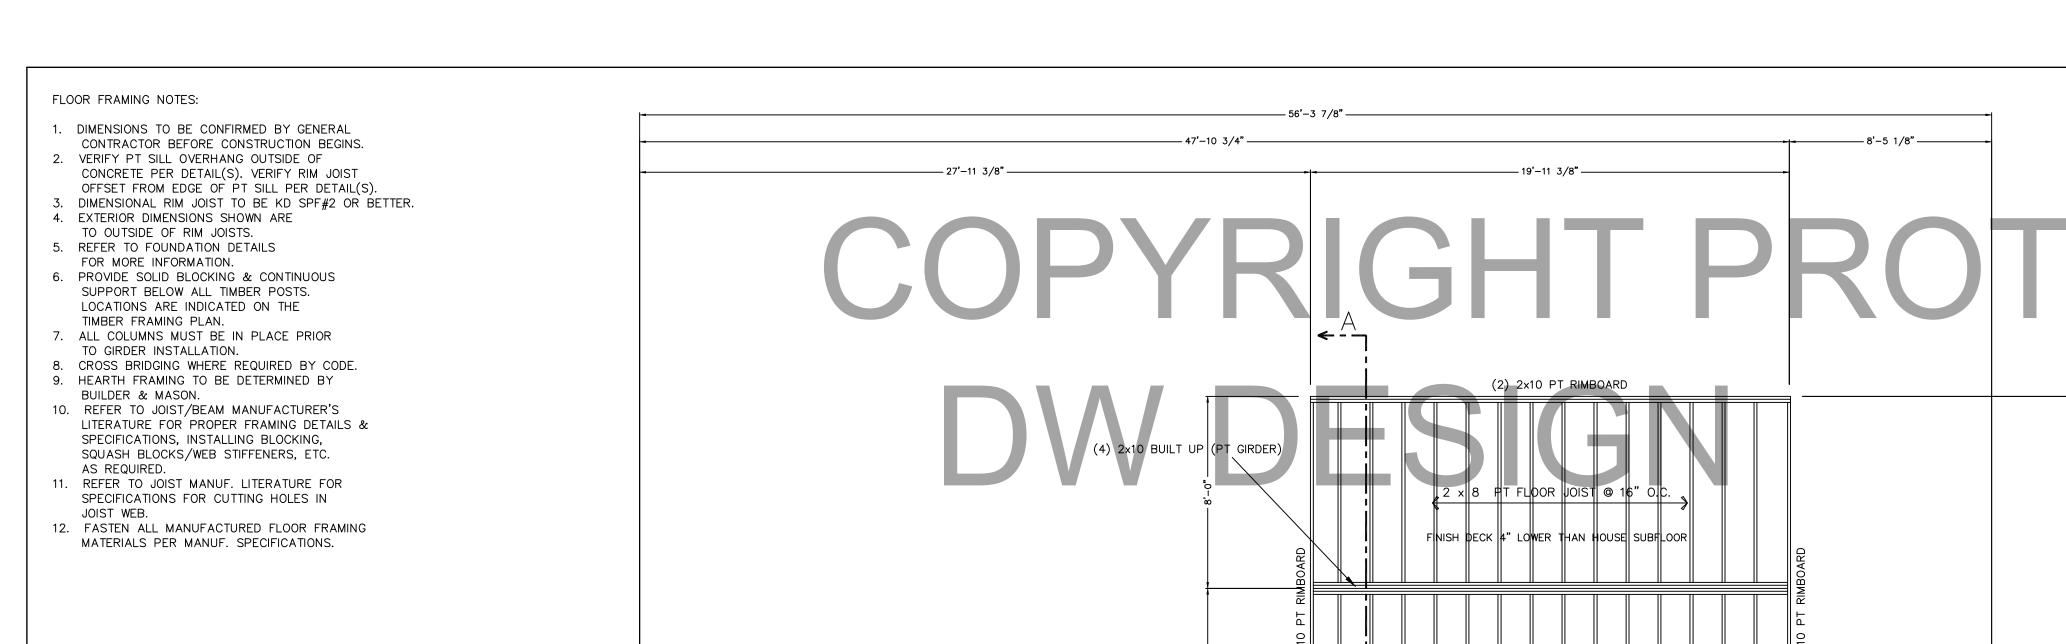

— 14'-0 1/2" —

2× RIMBOARD 2x RIMBOARD || 9 1∤|2" 11||0 TJ||FLOO||R JOI\$|T @ ||16" O.||¢. APPLIED AND SECURED PER MANUFACTURERS SPECS 1 3/4" x 9 1/2" 1.9 LVL (2) 1 3/4" x 9 1/2" 1.9 LVL POST 1 3/4" x 9 1/2" 1.9 LVL APPLIED AND SECURED PER MANUFACTURERS SPECS 2x RIMBOARD 2x RIMBOARD 2x RIMBOARD (2) 2x8 PT RIMBOARD **ر** - - -

FIRST FLOOR FRAMING PLAN

— 14'-0 1/2" ——

– 19'–9 3/4" —

REFER TO JOIST/BEAM MANUFACTURER'S LITERATURE FOR PROPER FRAMING DETAILS & SPECIFICATIONS, INSTALLING BLOCKING, SQUASH BLOCKS/WEB STIFFENERS, ETC. AS REQUIRED.

PRIOR TO CONSTRUCTION OF TIMBER FRAME, ALL 1st FLOOR

SOLID BLOCKING REQ'D

HARDWIRE SMOKE DETECTORS (W/ BATTERY B.U.) EACH FLOOR

COPYRIGHT LAWS PROHIBIT REPRODUCTION OR USE OF THIS DRAWING, IN WHOLE OR IN PART, WITHOUT THE EXPRESSED WRITTEN PERMISSION OF DW TIMBER FRAME DESIGN

COPYRIGHT PROTECTED

DIMENSIONS TO BE CONFIRMED BY GENERAL CONTRACTOR BEFORE CONSTRUCTION BEGINS.

FRAMING MUST BE IN PLACE AND LEVEL

UNDER ALL TIMBER POSTS: BLOCKING TO BE VERTICAL GRAIN TO MINIMIZE COMPRESSION

Q


> ESIDENG, G, TN HAWKINS I LYNCHBUF

DW TIMBER F TIMBER FRAME & F

A-8

DO NOT SCALE DIMENSIONS ON THESE DRAWINGS. THESE IMAGES ARE MACHINE REPRODUCTIONS AND MAY CONTAIN A MARGIN OF ERROR.

!--- OUTLINE OF TIMBER POST ABOVE L--- POSTS ALIGNED TO CENTER

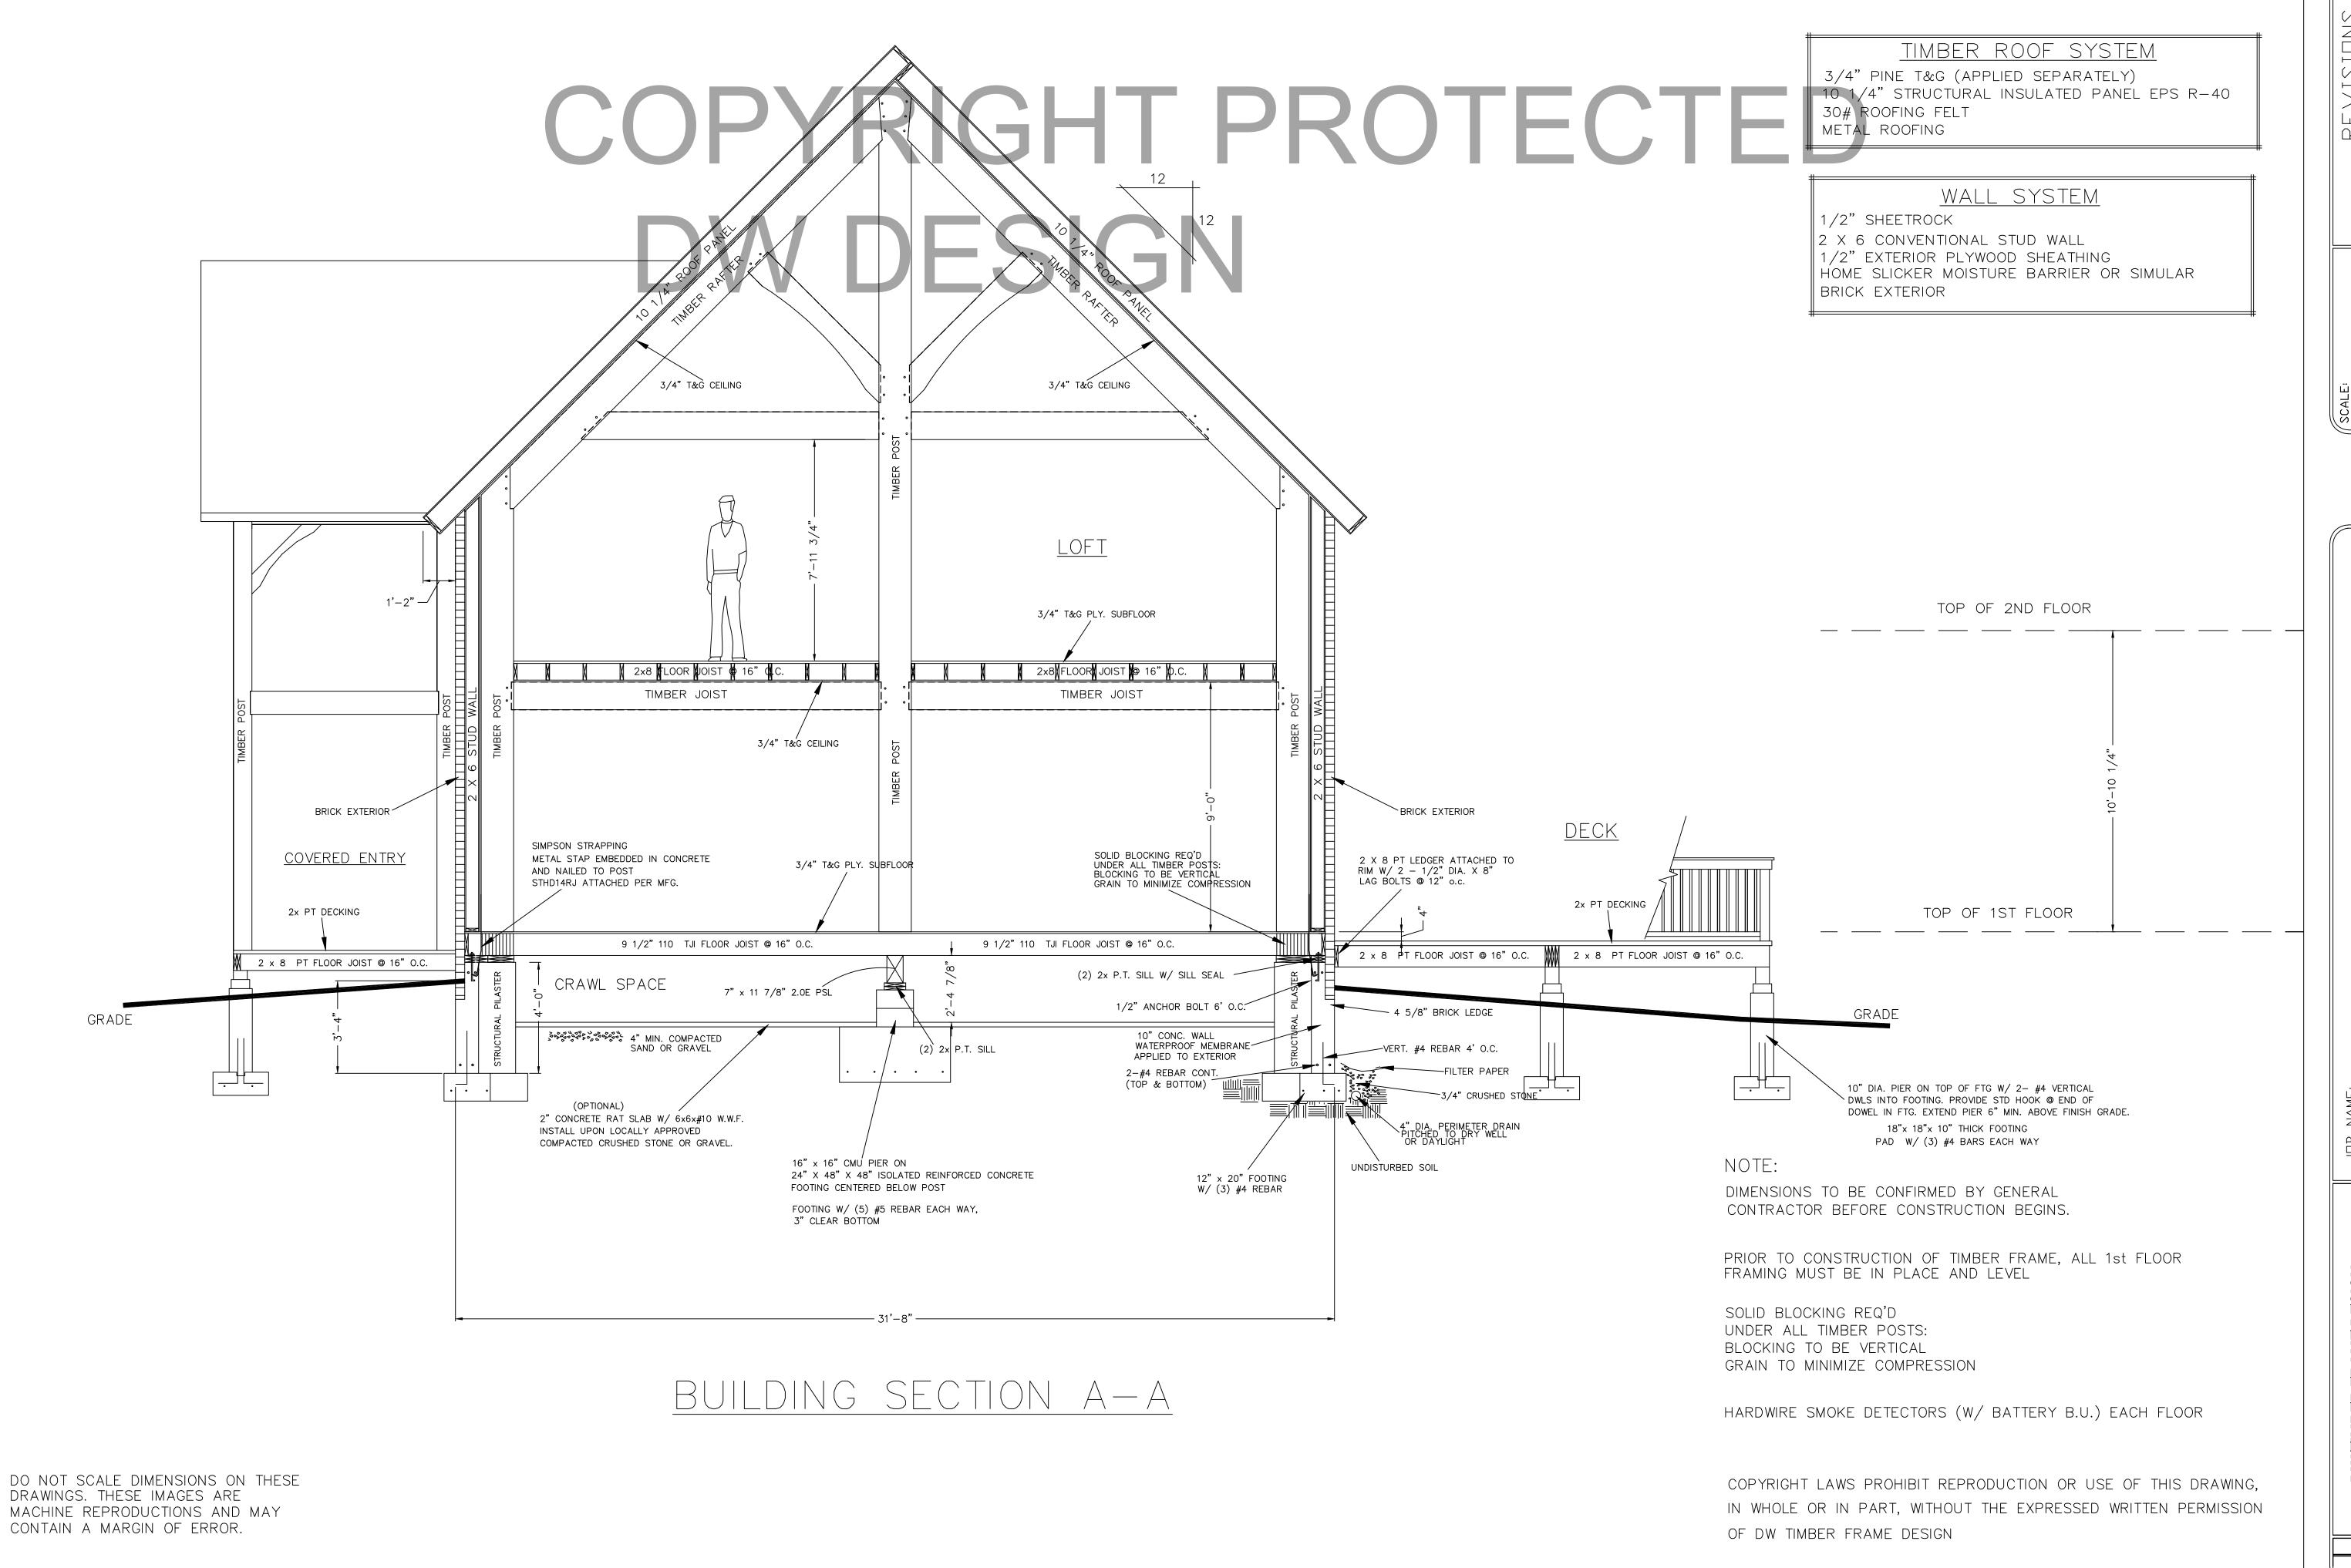

E: 3/8" = 1'.0" 2/11/15 AN BY: DEW 2/18/16 2/18/16 2/18/16 2/18/16 2/18/16 2/18/16 2/18/16


HAWKINS RESIDENCE LYNCHBURG, TN

JOB NAME:

AME DESIGN
VEL HOME DESIGN
——

R FRAME & PANEL HOME DE

A-A

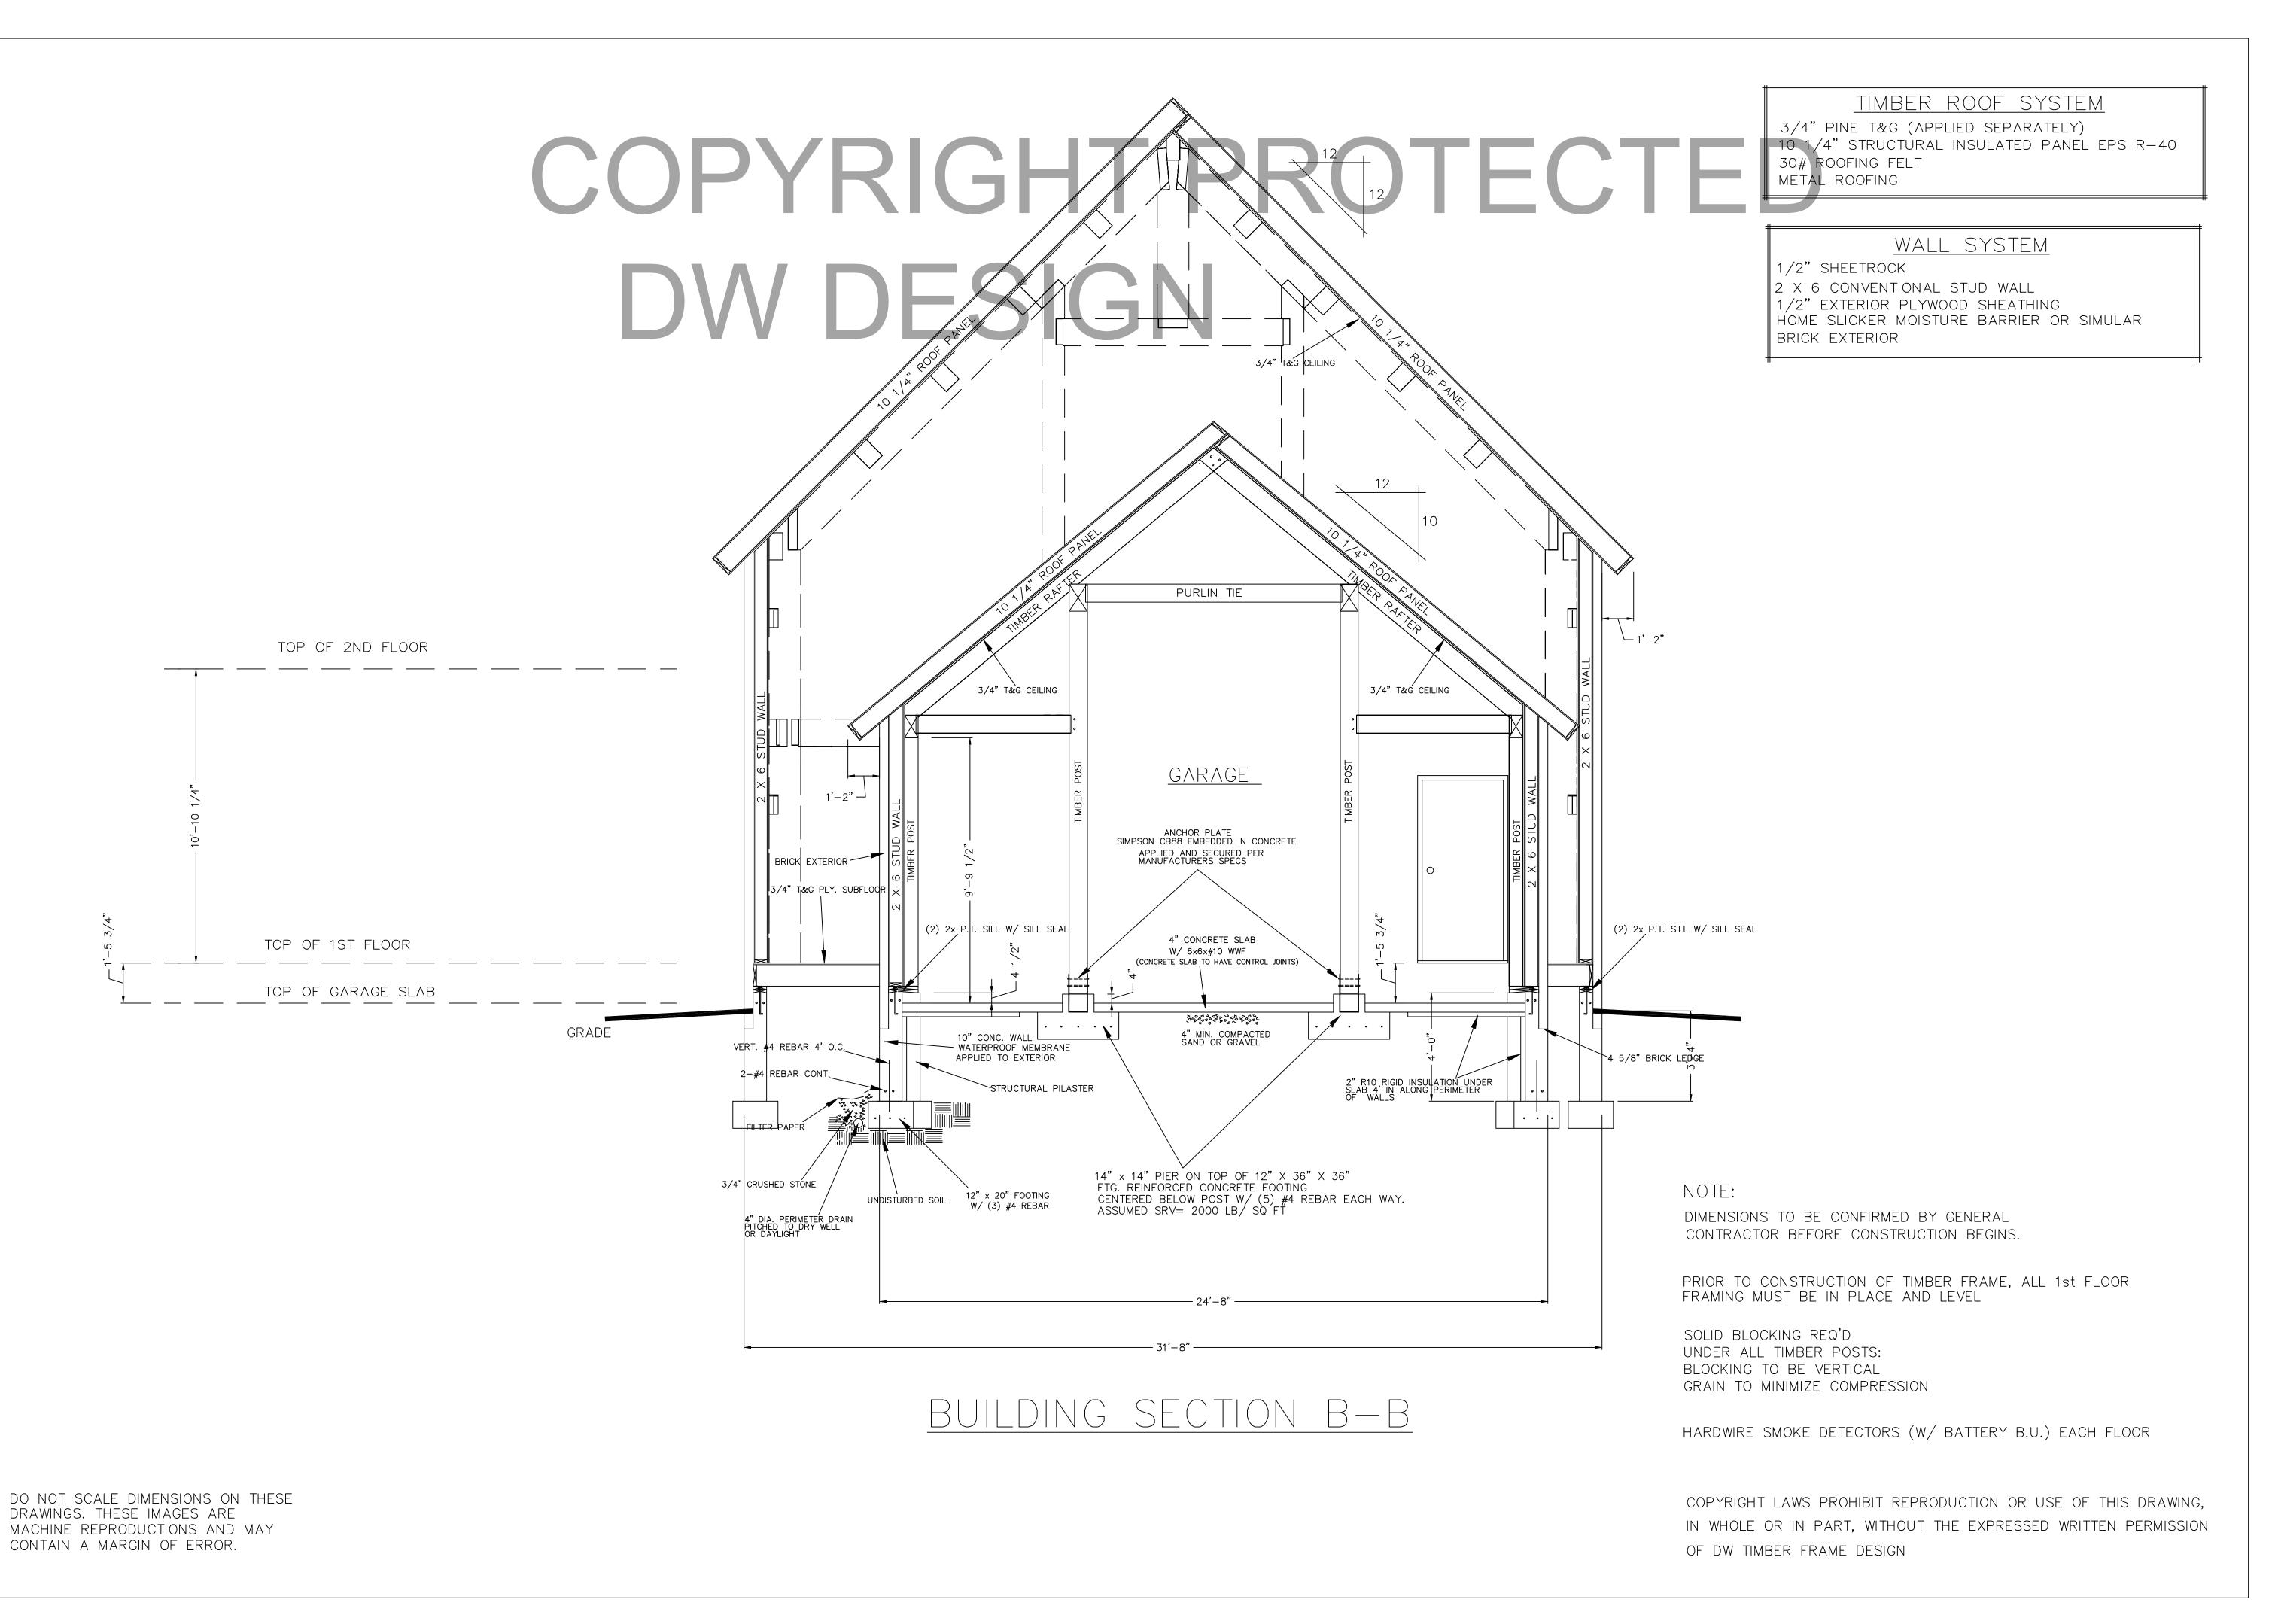

CALE: **3/8" = 1'.O"**ATE: **2/11/15**ATE: **2/11/15**RAWN BY: **DEW**HECKED BY:

AECKED BY:

NS RESIDENCE BURG, TN

HA

JOB NAME:

FRAME DESIGN
PANEL HOME DESIGN

W TIMBER FRAME DE

B-B