

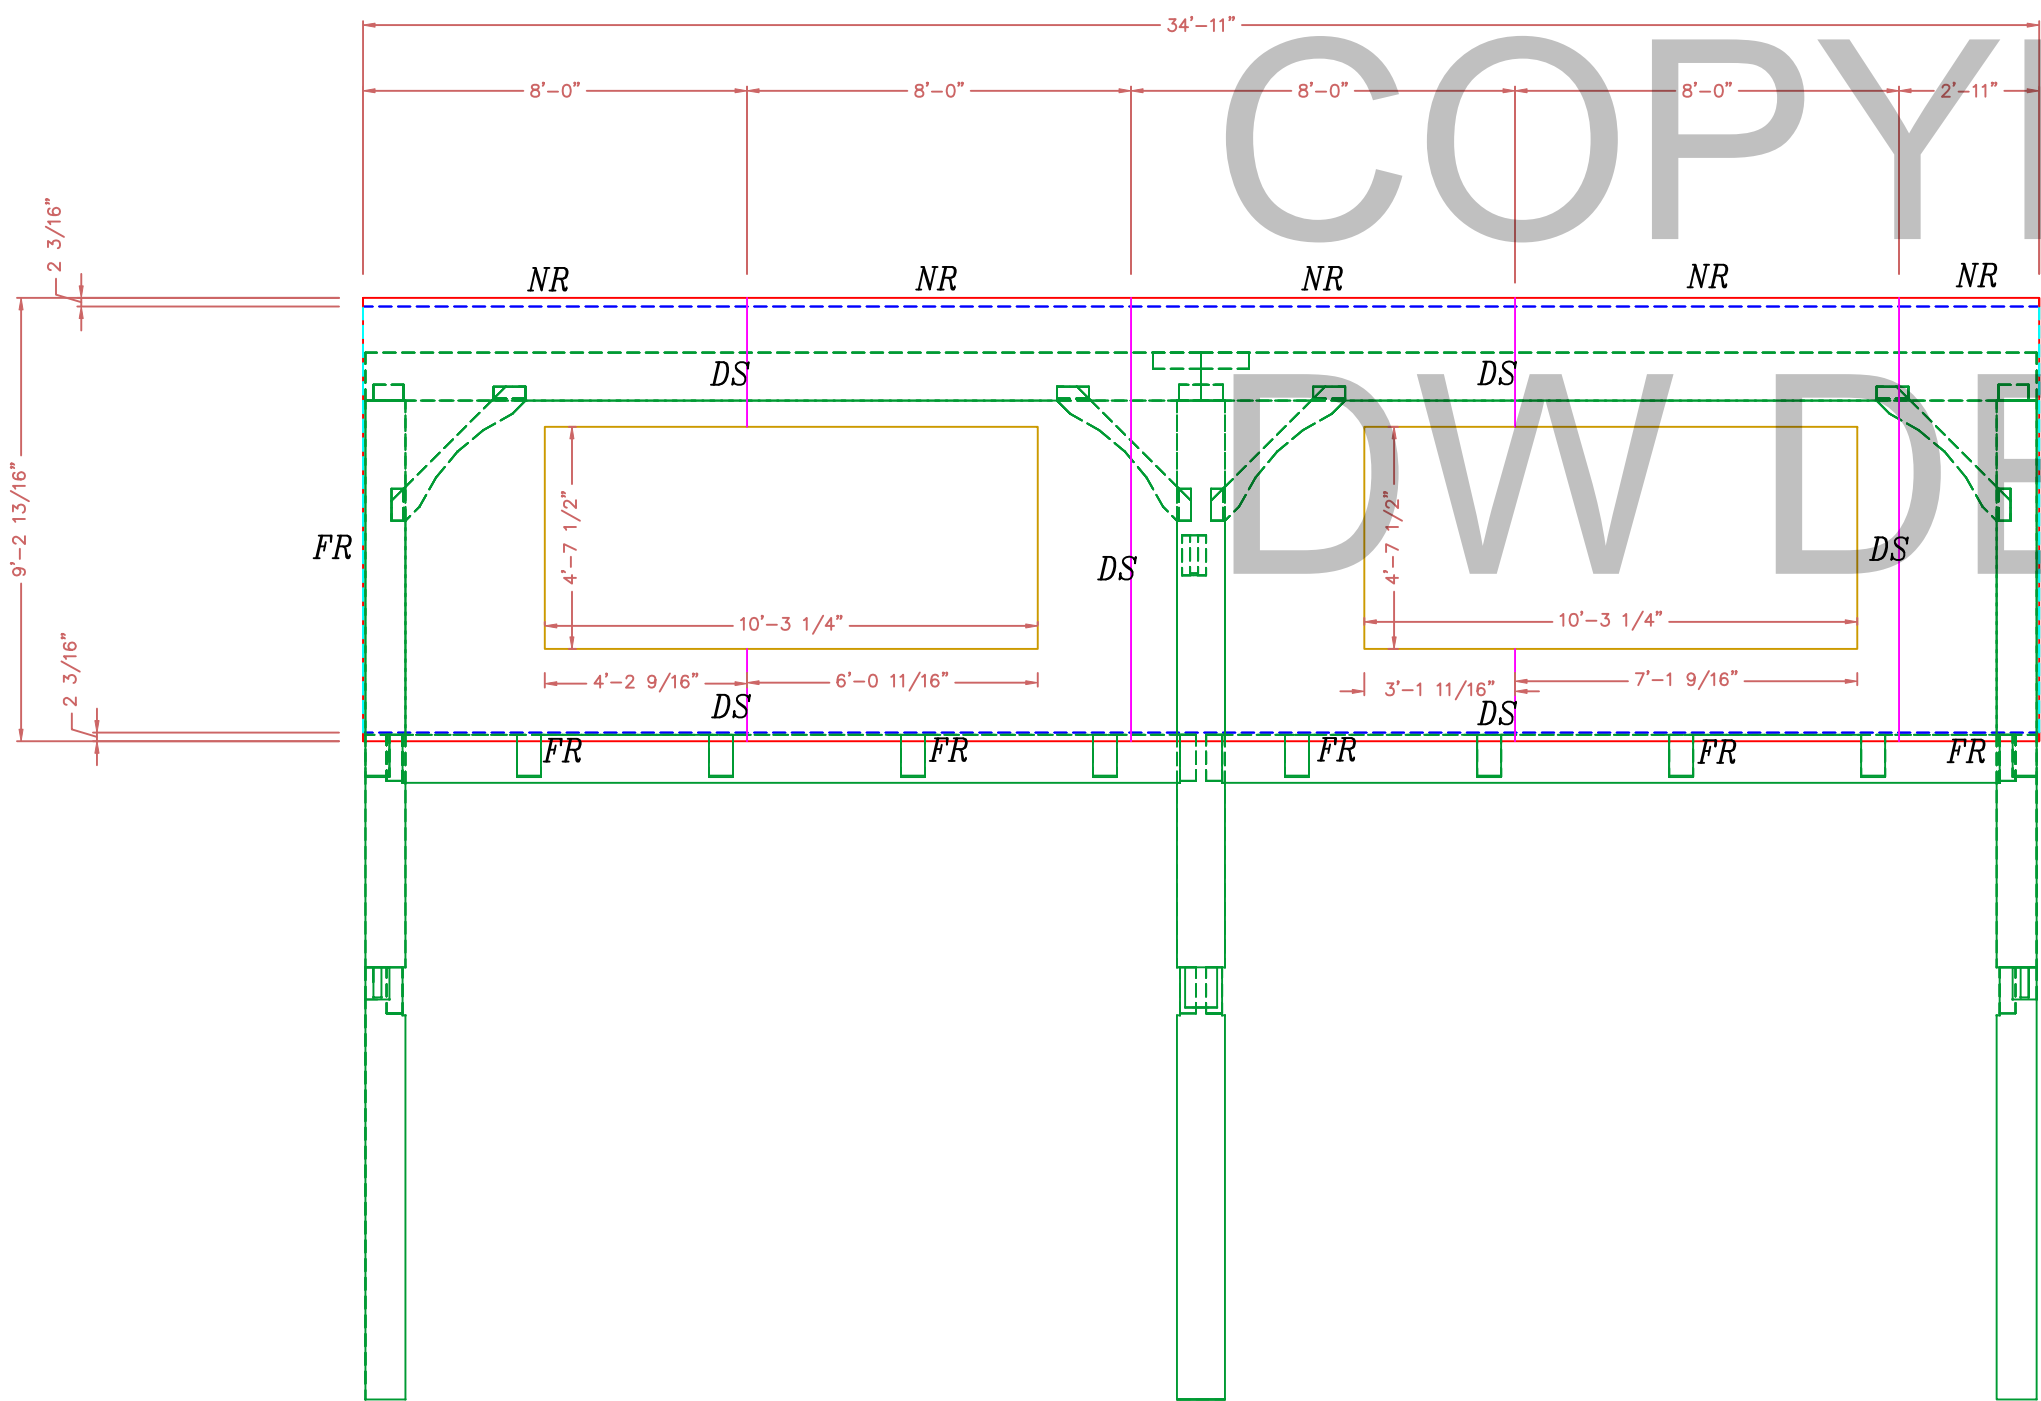



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DW DESIGN

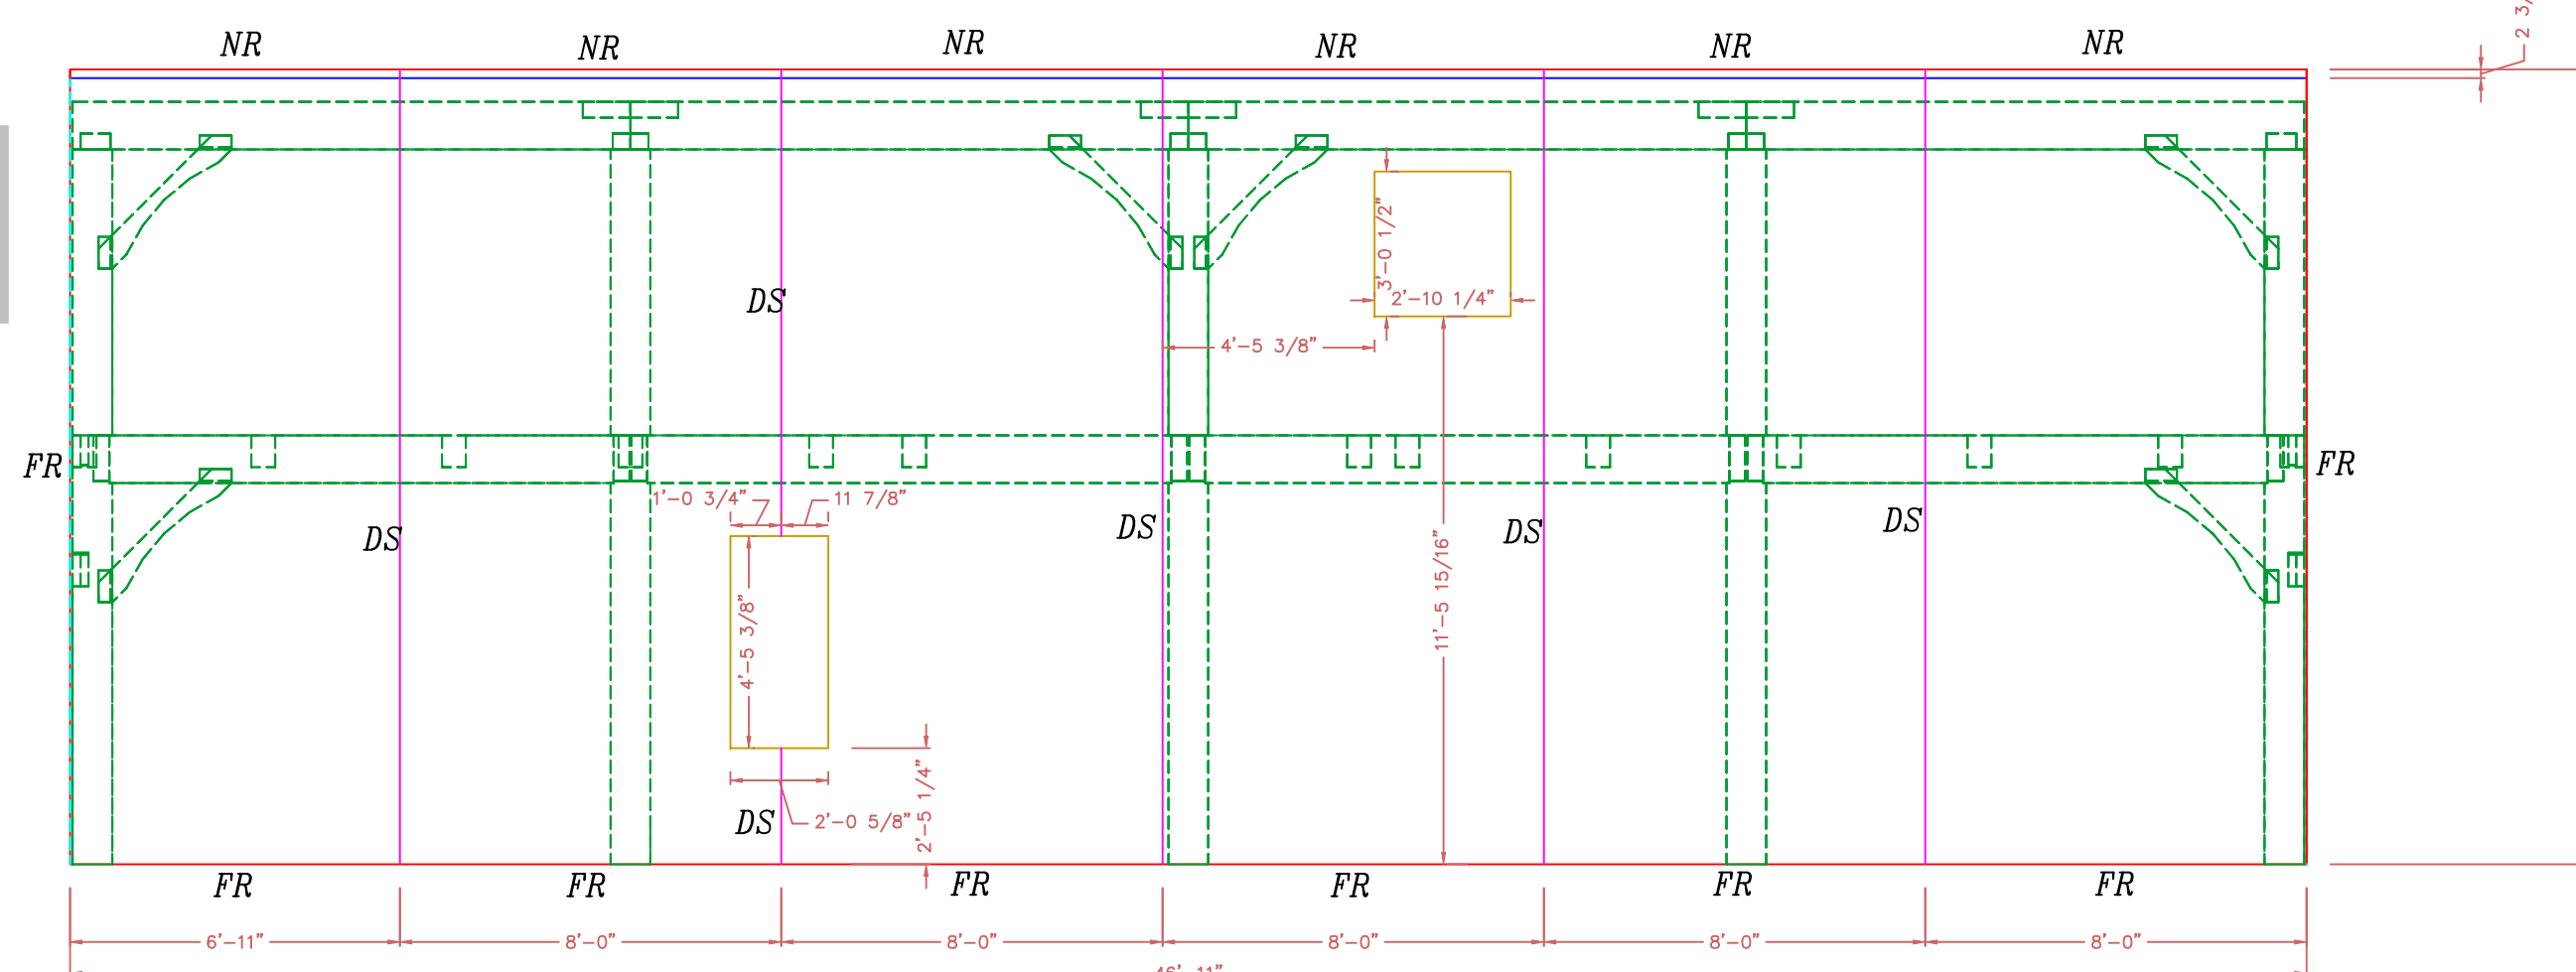

WALL 2
VIEWED FROM SOUTH
6 1/2" STRUCTURAL INSULATED (E.P.S.) PANELS.

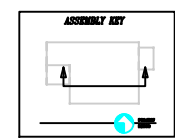


WALL 4
NORTH ELEVATION
6 1/2" STRUCTURAL INSULATED (E.P.S.) PANELS.

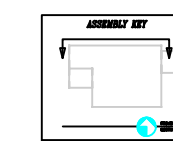



NOTE:
ALL WINDOW & DOOR OPENINGS ARE FULL ROUTE

- = HIDDEN CUT (BACK SKIN)
- = VISABLE CUT (FRONT SKIN)


- FR2 = DOUBLE FULL ROUTE
- FR = FULL ROUTE
- HR = HALF ROUTE
- SS = SINGLE SPLINE
- DS = DOUBLE SPLINE
- NR = NO ROUTE

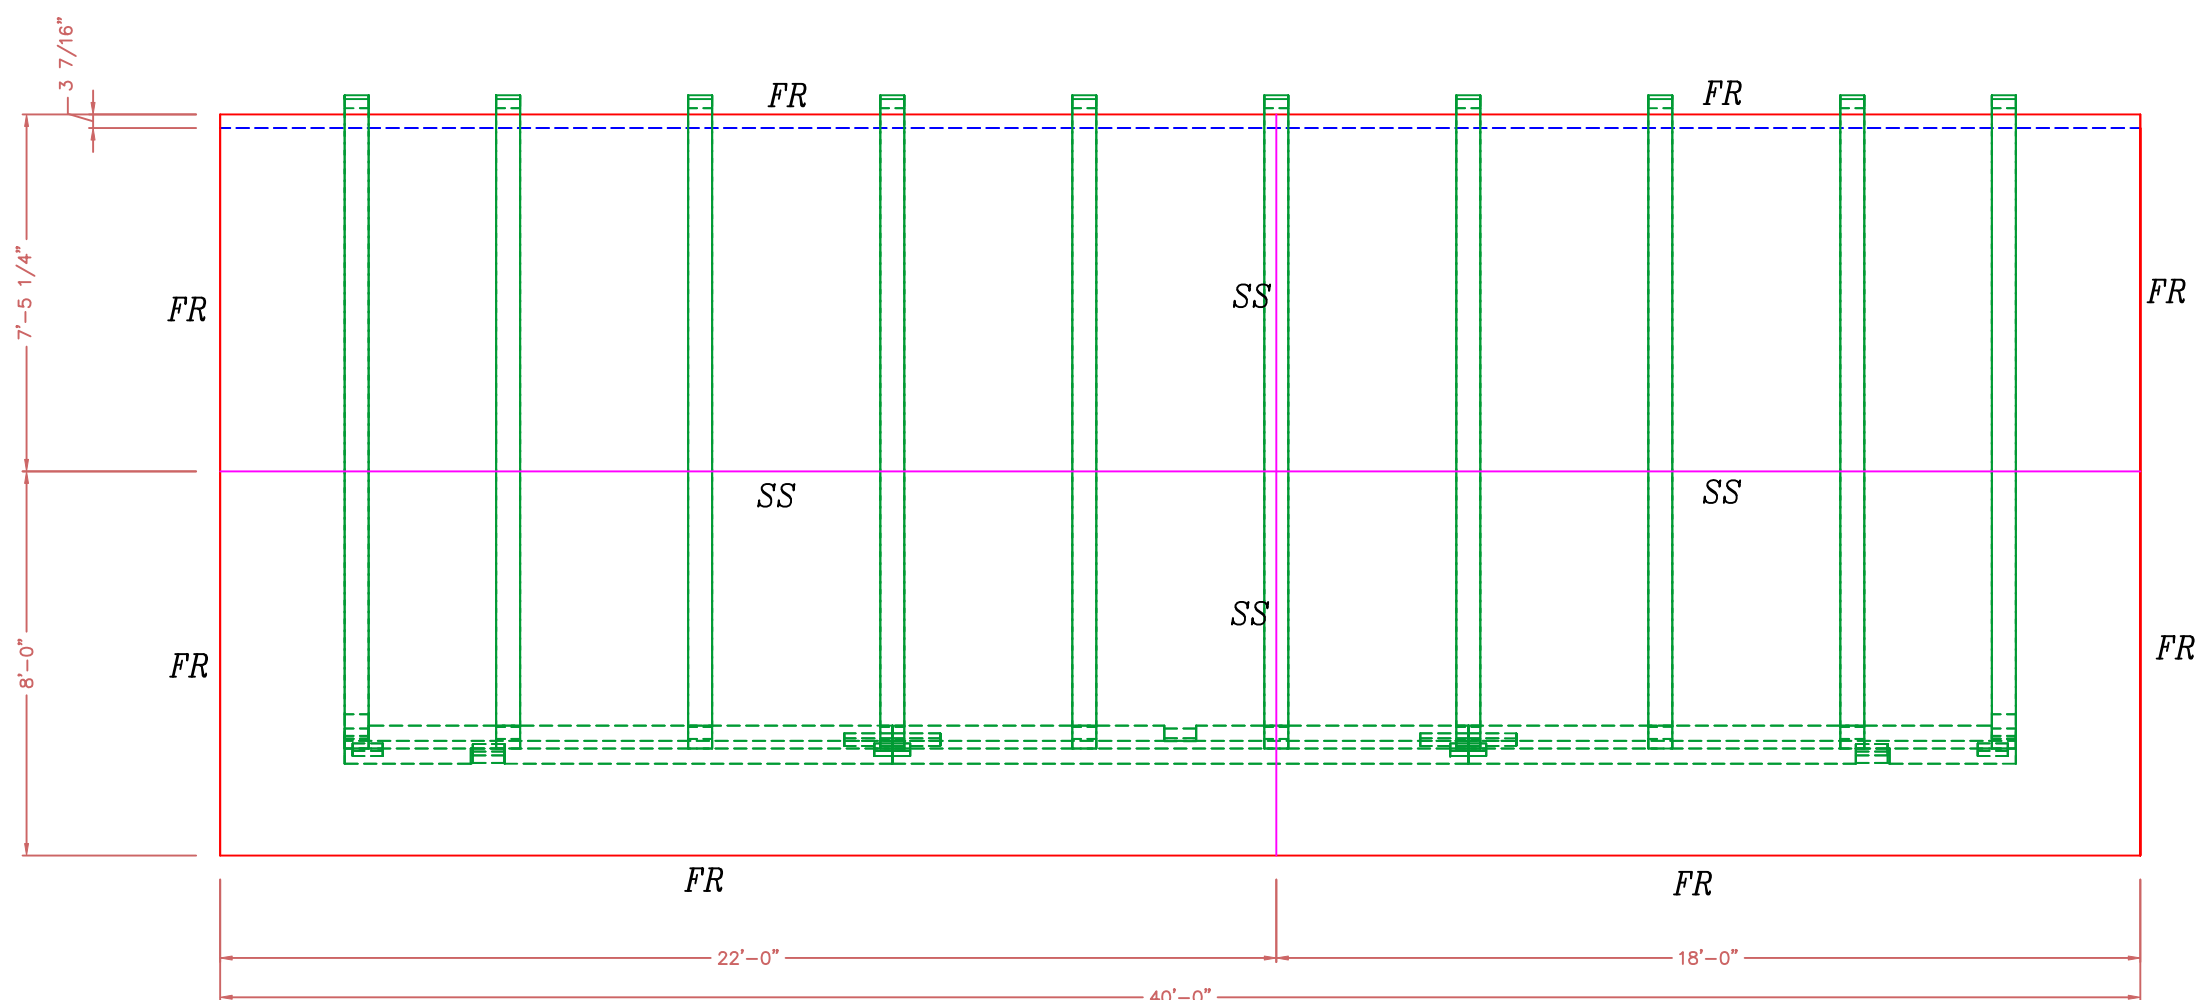

ROOF
SOUTH ELEVATION
10 1/4" STRUCTURAL INSULATED (E.P.S.) PANELS.

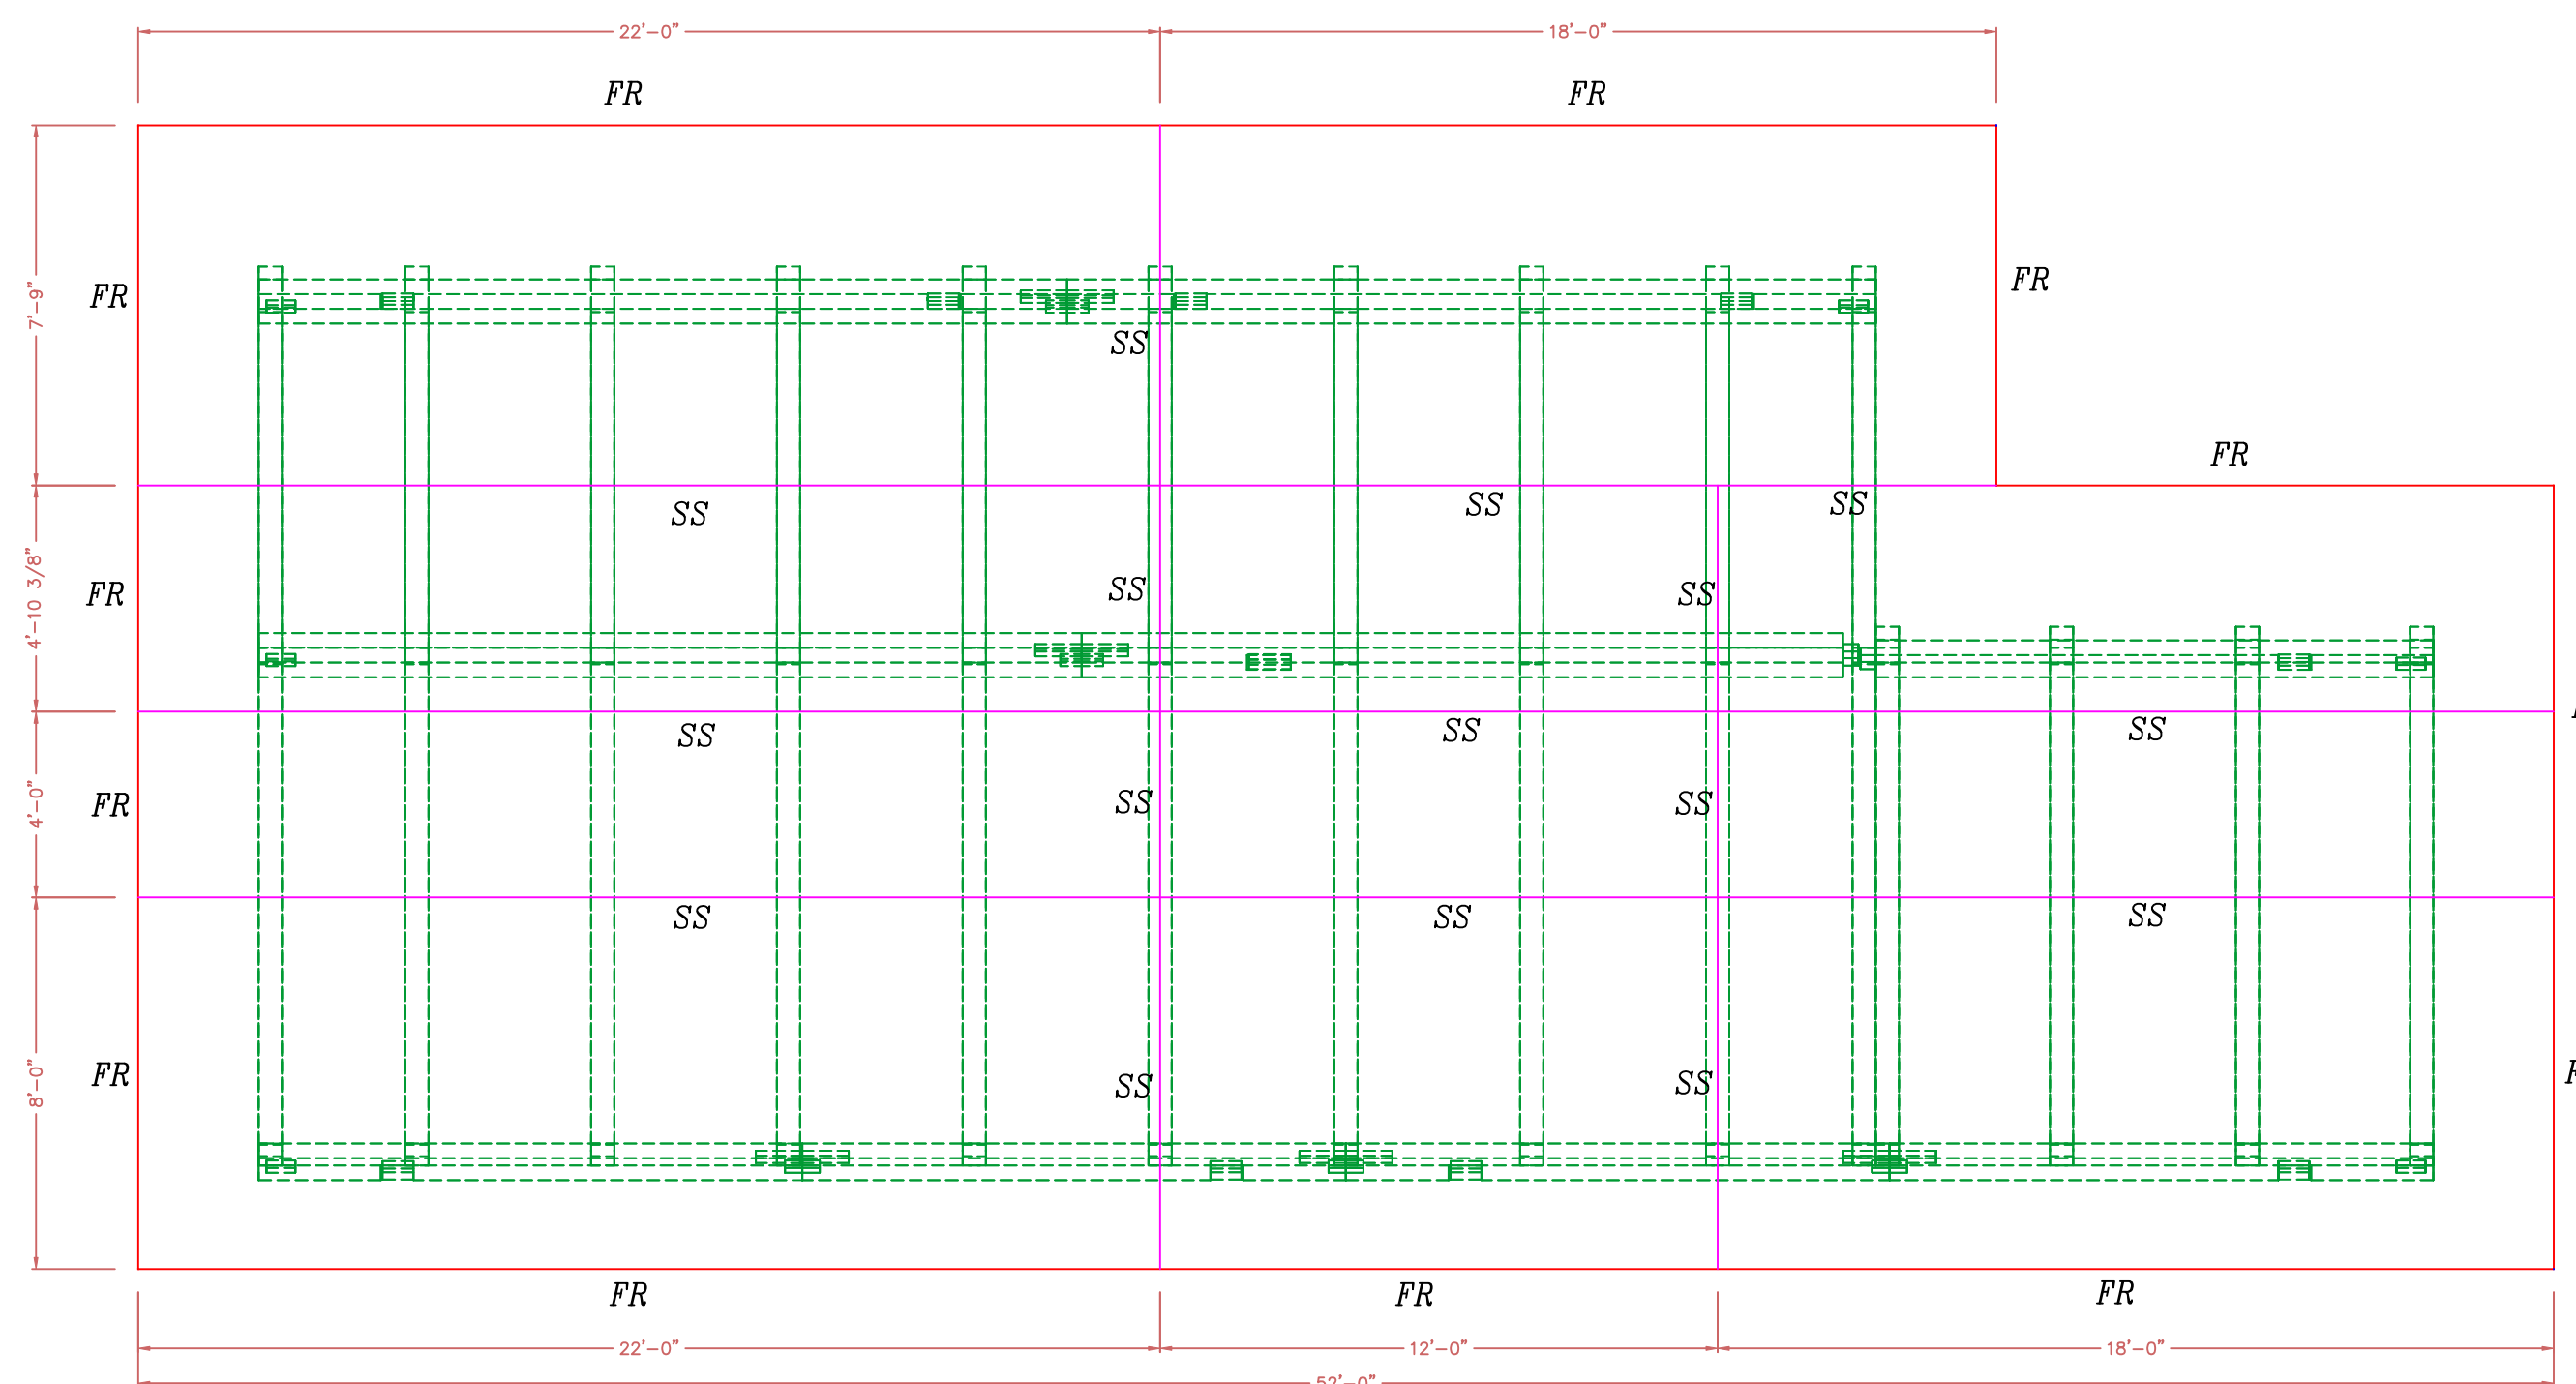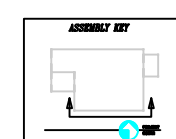

ROOF
NORTH ELEVATION
10 1/4" STRUCTURAL INSULATED (E.P.S.) PANELS.

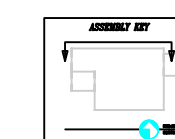

ROOF: IS 10 1/4" STRUCTURAL INSULATED (E.P.S.) PANELS.
THEY SHALL BE APPLIED TO TIMBER FRAME OVER 3/4" T & G BOARDS.

WALLS: ARE 6 1/2" STRUCTURAL INSULATED (EPS) PANELS.
THEY SHALL BE APPLIED TO TIMBER FRAME OVER 1/2" SHEETROCK.
WITH 5/8" STRAPPING APPLIED TO EXTERIOR TIMBERS

NOTE:
DIMENSIONS TO BE CONFIRMED BY GENERAL CONTRACTOR BEFORE CONSTRUCTION BEGINS.

NOTE: ALL PANEL WALLS ARE VIEWED FROM OUTSIDE UNLESS NOTED OTHERWISE

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DO NOT SCALE DIMENSIONS ON THESE DRAWINGS. THESE IMAGES ARE MACHINE REPRODUCTIONS AND MAY CONTAIN A MARGIN OF ERROR.

REVISIONS	
NUMBER	DESCRIPTION

DATE: 2/13/20

SCALE: 1/4" = 1'-0"
DATE: 1/8/20
DRAWN BY: DEW
CHECKED BY:

JOB NAME: **COREY LEVY RESIDENCE**
BRUNSWICK, ME 04011

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