

DO NOT SCALE DIMENSIONS ON THESE DRAWINGS. THESE IMAGES ARE MACHINE REPRODUCTIONS AND MAY

CONTAIN A MARGIN OF ERROR.

BELDIN RESIDENCE
COLONA, IL 61241

**A-1** 

NUISIN

. 0


PRIOR TO CONSTRUCTION OF TIMBER FRAME, ALL 1st FLOOR FRAMING MUST BE IN PLACE AND LEVEL

FINAL LOCATION OF ALL INTERIOR PARTITIONS TO BE DETERMINED AT SITE.

SOLID BLOCKING REQ'D
UNDER ALL TIMBER POSTS:
BLOCKING TO BE VERTICAL
GRAIN TO MINIMIZE COMPRESSION

BASEMENT TO HAVE CO DETECTOR
HARDWIRE SMOKE DETECTORS (W/ BATTERY B.U.) EACH FLOOR

COPYRIGHT LAWS PROHIBIT REPRODUCTION OR USE OF THIS DRAWING, IN WHOLE OR IN PART, WITHOUT THE EXPRESSED WRITTEN PERMISSION OF DW TIMBER FRAME DESIGN

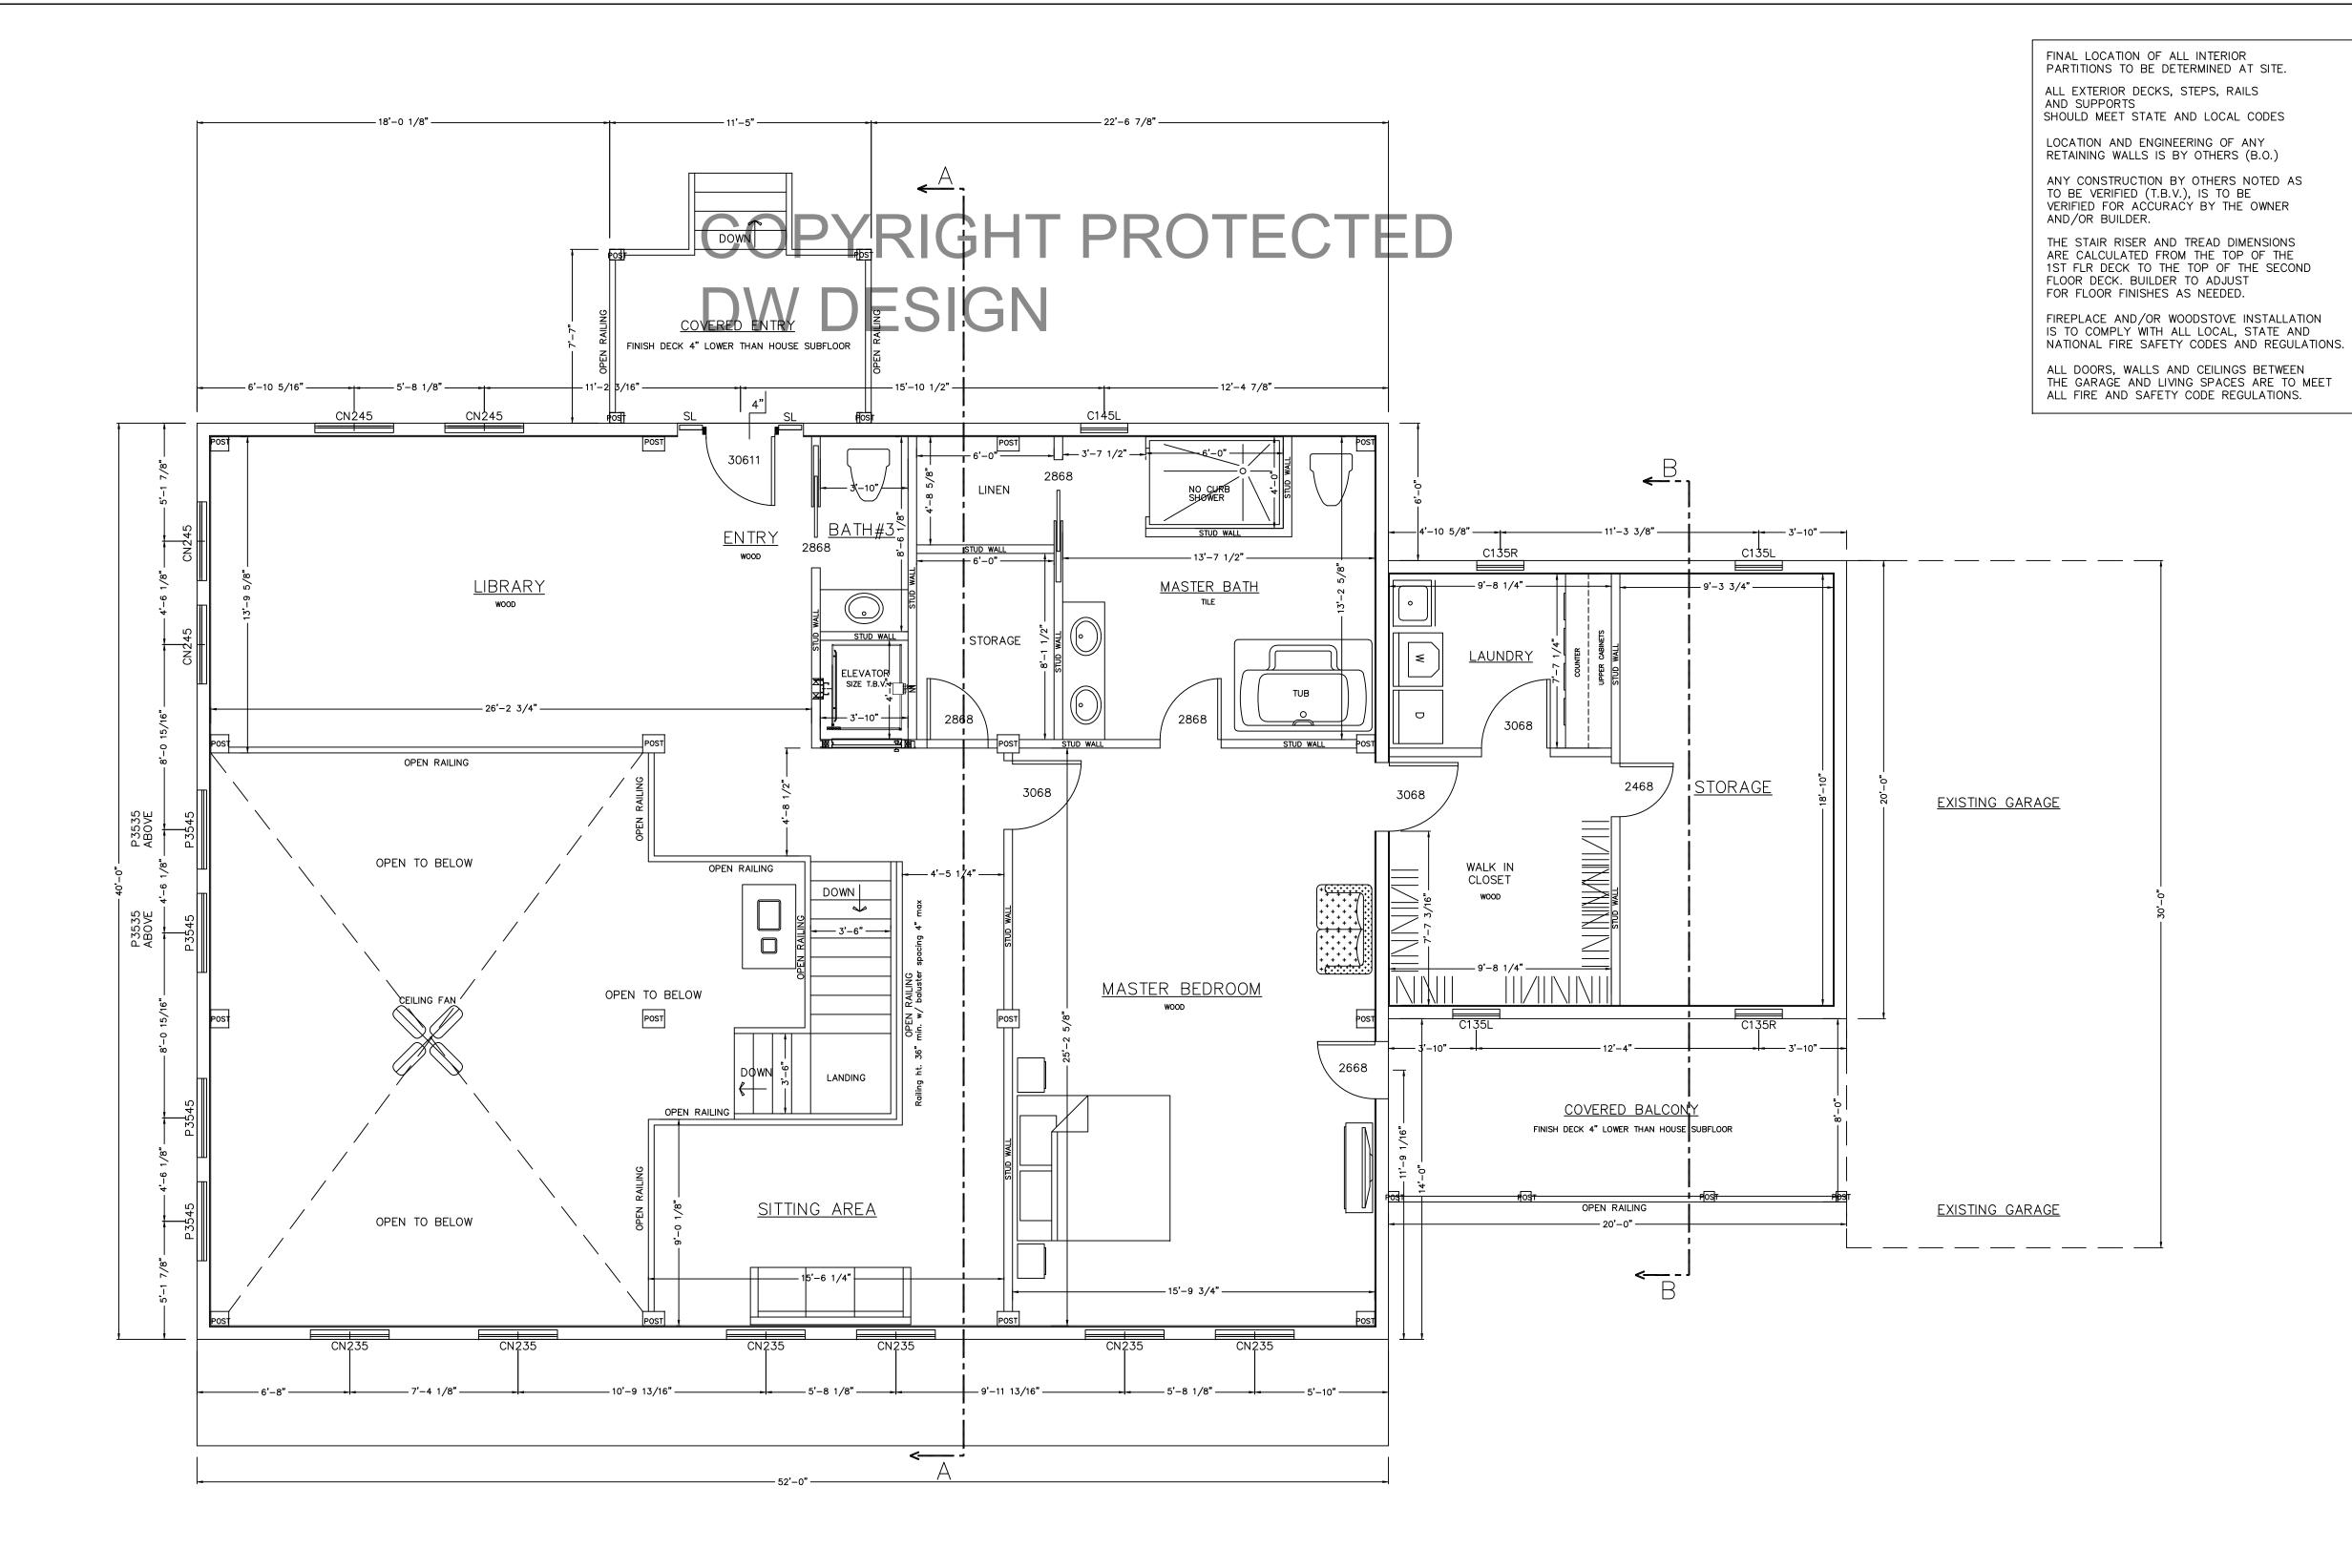

DIMENSIONS TO BE CONFIRMED BY GENERAL CONTRACTOR BEFORE CONSTRUCTION BEGINS.

PRIOR TO CONSTRUCTION OF TIMBER FRAME, ALL 1st FLOOR FRAMING MUST BE IN PLACE AND LEVEL

SOLID BLOCKING REQ'D UNDER ALL TIMBER POSTS: BLOCKING TO BE VERTICAL GRAIN TO MINIMIZE COMPRESSION BASEMENT TO HAVE CO DETECTOR HARDWIRE SMOKE DETECTORS (W/ BATTERY B.U.) EACH FLOOR

COPYRIGHT LAWS PROHIBIT REPRODUCTION OR USE OF THIS DRAWING, IN WHOLE OR IN PART, WITHOUT THE EXPRESSED WRITTEN PERMISSION OF DW TIMBER FRAME DESIGN

SECOND FLOOR PLAN

SID NO NO BEI CO


**A-2** 

Z

 $\geq$ 

Q

DO NOT SCALE DIMENSIONS ON THESE DRAWINGS. THESE IMAGES ARE MACHINE REPRODUCTIONS AND MAY CONTAIN A MARGIN OF ERROR.

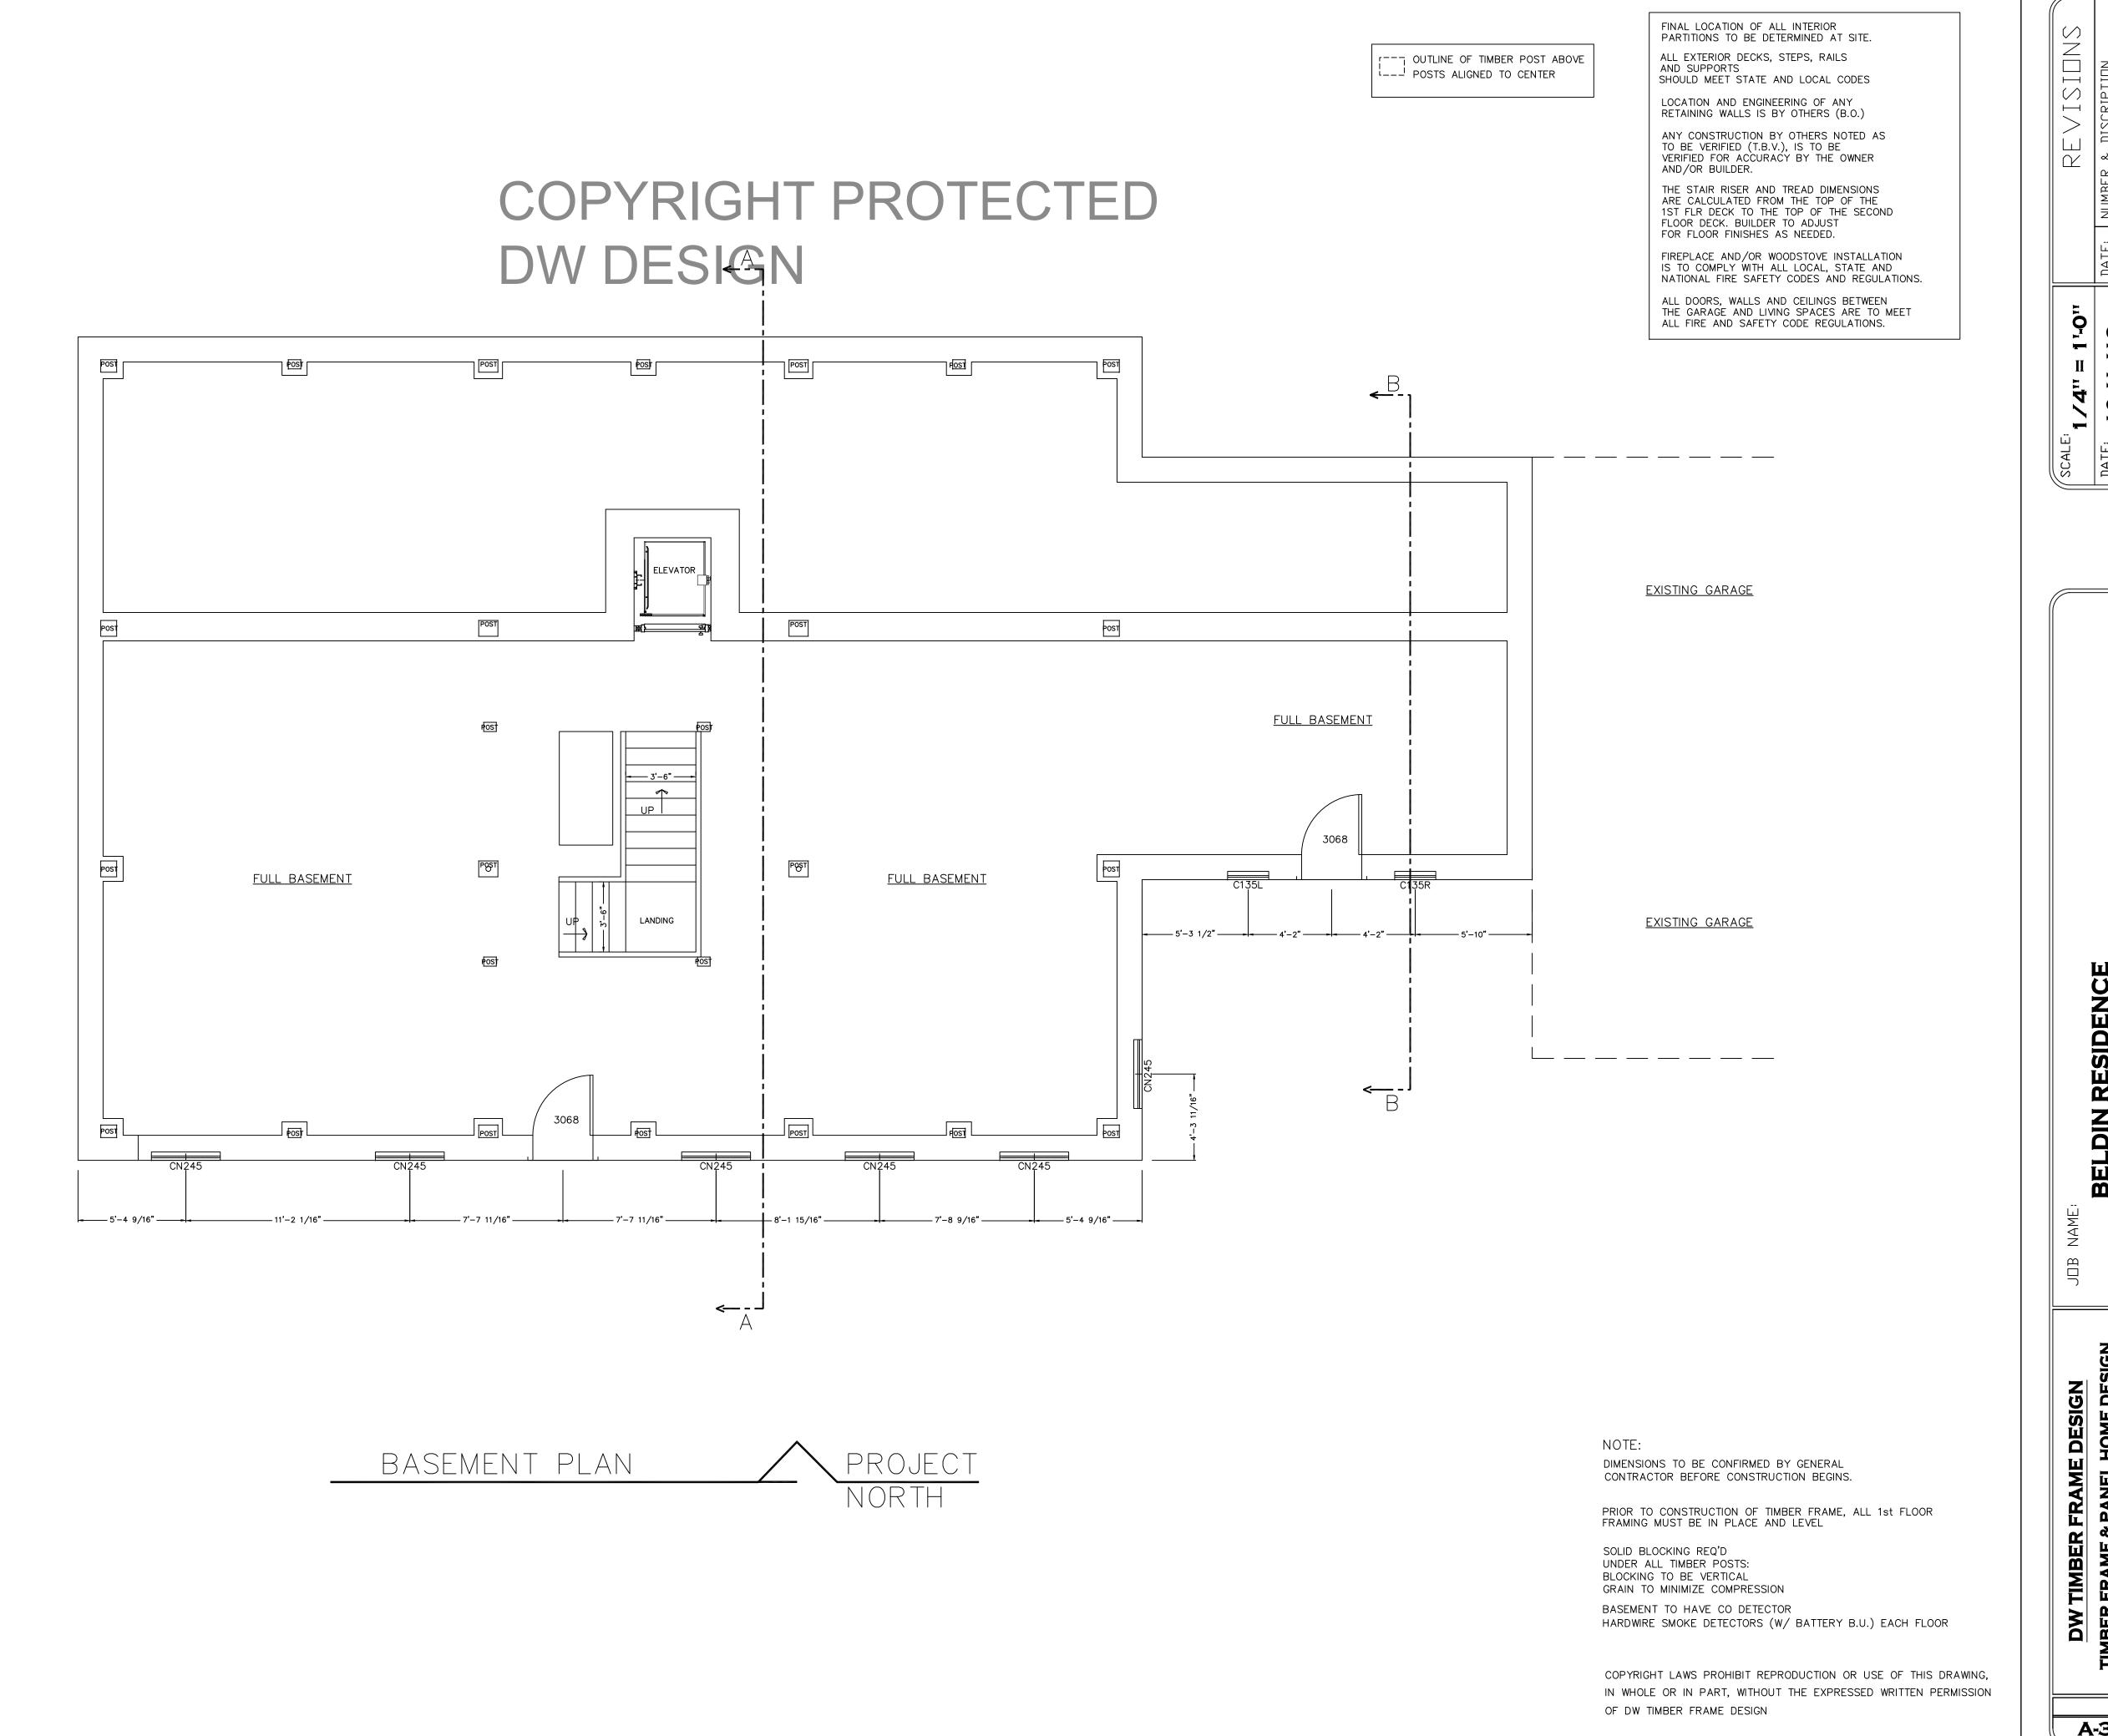


DO NOT SCALE DIMENSIONS ON THESE DRAWINGS. THESE IMAGES ARE MACHINE REPRODUCTIONS AND MAY

CONTAIN A MARGIN OF ERROR.

0

**A-3** 

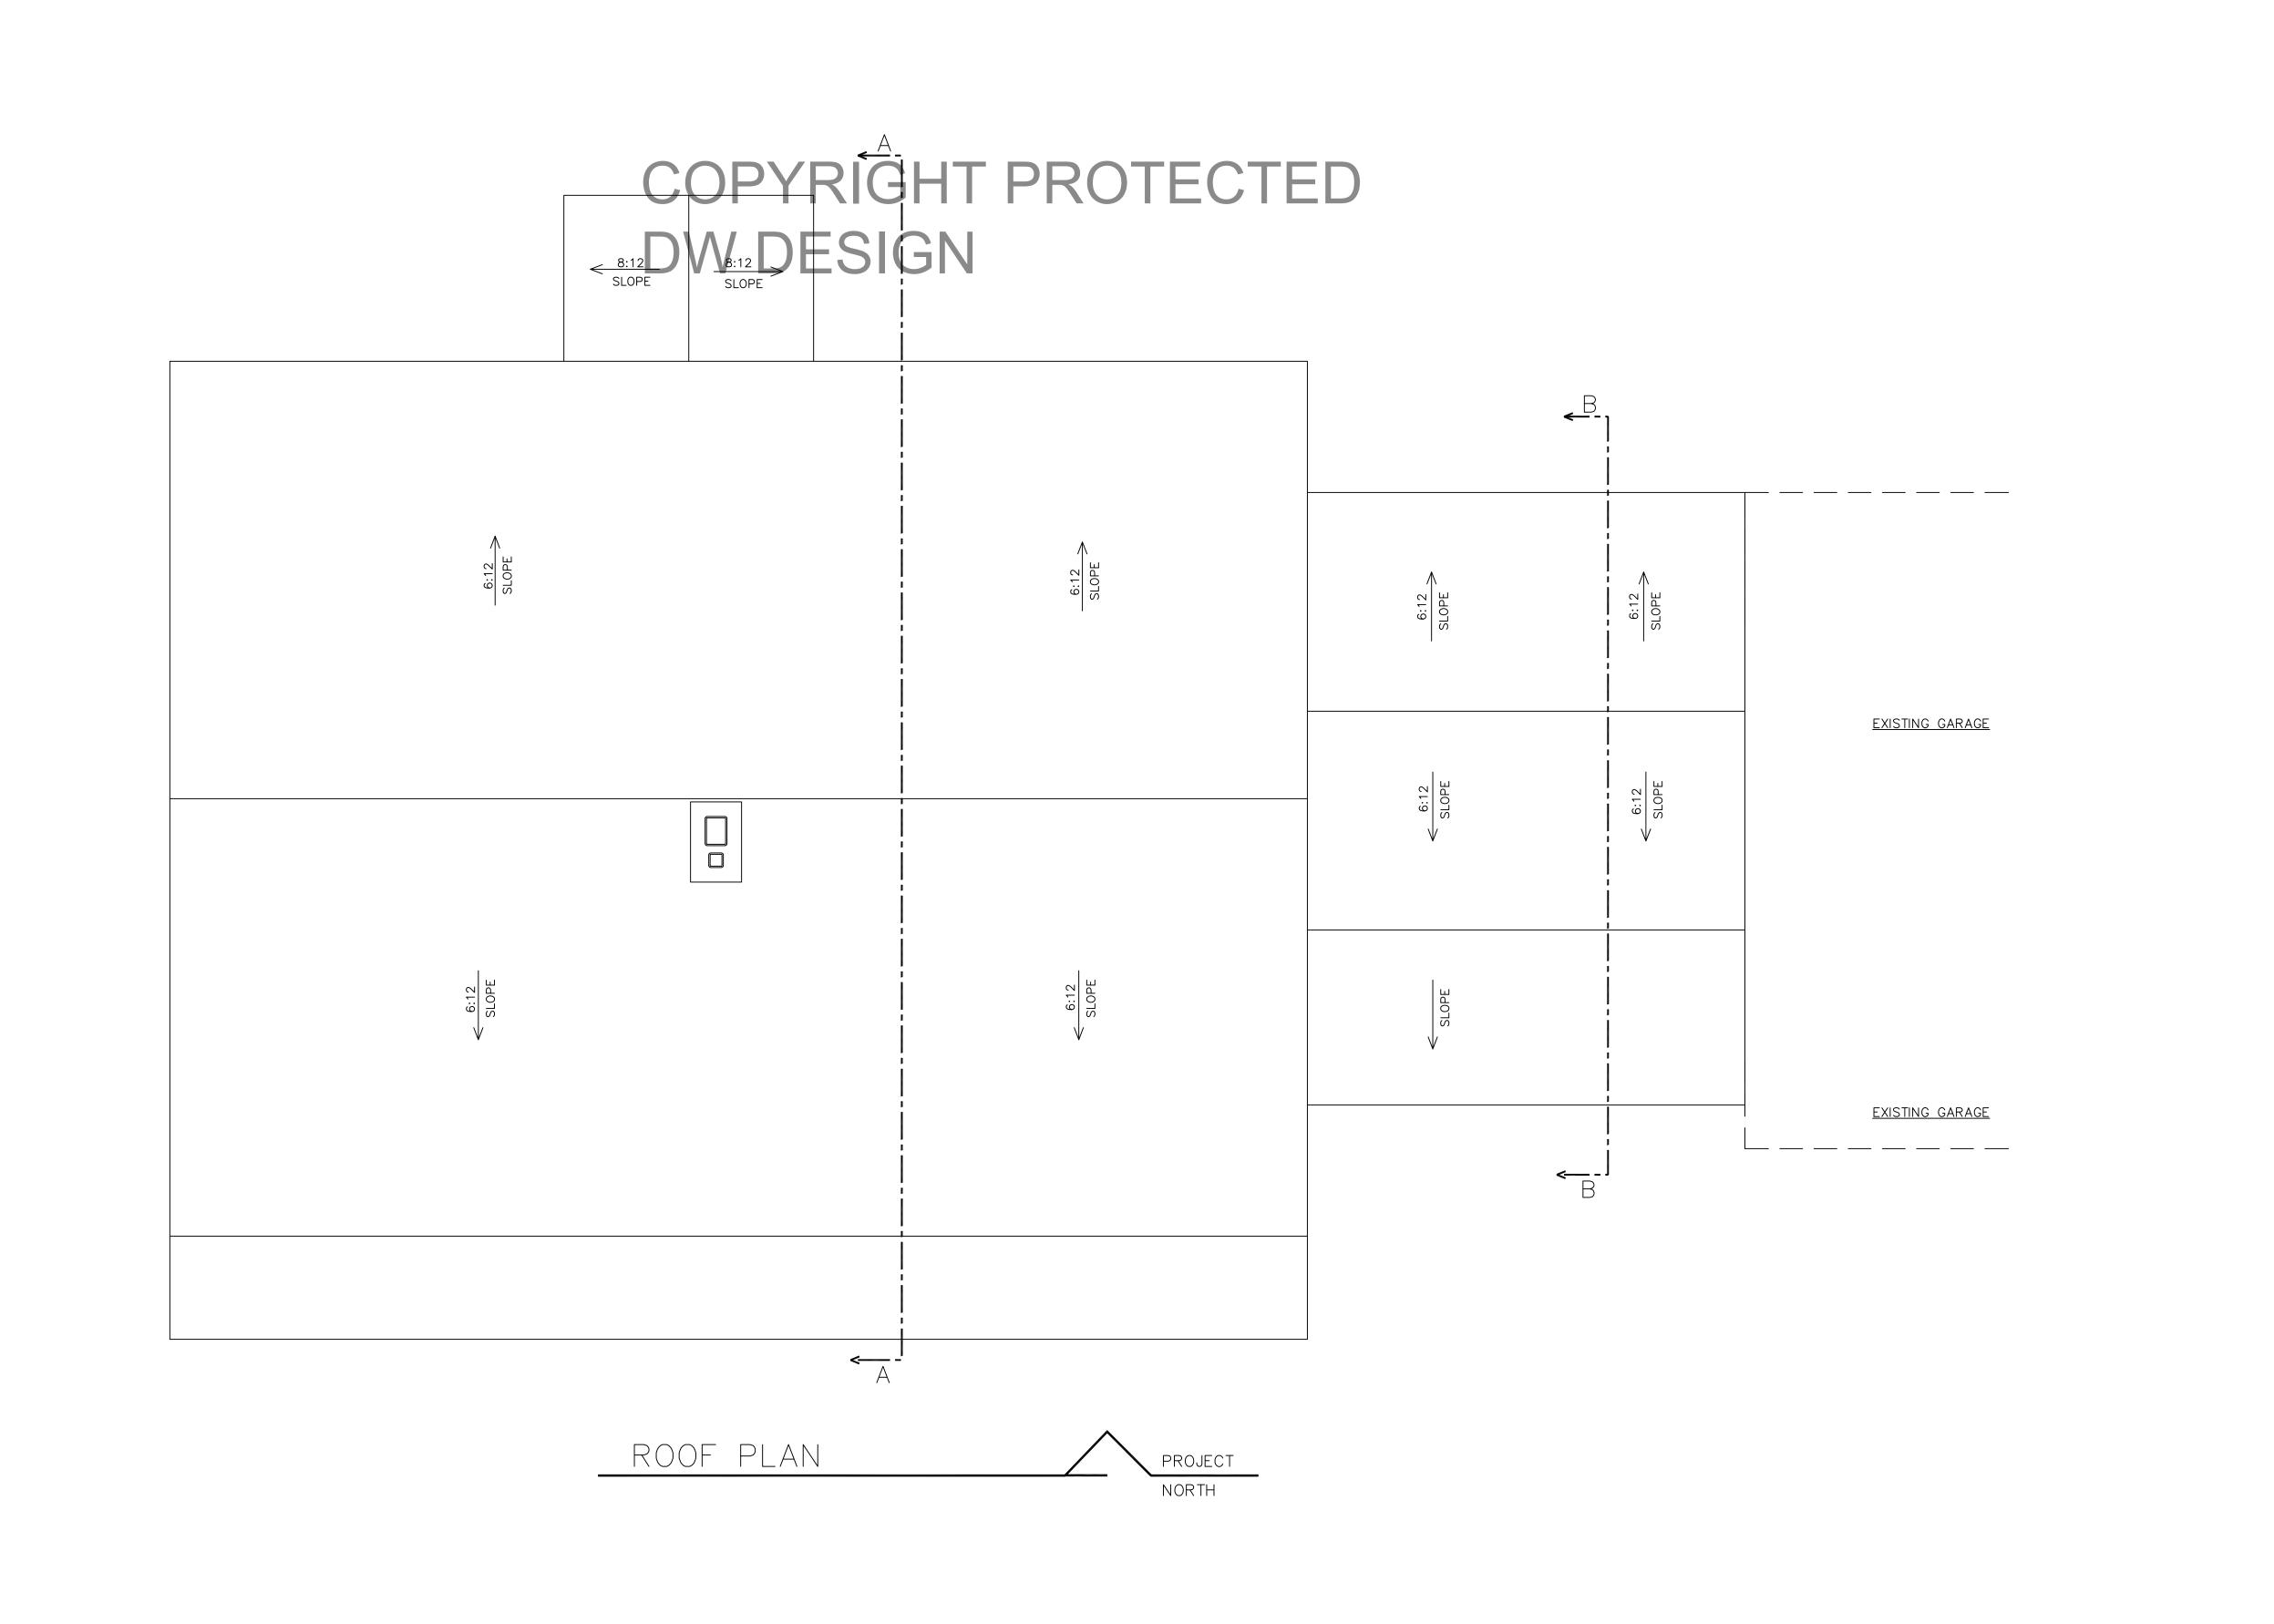

SCALE: 1/4" = 1'-O"

DATE: 10/1/19

DATE: NUMBER & DISCRIPTION
11/8/19

DRAWN BY: DEW

CHECKED BY: 2/20/20

CHECKED BY: 2/20/20

BELDIN RESIDENCE COLONA, IL 61241

DW TIMBER
TIMBER FRAME 8

**A-4** 

DO NOT SCALE DIMENSIONS ON THESE DRAWINGS. THESE IMAGES ARE MACHINE REPRODUCTIONS AND MAY CONTAIN A MARGIN OF ERROR.

COPYRIGHT LAWS PROHIBIT REPRODUCTION OR USE OF THIS DRAWING, IN WHOLE OR IN PART, WITHOUT THE EXPRESSED WRITTEN PERMISSION OF DW TIMBER FRAME DESIGN

#### COPYRIGHT PROTECTED DW DESIGN



SOUTH ELEVATION


DO NOT SCALE DIMENSIONS ON THESE COPYRIGHT LAWS PROHIBIT REPRODUCTION OR USE OF THIS DRAWING, DRAWINGS. THESE IMAGES ARE IN WHOLE OR IN PART, WITHOUT THE EXPRESSED WRITTEN PERMISSION MACHINE REPRODUCTIONS AND MAY CONTAIN A MARGIN OF ERROR. OF DW TIMBER FRAME DESIGN

I RESIDENCE A, IL 61241 BELDIN

DW TIMBER FRAME DESIGN TIMBER FRAME & PANEL HOME DESI

**A-5** 

### COPYRIGHT PROTECTED DW DESIGN

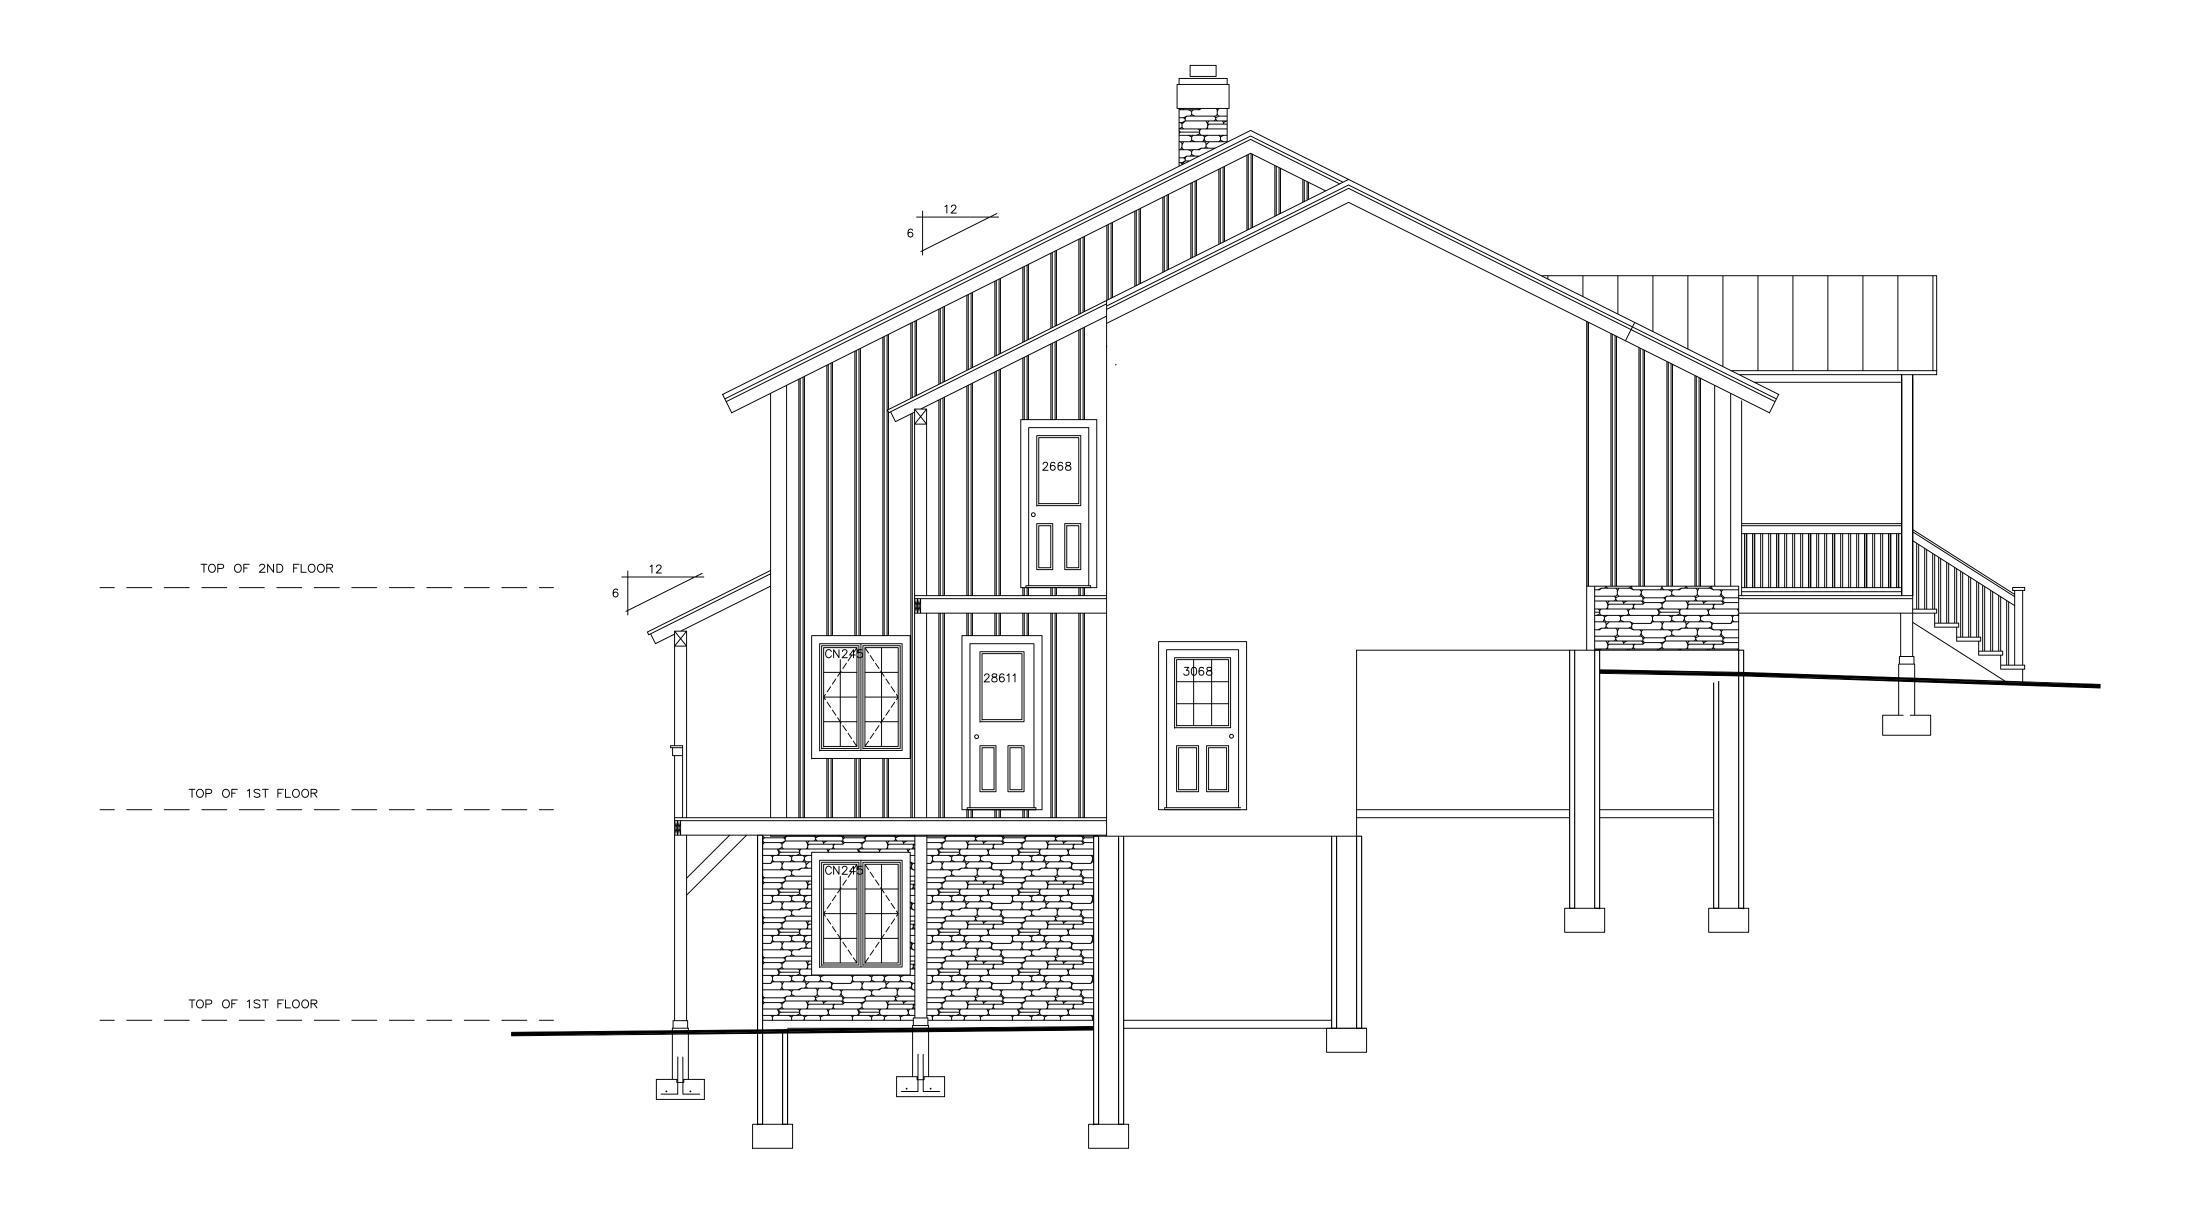

EAST ELEVATION


•	7/18	DEW	
	10/1/	BY:	CHECKED BY:
	DATE	DRAWN BY:	CHECK

I RESIDENCE A, IL 61241 BELDIN

DO NOT SCALE DIMENSIONS ON THESE DRAWINGS. THESE IMAGES ARE MACHINE REPRODUCTIONS AND MAY CONTAIN A MARGIN OF ERROR.

COPYRIGHT LAWS PROHIBIT REPRODUCTION OR USE OF THIS DRAWING, IN WHOLE OR IN PART, WITHOUT THE EXPRESSED WRITTEN PERMISSION OF DW TIMBER FRAME DESIGN

# COPYRIGHT PROTECTED DW DESIGN

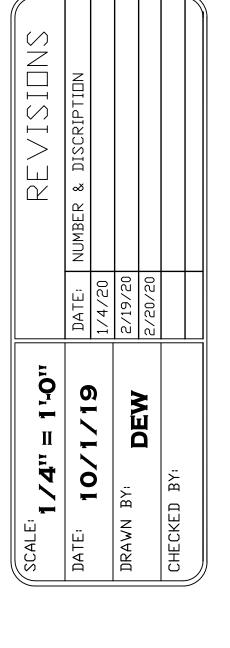


SIDENCE L 61241

BEL! COL

DW TIMBER FRAME DESIGN BER FRAME & PANEL HOME DESIGN

**A-7** 

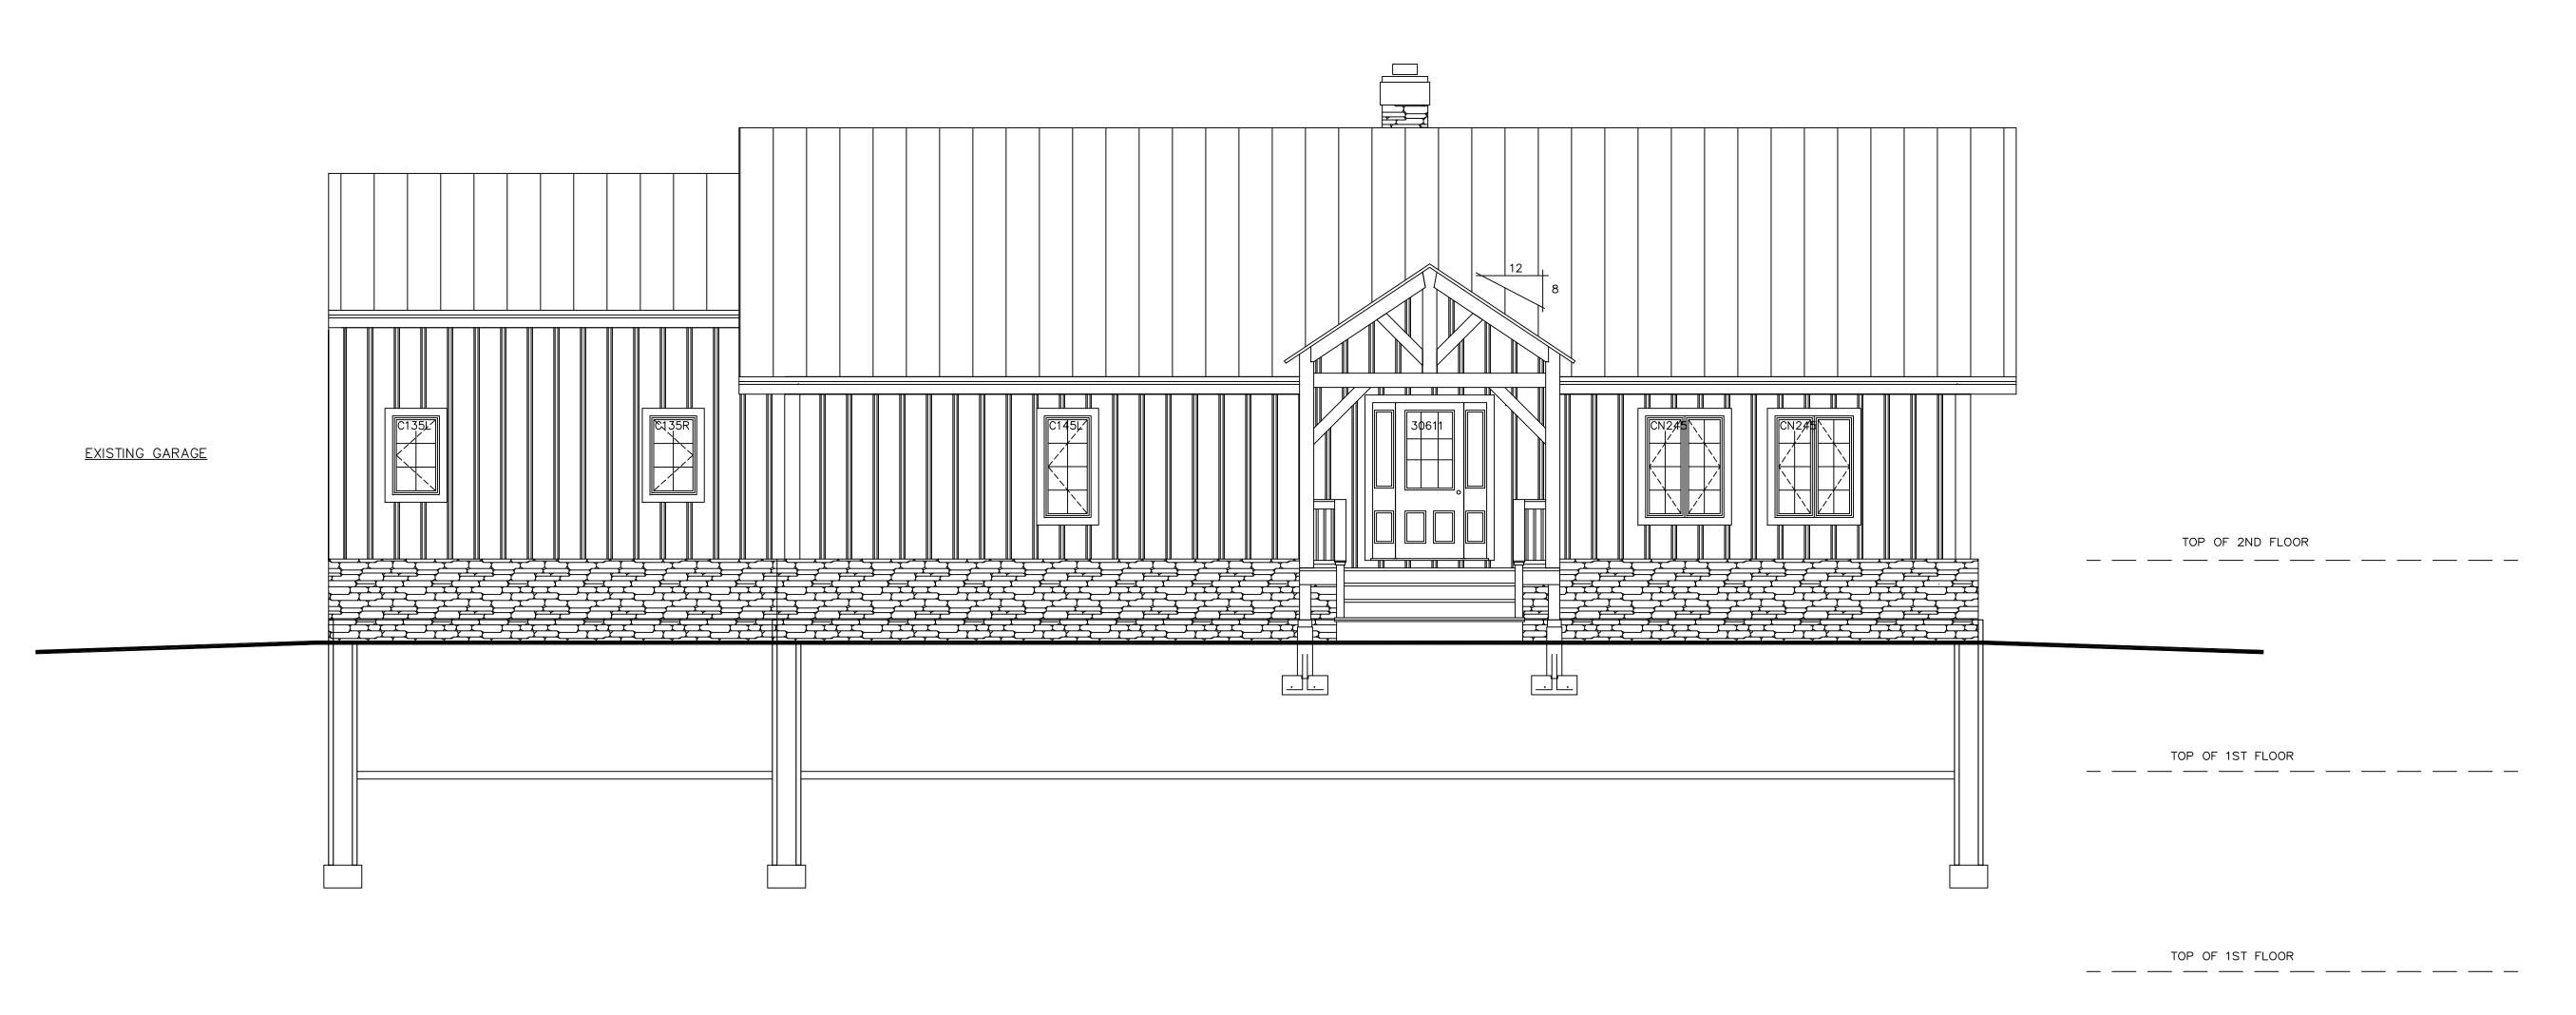


NORTH ELEVATION

COPYRIGHT LAWS PROHIBIT REPRODUCTION OR USE OF THIS DRAWING, IN WHOLE OR IN PART, WITHOUT THE EXPRESSED WRITTEN PERMISSION OF DW TIMBER FRAME DESIGN

DO NOT SCALE DIMENSIONS ON THESE DRAWINGS. THESE IMAGES ARE MACHINE REPRODUCTIONS AND MAY CONTAIN A MARGIN OF ERROR.

# COPYRIGHT PROTECTED DW DESIGN

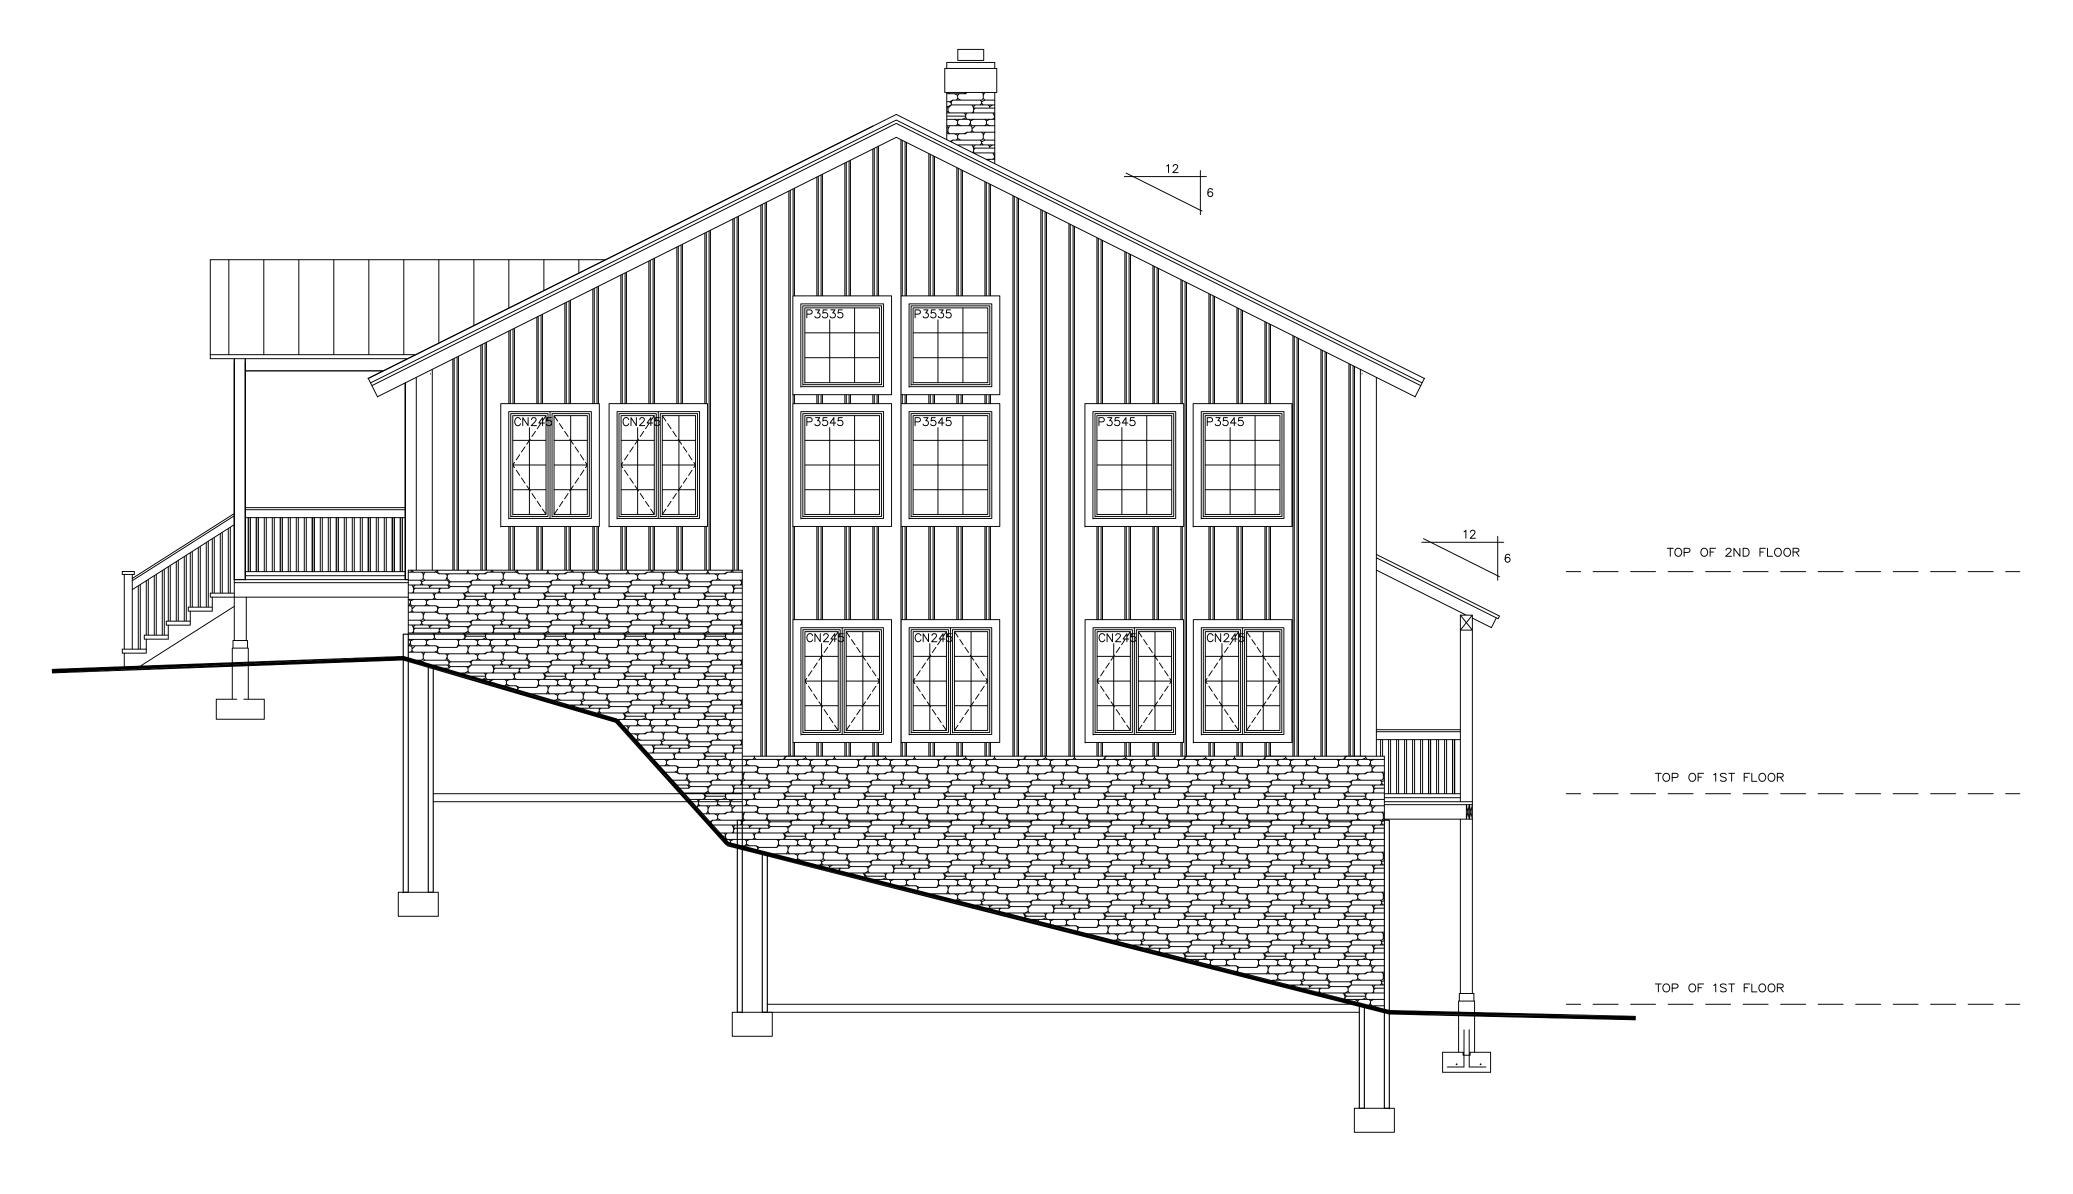

WEST ELEVATION


COPYRIGHT LAWS PROHIBIT REPRODUCTION OR USE OF THIS DRAWING, IN WHOLE OR IN PART, WITHOUT THE EXPRESSED WRITTEN PERMISSION OF DW TIMBER FRAME DESIGN


SCALE: 1/4" = 1'-0"		REVISIONS
DATE: 10/1/19	DATE	DATE: NUMBER & DISCRIPTION
	1/4/20	
DRAWN BY:	2/19/20	
Y I	2/20/20	
CHECKED BY:		
<i></i>		

BELDIN RESIDENCE
COLONA, IL 61241

DW TIMBER FRAN BER FRAME & PANEI

Δ-8

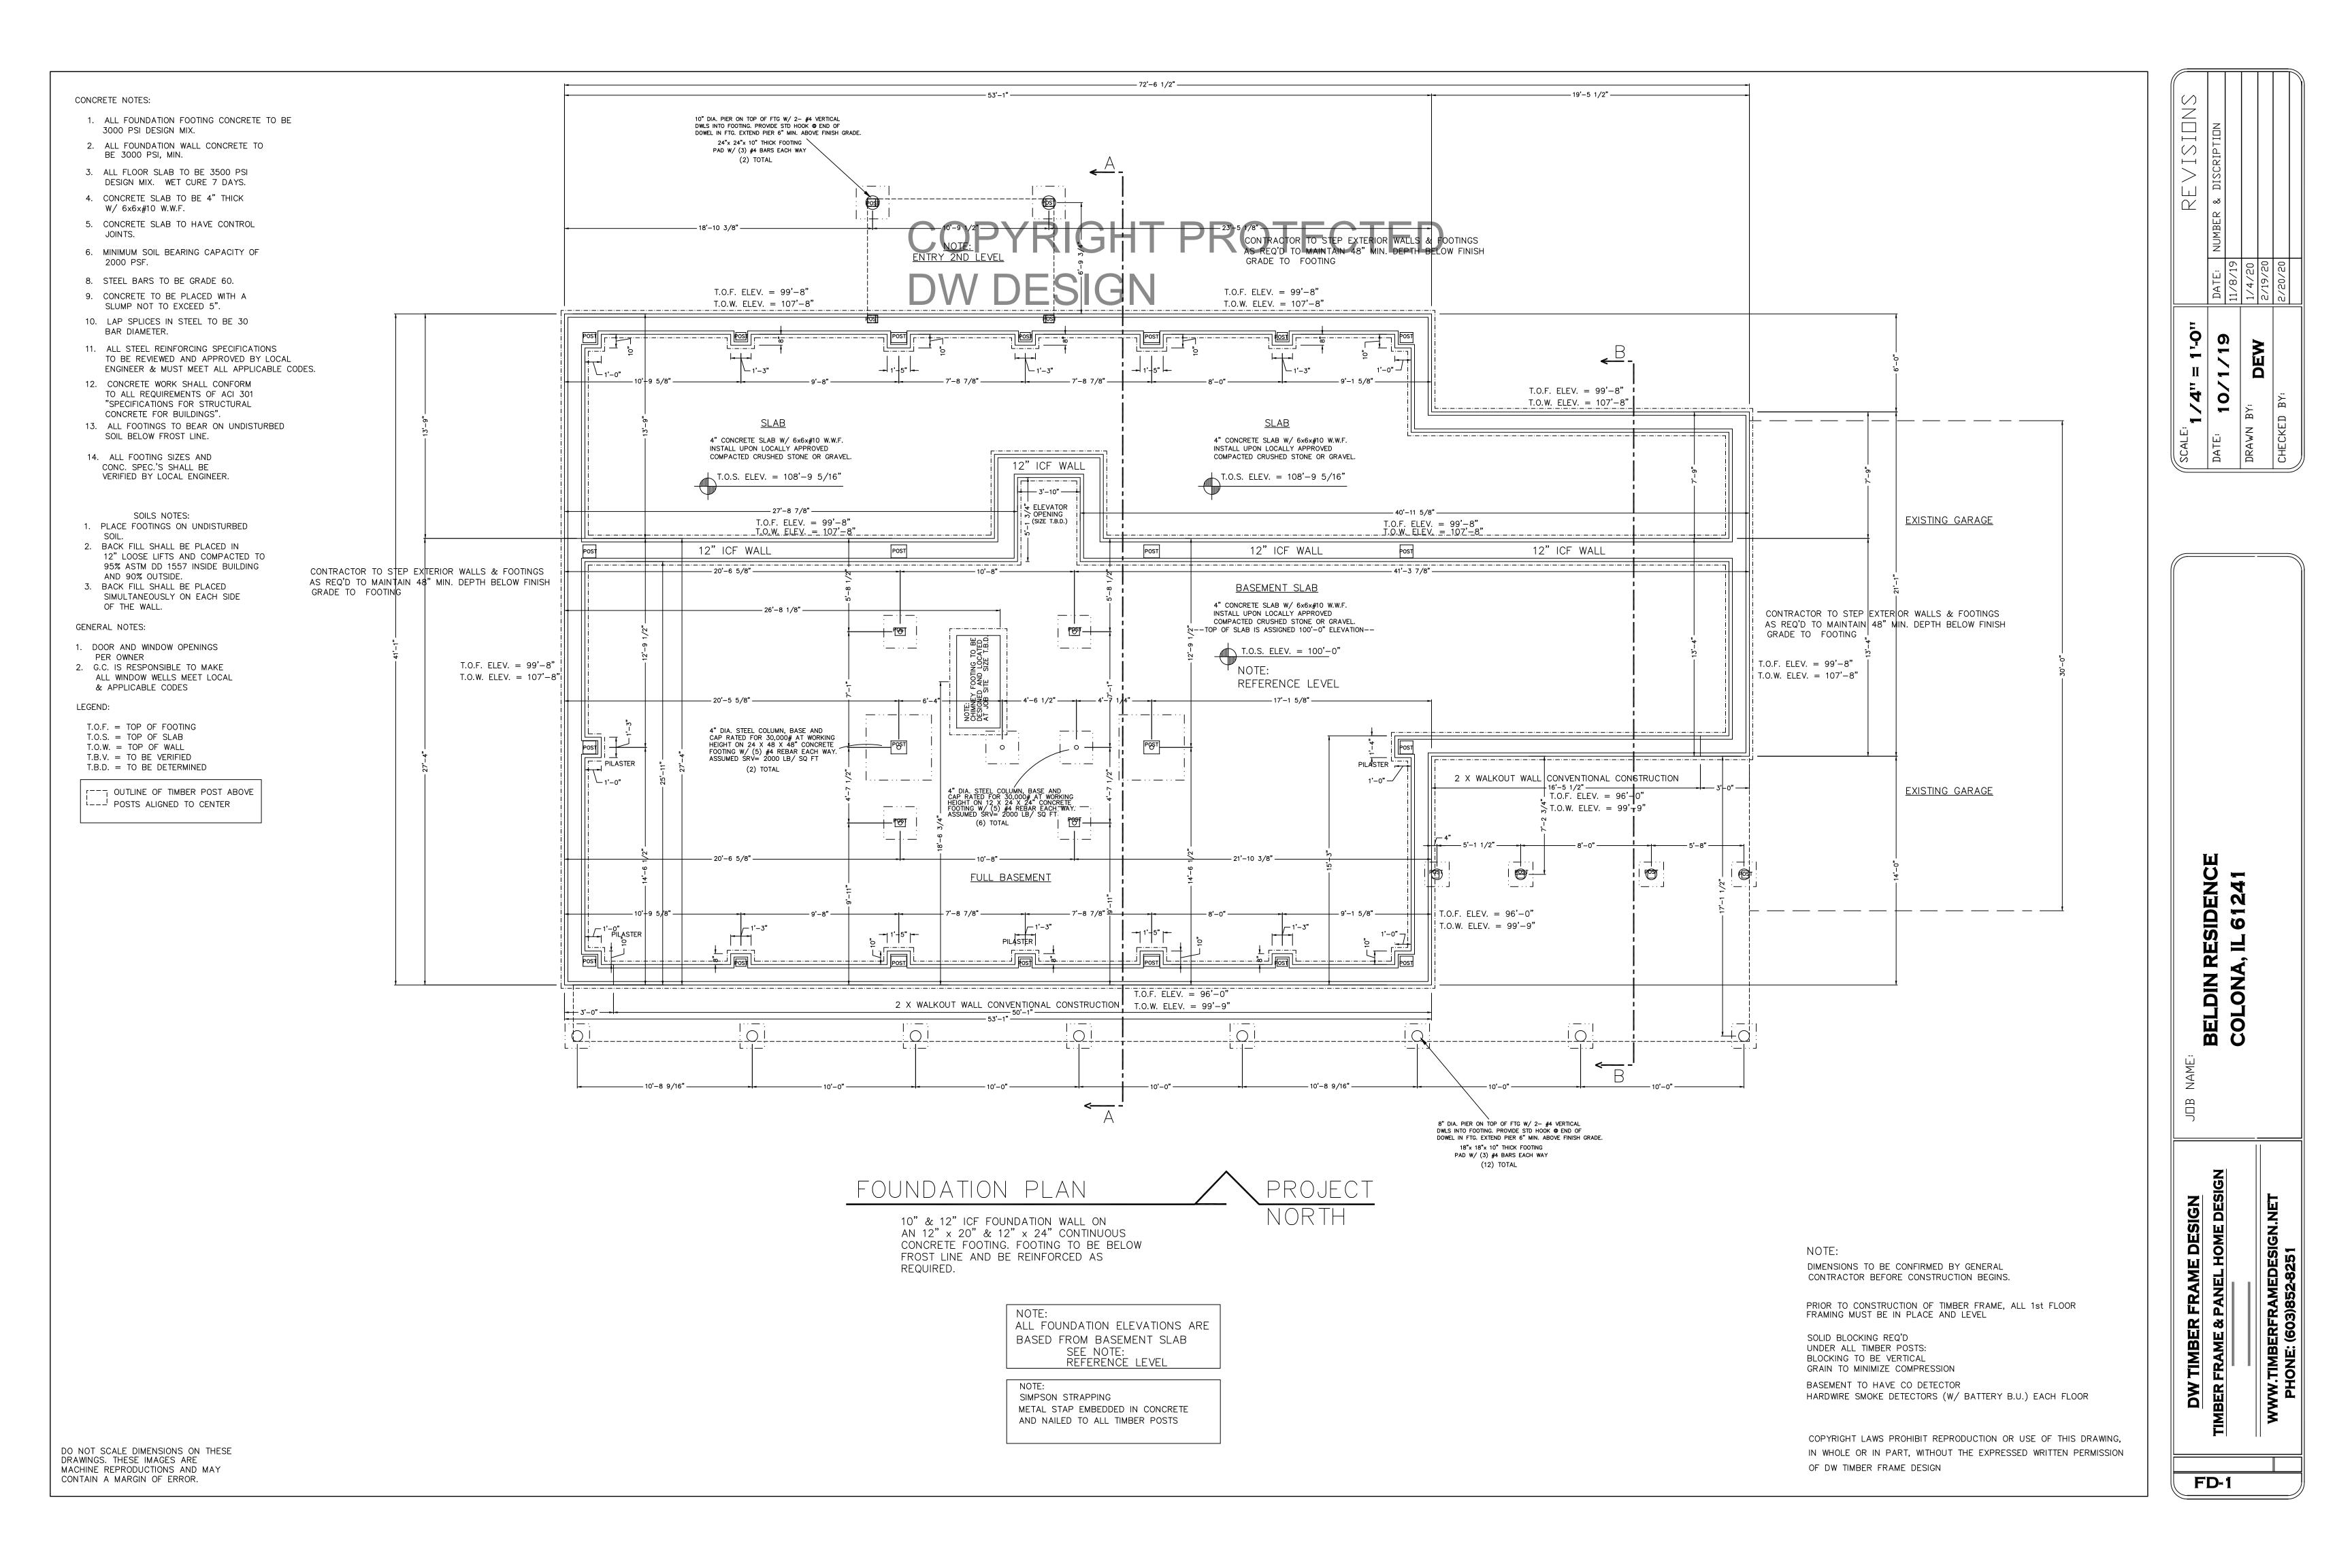

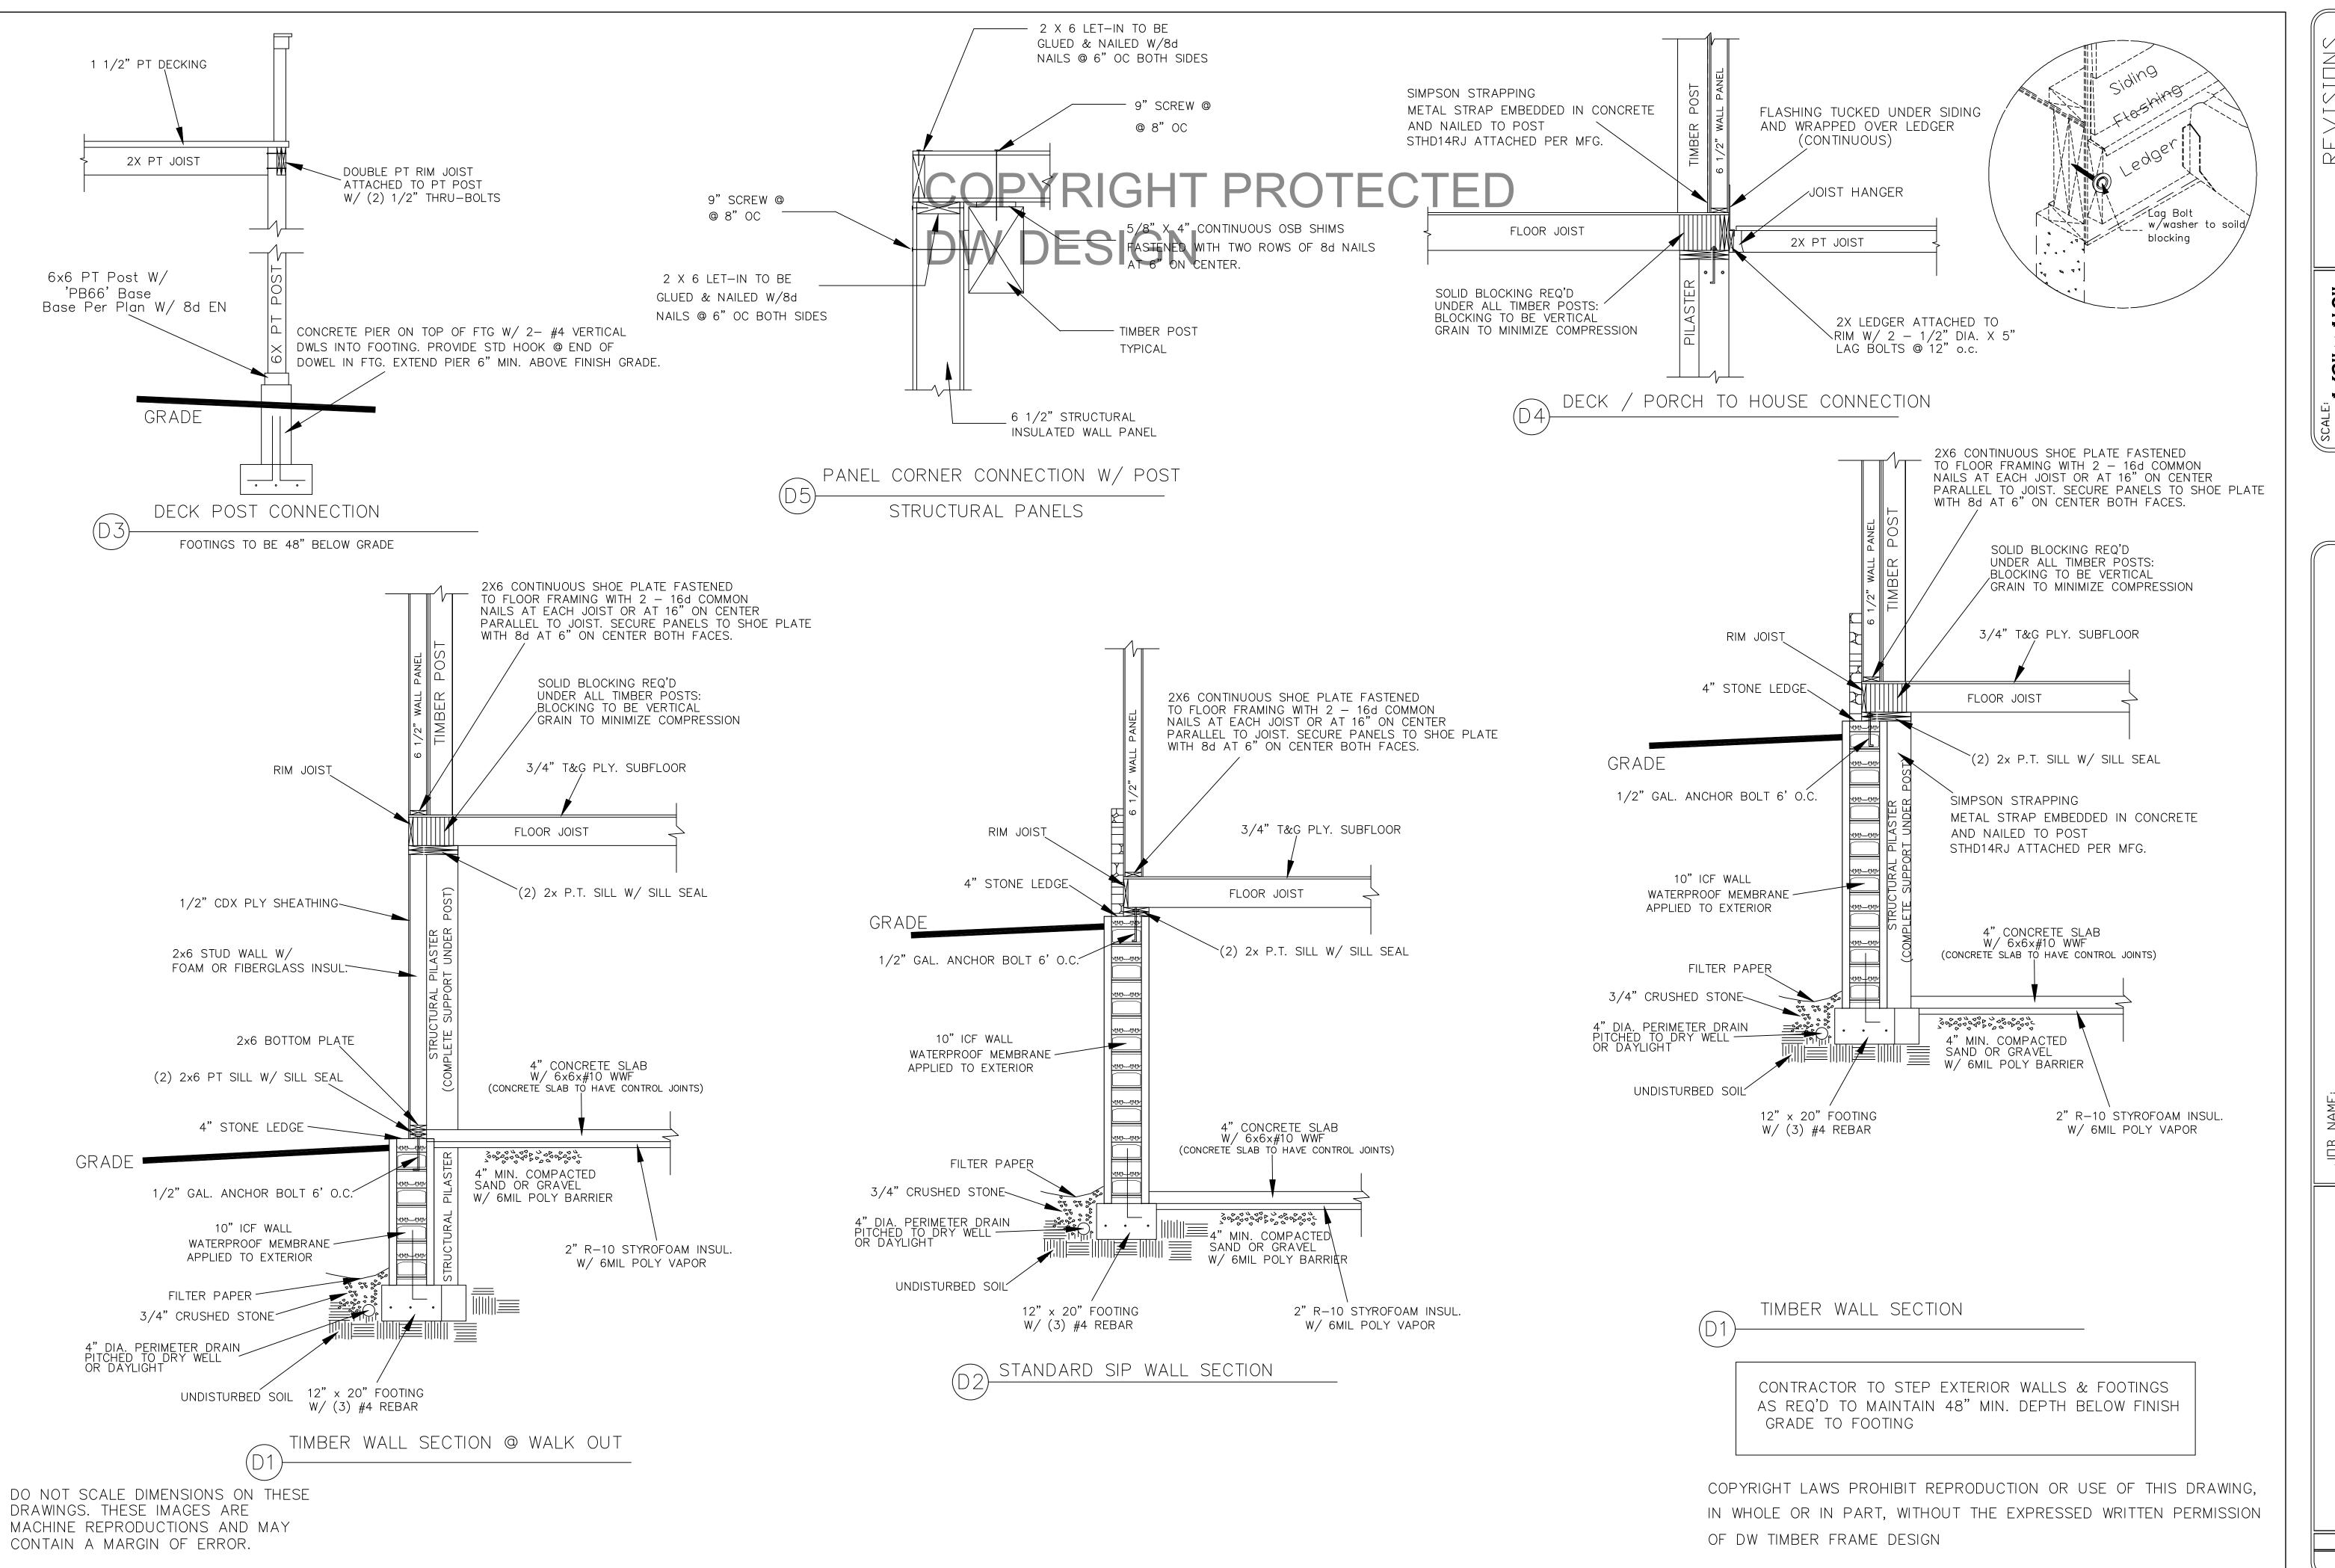

SION VI. 

RESIDENCE

BELDIN

F DESIGN HOME DES

FD-2

#### FLOOR FRAMING NOTES:

- 1. DIMENSIONS TO BE CONFIRMED BY GENERAL CONTRACTOR BEFORE CONSTRUCTION BEGINS.
- 2. VERIFY PT SILL OVERHANG OUTSIDE OF CONCRETE PER DETAIL(S). VERIFY RIM JOIST OFFSET FROM EDGE OF PT SILL PER DETAIL(S).
- 3. DIMENSIONAL RIM JOIST TO BE KD SPF#2 OR BETTER. 4. EXTERIOR DIMENSIONS SHOWN ARE
- TO OUTSIDE OF RIM JOISTS.
- 5. REFER TO FOUNDATION DETAILS FOR MORE INFORMATION.
- 6. PROVIDE SOLID BLOCKING & CONTINUOUS SUPPORT BELOW ALL TIMBER POSTS. LOCATIONS ARE INDICATED ON THE
- TIMBER FRAMING PLAN. 7. ALL COLUMNS MUST BE IN PLACE PRIOR TO GIRDER INSTALLATION.
- 8. CROSS BRIDGING WHERE REQUIRED BY CODE. 9. HEARTH FRAMING TO BE DETERMINED BY BUILDER & MASON.
- 10. REFER TO JOIST/BEAM MANUFACTURER'S LITERATURE FOR PROPER FRAMING DETAILS & SPECIFICATIONS, INSTALLING BLOCKING, SQUASH BLOCKS/WEB STIFFENERS, ETC.
- AS REQUIRED. 11. REFER TO JOIST MANUF. LITERATURE FOR SPECIFICATIONS FOR CUTTING HOLES IN
- JOIST WEB. 12. FASTEN ALL MANUFACTURED FLOOR FRAMING MATERIALS PER MANUF. SPECIFICATIONS.


[--- OUTLINE OF TIMBER POST ABOVE L--- POSTS ALIGNED TO CENTER

DO NOT SCALE DIMENSIONS ON THESE


MACHINE REPRODUCTIONS AND MAY


DRAWINGS. THESE IMAGES ARE

CONTAIN A MARGIN OF ERROR.

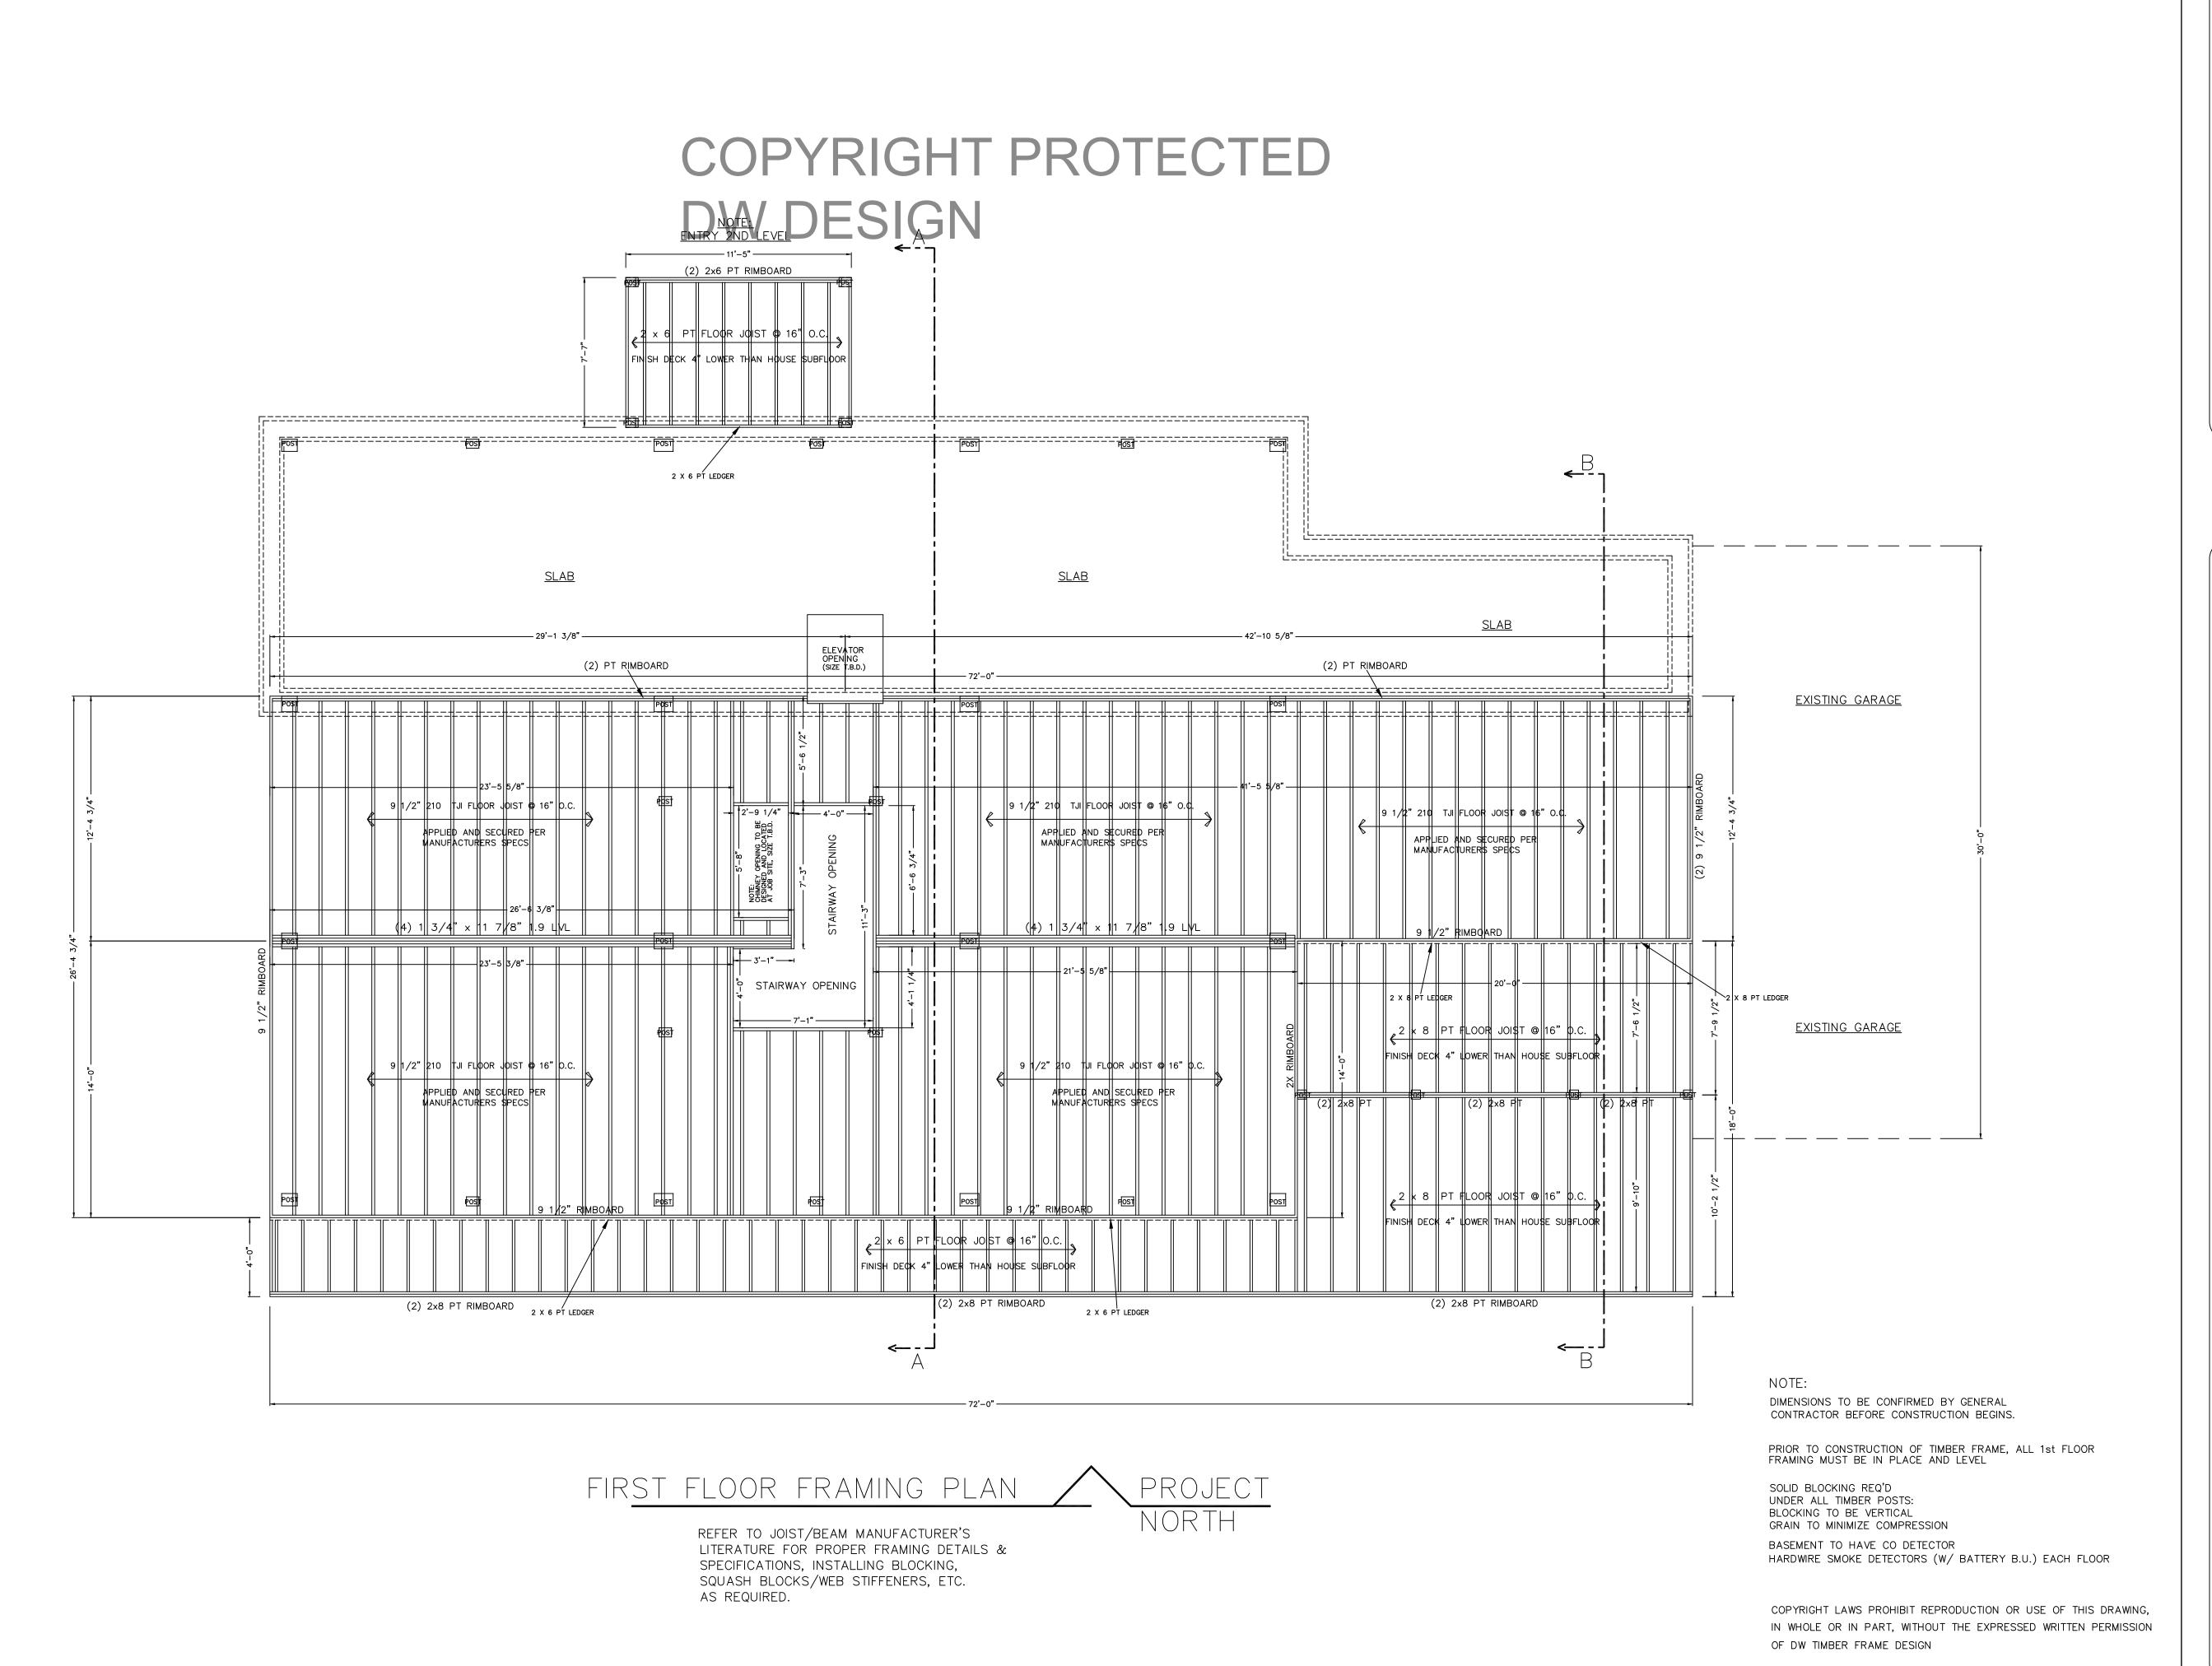

ESIDENCE IL 61241 BELDIN COLONA

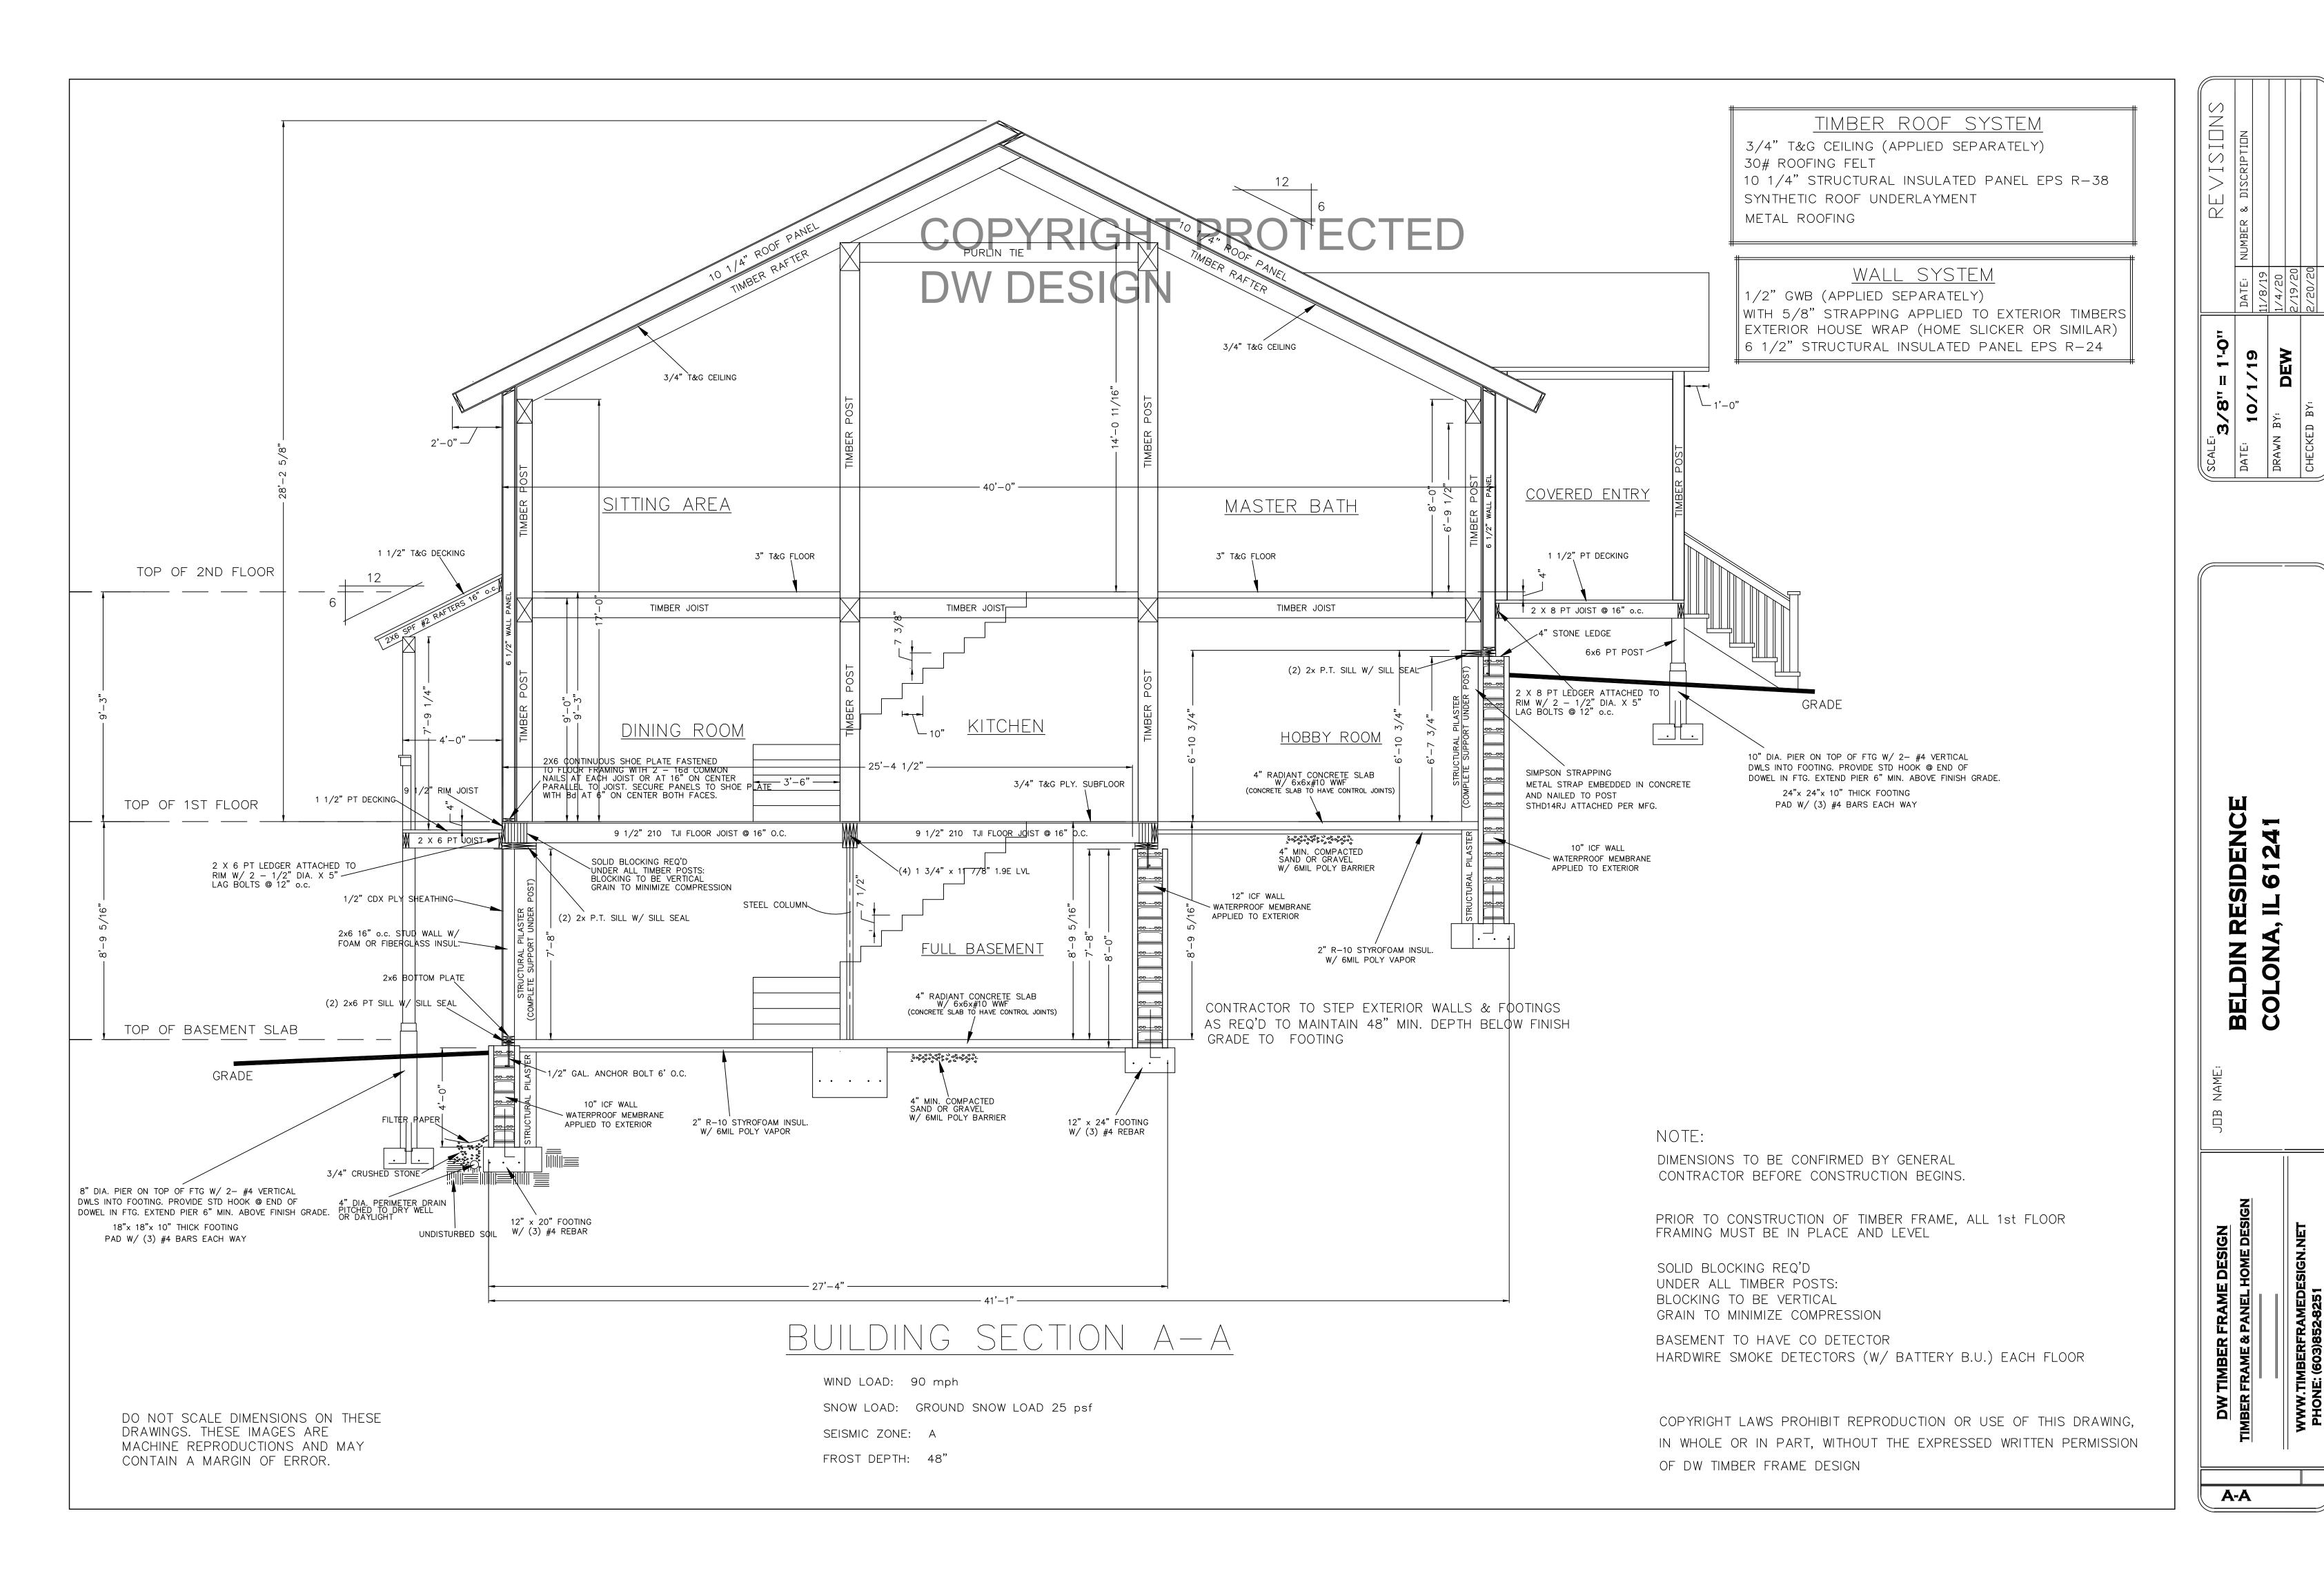

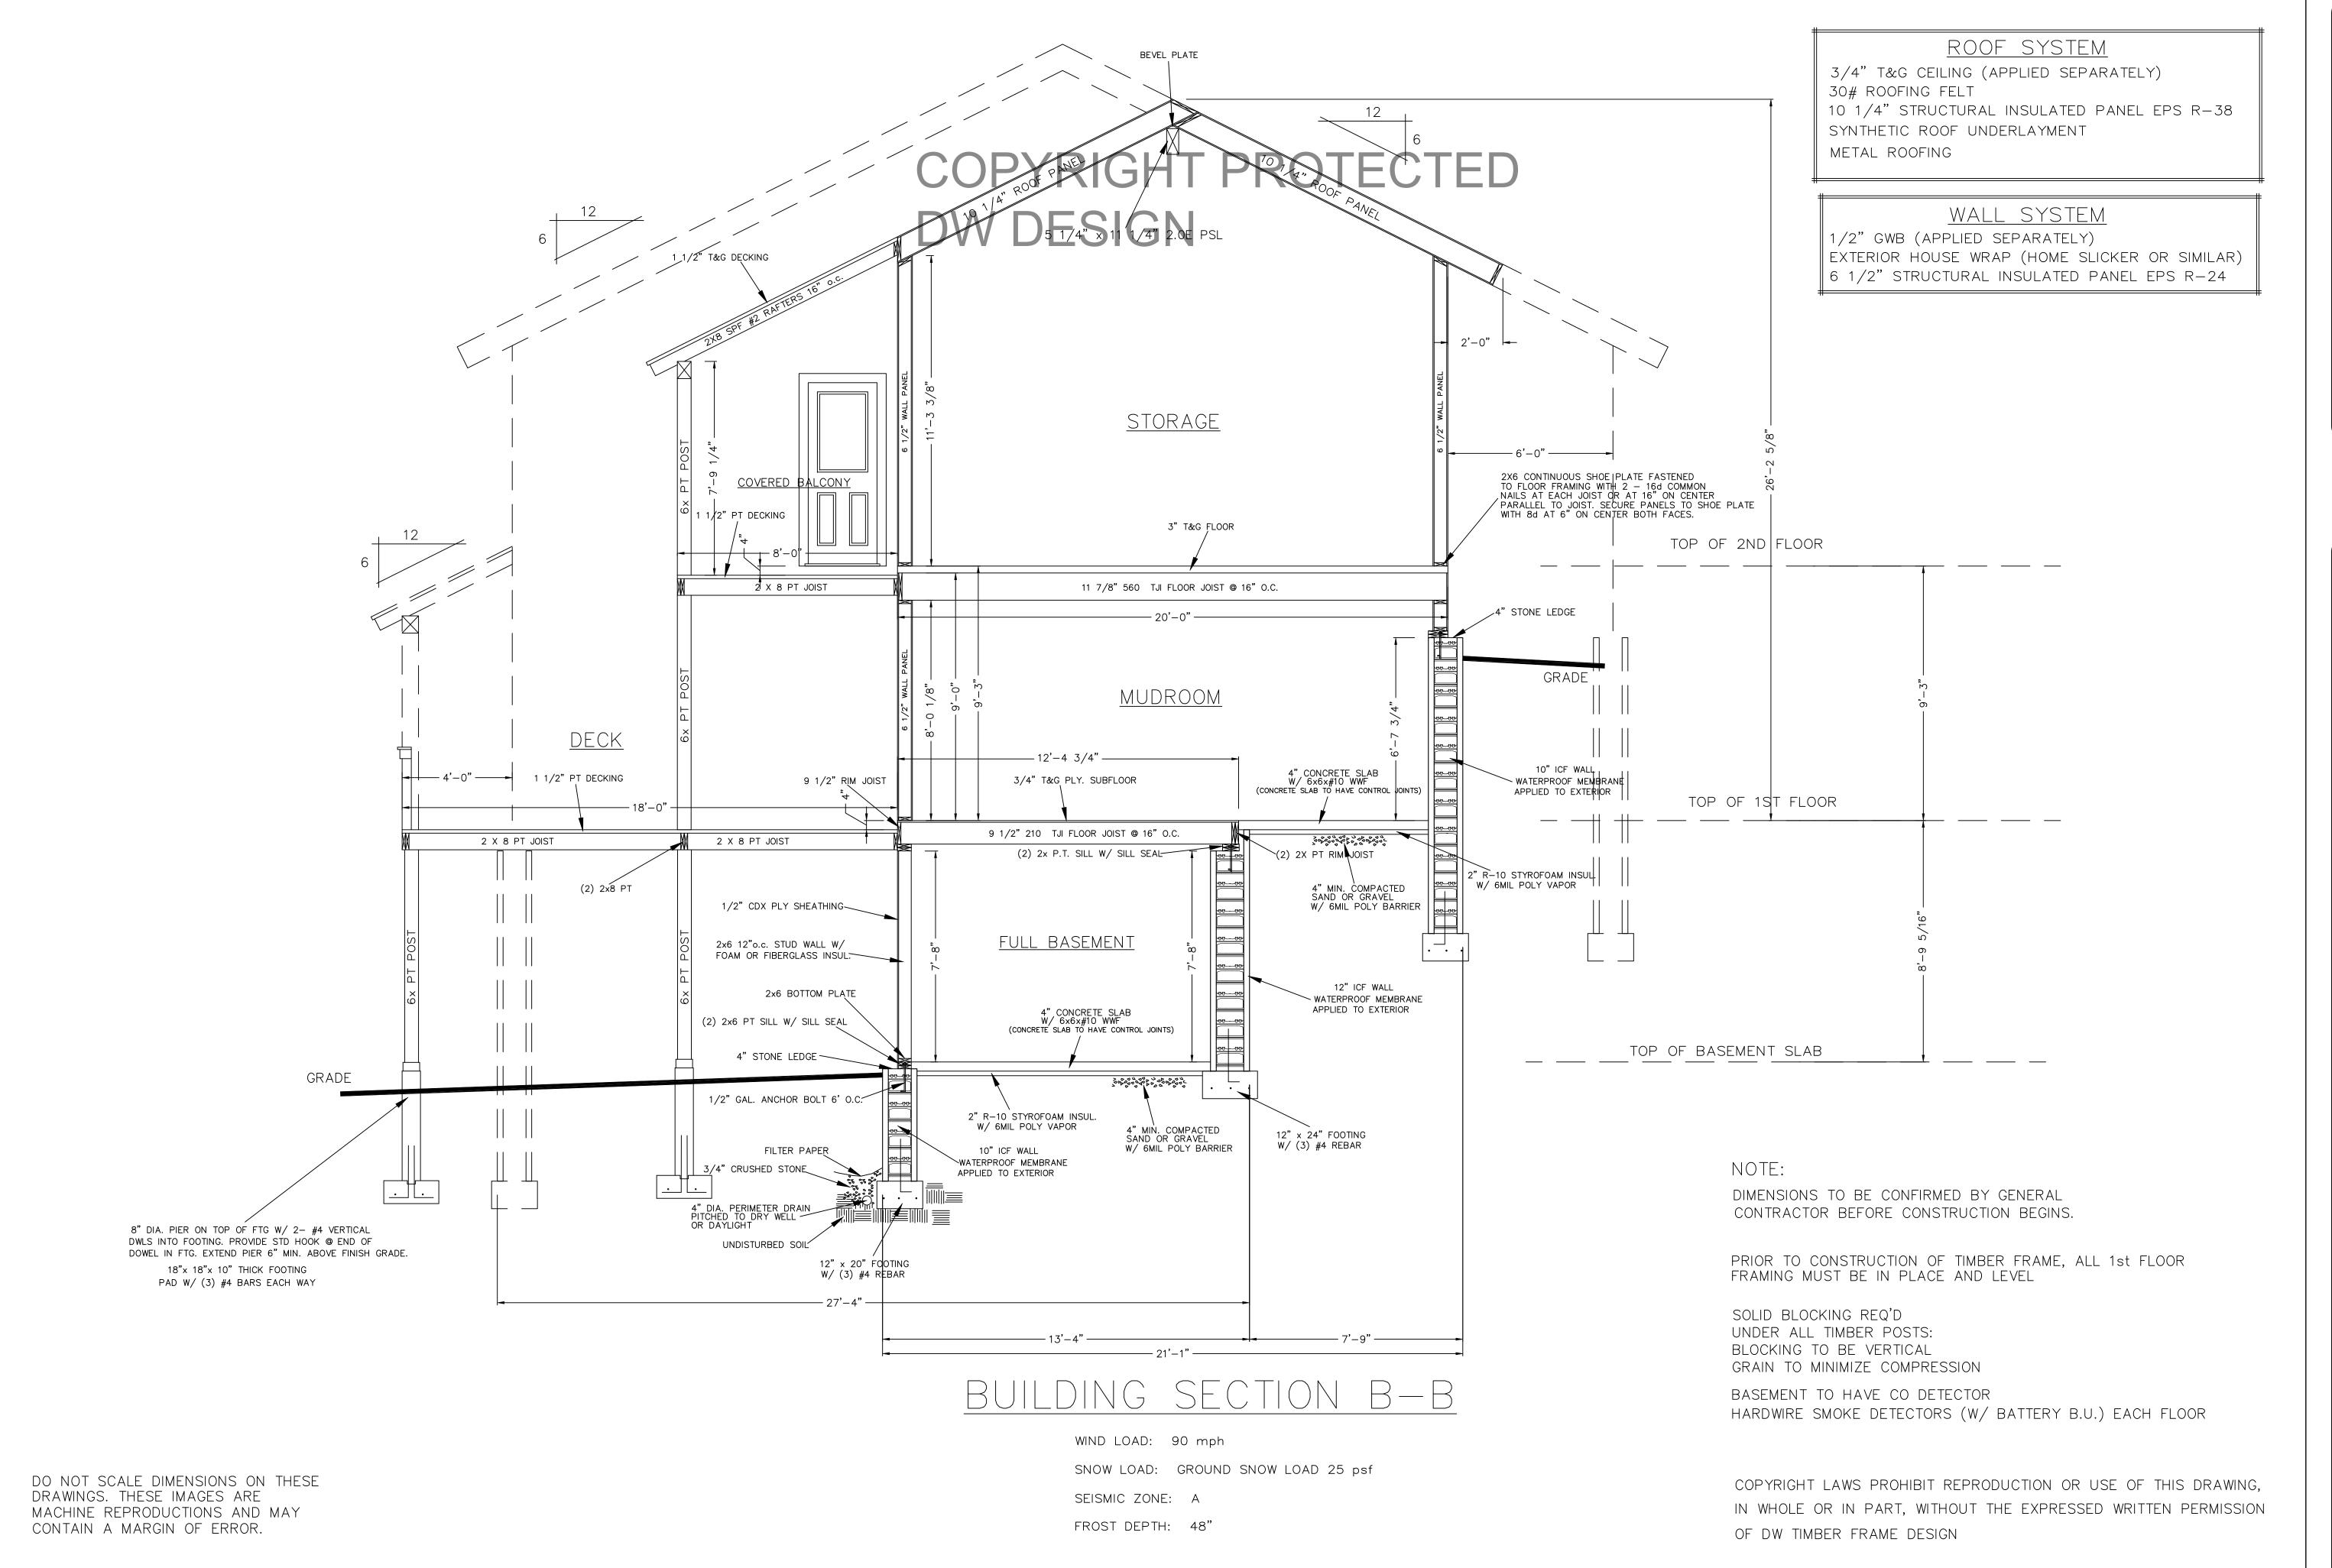

SNOISIA A H

> С Н SIDEN L 6124 NO BEL COL

DW TIMBER FRAME DESIGN TIMBER FRAME & PANEL HOME DES

B-B