
COPYRIGHT PROTECTED PRESTERO RESIDENCE DW DESIGN QUINCY, FL

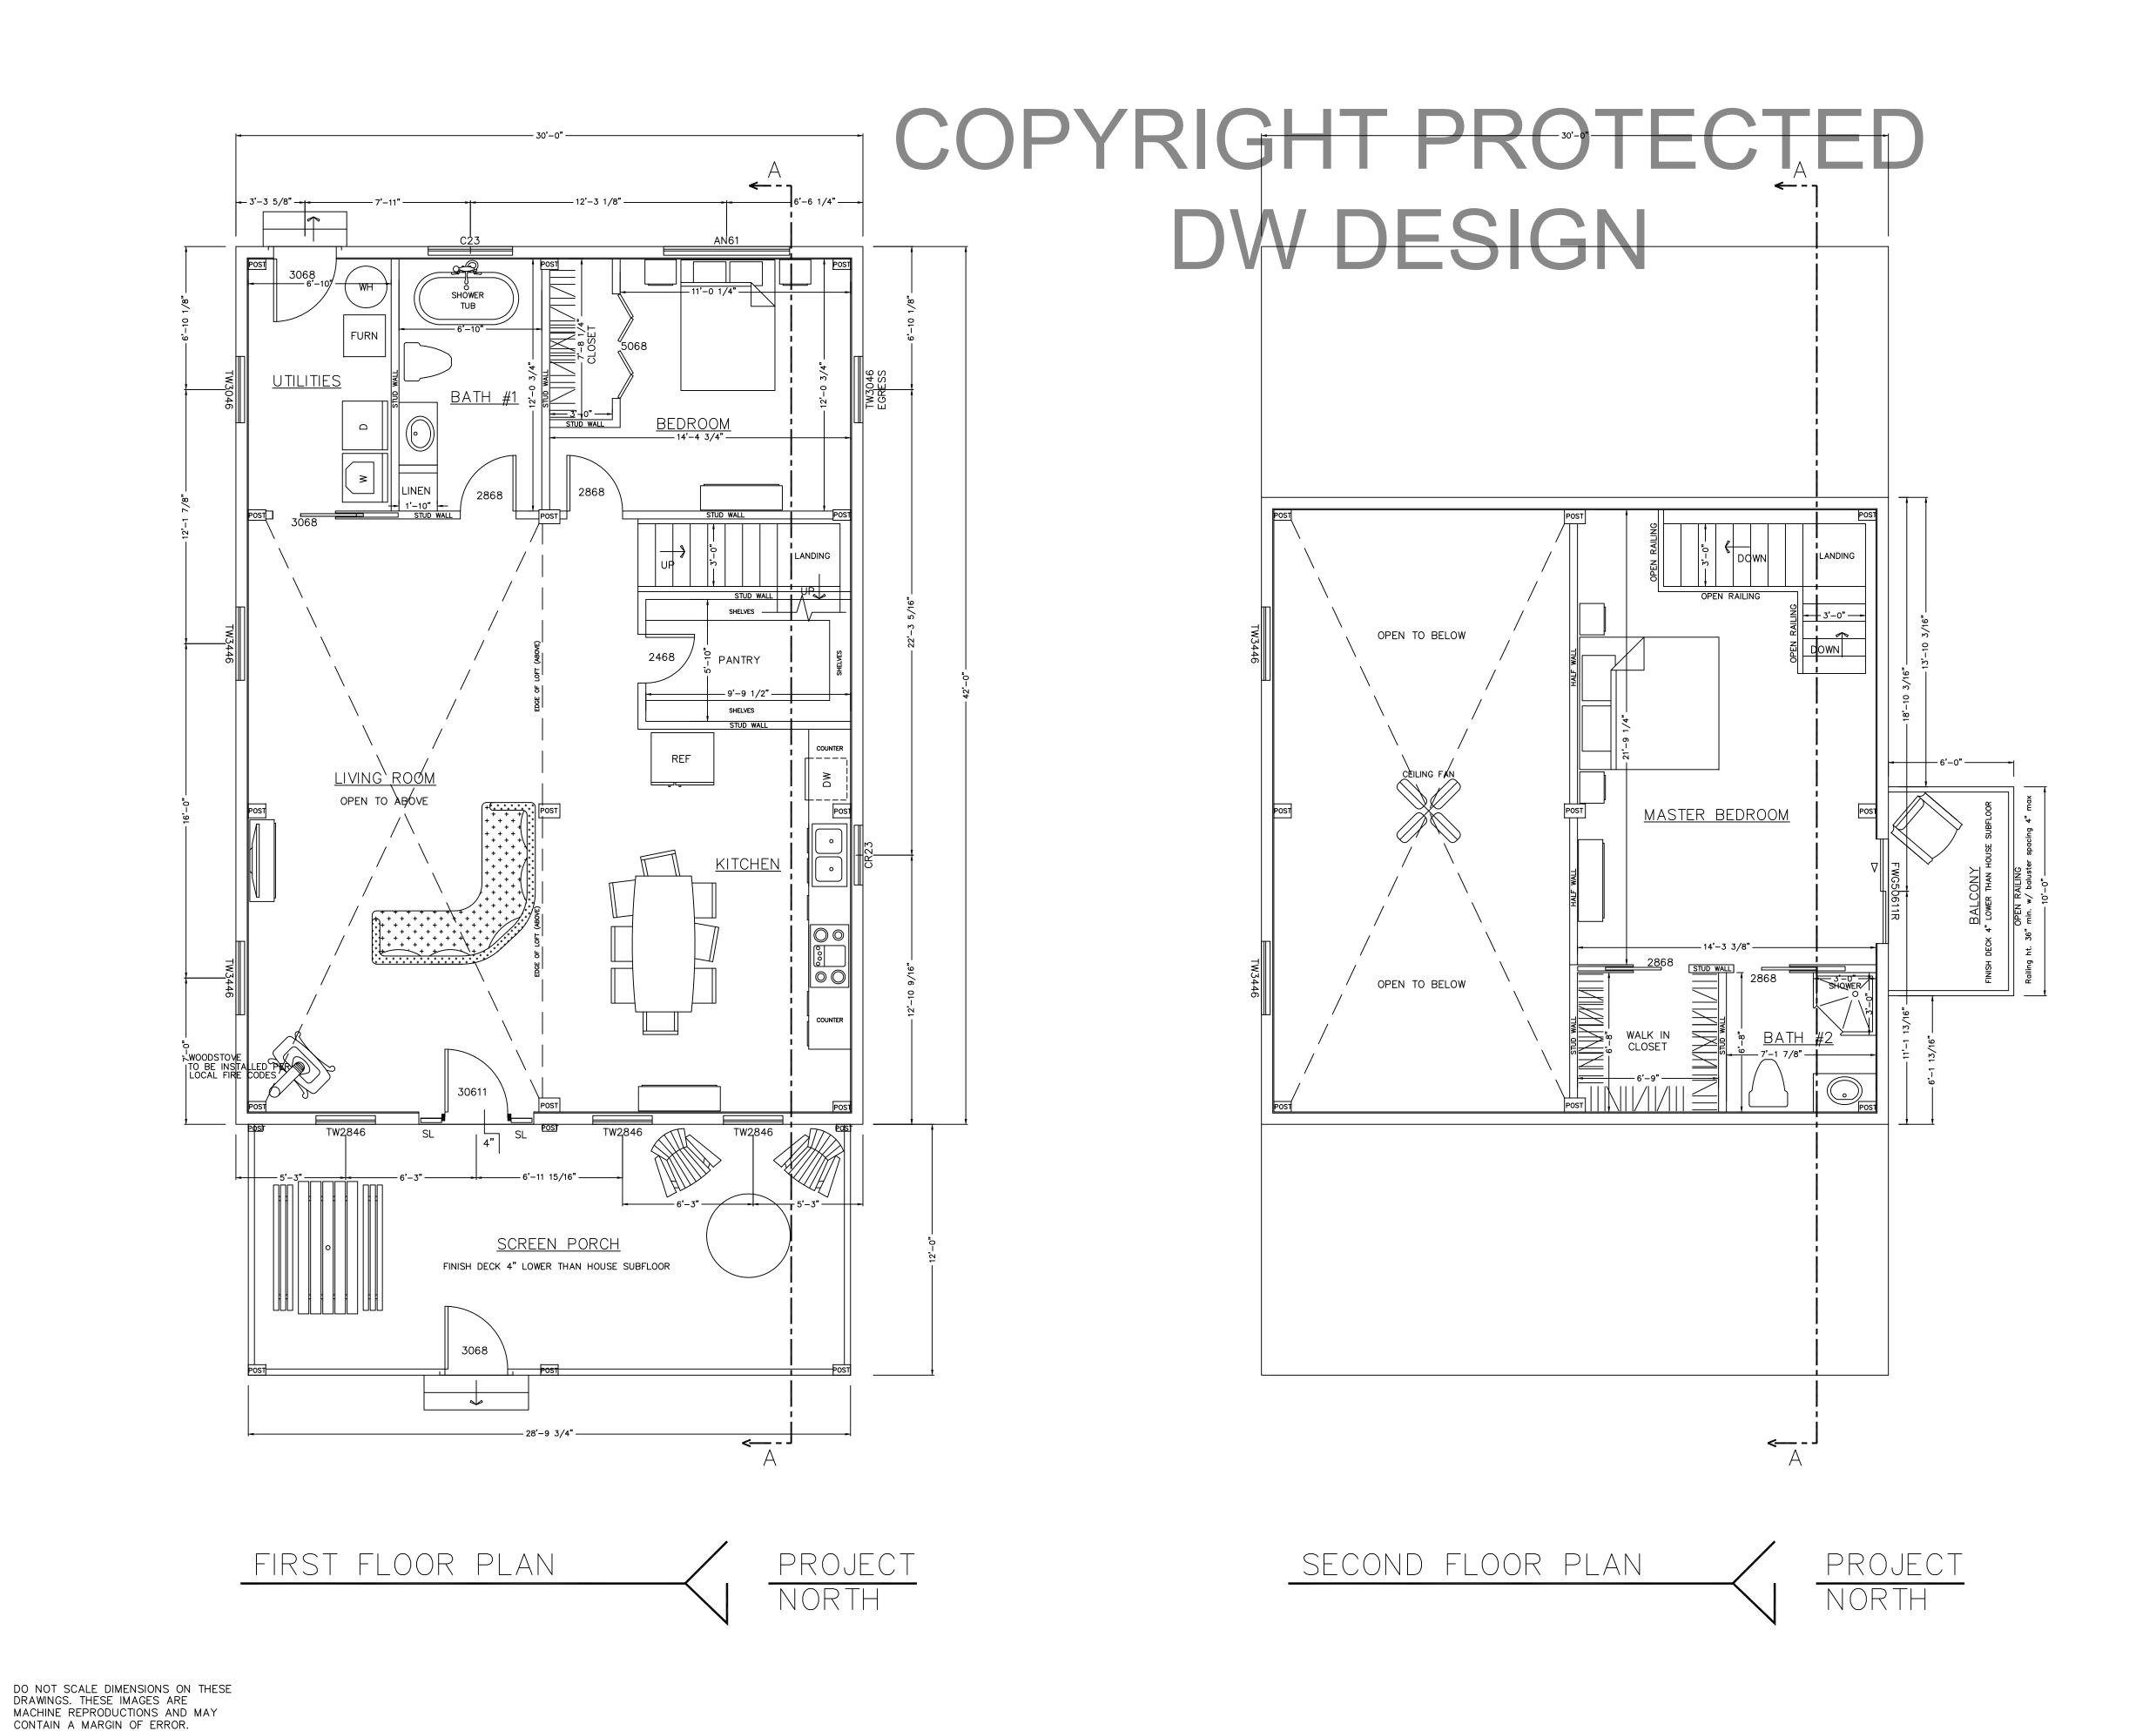

FINAL LOCATION OF ALL INTERIOR PARTITIONS TO BE DETERMINED AT SITE.

ALL EXTERIOR DECKS, STEPS, RAILS AND SUPPORTS
SHOULD MEET STATE AND LOCAL CODES

LOCATION AND ENGINEERING OF ANY RETAINING WALLS IS BY OTHERS (B.O.)

ANY CONSTRUCTION BY OTHERS NOTED AS TO BE VERIFIED FOR ACCURACY BY THE OWNER AND/OR BUILDER.

THE STAIR RISER AND TREAD DIMENSIONS
ARE CALCULATED FROM THE TOP OF THE
1ST FLR DECK TO THE TOP OF THE SECOND FLOOR DECK. BUILDER TO ADJUST FOR FLOOR FINISHES AS NEEDED.

FIREPLACE AND/OR WOODSTOVE INSTALLATION IS TO COMPLY WITH ALL LOCAL, STATE AND NATIONAL FIRE SAFETY CODES AND REGULATIONS.

ALL DOORS, WALLS AND CEILINGS BETWEEN
THE GARAGE AND LIVING SPACES ARE TO MEET
ALL FIRE AND SAFETY CODE REGULATIONS.

	DATE: 8/30/10	DATE: NUN	N
	61 206 19	9/10/19	
	DRAWN BY:	10/7/19	
	DFW	11/17/19	
	CHECKED BY:		
_			

PRESTERO QUINCY, FL

COPYRIGHT LAWS PROHIBIT REPRODUCTION OR USE OF THIS DRAWING, IN WHOLE OR IN PART, WITHOUT THE EXPRESSED WRITTEN PERMISSION OF DW TIMBER FRAME DESIGN

HARDWIRE SMOKE DETECTORS (W/ BATTERY B.U.) EACH FLOOR

PRIOR TO CONSTRUCTION OF TIMBER FRAME, ALL 1st FLOOR FRAMING MUST BE IN PLACE AND LEVEL

DIMENSIONS TO BE CONFIRMED BY GENERAL CONTRACTOR BEFORE CONSTRUCTION BEGINS.

SOLID BLOCKING REQ'D UNDER ALL TIMBER POSTS: BLOCKING TO BE VERTICAL

GRAIN TO MINIMIZE COMPRESSION

A-1

ROOF PLAN

ALE: 1/4" = 1'-O"

TE: 8/30/19

AWN BY: DEW


ECKED BY:


TERO RESIDENCE CY, FL

JOB NAME:

TIMBER FRAME DESIGN
FRAME & PANEL HOME DESIGN
TIMBERFRAMEDESIGN.NET

COPYRIGHT LAWS PROHIBIT REPRODUCTION OR USE OF THIS DRAWING, IN WHOLE OR IN PART, WITHOUT THE EXPRESSED WRITTEN PERMISSION OF DW TIMBER FRAME DESIGN

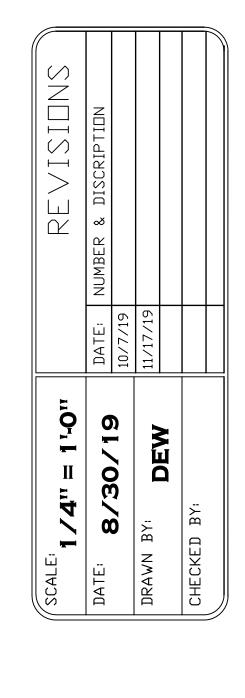

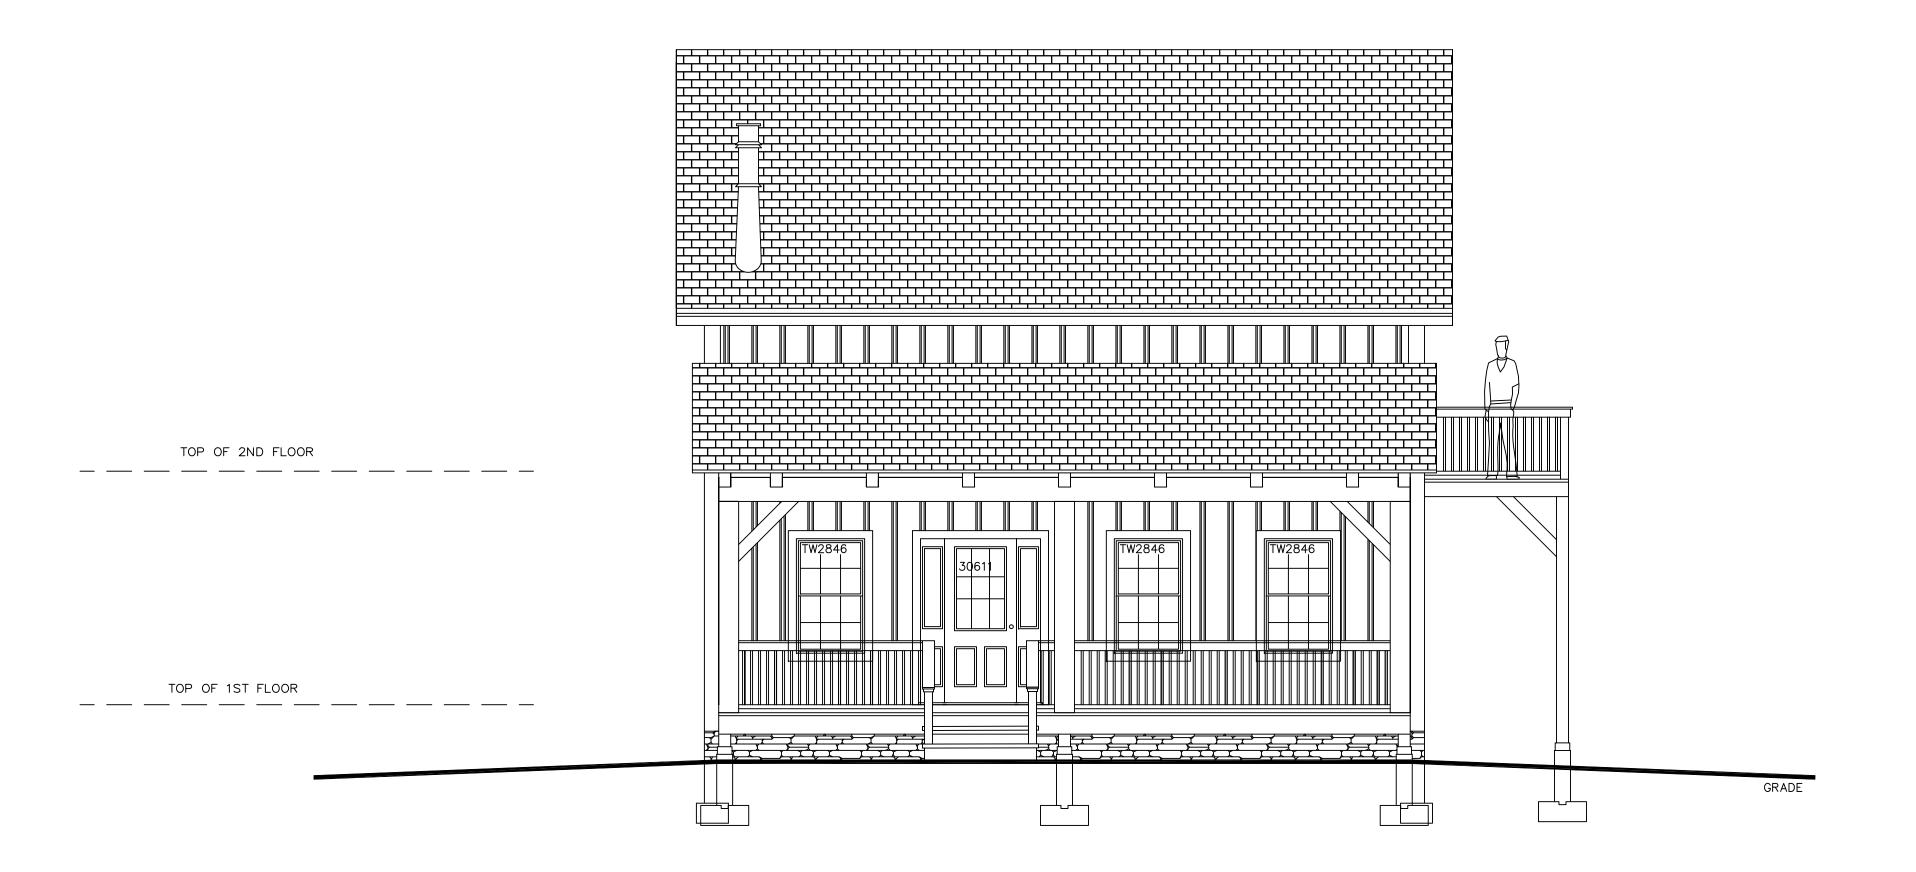


WEST ELEVATION


RESIDENC DW TIMBER FRAME DESIGN TIMBER FRAME & PANEL HOME DES

A-3

DO NOT SCALE DIMENSIONS ON THESE DRAWINGS. THESE IMAGES ARE MACHINE REPRODUCTIONS AND MAY CONTAIN A MARGIN OF ERROR.

COPYRIGHT LAWS PROHIBIT REPRODUCTION OR USE OF THIS DRAWING, IN WHOLE OR IN PART, WITHOUT THE EXPRESSED WRITTEN PERMISSION OF DW TIMBER FRAME DESIGN

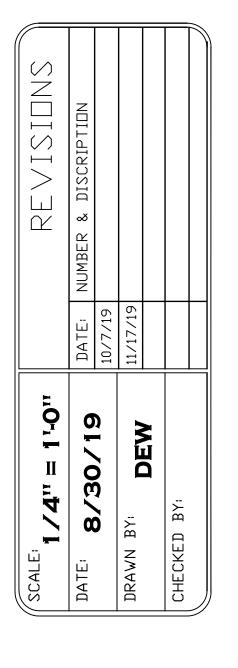

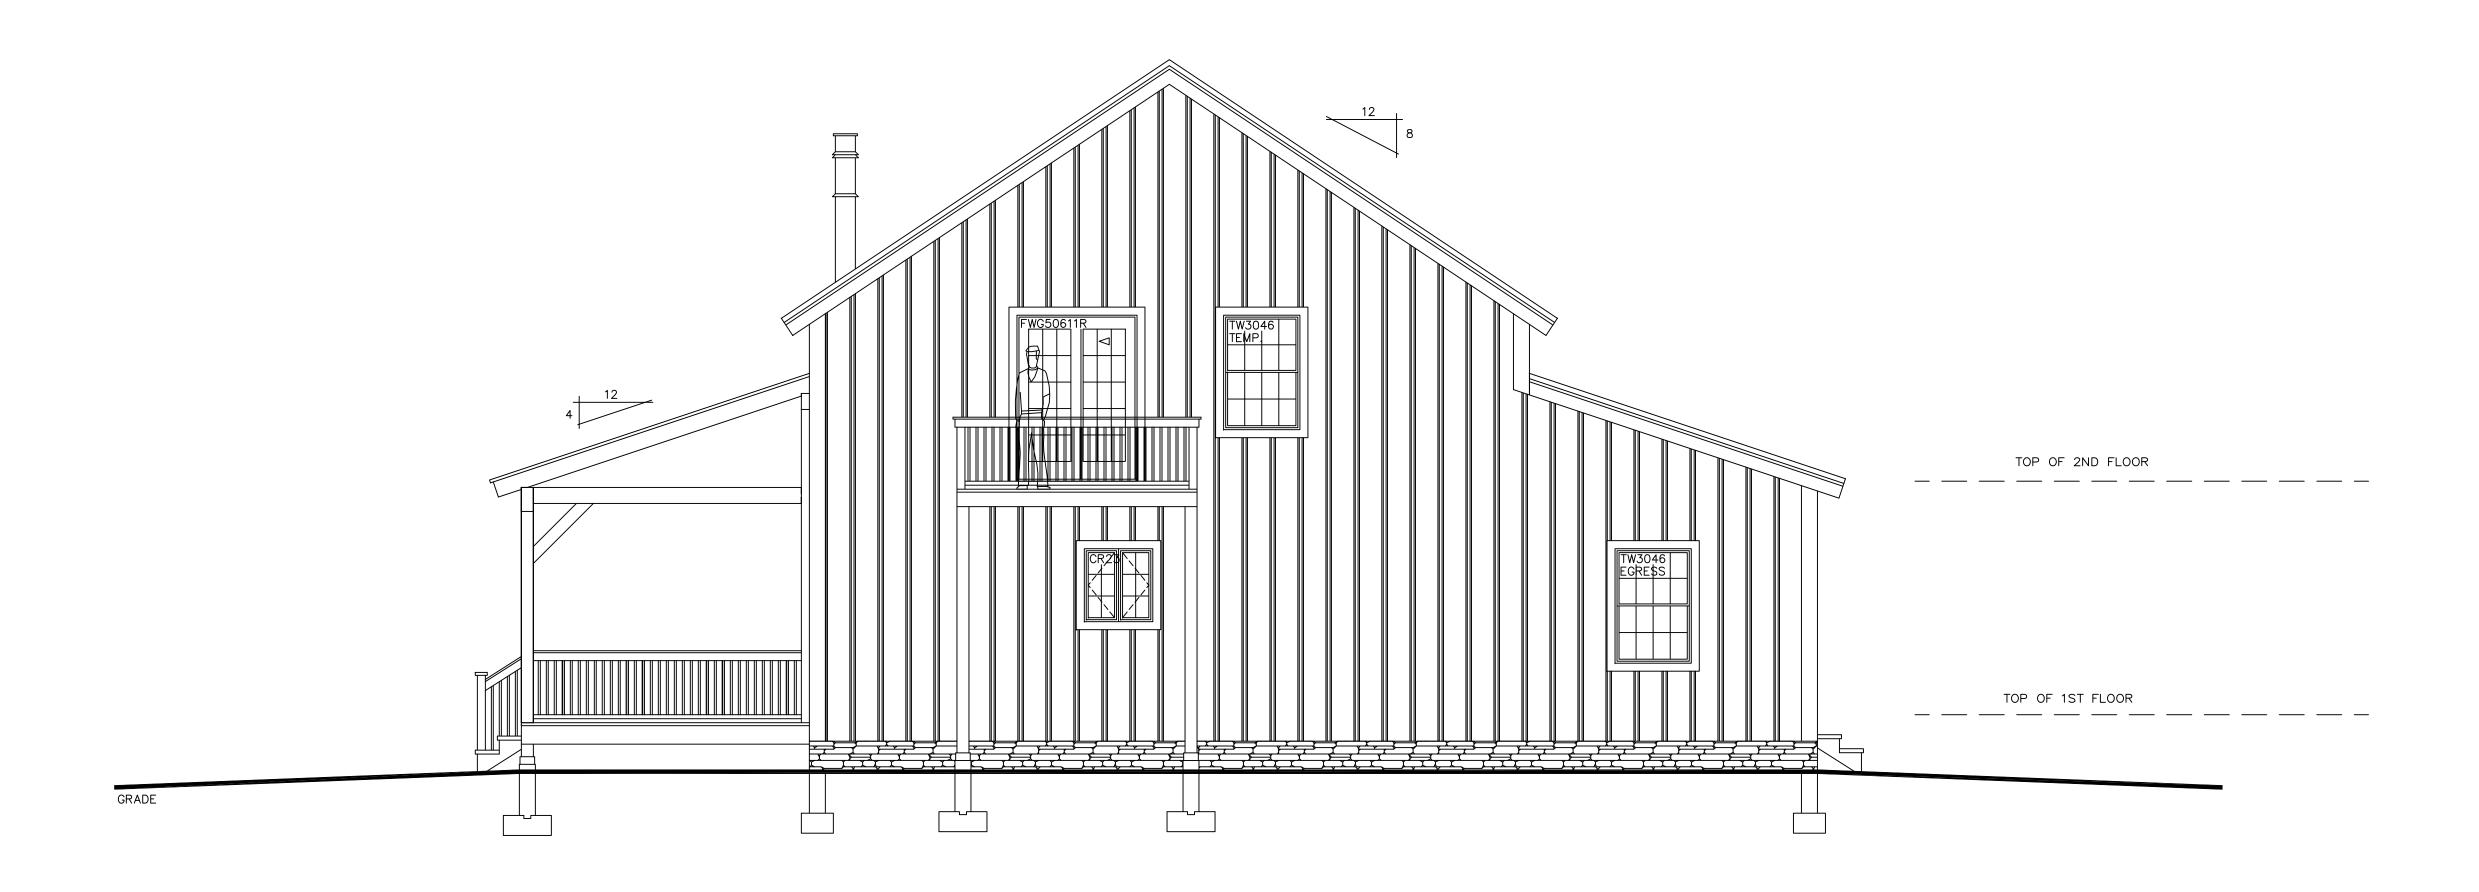


SOUTH ELEVATION

PRESTERO RESIDENCE
QUINCY, FL

A-4


DO NOT SCALE DIMENSIONS ON THESE DRAWINGS. THESE IMAGES ARE MACHINE REPRODUCTIONS AND MAY CONTAIN A MARGIN OF ERROR.

COPYRIGHT LAWS PROHIBIT REPRODUCTION OR USE OF THIS DRAWING, IN WHOLE OR IN PART, WITHOUT THE EXPRESSED WRITTEN PERMISSION OF DW TIMBER FRAME DESIGN

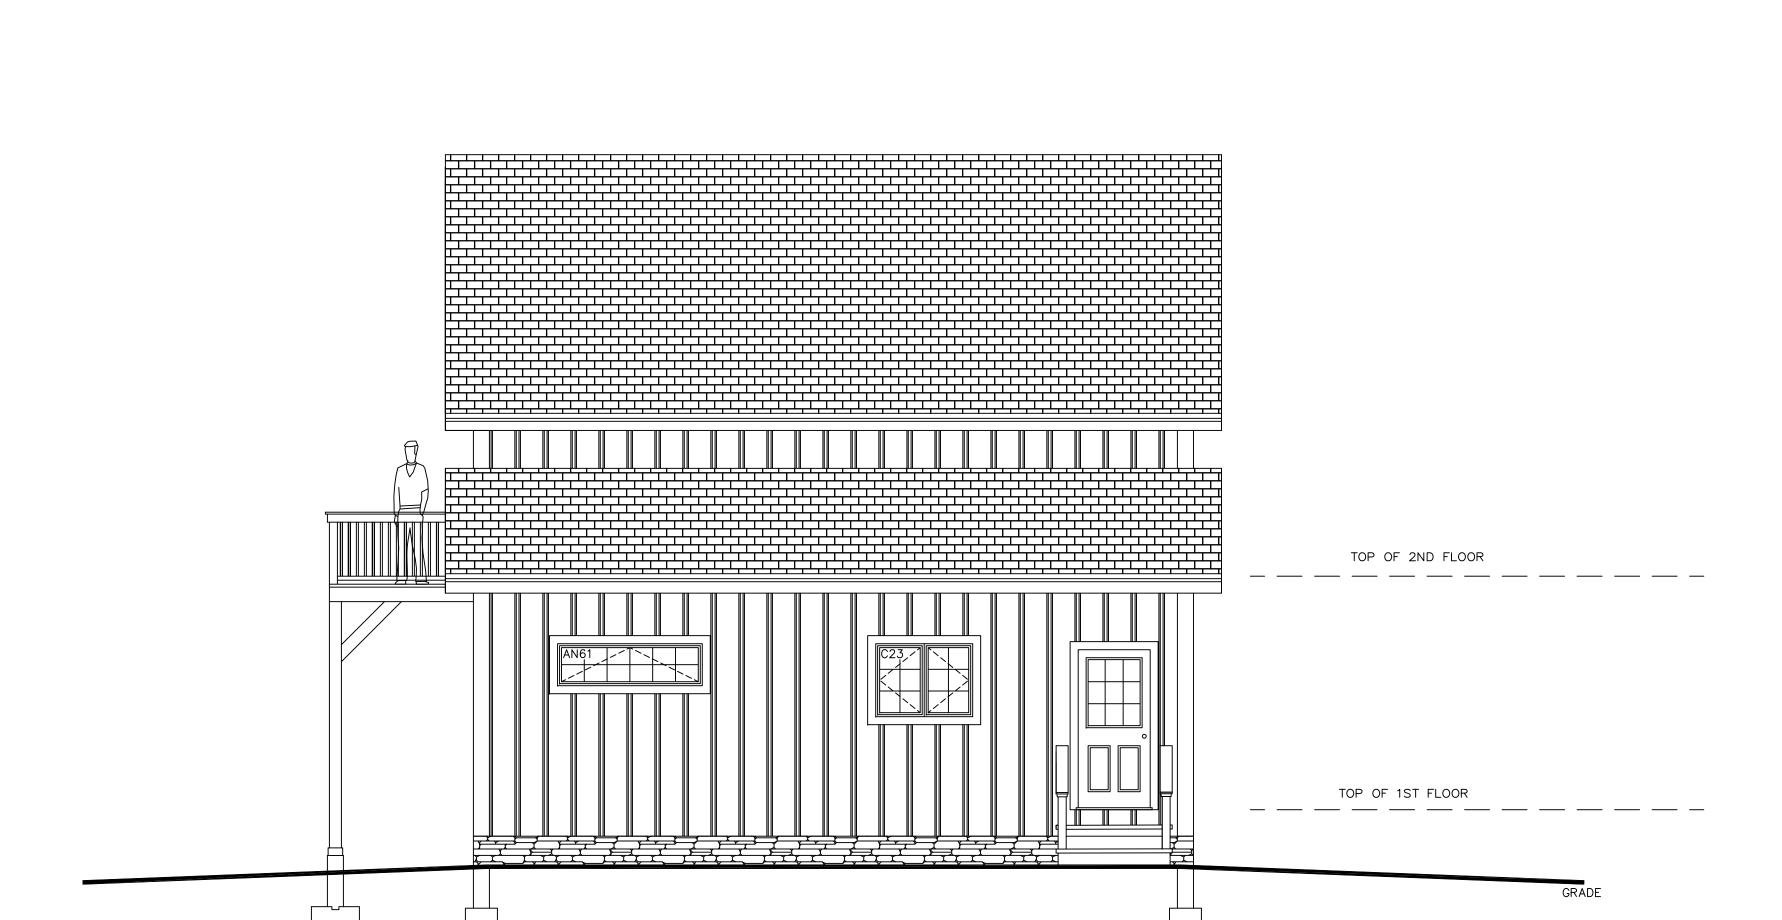

EAST ELEVATION

DO NOT SCALE DIMENSIONS ON THESE DRAWINGS. THESE IMAGES ARE MACHINE REPRODUCTIONS AND MAY CONTAIN A MARGIN OF ERROR.

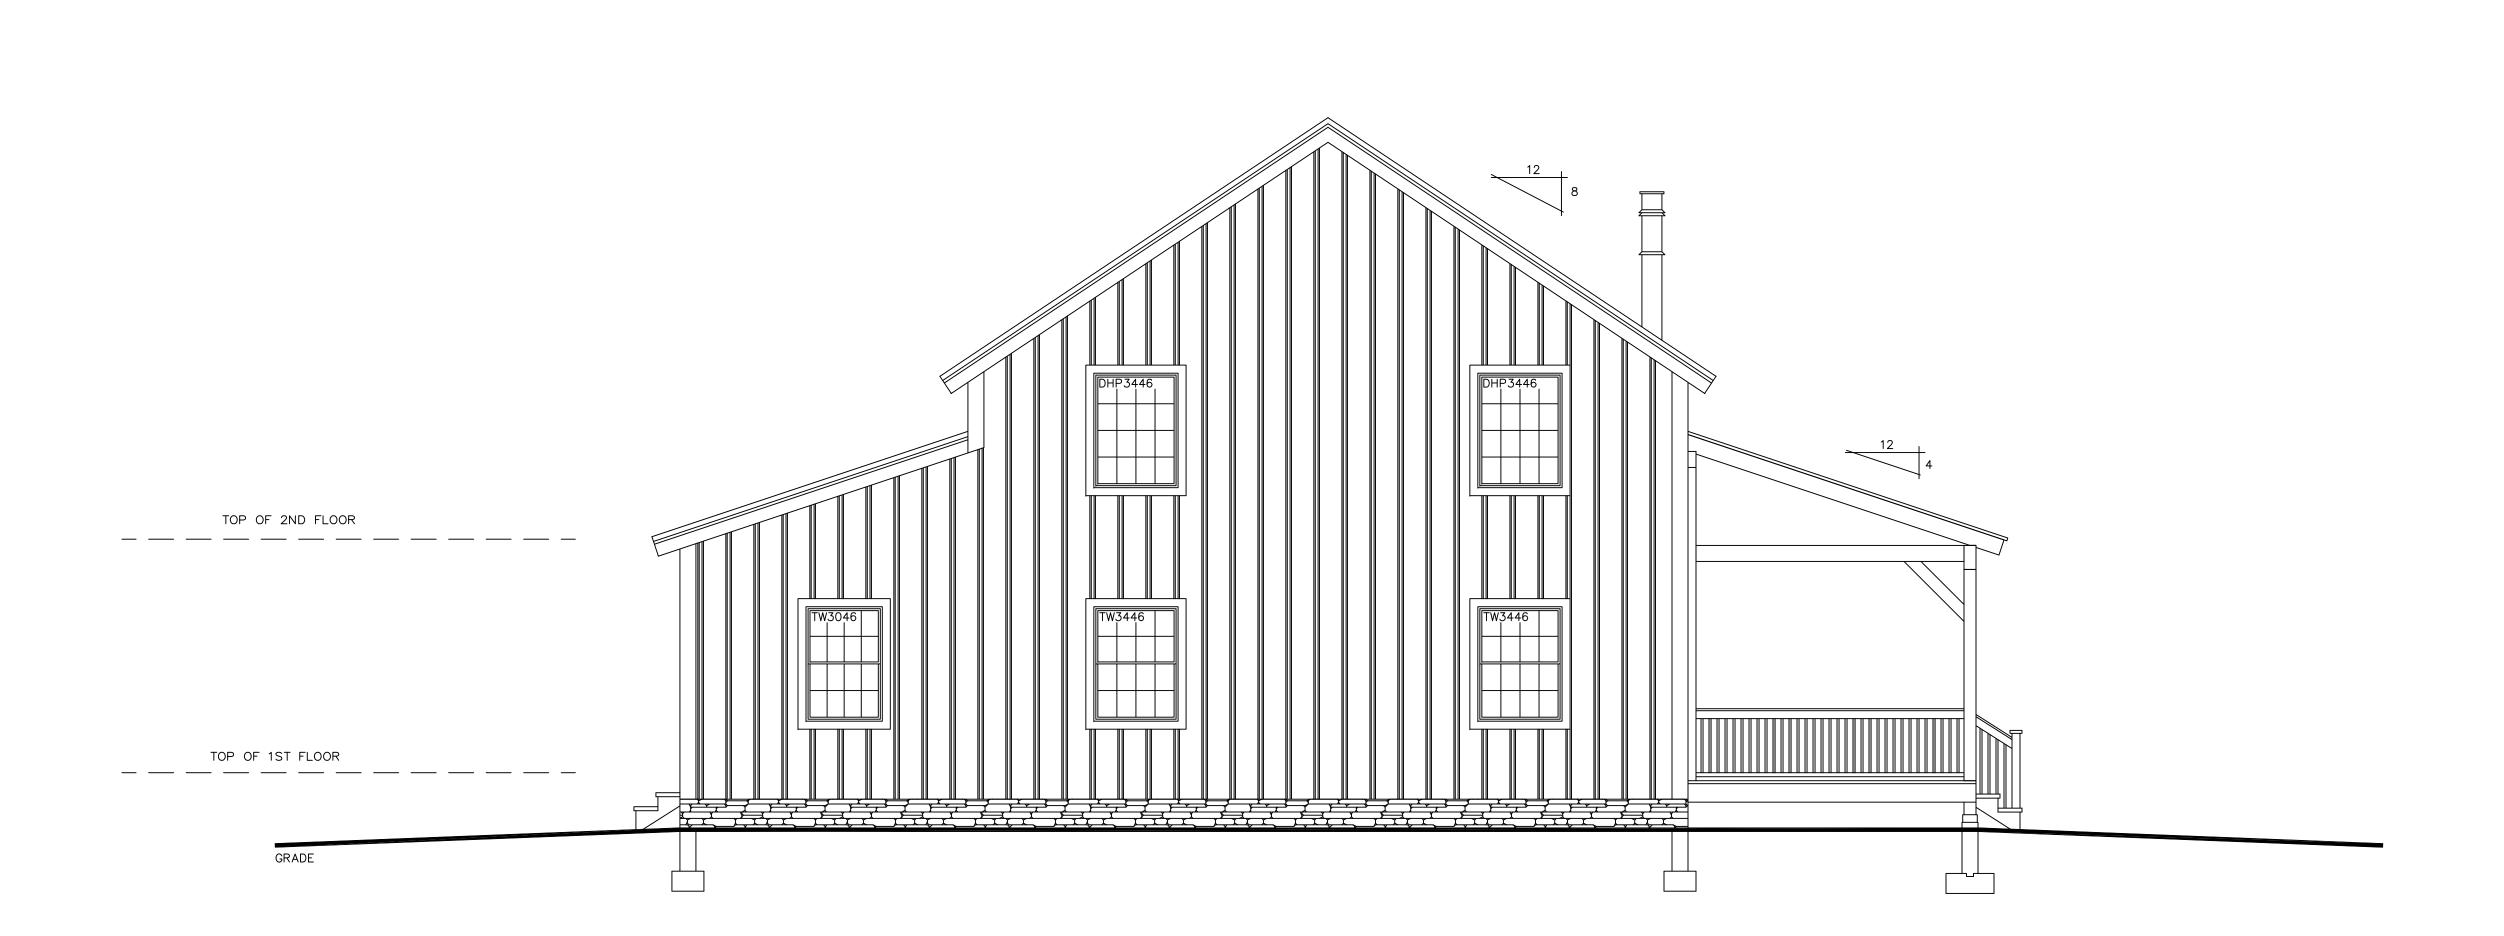

NORTH ELEVATION

RESIDENC PRESTERO I QUINCY, FL

A-6

CONCRETE NOTES:

- 1. ALL FOUNDATION FOOTING CONCRETE TO BE 3000 PSI DESIGN MIX.
- 2. ALL FOUNDATION WALL CONCRETE TO
- BE 3000 PSI, MIN.
- 3. ALL FLOOR SLAB TO BE 3500 PSI DESIGN MIX. WET CURE 7 DAYS.
- 4. CONCRETE SLAB TO BE 2" THICK W/ 6x6x#10 W.W.F. (OPTIONAL)
- 5. CONCRETE SLAB TO HAVE CONTROL
- 6. MINIMUM SOIL BEARING CAPACITY OF
- 8. STEEL BARS TO BE GRADE 60.

2000 PSF.

- 9. CONCRETE TO BE PLACED WITH A SLUMP NOT TO EXCEED 5".
- 10. LAP SPLICES IN STEEL TO BE 30 BAR DIAMETER.
- 11. ALL STEEL REINFORCING SPECIFICATIONS TO BE REVIEWED AND APPROVED BY LOCAL ENGINEER & MUST MEET ALL APPLICABLE CODES.
- 12. CONCRETE WORK SHALL CONFORM TO ALL REQUIREMENTS OF ACI 301 "SPECIFICATIONS FOR STRUCTURAL

CONCRETE FOR BUILDINGS".

- 13. ALL FOOTINGS TO BEAR ON UNDISTURBED SOIL BELOW FROST LINE.
- 14. ALL FOOTING SIZES AND CONC. SPEC.'S SHALL BE VERIFIED BY LOCAL ENGINEER.

SOILS NOTES:

- 1. PLACE FOOTINGS ON UNDISTURBED
- 2. BACK FILL SHALL BE PLACED IN 12" LOOSE LIFTS AND COMPACTED TO 95% ASTM DD 1557 INSIDE BUILDING
- AND 90% OUTSIDE. 3. BACK FILL SHALL BE PLACED SIMULTANEOUSLY ON EACH SIDE OF THE WALL.

GENERAL NOTES:

- 1. DOOR AND WINDOW OPENINGS PER OWNER
- 2. G.C. IS RESPONSIBLE TO MAKE ALL WINDOW WELLS MEET LOCAL & APPLICABLE CODES

LEGEND:


T.O.F. = TOP OF FOOTINGT.O.S. = TOP OF SLAB

T.O.W. = TOP OF WALLT.B.V. = TO BE VERIFIED

T.B.D. = TO BE DETERMINED

T.O.P. = TOP OF PIER

[--- OUTLINE OF TIMBER POST ABOVE L--- POSTS ALIGNED TO CENTER

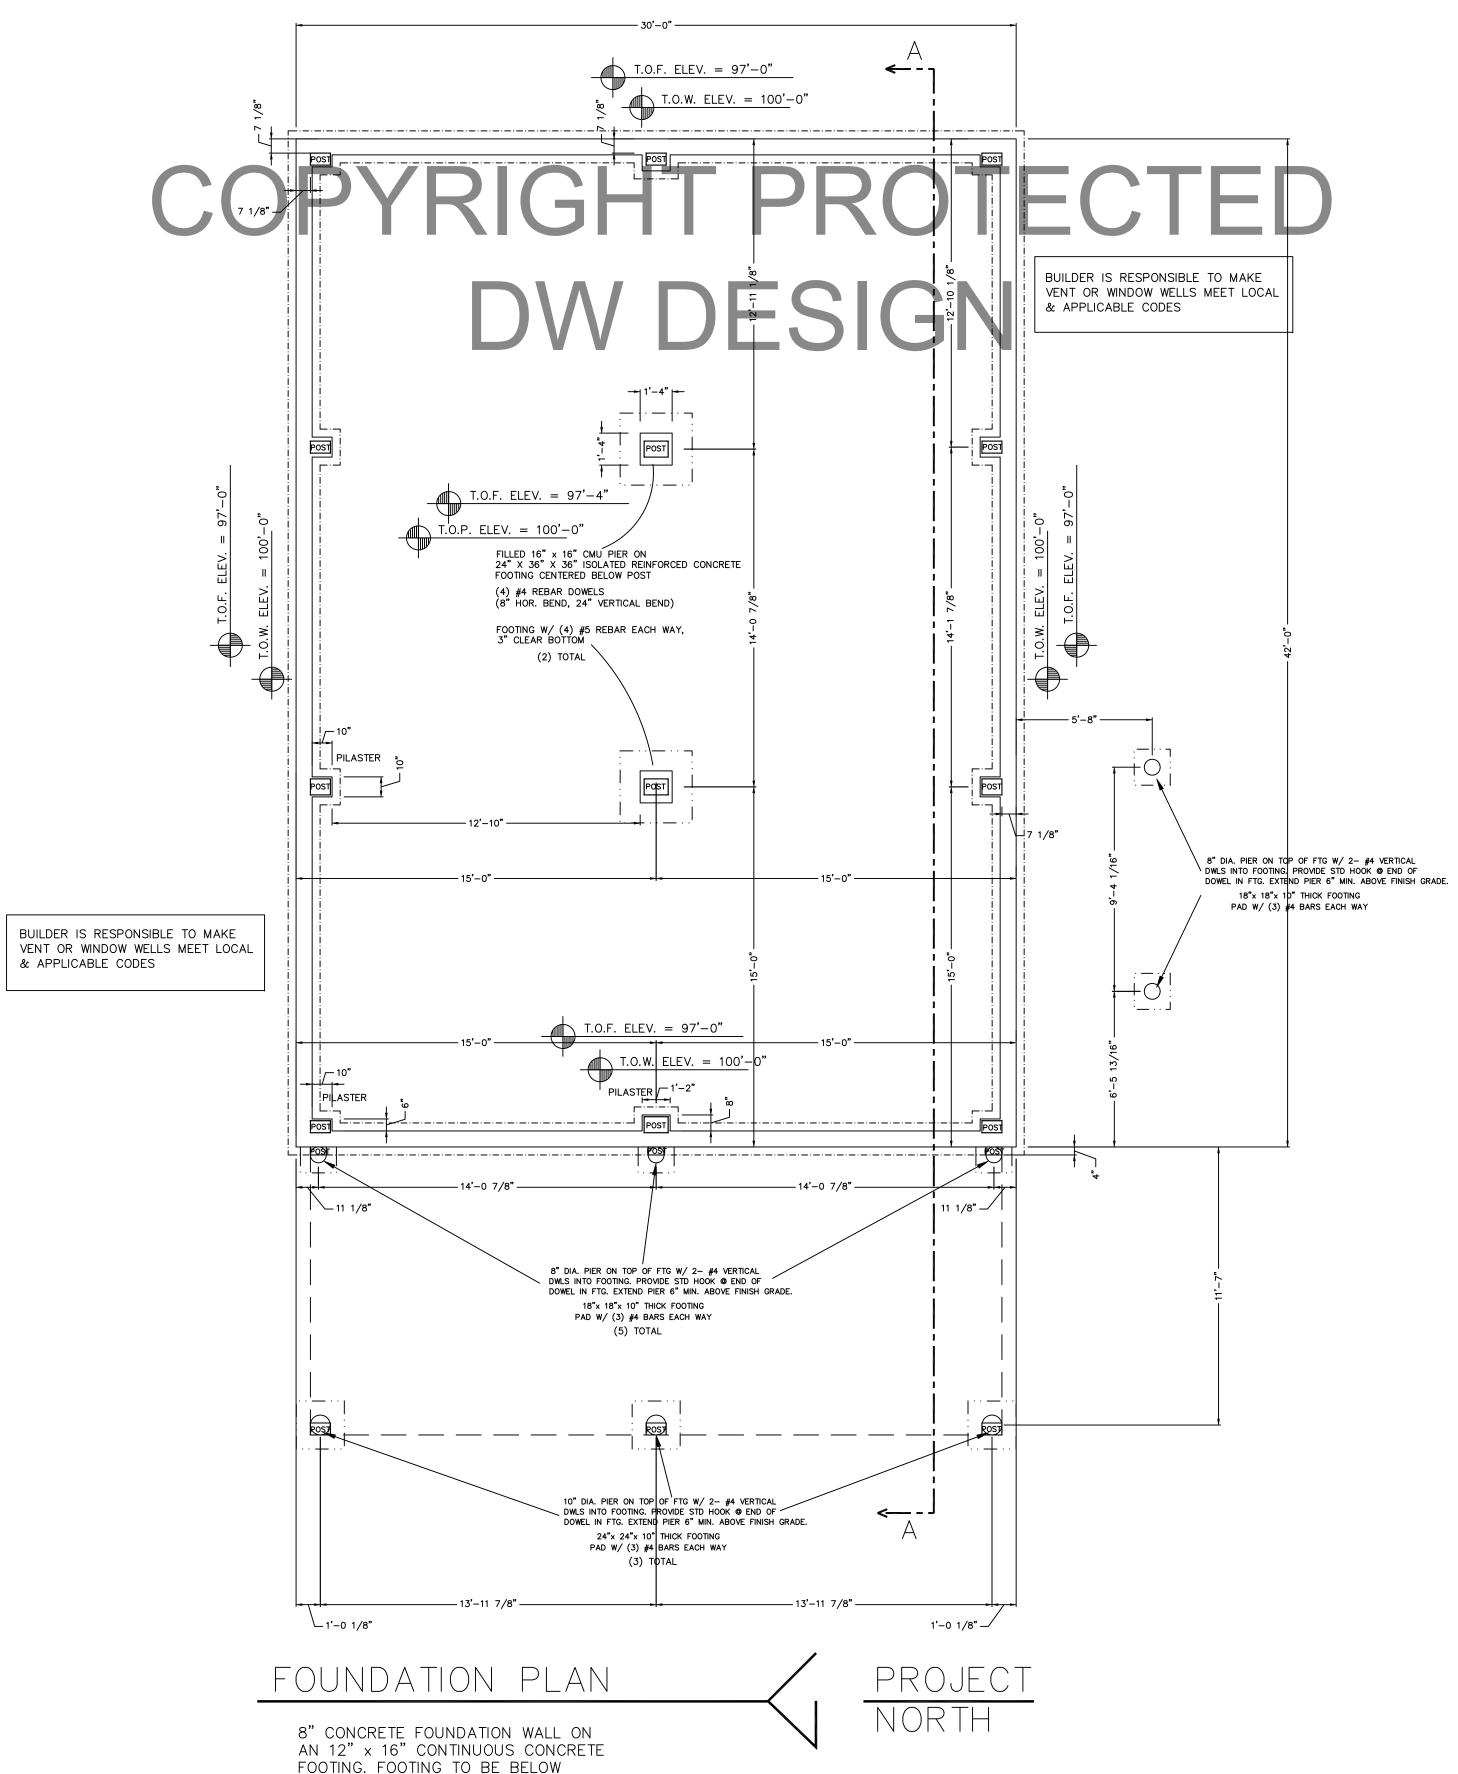

FOOTING. FOOTING TO BE BELOW FROST LINE AND BE REINFORCED AS REQUIRED.

> ALL FOUNDATION ELEVATIONS ARE BASED FROM PERIMETER WALL

SIMPSON STRAPPING METAL STAP EMBEDDED IN CONCRETE AND NAILED TO ALL TIMBER POSTS

DIMENSIONS TO BE CONFIRMED BY GENERAL CONTRACTOR BEFORE CONSTRUCTION BEGINS.

PRIOR TO CONSTRUCTION OF TIMBER FRAME, ALL 1st FLOOR FRAMING MUST BE IN PLACE AND LEVEL

SOLID BLOCKING REQ'D UNDER ALL TIMBER POSTS: BLOCKING TO BE VERTICAL GRAIN TO MINIMIZE COMPRESSION


HARDWIRE SMOKE DETECTORS (W/ BATTERY B.U.) EACH FLOOR

COPYRIGHT LAWS PROHIBIT REPRODUCTION OR USE OF THIS DRAWING, IN WHOLE OR IN PART, WITHOUT THE EXPRESSED WRITTEN PERMISSION OF DW TIMBER FRAME DESIGN

<u>Ö</u> 0 30

PRESTERO | QUINCY, FL

DO NOT SCALE DIMENSIONS ON THESE DRAWINGS. THESE IMAGES ARE MACHINE REPRODUCTIONS AND MAY CONTAIN A MARGIN OF ERROR.

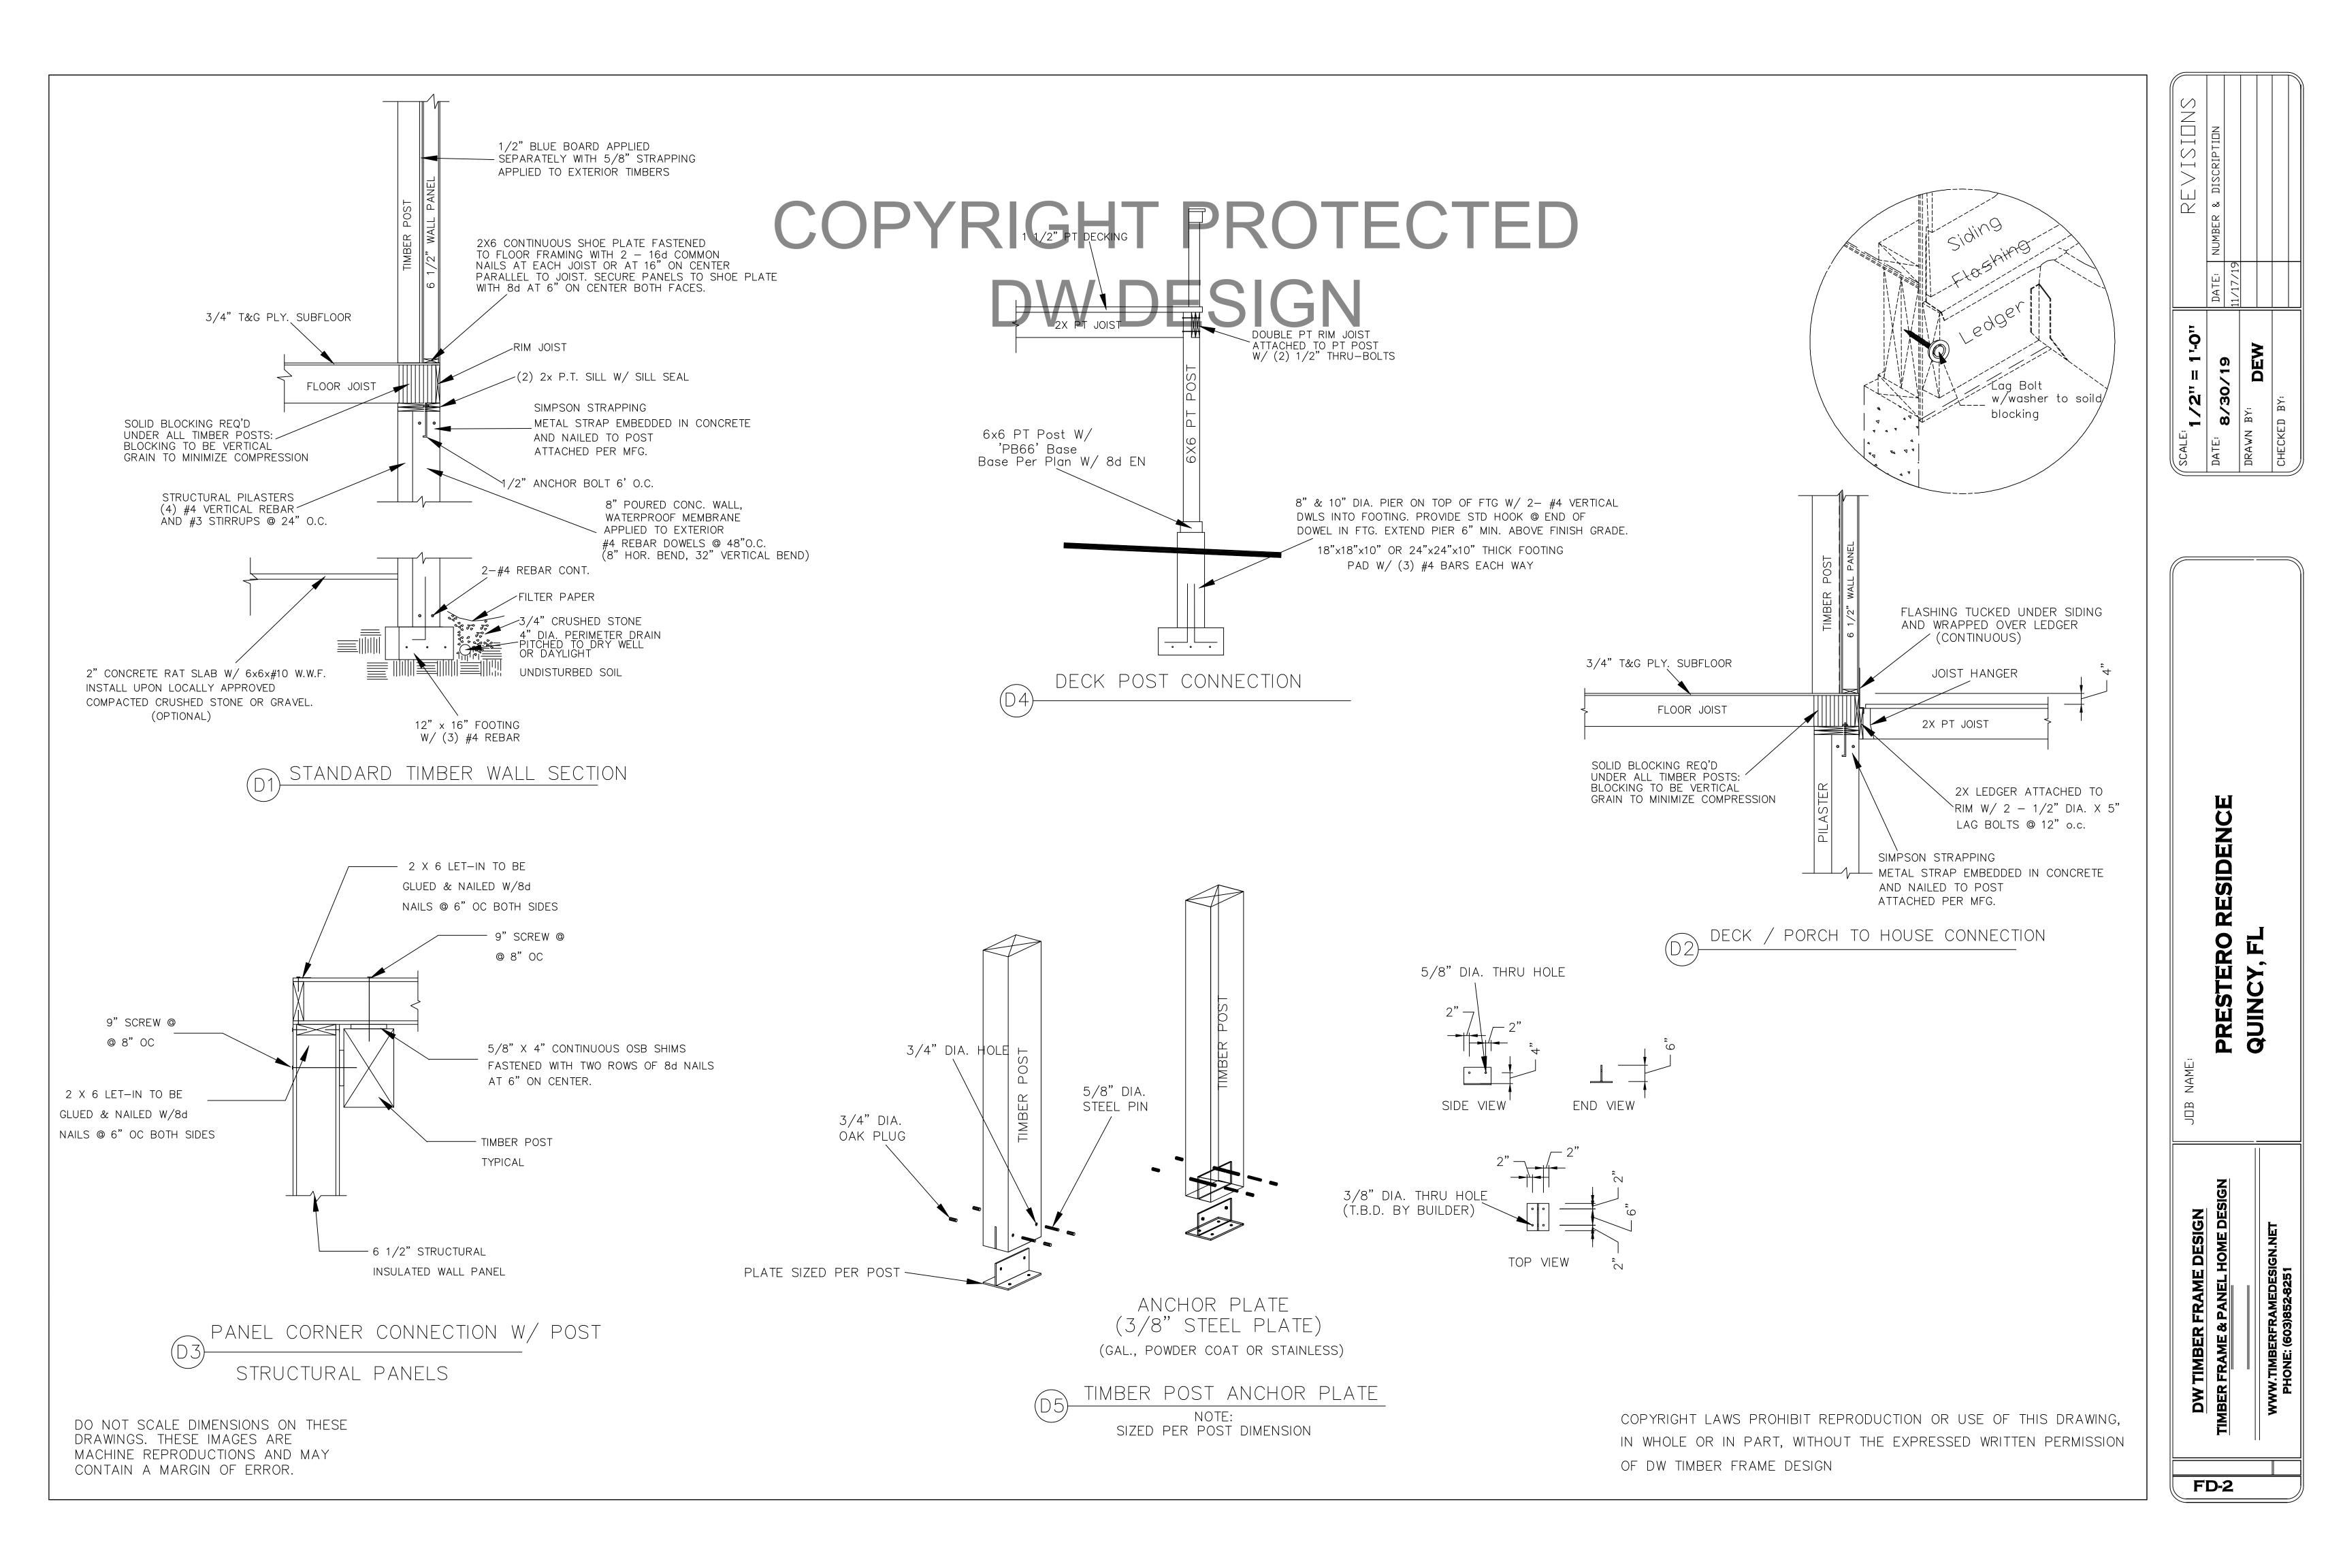


FLOOR FRAMING NOTES:

- 1. DIMENSIONS TO BE CONFIRMED BY GENERAL CONTRACTOR BEFORE CONSTRUCTION BEGINS.
- 2. VERIFY PT SILL OVERHANG OUTSIDE OF CONCRETE PER DETAIL(S). VERIFY RIM JOIST
- OFFSET FROM EDGE OF PT SILL PER DETAIL(S). 3. DIMENSIONAL RIM JOIST TO BE KD SPF#2 OR BETTER.
- 4. EXTERIOR DIMENSIONS SHOWN ARE TO OUTSIDE OF RIM JOISTS.
- 5. REFER TO FOUNDATION DETAILS
- FOR MORE INFORMATION. 6. PROVIDE SOLID BLOCKING & CONTINUOUS SUPPORT BELOW ALL TIMBER POSTS. LOCATIONS ARE INDICATED ON THE
- TIMBER FRAMING PLAN. 7. ALL COLUMNS MUST BE IN PLACE PRIOR TO GIRDER INSTALLATION.
- 8. CROSS BRIDGING WHERE REQUIRED BY CODE. 9. HEARTH FRAMING TO BE DETERMINED BY
- BUILDER & MASON. 10. REFER TO JOIST/BEAM MANUFACTURER'S LITERATURE FOR PROPER FRAMING DETAILS & SPECIFICATIONS, INSTALLING BLOCKING,
- AS REQUIRED. 11. REFER TO JOIST MANUF. LITERATURE FOR SPECIFICATIONS FOR CUTTING HOLES IN

SQUASH BLOCKS/WEB STIFFENERS, ETC.

JOIST WEB. 12. FASTEN ALL MANUFACTURED FLOOR FRAMING MATERIALS PER MANUF. SPECIFICATIONS.

[--- OUTLINE OF TIMBER POST ABOVE L--- POSTS ALIGNED TO CENTER

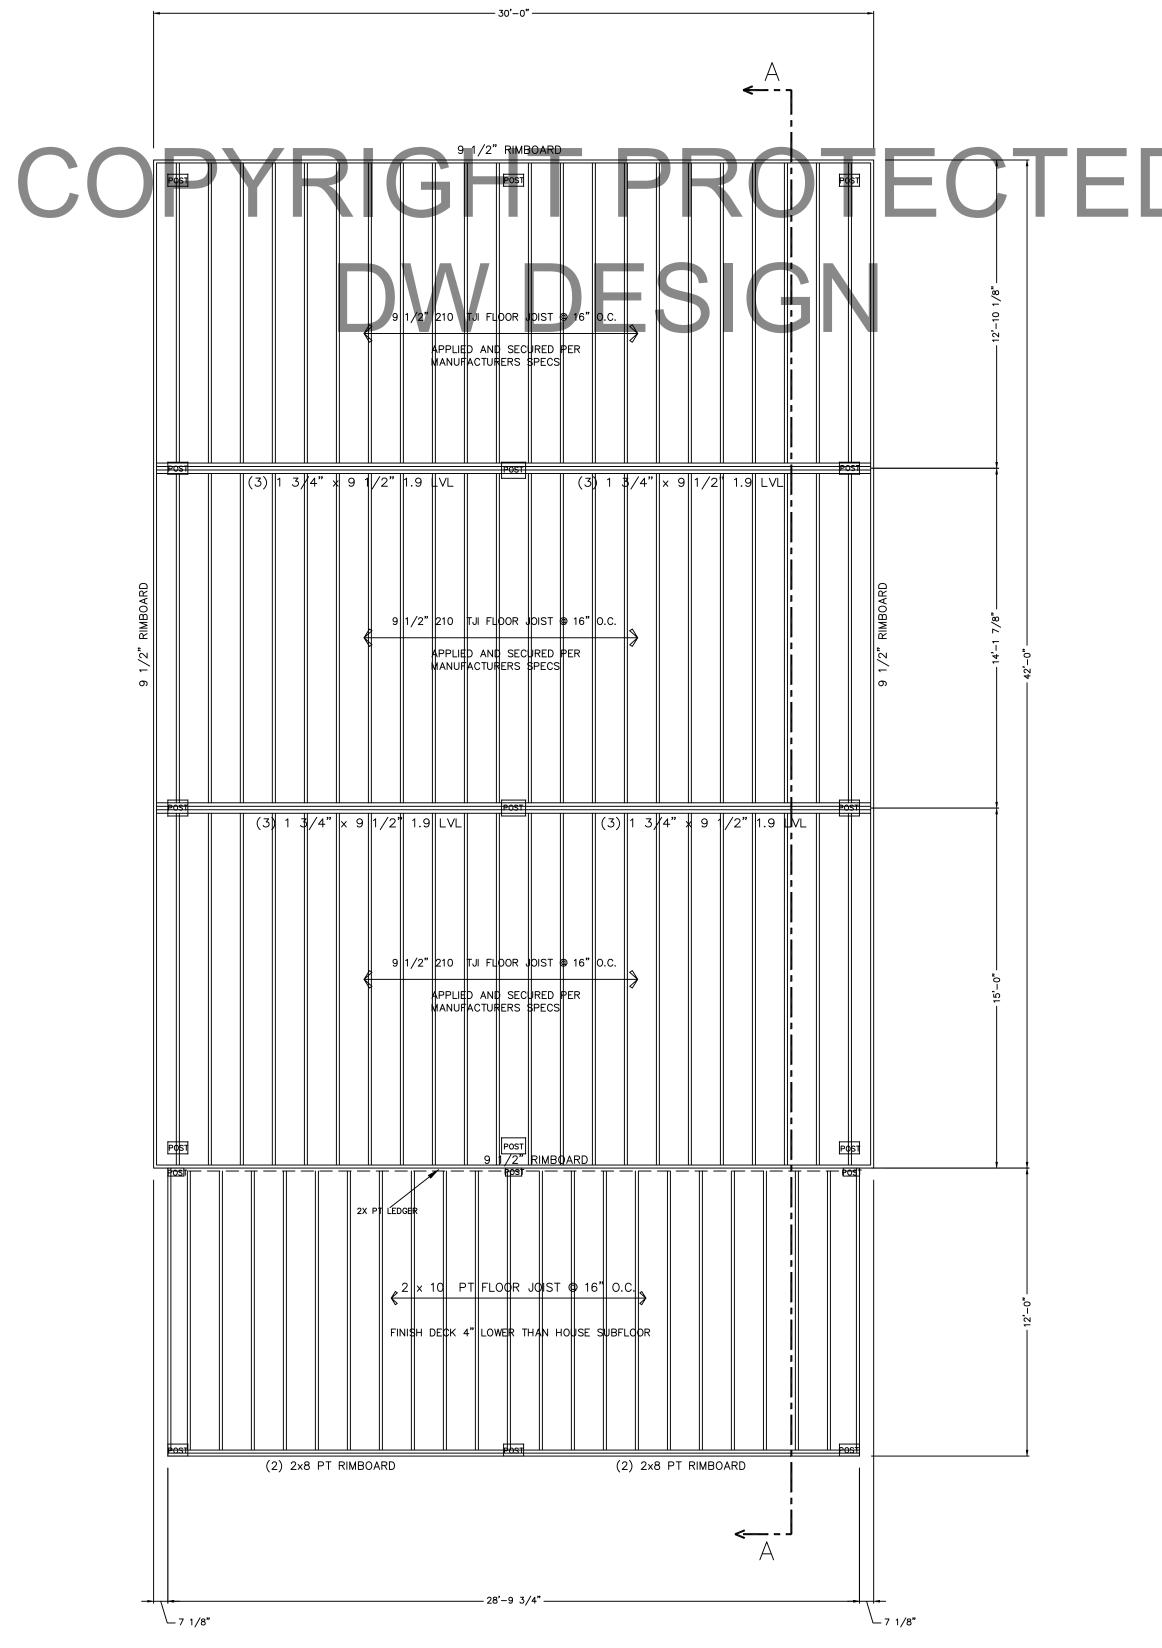

FIRST FLOOR FRAMING PLAN

REFER TO JOIST/BEAM MANUFACTURER'S LITERATURE FOR PROPER FRAMING DETAILS & SPECIFICATIONS, INSTALLING BLOCKING, SQUASH BLOCKS/WEB STIFFENERS, ETC. AS REQUIRED.

PROJECT NORTH

SOLID BLOCKING REQ'D UNDER ALL TIMBER POSTS: BLOCKING TO BE VERTICAL

COPYRIGHT LAWS PROHIBIT REPRODUCTION OR USE OF THIS DRAWING, IN WHOLE OR IN PART, WITHOUT THE EXPRESSED WRITTEN PERMISSION

9 1/2, 210			TEC
9 1/2, 210	Post		TED
	ED AND SECURED PER FACTURERS SPECS	12'-10 1/8"	
(3) 1 3/4" × 9 1/2" 1.9 LVL	(3) 1 3/4" × 9 1/2	1.9 LVL	
	TJI FLOOR JOIST © 16" O.C. ED AND SECURED PER FACTURERS SPECS	9 1/2" RIMBOARD	42'-0"
(3) 1 3/4" x 9 1/2" 1.9 LVL	. (3) 1 3/4" × 9 1/	/2" 1.9 VL	
	TJI FLOOR JOIST © 16" O.C. ED AND SECURED PER FACTURERS SPECS	15,-0"	
		Post Po	12'-0"
(2) 2x8 PT RIMBOARD	(2) 2x8 PT RIMBOA	ARD Post	
	€ 2 × 10 FINISH DE¢K	2 x 10 PT FLOOR JOIST © 16" O.C. FINISH DECK 4" LOWER THAN HOUSE SUBFLOOR	2x PT LEDGER 2x PT LEDGER 2x 10 PT FLOOR JOIST © 16" O.C. FINISH DECK 4" LOWER THAN HOUSE SUBFLOOR

DIMENSIONS TO BE CONFIRMED BY GENERAL CONTRACTOR BEFORE CONSTRUCTION BEGINS.

PRIOR TO CONSTRUCTION OF TIMBER FRAME, ALL 1st FLOOR FRAMING MUST BE IN PLACE AND LEVEL

GRAIN TO MINIMIZE COMPRESSION

HARDWIRE SMOKE DETECTORS (W/ BATTERY B.U.) EACH FLOOR


OF DW TIMBER FRAME DESIGN

VISION\$ 1.0

PRESTERO | QUINCY, FL

DW TIMBER FRAME DESIGN TIMBER FRAME & PANEL HOME DES

DO NOT SCALE DIMENSIONS ON THESE DRAWINGS. THESE IMAGES ARE MACHINE REPRODUCTIONS AND MAY CONTAIN A MARGIN OF ERROR.

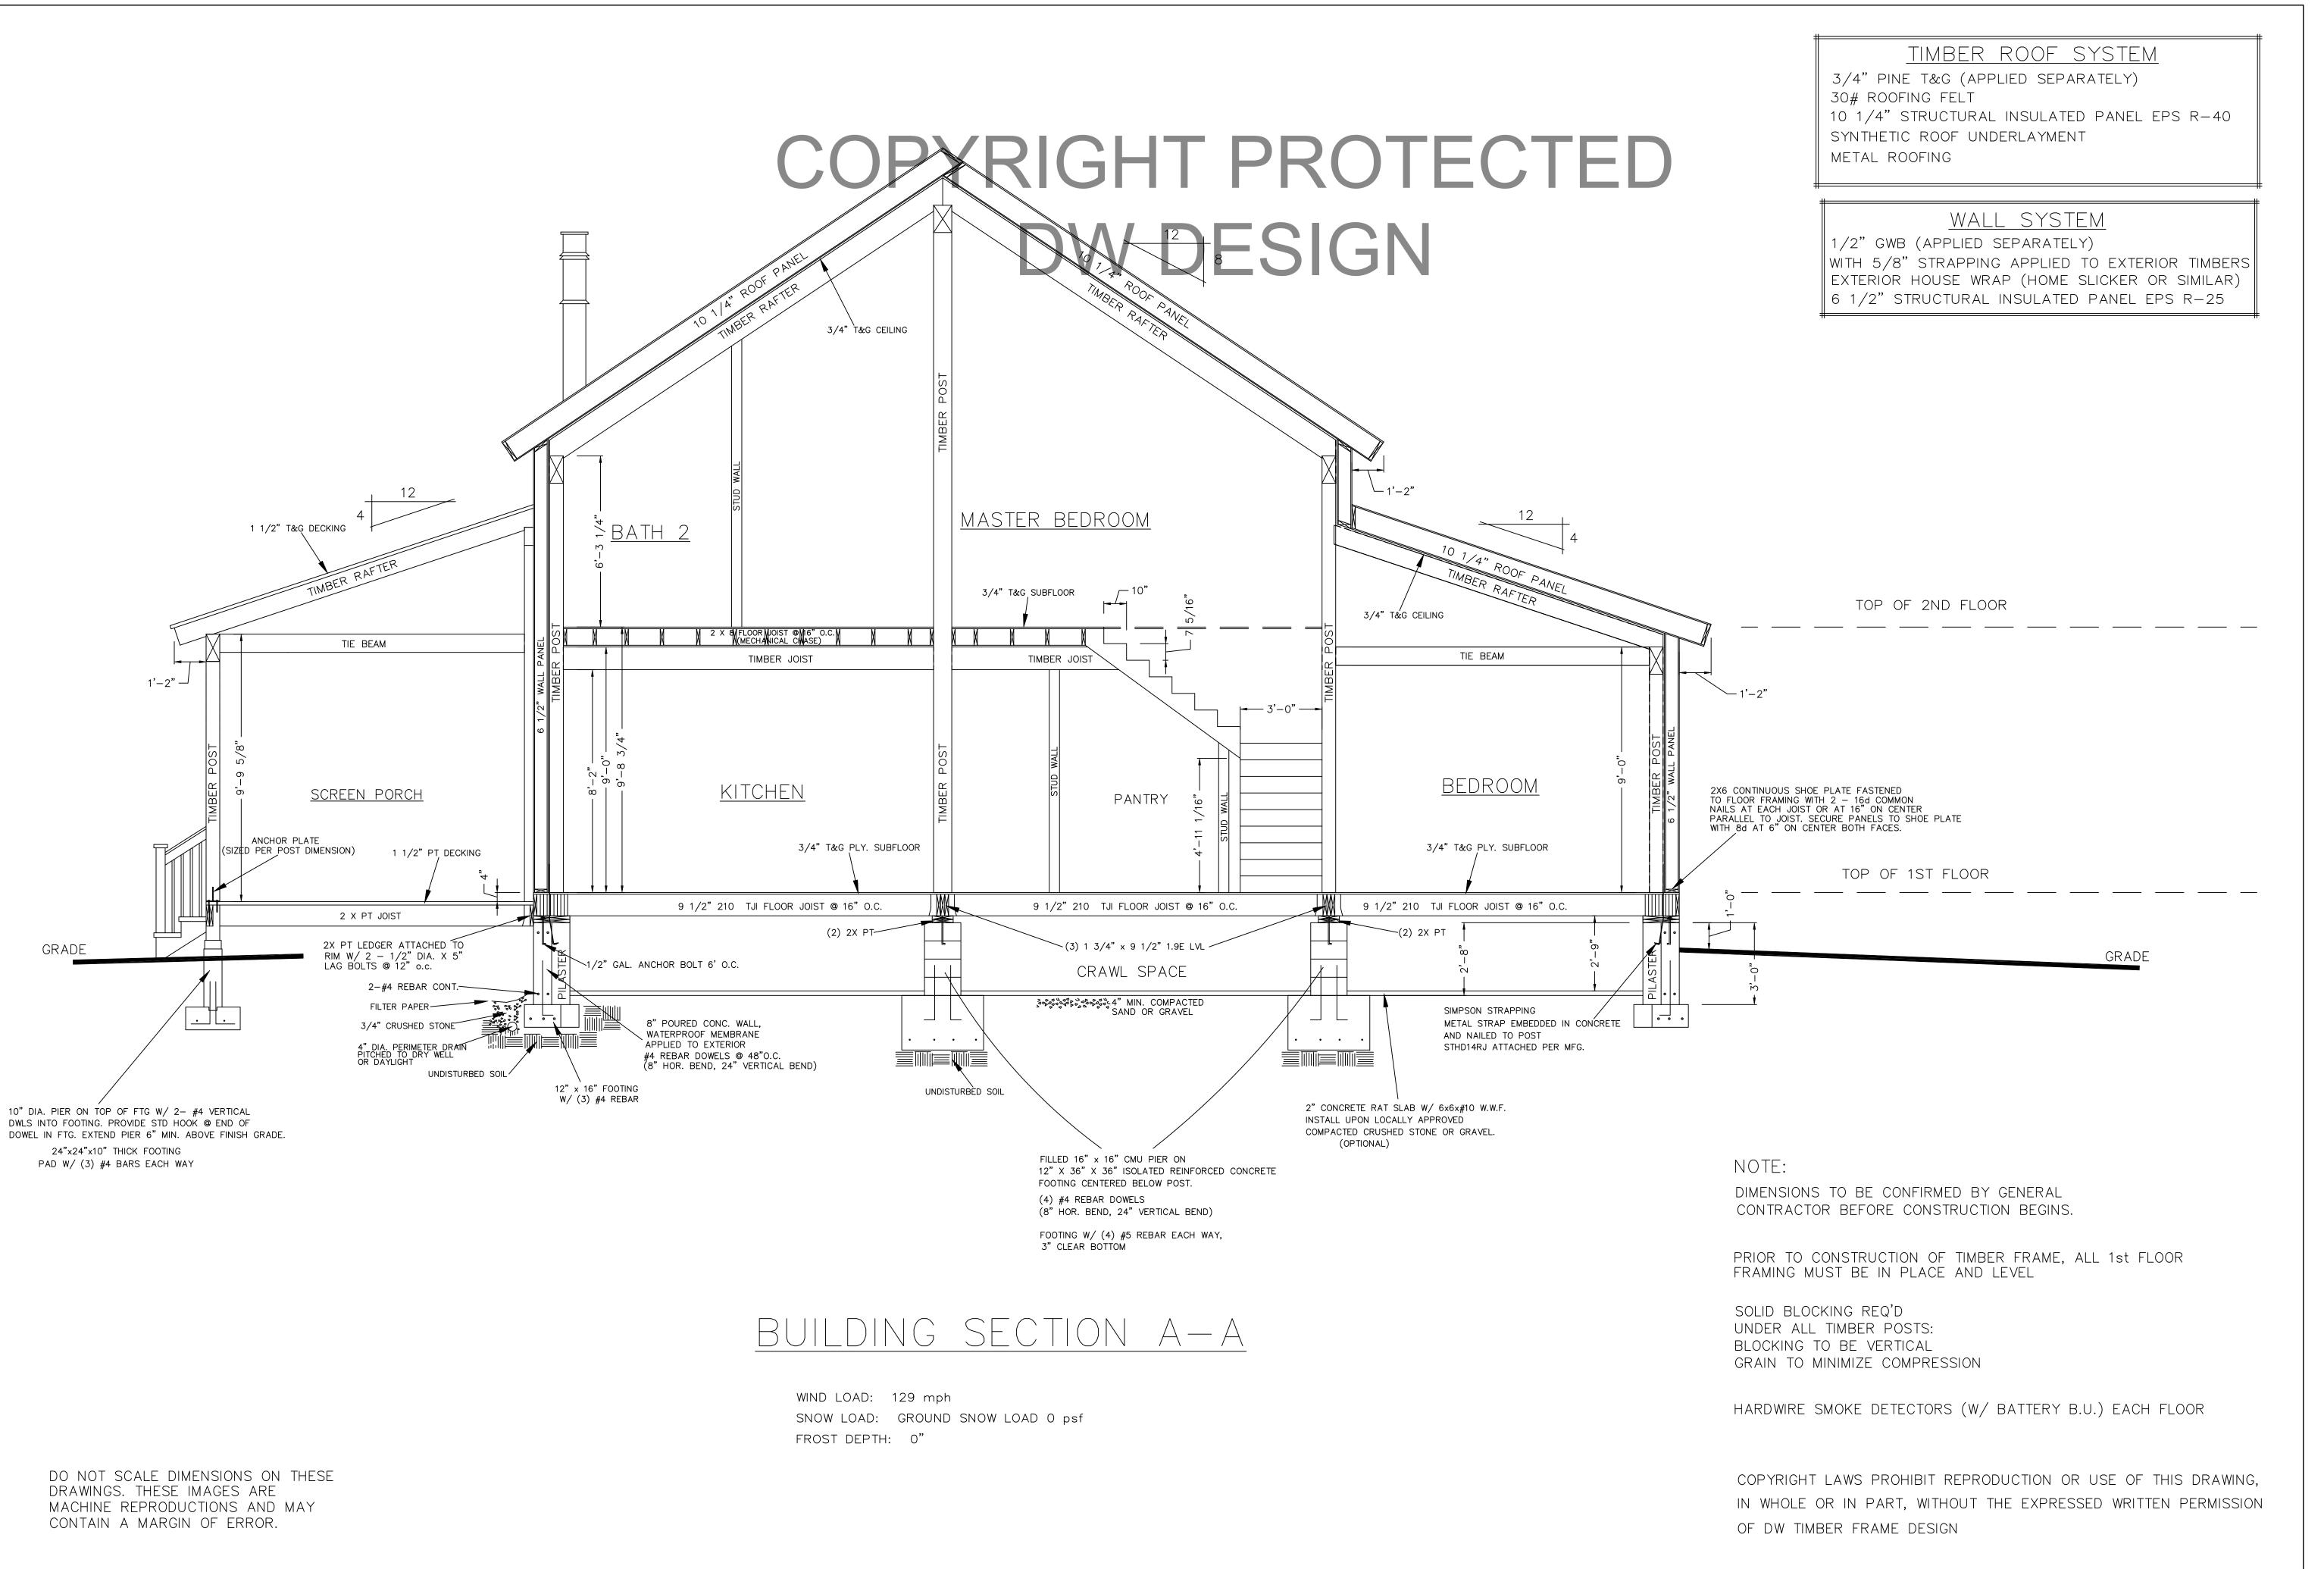

SNOISIA

PRESTERO QUINCY, FL

A-A