FINAL LOCATION OF ALL INTERIOR PARTITIONS TO BE DETERMINED AT SITE.

ALL EXTERIOR DECKS, STEPS, RAILS AND SUPPORTS SHOULD MEET STATE AND LOCAL CODES

LOCATION AND ENGINEERING OF ANY RETAINING WALLS IS BY OTHERS (B.O.)

ANY CONSTRUCTION BY OTHERS NOTED AS TO BE VERIFIED (T.B.V.), IS TO BE VERIFIED FOR ACCURACY BY THE OWNER AND/OR BUILDER.

THE STAIR RISER AND TREAD DIMENSIONS ARE CALCULATED FROM THE TOP OF THE 1ST FLR DECK TO THE TOP OF THE SECOND FLOOR DECK. BUILDER TO ADJUST FOR FLOOR FINISHES AS NEEDED.


FIREPLACE AND/OR WOODSTOVE INSTALLATION IS TO COMPLY WITH ALL LOCAL, STATE AND NATIONAL FIRE SAFETY CODES AND REGULATIONS.

COPYRIGHT LAWS PROHIBIT REPRODUCTION OR USE OF THIS DRAWING,

IN WHOLE OR IN PART, WITHOUT THE EXPRESSED WRITTEN PERMISSION

OF DW TIMBER FRAME DESIGN

ALL DOORS, WALLS AND CEILINGS BETWEEN THE GARAGE AND LIVING SPACES ARE TO MEET ALL FIRE AND SAFETY CODE REGULATIONS.

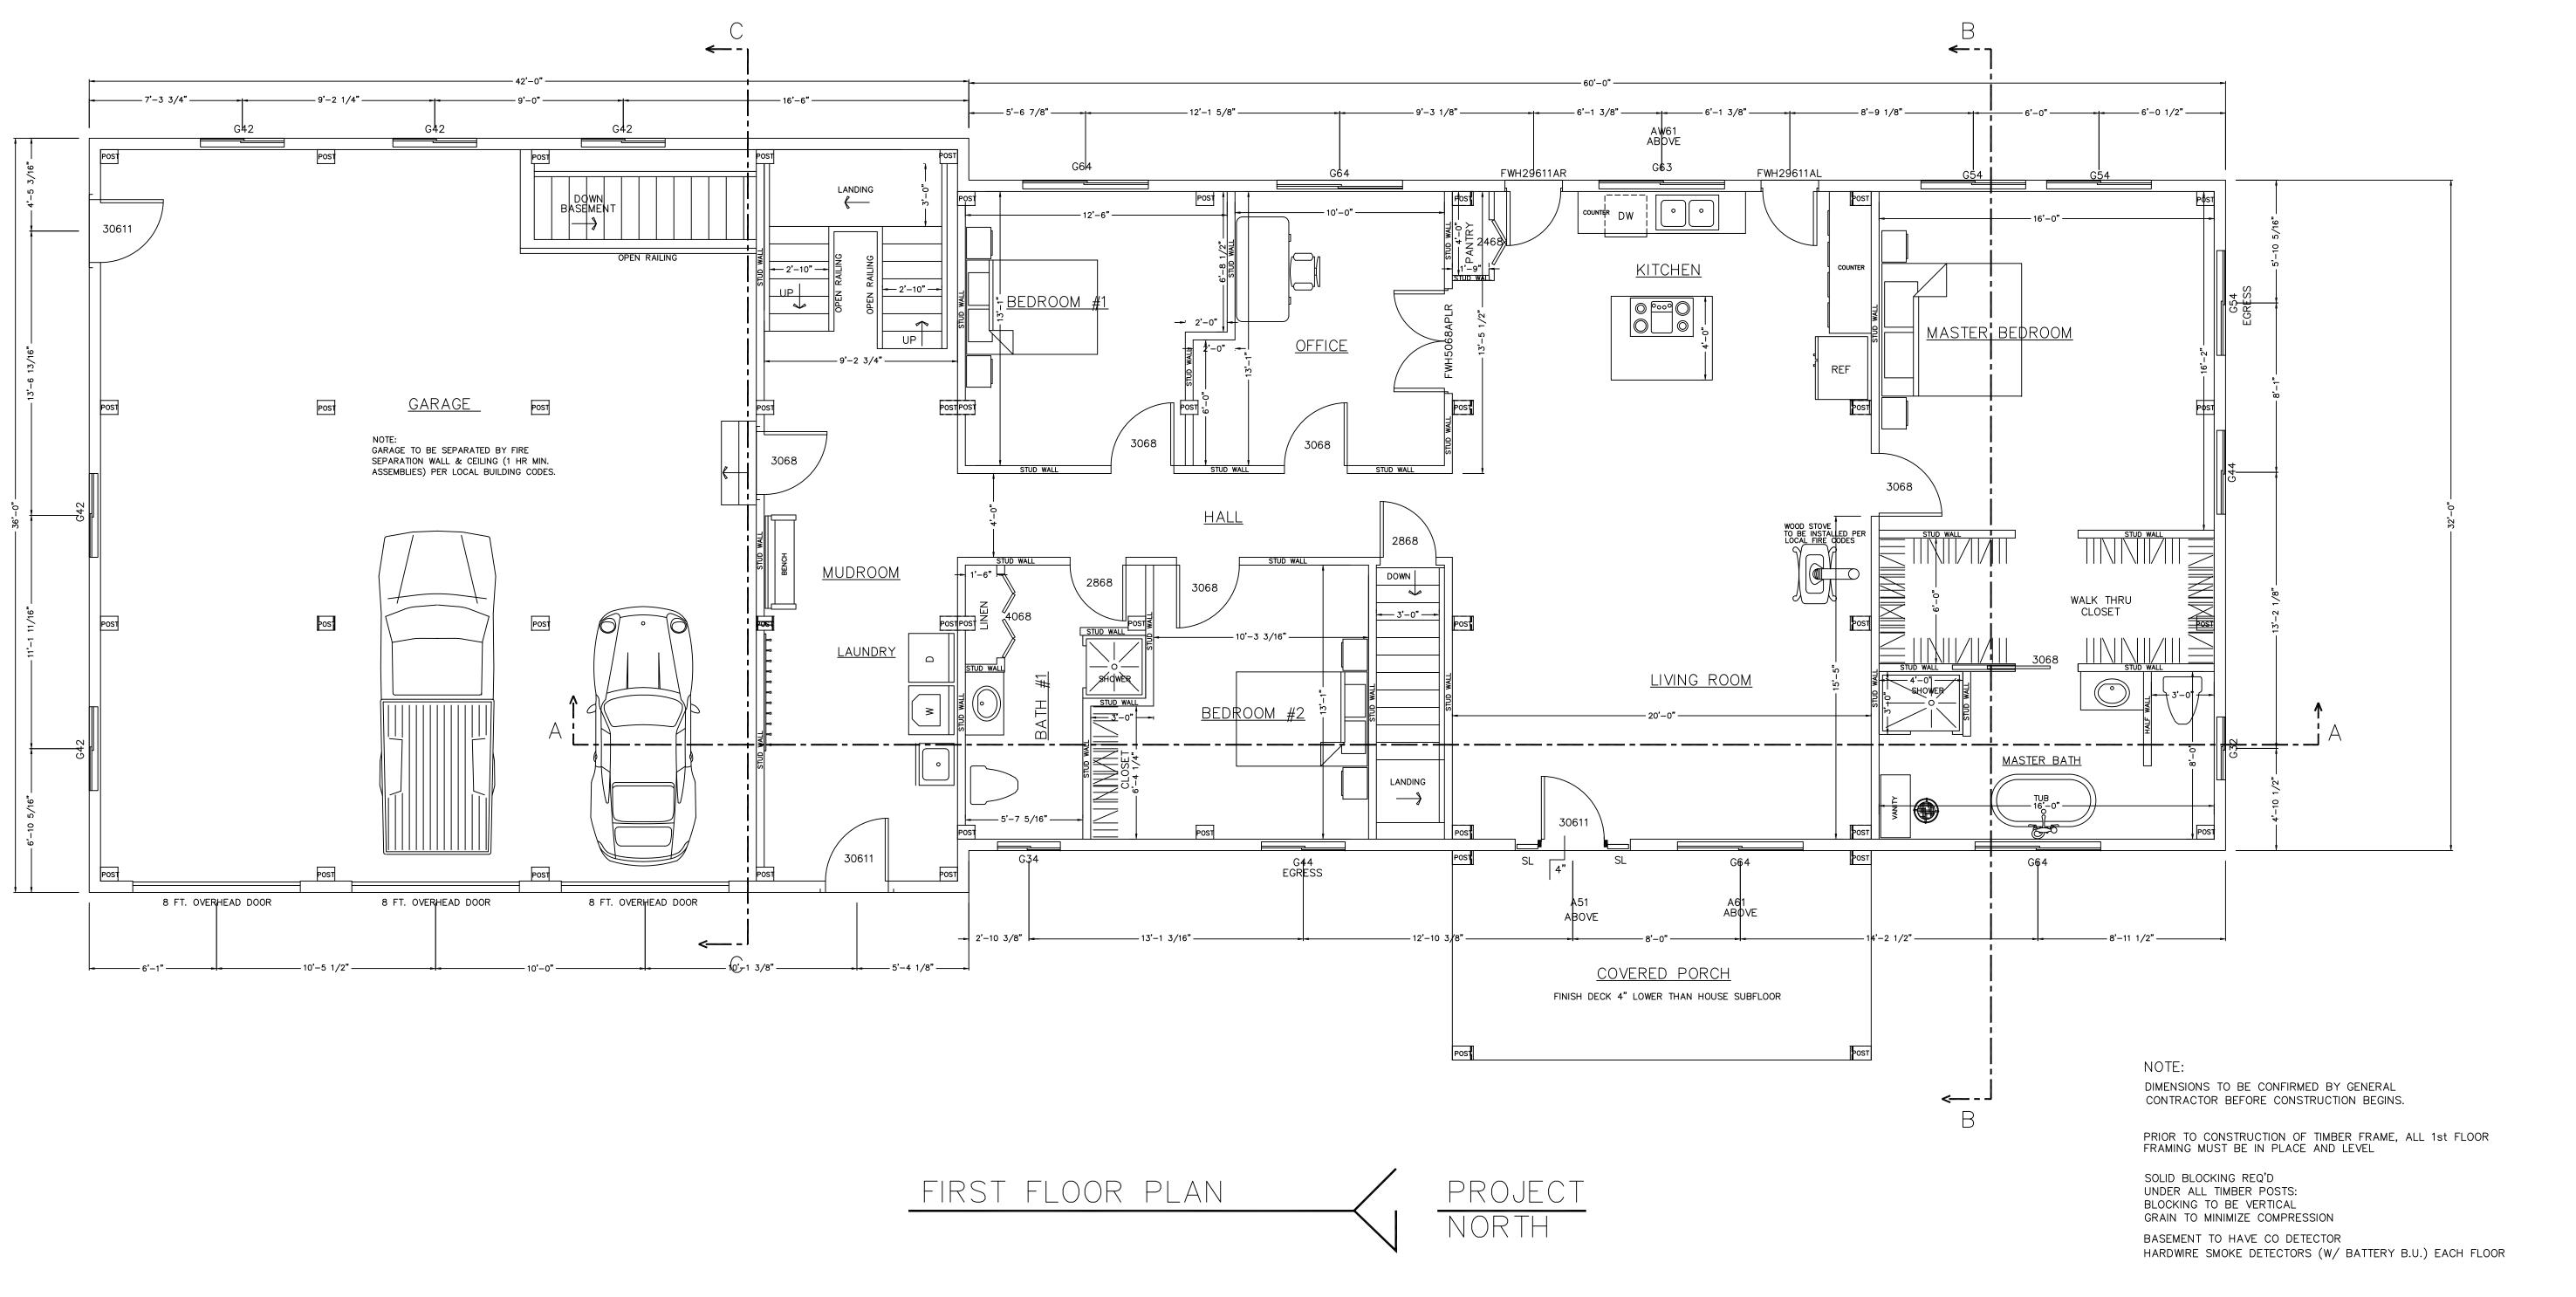

A-1

FINAL LOCATION OF ALL INTERIOR PARTITIONS TO BE DETERMINED AT SITE.

ALL EXTERIOR DECKS, STEPS, RAILS AND SUPPORTS SHOULD MEET STATE AND LOCAL CODES

LOCATION AND ENGINEERING OF ANY RETAINING WALLS IS BY OTHERS (B.O.)

ANY CONSTRUCTION BY OTHERS NOTED AS TO BE VERIFIED (T.B.V.), IS TO BE VERIFIED FOR ACCURACY BY THE OWNER AND/OR BUILDER.


THE STAIR RISER AND TREAD DIMENSIONS ARE CALCULATED FROM THE TOP OF THE 1ST FLR DECK TO THE TOP OF THE SECOND FLOOR DECK. BUILDER TO ADJUST FOR FLOOR FINISHES AS NEEDED.

FIREPLACE AND/OR WOODSTOVE INSTALLATION IS TO COMPLY WITH ALL LOCAL, STATE AND NATIONAL FIRE SAFETY CODES AND REGULATIONS.

IN WHOLE OR IN PART, WITHOUT THE EXPRESSED WRITTEN PERMISSION

OF DW TIMBER FRAME DESIGN

ALL DOORS, WALLS AND CEILINGS BETWEEN THE GARAGE AND LIVING SPACES ARE TO MEET ALL FIRE AND SAFETY CODE REGULATIONS.

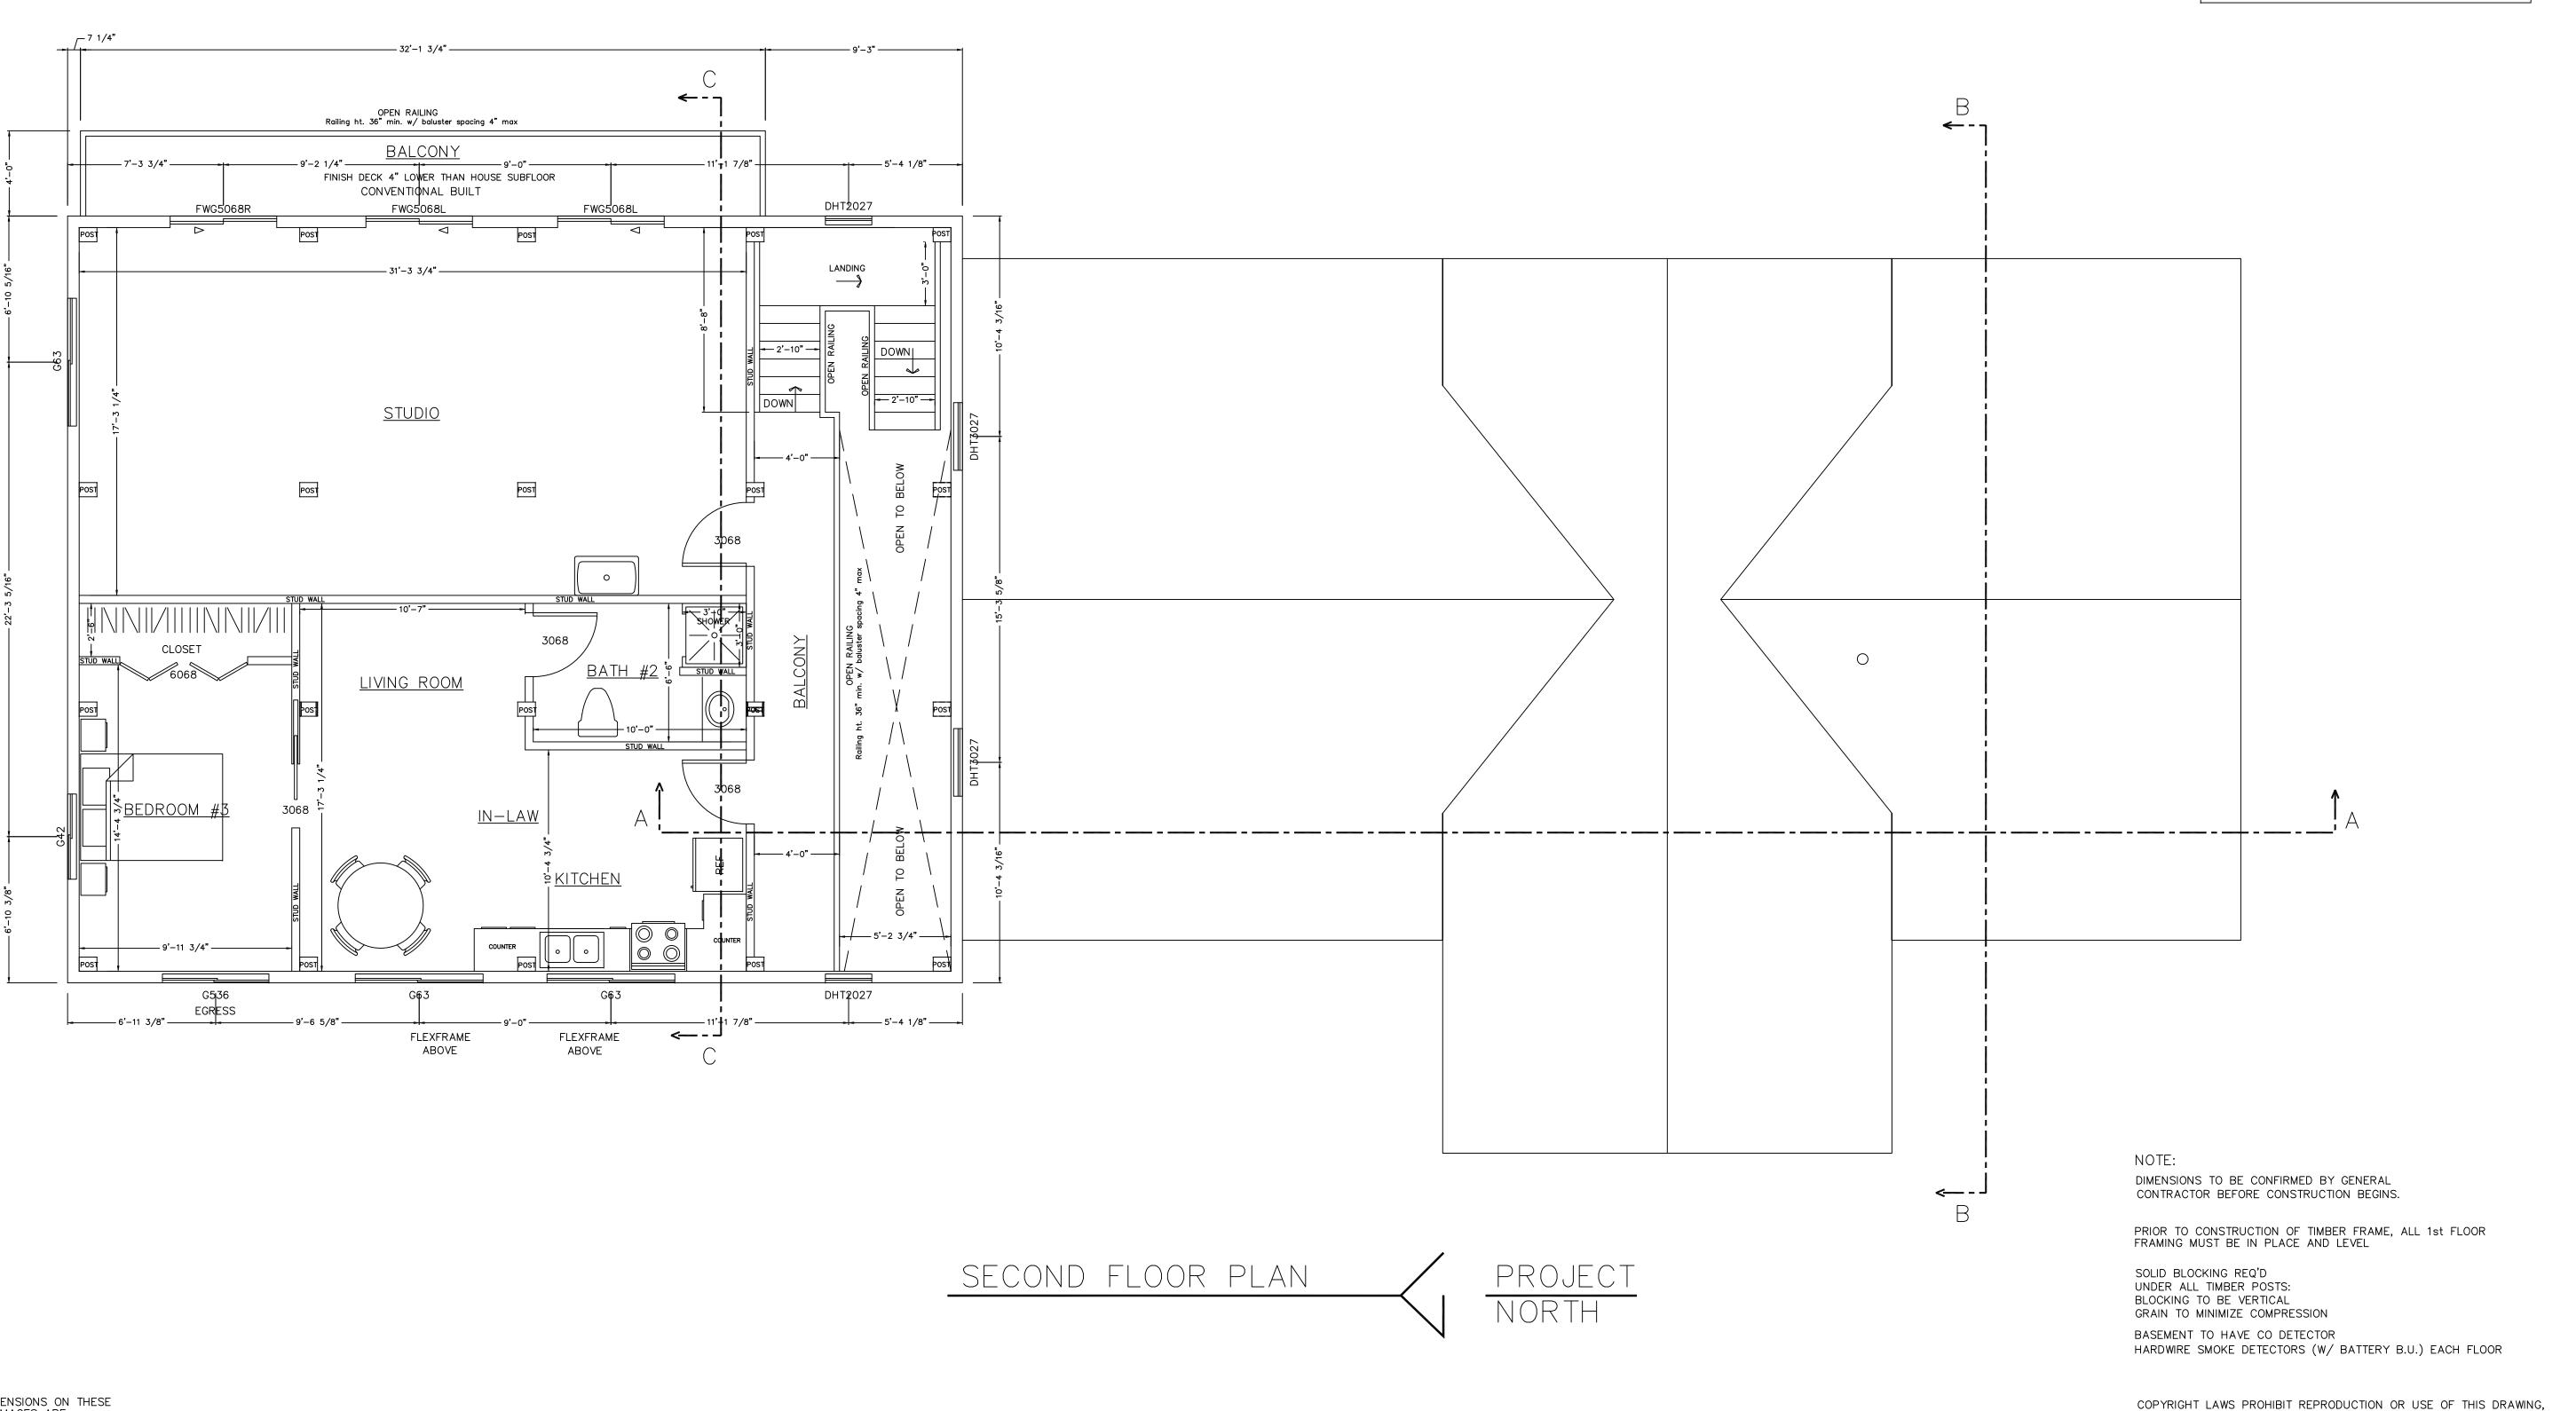

A-2

FINAL LOCATION OF ALL INTERIOR PARTITIONS TO BE DETERMINED AT SITE.

ALL EXTERIOR DECKS, STEPS, RAILS AND SUPPORTS SHOULD MEET STATE AND LOCAL CODES


LOCATION AND ENGINEERING OF ANY RETAINING WALLS IS BY OTHERS (B.O.)


ANY CONSTRUCTION BY OTHERS NOTED AS TO BE VERIFIED (T.B.V.), IS TO BE VERIFIED FOR ACCURACY BY THE OWNER AND/OR BUILDER.

THE STAIR RISER AND TREAD DIMENSIONS
ARE CALCULATED FROM THE TOP OF THE
1ST FLR DECK TO THE TOP OF THE SECOND
FLOOR DECK. BUILDER TO ADJUST
FOR FLOOR FINISHES AS NEEDED.

FIREPLACE AND/OR WOODSTOVE INSTALLATION
IS TO COMPLY WITH ALL LOCAL, STATE AND
NATIONAL FIRE SAFETY CODES AND REGULATIONS.

ALL DOORS, WALLS AND CEILINGS BETWEEN
THE GARAGE AND LIVING SPACES ARE TO MEET
ALL FIRE AND SAFETY CODE REGULATIONS.

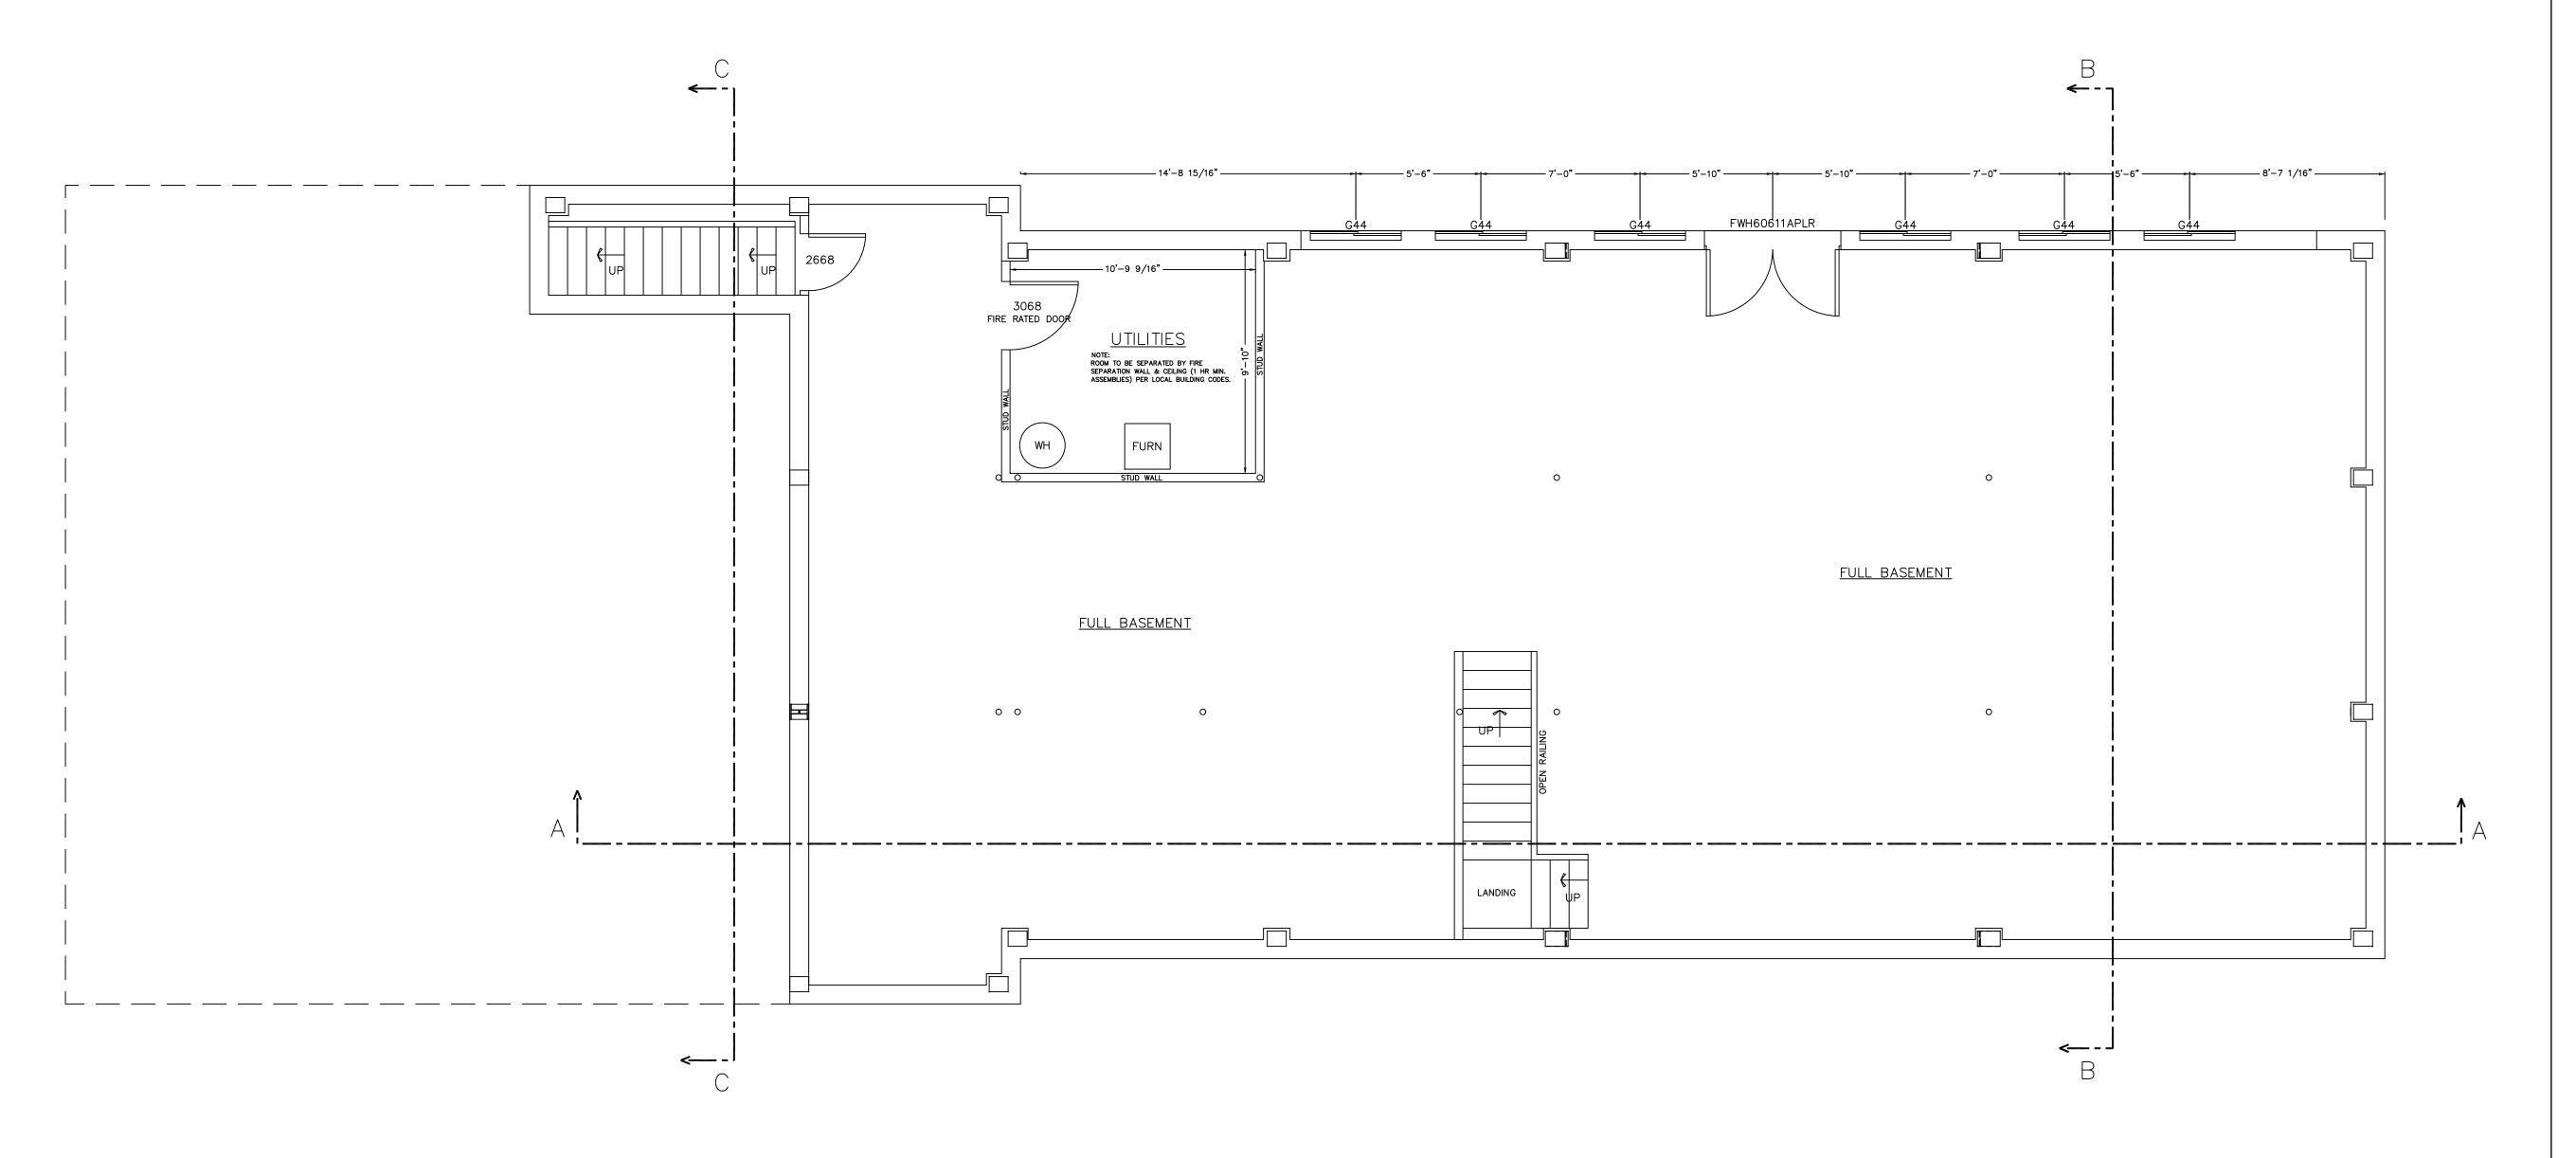

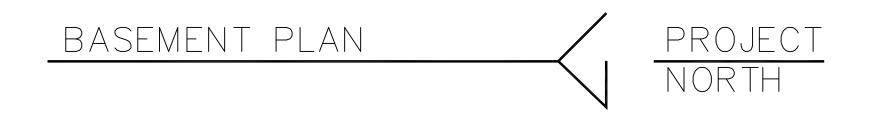

DIMENSIONS TO BE CONFIRMED BY GENERAL CONTRACTOR BEFORE CONSTRUCTION BEGINS.

PRIOR TO CONSTRUCTION OF TIMBER FRAME, ALL 1st FLOOR FRAMING MUST BE IN PLACE AND LEVEL

SOLID BLOCKING REQ'D
UNDER ALL TIMBER POSTS:
BLOCKING TO BE VERTICAL
GRAIN TO MINIMIZE COMPRESSION
BASEMENT TO HAVE CO DETECTOR

HARDWIRE SMOKE DETECTORS (W/ BATTERY B.U.) EACH FLOOR


COPYRIGHT LAWS PROHIBIT REPRODUCTION OR USE OF THIS DRAWING, IN WHOLE OR IN PART, WITHOUT THE EXPRESSED WRITTEN PERMISSION OF DW TIMBER FRAME DESIGN

DATE: 4/1/19
DRAWN BY: DEW
CHECKED BY:

BOLDUC RESIDENCE
FAIRFIELD, VT 05455

ABER FRAME & PANEL HOME DESIGNAM. TIMBERFRAMEDESIGN.NET

A-3

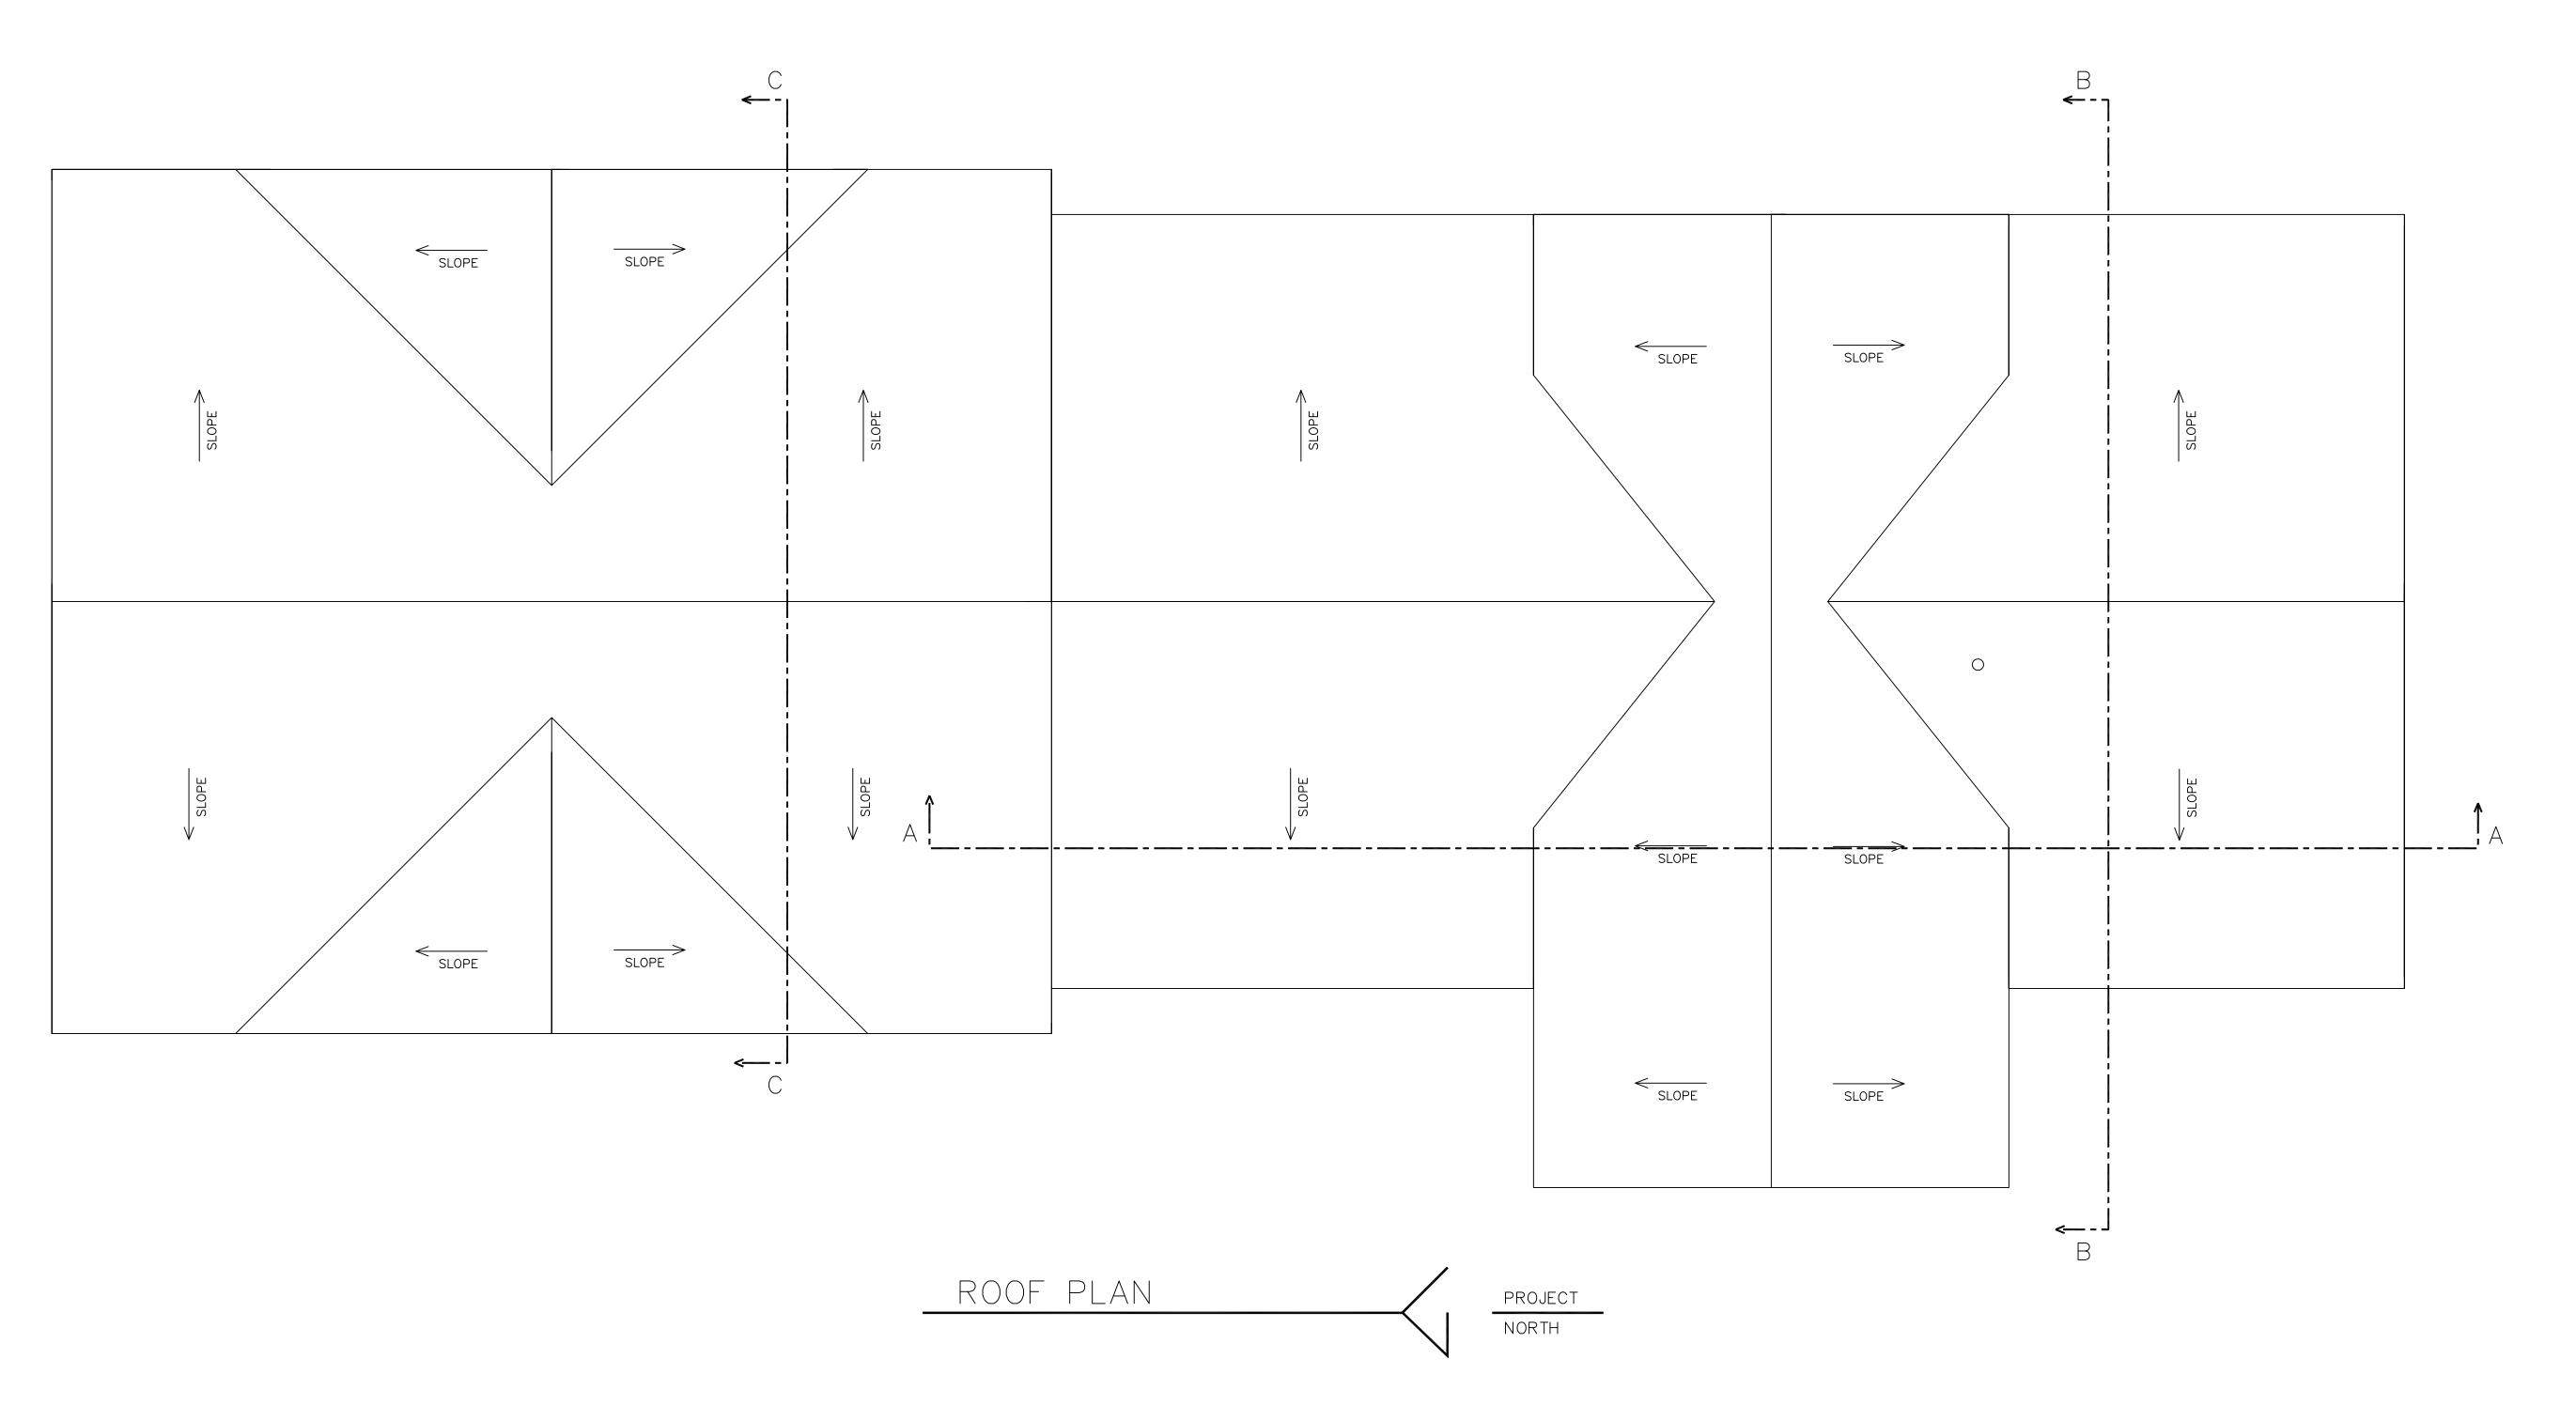

DO NOT SCALE DIMENSIONS ON THESE DRAWINGS. THESE IMAGES ARE MACHINE REPRODUCTIONS AND MAY CONTAIN A MARGIN OF ERROR.


COPYRIGHT LAWS PROHIBIT REPRODUCTION OR USE OF THIS DRAWING, IN WHOLE OR IN PART, WITHOUT THE EXPRESSED WRITTEN PERMISSION OF DW TIMBER FRAME DESIGN

DATE: NUMBER & DISCRIPTION 6/2/19 5/30/19 7/27/19	DATE: 1 6/2/19 6/15/19 6/30/19 7/27/19	SCALE: 1/4" = 1'-O" DATE: 4/1/19 DRAWN BY: CHECKED BY:
	6/30/19	
	6/15/19	
	6/2/19	
NUMBER & DISCRIPTION	DATE:	
REVISION		CALE: 1/4" = 1'-0"

BOLDUC RESIDENCE
FAIRFIELD, VT 05455

TIMBER FRAME DESIGN
FRAME & PANEL HOME DESIGN
FRAME & PANEL HOME DESIGN
FIMBERFRAMEDESIGN.NET
ONE: (603)852-8251

A-4

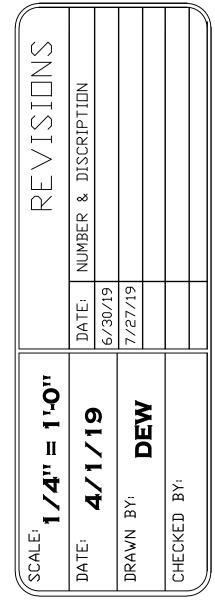

RESIDENCE LD, VT 05455

BOLDUC

A-5




TOP OF 1ST FLR WINDOWS @ 6'-11" TOP OF 2ND FLR WINDOWS @ 6'-8"

IN WHOLE OR IN PART, WITHOUT THE EXPRESSED WRITTEN PERMISSION OF DW TIMBER FRAME DESIGN

DO NOT SCALE DIMENSIONS ON THESE DRAWINGS. THESE IMAGES ARE MACHINE REPRODUCTIONS AND MAY CONTAIN A MARGIN OF ERROR.

COPYRIGHT LAWS PROHIBIT REPRODUCTION OR USE OF THIS DRAWING,

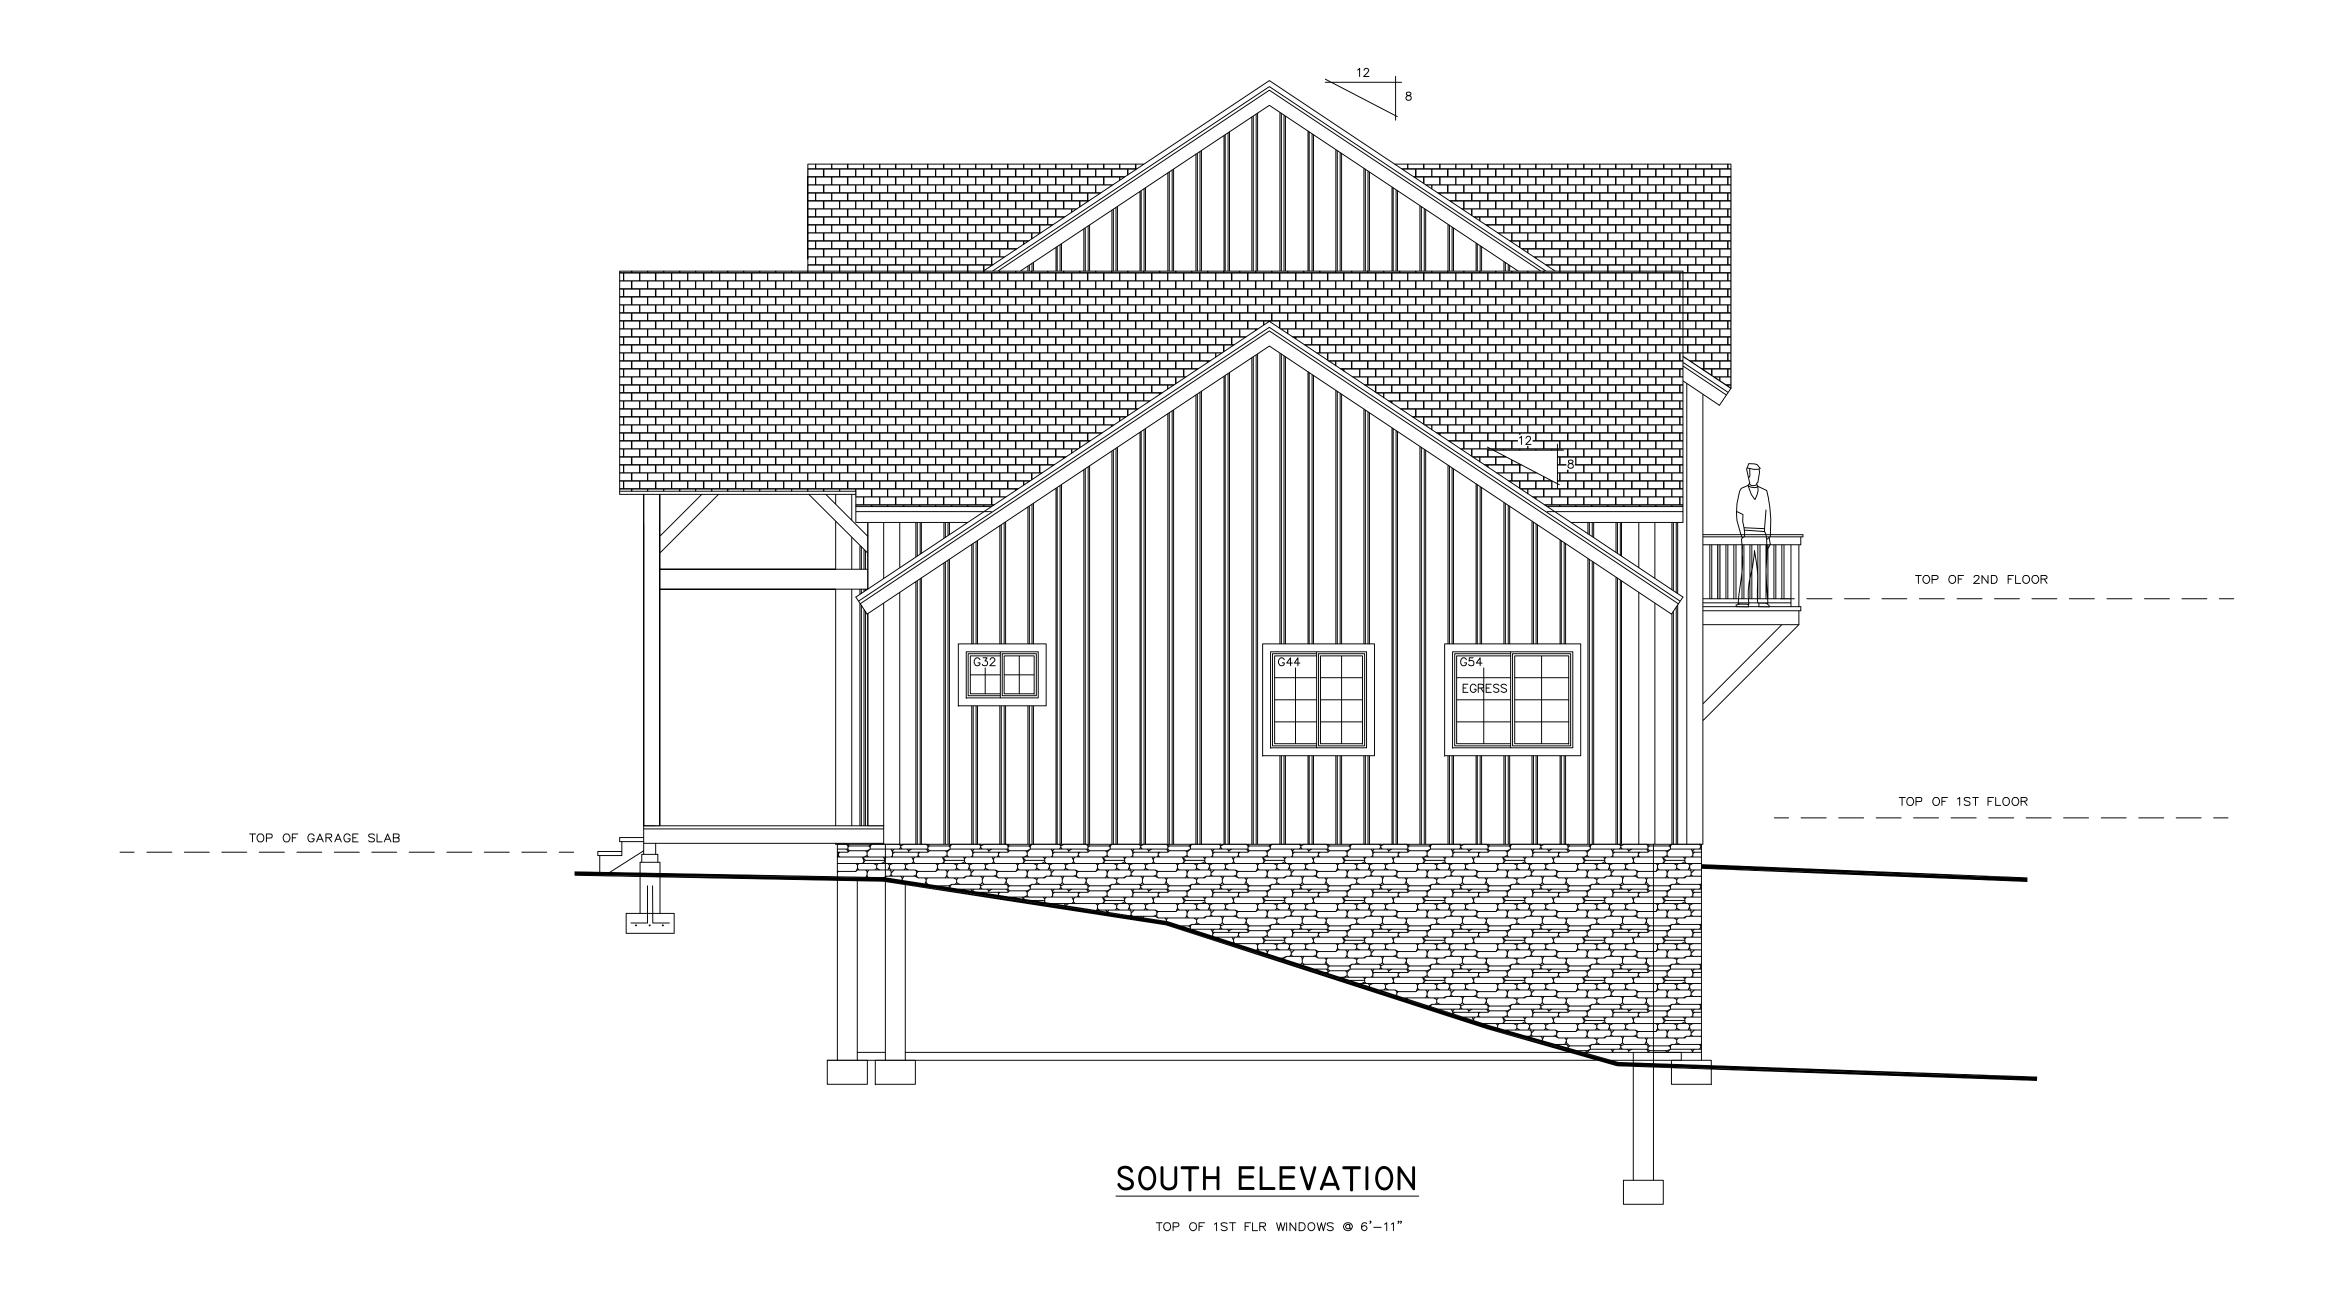


SIDENCE VT 05455 BOLDUC


DO NOT SCALE DIMENSIONS ON THESE DRAWINGS. THESE IMAGES ARE MACHINE REPRODUCTIONS AND MAY CONTAIN A MARGIN OF ERROR.

COPYRIGHT LAWS PROHIBIT REPRODUCTION OR USE OF THIS DRAWING, IN WHOLE OR IN PART, WITHOUT THE EXPRESSED WRITTEN PERMISSION OF DW TIMBER FRAME DESIGN

A-6

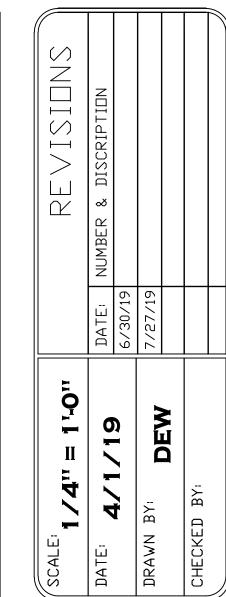


A-7

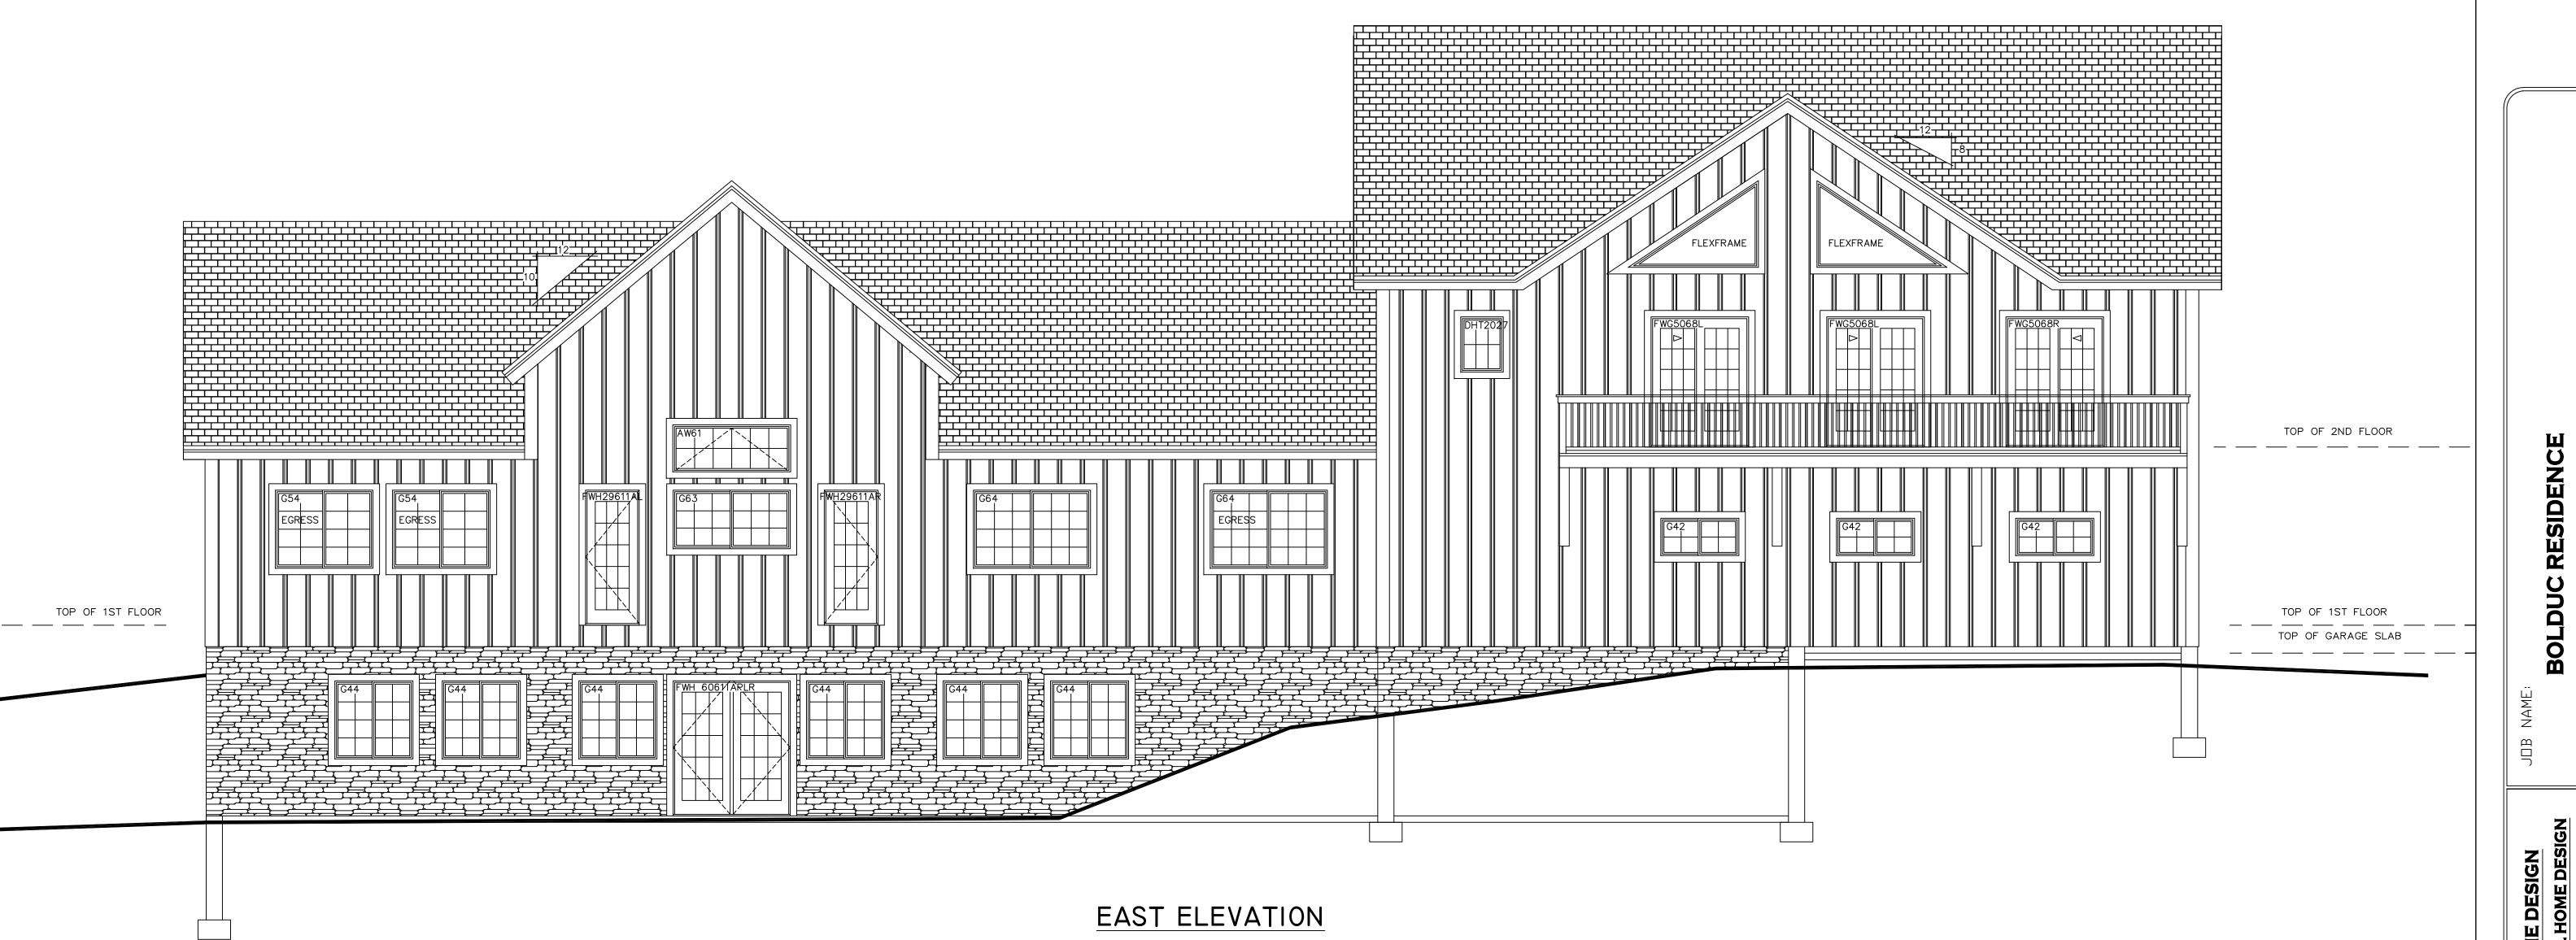

EAST ELEVATION

TOP OF 1ST FLR WINDOWS @ 6'-11" TOP OF 2ND FLR WINDOWS @ 6'-8" TOP OF BASEMENT WINDOWS @ 6'-11"

> COPYRIGHT LAWS PROHIBIT REPRODUCTION OR USE OF THIS DRAWING, IN WHOLE OR IN PART, WITHOUT THE EXPRESSED WRITTEN PERMISSION OF DW TIMBER FRAME DESIGN

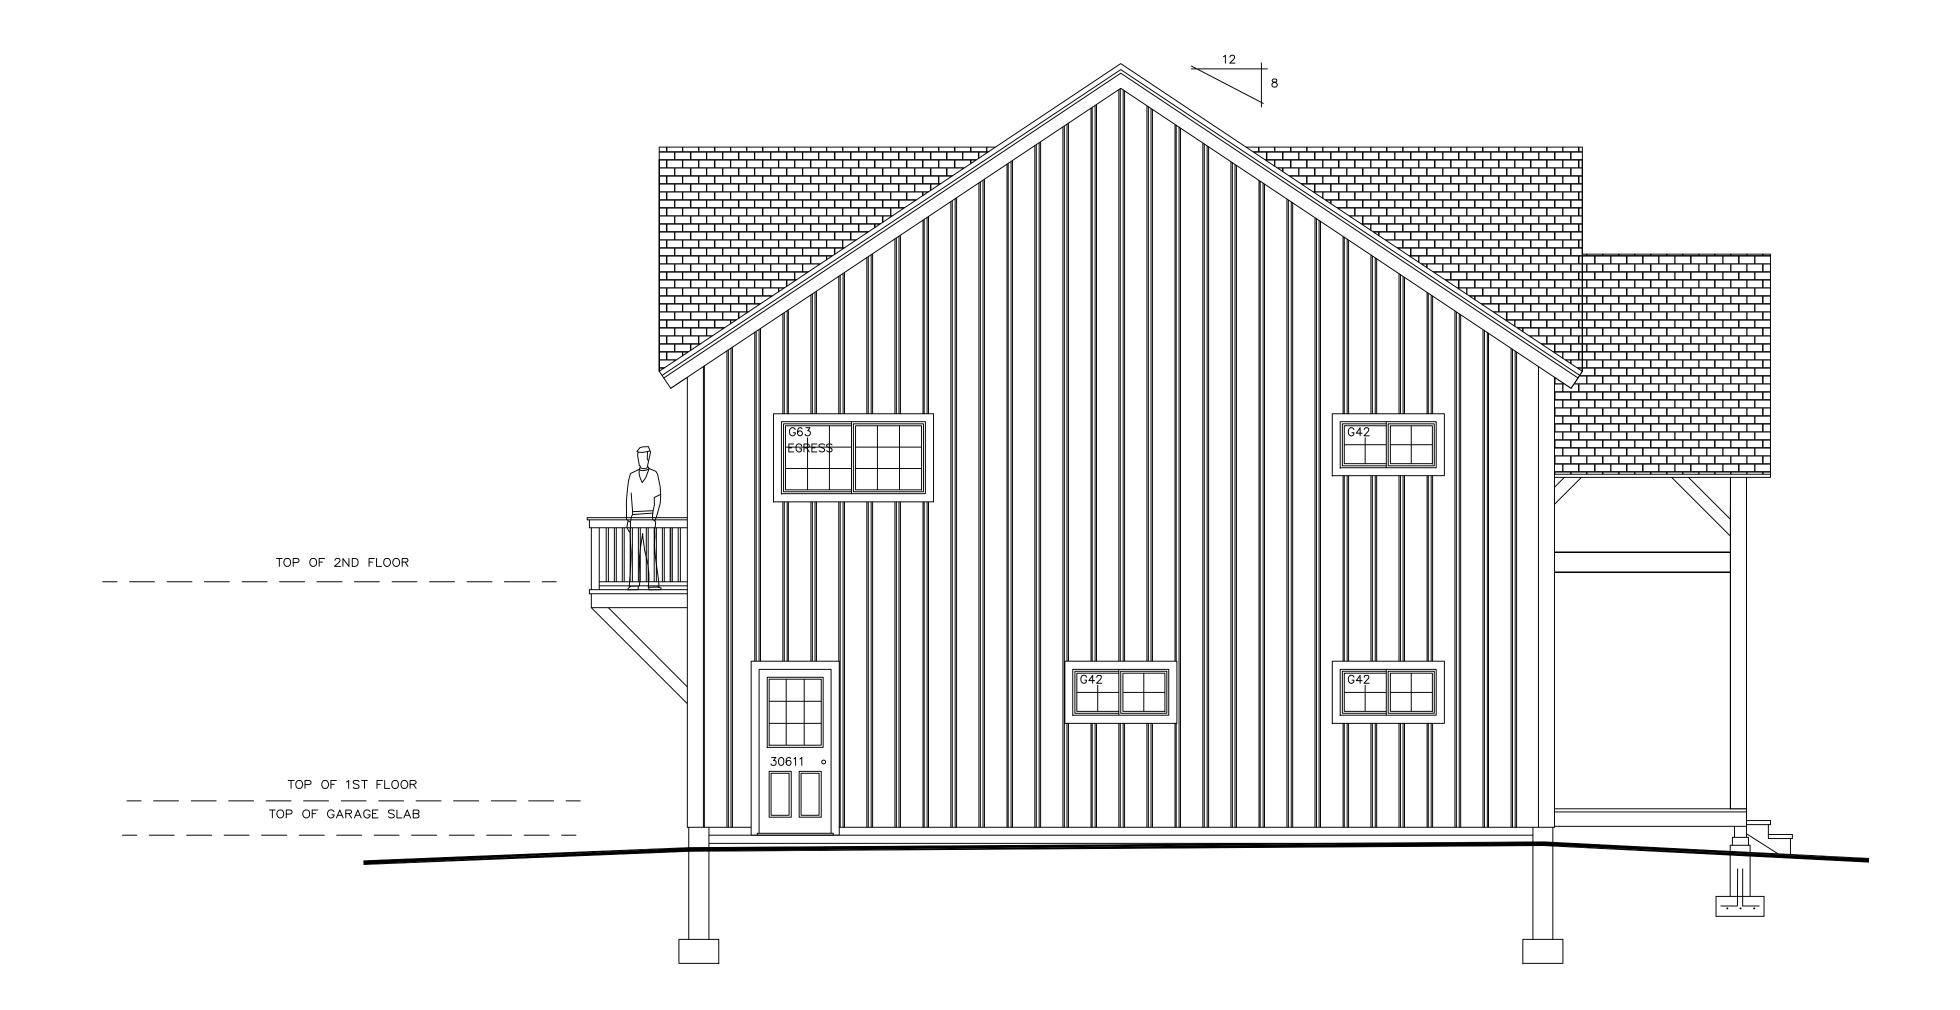

NORTH ELEVATION


TOP OF 1ST FLR WINDOWS @ 6'-11"
TOP OF 2ND FLR WINDOWS @ 6'-8"


RESIDENCE D, VT 05455 BOLDUC

A-8


DO NOT SCALE DIMENSIONS ON THESE DRAWINGS. THESE IMAGES ARE MACHINE REPRODUCTIONS AND MAY CONTAIN A MARGIN OF ERROR.

COPYRIGHT LAWS PROHIBIT REPRODUCTION OR USE OF THIS DRAWING, IN WHOLE OR IN PART, WITHOUT THE EXPRESSED WRITTEN PERMISSION OF DW TIMBER FRAME DESIGN

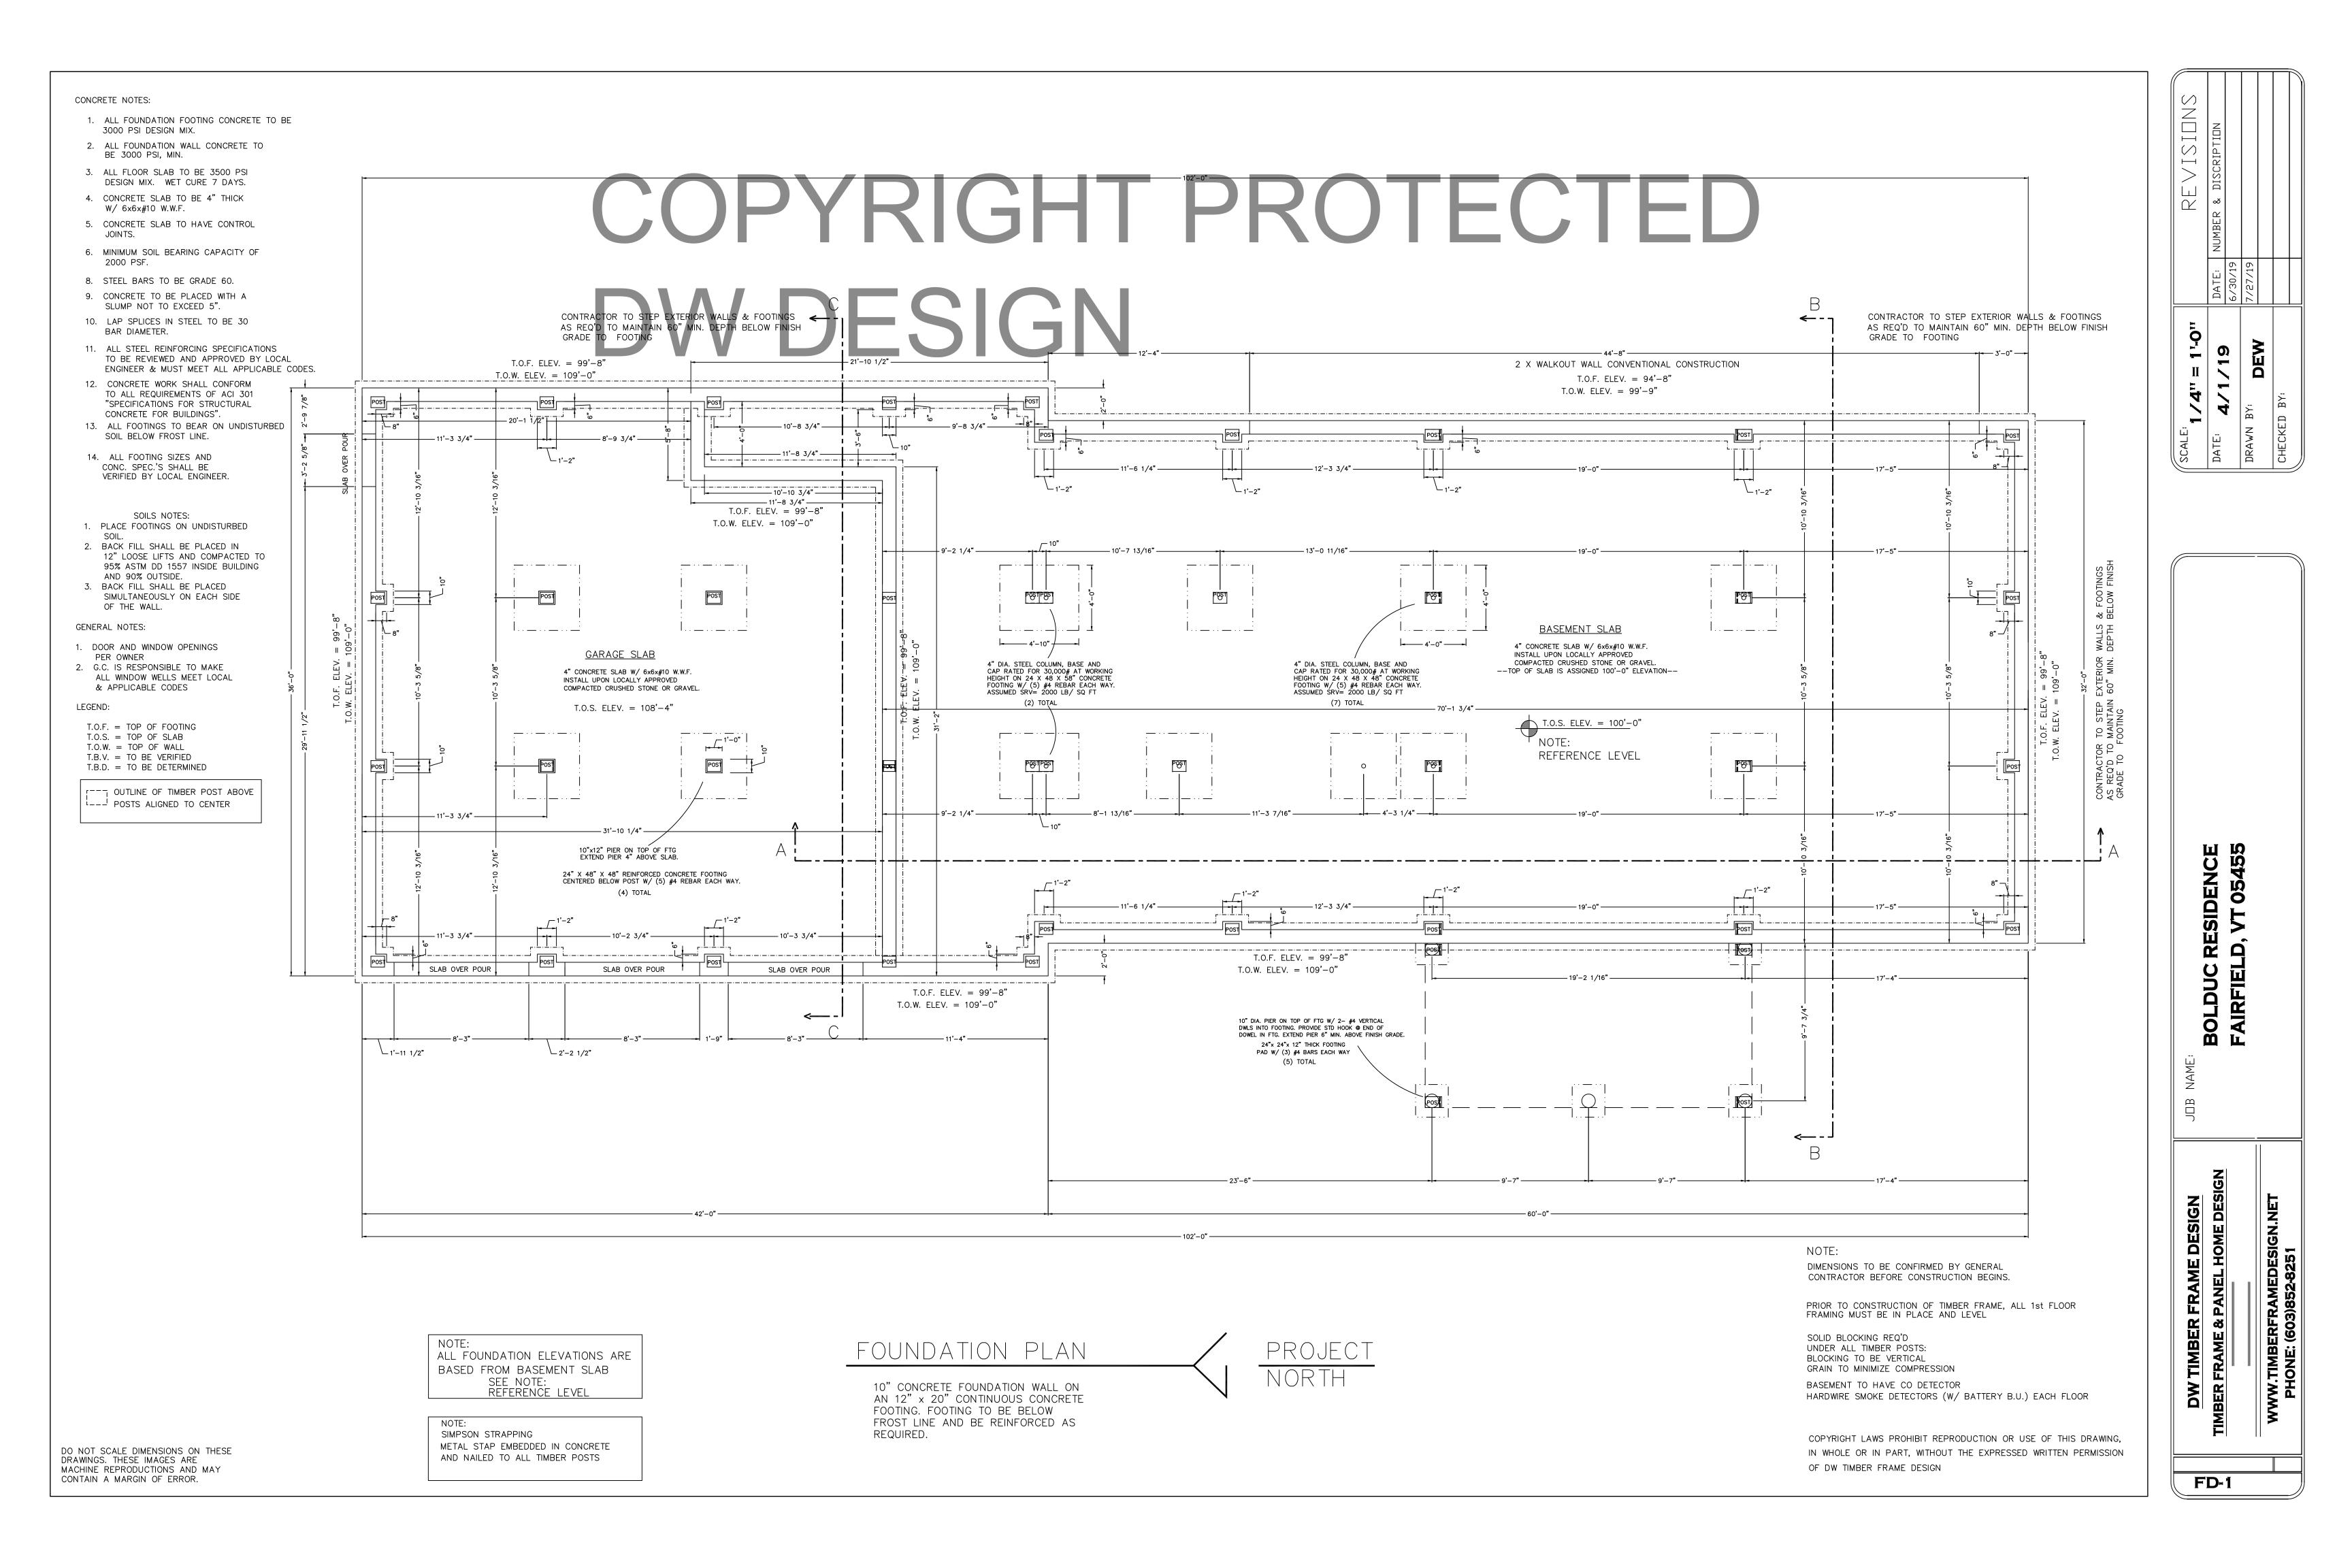


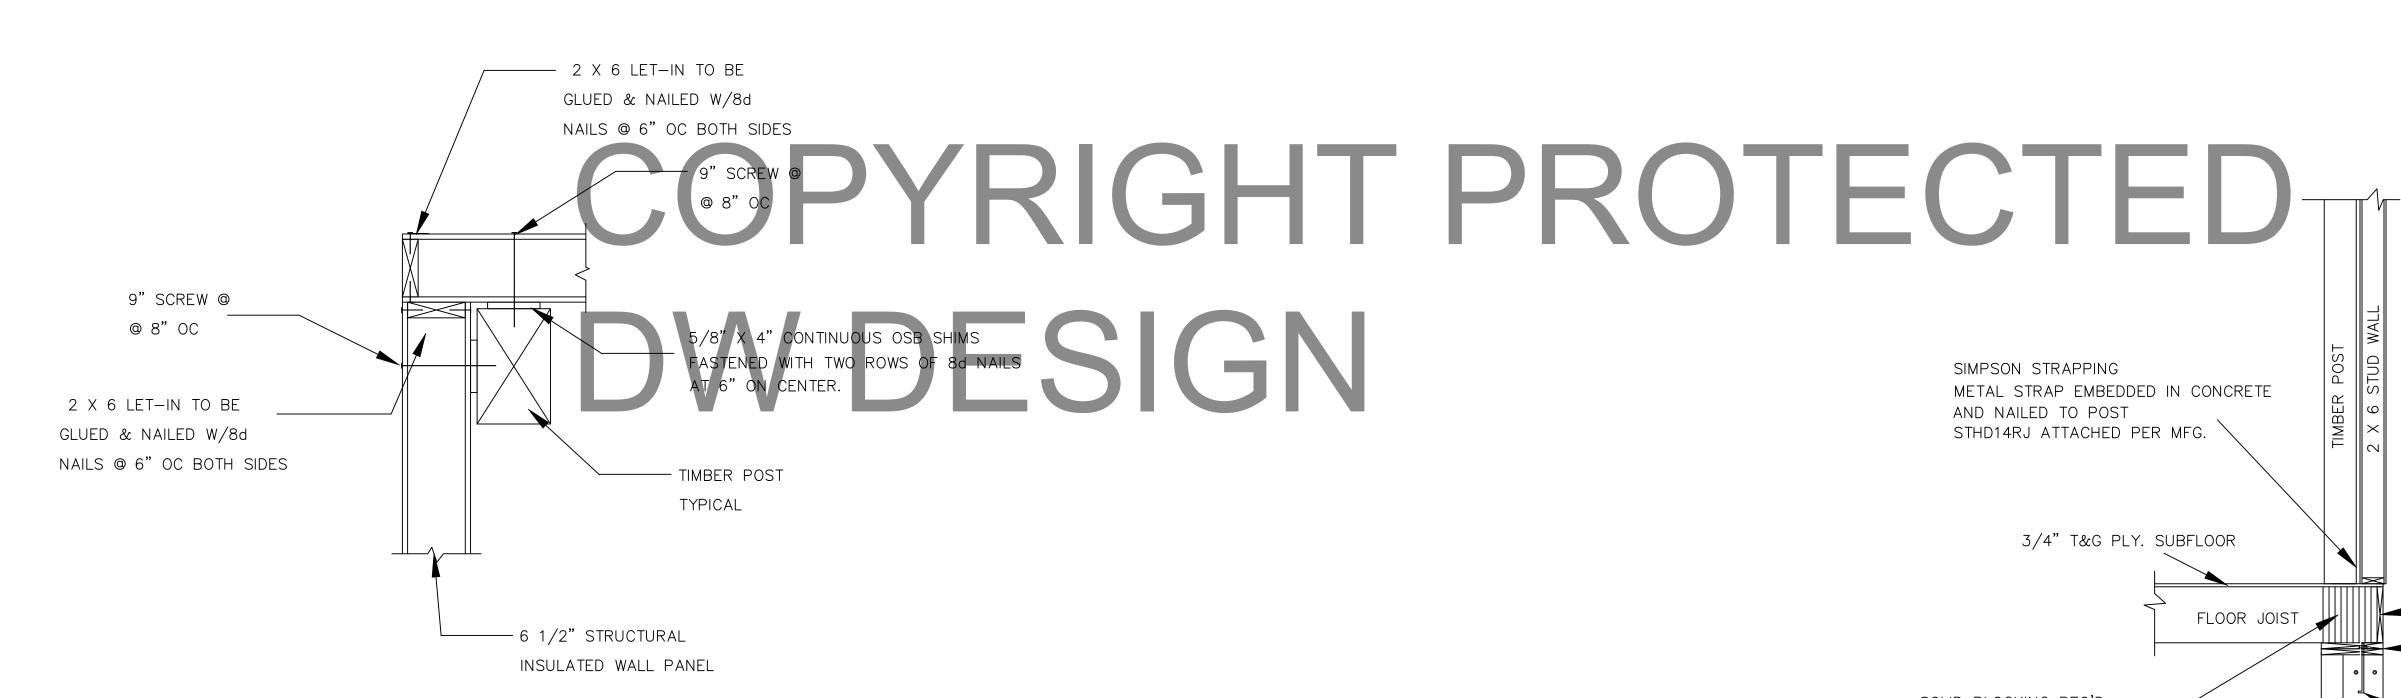


PANEL CORNER CONNECTION W/ POST STRUCTURAL PANELS

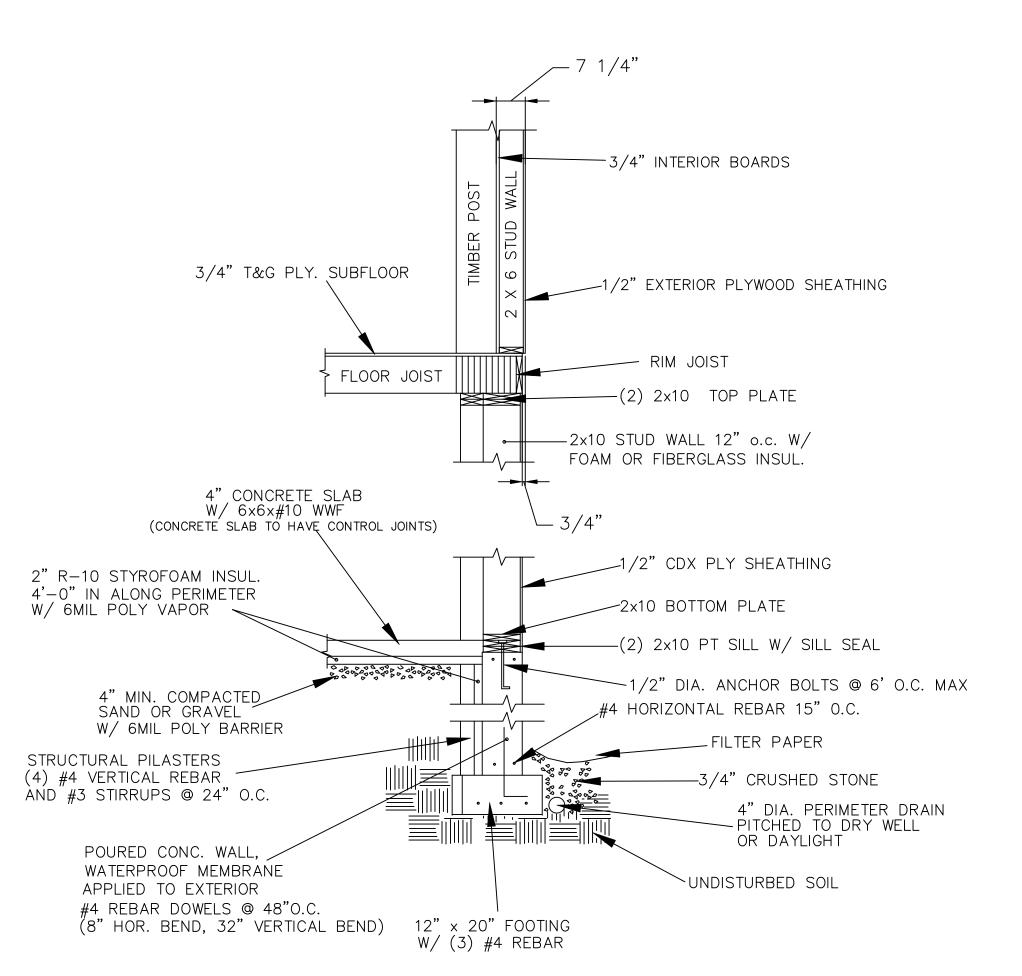

TIMBER WALL SECTION @ WALK OUT

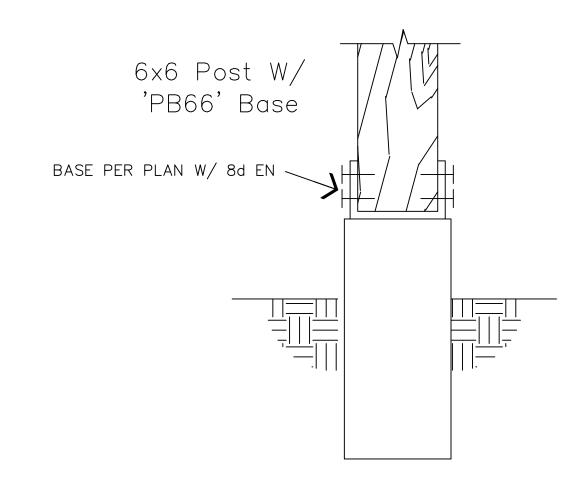

DECK TIMBER POST CONN.

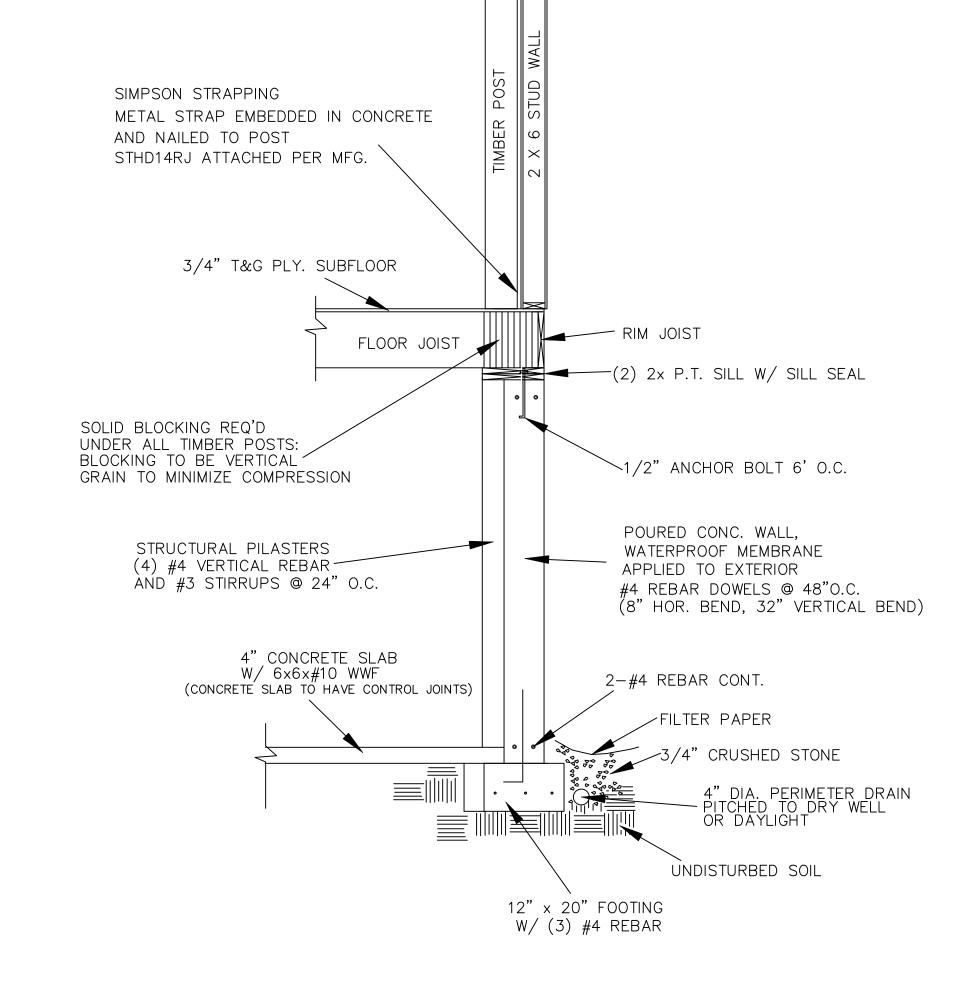

STANDARD TIMBER WALL SECTION

CONTRACTOR TO STEP EXTERIOR WALLS & FOOTINGS AS REQ'D TO MAINTAIN 60" MIN. DEPTH BELOW FINISH GRADE TO FOOTING

COPYRIGHT LAWS PROHIBIT REPRODUCTION OR USE OF THIS DRAWING, IN WHOLE OR IN PART, WITHOUT THE EXPRESSED WRITTEN PERMISSION OF DW TIMBER FRAME DESIGN

SCALE: 1/2" = 1'-0"

DATE: 4/1/19

DRAWN BY: DEW

CHECKED BY:

IVISION DISCRIPTION

BOLDUC RESIDENCE FAIRFIELD, VT 05455


JOB NAMI


TIMBER FRAME DESIGN
FRAME & PANEL HOME DESIGN

FD-2


DO NOT SCALE DIMENSIONS ON THESE DRAWINGS. THESE IMAGES ARE MACHINE REPRODUCTIONS AND MAY

CONTAIN A MARGIN OF ERROR.

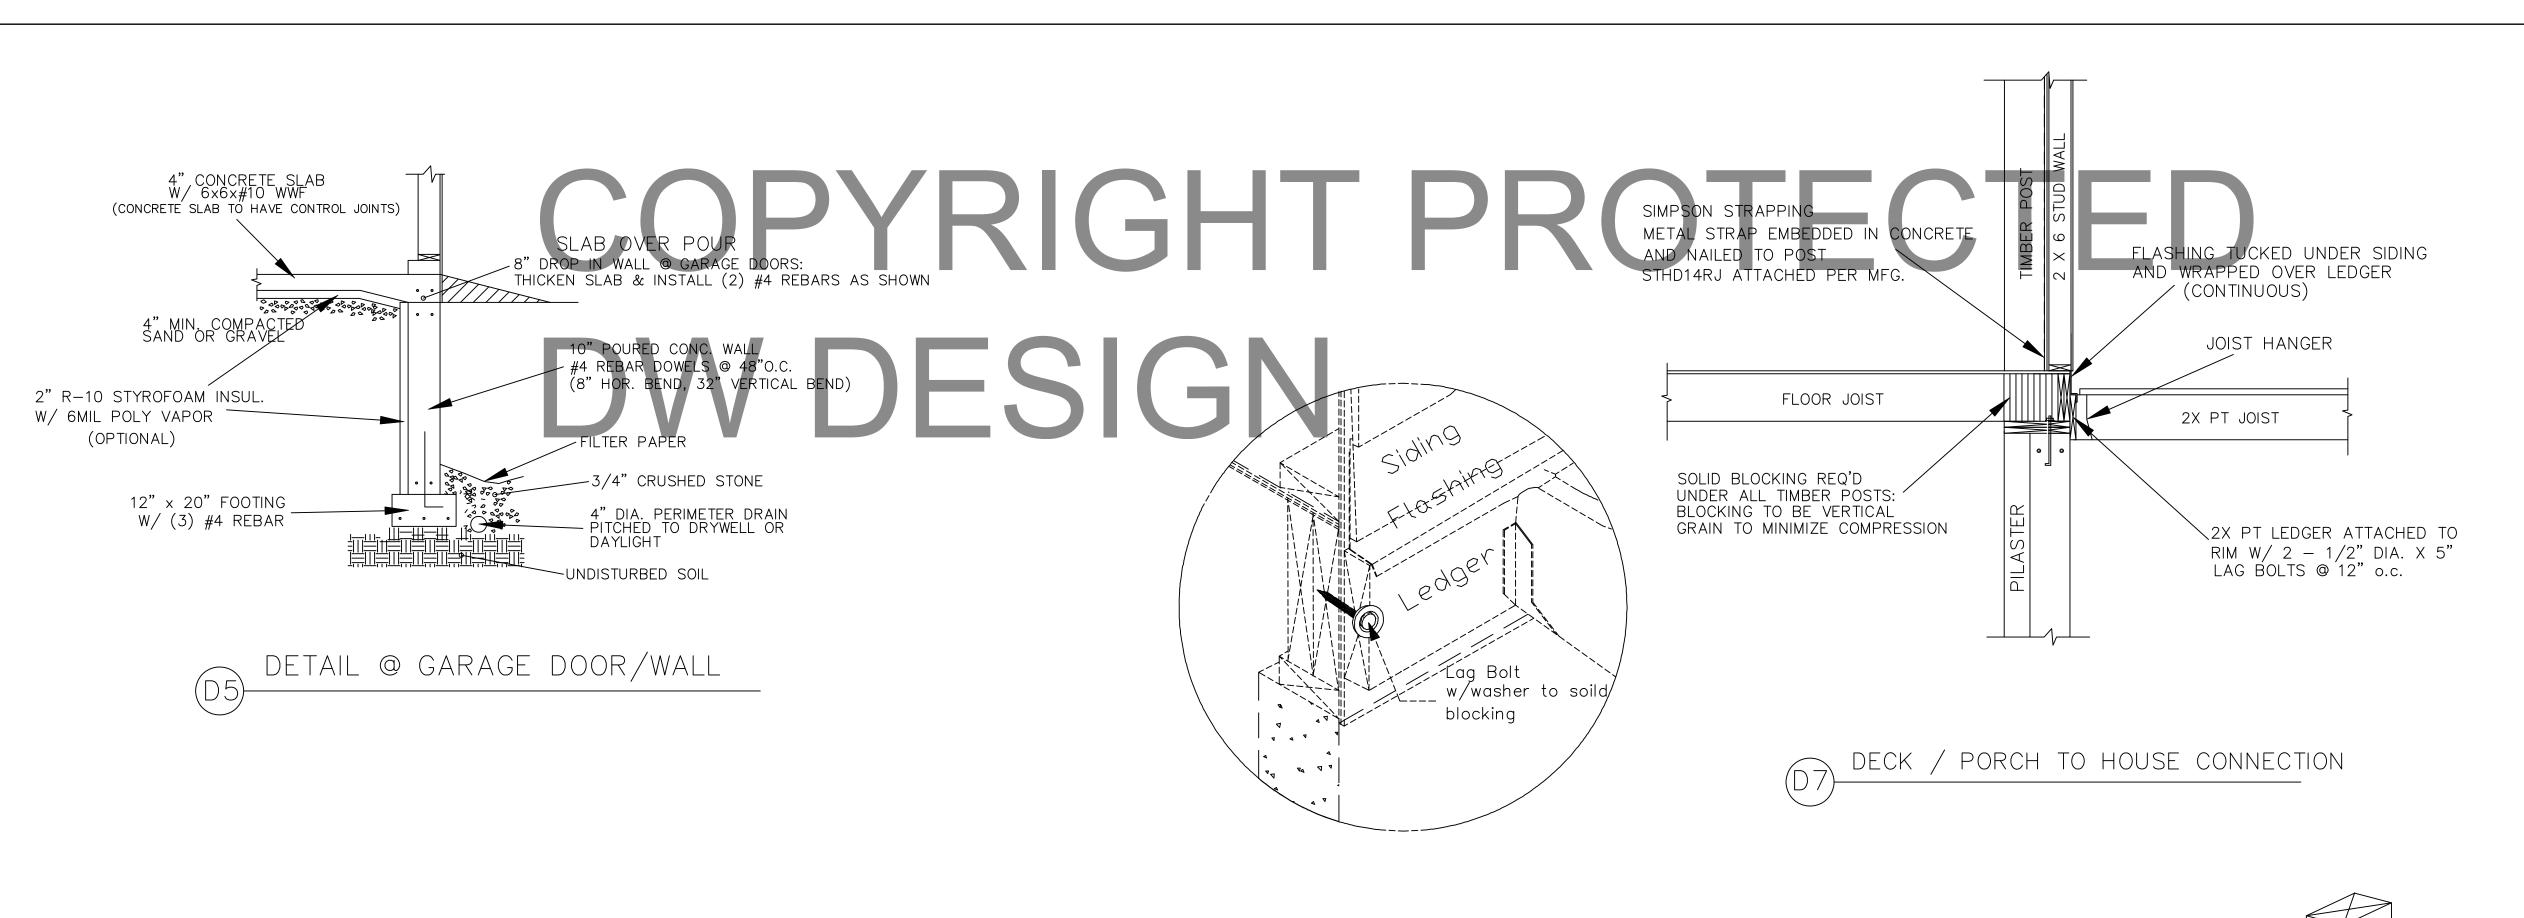

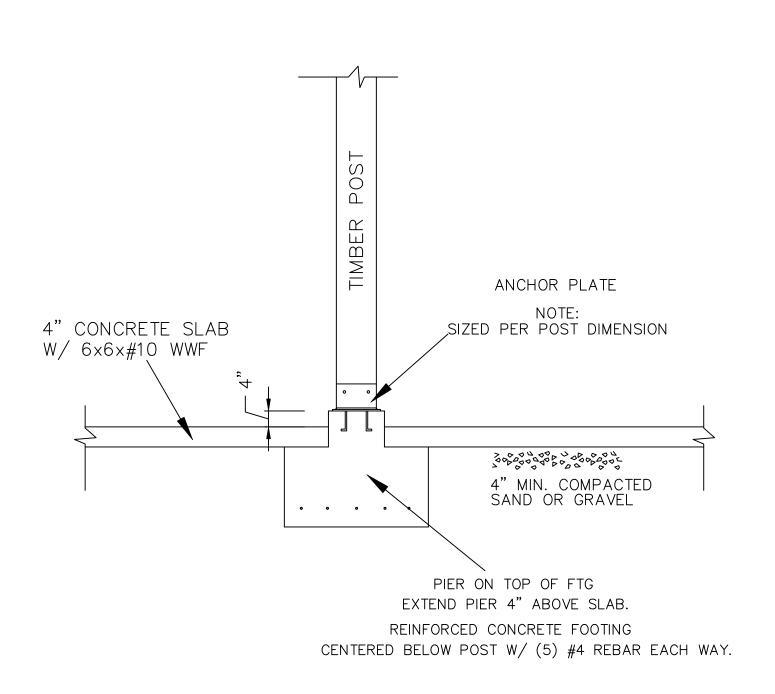




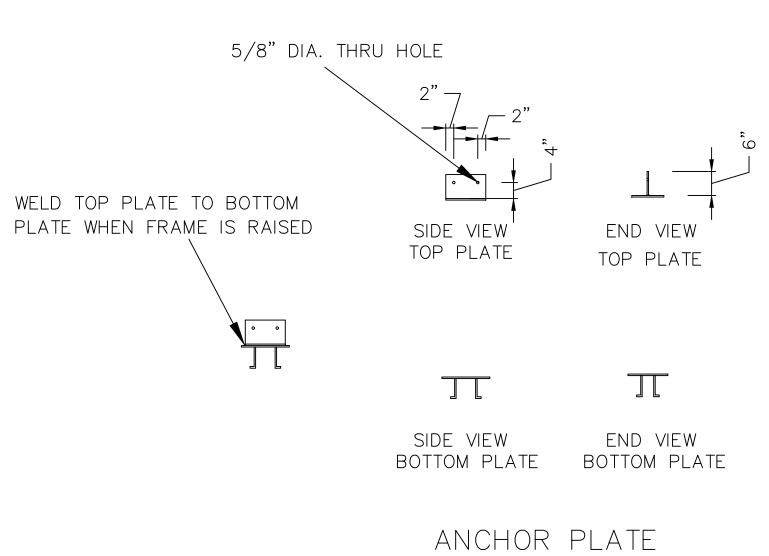

ANCHOR PLATE (3/8" STEEL PLATE)

GARAGE TIMBER POST ANCHOR PLATE NOTE: SIZED PER POST DIMENSION (INTERIOR POST)

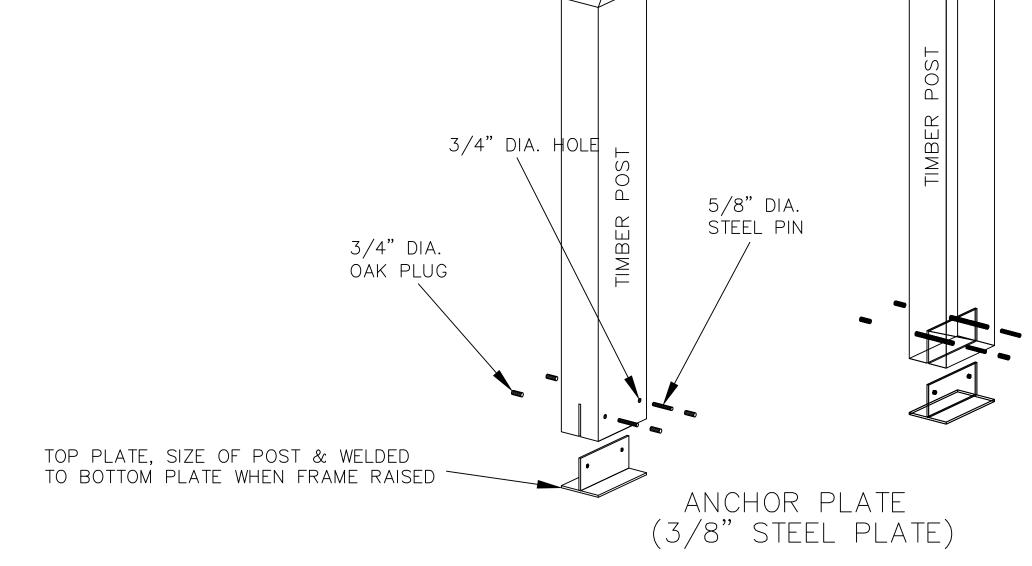

BOTTOM PLATE SIZE, 1" LARGER ON

EACH SIDE THAN THE TOP PLATE

(EMBED IN CONCRETE)

GARAGE TIMBER POST ANCHOR PLATE NOTE: SIZED PER POST DIMENSION (INTERIOR POST)

COPYRIGHT LAWS PROHIBIT REPRODUCTION OR USE OF THIS DRAWING, IN WHOLE OR IN PART, WITHOUT THE EXPRESSED WRITTEN PERMISSION OF DW TIMBER FRAME DESIGN

(4) #5 REBAR 5" LONG WELDED TO PLATE

CONTRACTOR TO STEP EXTERIOR WALLS & FOOTINGS AS REQ'D TO MAINTAIN 60" MIN. DEPTH BELOW FINISH GRADE TO FOOTING


-VISION DISCRIPTION R F


RESIDENCE D, VT 05455

BOLDUC FAIRFIEL

WWW.TIMBERFRAMEDESIGN.NET PHONE: (603)852-8251 FAX: (9

FD-3

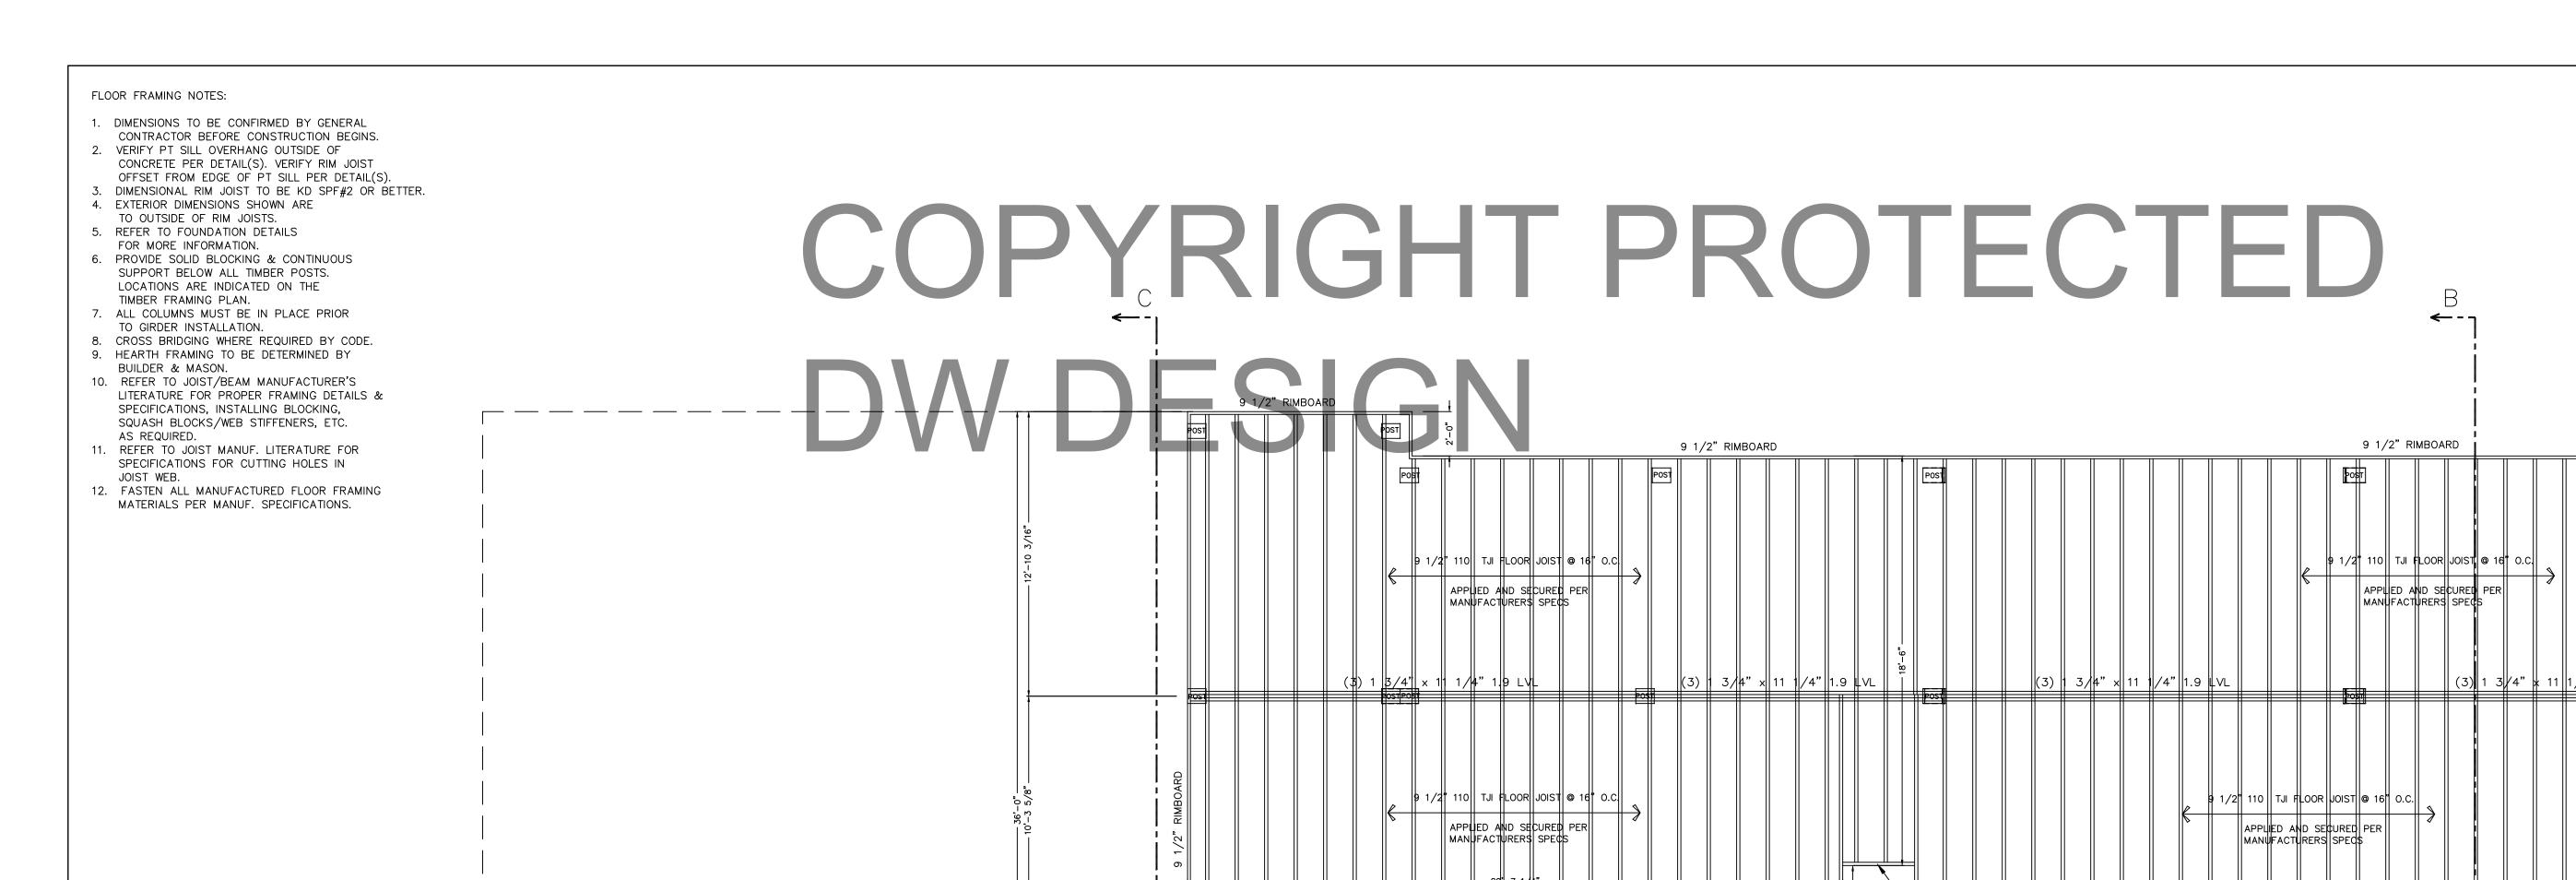

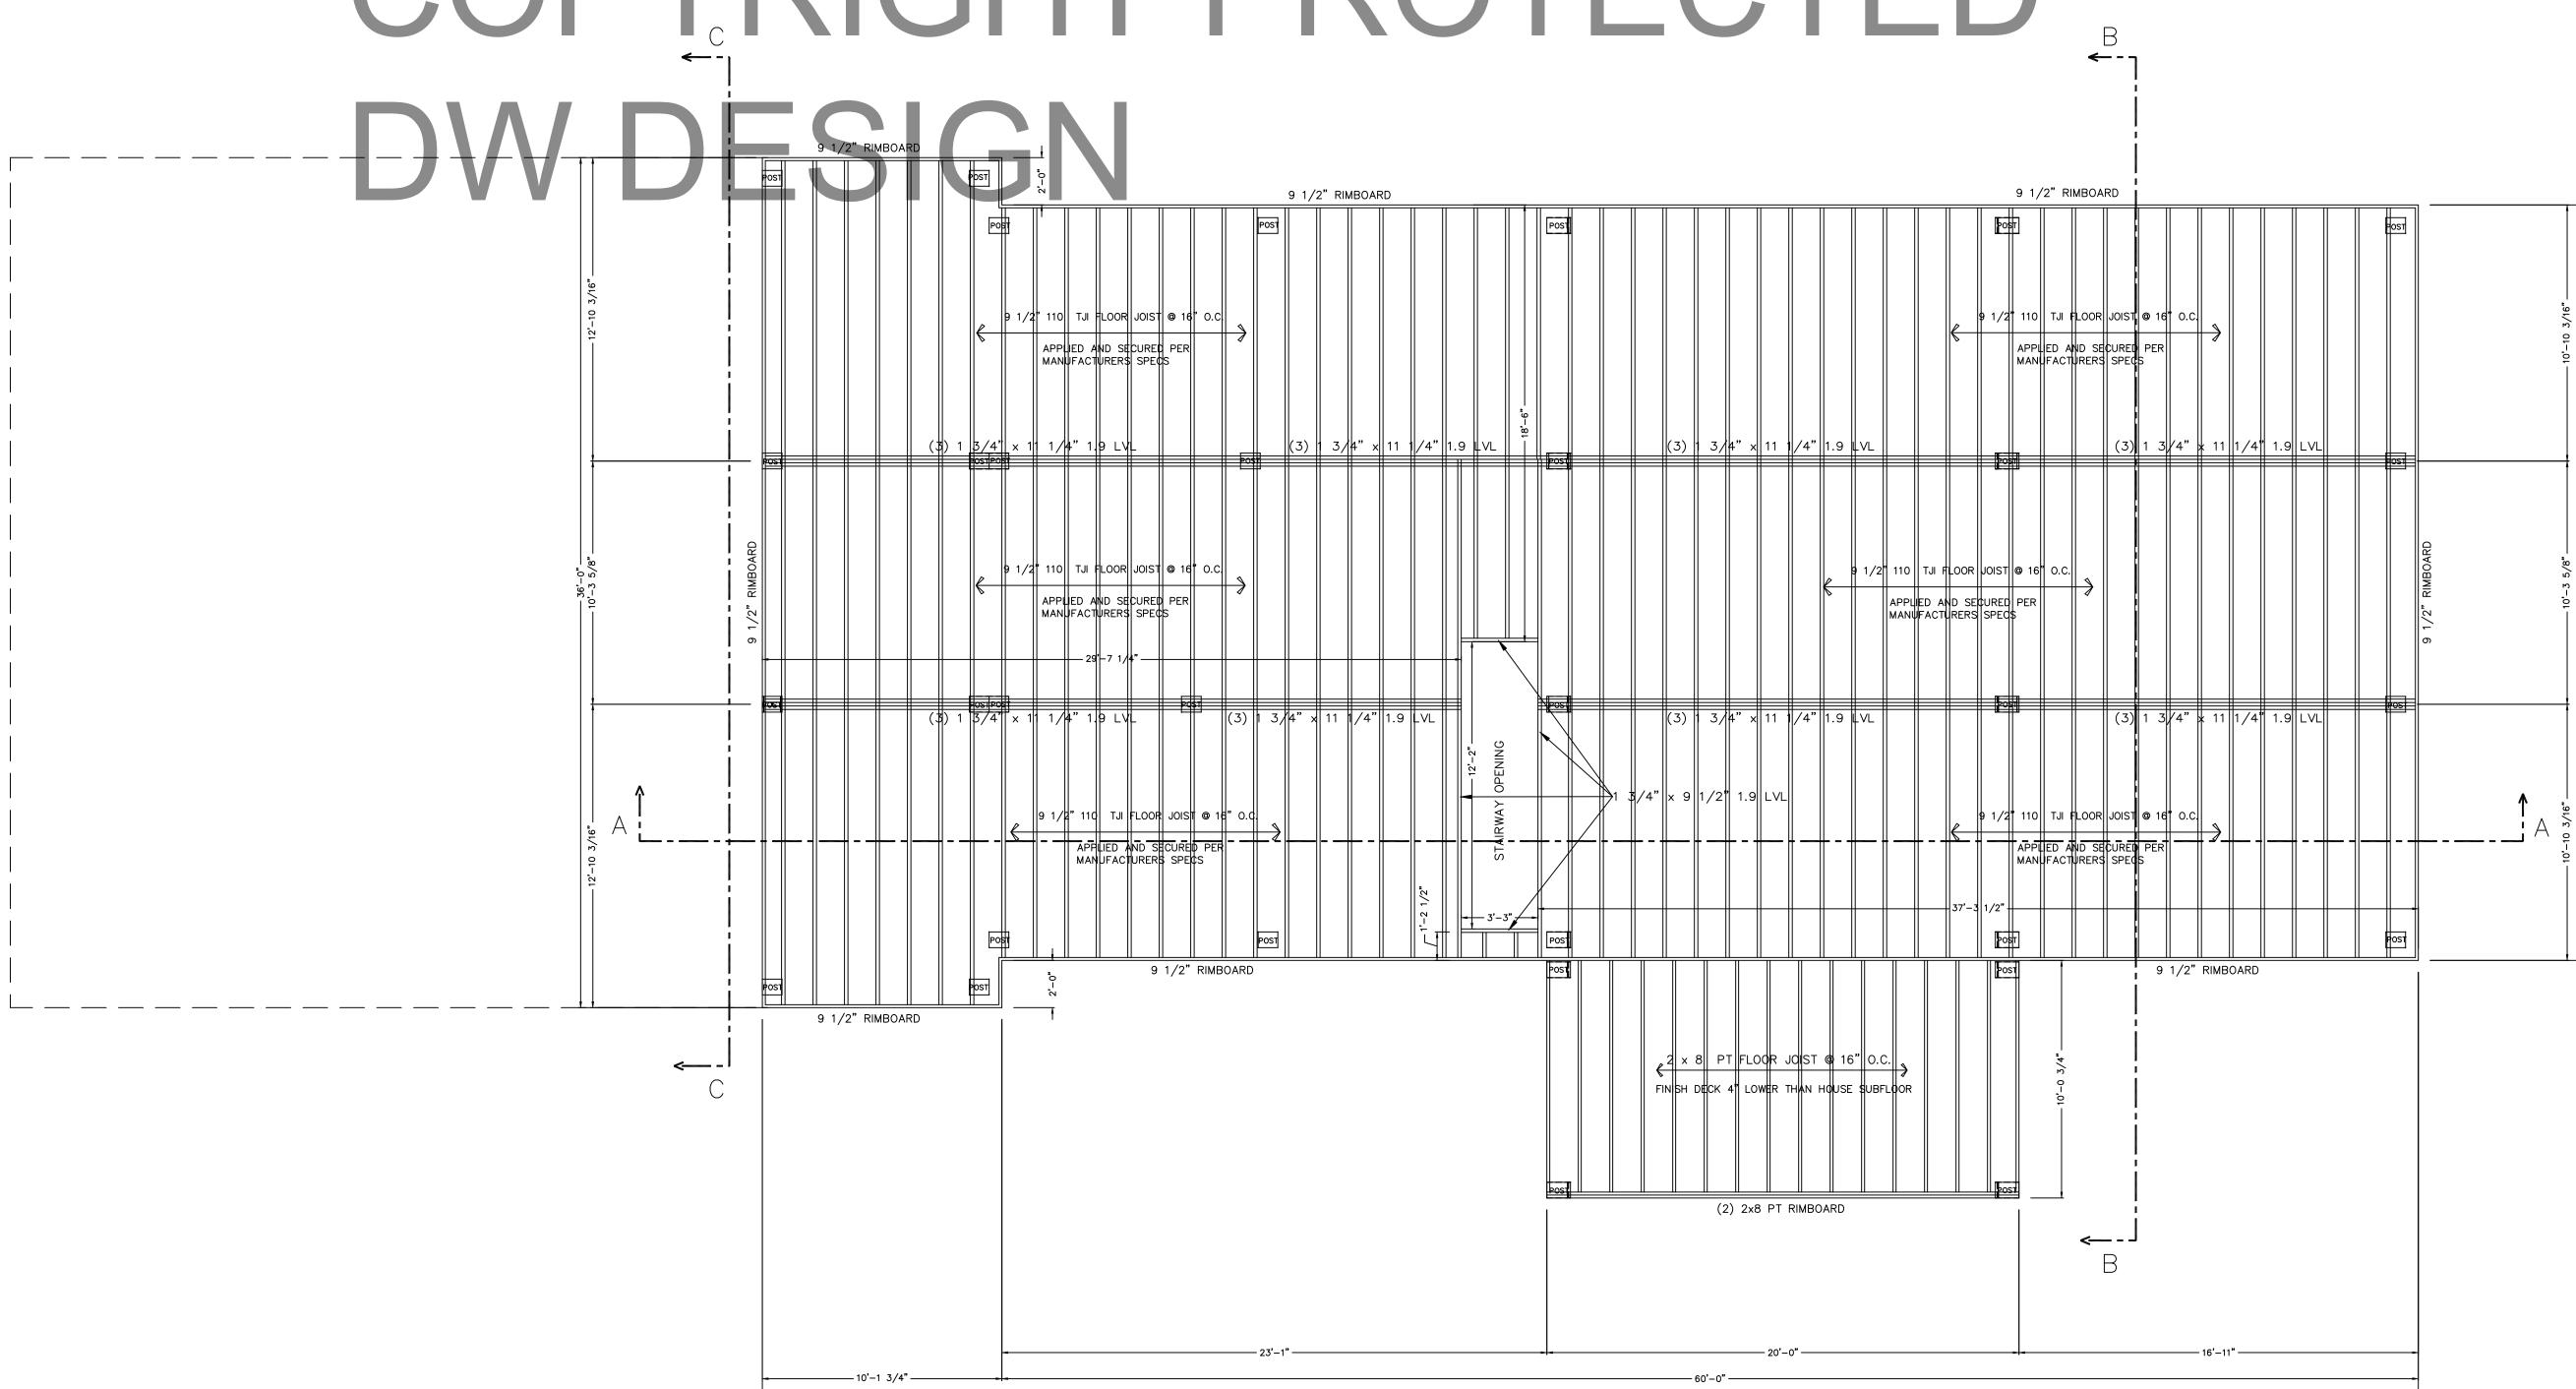

FIRST FLOOR FRAMING PLAN

REFER TO JOIST/BEAM MANUFACTURER'S LITERATURE FOR PROPER FRAMING DETAILS & SPECIFICATIONS, INSTALLING BLOCKING, SQUASH BLOCKS/WEB STIFFENERS, ETC. AS REQUIRED.




DIMENSIONS TO BE CONFIRMED BY GENERAL CONTRACTOR BEFORE CONSTRUCTION BEGINS.

PRIOR TO CONSTRUCTION OF TIMBER FRAME, ALL 1st FLOOR FRAMING MUST BE IN PLACE AND LEVEL

COPYRIGHT LAWS PROHIBIT REPRODUCTION OR USE OF THIS DRAWING, IN WHOLE OR IN PART, WITHOUT THE EXPRESSED WRITTEN PERMISSION OF DW TIMBER FRAME DESIGN

ESIDI

BOLDUC FAIRFIEL

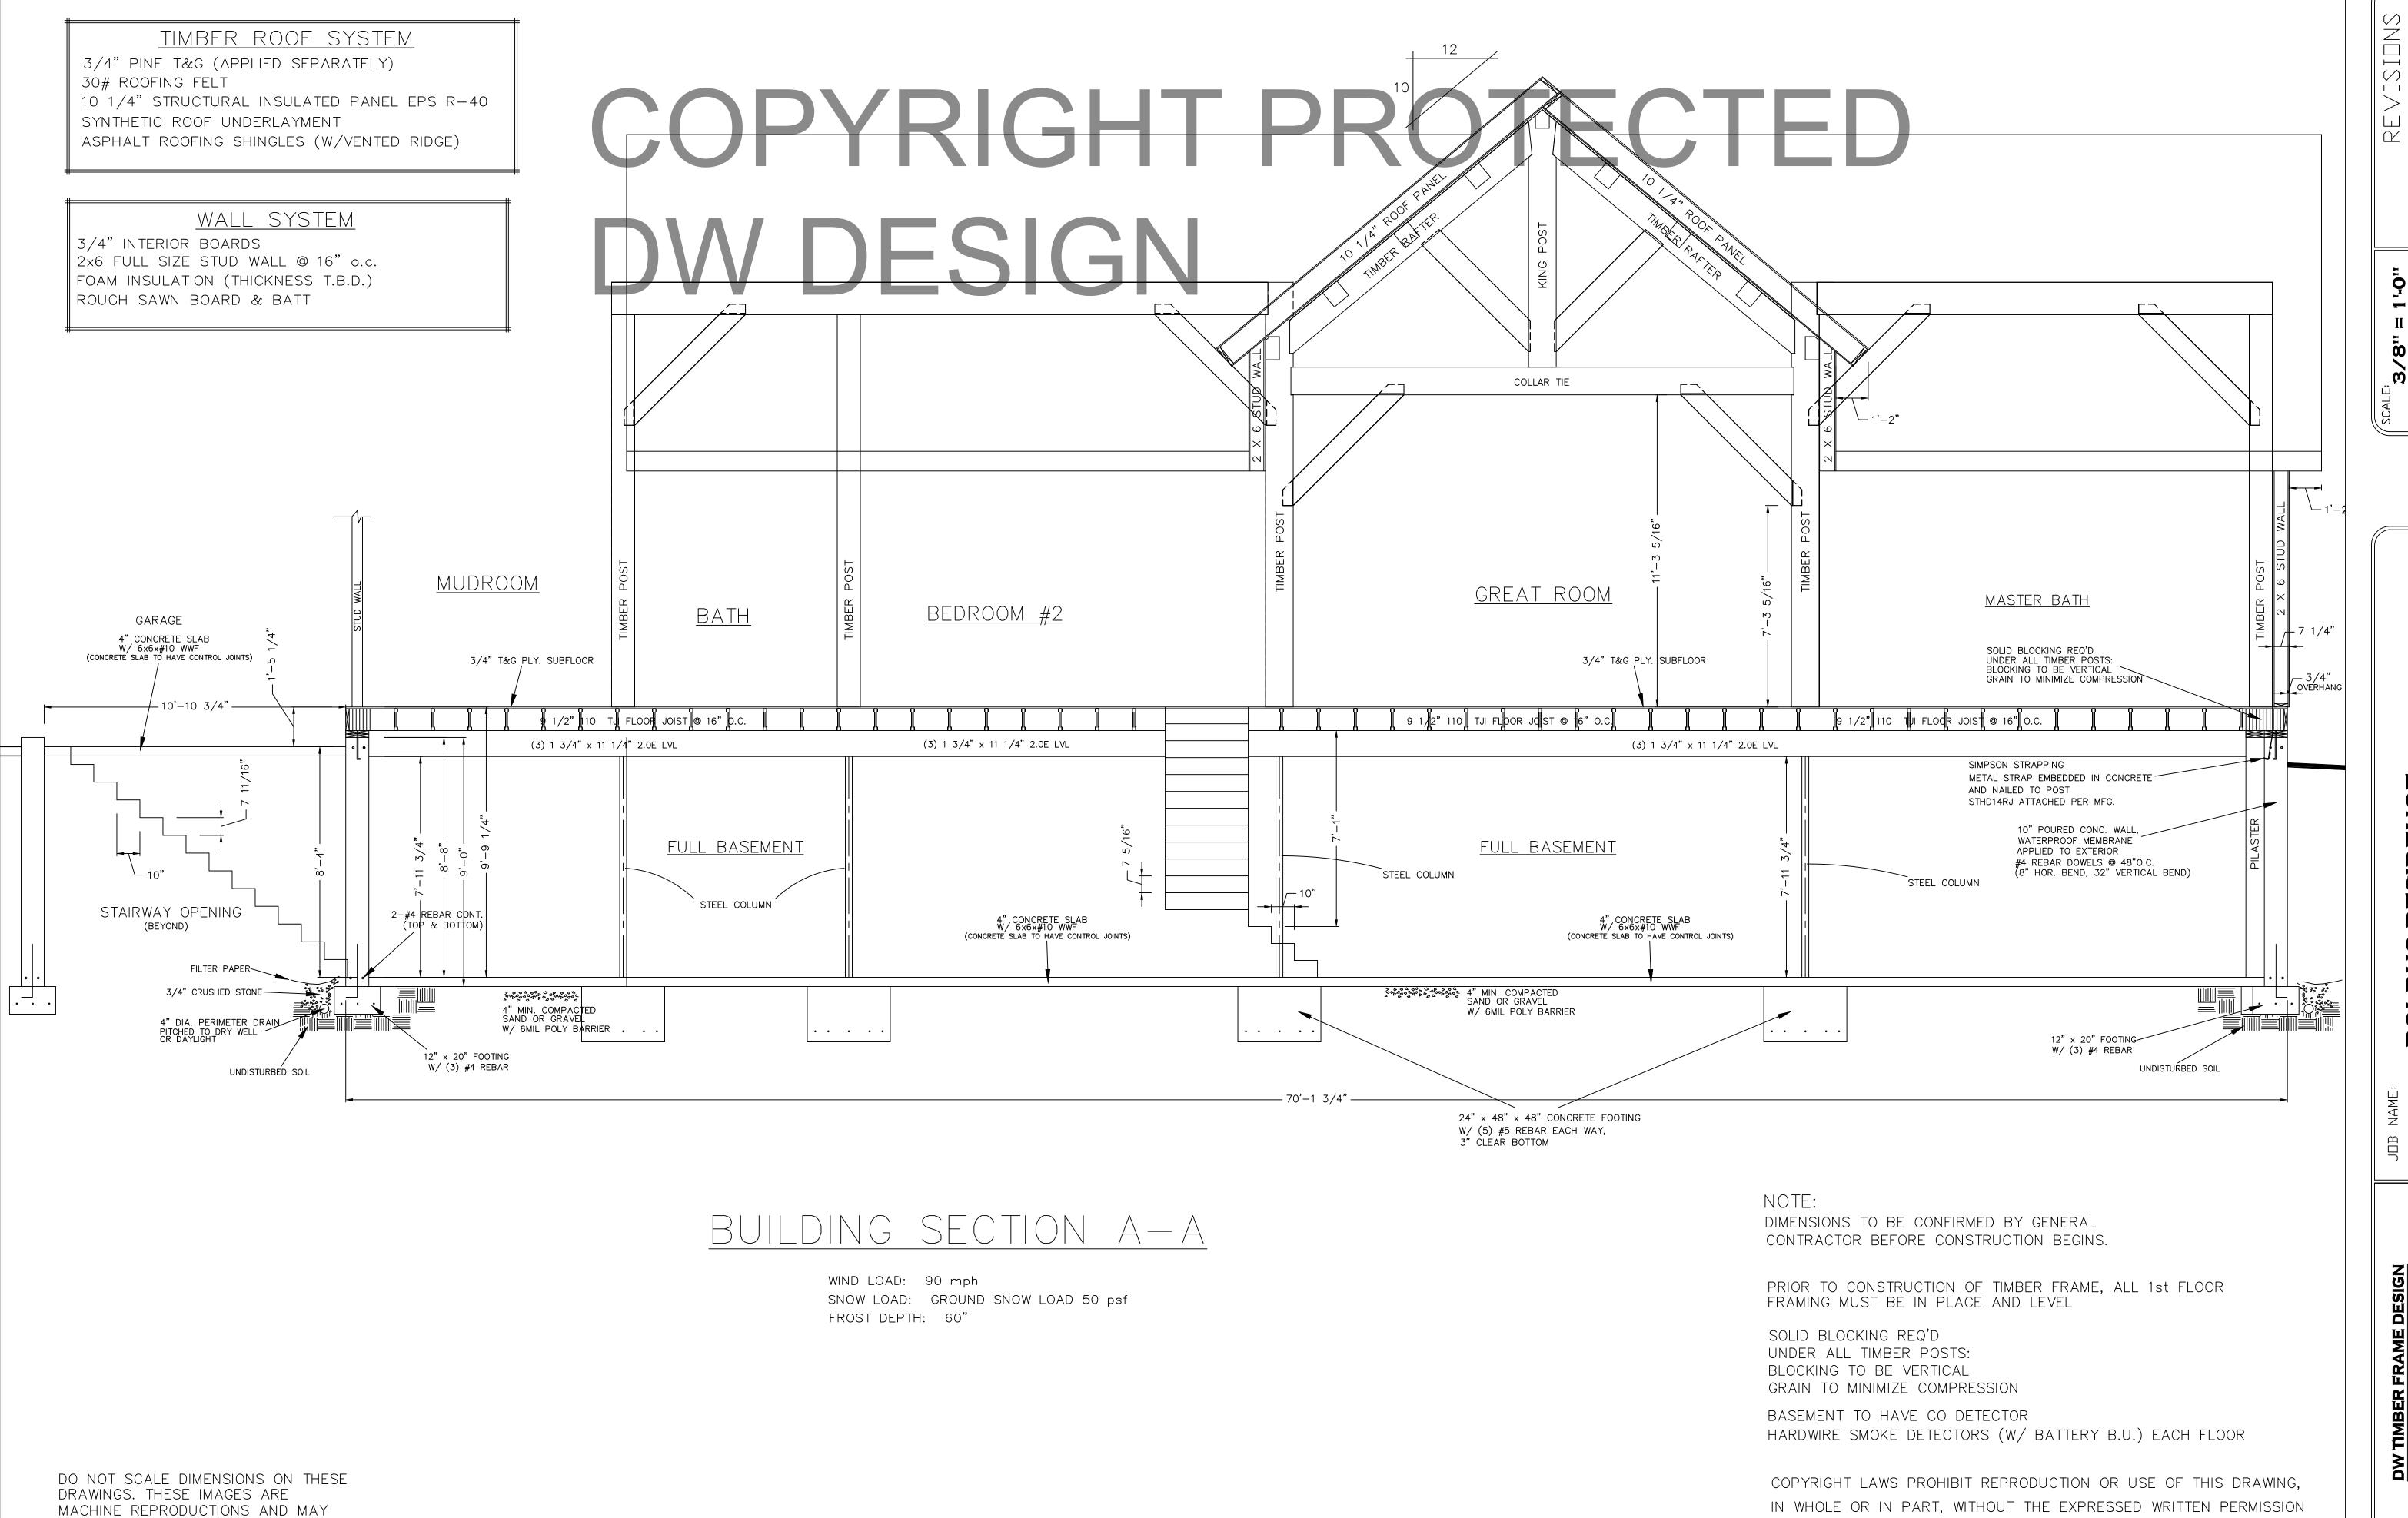


CONTAIN A MARGIN OF ERROR.

ICE 455 RESIDEN BOLDUC

A-A

OF DW TIMBER FRAME DESIGN

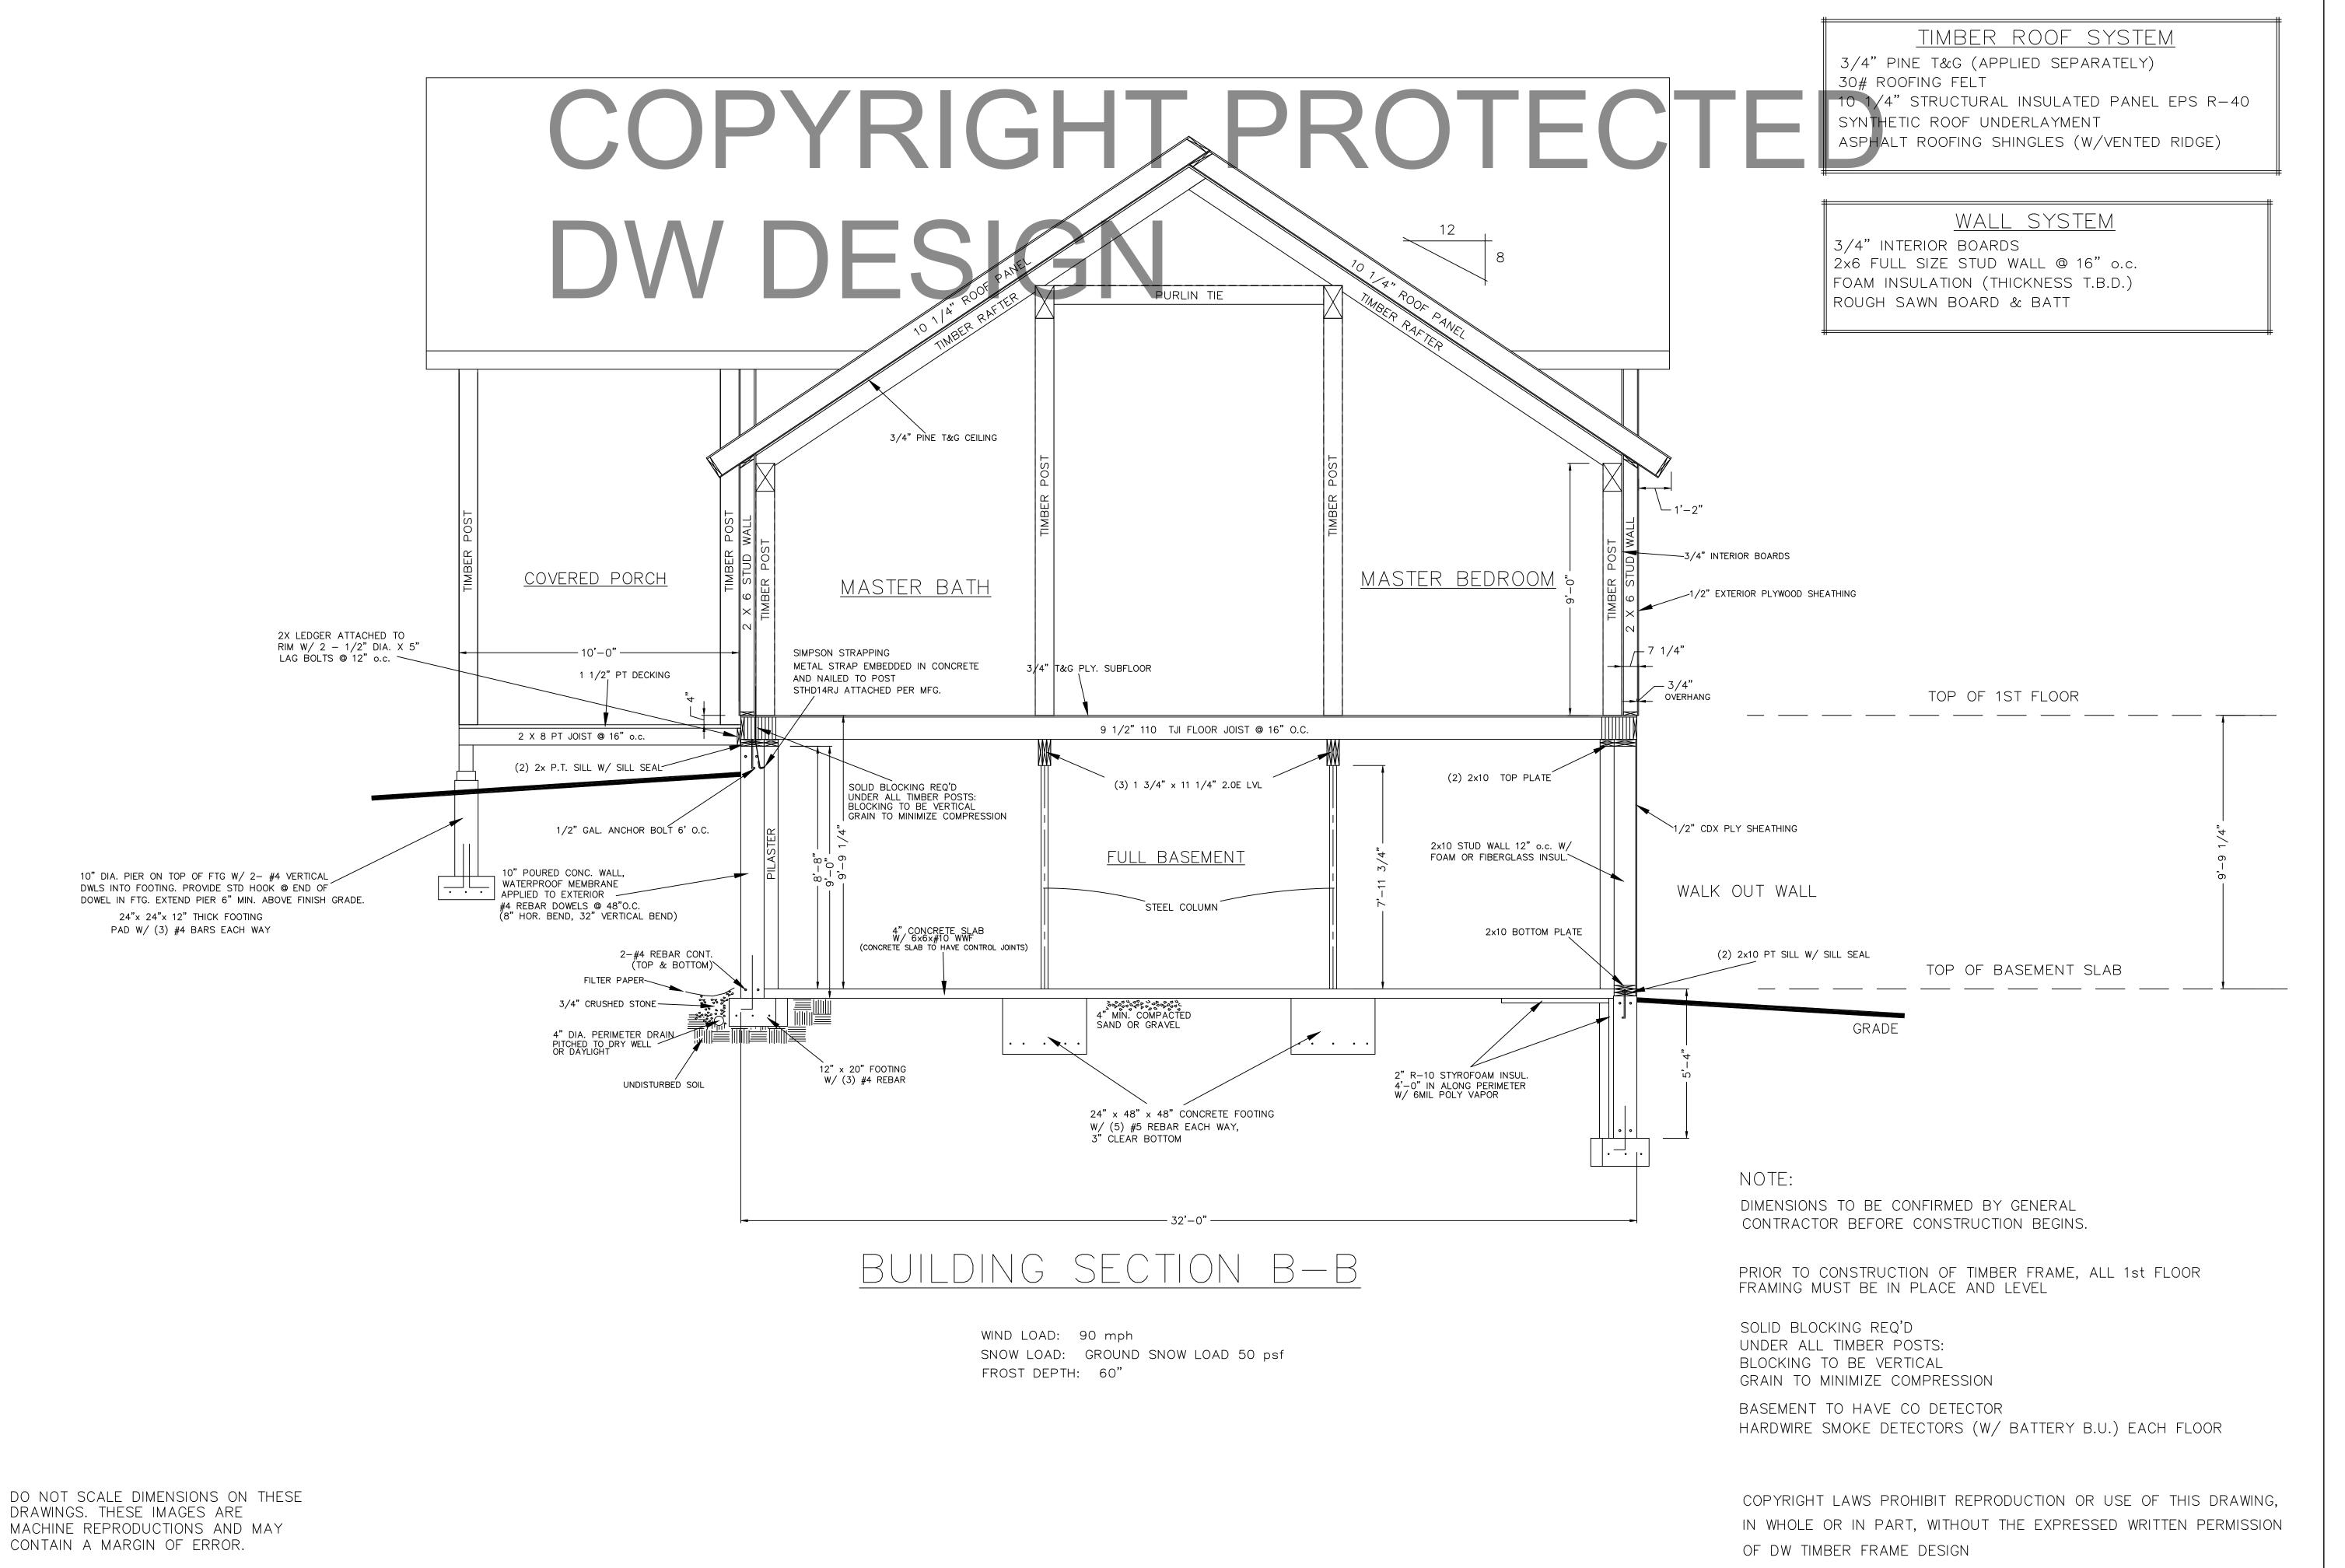

SNOISIA
 A


> CE 555 SIDEN 0

ЙĽ

6

TIMBER FRAME DESIGN FRAME & PANEL HOME DES

B-B

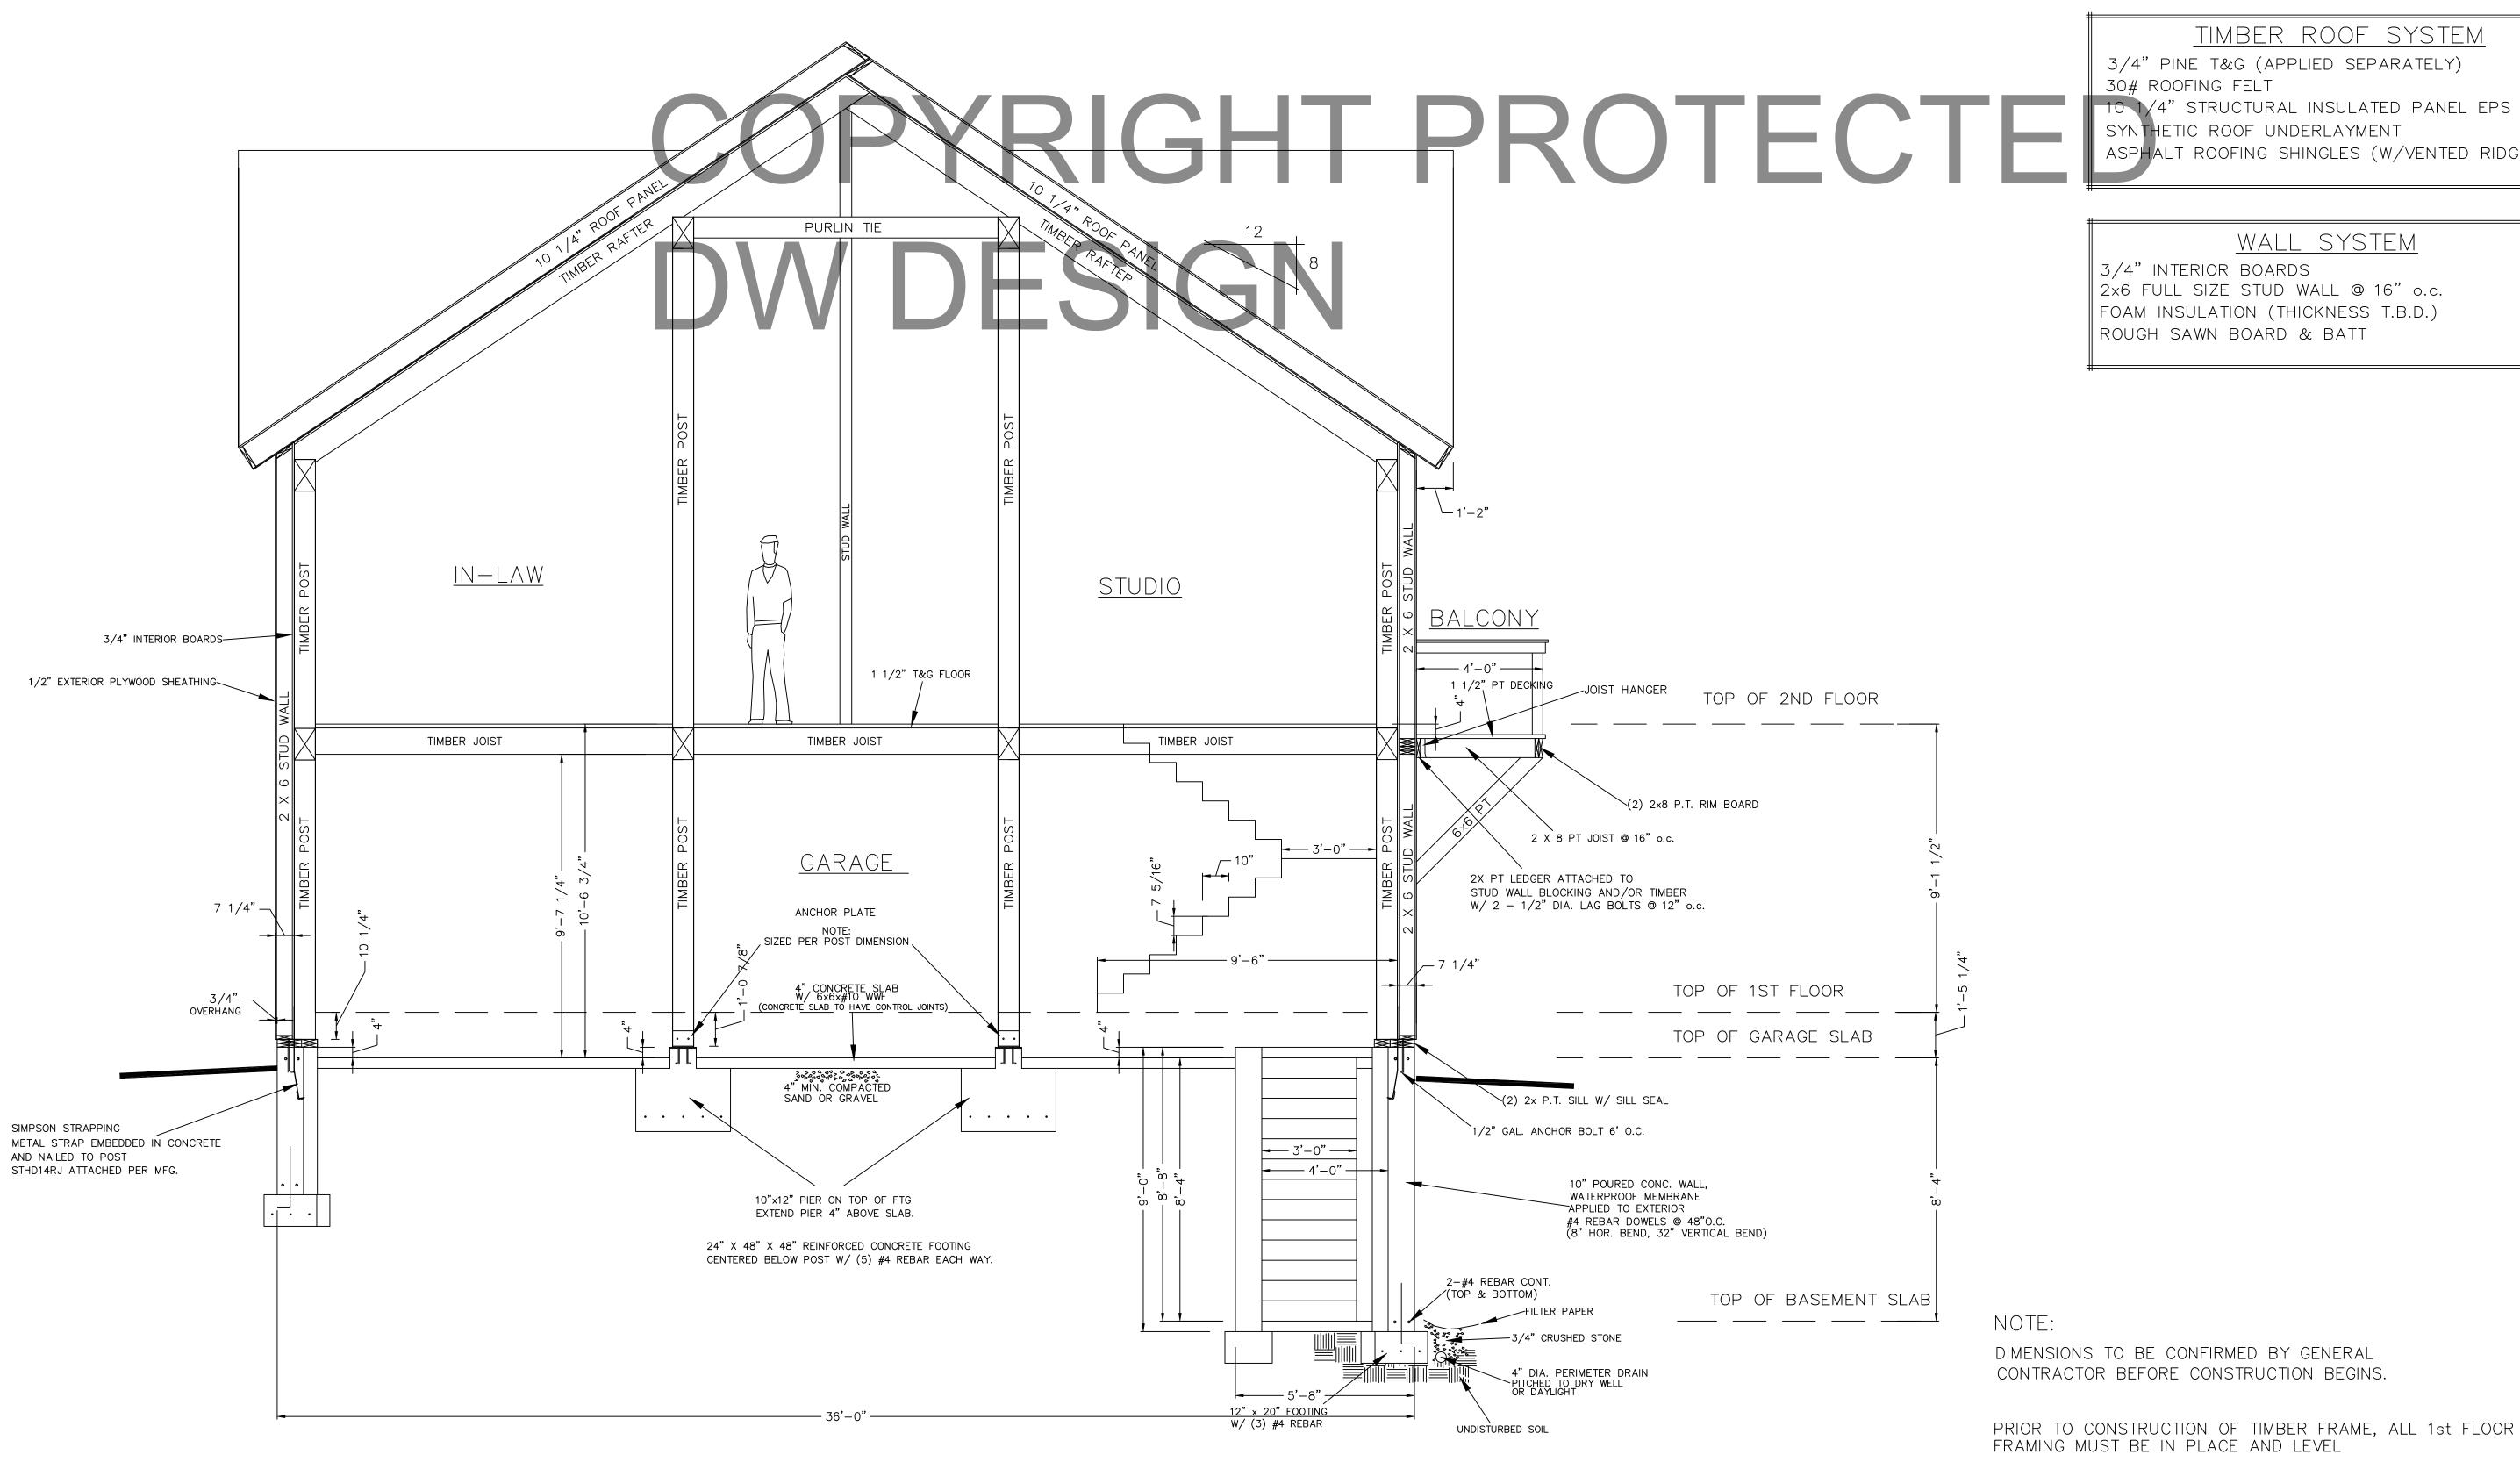

BUILDING SECTION C-C

WIND LOAD: 90 mph SNOW LOAD: GROUND SNOW LOAD 50 psf FROST DEPTH: 60"

DO NOT SCALE DIMENSIONS ON THESE DRAWINGS. THESE IMAGES ARE MACHINE REPRODUCTIONS AND MAY CONTAIN A MARGIN OF ERROR.

TIMBER ROOF SYSTEM

3/4" PINE T&G (APPLIED SEPARATELY) 30# ROOFING FELT

10 1/4" STRUCTURAL INSULATED PANEL EPS R-40 SYNTHETIC ROOF UNDERLAYMENT ASPHALT ROOFING SHINGLES (W/VENTED RIDGE)

WALL SYSTEM

3/4" INTERIOR BOARDS 2x6 FULL SIZE STUD WALL @ 16" o.c. FOAM INSULATION (THICKNESS T.B.D.) ROUGH SAWN BOARD & BATT

SNOISIA A H

> 05 及匠

COPYRIGHT LAWS PROHIBIT REPRODUCTION OR USE OF THIS DRAWING, IN WHOLE OR IN PART, WITHOUT THE EXPRESSED WRITTEN PERMISSION OF DW TIMBER FRAME DESIGN

HARDWIRE SMOKE DETECTORS (W/ BATTERY B.U.) EACH FLOOR

SOLID BLOCKING REQ'D

UNDER ALL TIMBER POSTS: BLOCKING TO BE VERTICAL

GRAIN TO MINIMIZE COMPRESSION

BASEMENT TO HAVE CO DETECTOR

C-C